

PORCH M. BATH M. BATH KITCHEN KITCHEN M. BDRM. M. BDRM. UTILITY UTILITY M. CLOS. HALL GARAGE GARAGE LIVING BATH STDY/BDRM STDY/BDRM PORCH **CONDITIONED AREA & GARAGES:** 2 X 1,475 SF = 2,950 SF

UNIT FLOOR PLAN - TYPE A

SCALE: 3/16" = 1'-0"

B1 UNIT FLOOR PLAN - TYPE B

SCALE: 3/16" = 1'-0"



FRONT ELEVATIONS RENDERED - UNIT TYPE A

SCALE: 3/16" = 1'-0"



FRONT ELEVATIONS RENDERED - UNIT TYPE B

SCALE: 3/16" = 1'-0"

pi architects

6010 Balcones Dr, Suite 200
Austin, TX 78731

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GREGORY P. HUNTEMAN
Archited* / Registration:
12979049-0301
Date: 10/03/2022

Not for regulatory pproval, permitting, or construction

approval, permitting, or construction

T NORTH OGDEN SENIO

GUE: CONCEPTUAL PLANNING SET


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EVISIONS:

DATE: 11/15/2022 PROJECT NUMBER 22019

SHEET TITLE:
SD UNIT PLANS FRONT
ELEVATIONS

SK2

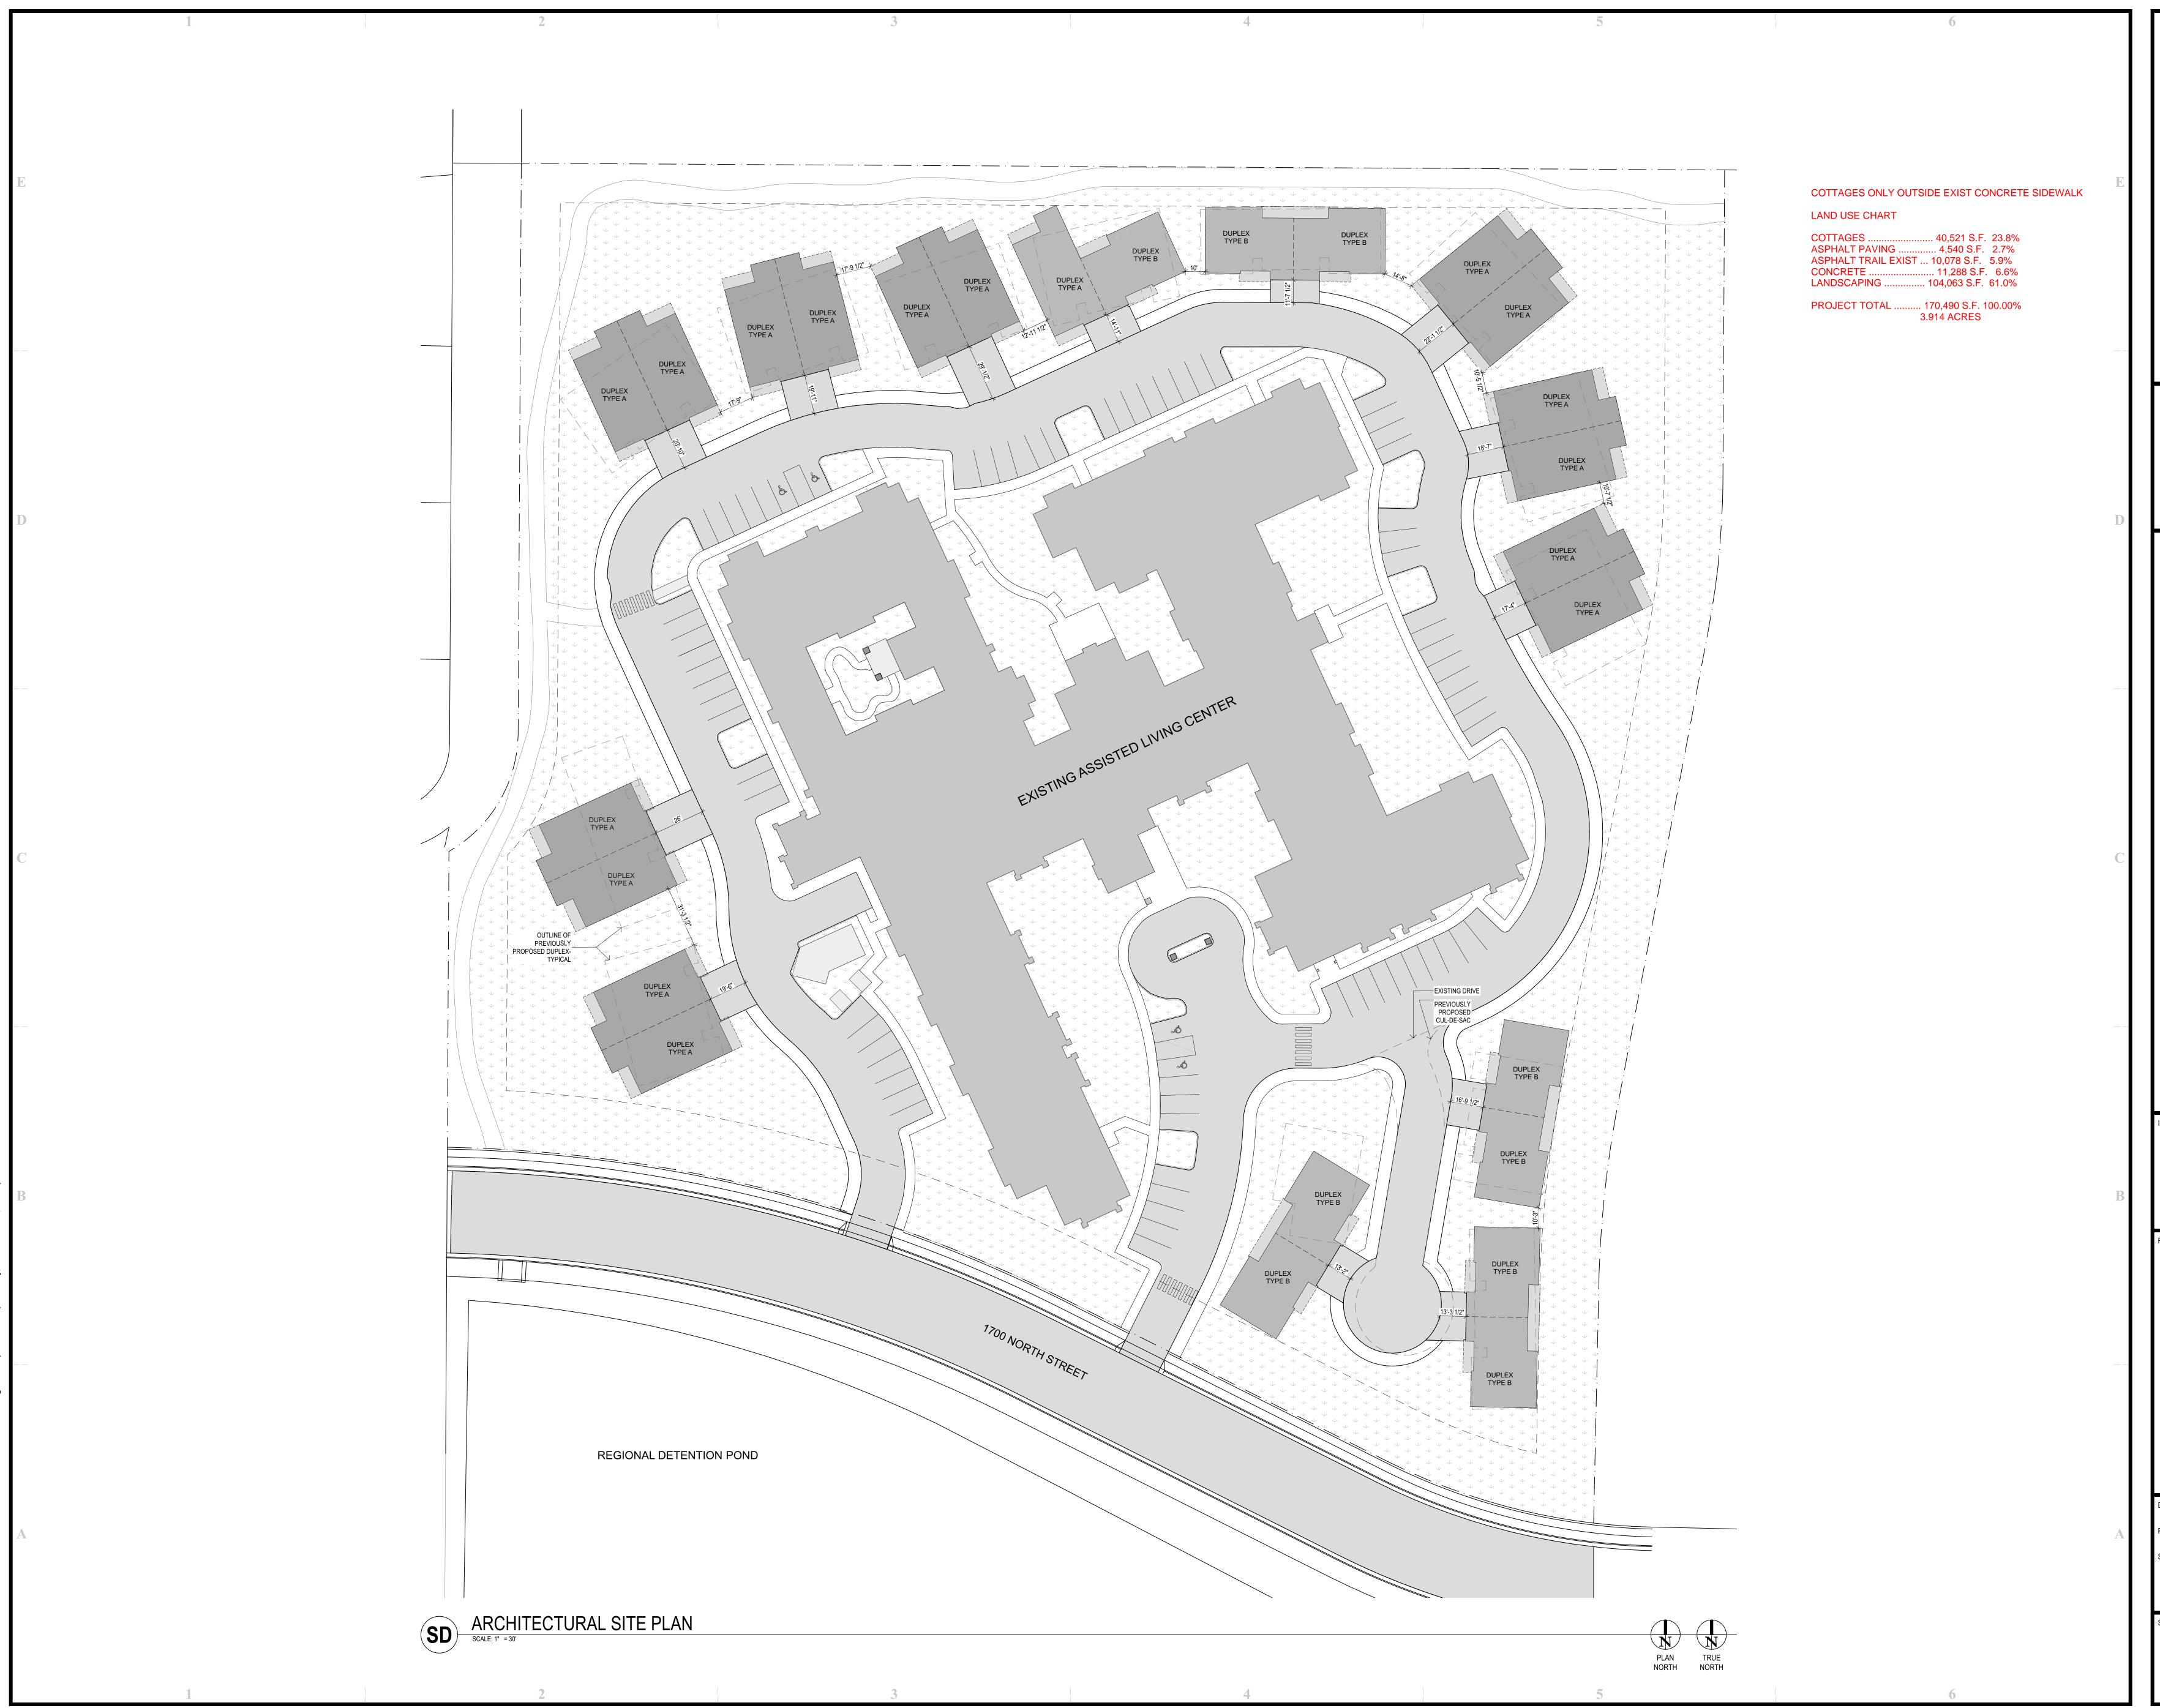

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architecture + master planning interiors + landscape architecture

GREGORY P. HUNTEMAN
Archited# / Registration:
12979049-0301
Date: 12/19/2022

Date: 129/9049-0301

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SENIOR LIVING

ES AT NORTH OGDEN SE

204 EAST 1700 NORTH ST.
NORTH OGDEN 11T 84414

SSUE:
CONCEPTUAL
PLANNING
PROGRESS SET

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REVISIONS:

DATE: 12/19/2022 PROJECT NUMBER: 22019

SHEET TITLE:
ARCHITECTURAL
SITE PLAN

SK1

CONSTRUCTION NOTES:

ALL CONSTRUCTION TO BE TO NORTH OGDEN CITY STANDARDS. IN THE EVENT THERE IS NO APPLICABLE STANDARD, CONTACT PROJECT ENGINEER / CITY ENGINEER. CONTRACTOR MUST ATTEND PRE-CONSTRUCTION CONFERENCE WITH CITY PRIOR TO COMMENCING WORK.

PRIOR TO CONSTRUCTION, CONTRACTOR TO LOCATE ALL EXISTING UTILITIES. CONTRACTOR IS RESPONSIBLE FOR UNCOVERING AND VERIFICATION OF ALL EXISTING UTILITIES.

TRAFFIC CONTROL IS THE RESPONSIBILITY OF CONTRACTOR; TRAFFIC CONTROL PLAN TO BE APPROVED BY NORTH OGDEN CITY AND IMPLEMENTED TO CITY APPROVAL.

SOILS TESTING TO BE PERFORMED ON PROJECT, ESPECIALLY FOR TRENCH RESTORATION. OWNER FUNDAMENTALLY WILL BE PAYING FOR SOILS TESTING BUT SUCH TO BE NEGOTIATED PRIOR TO START OF CONSTRUCTION (I.E. PERHAPS OWNER PAYS FOR ALL PASSING TESTS, CONTRACTOR FOR FAILING ONES, ETC.).

GRADING NOTES:

ALL EARTHWORK TO BE DONE TO SPECIFICATIONS OF GEOTECHNICAL REPORT BY AGEC, PROJECT NO. 1140512 DATED JULY 15, 2014.

WATER: FIRE HYDRANTS ARE LOCATED NEARBY - CONTACT NORTH OGDEN CITY FOR DETAILS/USAGE.

OBTAIN APPROPRIATE SWPPP PERMIT PRIOR TO COMMENCEMENT OF WORK.

IF APPLICABLE, EXCESS SOILS TO BE SPOILED ON-SITE AND/OR AT DIRECTION OF OWNER.

IMPORTANT: ALL UTILITY TRENCHES TO BE COMPACTED TO 95%! SURFACE SOILS ARE LEAN CLAY PER THE GEOTECHNICAL REPORT AND ARE UNLIKELY TO BE SUITABLE FOR TRENCH BACKFILL.

CULINARY WATER / FIRE PROTECTION:

SITE TO BE SERVED BY 8-INCH PVC WATER MAIN IN 1700 NORTH STREET. NEW LOOPING ON-SITE 8-INCH C-900 DR-14 WATER MAIN TO BE INSTALLED WITH 8-INCH MASTER METER-BRAND OCTAVE ULTRASONIC METER. WATER PROVIDER IS NORTH OGDEN CITY - CONTACT PRIOR TO COMMENCEMENT OF WORK - DAVID ESPINOZA AT 801-940-1952. WATER SERVICES WILL NEED TO BE INDIVIDUALLY TAPPED AT THE ON-SITE WATER MAIN, HOWEVER NO COTTAGES NOR THE MAIN BUILDING WILL HAVE INDIVIDUAL METERS - ONE COMPOSITE FLOW WILL BE METERED FROM 8-INCH PROJECT MASTER METER. EXTEND WATER SERVICES TO THE COTTAGES 10 FEET BEYOND BACK OF SIDEWALK AND PROVIDE BLUE-PAINTED 2" X 4" POST. ALSO PROVIDE LOCATOR WIRE & MAGNETIC TAPE WITH WATERLINES. FIRE HYDRANT LOCATIONS AND REQUIREMENTS ARE PER NORTH VIEW FIRE DISTRICT - CONTACT RYAN BARKER AT 801-782-8159.

SEWER:

SITE WILL BE SERVED BY NORTH OGDEN CITY FROM SEWER MAIN IN 1700 NORTH STREET. THE MAIN BUILDING WILL HAVE A 1000-GALLON GREASE TRAP ON THE WEST SIDE OF THE BUILDING - PROVIDE SAMPLING MANHOLE. MAIN BUILDING WILL ALSO HAVE A SEWER LATERAL EXITING OUT EAST SIDE OF BUILDING. IT IS PERMISSIBLE TO RUN A 4-INCH SEWER LATERAL TO A DUAL-UNIT / SINGLE STRUCTURE COTTAGE BUILDING. EXTEND SEWER LATERALS TO 10 FEET BEYOND BACK OF SIDEWALK AND MARK ALL LATERALS WITH GREEN-PAINTED 2" X 4" POST. ON-SITE SEWER MAIN TO BE 8-INCH SDR-35. IT IS STRONGLY RECOMMENDED TO INSTALL GRAVITY SEWER MAIN AND LATERALS OFF MAIN FIRST, BEFORE OTHER UTILTIY INSTALLATION ON-SITE. NORTH OGDEN CITY CONTACT: TRENT WILKINS AT 801-940-1934.

STORM DRAINAGE:

STORM DRAINAGE WILL BE ROUTED TO TWO DRAINAGE LOCATIONS ON THE NORTH SIDE OF 1700 NORTH STREET. THE SITE CONTRIBUTES TO A REGIONAL STORMWATER BASIN LOCATED ON THE OPPOSITE SIDE OF 1700 NORTH STREET. PROJECT DETENTION TAKES PLACE IN THE REGIONAL POND. DUE TO VERY FLAT TOPOGRAPHY IN THE AREA, REGIONAL POND FLOWS COULD BACK-UP INTO ON-SITE STORM PIPING, HOWEVER NO FLOWS SHOULD SURFACE OUT OF THE ON-SITE INLETS AND THE MAIN BUILDING AND COTTAGES HAVE FINISH FLOORS WELL ABOVE REGIONAL POND TOP OF BANK ELEVATIONS. THE SITE WILL HAVE A SOUTHWEST 18-INCH STUB PROVIDED, WHICH WILL SERVE THE WEST PORTION OF THE SITE. THE EAST PORTION OF THE SITE WILL TIE INTO A CURB INLET BOX ABOUT MID-PROJECT ON THE NORTH SIDE OF 1700 NORTH STREET. CONNECT ROOF DRAINAGE INTO ON-SITE DRAINAGE STRUCTURES. STORM DRAIN PIPING TO BE RCP IN ALL PAVEMENT AREAS, WITH FULL DEPTH BACKFILL (PIPING IS GENERALLY QUITE SHALLOW). NORTH OGDEN CITY CONTACT: DAVID SMITH @ 801-940-1954.

ENGINEER'S NOTICE TO CONTRACTORS:


THE EXISTENCE AND LOCATION OF ANY UNDERGROUND UTILITY PIPES OR STRUCTURES SHOWN ON THESE PLANS WERE OBTAINED FROM AVAILABLE INFORMATION PROVIDED BY OTHERS. THE LOCATIONS SHOWN ARE APPROXIMATE AND SHALL BE CONFIRMED IN THE FIELD BY THE CONTRACTOR, SO THAT ANY NECESSARY ADJUSTMENT CAN BE MADE IN ALIGNMENT AND/OR GRADE OF THE PROPOSED IMPROVEMENTS. THE CONTRACTOR IS REQUIRED TO CONTACT THE UTILITY COMPANIES AND TAKE PRECAUTIONARY MEASURES TO PROTECT ANY UTILITY LINES SHOWN, AND ANY OTHER LINES OBTAINED BY THE CONTRACTOR'S RESEARCH, AND OTHERS NOT OF RECORD NOR SHOWN ON THESE PLANS.

BLUE STAKES LOCATION CENTER:

CALL TOLL FREE: 1-800-662-4111, TWO WORKING DAYS BEFORE YOU DIG.

CANYON VIEW SENIOR LIVING IMPROVEMENT PLANS



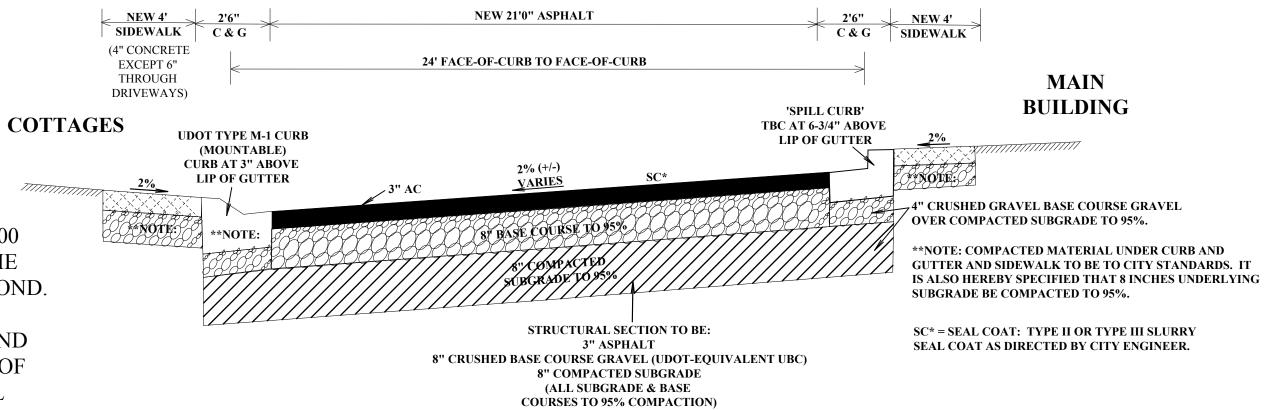

INTERNAL DRIVEWAY TYPICAL SECTION

HANSEN & ASSOCIATES, INC.

Consulting Engineers and Land Surveyors
538 North Main Street Brigham City, Utah 84302
(435) 723-3491 www.haies.net



SHEET INDEX:

- C1....PROJECT DATA / COVER SHEET
- C2....SITE PLAN
- C3....GRADING & DRAINAGE PLAN SOUTH
- C4....GRADING & DRAINAGE PLAN NORTH
- C5....MASTER UTILITY PLAN

SECONDARY WATER:

IRRIGATION WILL BE FROM A PINEVIEW SECONDARY WATER MAIN IN 1700 NORTH STREET. A 4-INCH WATER LINE AND METER WILL BE PROVIDED, AS WELL AS A 4-INCH LOOPING ON-SITE MAIN LINE. SECONDARY WATER MAINLINES SHALL BE ASTM D2241 - CLASS 200 - SDR-21 PVC PIPE (PURPLE-COLORED). SEE LANDSCAPE & IRRIGATION PLANS. PINEVIEW WATER CONTACT: MARK GREENHALGH 801-721-7119.

ELECTRICAL:

UNDERGROUND POWER WILL BE ALONG NORTH SIDE OF 1700 NORTH STREET. ON-SITE PLAN TO BE PER ELECTRICAL ENGINEERING PLANS. NOTE EXTENSIVE ON-SITE LIGHTING PLANS.

TELEPHONE:

TELEPHONE ROUTING: TBD - ASSUMED TO FOLLOW ELECTRICAL ROUTING.

GAS:

GAS MAIN TO BE ALONG NORTH SIDE OF 1700 NORTH STREET - GAS ROUTING HAS NOT YET BEEN DEFINITIVELY DETERMINED. IT MAY BE ADVANTAGEOUS TO INSTALL GAS LINE AND SERVICE STUBS PRIOR TO SIDEWALK INSTALLATION.

STRUCTURAL SECTION / COTTAGE DRIVEWAYS:

PER GEOTECHNICAL REPORT, ON-SITE STRUCTURAL SECTION IS 3 INCHES ASPHALT ON 8 INCHES CRUSHED BASE COURSE GRAVEL (UDOT-EQUIVALENT UBC) ON 8 INCHES OF COMPACTED SUBGRADE, WHICH ALSO APPLIES TO ALL UTILITY CROSSINGS.

DRIVEWAYS AND SIDEWALKS THROUGH DRIVEWAYS ARE TO HAVE 6 INCHES OF CONCRETE. PER THE GEOTECHNICAL REPORT, THICKER PAVEMENT SECTIONS MAY BE CONSIDERED FOR AREAS OF CONCENTRATED TRAFFIC OR HEAVIER VEHICLES SUCH AS NEAR ENTRY WAYS AND ADJACENT TRASH ENCLOSURES. A CONCRETE APPROACH SLAB CONSISTING OF 6-1/2 INCHES OF PORTLAND CEMENT CONCRETE OVERLYING 4 INCHES OF CRUSHED BASE COURSE GRAVEL (UDOT-EQUIVALENT UBC), (ON 8 INCHES OF COMPACTED SUBGRADE TO 95%) IS RECOMMENDED AT TRASH ENCLOSURES.

OUTSIDE PERIMETER IS UDOT TYPE M-1 MOUNTABLE CURB FOR FLEXIBILITY FOR DRIVEWAY PLACEMENT, AND TO ACCOMMODATE ELIMINATION OF TRANSITIONS AT DRIVEWAY/SIDEWALK INTERFACE LOCATIONS.


THE MAJORITY OF THE INNER PERIMETER DRIVEWAY IS STANDARD SPILL CURB AND GUTTER, MEANING DRAINING AWAY FROM THE BUILDING/CURB LINE, NOT TOWARDS IT. THE TOP OF CURB WILL BE 6-3/4 TO 7 INCHES HIGHER THAN THE LIP OF THE GUTTER.

THE GRADING PLANS SHOW LIP OF GUTTER ON THE OUTER PERIMETER AND 'TA' (TOP OF ASPHALT) ON THE INNER PERIMETER, ALONG WITH TBC ELEVATIONS. DUE TO THE DIFFERING TOP OF CURB ELEVATIONS, AND TO ASSURE PROPER SUBGRADE-ROADBASE-ASPHALT PREPARATION, IT IS STRONGLY RECOMMENDED THAT CONTRACTOR HAVE STAKING PERTAIN TO 'LIP' AND 'TA' ELEVATIONS TO ELIMINATE CONFUSION OVER VARYING TBC MATHEMATICS IN THE FIELD.


PROJECT ENGINEER:

JAMES FLINT UTAH PE 7806324-2202 DATE:




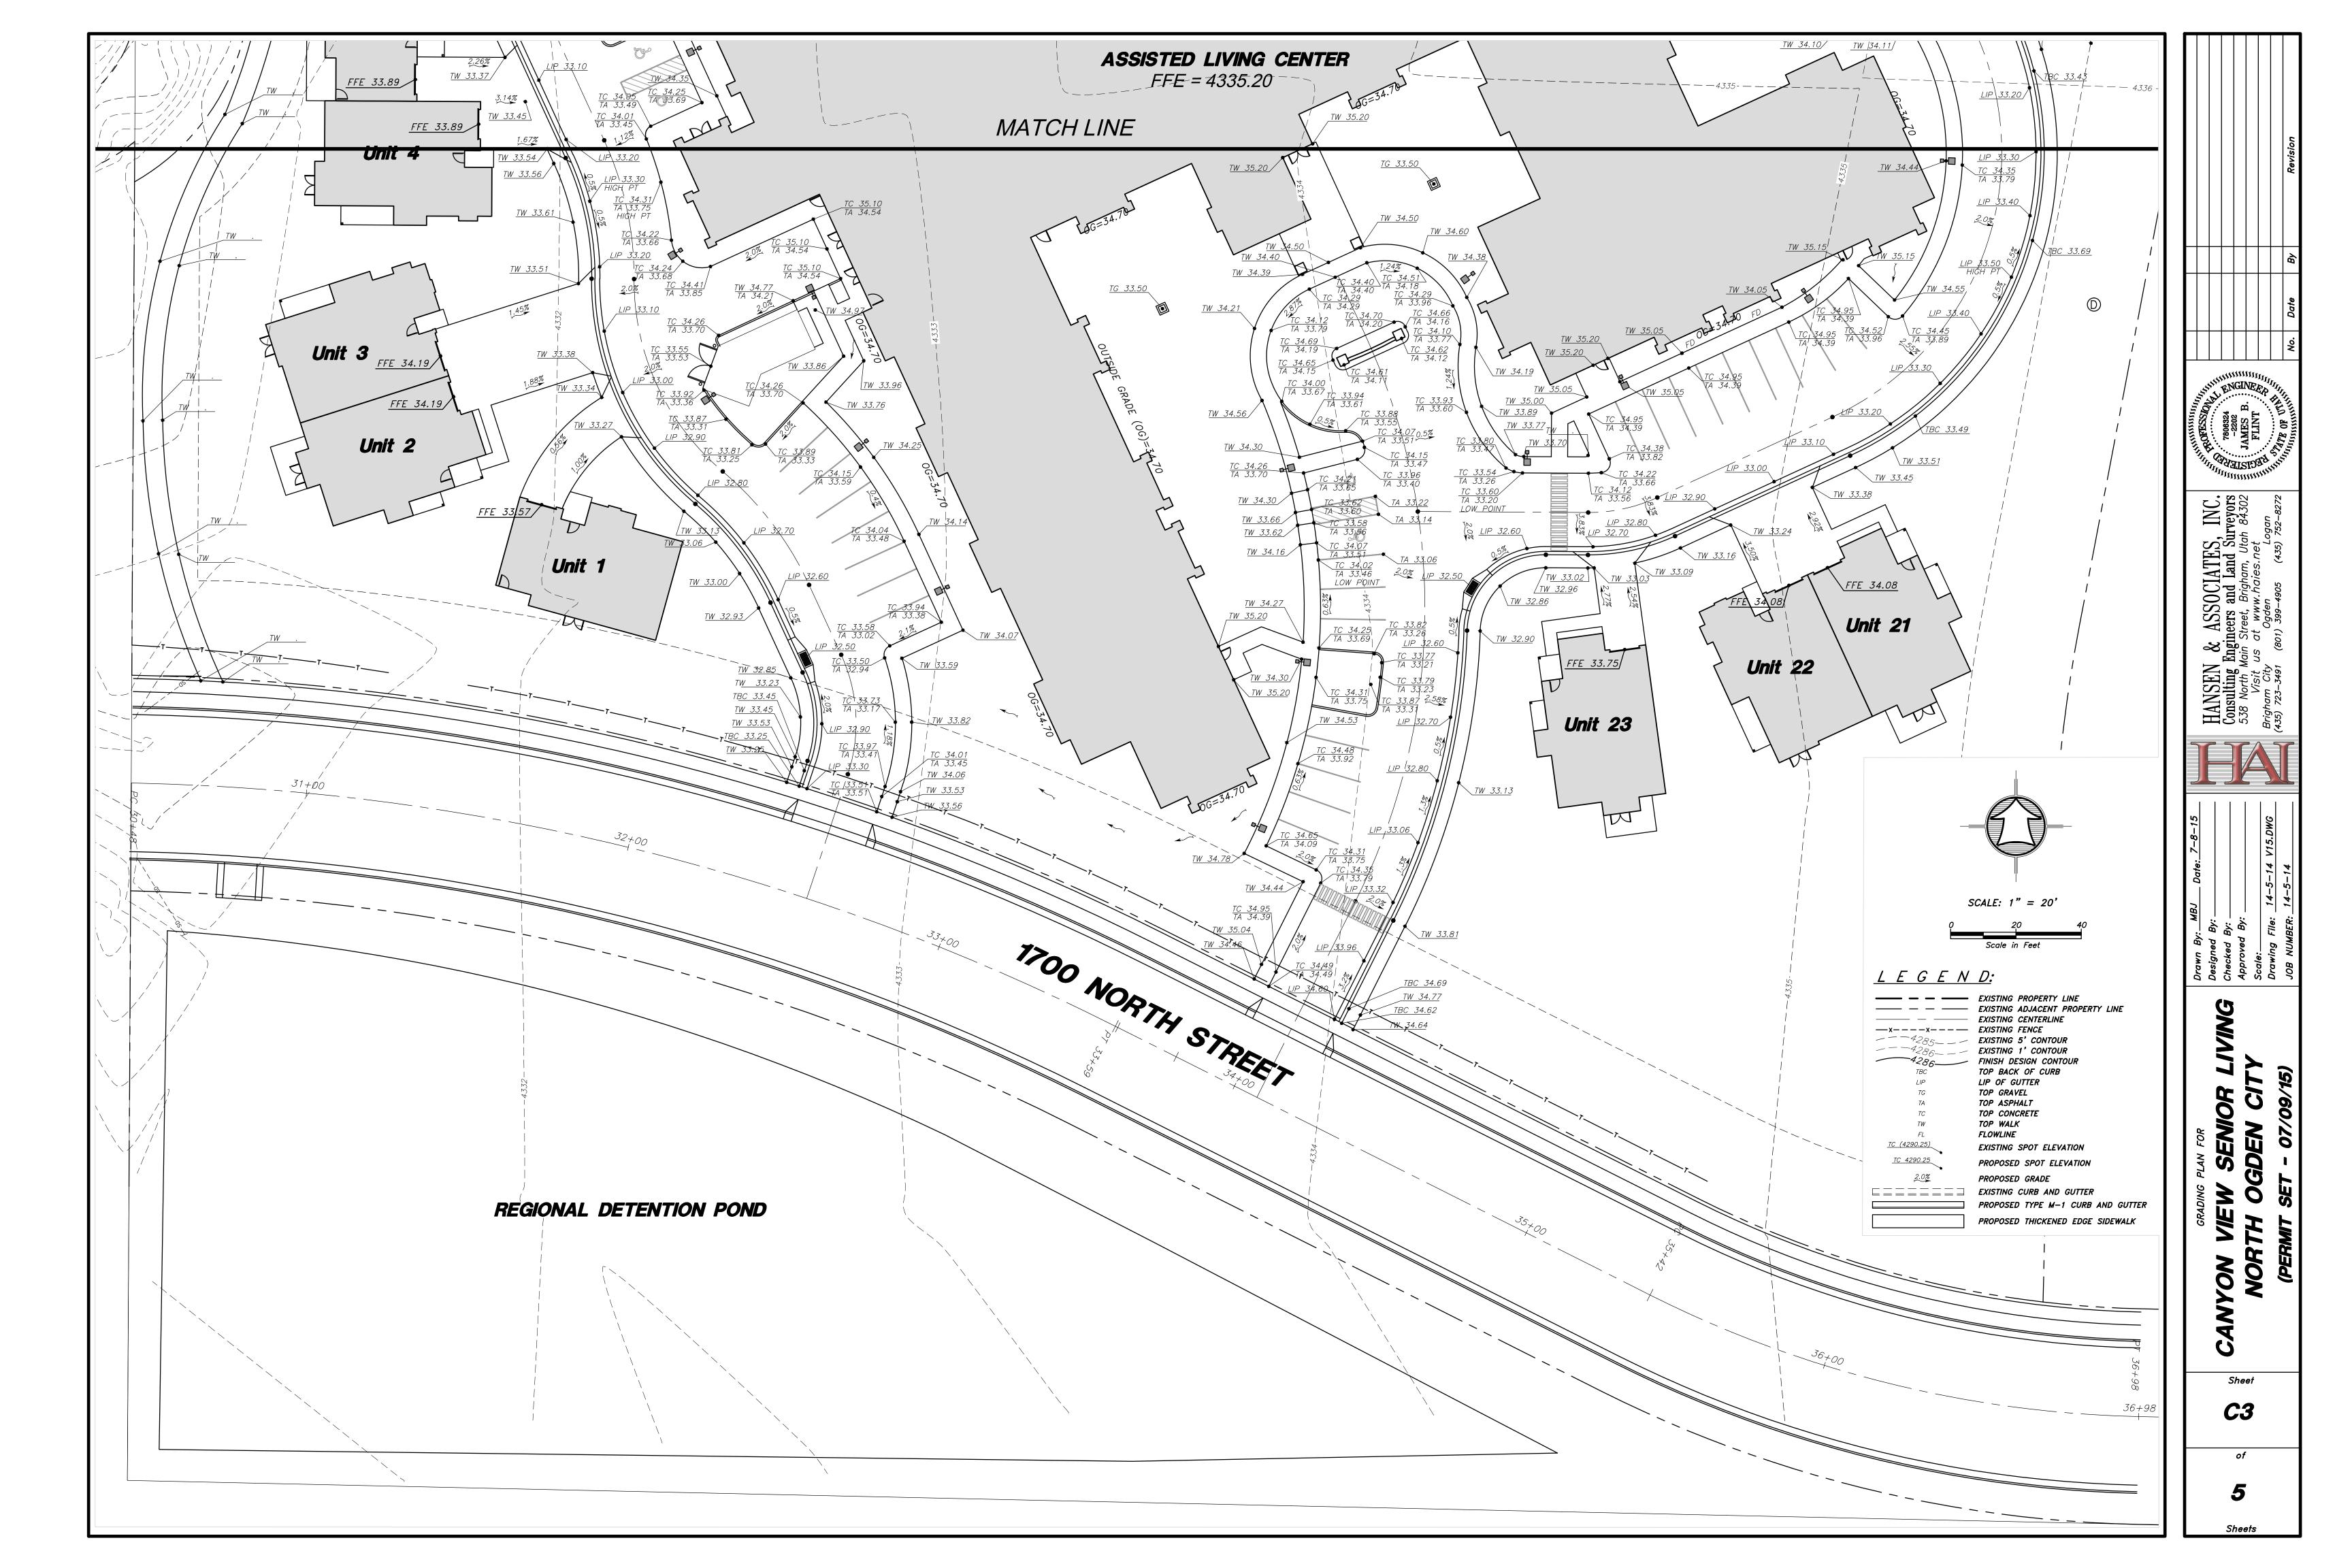





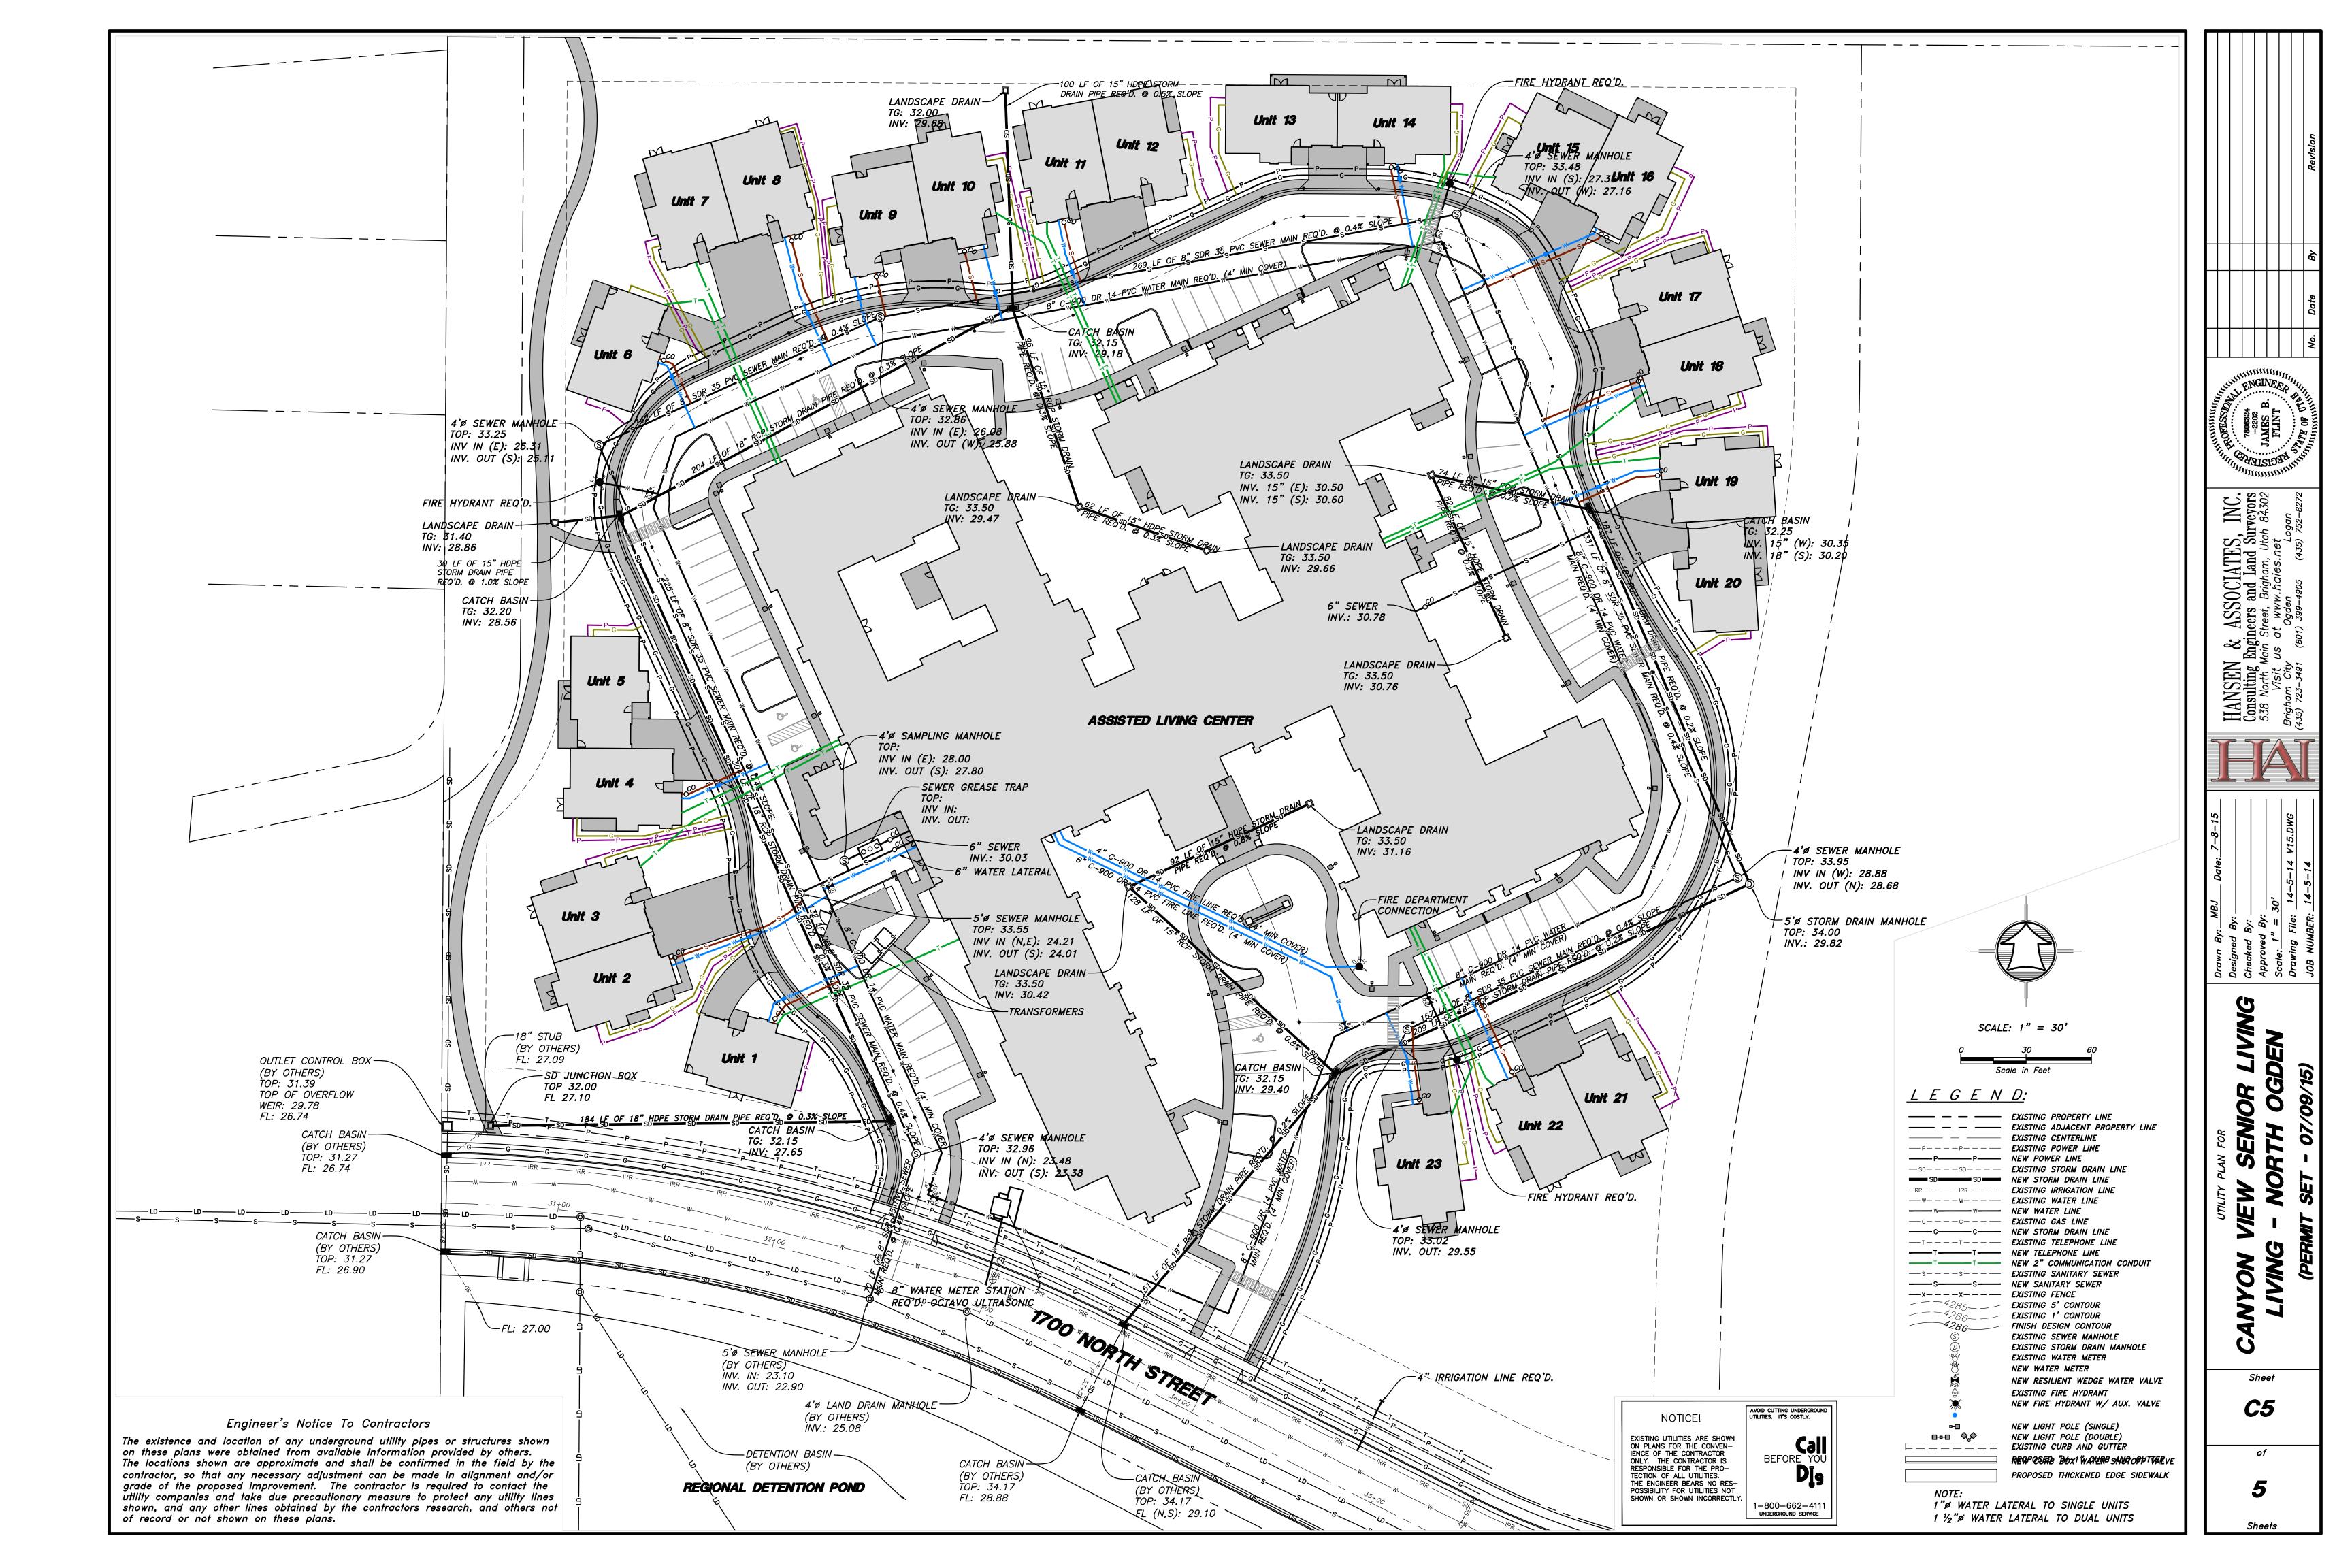


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TREE PLANTING WITH DOUBLE STAKES

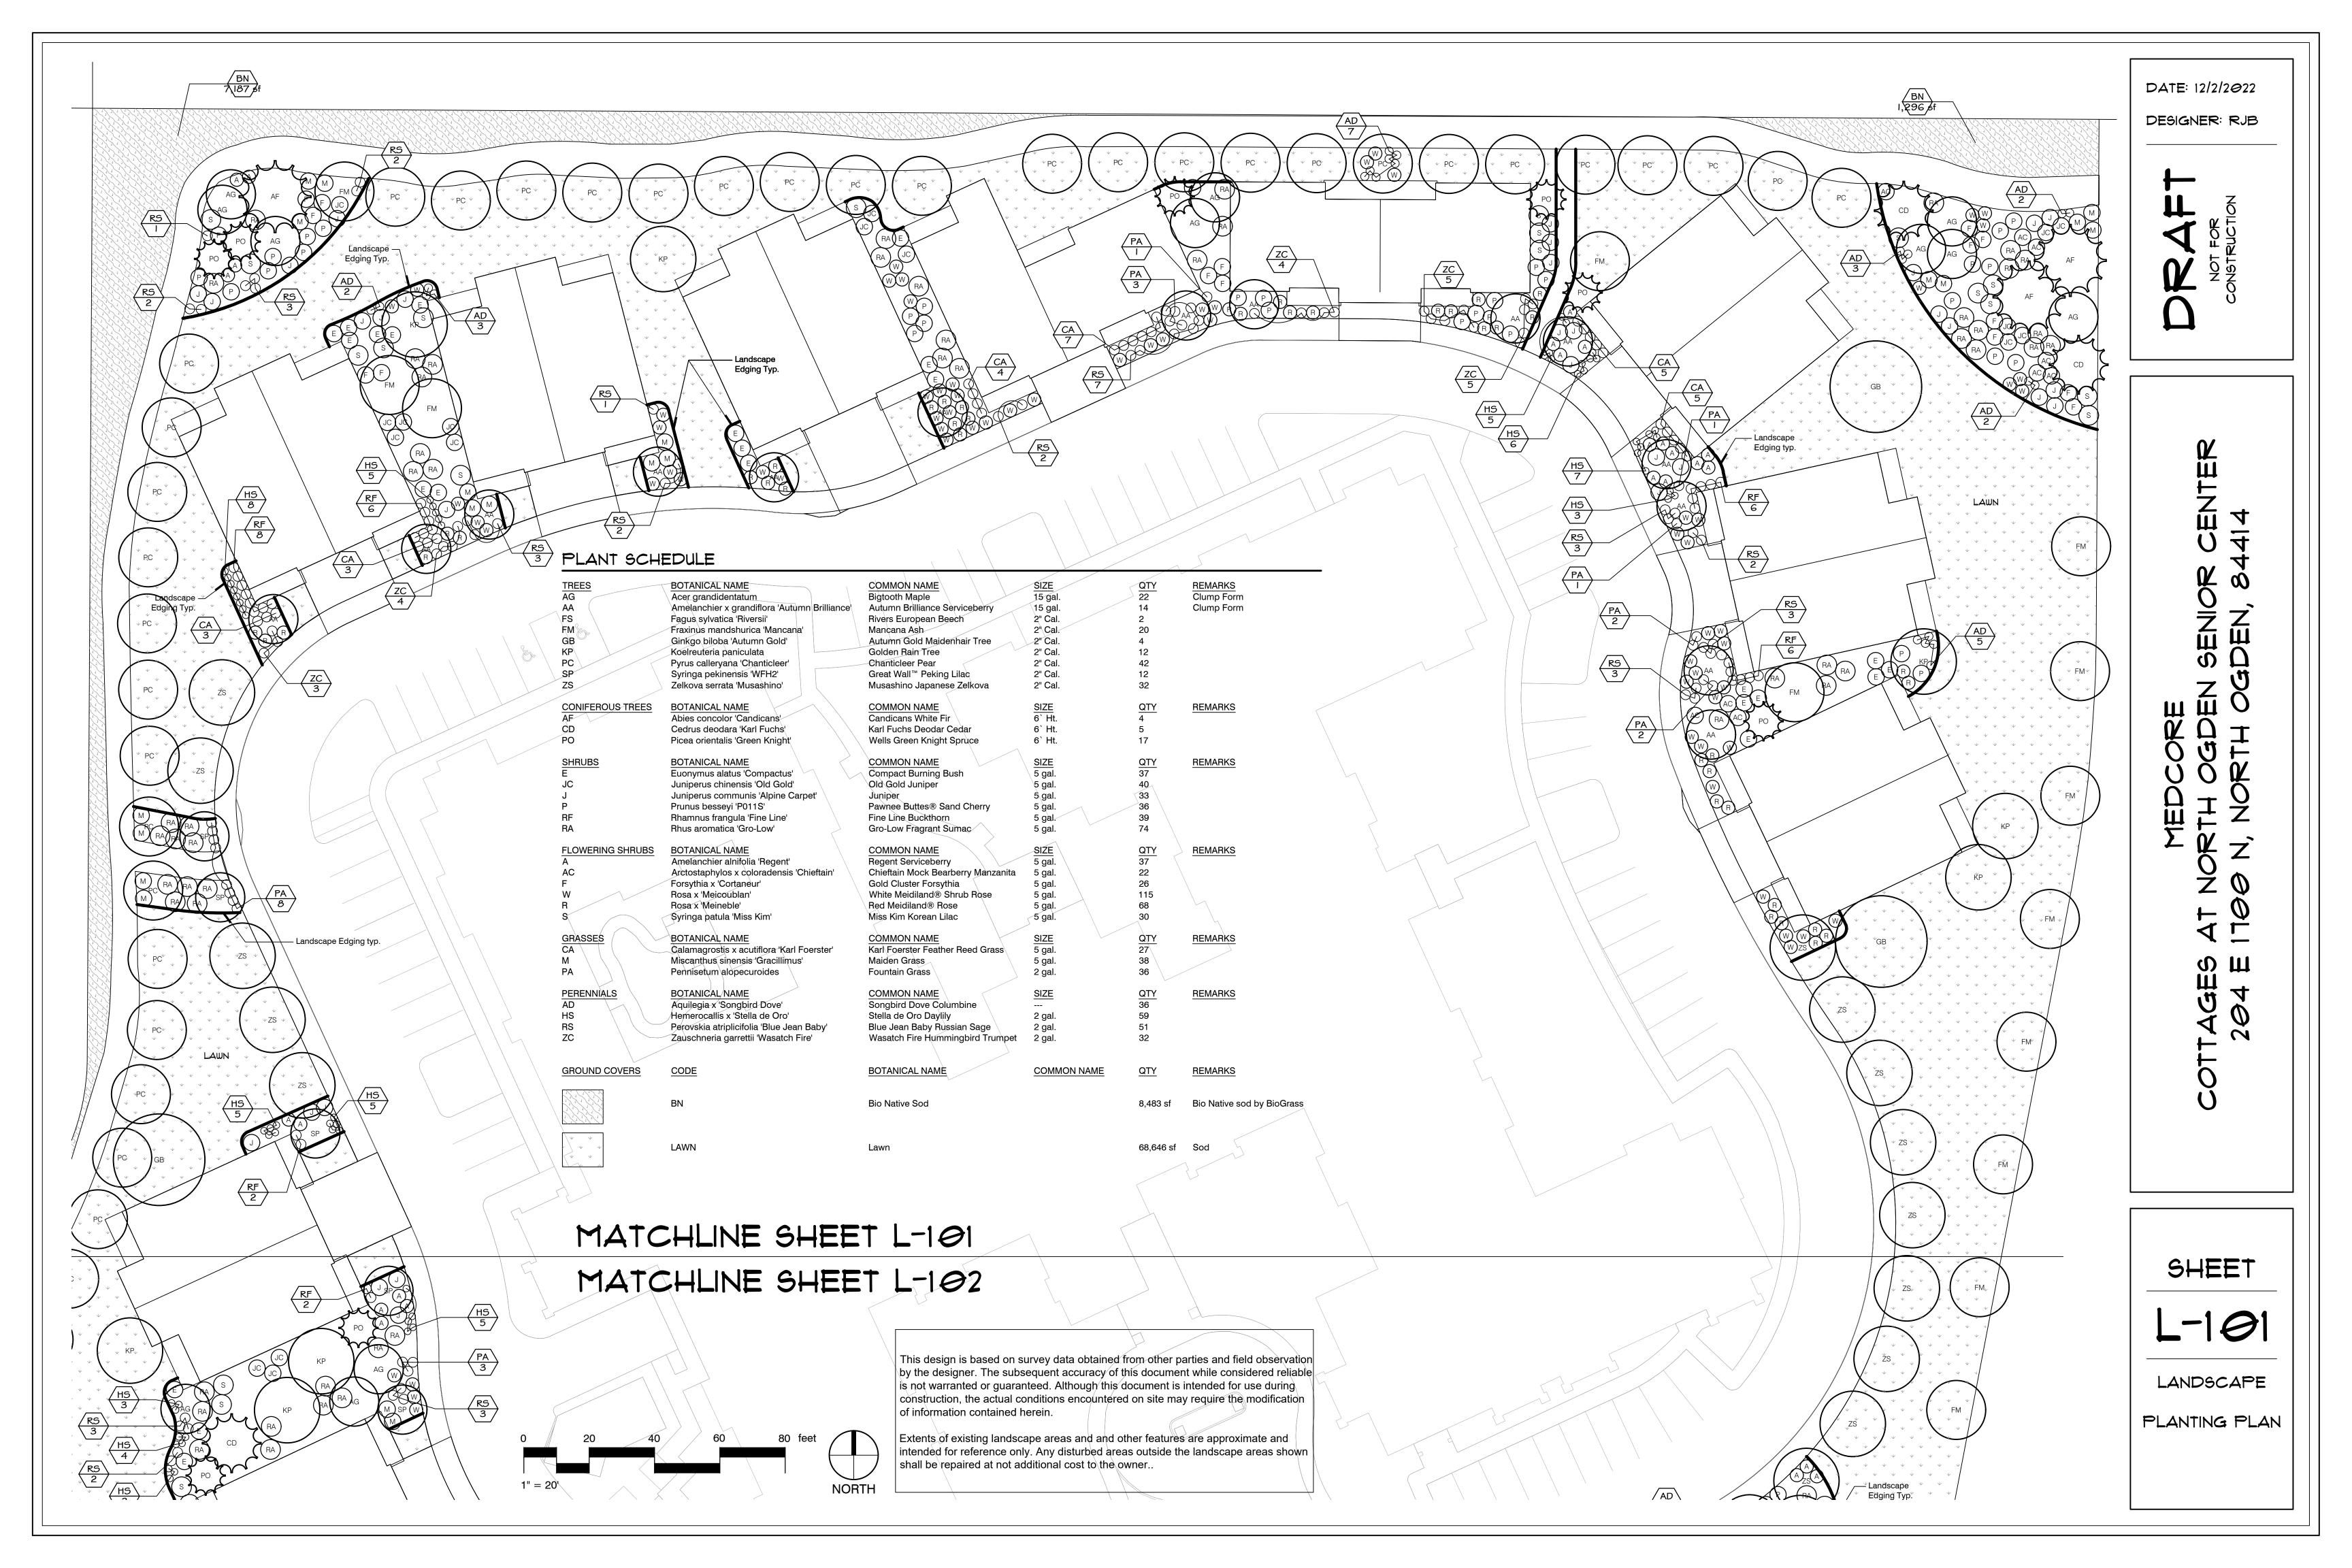P-NOC-11

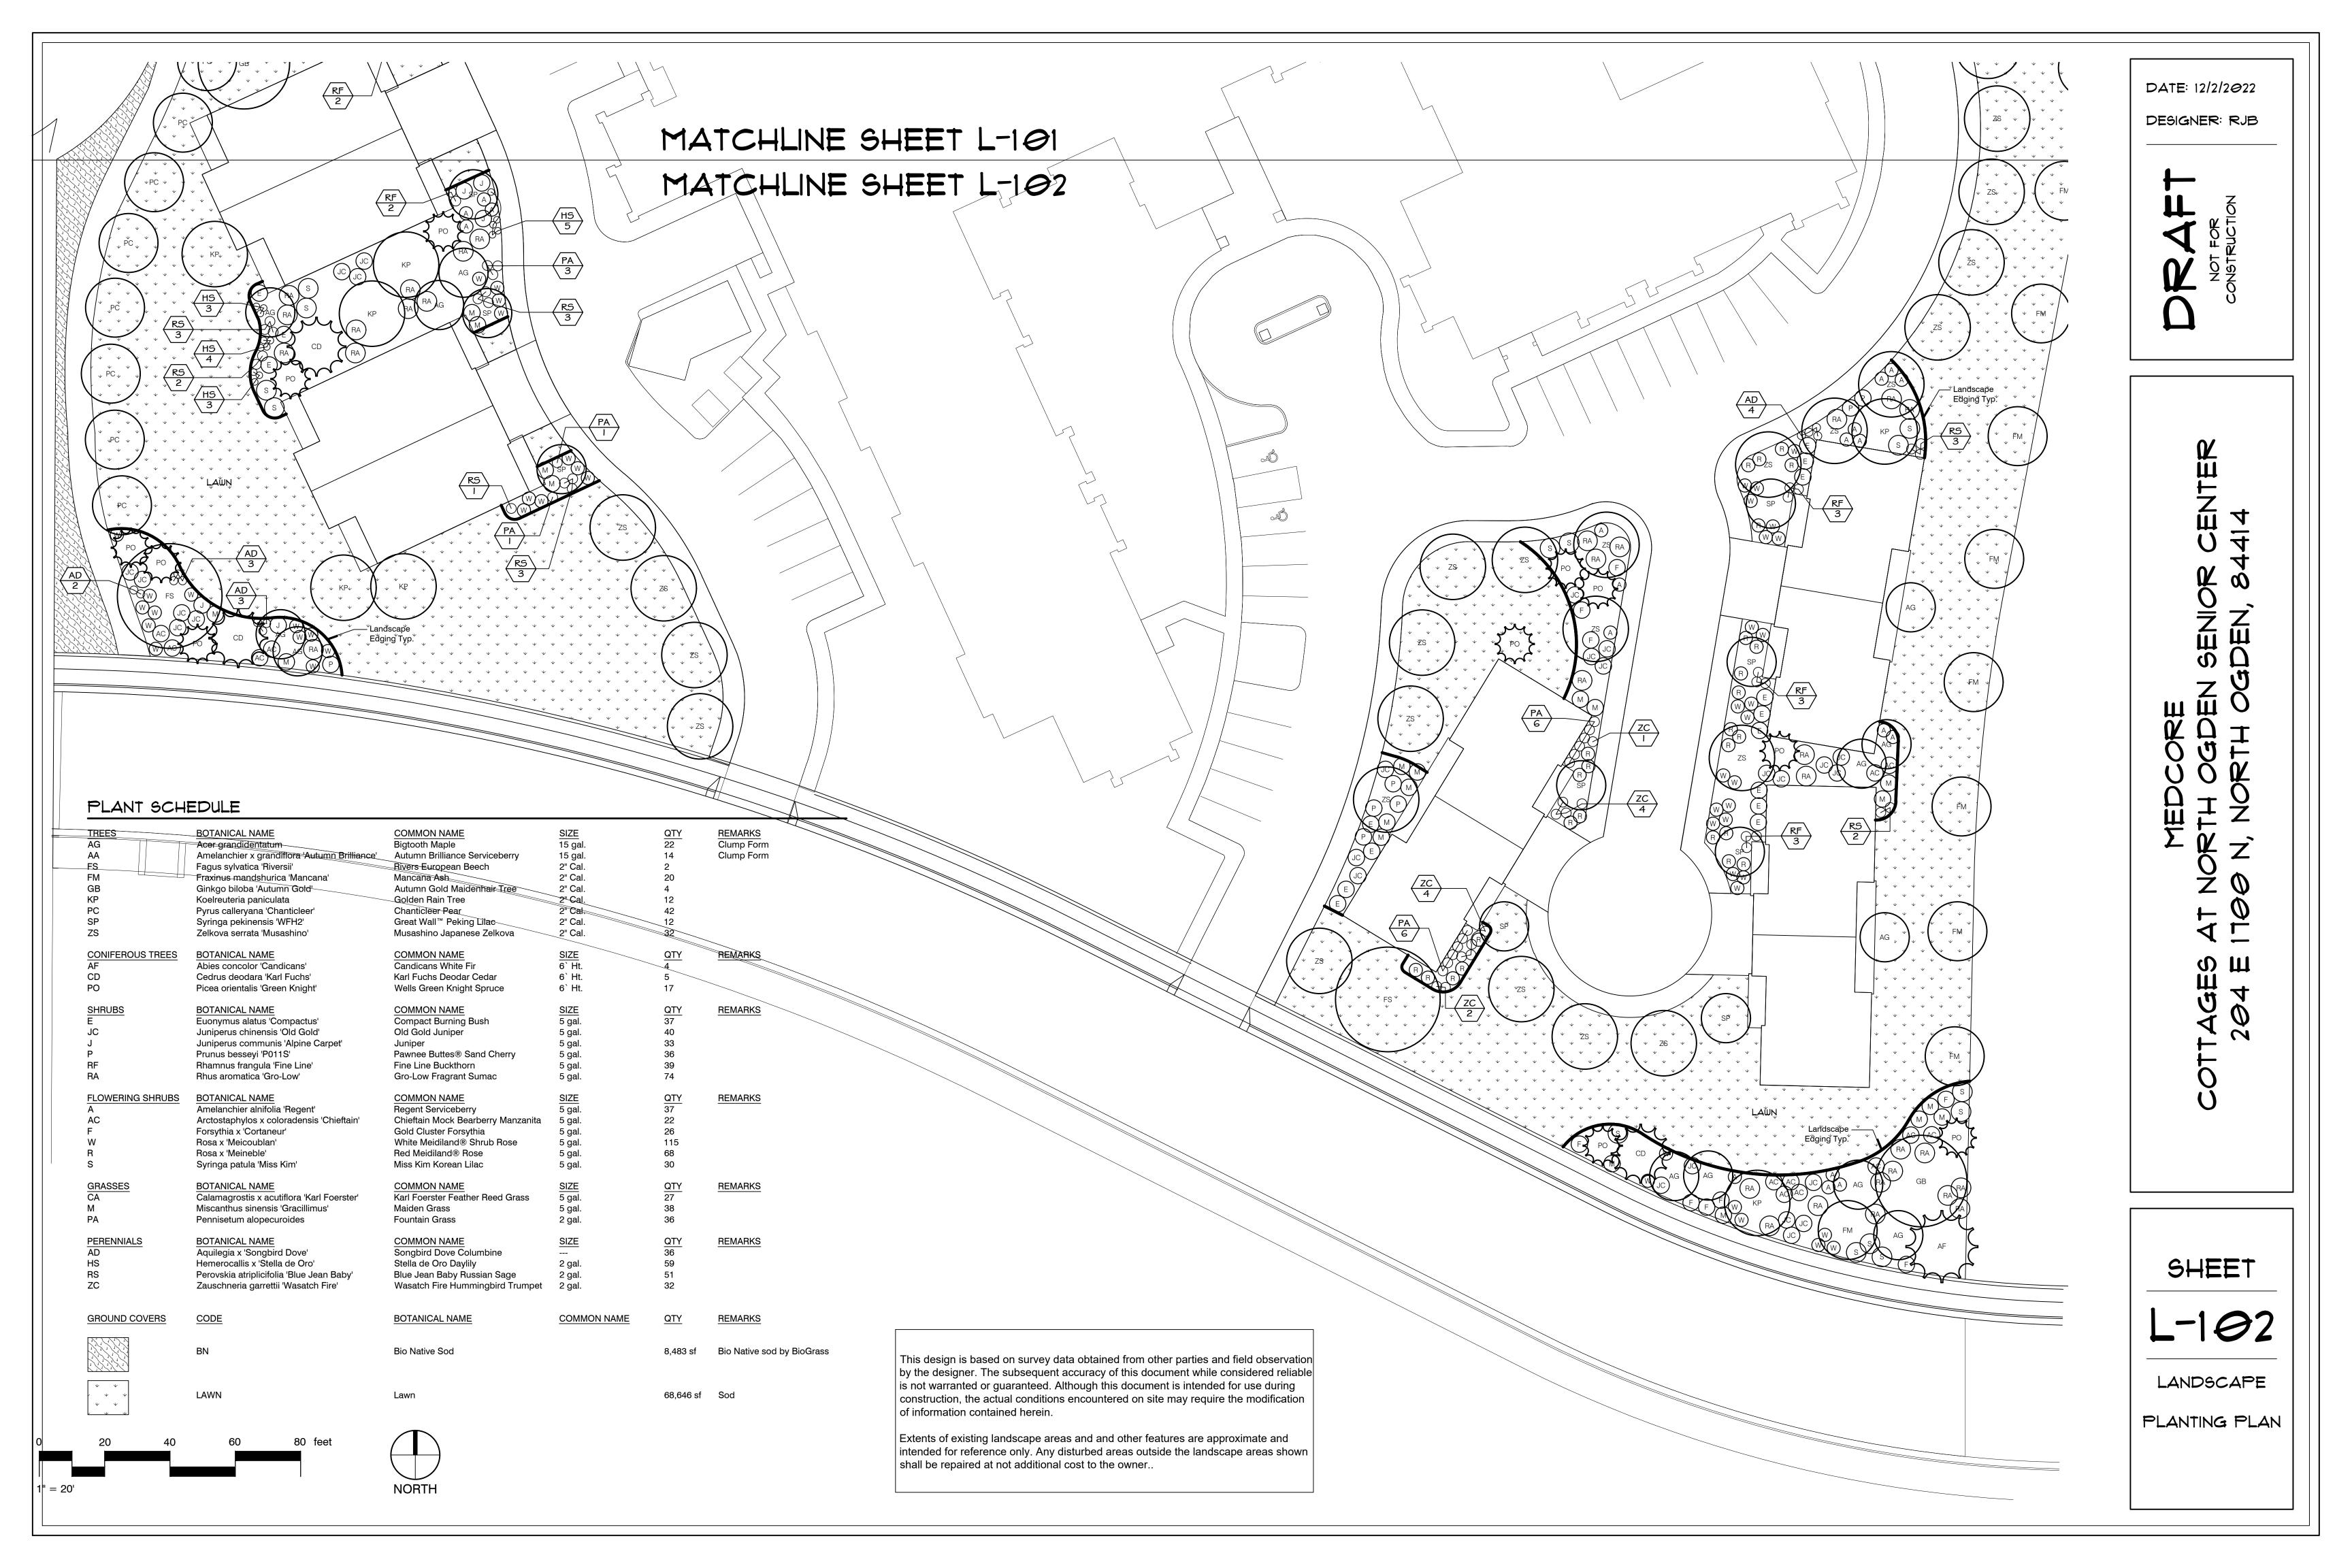Notes:

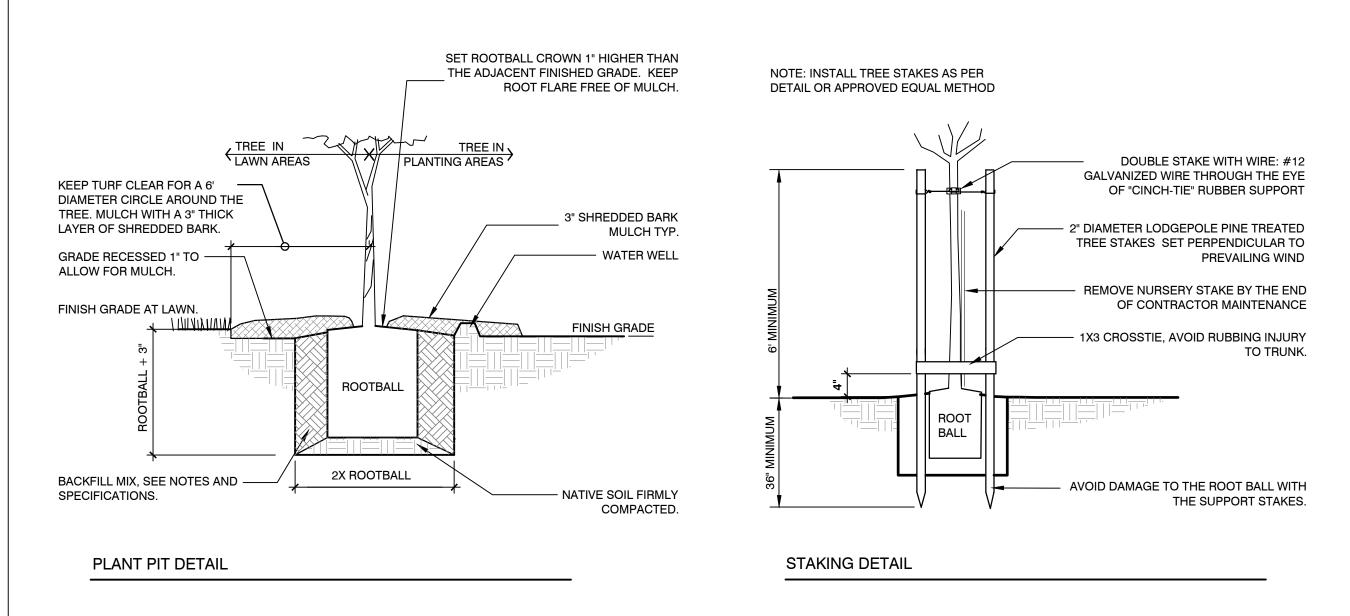The contractor shall examine the site conditions under which the work is to be performed and notify the Owner's Authorized Representative (OAR) in writing of any unsatisfactory conditions. Do not proceed until conditions have been rectified.

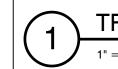The contractor shall coordinate with all other associated trades to best facilitate the progress of the project.

Before any excavation the contractor shall notify blue stakes and coordinate with the OAR for the location of all sleeves, conduits, utilities, etc.


The contractor is responsible for finish grade elevations in the landscape areas. Allow for and provide 3" shredded bark mulch in all landscape and planted areas. Trees planted in lawn areas shall be installed with a 6' diameter circle of shredded bark mulch. All mulched areas to receive weed barrier fabric.

All plant materials must meet sizes indicated in schedules. The OAR reserves the right to refuse plant materials which do not meet the quality required of the project or industry standards. All deciduous trees shall have full, well shaped heads and a single vertical leader when appropriate to species.

Lawn areas shall be irrigated with overhead spray placing heads with 85% coverage. All trees and shrubs shall be irrigated separately from lawn areas. Piping shall be sized to maintain velocities less than 5 feet per second. Zones shall be established to maintain the minimum operating pressure needed for all irrigation equipment.

All plant quantities are shown for convenience only. The contractor shall verify all quantities and provide plants necessary to complete the plantings as shown.


Amended topsoil is required - 6" minimum depth in all planting areas, 4" minimum depth for all sod areas, and as backfill for all plants.

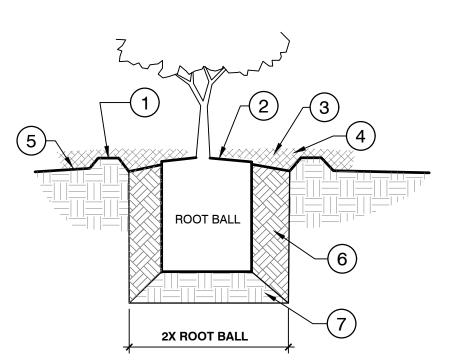

- 1) WATER WELL
- 4) 3" SHREDDED BARK MULCH TYP.
- SET ROOT BALL CROWN 1"

 HIGHER THAN SURROUNDING
 FINISHED GRADE. KEEP BASE OF
 SHRUB CLEAR OF MULCH.
 - 5 FINISH GRADE

 F 6 AMENDED TOPSOIL
- 3 SLOPE FINISHED GRADE AT BACKFILL AWAY FROM ROOT
- 7 NATIVE SOIL FIRMLY COMPACTED

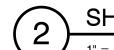

SHRUB PLANTING

P-NOC-07

DATE: 12/2/2022

DESIGNER: RJB



MEDCORE COTTAGES AT NORTH OGDEN SENIOR CENTER 204 E 1100 N, NORTH OGDEN, 84414

SHEET

L-103

LANDSCAPE

DETAILS \$ NOTES