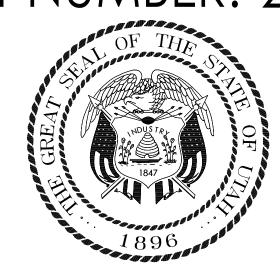
DFCM PROJECT NUMBER: 21147240



State of Utah - Department of Administrative Services

# DIVISION OF FACILITIES CONSTRUCTION AND MANAGEMENT

4110 State Office Building / Salt Lake City, Utah 84414/801-538-3018

# OWNER: UTAH STATE DFCM 4110 State Office Building Salt Lake City, UT 84114

Contact: Denise Austin, Project Manager

### OWNER:

OGDEN - WEBER TECHNICAL COLLEG 00 Washington Blvd. Ogden, UT 84404

Contact: Josh Ulm, Facilities Director Telephone: 801.627.8384

### ARCHITECT:

SANDERS ASSOCIATES ARCHITECTS 2668 Grant Ave. Suite 100 Ogden, UT 84401

Contact: M. Shane Sanders, AIA Telephone: 801.621.7303

## MECHANICAL:

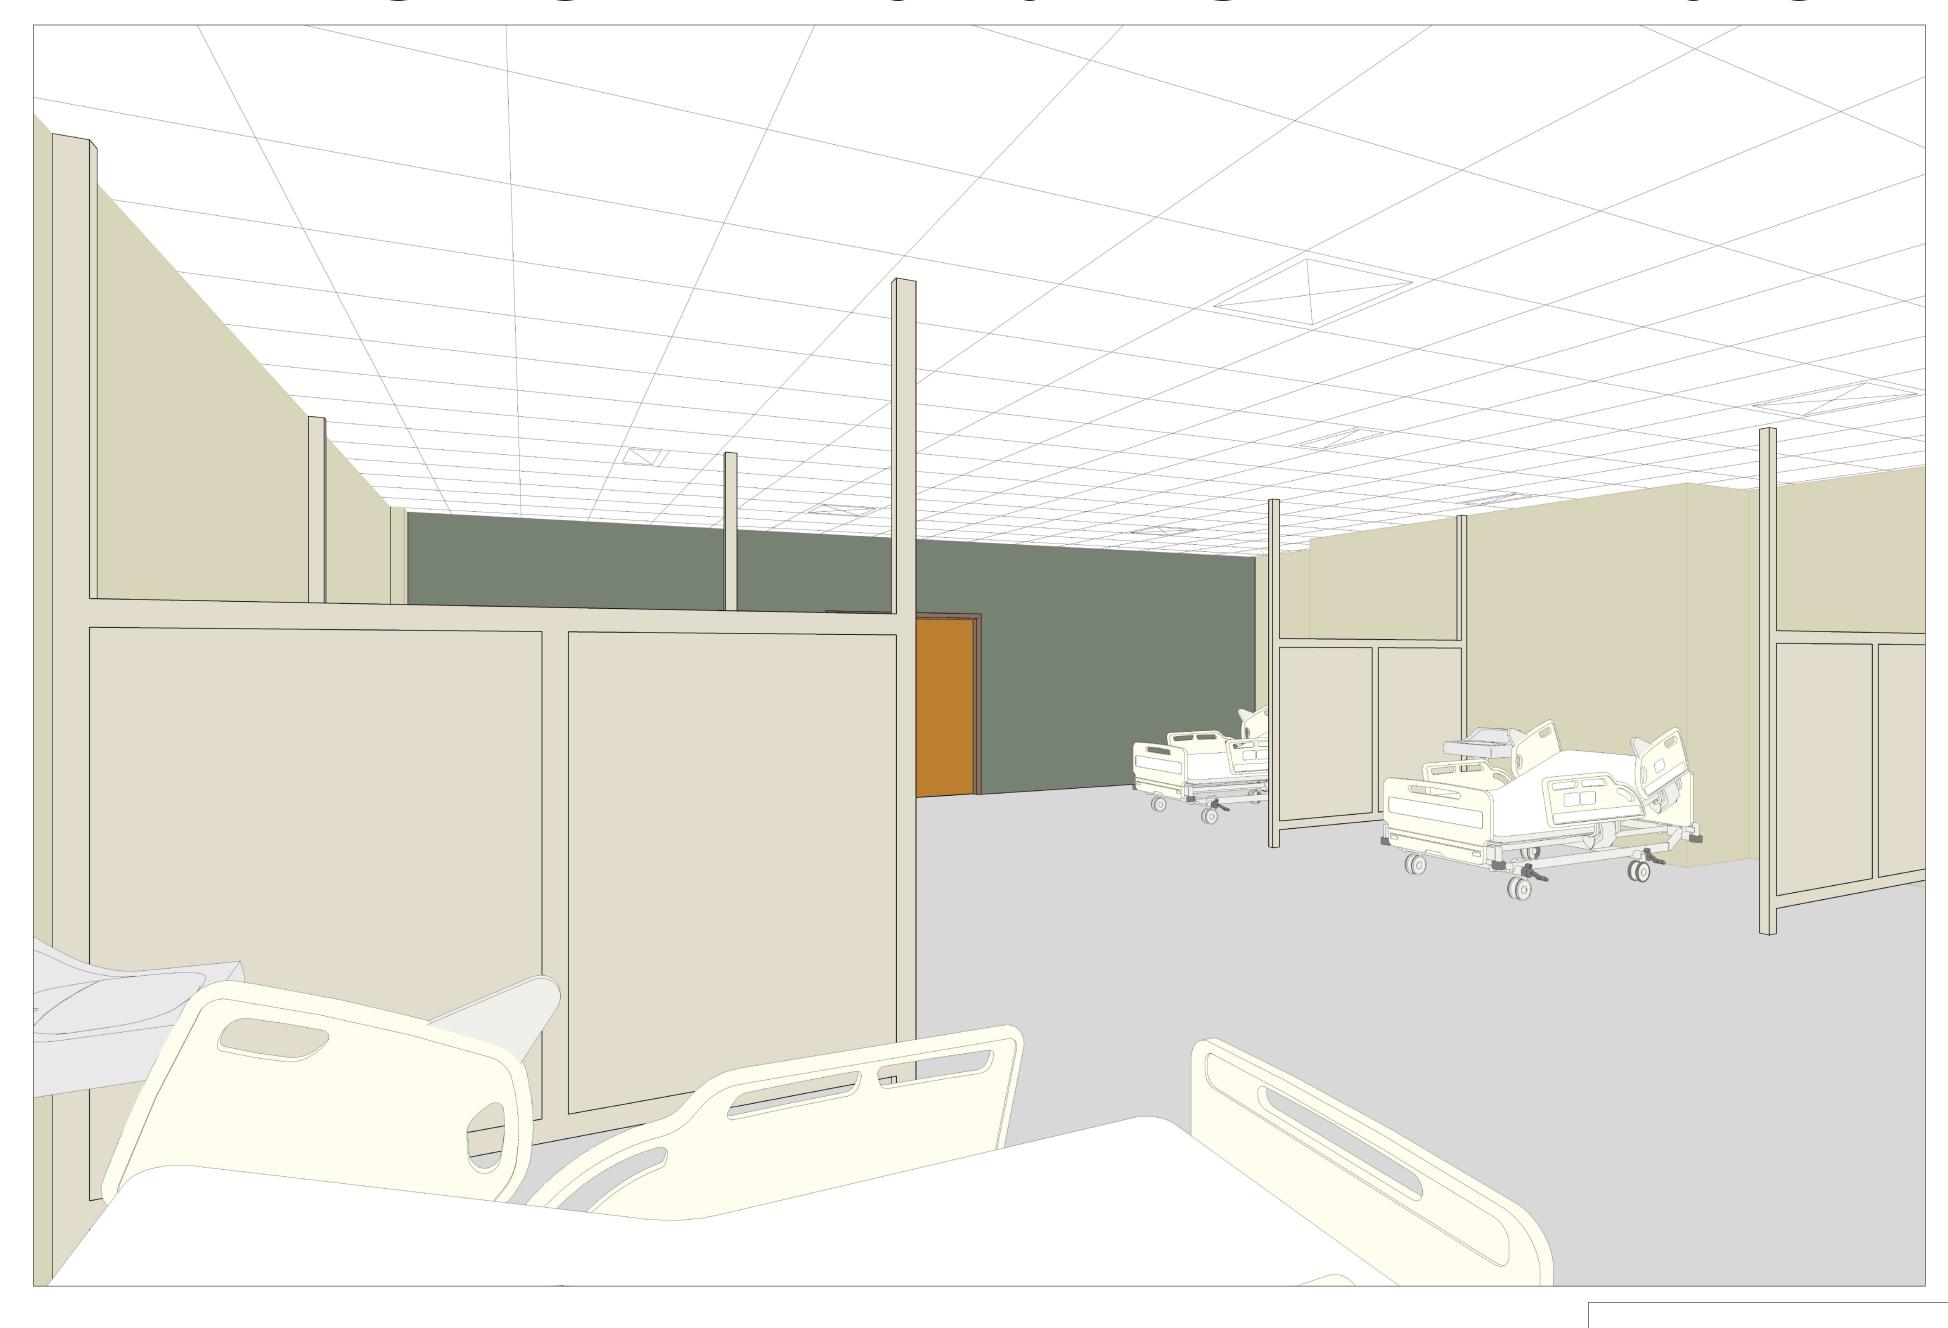
8619 Sandy Parkway #101 Sandy, UT 84070

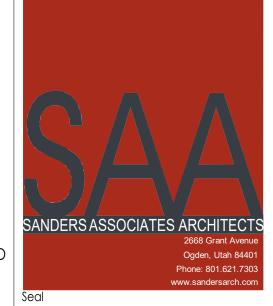
Contact: Win Packer, PE Telephone: 801.466.4021

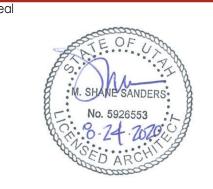
# ELECTRICAL:

635 South State Street Salt Lake City, UT 84111

Contact: Josh Oakeson, PE Telephone: 801.532.2196 OWTC HEALTH TECHNOLOGY PRACTICAL NURSING EXPANSION







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ALTH TECHNOLOGY NL NURSING EXPANSION

Issued

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DFCM Project No. 21147240

SAA Project No. 2020-16

Drawing Title

COVER SHEET

Sheet Number

G1001

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DRAWING INDEX

GENERAL INFORMATION

COVER SHEET

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AD102 DEMOLITION FLOOR PLAN LEVEL 2 AREA B AD103 DEMOLITION REFLECTED CEILING PLAN

AE102 LEVEL 2 AREA A

AE103 LEVEL 2 AREA B AE141 REFLECTED CEILING PLAN

AE161 FINISH FLOOR PLAN

AE441 INTERIOR ELEVATIONS

AE501 MILLWORK DETAILS AE601 DOOR SCHEDULE & FRAME TYPES

AE641 FINISH SCHEDULE AE661 PARTITION TYPES

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PE102.1 PLUMBING SEWER AND VENT FLOOR PLANS AREA A

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MD102.1 MECHANICAL PIPING LEVEL 2 DEMOLITION PLANS AREA A

MD102.2 MECHANICAL PIPING LEVEL 2 DEMOLITION PLANS AREA B ME101.1 MECHANICAL LEVEL 2 FLOOR PLANS AREA A

ME101.2 MECHANICAL LEVEL 2 FLOOR PLANS AREA B

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ELECTRICAL

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E301 LEVEL 02 AREA A POWER PLAN

E302 LEVEL 02 AREA B POWER PLAN

E401 LEVEL 02 AREA A SYSTEMS PLAN

E402 LEVEL 02 AREA B SYSTEMS PLAN E501 ELECTRICAL DIAGRAMS

#### MISCELLANEOUS GENERAL NOTES

1. THE PROJECT MANUAL, UNDER SEPARATE COVER, IS AN INTEGRAL PART OF THESE CONSTRUCTION DRAWINGS.

LOCATION OF THE INFORMATION ON THE DOCUMENTS.

- 2. PLANS, SECTIONS, ELEVATIONS, DETAILS AND DIMENSIONS LABELED "TYPICAL" SHALL APPLY TO ALL SITUATIONS OCCURRING THAT ARE THE SAME
- OR SIMILAR TO THOSE SPECIFICALLY NOTED ON THE DRAWINGS. 3. ALL WORK, MATERIALS, AND METHODS SHALL BE IN CONFORMANCE WITH
- THE CODES, ORDINANCES AND REGULATIONS OF ALL GOVERNMENTAL AGENCIES HAVING JURISDICTION AT THE PROJECT LOCATION. 4. CONTRACTORS ARE RESPONSIBLE FOR ALL WORK REGARDLESS OF THE
- 5. KEEP SITE CLEAN AND CLEAR OF DEBRIS AND IN ORDERLY CONDITION THAT DOES NOT DETRACT FROM THE SURROUNDING SITE AND REPAIR ANY DAMAGE CAUSED BY WORK OF THE CONTRACT.
- 6. Install sealant at exterior side of all joints, seams, connections  $\Box$ OR OPENINGS WHICH WOULD ALLOW WATER OR AIR INFILTRATION EXCEPT AS NOTED OTHERWISE. SEALANT COLOR TO MATCH ADJACENT SURFACE. COLOR REQUIRES ARCHITECTS APPROVAL.
- 7. ALL SPECIAL ACCESSIBLE FACILITIES SHALL BE IDENTIFIED WITH APPROVED
- SIGNAGE. 8. THE CONTRACTOR IS RESPONSIBLE FOR PRODUCING A WEATHER TIGHT BUILDING, DETAILS AND OMISSIONS TO DRAWINGS NOTWITHSTANDING. ALL DRAWING CONFLICTS WHICH MAY NOT ALLOW A WEATHERTIGHT
- CONDITION SHALL BE BROUGHT TO THE ATTENTION OF THE ARCHITECT. 9. DISCREPANCIES BETWEEN ACTUAL CONDITIONS AND PLANS SHALL BE BROUGHT TO THE ATTENTION OF THE ARCHITECT. CONTRACTOR SHALL SUBMIT SPECIFIC DISCREPANCIES FOR ARCHITECT REVIEW.
- 10. PROVIDE FULL METAL BACKING PLATE (16 GAUGE X 6" HIGH SECURED TO 3 STUDS MIN.) OR WOOD BLOCKING AS REQUIRED TO SECURELY ANCHOR ALL WALL MOUNTED EQUIPMENT (CABINETS, TOILET ROOM ACCESSORIES, HARDWARE, ETC.). BLOCKING SHALL PROVIDE A RIGID CONNECTION CAPABLE OF SUPPORTING DESIGN LOADS. PROVIDE A 16 GAUGE X 6" STL. STUD/TRACK SECURED TO 2 STUDS TO SECURELY SUPPORT ALL WALL STOPS (DOOR BUMPER).
- 11. COORDINATE WITH ALL TRADES, SIZES AND LOCATIONS OF ALL OPENINGS FOR MECHANICAL, PLUMBING AND ELECTRICAL EQUIPMENT, EQUIPMENT PADS OR BASES, AS WELL AS ELECTRIC POWER, WATER, AND DRAIN INSTALLATIONS, BEFORE PROCEEDING WITH WORK. CONTRACTOR SHALL PROVIDE COORDINATION DRAWINGS FOR PROPER PLACEMENT OF ALL TRADES' WORK, ANY CONCERNS, SPACE LIMITATIONS OR STRUCTURAL CONFLICTS, SHALL BE BROUGHT TO THE ATTENTION OF THE ARCHITECT. A REASONABLE RESPONSE TIME SHALL BE ALLOWED AS NOTED IN THE
- SPECIFICATIONS. 12. ALL FLOOR OR WALL OPENINGS REQUIRED FOR PIPES, DUCTS, CONDUITS, ETC. SHALL BE SEALED IN AN APPROVED MANNER.

13. FIRE SPRINKLER DESIGN TO BE DONE BY A CERTIFIED SUB-CONTRACTOR

INDICATES THAT THE CONTRACTOR HAS REVIEWED AND COORDINATED FIRE-SPRINKLER PIPING LOCATIONS WITH ALL TRADES. 14. ROOMS ENCLOSED WITH RATED WALLS REQUIRE RATED DOORS. ANY DUCTS PASSING THROUGH WALLS REQUIRE FIRE DAMPERS AND OR FIRE/SMOKE

PRIOR TO SUBMITTAL TO ARCHITECT. SUBMITTAL TO THE ARCHITECT ALSO

- DAMPERS. ANY CONDUIT OR PIPING REQUIRES RATED SEALANT AT JOINTS. 15. IT IS THE CONTRACTOR'S RESPONSIBILITY TO COORDINATE AND LOCATE ELECTRICAL, DATA AND PHONE RECEPTACLES, SWITCHES, ETC. TO AVOID
- CASEWORK DOORS, ETC. 16. THE DRAWINGS AND SPECIFICATIONS INDICATE THE GENERAL SCOPE OF THE PROJECT IN TERMS OF THE ARCHITECTURAL AND STRUCTURAL DESIGN CONCEPT. THE DIMENSIONS OF THE BUILDING, THE TYPE OF STRUCTURAL, MECHANICAL, ELECTRICAL AND UTILITY SYSTEMS AND MAJOR
- ARCHITECTURAL ELEMENTS OF CONSTRUCTION AS "SCOPE" DOCUMENTS. 17. THE DRAWINGS AND SPECIFICATIONS DO NOT NECESSARILY INDICATE OR DESCRIBE ALL WORK REQUIRED FOR THE FULL PERFORMANCE AND COMPLETION OF THE WORK. CONTRACTS SHALL BE LET ON THE BASIS OF SUCH DOCUMENTS, WITH THE UNDERSTANDING THAT THE CONTRACTOR IS TO FURNISH ALL ITEMS REQUIRED FOR PROPER COMPLETION OF THE WORK WITH OUT ADJUSTMENT TO CONTRACT PRICE. IT IS INTENDED THAT THE WORK TO BE OF SOUND AND QUALITY CONSTRUCTION AND THE CONTRACTOR SHALL BE SOLELY RESPONSIBLE FOR THE INCLUSION OF ADEQUATE AMOUNTS TO COVER INSTALLATION OF ALL ITEMS INDICATED. DESCRIBED OR REASONABLY IMPLIED.





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GENERAL INFORMATION

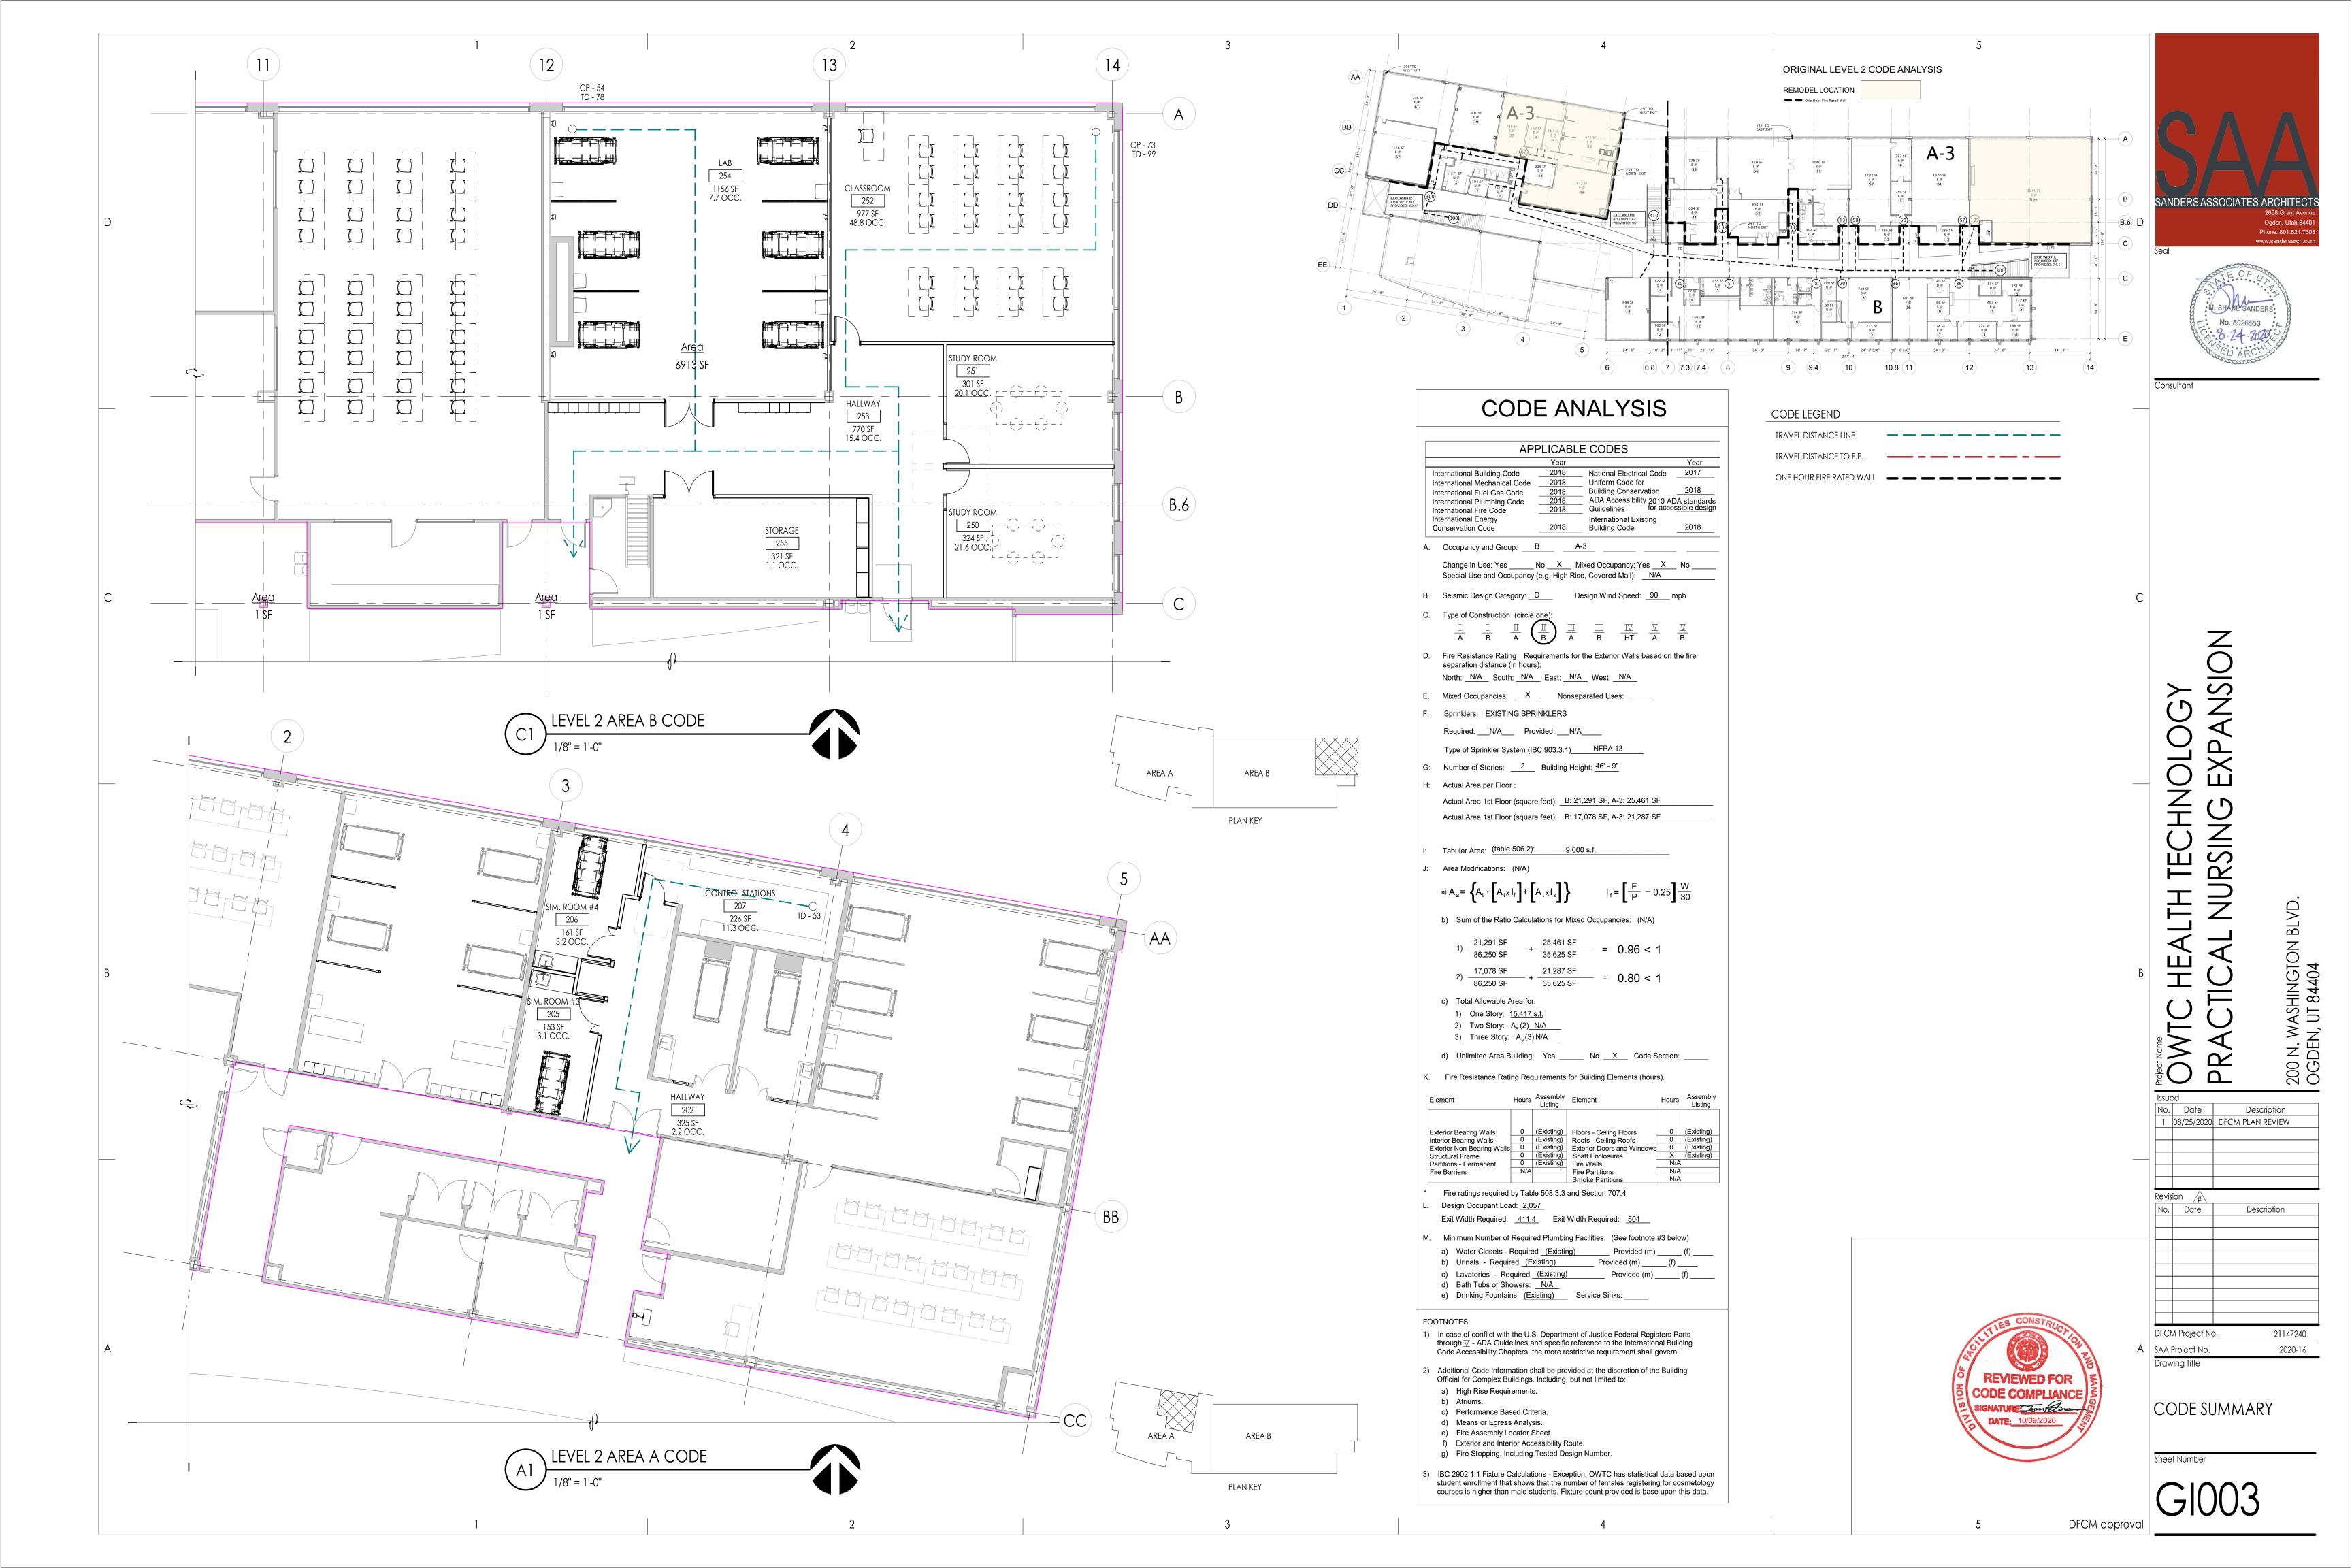
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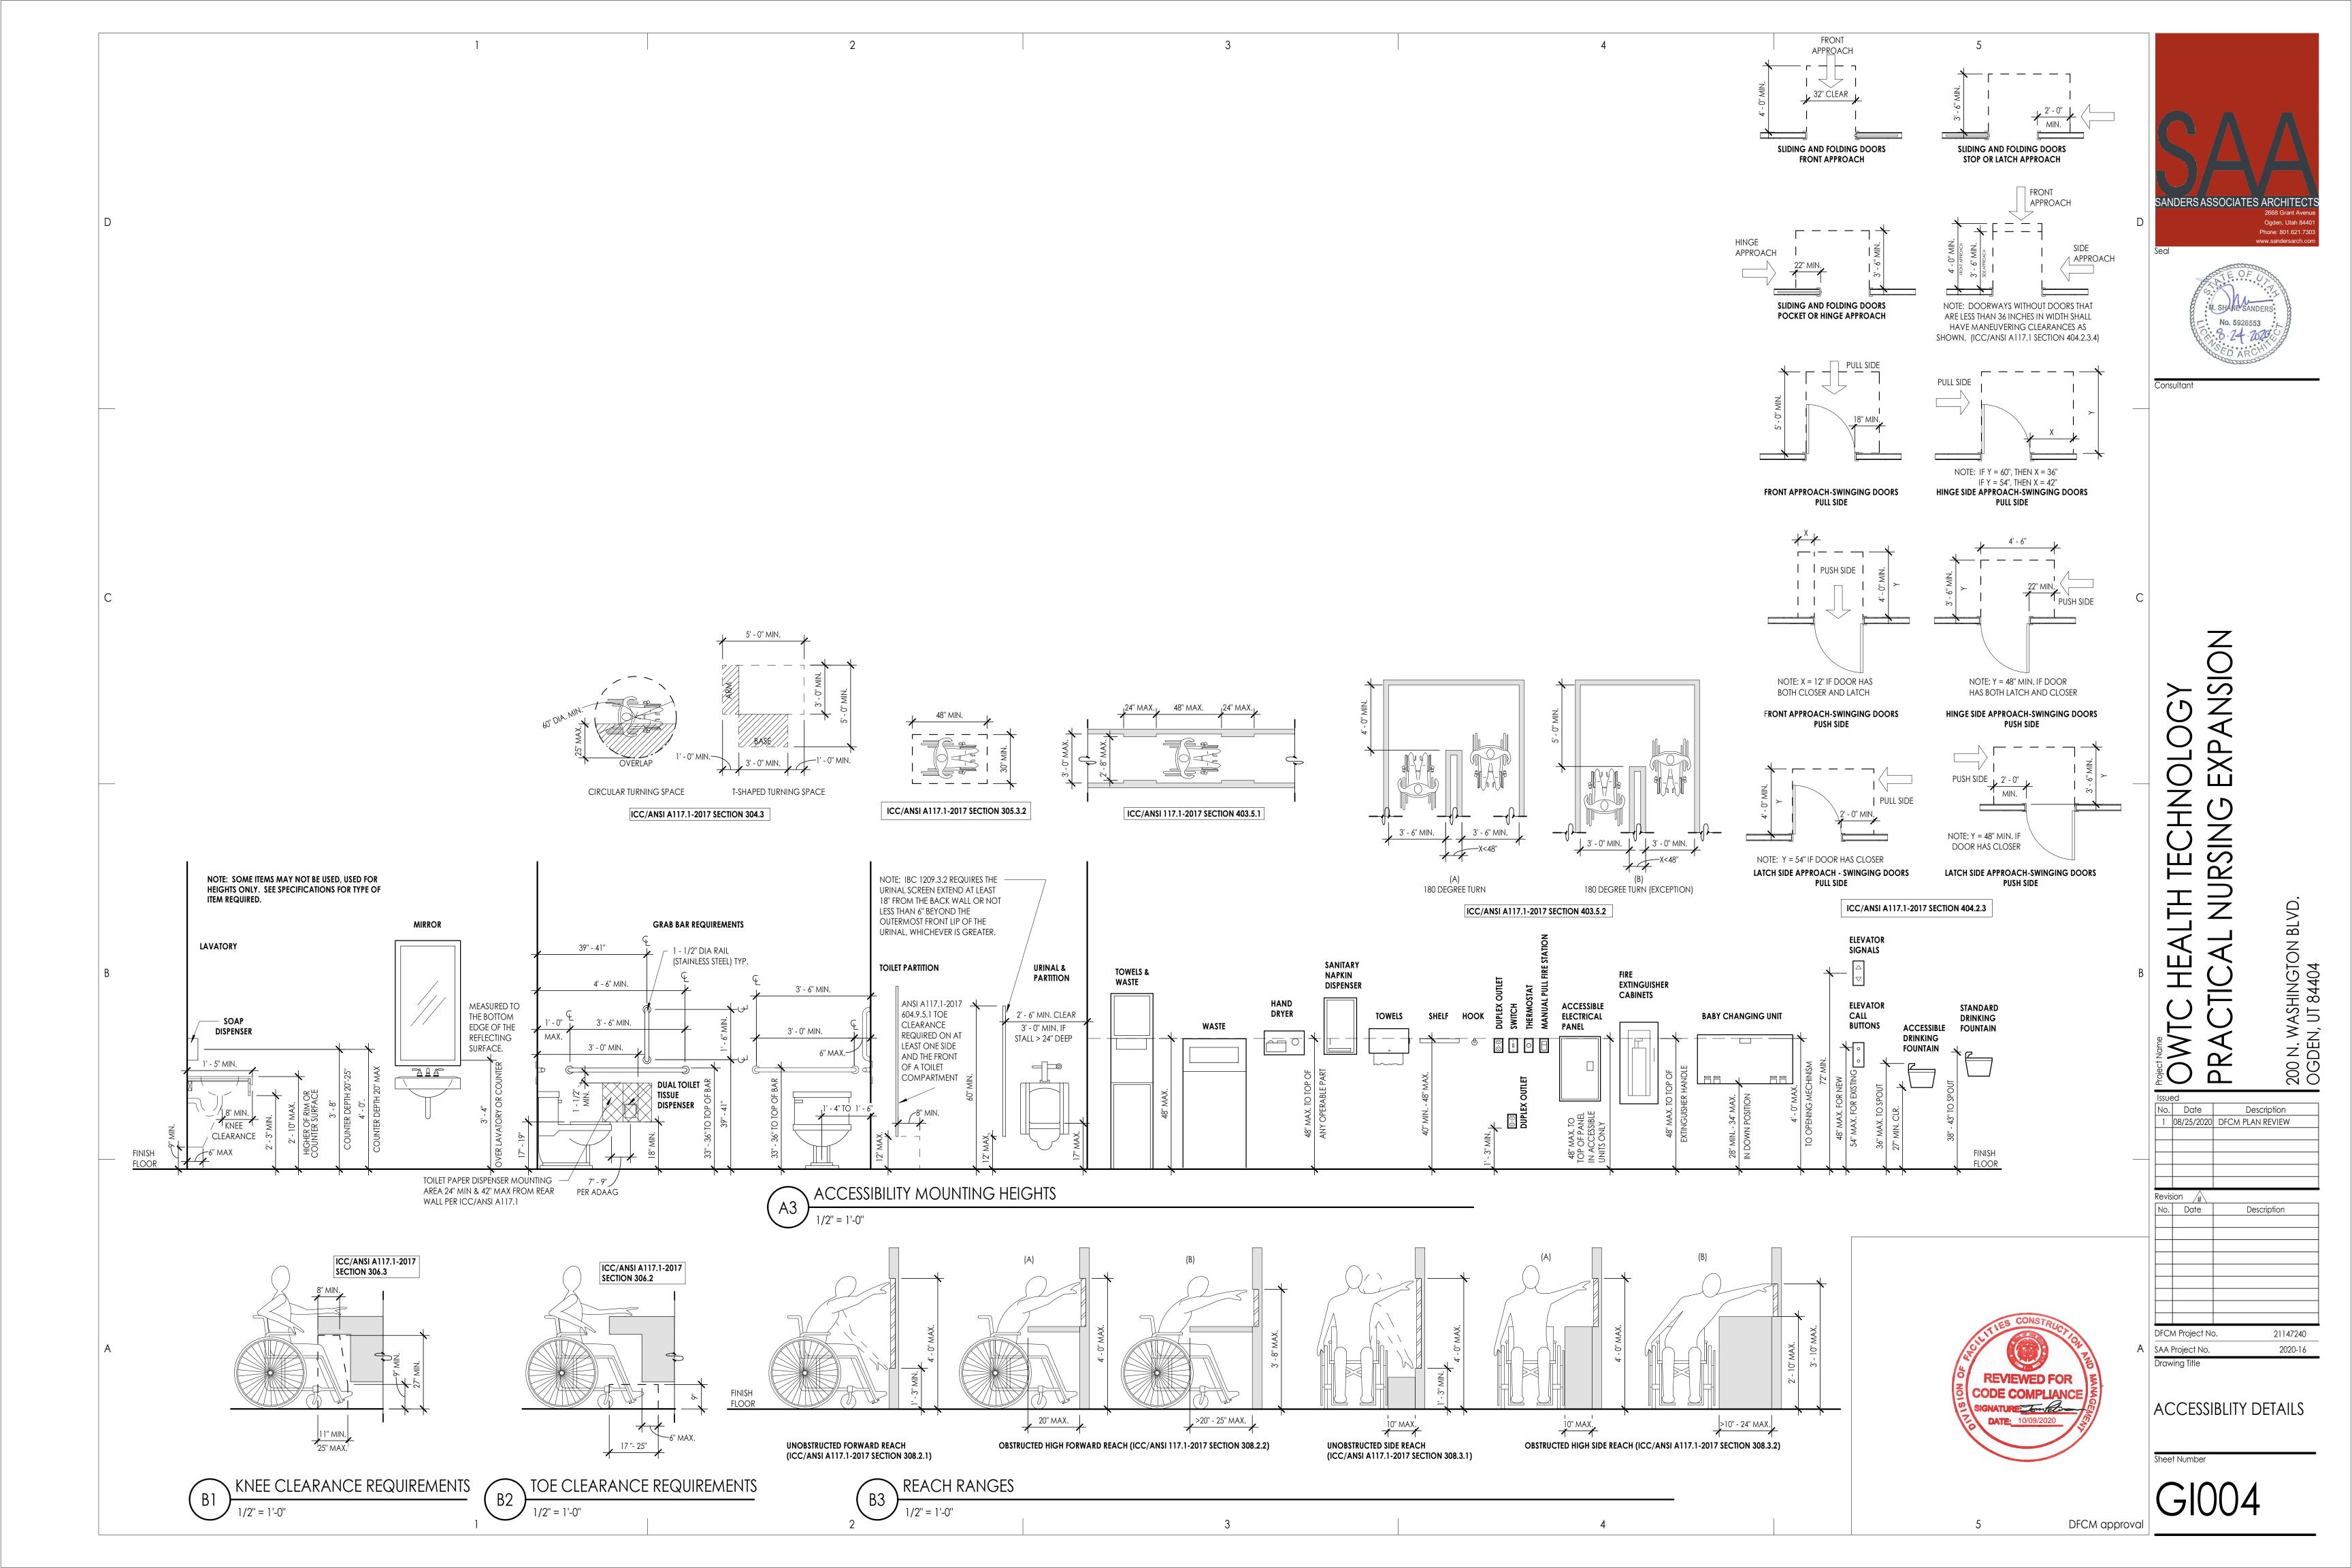
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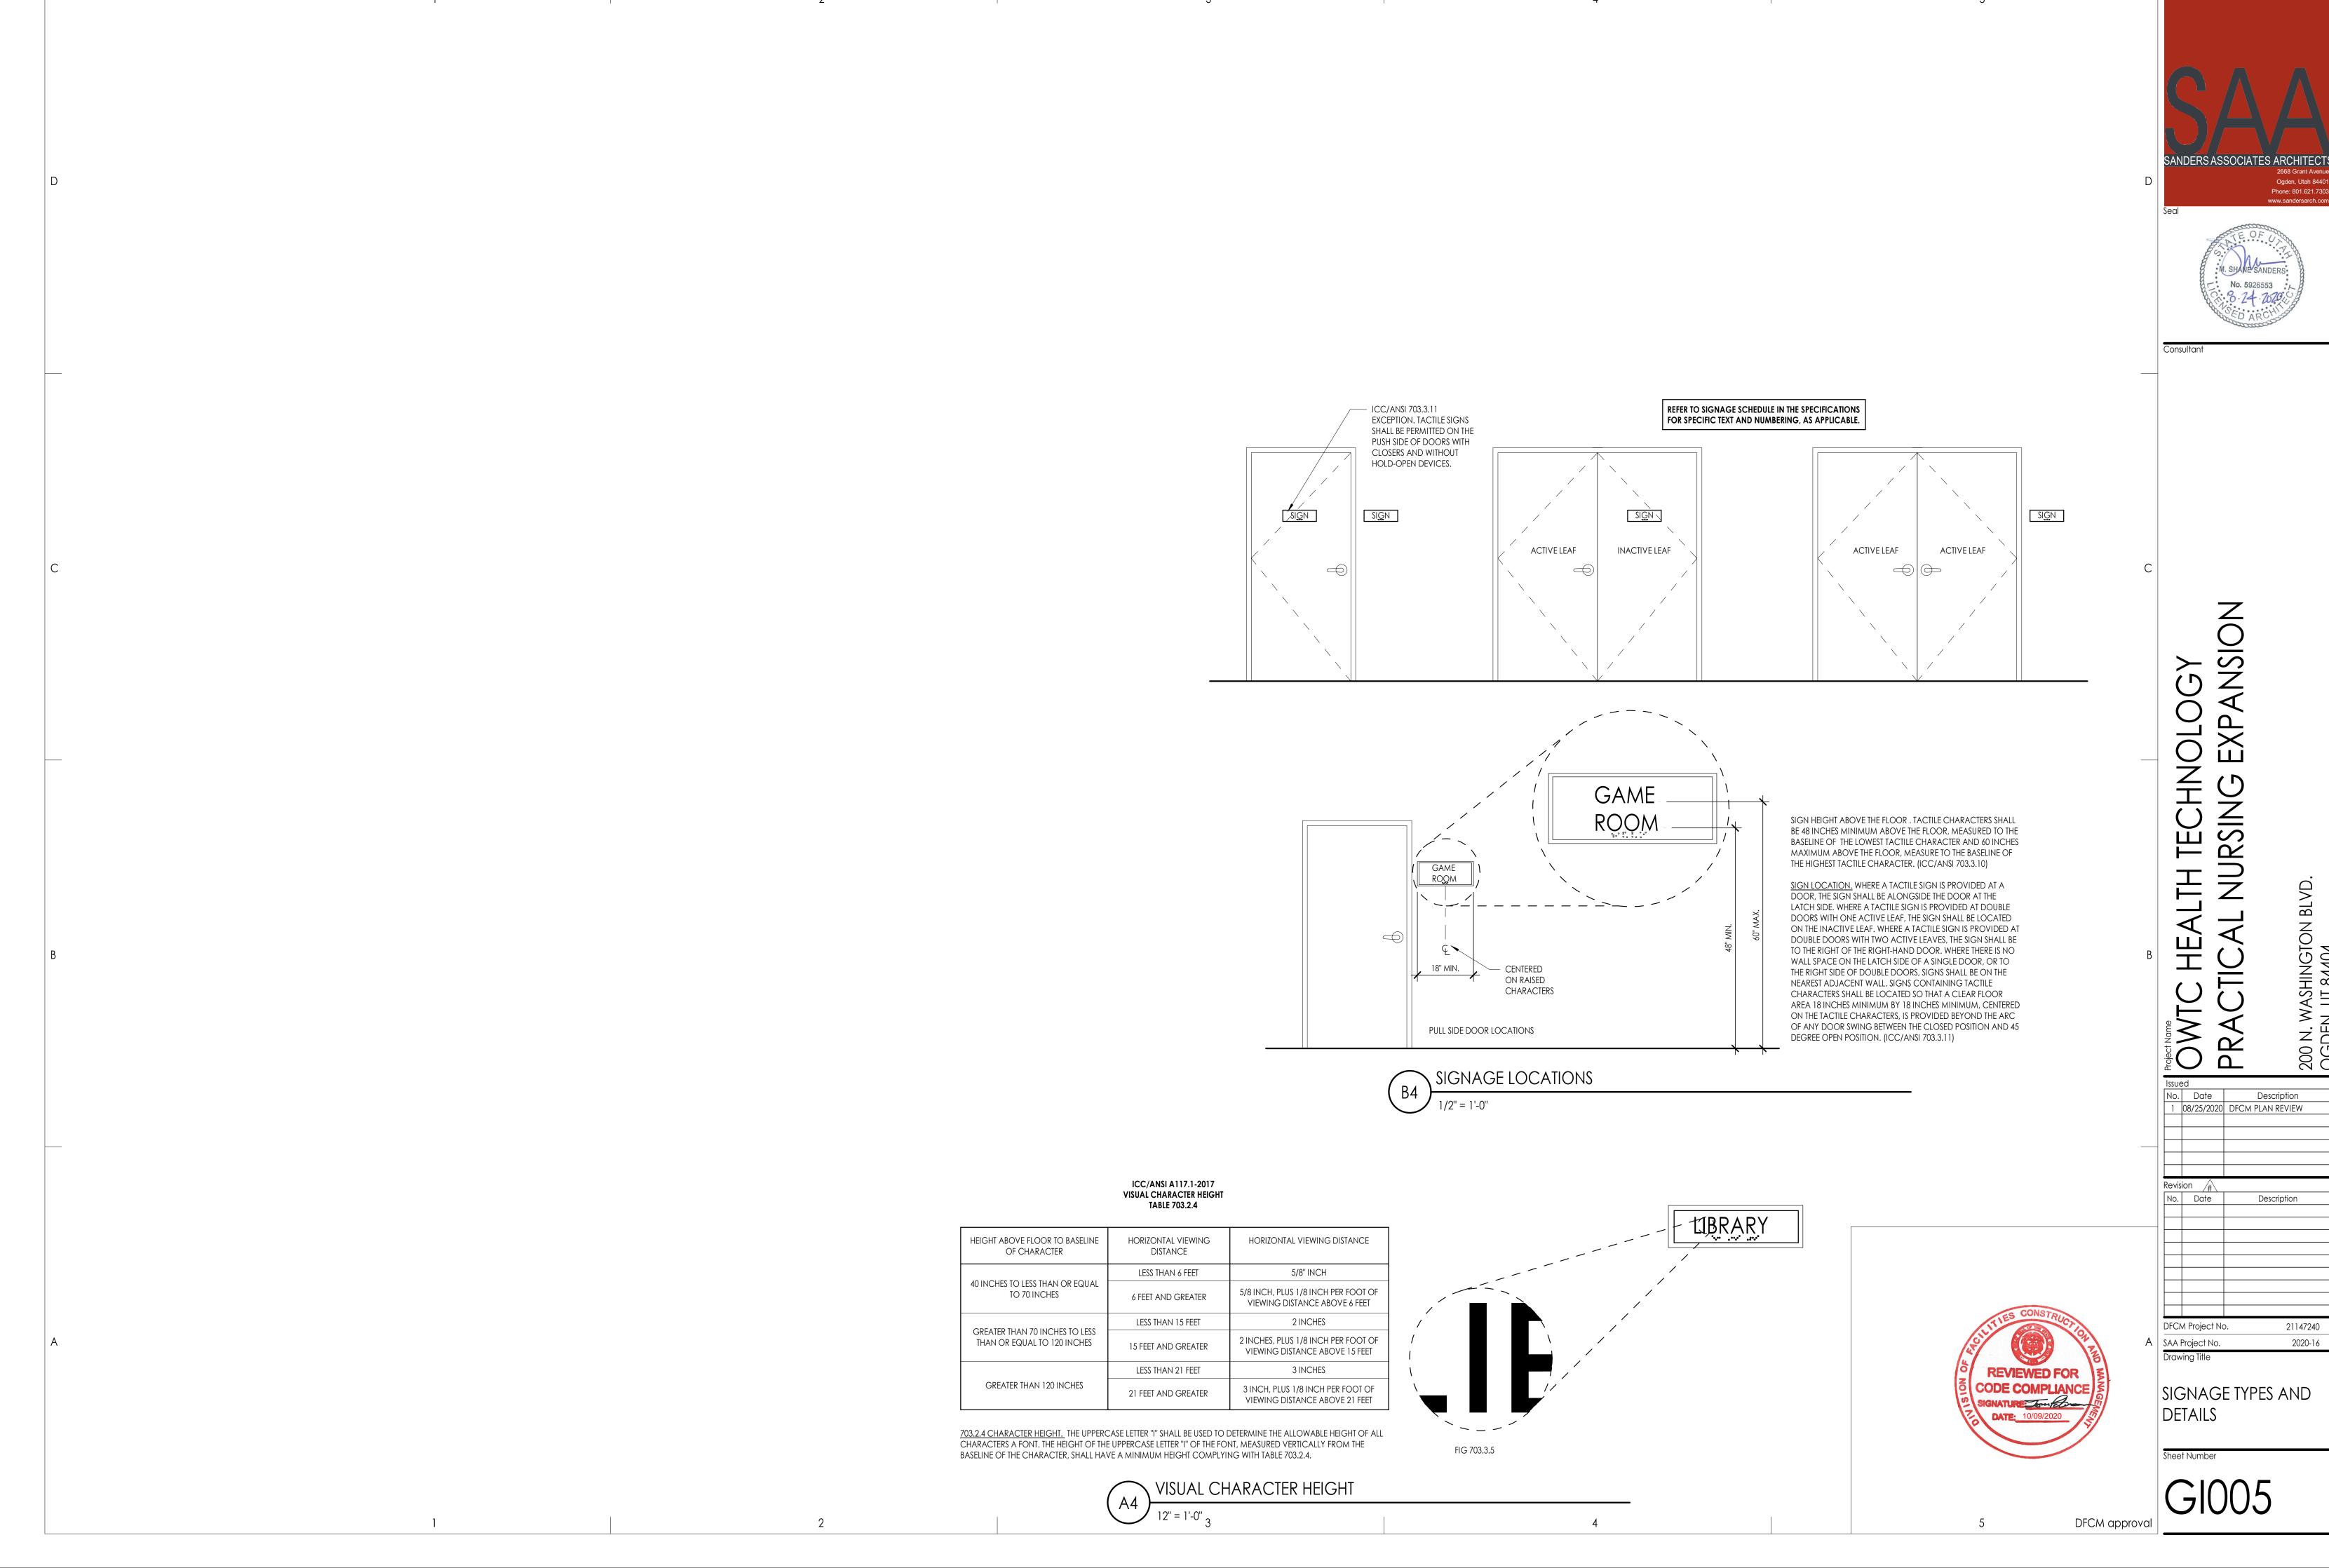
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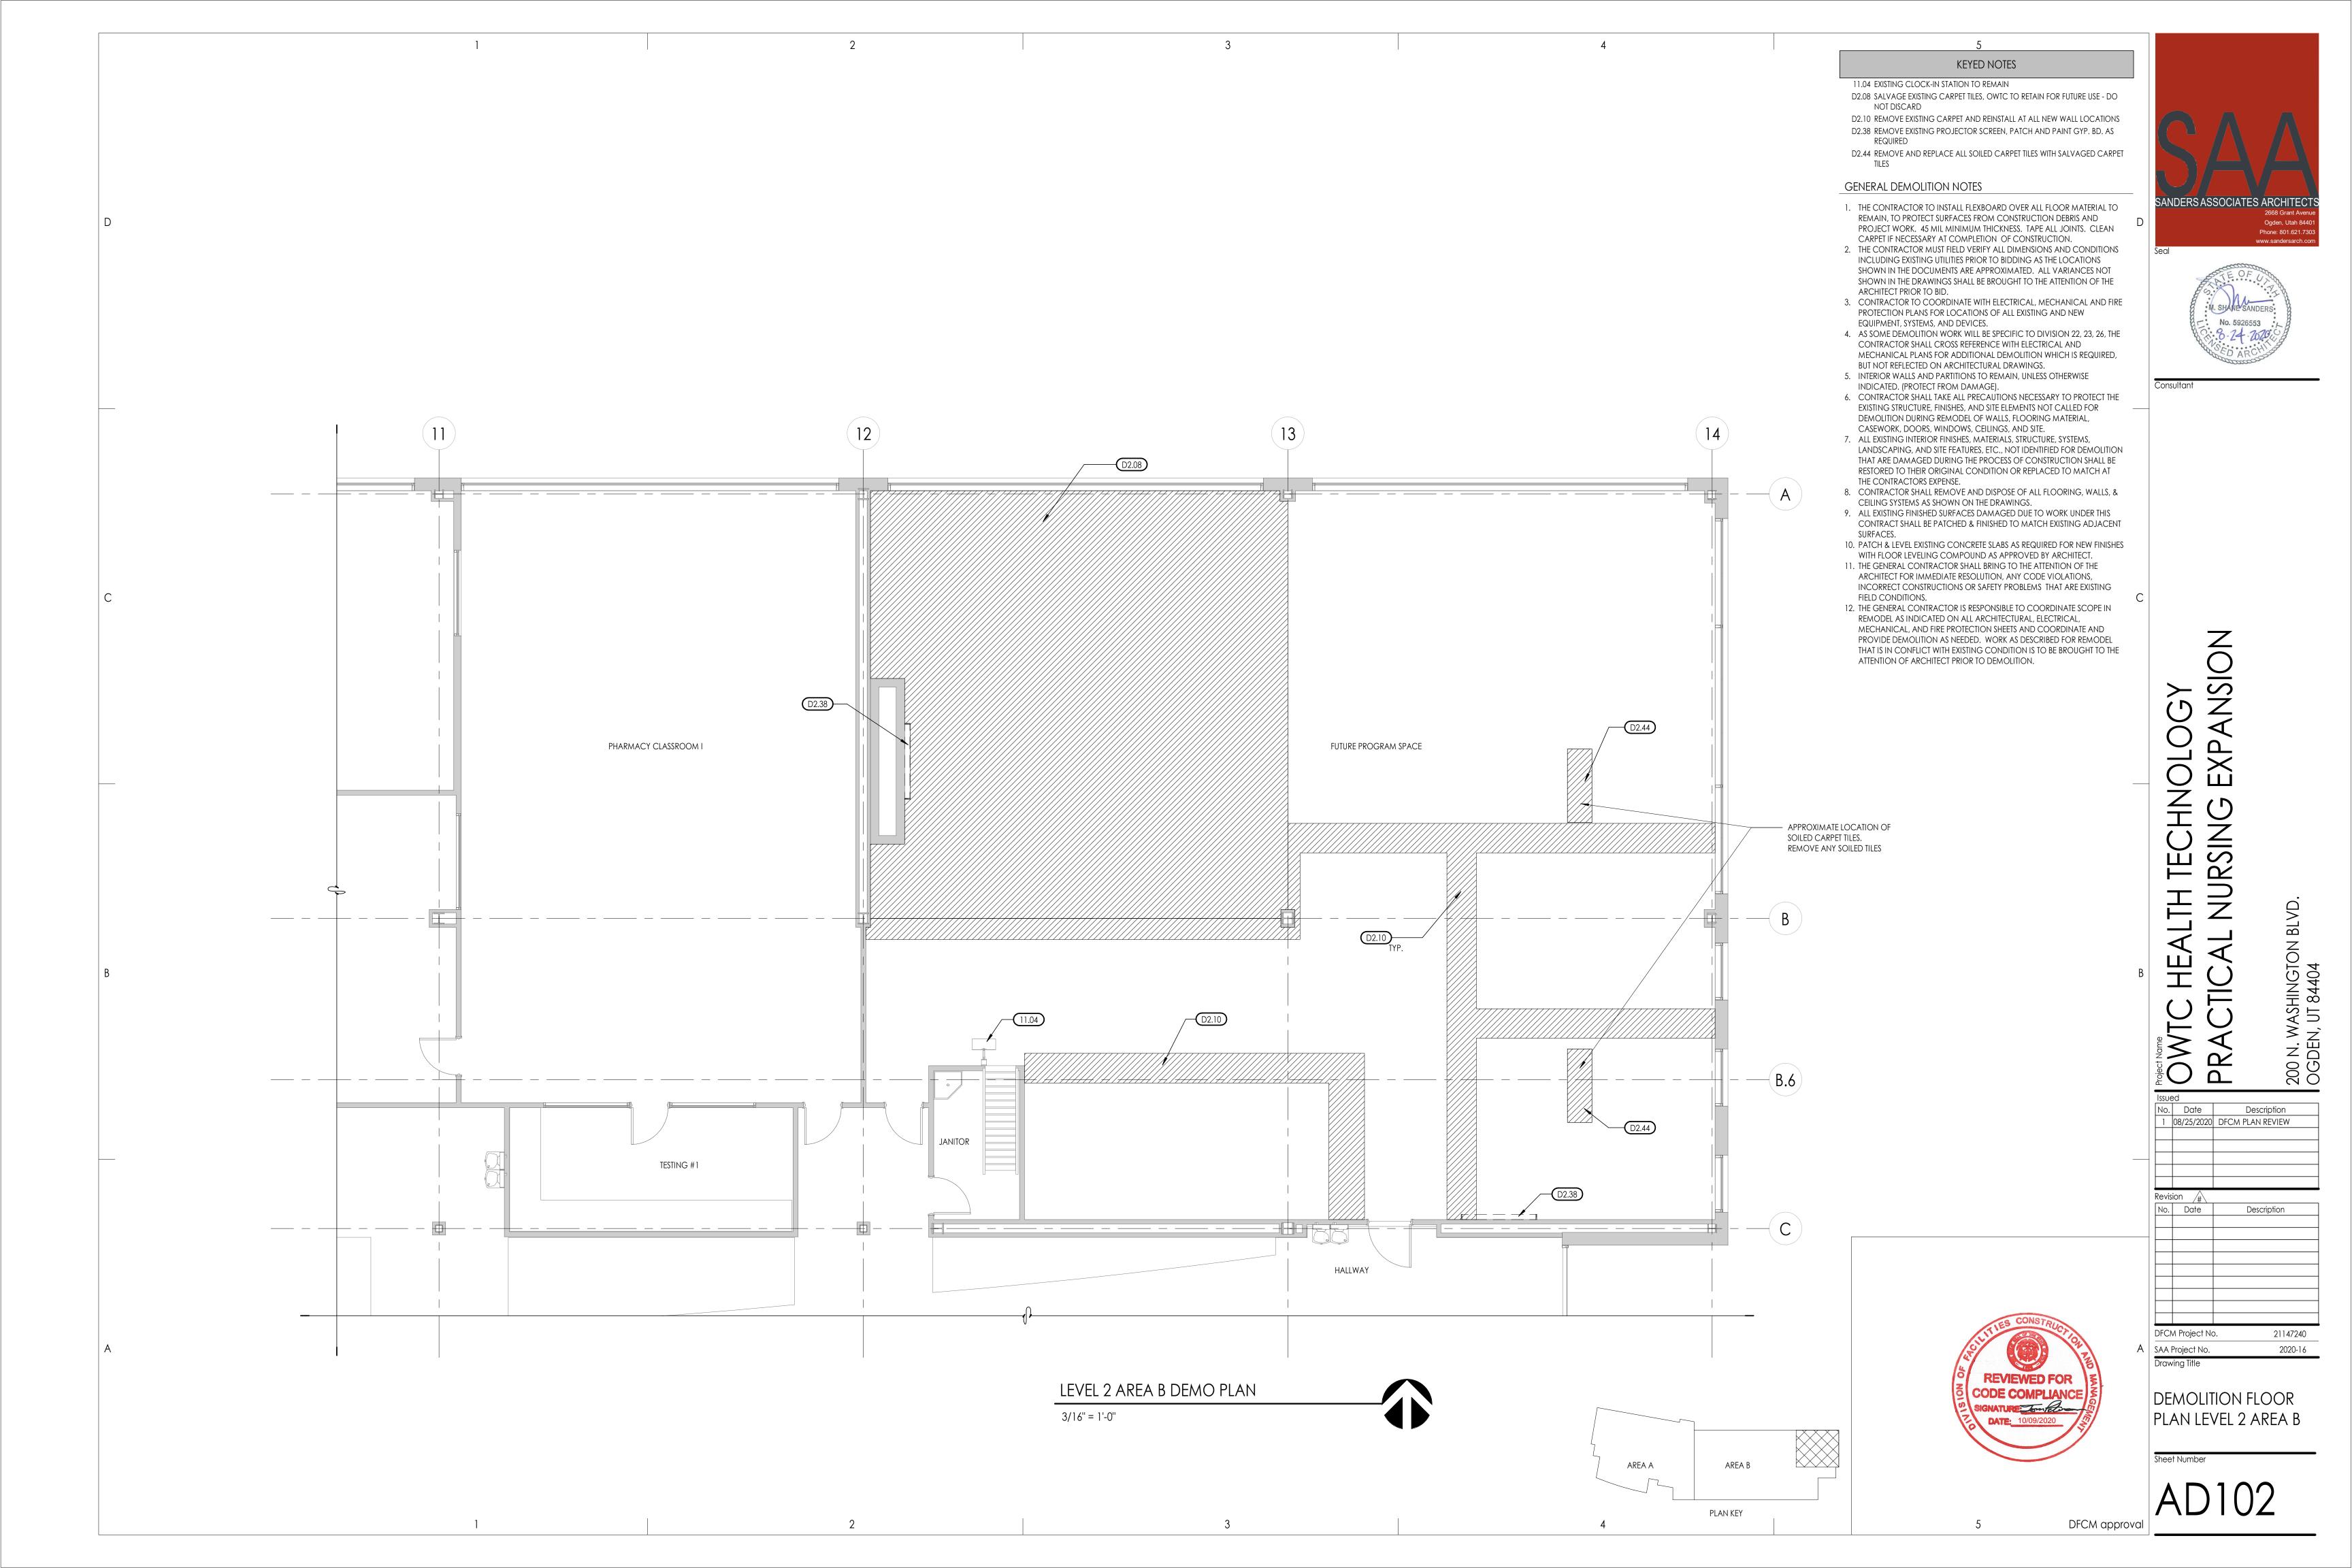
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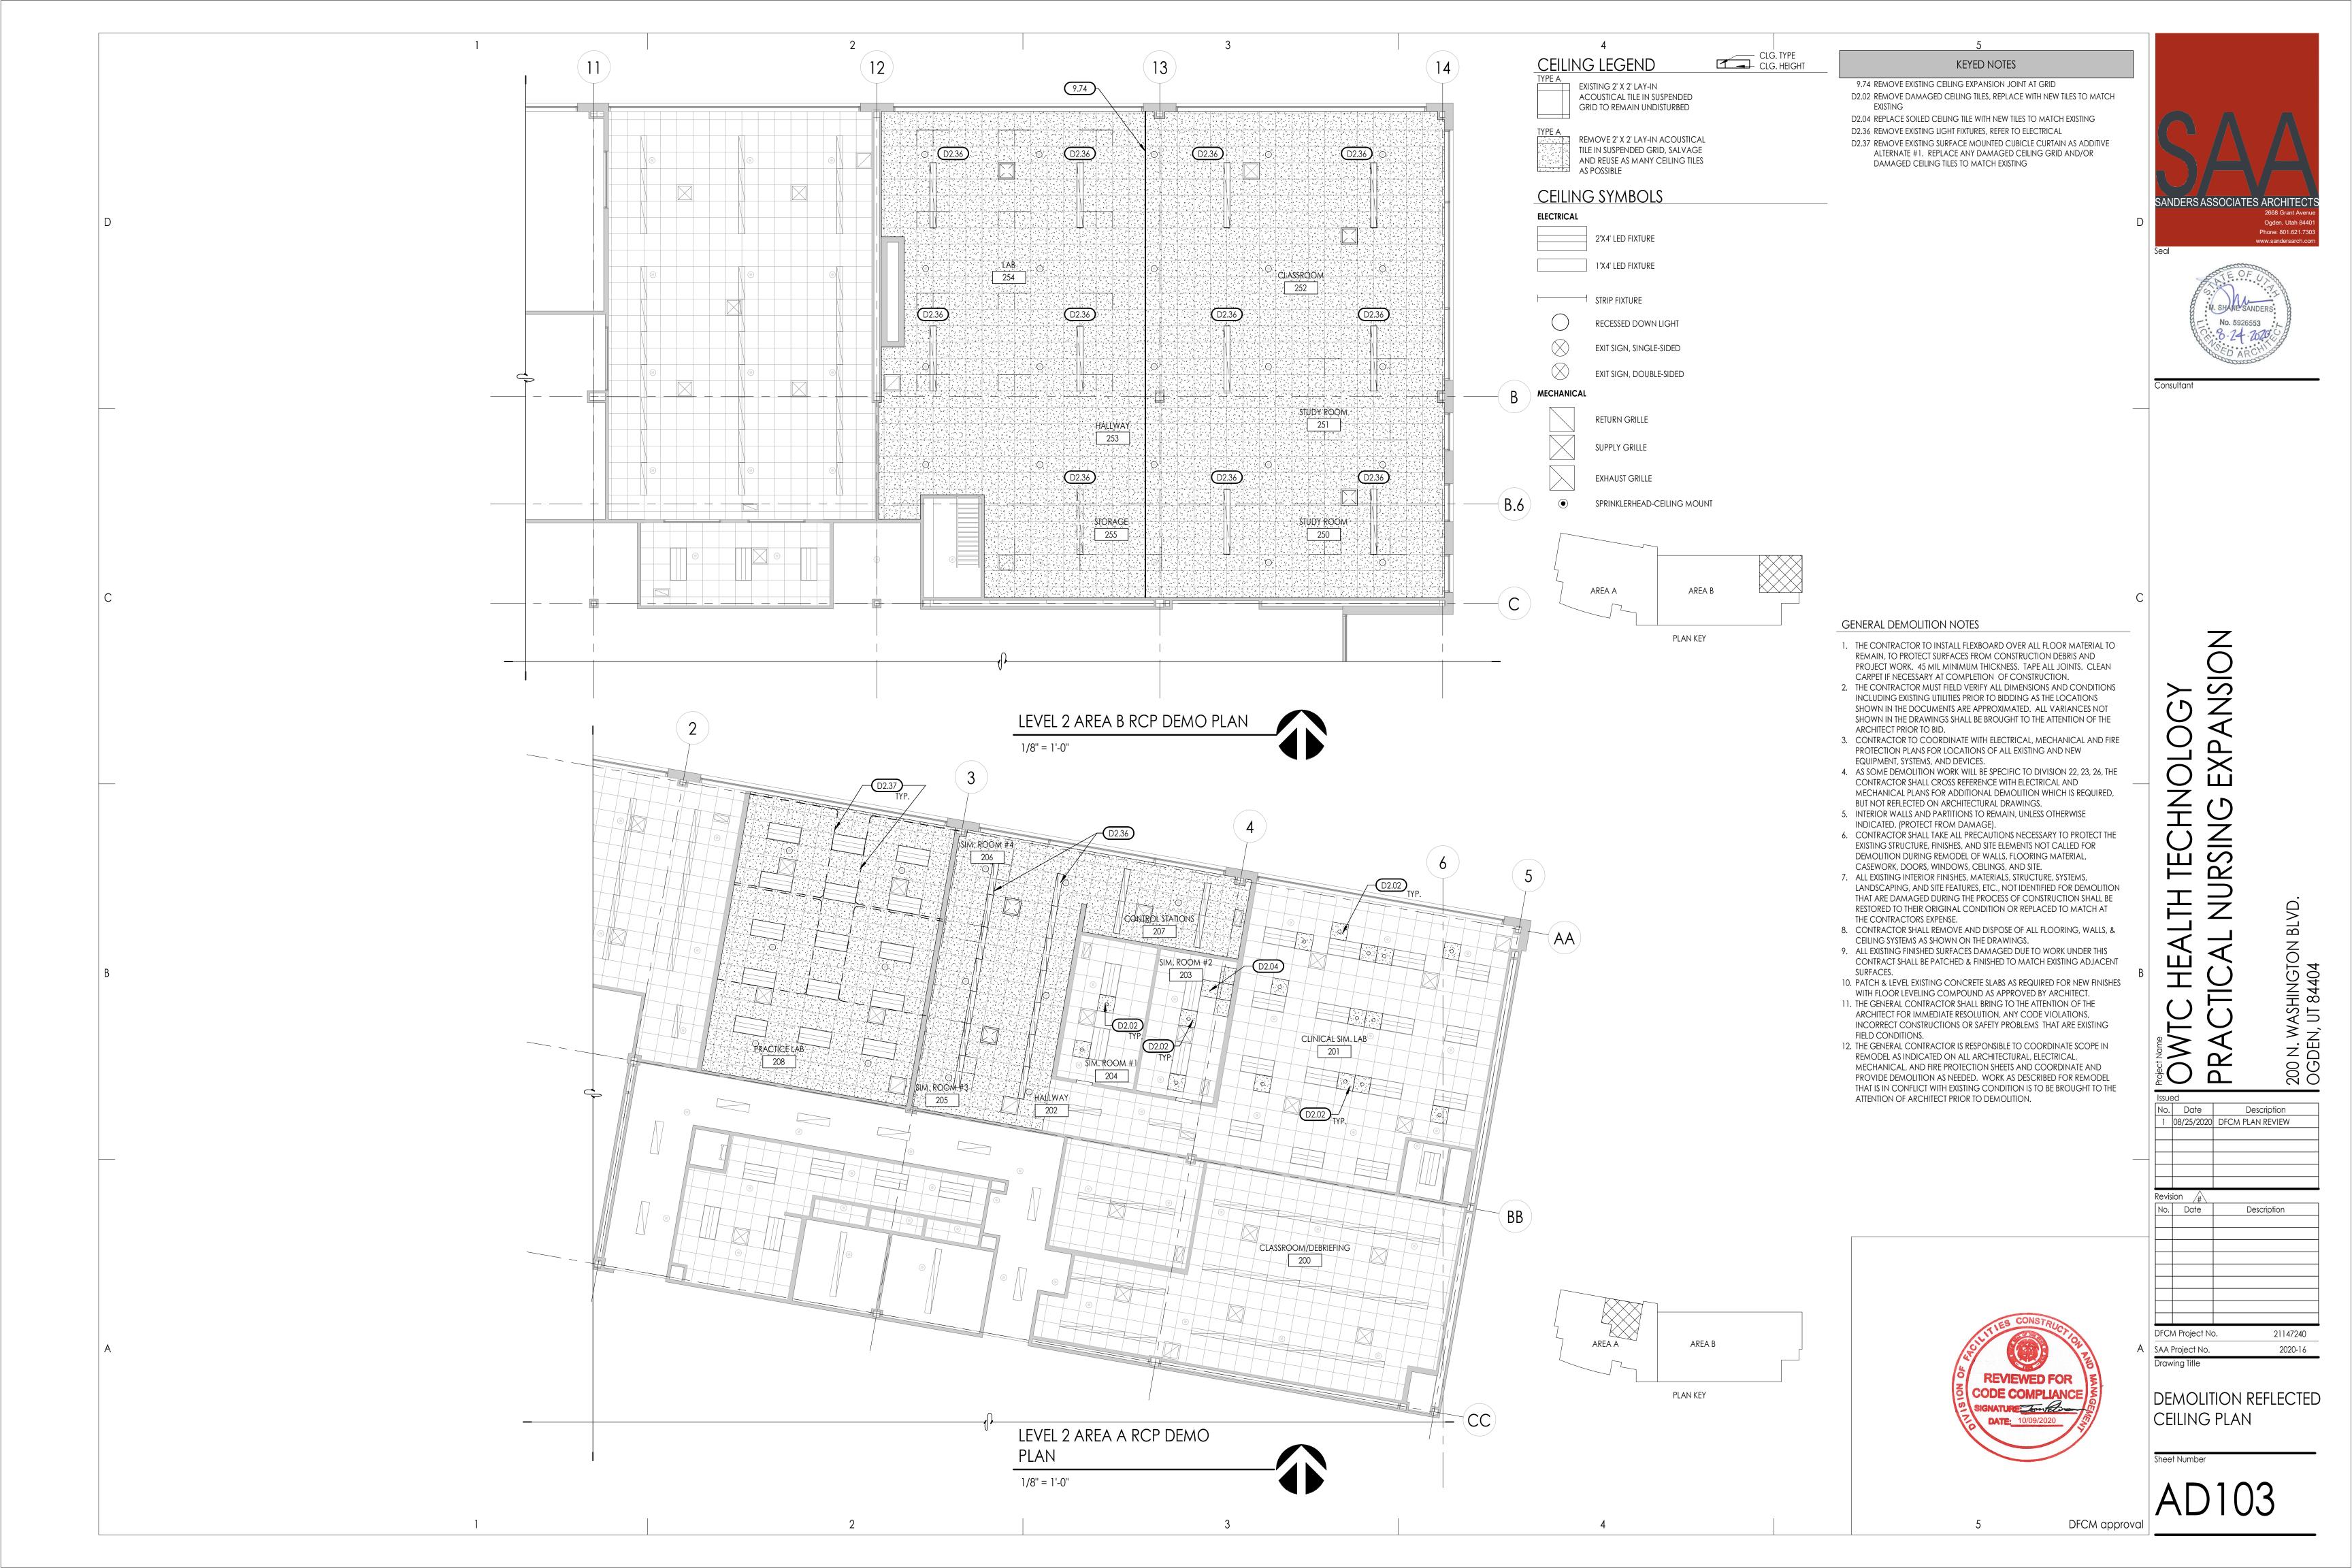


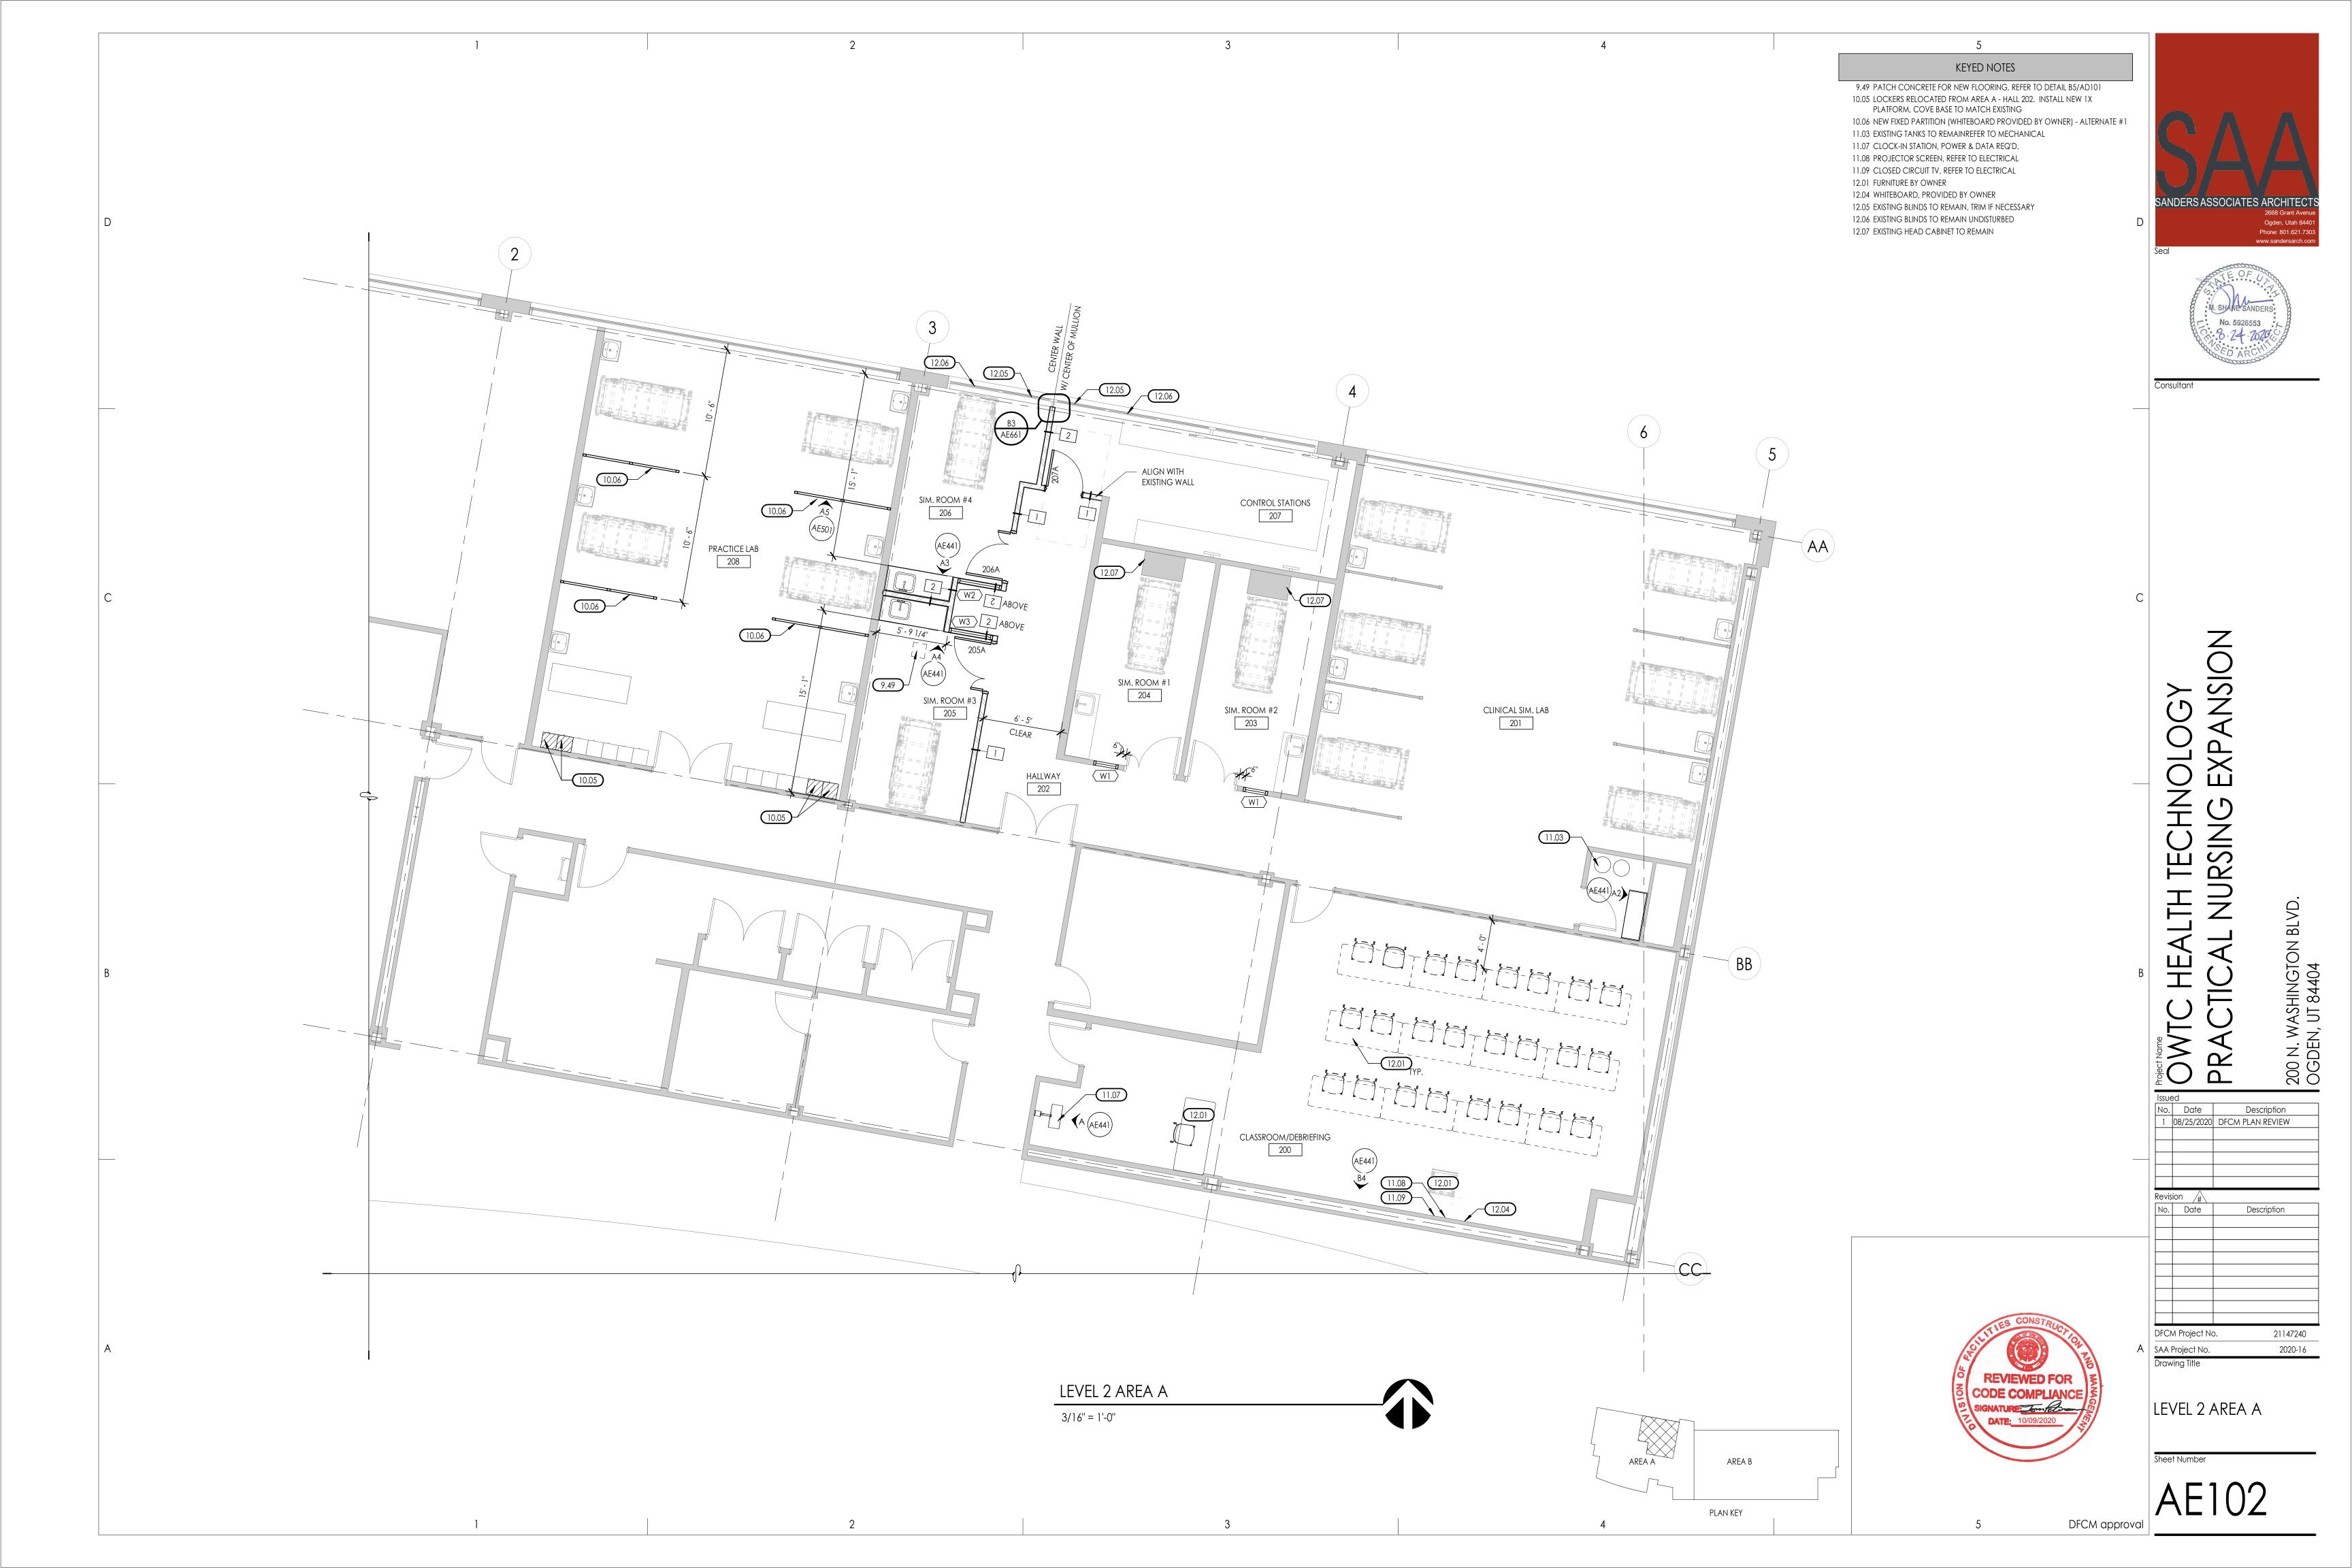


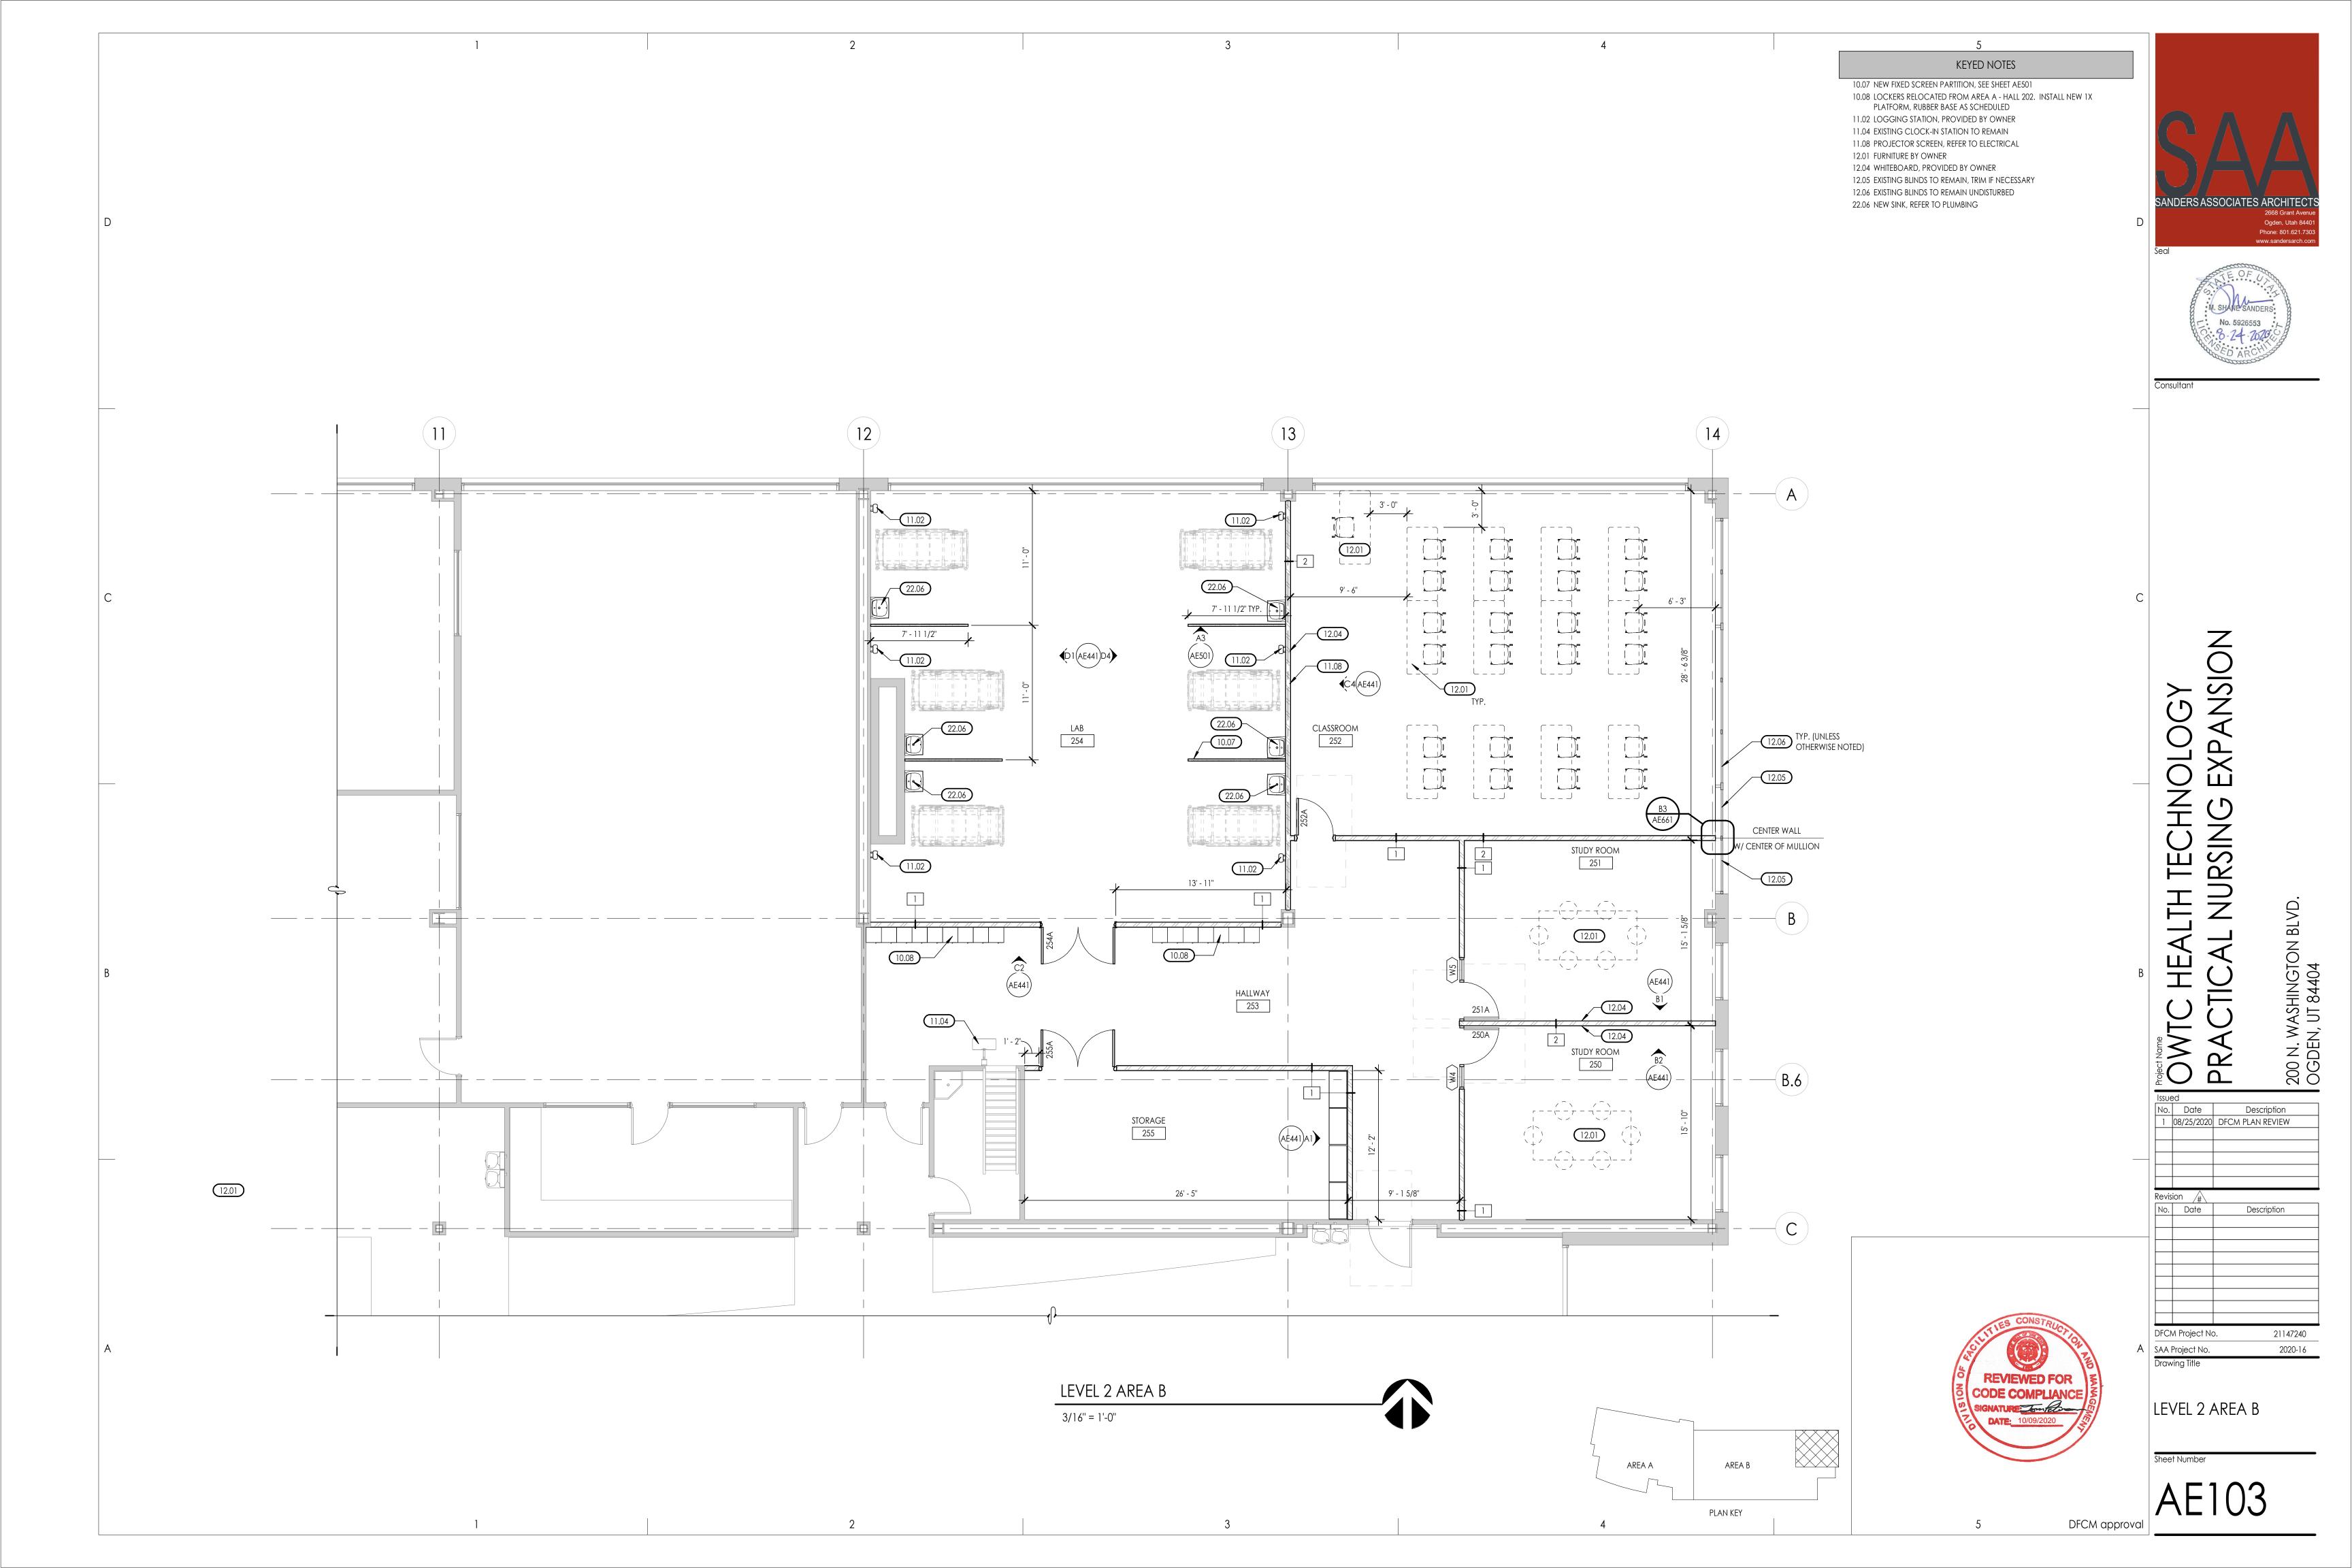


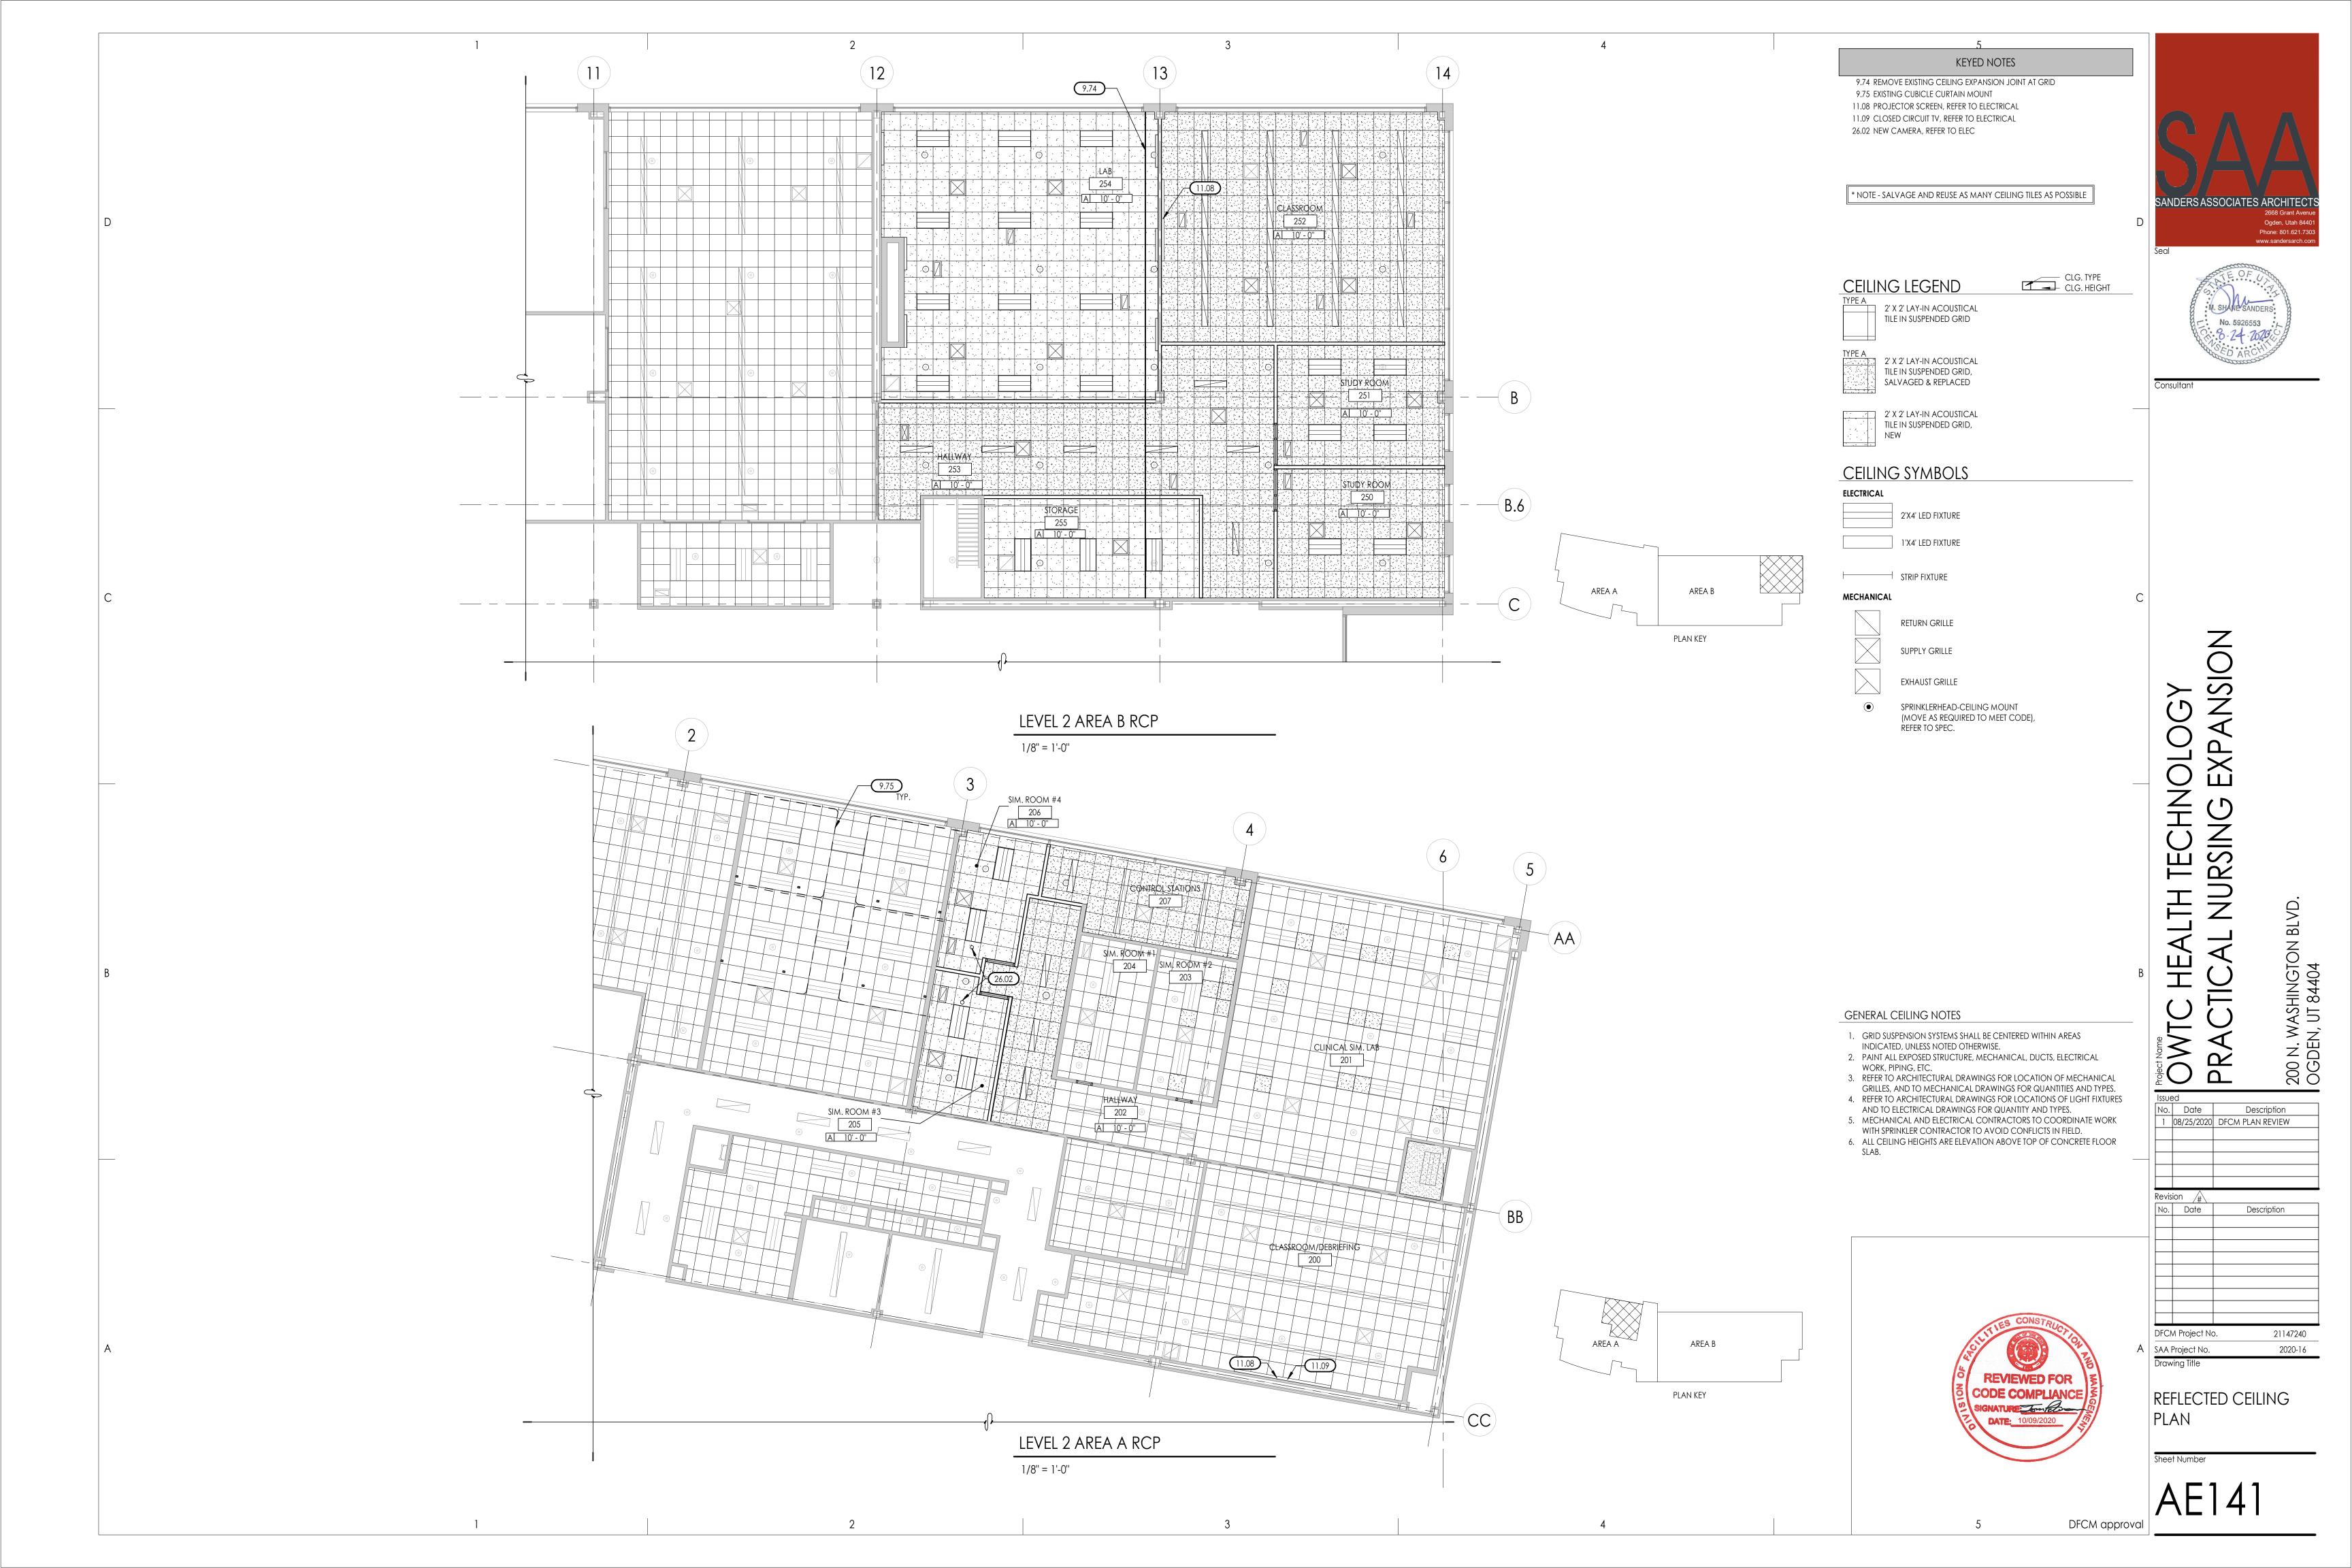


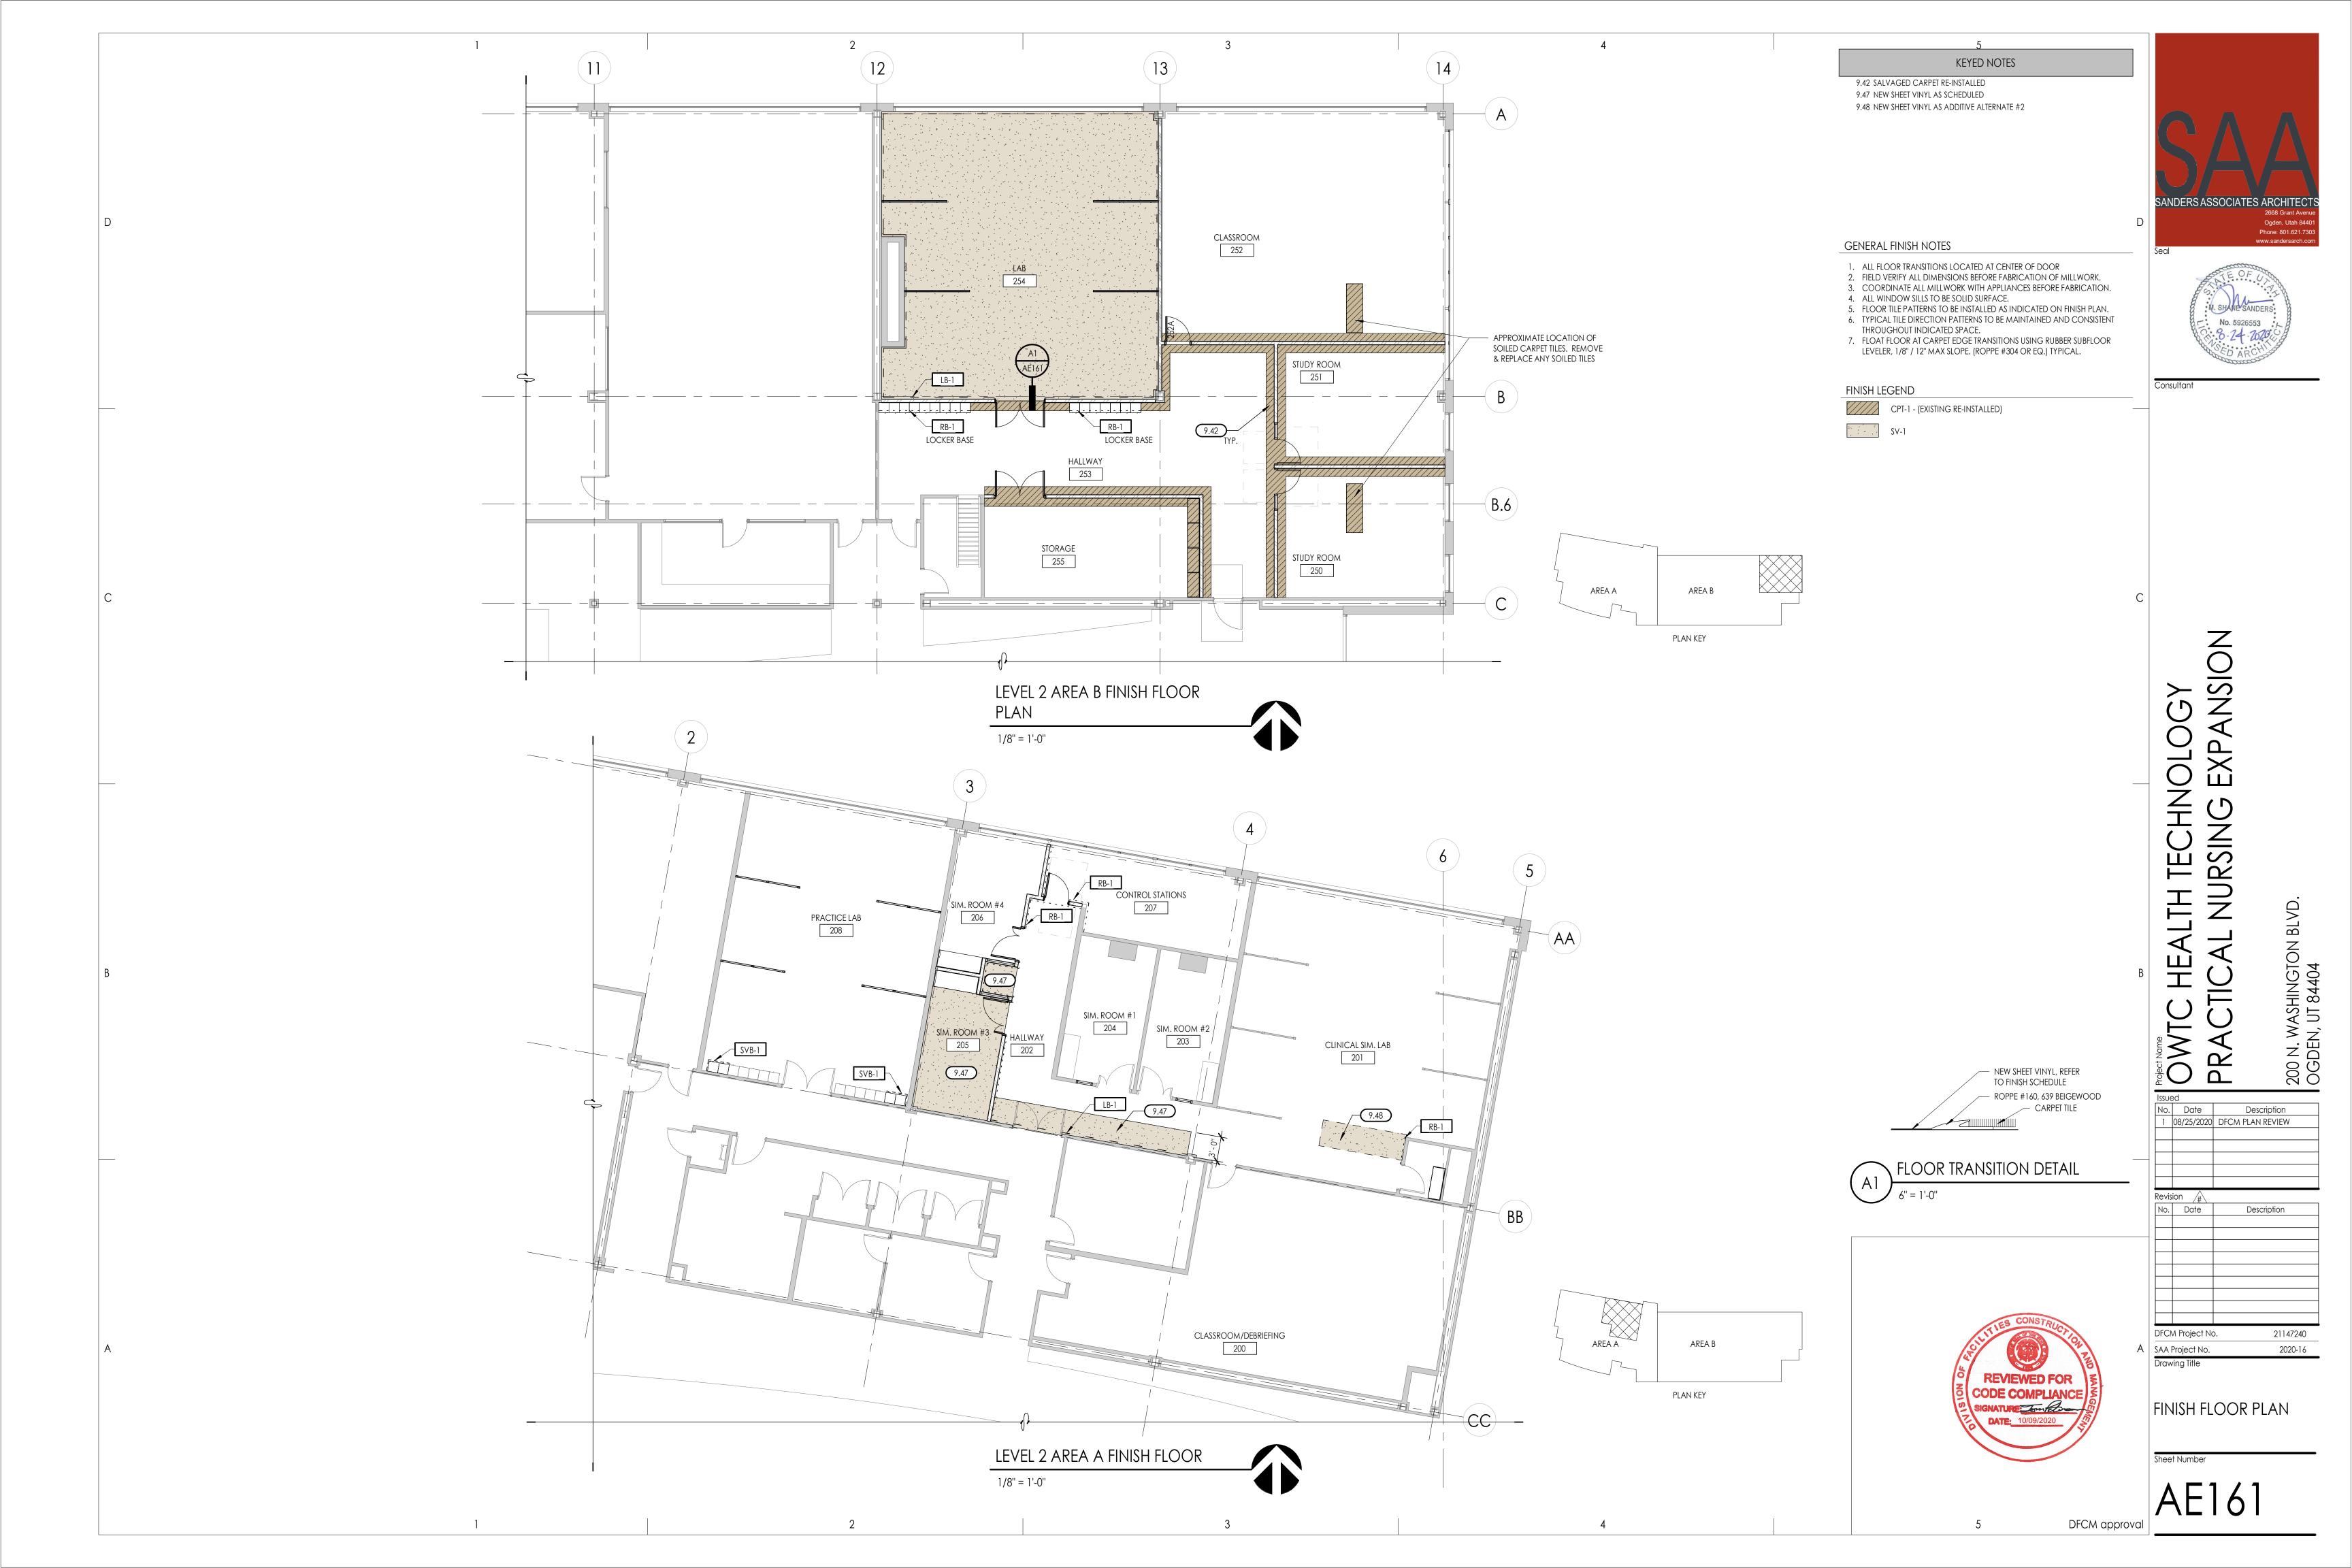


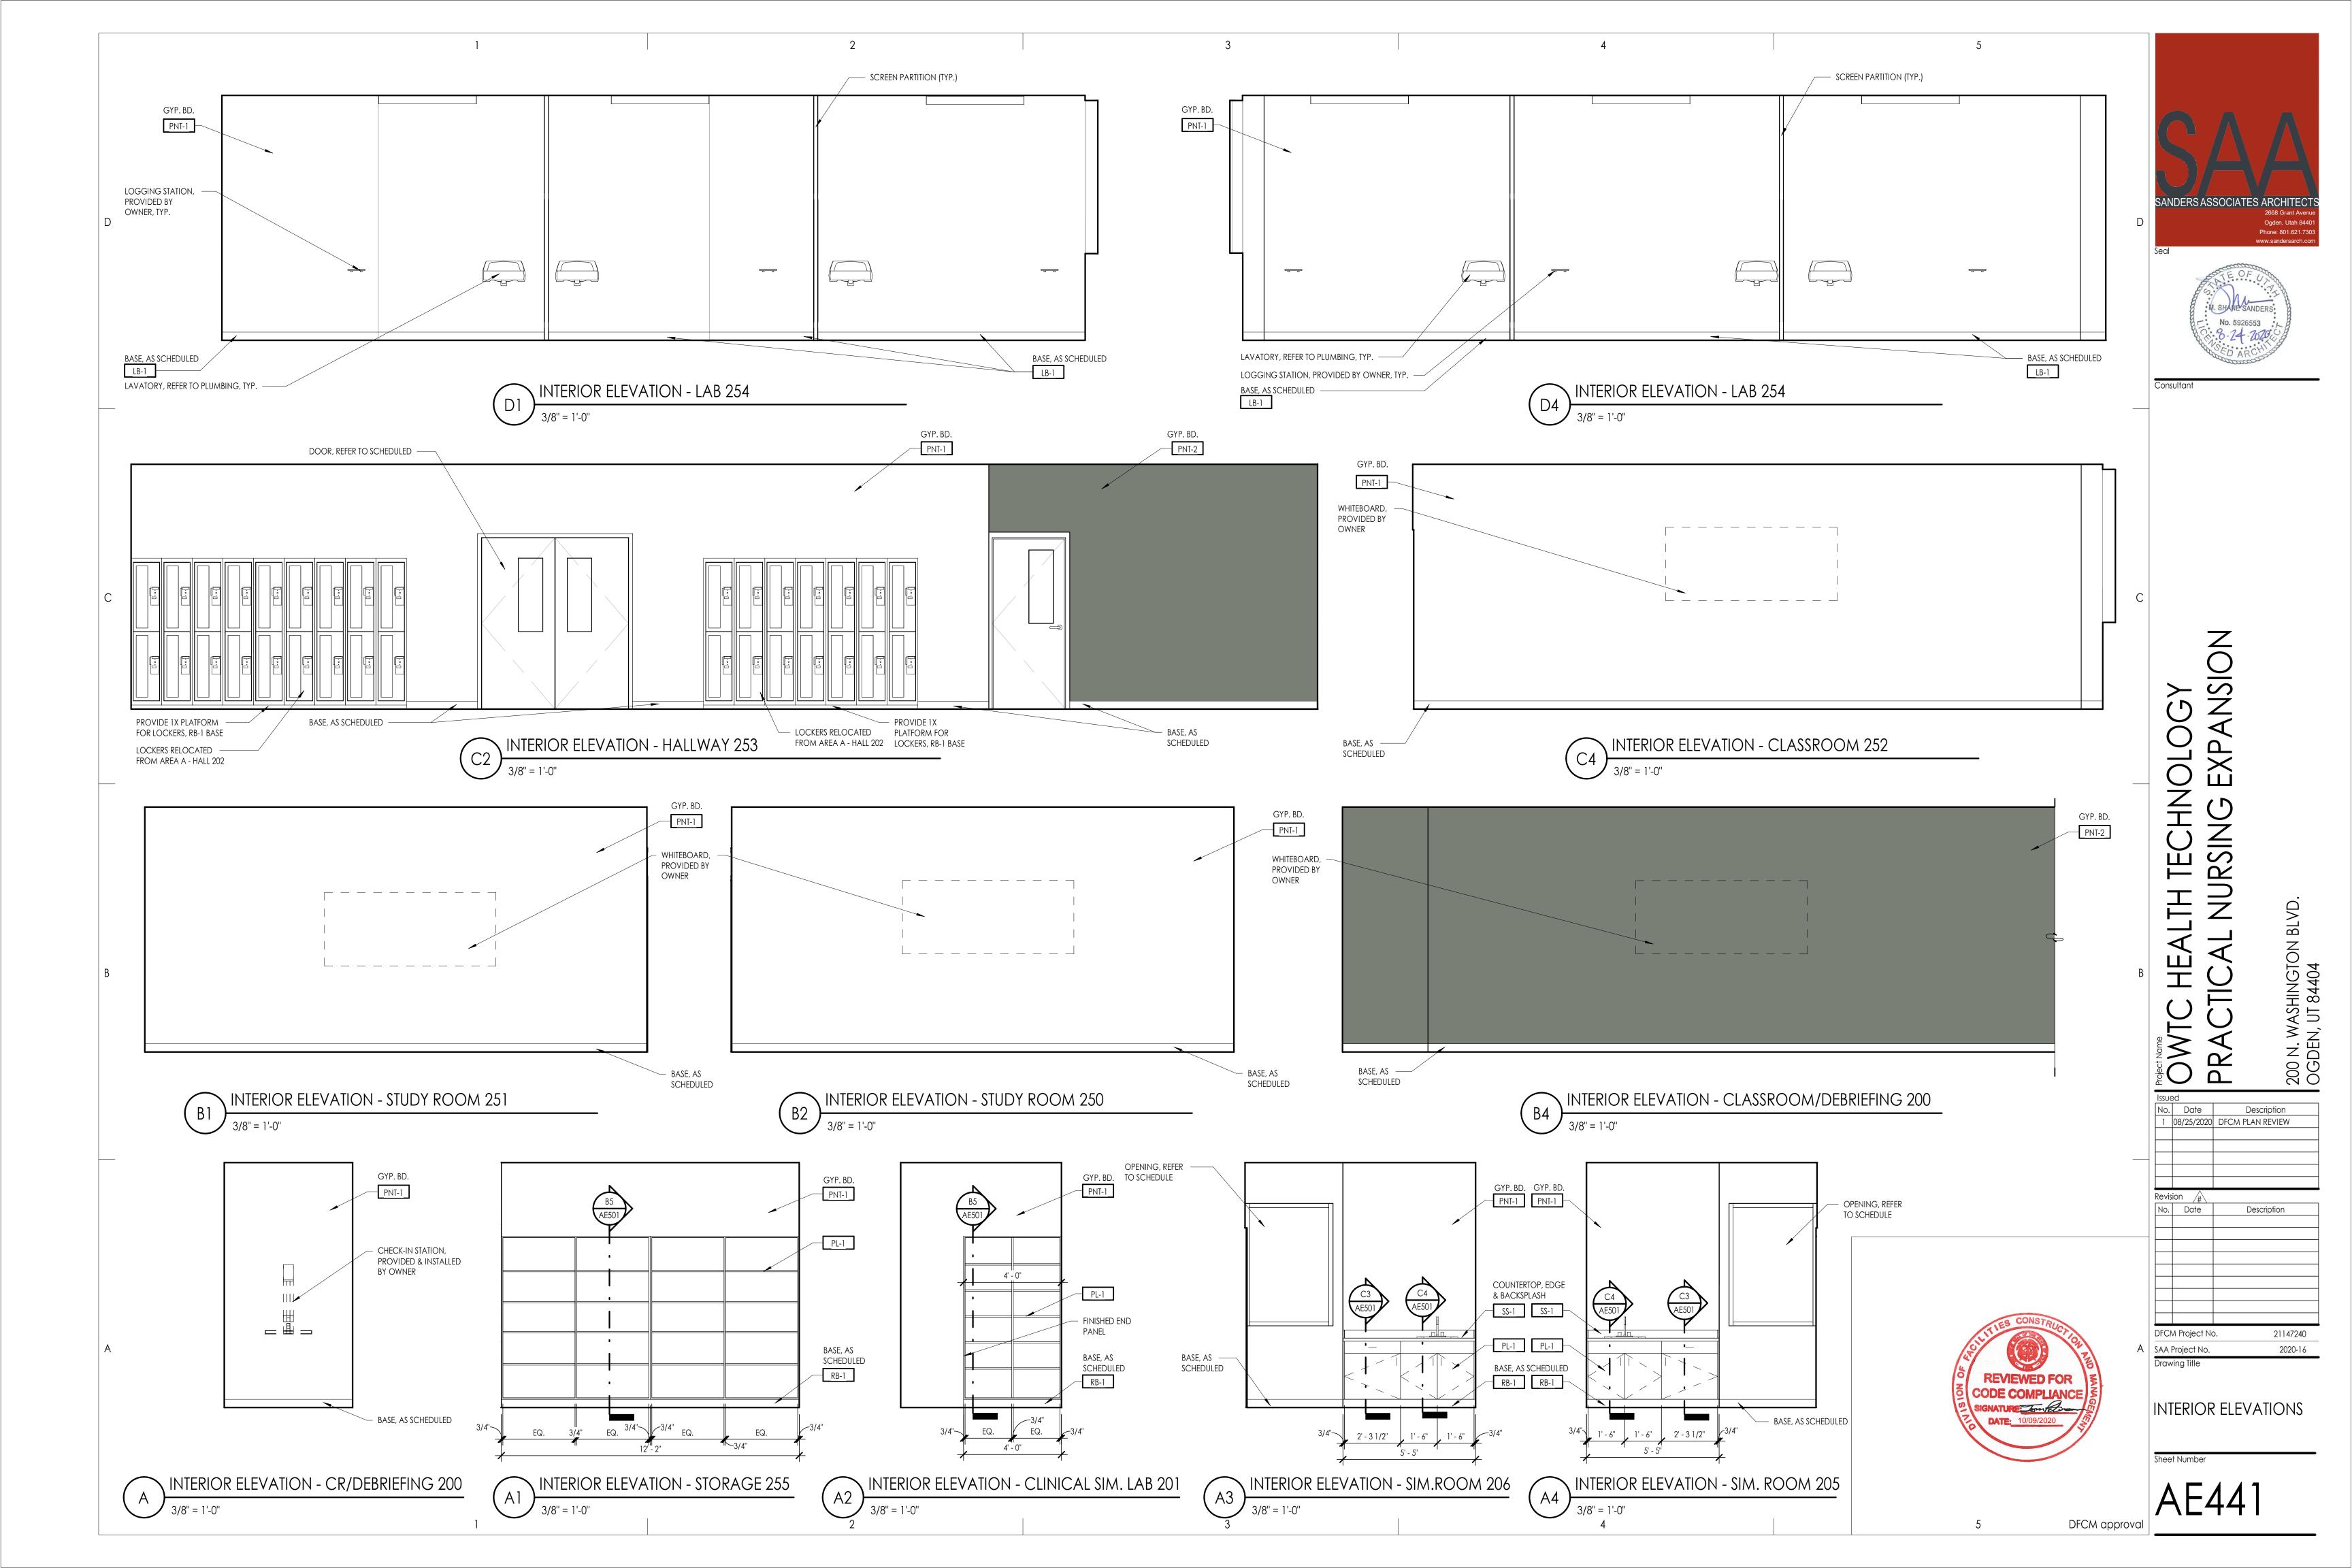


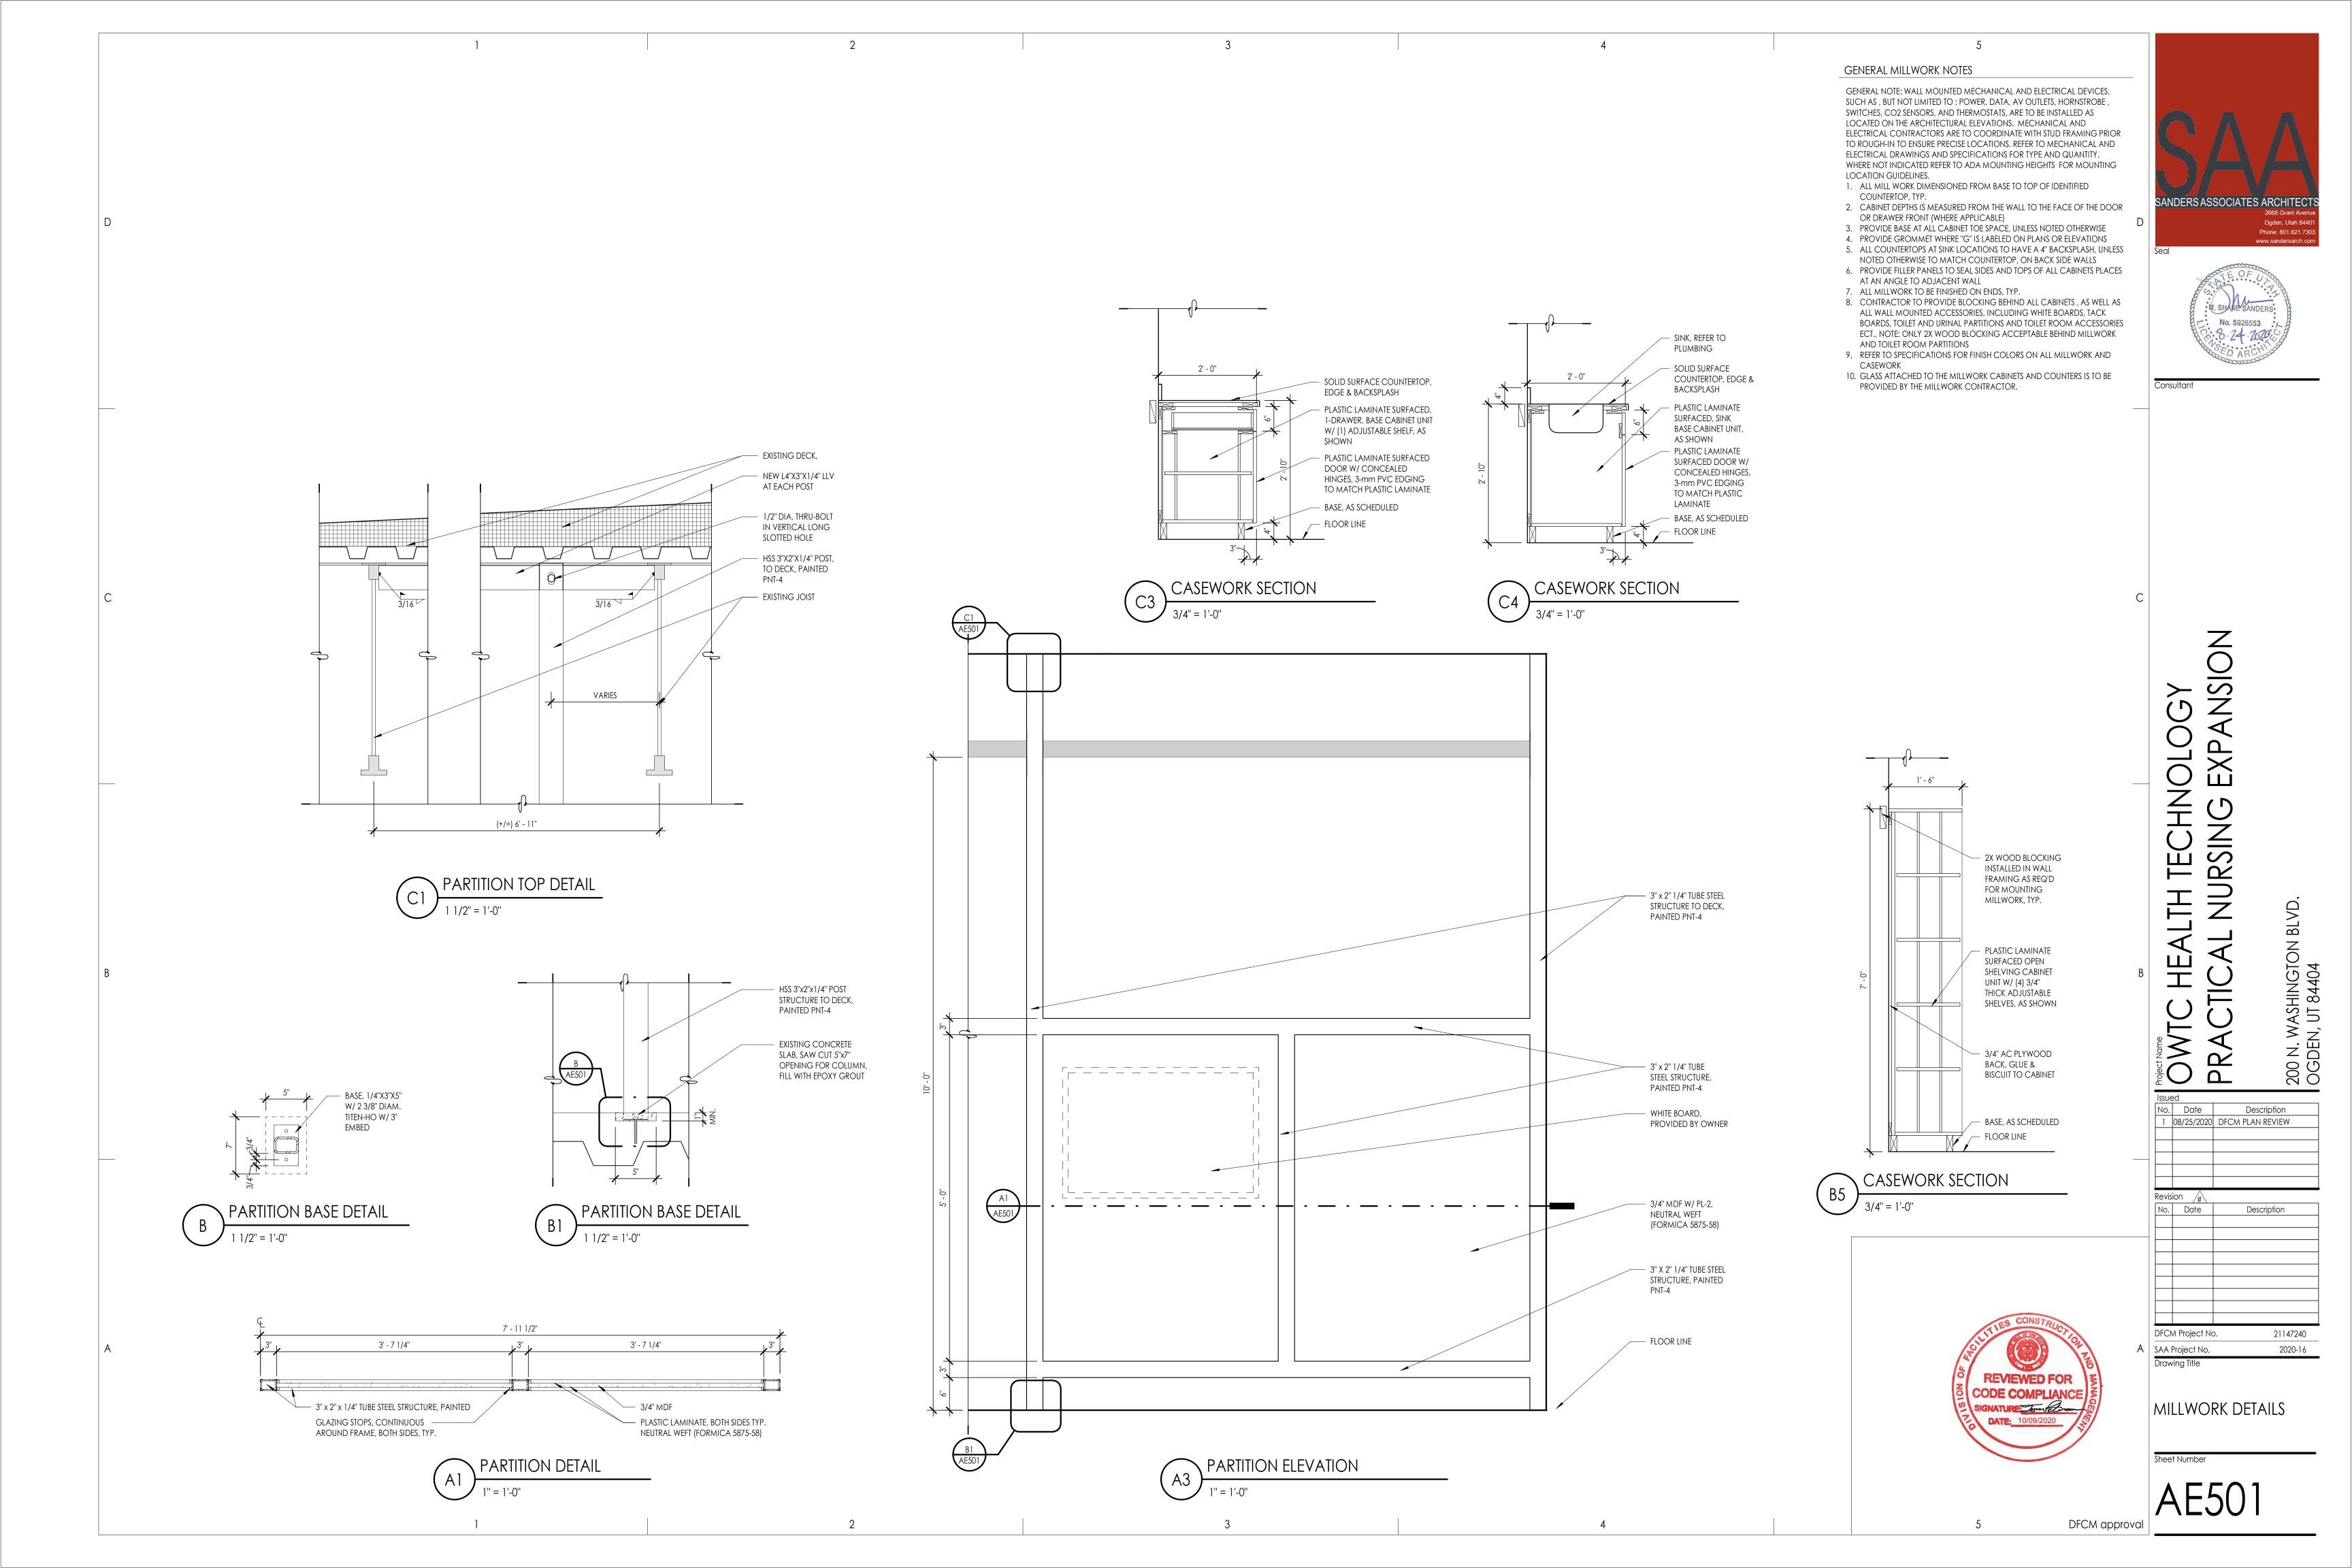


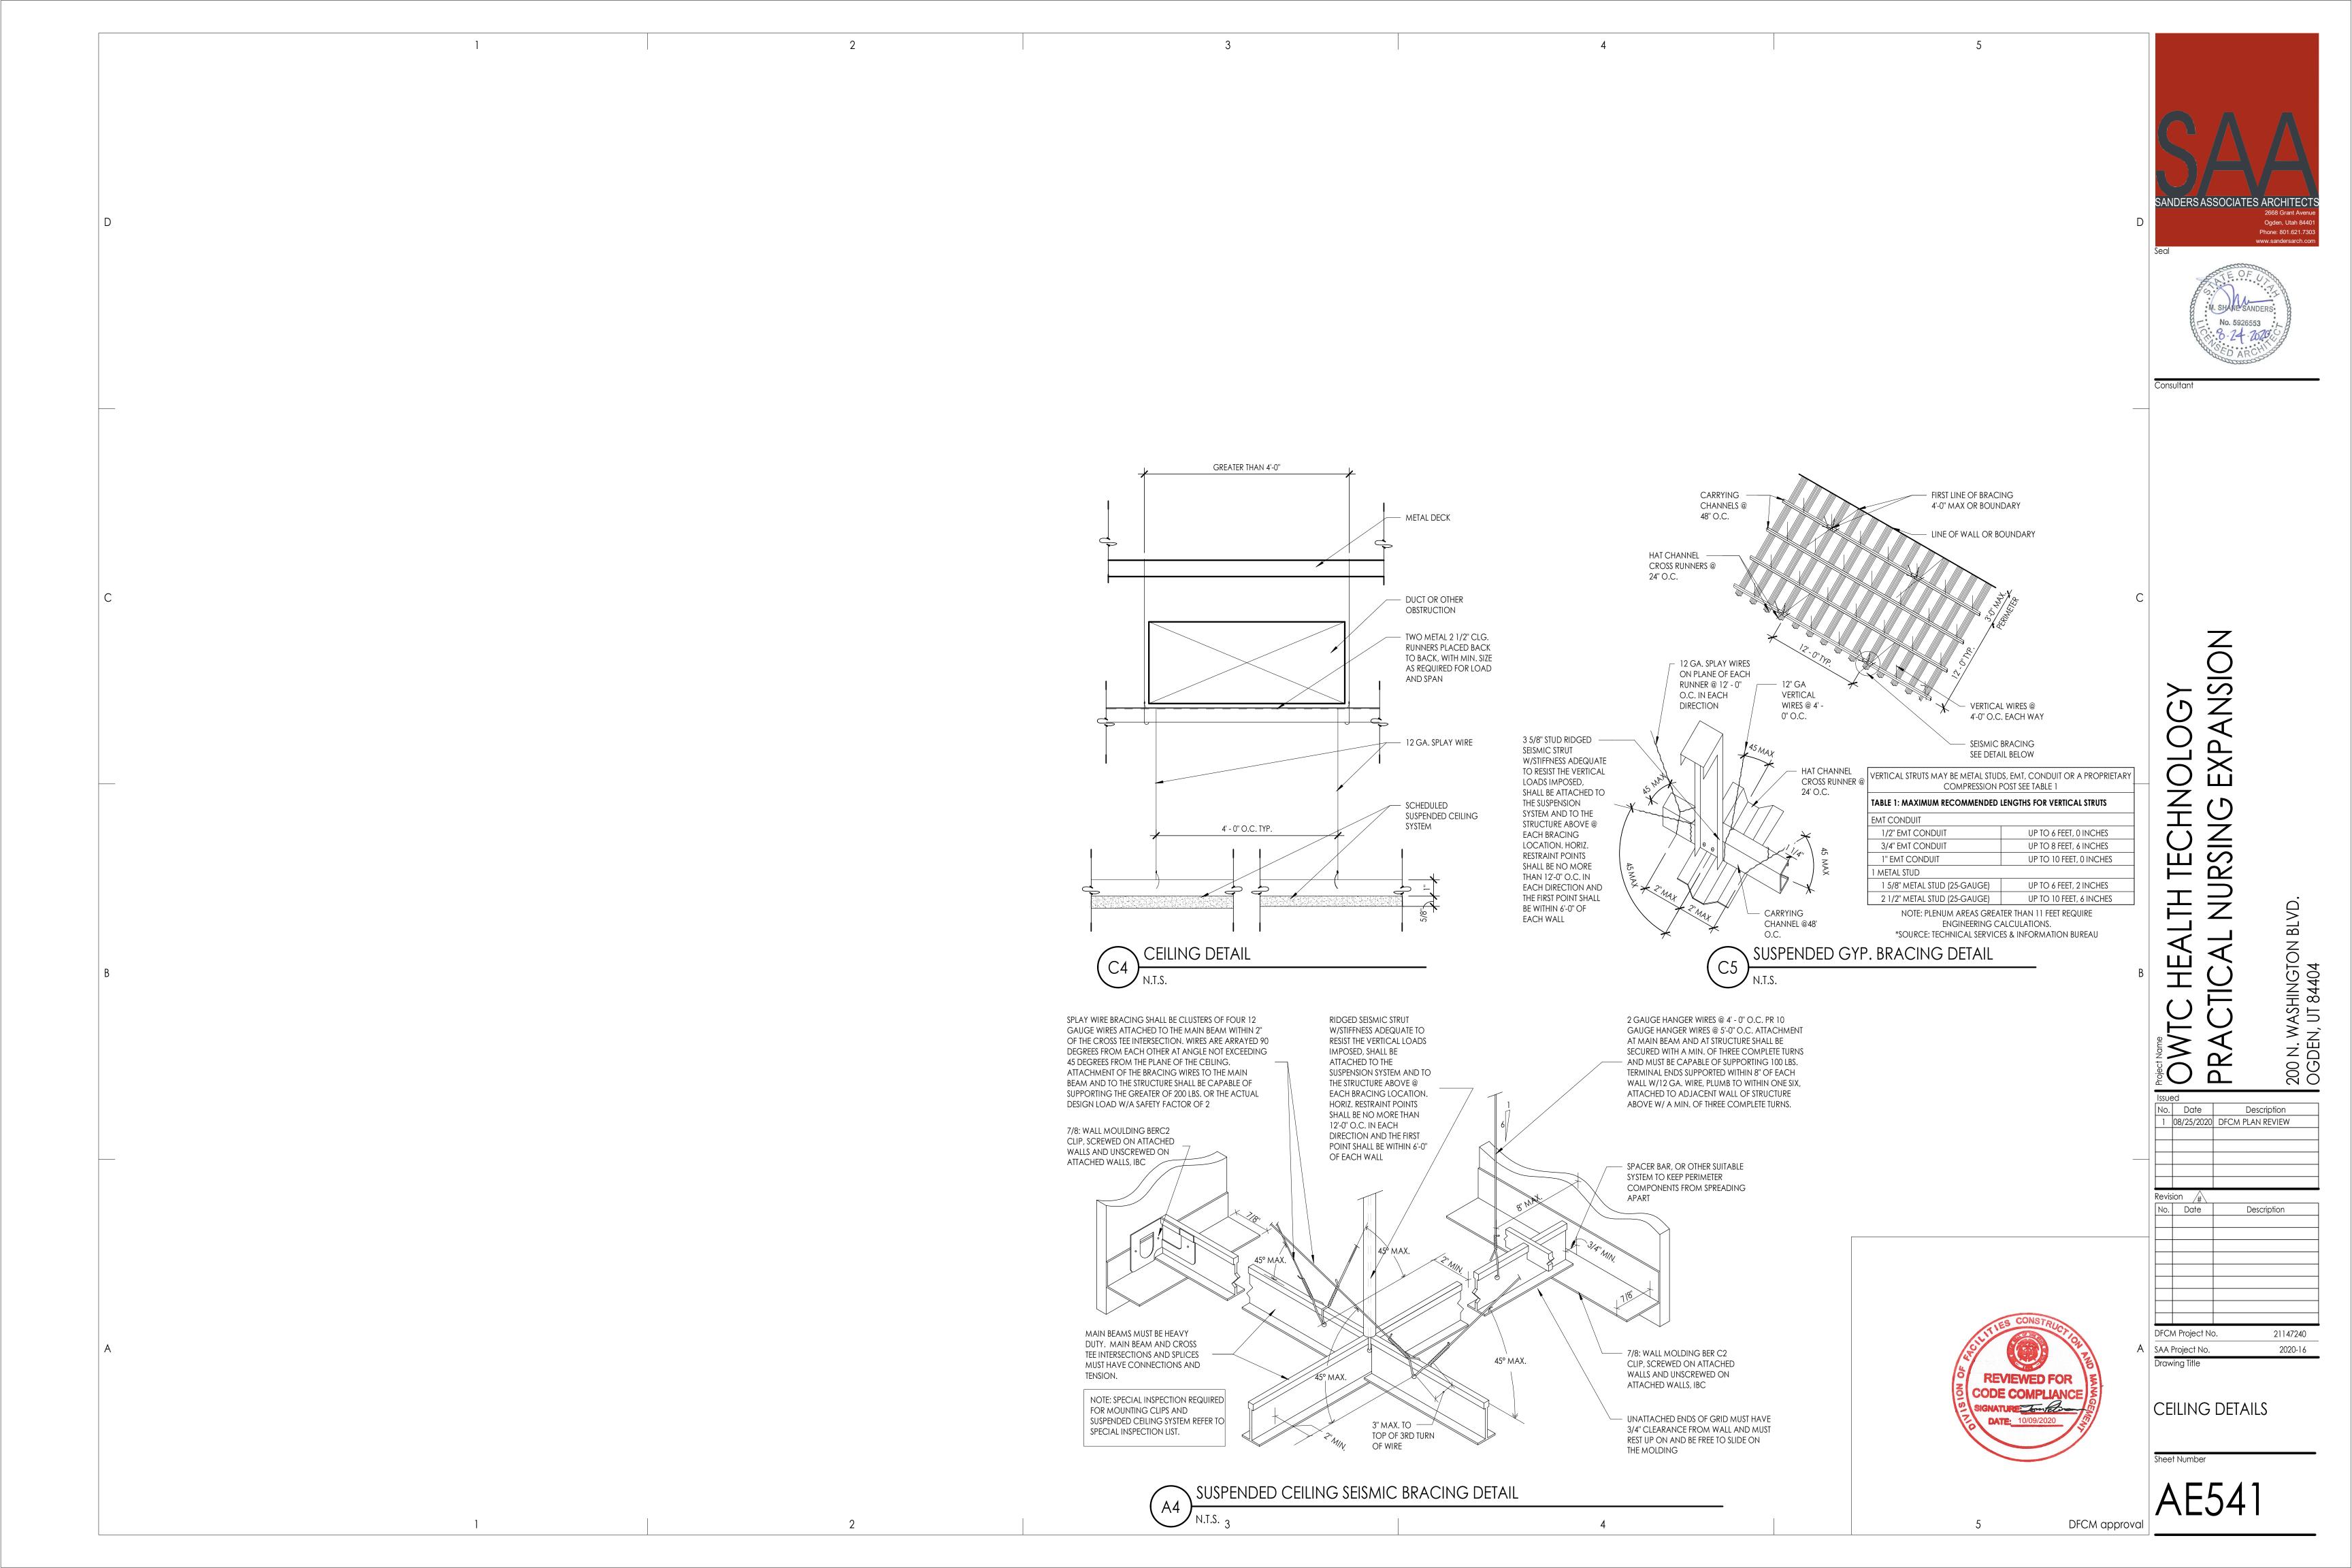


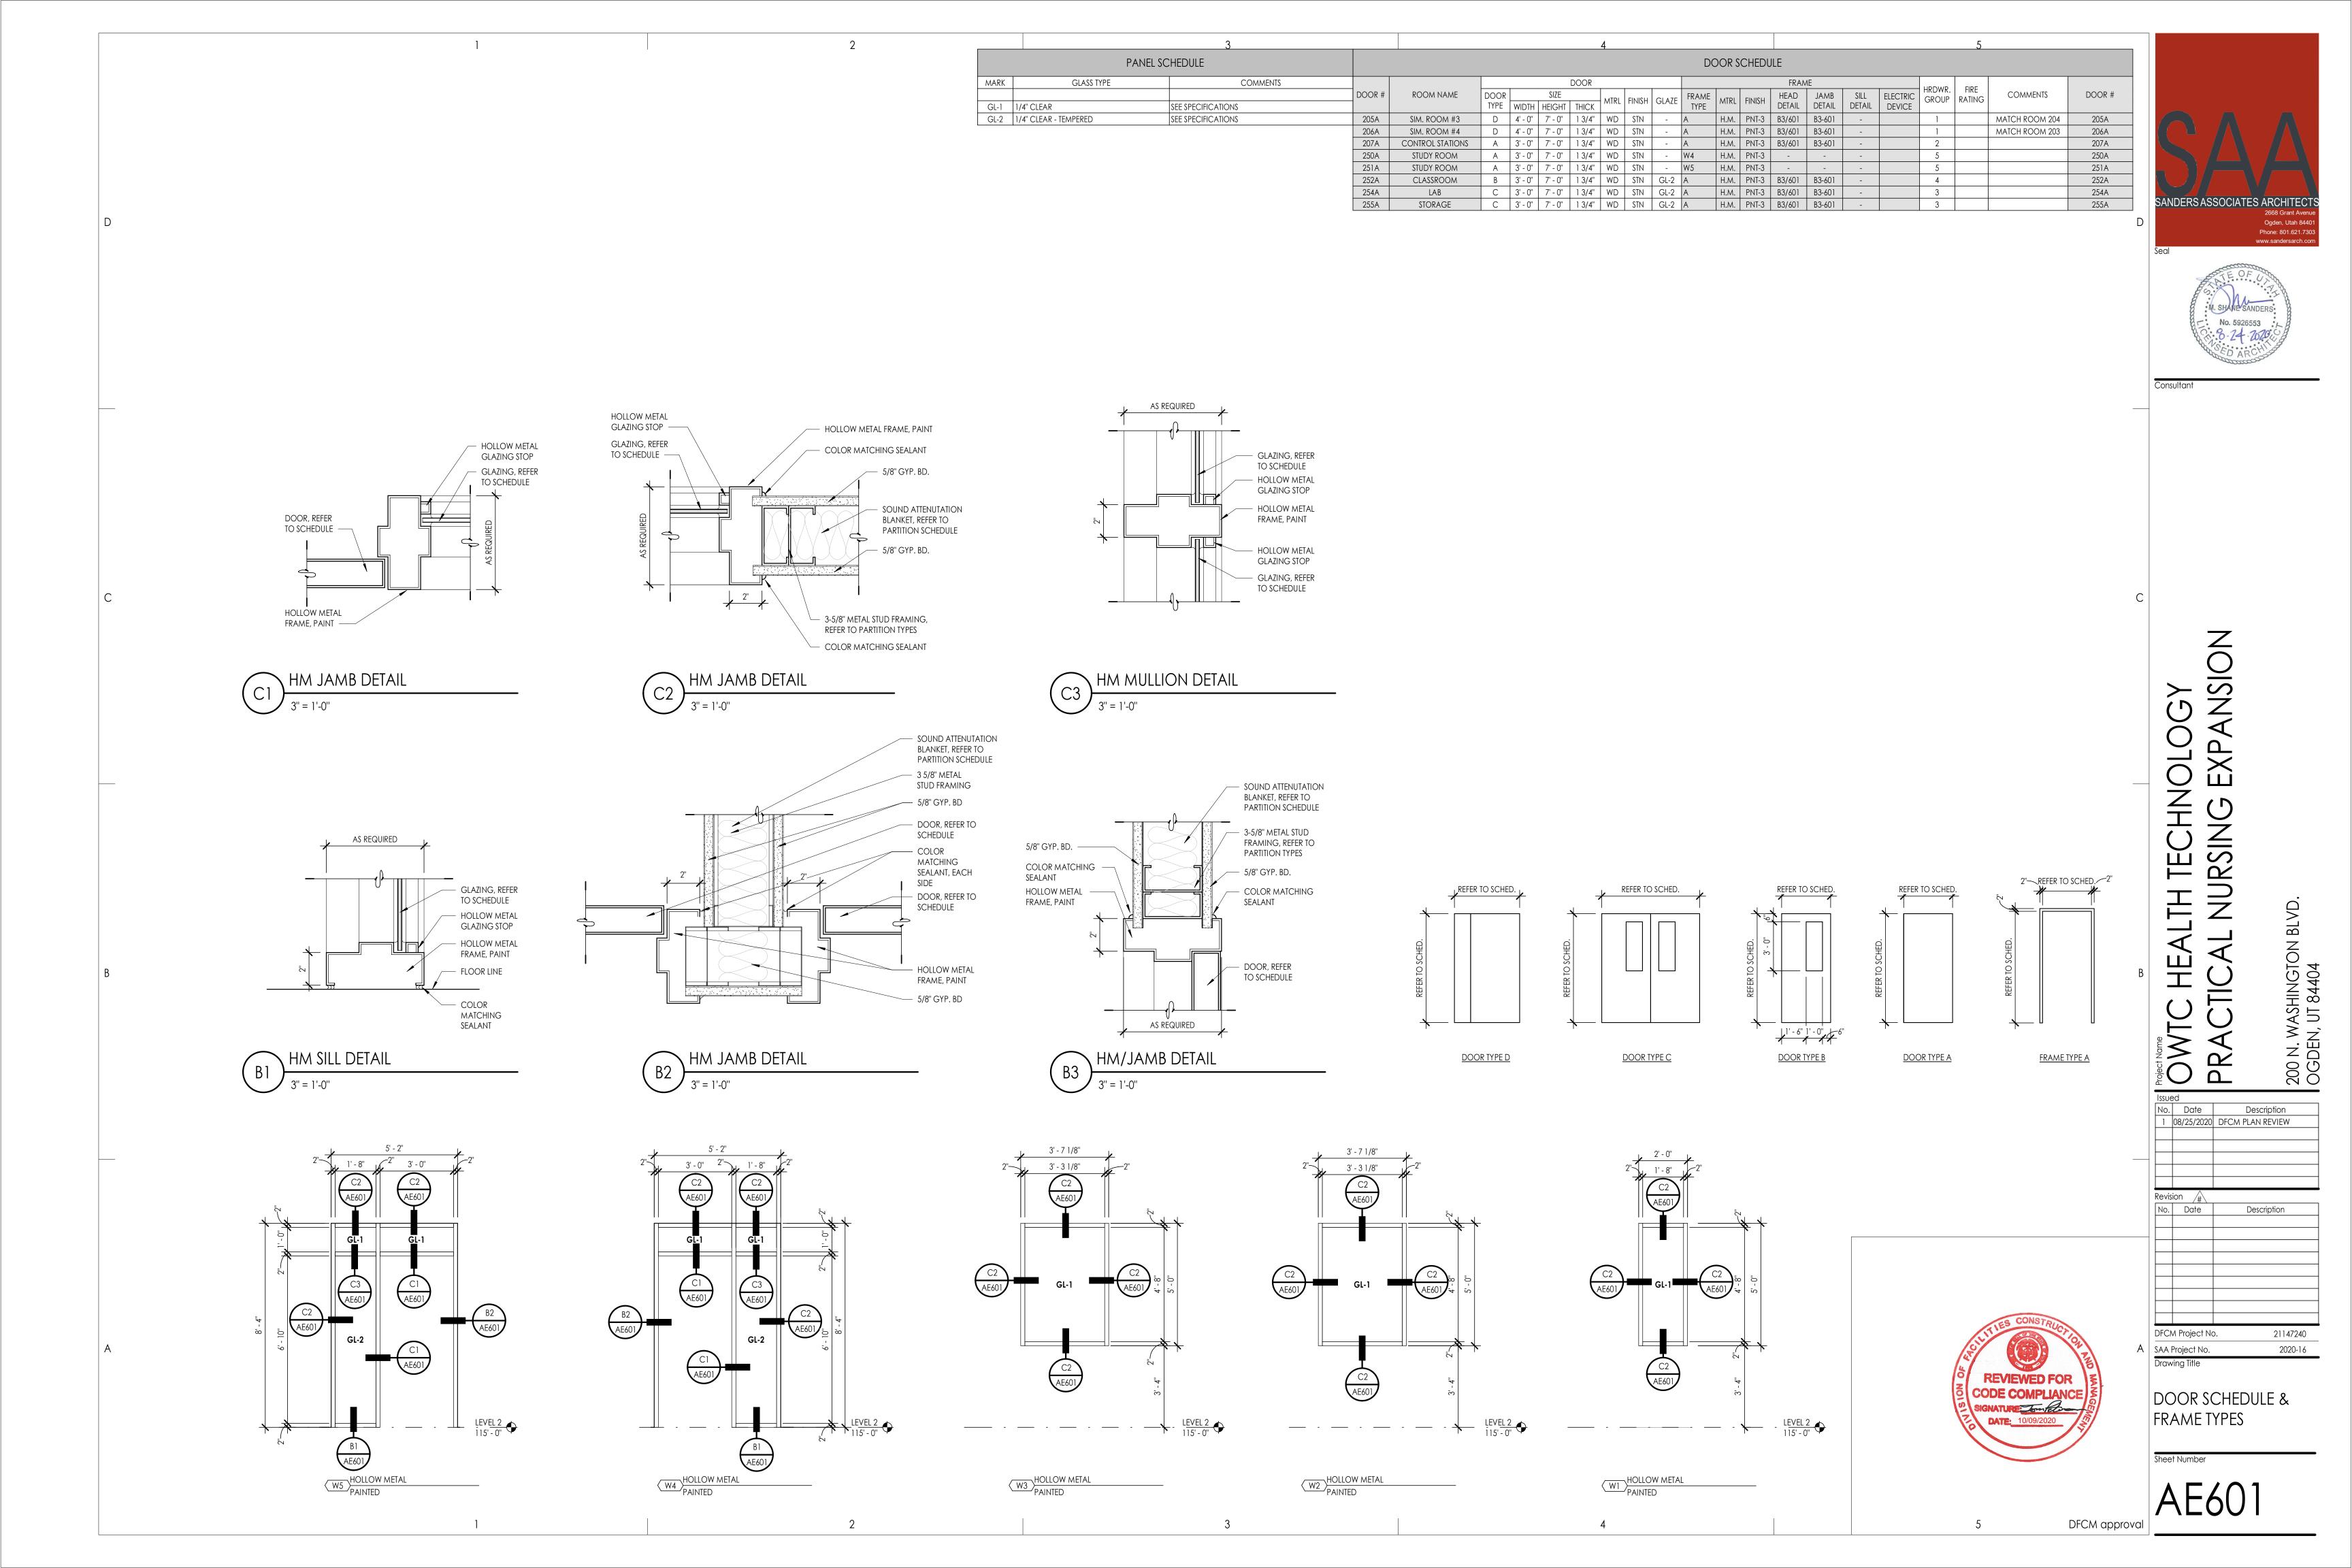












		1		2		3				4					
			INTERIOR FINISH LEGEND									room finish	H SCHEDULE		
CODE	MATERIAL	MANUFACTURER	PRODUCT	COLOR/FINISH	SIZE	COMMENTS	NO.	NAME	FLOOR	BASE FINISH	NORTH WALL	SOUTH WALL	EAST WALL	WEST WALL	CEILIN
CARPET							200	CLASSROOM/DEBRIEFIN		EXISTING TO REMAIN		PNT-2	-	PNT-1	AC-1
 CPT-1	SALVAGED CARPET TILE					REPLACE SOILED CARPET TILES, RETAIN FOR OWNER	201	CLINICAL SIM. LAB	EXISTING TO REMAIN	EXISTING TO REMAIN		-	-	-	AC-1
	ONETHOED ON WELL HEE					NET ENDE GOILES GAIN ET HELD, NETATIVOR GAMER	202	HALLWAY SIM. ROOM #2	EXISTING/SV-1 EXISTING TO REMAIN	EXISTING/LB-1/RB-1 EXISTING TO REMAIN	PNT-1	PNT-2	PNT-2	PNT-1/PNT-2	AC-1
/INYL							204	SIM. ROOM #1	EXISTING TO REMAIN	EXISTING TO REMAIN		-	-	-	AC-1
SV-1	MARMOLEUM	FARBO	REAL	HORSE ROAN (3232)		WELD TO EXISTING SHEET VINYL	205	SIM. ROOM #3	SV-1	RB-1	PNT-1	PNT-1	PNT-1	PNT-2	AC-1
BASE							206	SIM. ROOM #4	EXISTING TO REMAIN	RB-1	PNT-1	PNT-1	PNT-1	PNT-2	AC-1
 	CARPET BASE			MATCH EXISTING	MATCH EXISTING	TOP EDGE DETAIL TO MATCH EXISTING	207	CONTROL STATIONS PRACTICE LAB	EXISTING TO REMAIN  EXISTING TO REMAIN	EXISTING/RB-1  EXISTING TO REMAIN	-     -	PNT-1	-	PNT-1	AC-1
		D O D D S	TOO SERVES TYPE TO				250	STUDY ROOM	EXISTING TO REMAIN	EXISTING/CB-1	PNT-1	PNT-2	PNT-1	PNT-1	AC-1
RB-1	RUBBER BASE	ROPPE	700 SERIES TYPE TP	BEIGEWOOD (639)	4" COVE	REFER TO AE161 FOR LOCATION	251	STUDY ROOM	EXISTING TO REMAIN	EXISTING/CB-1	PNT-2	PNT-1	PNT-1	PNT-1	AC-1
SVB-1	SALVAGED SHEET VINYL				MATCH EXISTING	TOP EDGE DETAIL TO MATCH EXISTING, REFER TO AE161 FOR LOCATION	252	CLASSROOM	EXISTING TO REMAIN	EXISTING/CB-1	PNT-1	PNT-2 PNT-2	PNT-1	PNT-1	AC-1
LB-1	MARMOLEUM	FARBO	REAL	HORSE ROAN (3232)	HEIGHT, MATCH EXISTING	COVE BASE, TOP EDGING TO MATCH EXISTING	253	HALLWAY LAB	EXISTING TO REMAIN  SV-1	EXISTING/CB-1/RB-1	PNT-1/PNT-2	PNT-2	PNT-1	PNT-2 PNT-1	AC-1
PAINT							255	STORAGE	EXISTING TO REMAIN	EXISTING/CB-1/RB-1	PNT-1	PNT-1	PNT-1	PNT-1	AC-1
PNT-1	FIELD PAINT	BENJAMIN MOORE	COLOR: MANCHESTER TAN HC-81	EGGSHELL			_								
PNT-2	ACCENT PAINT	SHERWIN WILLIAMS	COLOR: RETREAT SW6207 (217-C5)	EGGSHELL											
PNT-3	HM PAINT	SHERWIN WILLIAMS	COLOR: NUTHATCH SW6088 (197-C5)	SEMI-GLOSS		HM DOOR FRAMES									
PNT-4	HM PAINT	BENJAMIN MOORE	COLOR: MANCHESTER TAN HC-81	SEMI-GLOSS		PARTITIONS									
PLASTIC LAMINATE			I		I										
PL-1	PLASTIC LAMINATE	FORMICA	GINGER ROOT MAPLE 7288-58	MATTE FINISH		CASEWORK									
PL-2	PLASTIC LAMINATE	FORMICA	NEUTRAL WEFT 5875-58	MATTE FINISH		PARTITIONS									
SOLID SURFACE															
SS-1	SOLID SURFACE	DUPONT CORIAN	SOLID SURFACE	BURLED BEACH	3/4" THICK	CONTACT PAULA AT HALLMARK BUILDING SUPPLIES: CELL-612-578-1788; EMA PAULA@HLLMARK.COM; OFFICE 800-274-7842 EXT. 527	IL								
ACOUSTICAL						·									
	ACOUSTICAL CEILING	ARMSTRONG	DUNE WITH 15/16" SQUARE EDGE; GRID: ARMSTRONG PRELUDE PLUS XL	WHITE	2' X 2'	ARMSTRONG SEISMIC JOINT CLIP SYSTEM INCLUDING BERC2 CLIP AS REQUIR	ED								

SANDERS ASSOCIATES ARCHITECTS
2668 Grant Avenue
Ogden, Utah 84401
Phone: 801.621.7303
www.sandersarch.com



CASEWORK CASEWORK
COUNTER CABINET

204 205

208 250

253 254 255

TC HEALTH TECHNOLOGY CTICAL NURSING EXPANS

200 N. WASHINGTON BLVD. OGDEN, UT 84404 Issued

No. Date Description

1 08/25/2020 DFCM PLAN REVIEW Revision /#
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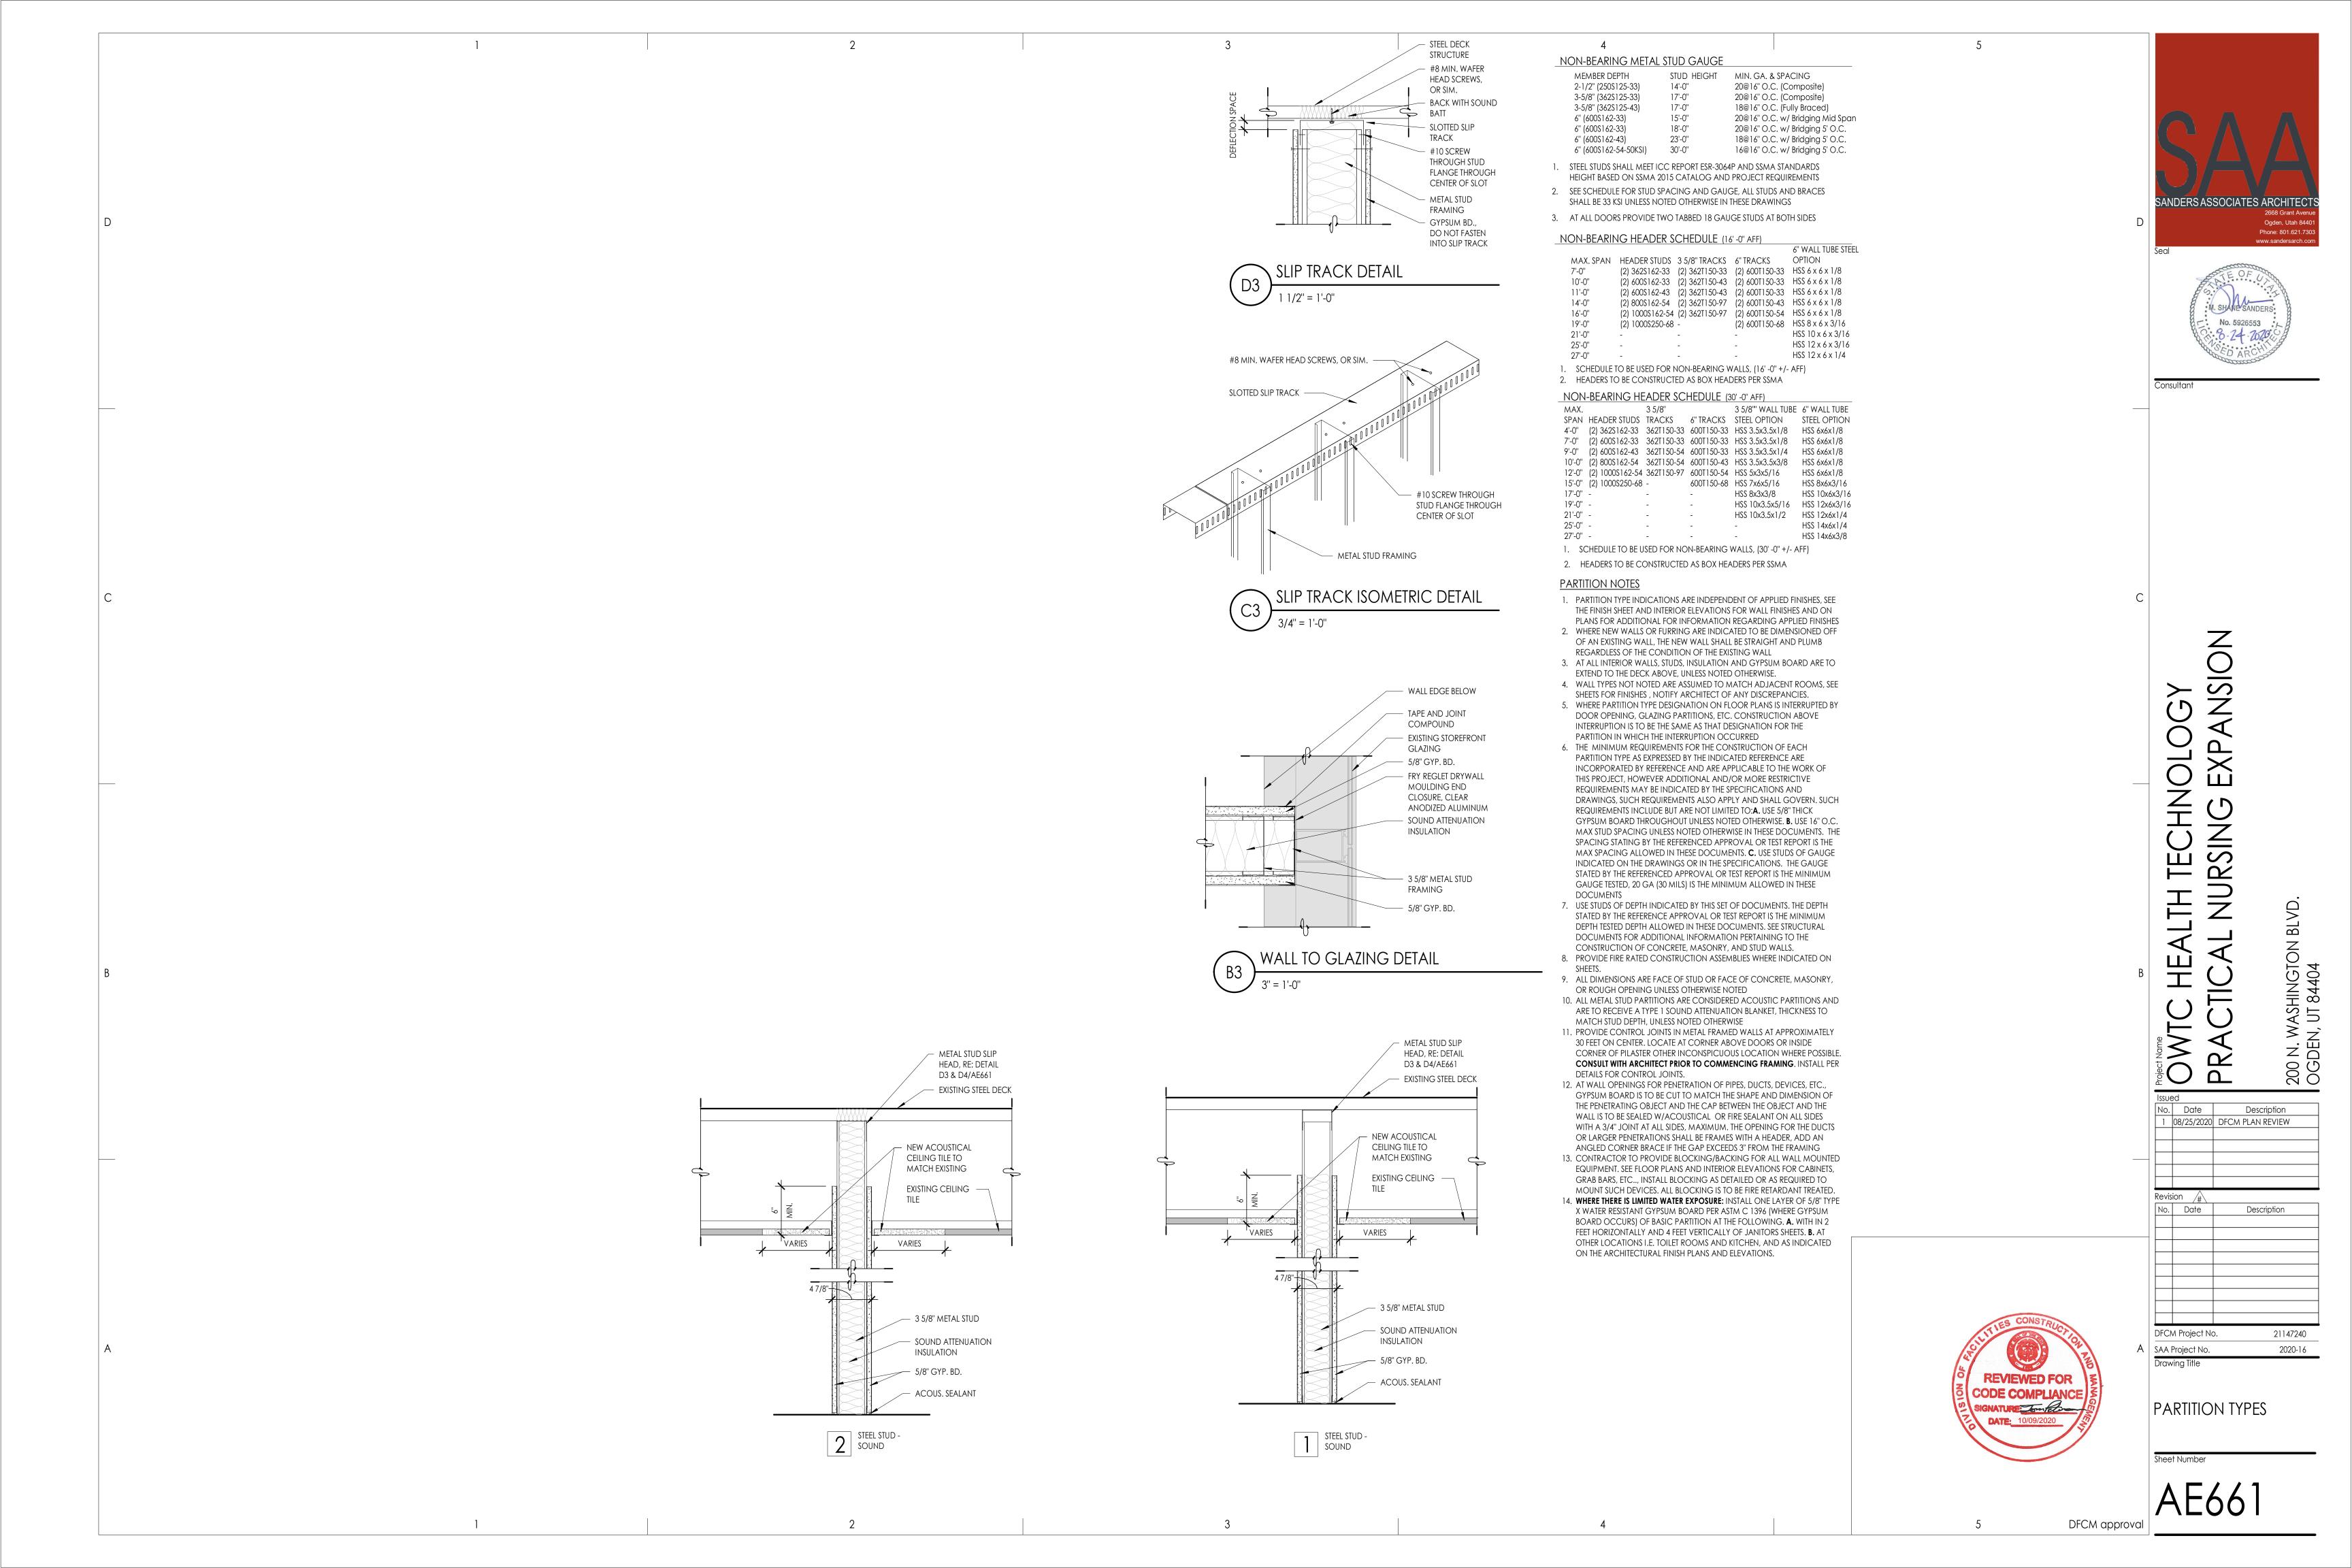
DFCM Project No. 21147240 A SAA Project No.

Drawing Title 2020-16

FINISH SCHEDULE

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Sheet Number



#### PLUMBING GENERAL NOTES

<u>G-1</u> - ALL PLUMBING SHALL BE INSTALLED AND CONFORM TO THE 2018 EDITION OF THE INTERNATIONAL PLUMBING CODE (IPC) WITH UTAH ANNOTATIONS AND LOCAL AUTHORITY REQUIREMENTS.

<u>G-2</u> - ALL PIPING MATERIALS SHALL MEET ALL REQUIREMENTS OF IPC AND LOCAL AUTHORITY. PLASTIC PIPING SHALL BE ALLOWED ONLY WHERE ALLOWED BY CODE. PLASTIC PIPING SHALL NOT BE ROUTED THROUGH RETURN AIR PLENUMS OR OTHER AREAS PROHIBITED BY THE IMC, IPC, OR NFPA CODES OR BY LOCAL AUTHORITY.

<u>G-3</u> - GAS PIPING INSTALLATION SHALL BE IN STRICT ACCORDANCE WITH GAS COMPANY REGULATIONS, NFPA CODE REQUIREMENTS, AND LOCAL AUTHORITY.

<u>G-4</u> - ALL MATERIALS SHALL BE NEW AND SHALL BE DOMESTIC MADE UNLESS SPECIFICALLY APPROVED OTHERWISE IN WRITING BY ARCHITECT OR OWNER.

<u>G-5</u> - PROVIDE VACUUM BREAKERS AND BACK FLOW PREVENTERS WHERE REQUIRED BY CODE OR WHERE THERE MAY BE ANY POSSIBLE CHANCE FOR CROSS CONTAMINATION. PREVENTERS SHALL BE INSTALLED IN ACCORDANCE WITH UTAH CODE.

<u>G-6</u> - ALL PLUMBING INFORMATION IS NOT LIMITED TO THE PLUMBING DRAWINGS. CONTRACTOR SHALL BE RESPONSIBLE FOR INFORMATION ON ALL OTHER CONSTRUCTION DOCUMENTS INCLUDING SPECIFICATIONS, ARCHITECTURAL DRAWING, STRUCTURAL DRAWINGS, MECHANICAL DRAWINGS, AND ELECTRICAL DRAWINGS.

<u>G-7</u> - THE WORKING DRAWINGS ARE DIAGRAMMATIC. BECAUSE OF THE SMALL SCALE OF THE DRAWING, THEY DO NOT SHOW EVERY OFFSET, BEND OR ELBOW NECESSARY FOR THE COMPLETE INSTALLATION IN THE SPACE PROVIDED. ALL PIPING SHALL BE CHECKED AND COORDINATED WITH THE SPECIFICATIONS, ARCHITECTURAL, STRUCTURAL, MECHANICAL, AND ELECTRICAL DRAWINGS.

<u>G-8</u> - COORDINATE ALL PIPING AND PLUMBING EQUIPMENT WITH ALL OTHER TRADES AND/OR CONTRACTORS PRIOR TO INSTALLATION.

<u>G-9</u> - ANY AND ALL ALTERATIONS TO THE SYSTEM SHOWN SHALL BE THE RESPONSIBILITY OF THIS CONTRACTOR AND ARCHITECT/ENGINEER SHALL BE NOTIFIED IN WRITING PRIOR TO CHANGES.

<u>G-10</u> - ALL WATER SYSTEMS SHALL MEET THE REQUIREMENTS OF ANSI/NSF STANDARD 61 SECTION 9 (1998), CONCERNING METAL CONTAMINANTS IN THE WATER SYSTEM.

<u>G-11</u>- WATER PIPING SHALL NOT BE ROUTED IN OUTSIDE WALLS OR ON EXTERIOR SIDE OF BUILDING INSULATION ENVELOPE.

<u>G-12</u> - WATER HAMMER ARRESTORS SHALL BE INSTALLED IN ALL WATER LINES WITH QUICK OPEN OR QUICK CLOSE VALVES.

WATER HAMMER ARRESTOR SCHEDULE:

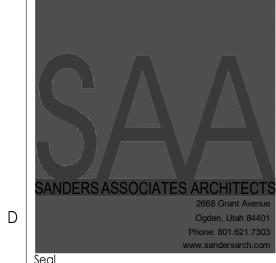
TYPE A 1-11 FIXTURE UNITS TYPE B 12-32 FIXTURE UNITS

TYPE C 33-60 FIXTURE UNITS

TYPE D 61-113 FIXTURE UNITS

<u>G-14</u> - ALL PIPING, MATERIALS, ETC. SHALL BE NEW AND <u>DOMESTIC</u> MADE UNLESS SPECIFICALLY AUTHORIZED IN WRITING PRIOR TO BID.

PLUMBING LEGEND							
MEANING	SYMBOL OR ABBREVIATION	MEANING	SYMBOL OR ABBREVIATION				
HOT WATER LINE	HW	WALL CLEANOUT	wco				
COLD WATER LINE	CW	CLEANOUT	СО				
HOT WATER RECIRCULATING LINE	HWREC	CLEANOUT TO GRADE	COTG				
VENT LINE	V	FLOOR CLEANOUT	FCO				
WASTE LINE	SS	BALL VALVE	Ф				
GAS LINE	G	UNION					
VENT THRU ROOF	VTR	CONNECTION TO EXISTING PIPING	<b>⊕</b>				
UNDER FLOOR	UF	REGULATOR	®				
SANITARY SEWER	SS	SOFT WATER	SW				
PRIMARY ROOF DRAIN	PRD	SECONDARY ROOF DRAIN	SRD				



8.24.20
WINWARD M.
PACKER
No. 375080

Consultant



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OWTC HEALTH TECHNOLOG NURSING EXPANSION

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OGDEN, UT 84404

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DFCM Project No.

SAA Project No.

Drawing Title

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PLUMBING LEGEND AND GENERAL NOTES

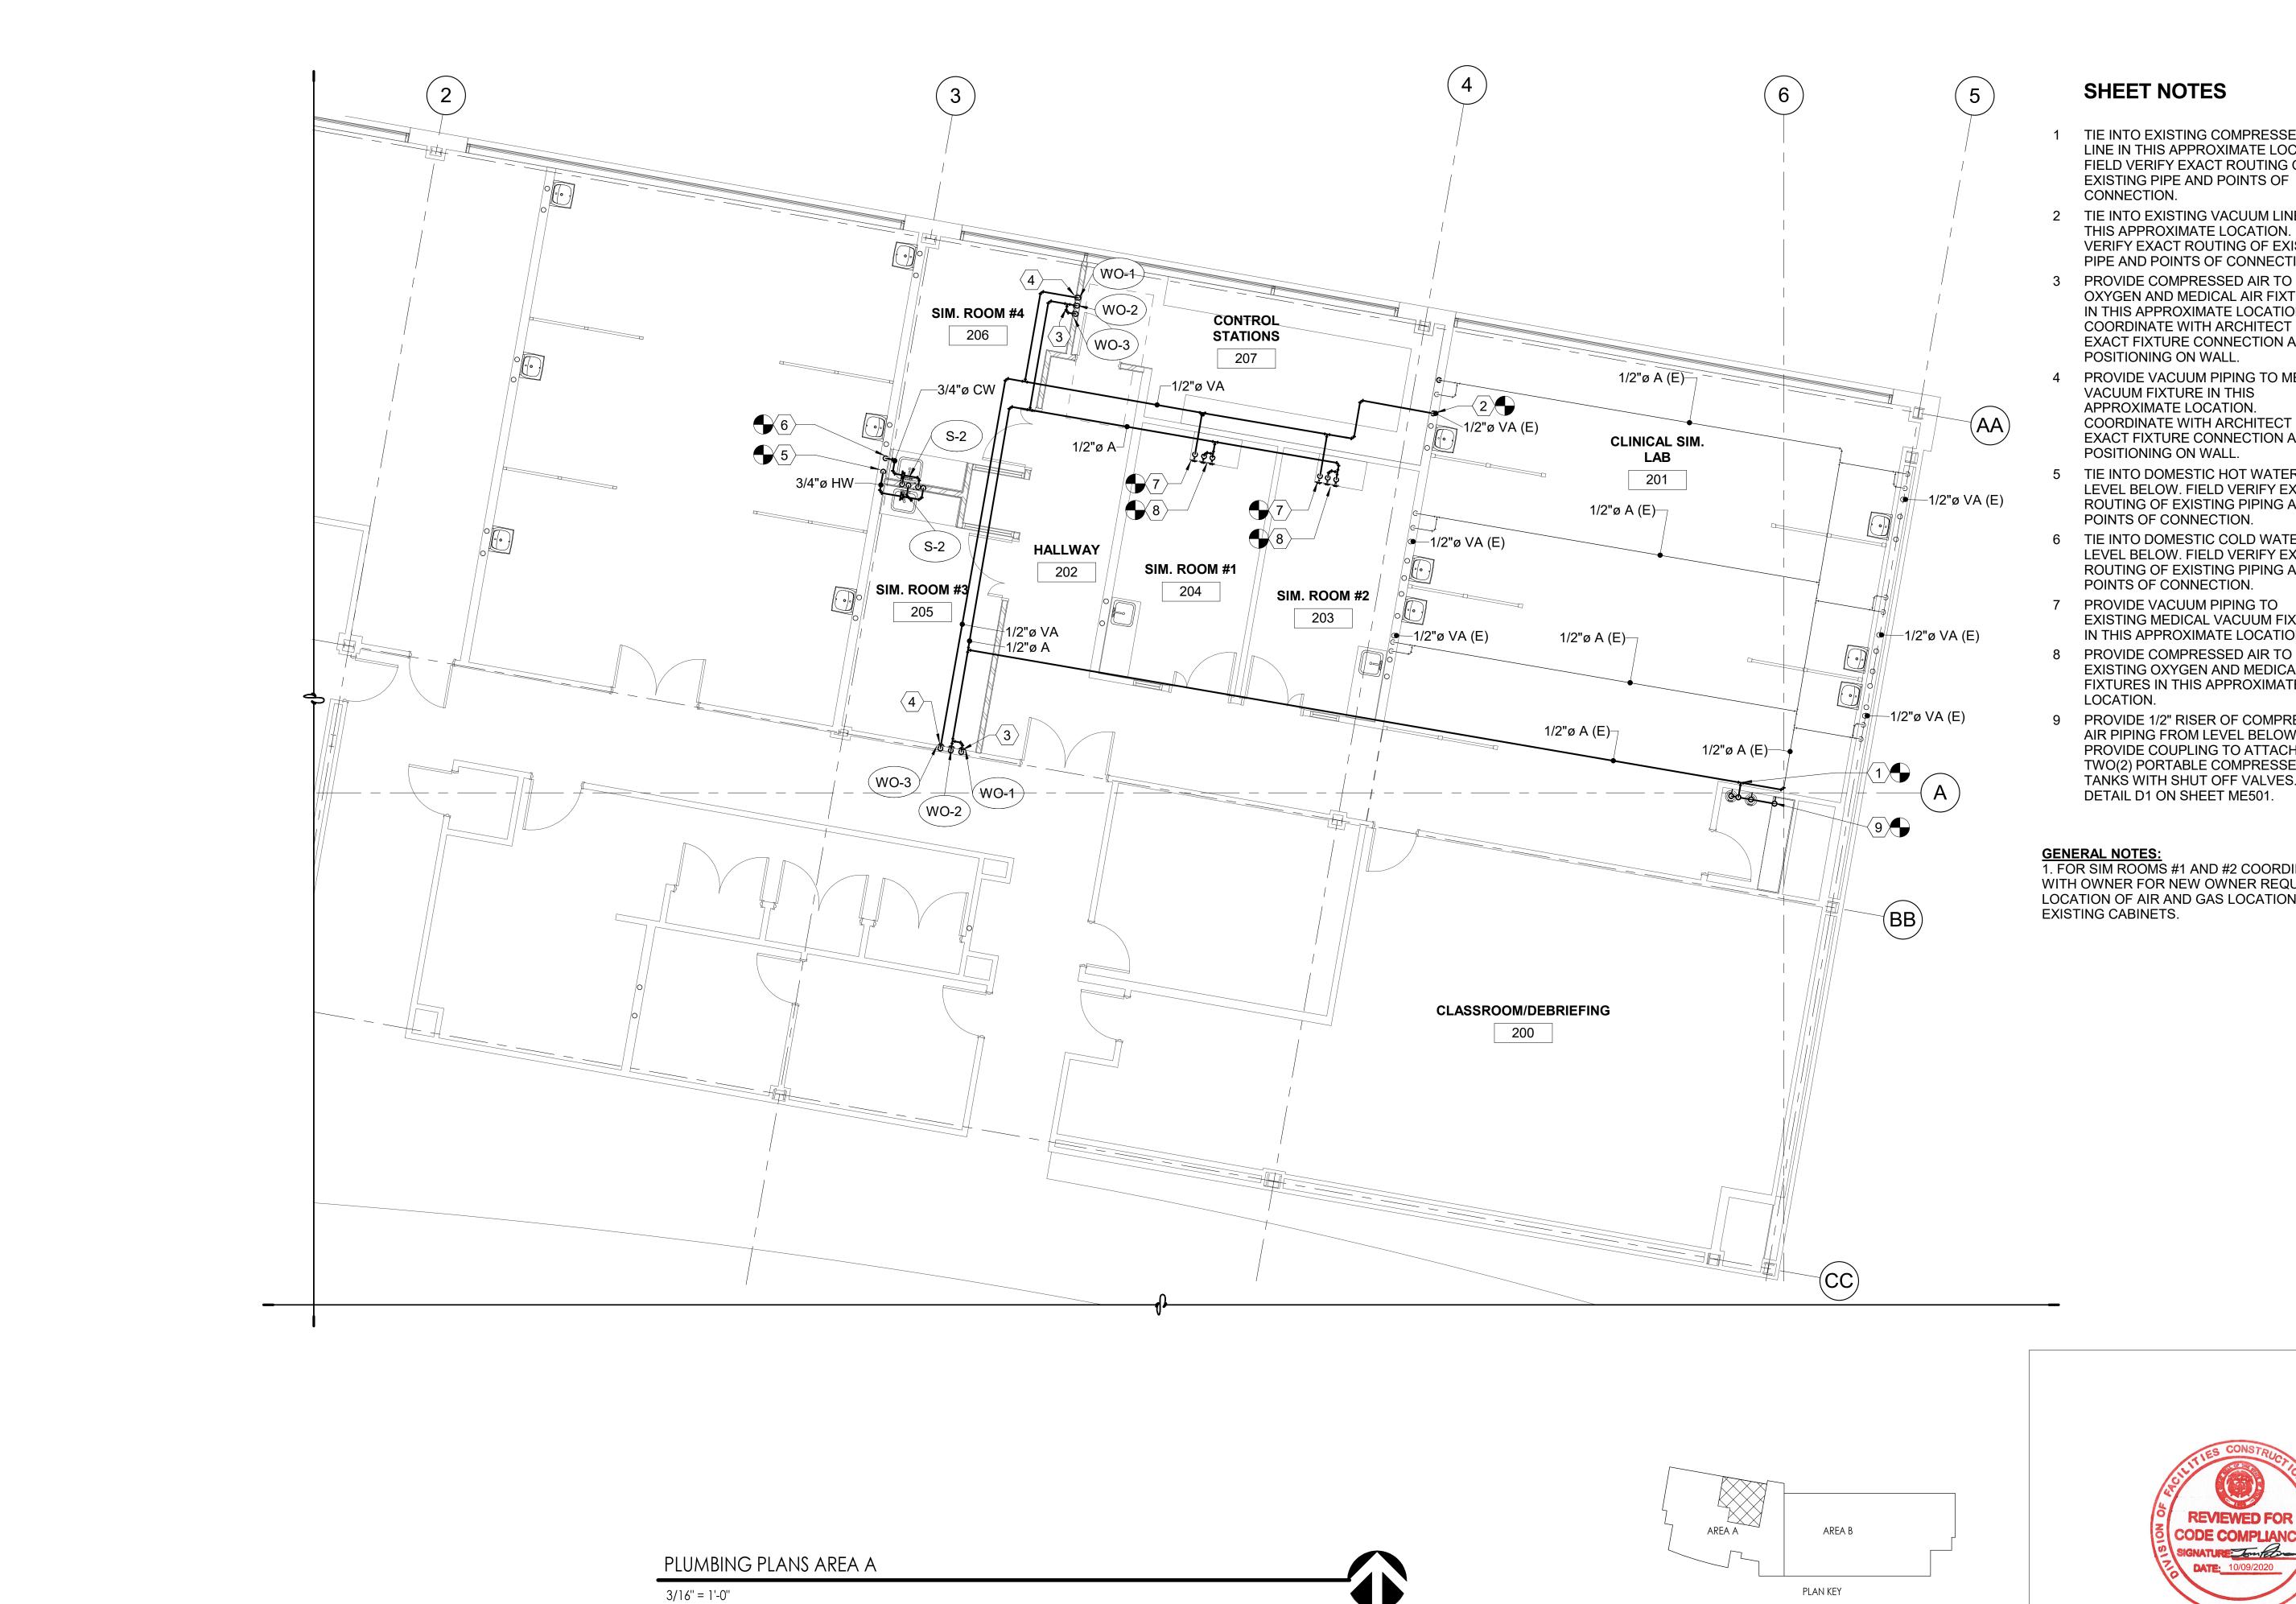
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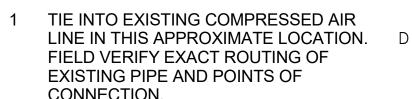
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PG001

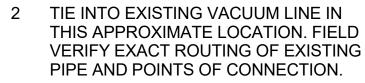
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**SHEET NOTES** 



(#)



- 3 PROVIDE COMPRESSED AIR TO BOTH OXYGEN AND MEDICAL AIR FIXTURES IN THIS APPROXIMATE LOCATION. COORDINATE WITH ARCHITECT FOR EXACT FIXTURE CONNECTION AND POSITIONING ON WALL.
- PROVIDE VACUUM PIPING TO MEDICAL VACUUM FIXTURE IN THIS APPROXIMATE LOCATION. COORDINATE WITH ARCHITECT FOR EXACT FIXTURE CONNECTION AND POSITIONING ON WALL.
- TIE INTO DOMESTIC HOT WATER ON LEVEL BELOW. FIELD VERIFY EXACT ROUTING OF EXISTING PIPING AND POINTS OF CONNECTION.
- 6 TIE INTO DOMESTIC COLD WATER ON LEVEL BELOW. FIELD VERIFY EXACT ROUTING OF EXISTING PIPING AND POINTS OF CONNECTION.
- 7 PROVIDE VACUUM PIPING TO EXISTING MEDICAL VACUUM FIXTURE IN THIS APPROXIMATE LOCATION.
- 8 PROVIDE COMPRESSED AIR TO BOTH EXISTING OXYGEN AND MEDICAL AIR FIXTURES IN THIS APPROXIMATE
- 9 PROVIDE 1/2" RISER OF COMPRESSED AIR PIPING FROM LEVEL BELOW. DETAIL D1 ON SHEET ME501.

GENERAL NOTES:

1. FOR SIM ROOMS #1 AND #2 COORDINATE WITH OWNER FOR NEW OWNER REQUIRED LOCATION OF AIR AND GAS LOCATIONS IN EXISTING CABINETS.

CSSIONAL ENC 8.24.20 WINWARD M. **PACKER** No. 375080

Consultant



ENGINEERING INC.

Email excellence@whw-engineering.com

8619 Sandy Parkway Suite 101 Sandy, Utah 84070 801-466-4021, fax 466-8536

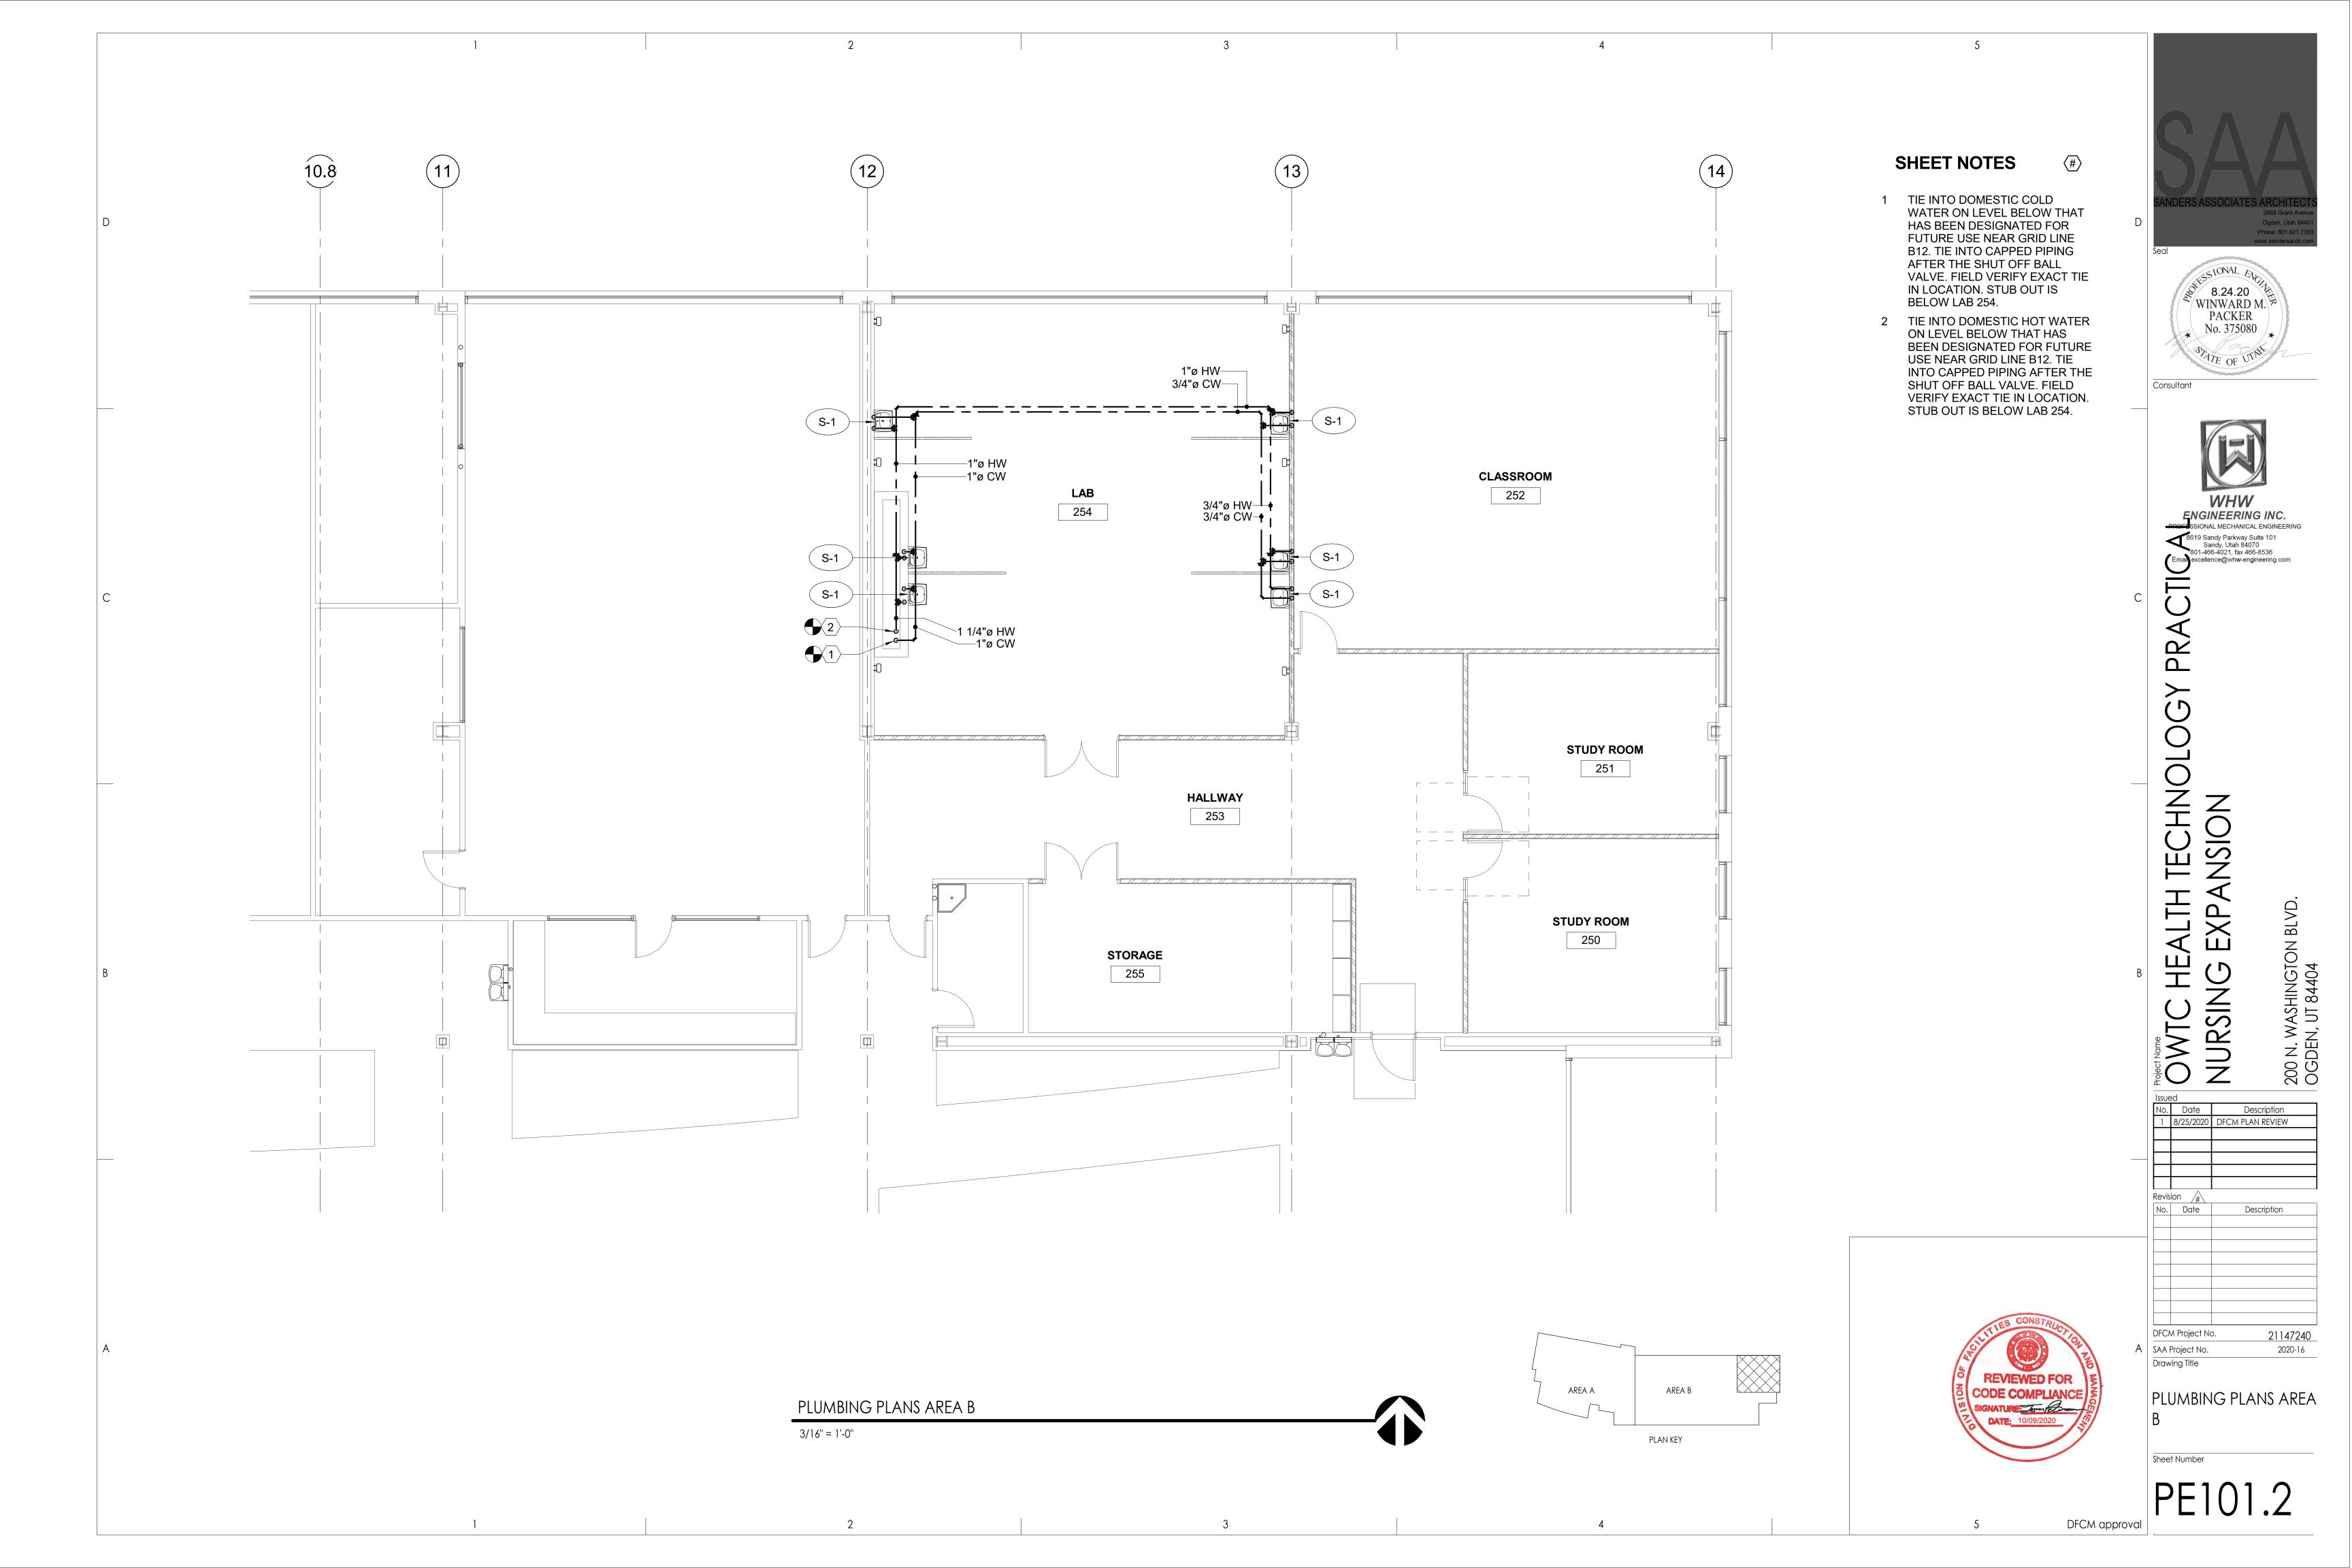
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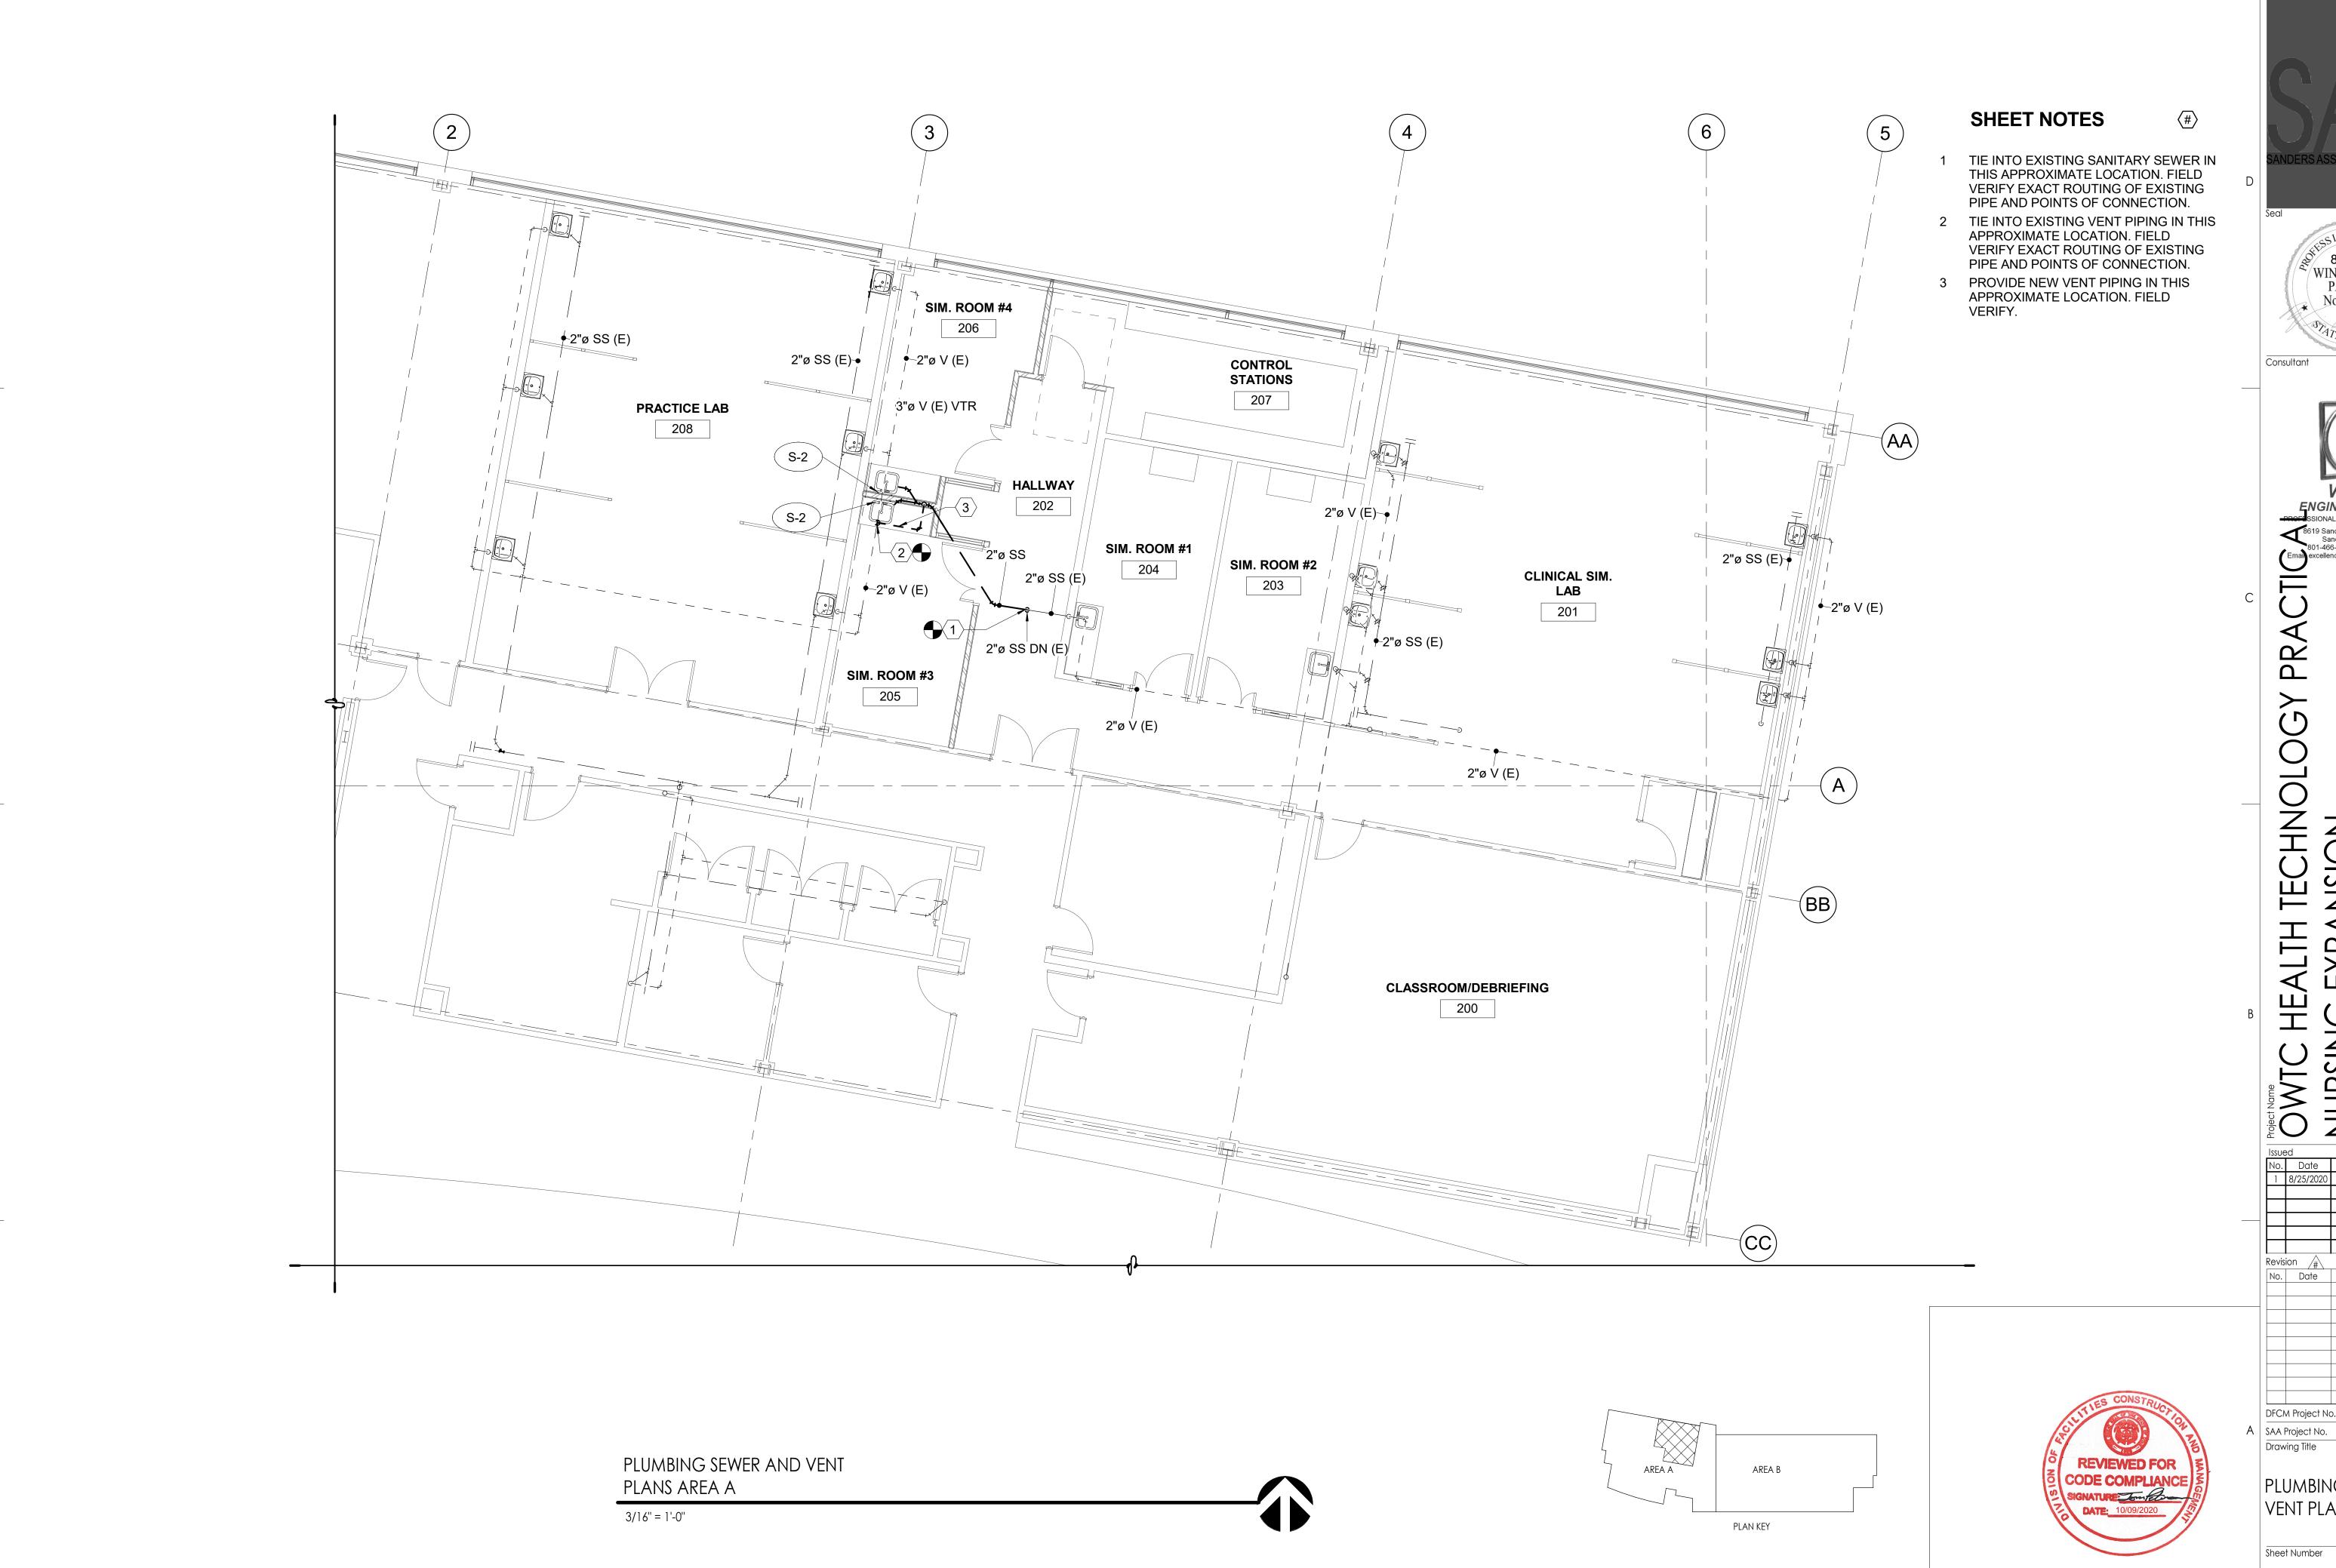
PROVIDE COUPLING TO ATTACH TO TWO(2) PORTABLE COMPRESSED AIR TANKS WITH SHUT OFF VALVES. SEE

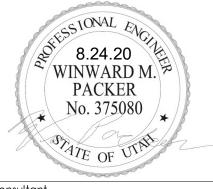
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Revis	ion /#	
No.	Date	Description
DFCI	M Project No	D. 21147240

PLUMBING PLANS AREA

Sheet Number







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PROFESSIONAL MECHANICAL ENGINEERING

8619 Sandy Parkway Suite 101 Sandy, Utah 84070 801-466-4021, fax 466-8536

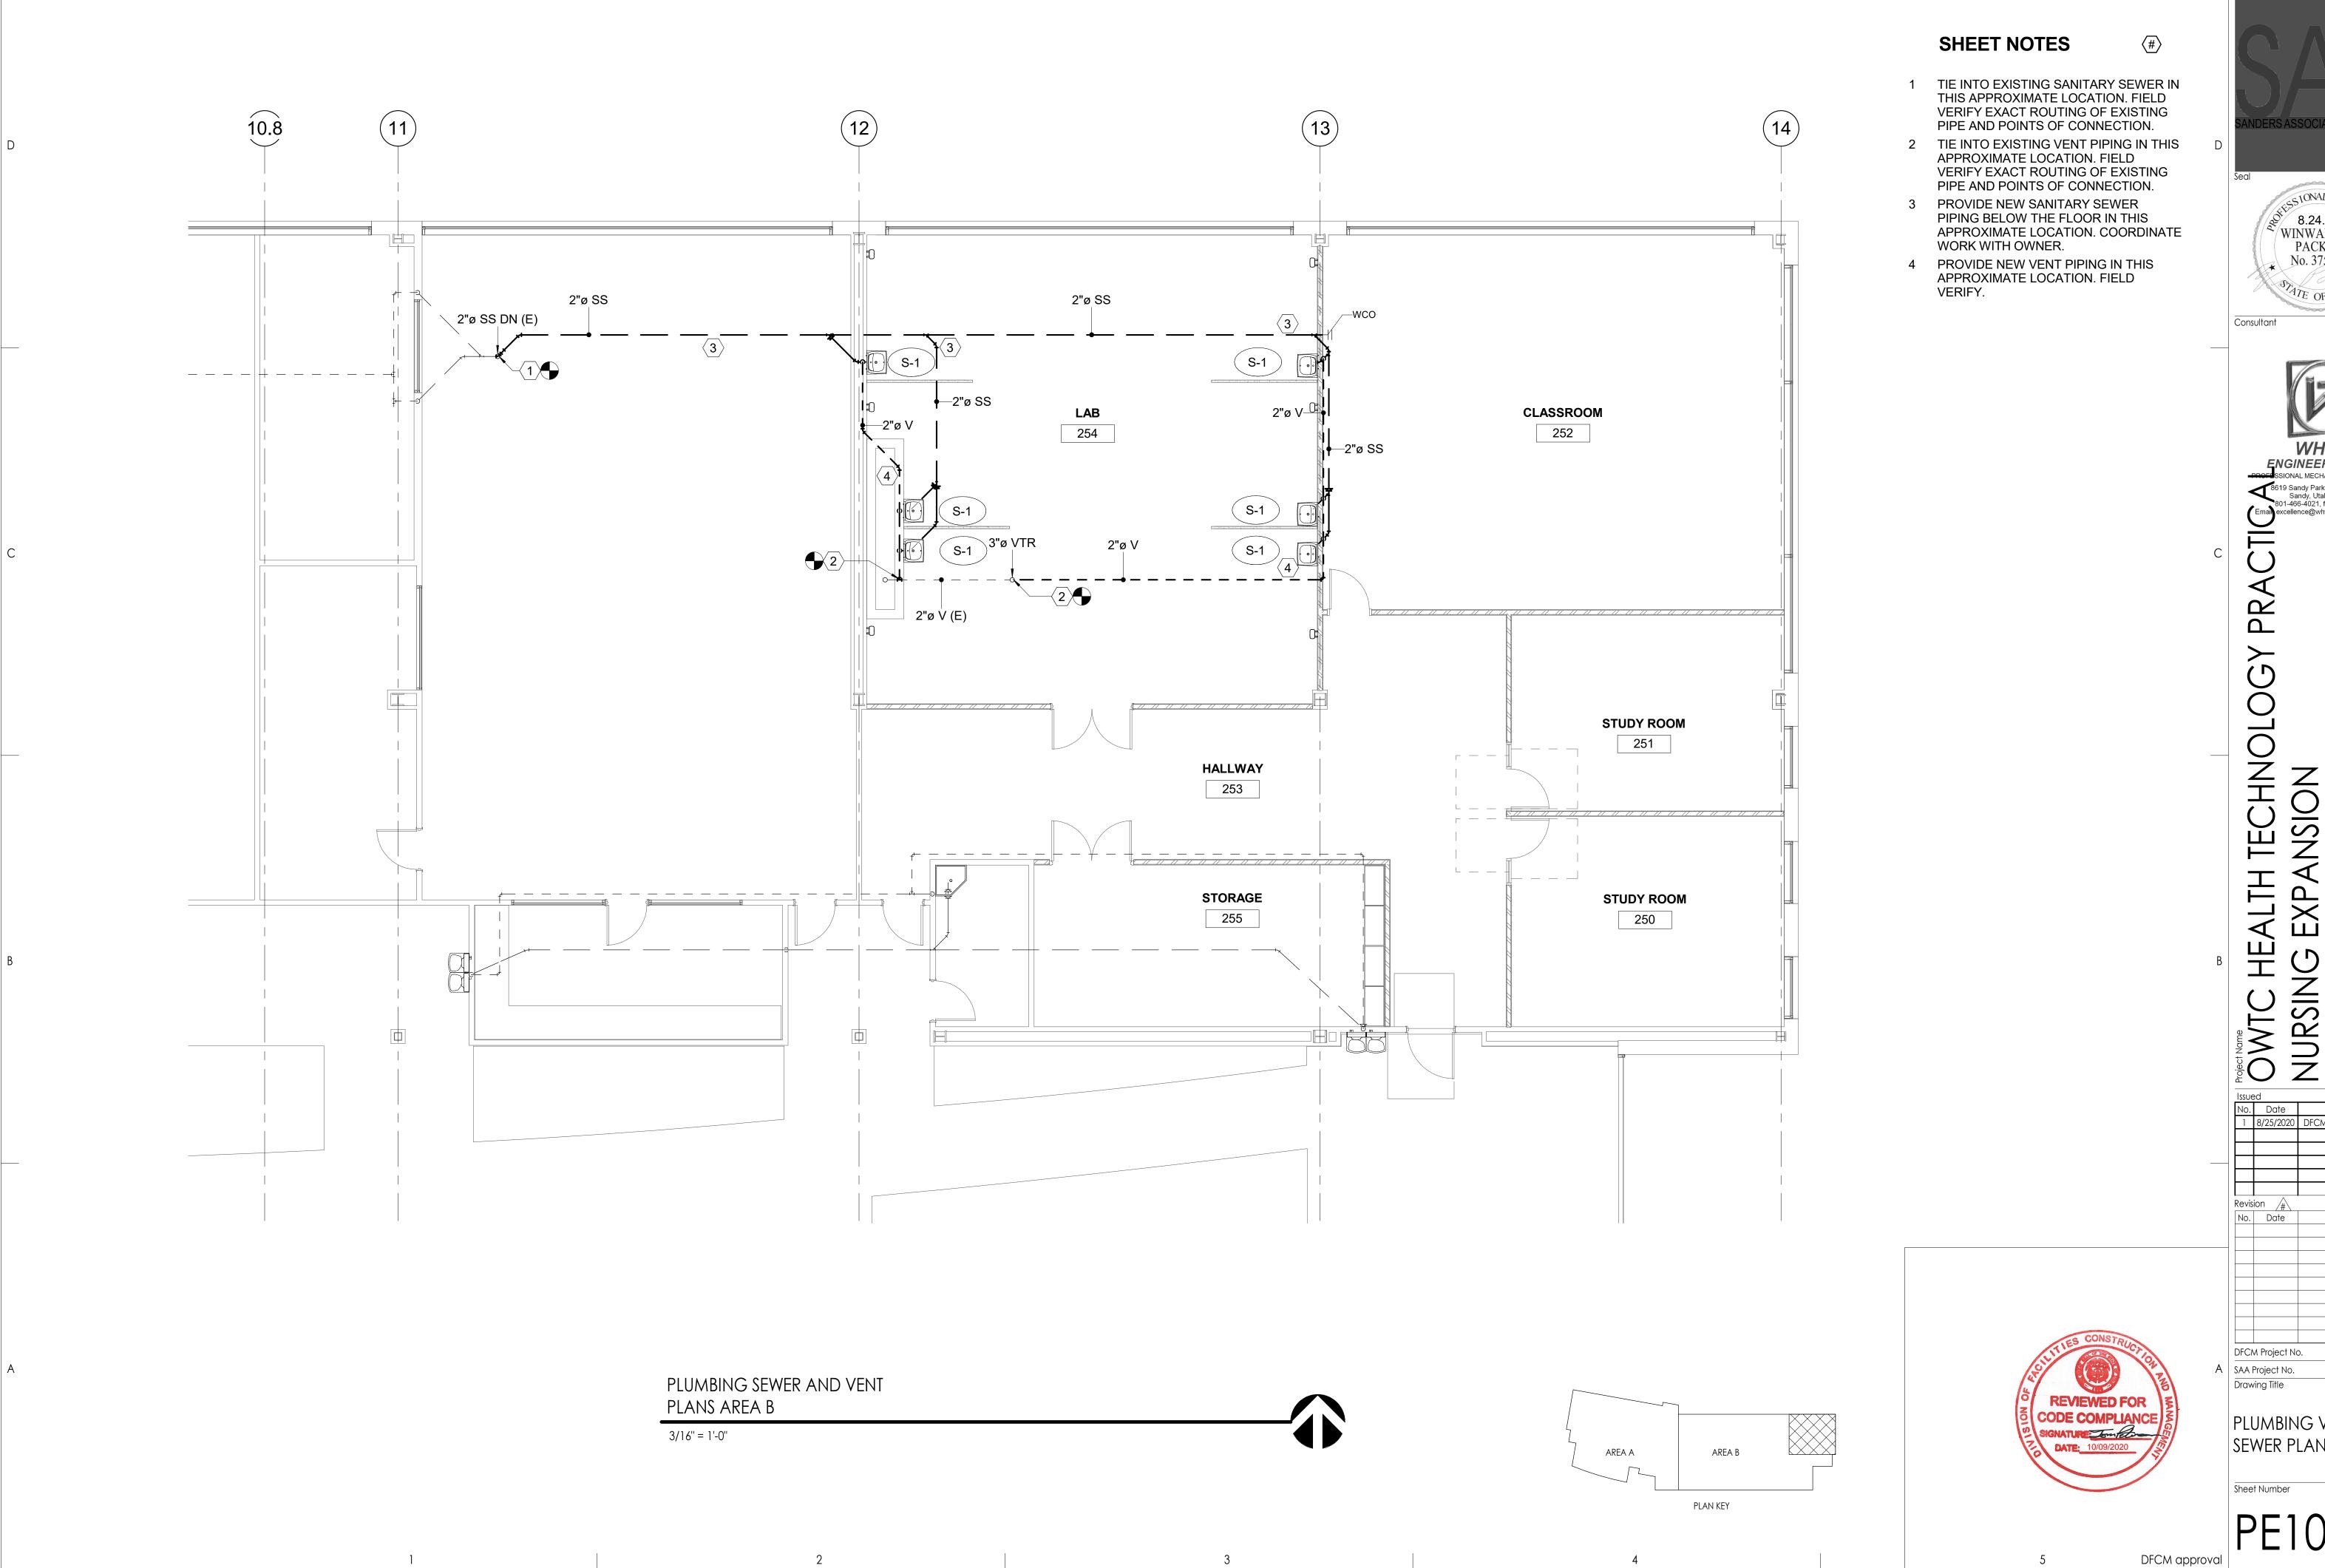
D. Date Description
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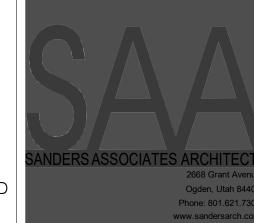
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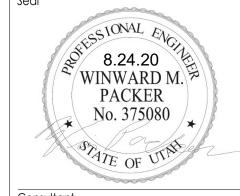
PLUMBING SEWER AND VENT PLANS AREA A

DFCM approval

PE102.1



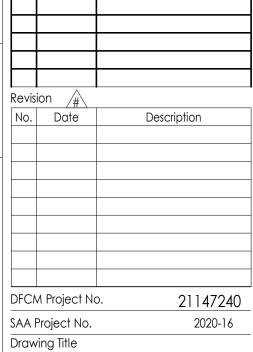




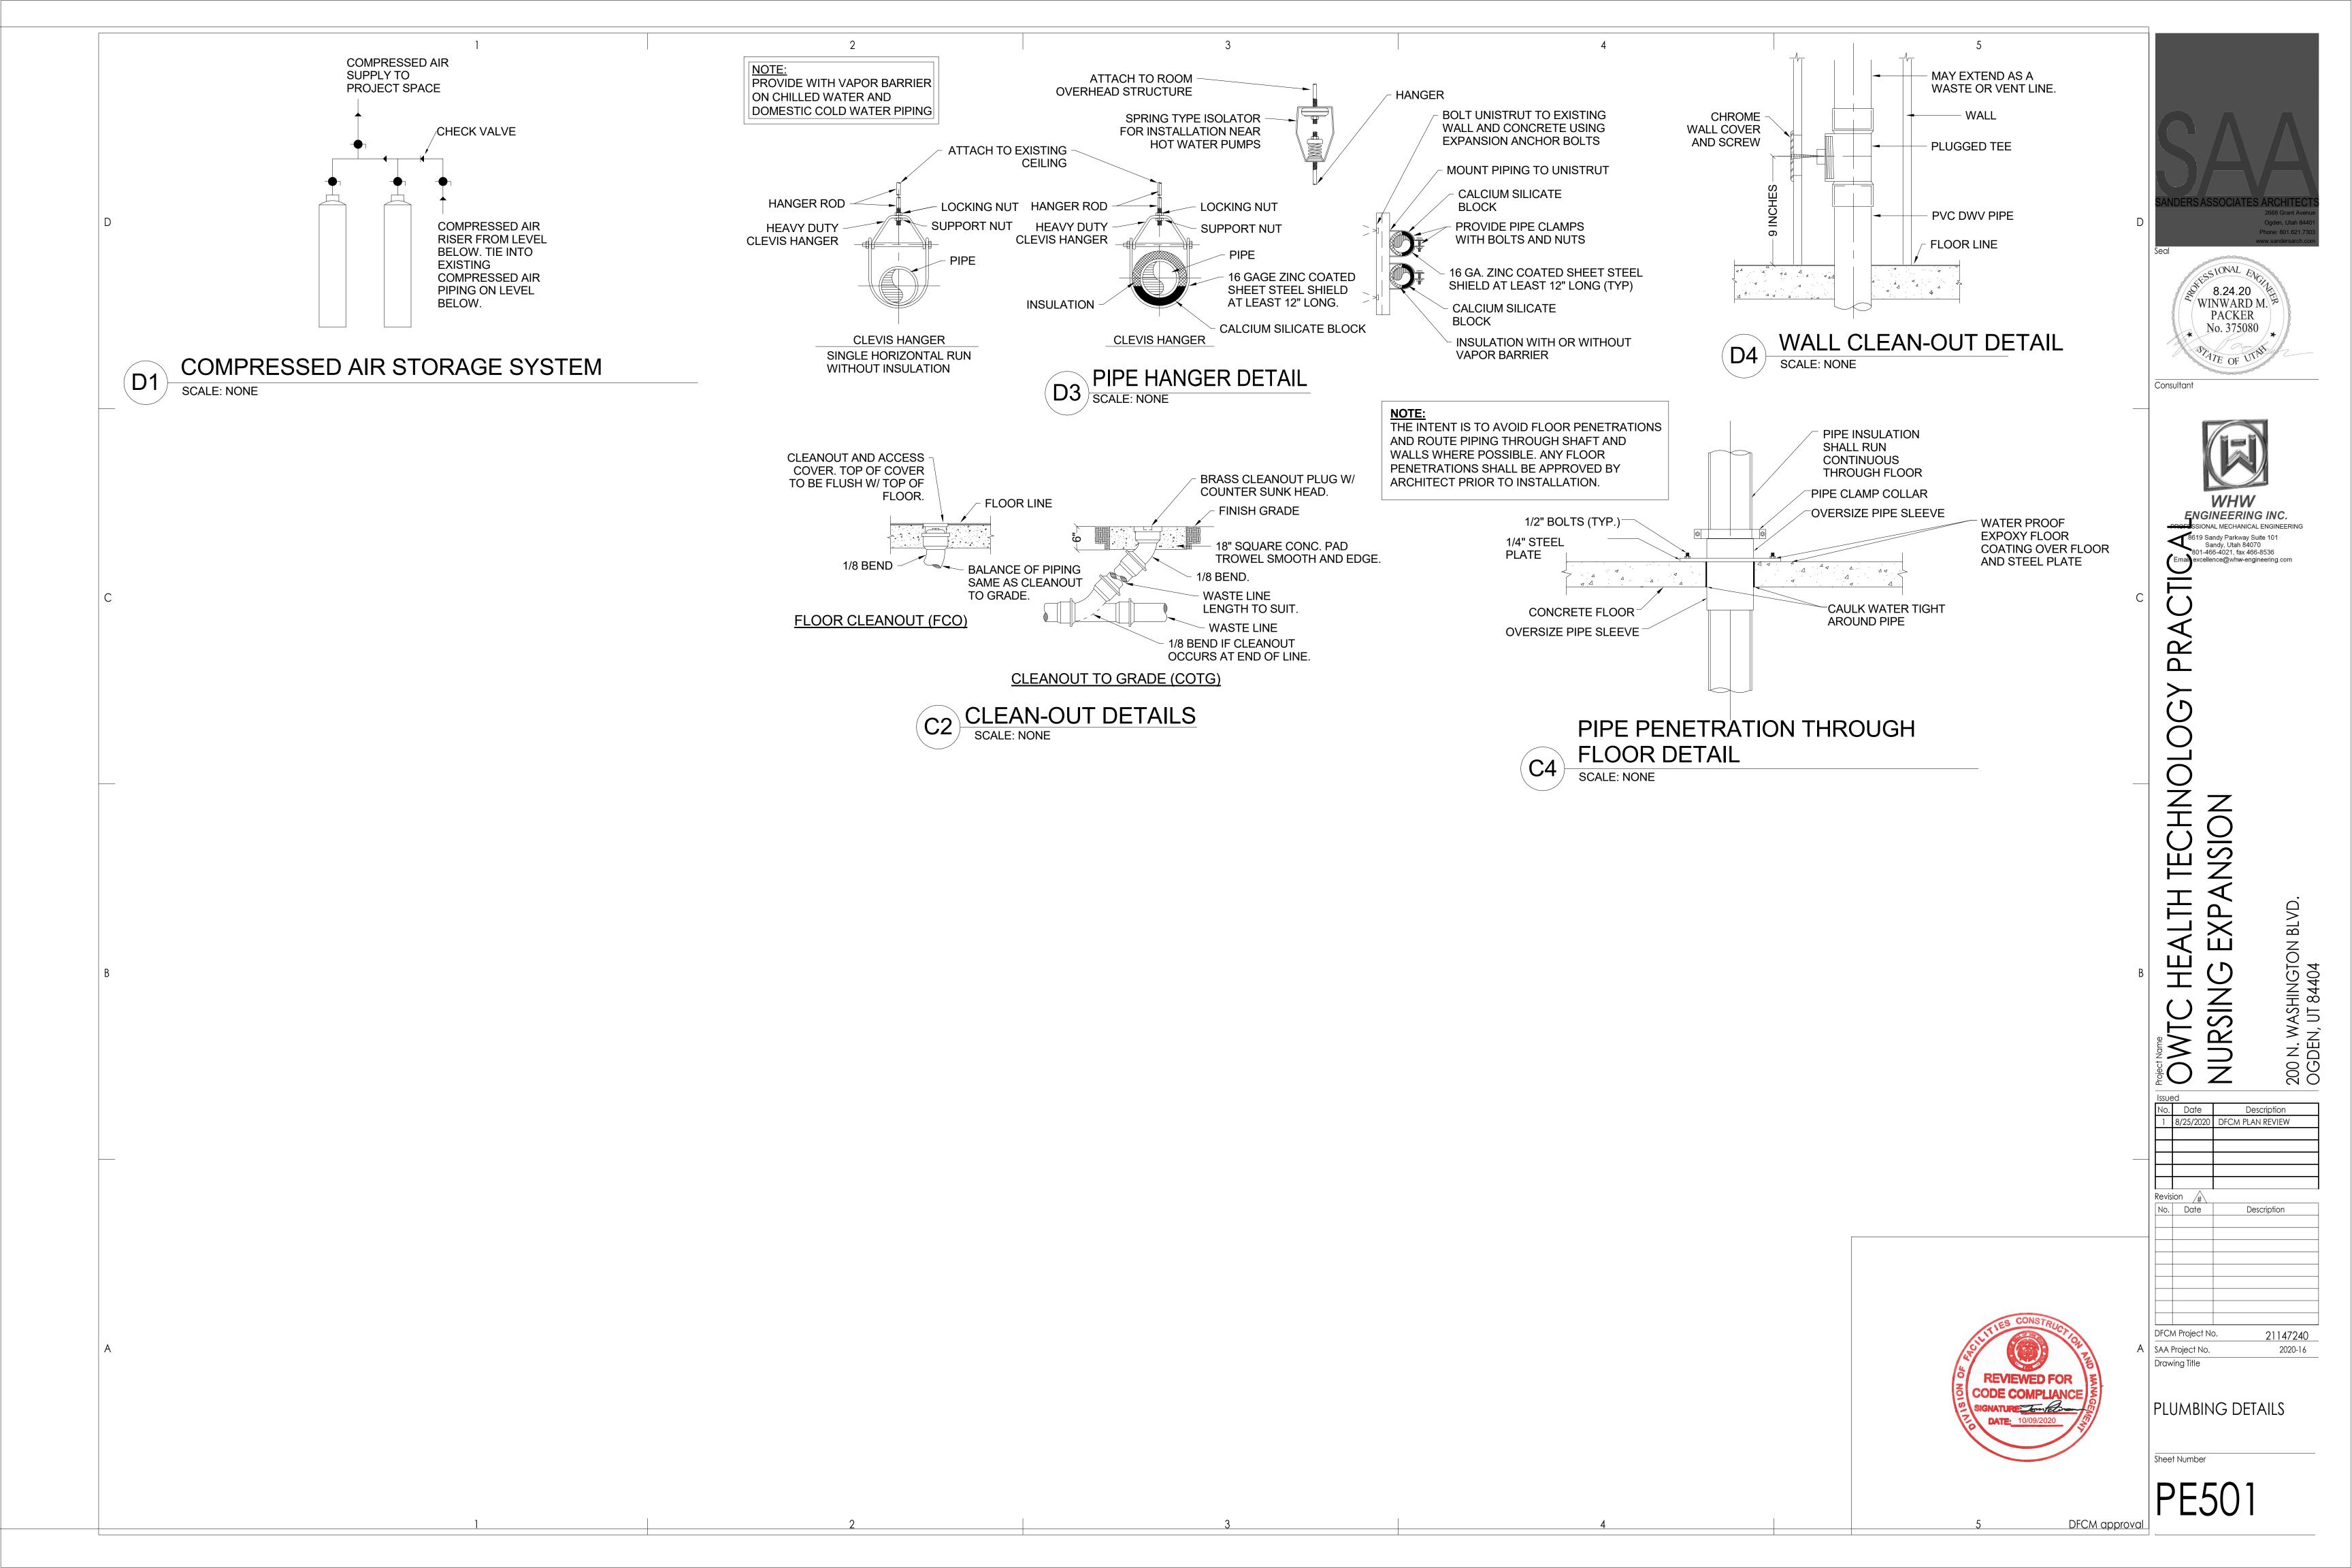


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PLUMBING VENT AND SEWER PLANS AREA B



PLUMBING FIXTURE SCHEDULE									TAG	
EQUIPMENT NUMBER	FIXTURE	TRAP	PL WASTE	UMBING PI VENT		HOT WATER	POINT OF USE MIXING VALVE?		REMARKS	SCHEDULE NOTES
S-1	SINK	1 1/2"	1 1/2"	1 1/2"	1/2"	1/2"	Yes	110 °F	PROVIDE A WALL MOUNTED SINK WITH THERMOSTATIC AND PRESSURE MIXING VALVE, KOHLER K-2005 OR EQUAL. PROVIDE WITH GOOSENECK STYLE FAUCET AND WRISTBLADE HANDLES, DELTA 3579LF-WFLGHDF OR EQUAL. 6" x 5 3/4" x 11"	1
S-2	SINK	1 1/2"	1 1/2"	1 1/2"	1/2"	1/2"	Yes	110 °F	COUNTER MOUNTED DROP IN STAINLESS STEEL SINK. JUST 18 GAUGE OR EQUAL. PROVIDE WITH THERMOSTATIC AND PRESSURE MIXING VALVE. PROVIDE WITH GOOSENECK STYLE FAUCET AND WRISTBLADE HANDLES, DELTA 3579LF-WFLGHDF OR EQUAL. 6" x 5 3/4" x 11".	1

1. SEE SPECIFICATIONS FOR OTHER APPROVED MANUFACTURERS.

MEDICAL WALL OUTLETS							
EQUIPMENT		PLUMBING PIPE SIZES		SCHEDULE			
NUMBER	FIXTURE		REMARKS	NOTES			
WO-1	OXYGEN	1/2"	AMICO OHMEDA WALL OUTLET MODEL O-QDWALM-U-OXY. COORDINATE WITH ARCHITECT FOR CONNECTION TYPE AND EXACT POSITIONING ON WALL.	1			
WO-2	MEDICAL AIR	1/2"	AMICO OHMEDA WALL OUTLET MODEL O-QDWALM-U-AIR. COORDINATE WITH ARCHITECT FOR CONNECTION TYPE AND EXACT POSITIONING ON WALL.	1			
WO-3	VACUUM	1/2"	AMICO OHMEDA WALL OUTLET MODEL O-QDWALM-U-VAC. COORDINATE WITH ARCHITECT FOR CONNECTION TYPE AND EXACT POSITIONING ON WALL.	1			

1. SEE SPECIFICATIONS FOR OTHER APPROVED MANUFACTUERS.



Consultant



PRA

Project Name
OWTC HE/
NURSING E

200 N. WASHINGTON BLVD. OGDEN, UT 84404 No. Date Description
1 8/25/2020 DFCM PLAN REVIEW Revision /#
No. Date Description

DFCM Project No. A SAA Project No.

Drawing Title

PLUMBING SCHEDULES

21147240 2020-16

Sheet Number

PE601

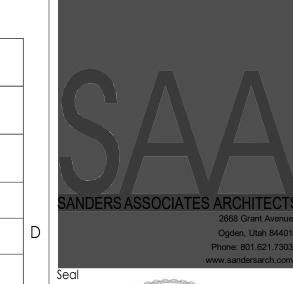
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#### **GENERAL NOTES**

**G-1** - MECHANICAL INFORMATION IS NOT LIMITED TO THE MECHANICAL DRAWINGS CONTRACTOR SHALL BE RESPONSIBLE FOR INFORMATION OF THE EXISTING BUILDING AND SITE CONDITIONS, EXISTING PIPING, EXISTING ELECTRICAL, AND EXISTING SUPPORTS.

- A EACH DRAWING SHEET AND THE SPECIFICATIONS HAVE BEEN PREPARED TO SUPPLEMENT EACH OTHER AND THEY SHALL BE INTERPRETED AS AN INTEGRAL UNIT WITH ITEMS SHOWN AND NOTED ON ONE AND NOT THE OTHER BEING FURNISHED AND INSTALLED AS THOUGH SHOWN AND CALLED OUT IN ALL PLACES. ITEMS IN SPECIFICATIONS OR DRAWINGS LISTED WHICH ARE DIFFERING IN EFFICIENCY OR QUALITY SHALL BE HELD TO THE GREATEST OF: EFFICIENCY, QUALITY OR GOVERNING CODE.
- B THE CONTRACTOR WILL BE HELD RESPONSIBLE FOR THE INSTALLATION OF THE SYSTEMS ACCORDING TO THE TRUE INTENT AND MEANING OF THE CONTRACT DOCUMENTS.
- C THE CONTRACTOR SHALL INSTALL ALL EQUIPMENT WITH PROPER SERVICE ACCESS AND CLEARANCES ACCORDING TO MANUFACTURERS RECOMMENDATIONS. THE CONTRACTOR SHALL REVIEW SUPPLIERS BID PACKAGES FOR COMPLETENESS AND COMPLIANCE TO THE SPECIFICATIONS, SCHEDULES, AND DESIGN INTENT (ALL EQUIPMENT AND METHODS). THE CONTRACTOR SHALL REMOVE AND REINSTALL CORRECTLY AT HIS OWN EXPENSE ANY EQUIPMENT NOT IN COMPLIANCE.
- D THE CONTRACTOR SHALL CONSULT MANUFACTURERS INSTALLATION INSTRUCTIONS FOR SIZES, METHODS, ACCESSORIES, AND CLEARANCES IN SPACE AVAILABLE PRIOR TO BIDDING PROJECT.
- E ANYTHING NOT CLEAR OR IN CONFLICT WILL BE EXPLAINED BY MAKING APPLICATION TO THE ENGINEER IN WRITING.
- **G-2** ANY AND ALL ALTERATIONS TO THE SYSTEM SHOWN SHALL BE SUBMITTED TO THE ENGINEER PRIOR TO CHANGES FOR APPROVAL. CONTRACTOR SHALL NOT START ANY CHANGES UNTIL NOTIFIED IN WRITING. IF CHANGES ARE MADE PRIOR TO APPROVAL CONTRACTOR SHALL TAKE ALL RESPONSIBILITY FOR THE CHANGES MADE AND ALL COSTS RELATING TO FAILURE OR REPLACEMENT OF ALTERATIONS.
- **G-3** CONTRACTOR SHALL FIELD VERIFY ALL DIMENSIONS AND LOCATIONS.
- **G-4** THE WORKING DRAWINGS ARE DIAGRAMMATIC. THEY DO NOT SHOW EVERY OFFSET, BEND, OR ELBOW NECESSARY FOR THE COMPLETE INSTALLATION IN THE SPACE PROVIDED. ALL LOCATIONS FOR MECHANICAL EQUIPMENT SHALL BE FIELD VERIFIED AND COORDINATED WITH ALL DRAWINGS. THE CONTRACTOR SHALL PROVIDE OR COORDINATE WITH THE GENERAL CONTRACTOR PROVISIONS FOR BLOCKOUTS OR CORE DRILLS THROUGH STRUCTURE.
- **G-5** THE INSTRUCTION TO "PROVIDE" ALSO INCLUDES INSTALLATION.
- **G-6** MECHANICAL CONTRACTOR SHALL PROVIDE AND INSTALL SMOKE AND FIRE DAMPERS AS REQUIRED BY LOCAL CODES AND AUTHORITIES.
- G-7 SHEET METAL DUCT SIZES SHOWN ON DRAWINGS ARE FREE AREA DIMENSIONS.
- G-8 PROVIDE AND INSTALL BALANCING DAMPERS IN ALL SUPPLY AND EXHAUST AIR BRANCH DUCTS. BALANCE TO CFM SHOWN ON PLAN.
- G-9 SEE ARCHITECTURAL REFLECTED CEILING PLAN FOR EXACT LOCATION OF DIFFUSERS AND GRILLES.
- **G-10** PROVIDE TURNING VANES IN ALL ELBOWS OF RECTANGULAR DUCT.
- **G-11** THE CONTRACTOR SHALL ASSUME ALL RESPONSIBILITY IN HANDLING AND DISPOSING OF REFRIGERANTS, OILS, ETC. ALL SUCH MATERIALS SHALL BE HANDLED, DISPOSED, AND USED IN ACCORDANCE WITH ALL LOCAL, STATE, AND FEDERAL LAWS.
- **G-12** THE MECHANICAL CONTRACTOR SHALL VERIFY MOTOR VOLTAGES WITH THE ELECTRICAL DRAWING BEFORE ORDERING MOTORIZED EQUIPMENT AND CONTROLS.
- **G-13** C.F.M. LISTED IS ACTUAL AIR.
- G-14 SUPPLIERS SHALL REVIEW ALL DRAWINGS AND THE SPECIFICATIONS PRIOR TO SUBMITTING PRICES TO THE CONTRACTOR. ALL QUESTIONS AND DISCREPANCIES SHALL BE BROUGHT TO THE ENGINEERS ATTENTION PRIOR TO BIDDING.
- **G-15** CONTRACTOR SHALL THOROUGHLY REVIEW AND SIGN SUBMITTALS FOR COMPLETENESS AND COMPLIANCE TO THE SPECIFICATIONS PRIOR TO ENGINEERS REVIEW. SUPPLIERS SHALL HIGHLIGHT OR MARK ALL INFORMATION REQUIRED TO SHOW COMPLIANCE TO THE SPECIFICATIONS. ALL REQUESTED EXCEPTIONS TO THE SPECIFICATIONS, OR SCHEDULES SHALL BE CLEARLY NOTED AND EXPLAINED. SUBMITTAL REVIEW AND ACCEPTANCE IS FOR DESIGN CONCEPT ONLY, AND DOES NOT AT ANY TIME RELIEVE THE CONTRACTOR OF RESPONSIBILITY TO MEET SPECIFICATIONS, CAPACITIES, OR DESIGN INTENT.
- **G-16** ALL MECHANICAL SHALL BE INSTALLED AND CONFORM TO THE 2018 EDITION OF THE IMC AND IPC WITH UTAH ANNOTATIONS AND LOCAL AUTHORITY REQUIREMENTS.
- G-17 THIS CONTRACTOR SHALL BE RESPONSIBLE FOR THE DRAINING DOWN AND RE-FILLING OF ALL SYSTEMS NECESSARY TO COMPLETE THE WORK OUTLINED BY THIS PROJECT. THIS INCLUDES PROVIDING THE REQUIRED CHEMICAL TREATMENT WHEN RE-FILLING THE SYSTEM.
- G-18 ALL PIPING, MATERIALS, ETC. SHALL BE NEW AND DOMESTIC MADE UNLESS SPECIFICALLY AUTHORIZED IN WRITING PRIOR TO BID.
- G-19 PROVIDE FIRE SPRINKLER MODIFICATIONS PER PERFORMANCE SPECIFICATION THROUGH NICET LEVEL 3 CERTIFIED DESIGN BUILD FIRE SPRINKLER CONTRACTOR.
- **G-20** THIS CONTRACTOR SHALL CONTRACT WITH A DESIGN BUILD ELECTRICAL CONTRACTOR FOR THE DESIGN AND CONSTRUCTION OF THE ELECTRICAL PORTION OF THIS PROJECT. ELECTRICAL INSTALLATION AND DESIGN SHALL BE PER 2017 NEC.

			<b></b>		MECHANICAL		
SYMBOL	ABR,	DESCRIPTION	SYMBOL	ABR,	DESCRIPTION	SYMBOL	A
^	GENE	ERAL TERMINOLOGY			AIR SIDE		
A		SECTION LETTER DESIGNATION	<u> </u>		EXISTING AIR DUCT TO BE REMOVED		
ME101		SECTION DRAWN ON THIS SHEET			EXISTING AIR DUCT TO REMAIN	R	
A2		DETAIL NUMBER DESIGNATION			NEW AIR DUCT		
		CORRESPONDING WITH GRID LOCATION	H		RECT TO RECT AIR DUCT TAKE-OFF	— [ <u>—</u>	
AH		MECHANICAL EQUIPMENT DESIGNATION			RECT TO RND AIR DUCT TAKE-OFF		
1		EQUIPMENT ITEM DESIGNATION			RND TO RND AIR DUCT TAKE-OFF		
D-1		REGISTER, GRILLE OR DIFFUSER			MEDIUM PRESSURE TAKE-OFF	- $$	
CFM		DESIGNATION WITH BALANCING CFM LISTED BELOW	HHHHHHH		FLEXIBLE AIR DUCT	—————————————————————————————————————	
		GRILLE OR LOUVER DESIGNATION			LINED DUCT	—ф—	
R-1		WHERE BALANCING NOT REQUIRED	Ü		RADIUS ELBOW	<u></u>	
$\triangle$		REVISION DESIGNATOR AND NUMBER			ECCENTRIC DUCT TRANSITION	<del>\</del>	
1		KEY NOTE DESIGNATOR AND NUMBER			CONCENTRIC DUCT TRANSITION		
•	POC	POINT OF CONNECTION			VOLUME DAMPER	***	
	POR	POINT OF REMOVAL			SUPPLY AIR DIFFUSER	<u> </u>	
AFF		ABOVE FINISHED FLOOR			RETURN & TRANSFER AIR GRILLE		
AP		ACCESS PANEL			EXHAUST GRILLE OR CEILING EXH. FAN	<u>_</u>	
C EL.		CENTERLINE ELEVATION			RETURN & OUTSIDE AIR DUCT UP/DN	———	
GC		GENERAL CONTRACTOR			RETURN & OA ROUND DUCT UP/DN	T	
MC		MECHANICAL CONTRACTOR			SUPPLY AIR UDCT UP/DN		
ATC		CONTROLS CONTRACTOR			SUPPLY AIR ROUND DUCT UP/DN		
EC		ELECTRICAL CONTRACTOR			EXHAUST AIR DUCT UP/DN		
FPC		FIRE PROTECTION CONTRACTOR			EXHAUST AIR ROUND DUCT UP/DN		
NIC		NOT IN CONTRACT		AP	ACCESS PANEL		
NTS		NOT TO SCALE	[		EXISTING EQUIPMENT TO BE REMOVED		
С		COMMON			EXISTING EQUIPMENT TO REMAIN		
NC		NORMALLY CLOSED			NEW EQUIPMENT		
NO		NORMALLY OPEN	SA		SUPPLY AIR		
			RA		RETURN AIR		
			EA		EXHAUST AIR		
			FO		FLAT OVAL		
			T	T-STAT	WALL MOUNTED THERMOSTAT		
			S		WALL MOUNTED TEMP. SENSOR		
			F	F-STAT	WALL MOUNTED FIRESTAT		
			(C)	CO2	CARBON DIOXIDE SENSOR		



ABR,

WET SIDE

PITCH DOWN

ELBOW UP/DN

TEE UP/DN

NEW PIPING

PIPE CAP OR PLUG

ANCHOR POINT

FLEXIBLE CONNECTION

CULINARY COLD WATER

CULINARY HOT WATER

HEATING WATER SUPPLY

HEATING WATER RETURN

CULINARY HOT WATER RECIRC

DESCRIPTION

EXISTING PIPING TO BE REMOVED

REDUCER - CONCENTRIC / ECCENTRIC

EXISTING PIPING TO REMAIN

SYMBOL

 $\bigcirc$ 

 $\overline{-}$ 

 $\longrightarrow$ 

\_\_\_\_\_

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ABR,

WET SIDE

REGULATOR

BUTTERFLY VALVE

CHECK VALVE

BALL VALVE

STRAINER

THERMOWELL

PRESSURE & TEMP TAP

DIRECTION OF FLOW

PUMP

DESCRIPTION

MOTORIZED 2-WAY CONTROL VALVE

MOTORIZED 3-WAY CONTROL VALVE

CIRCUIT BALANCING VALVE

STRAINER W/ PLUG BLOW OFF

THERMOMETER & THERMOWELL

PRESSURE GAUGE W/ COCK - WATER

**AUTOMATIC AIR VENT** 

MANUAL AIR VENT

8.24.20 WINWARD M. PACKER No. 375080

Consultant

<u>\_</u>

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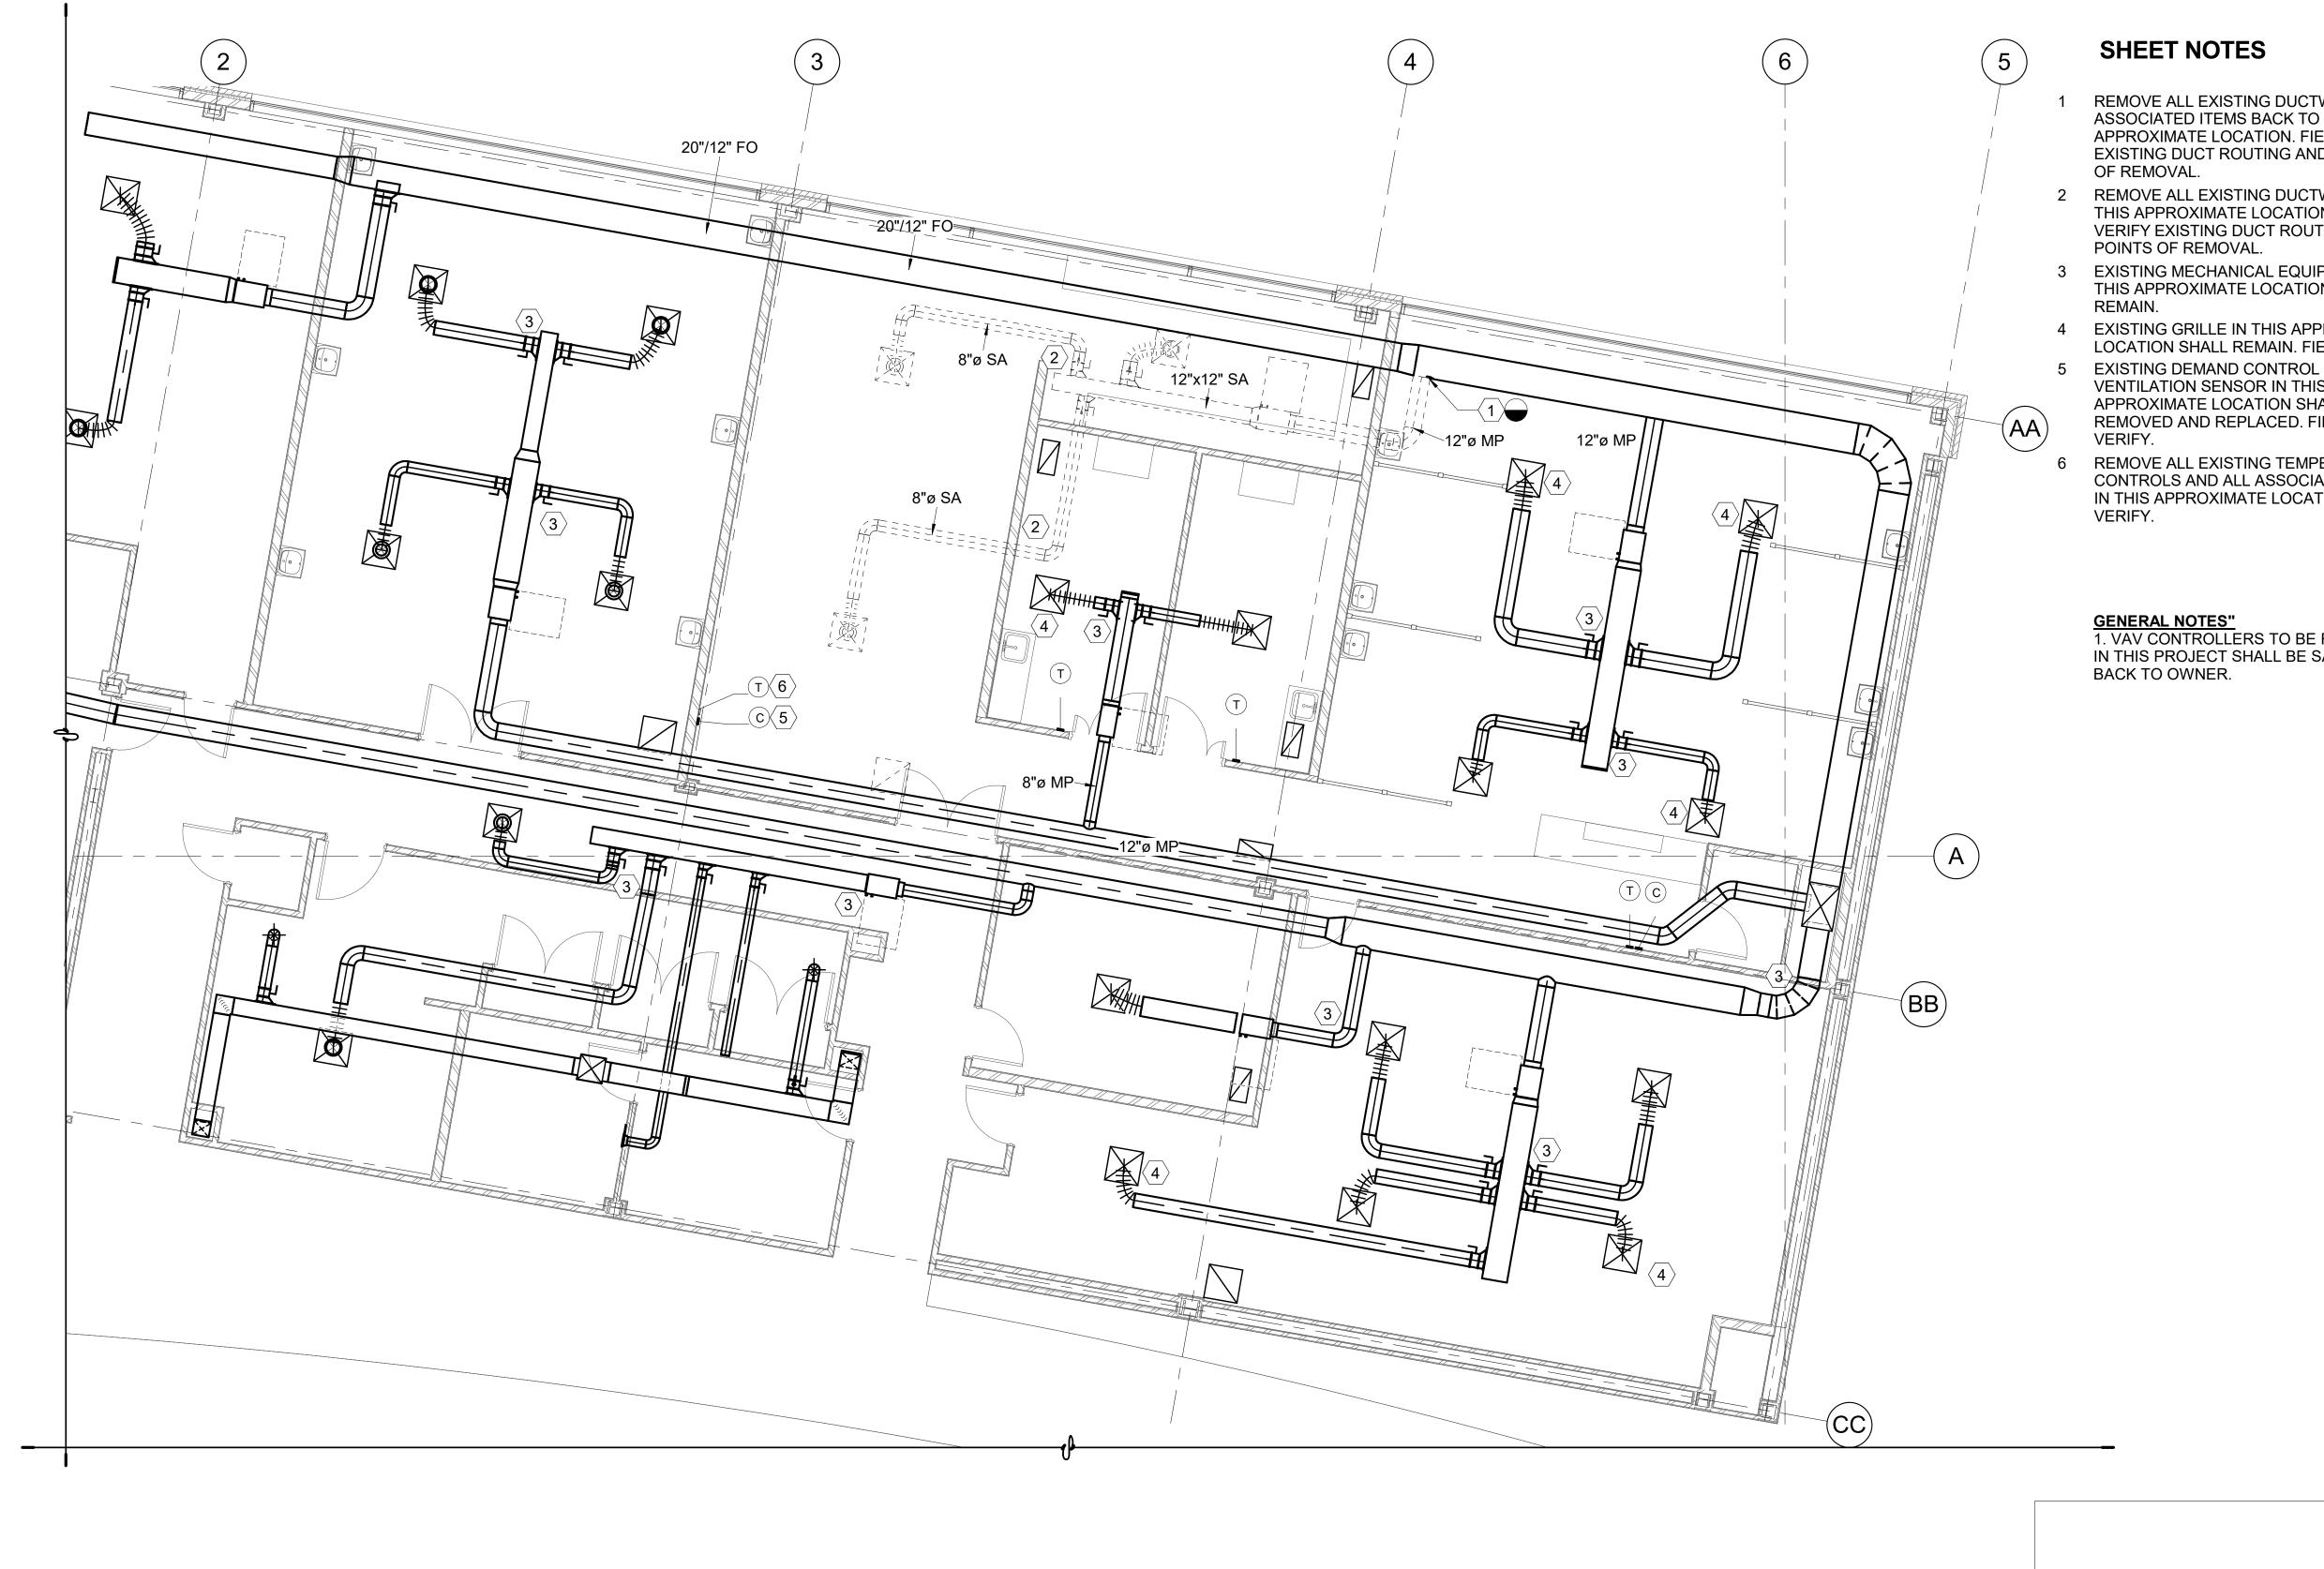
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8/25/2020 DFCM PLAN REVIEW

MECHANICAL GENERAL NOTES AND LEGEND

Sheet Number



**SHEET NOTES** 

REMOVE ALL EXISTING DUCTWORK AND D ASSOCIATED ITEMS BACK TO THIS APPROXIMATE LOCATION. FIELD VERIFY EXISTING DUCT ROUTING AND POINTS OF REMOVAL.

- 2 REMOVE ALL EXISTING DUCTWORK IN THIS APPROXIMATE LOCATION. FIELD VERIFY EXISTING DUCT ROUTING AND POINTS OF REMOVAL.
- 3 EXISTING MECHANICAL EQUIPMENT IN THIS APPROXIMATE LOCATION SHALL
- 4 EXISTING GRILLE IN THIS APPROXIMATE LOCATION SHALL REMAIN. FIELD VERIFY.
- VENTILATION SENSOR IN THIS APPROXIMATE LOCATION SHALL BE REMOVED AND REPLACED. FIELD
- REMOVE ALL EXISTING TEMPERATURE CONTROLS AND ALL ASSOCIATED ITEMS IN THIS APPROXIMATE LOCATION. FIELD

8.24.20 WINWARD M. **PACKER** No. 375080

Consultant



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GENERAL NOTES"

1. VAV CONTROLLERS TO BE REMOVED IN THIS PROJECT SHALL BE SALVAGED BACK TO OWNER.

**\_** 

Date Description 8/25/2020 DFCM PLAN REVIEW

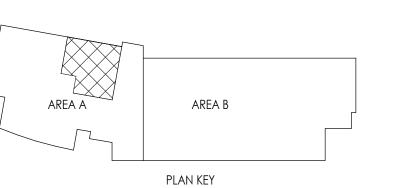
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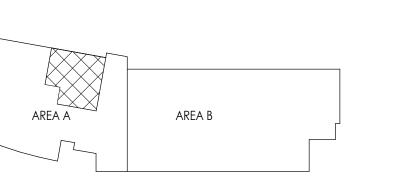
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Drawing Title

MECHANICAL LEVEL 2 DEMOLITION PLANS AREA A

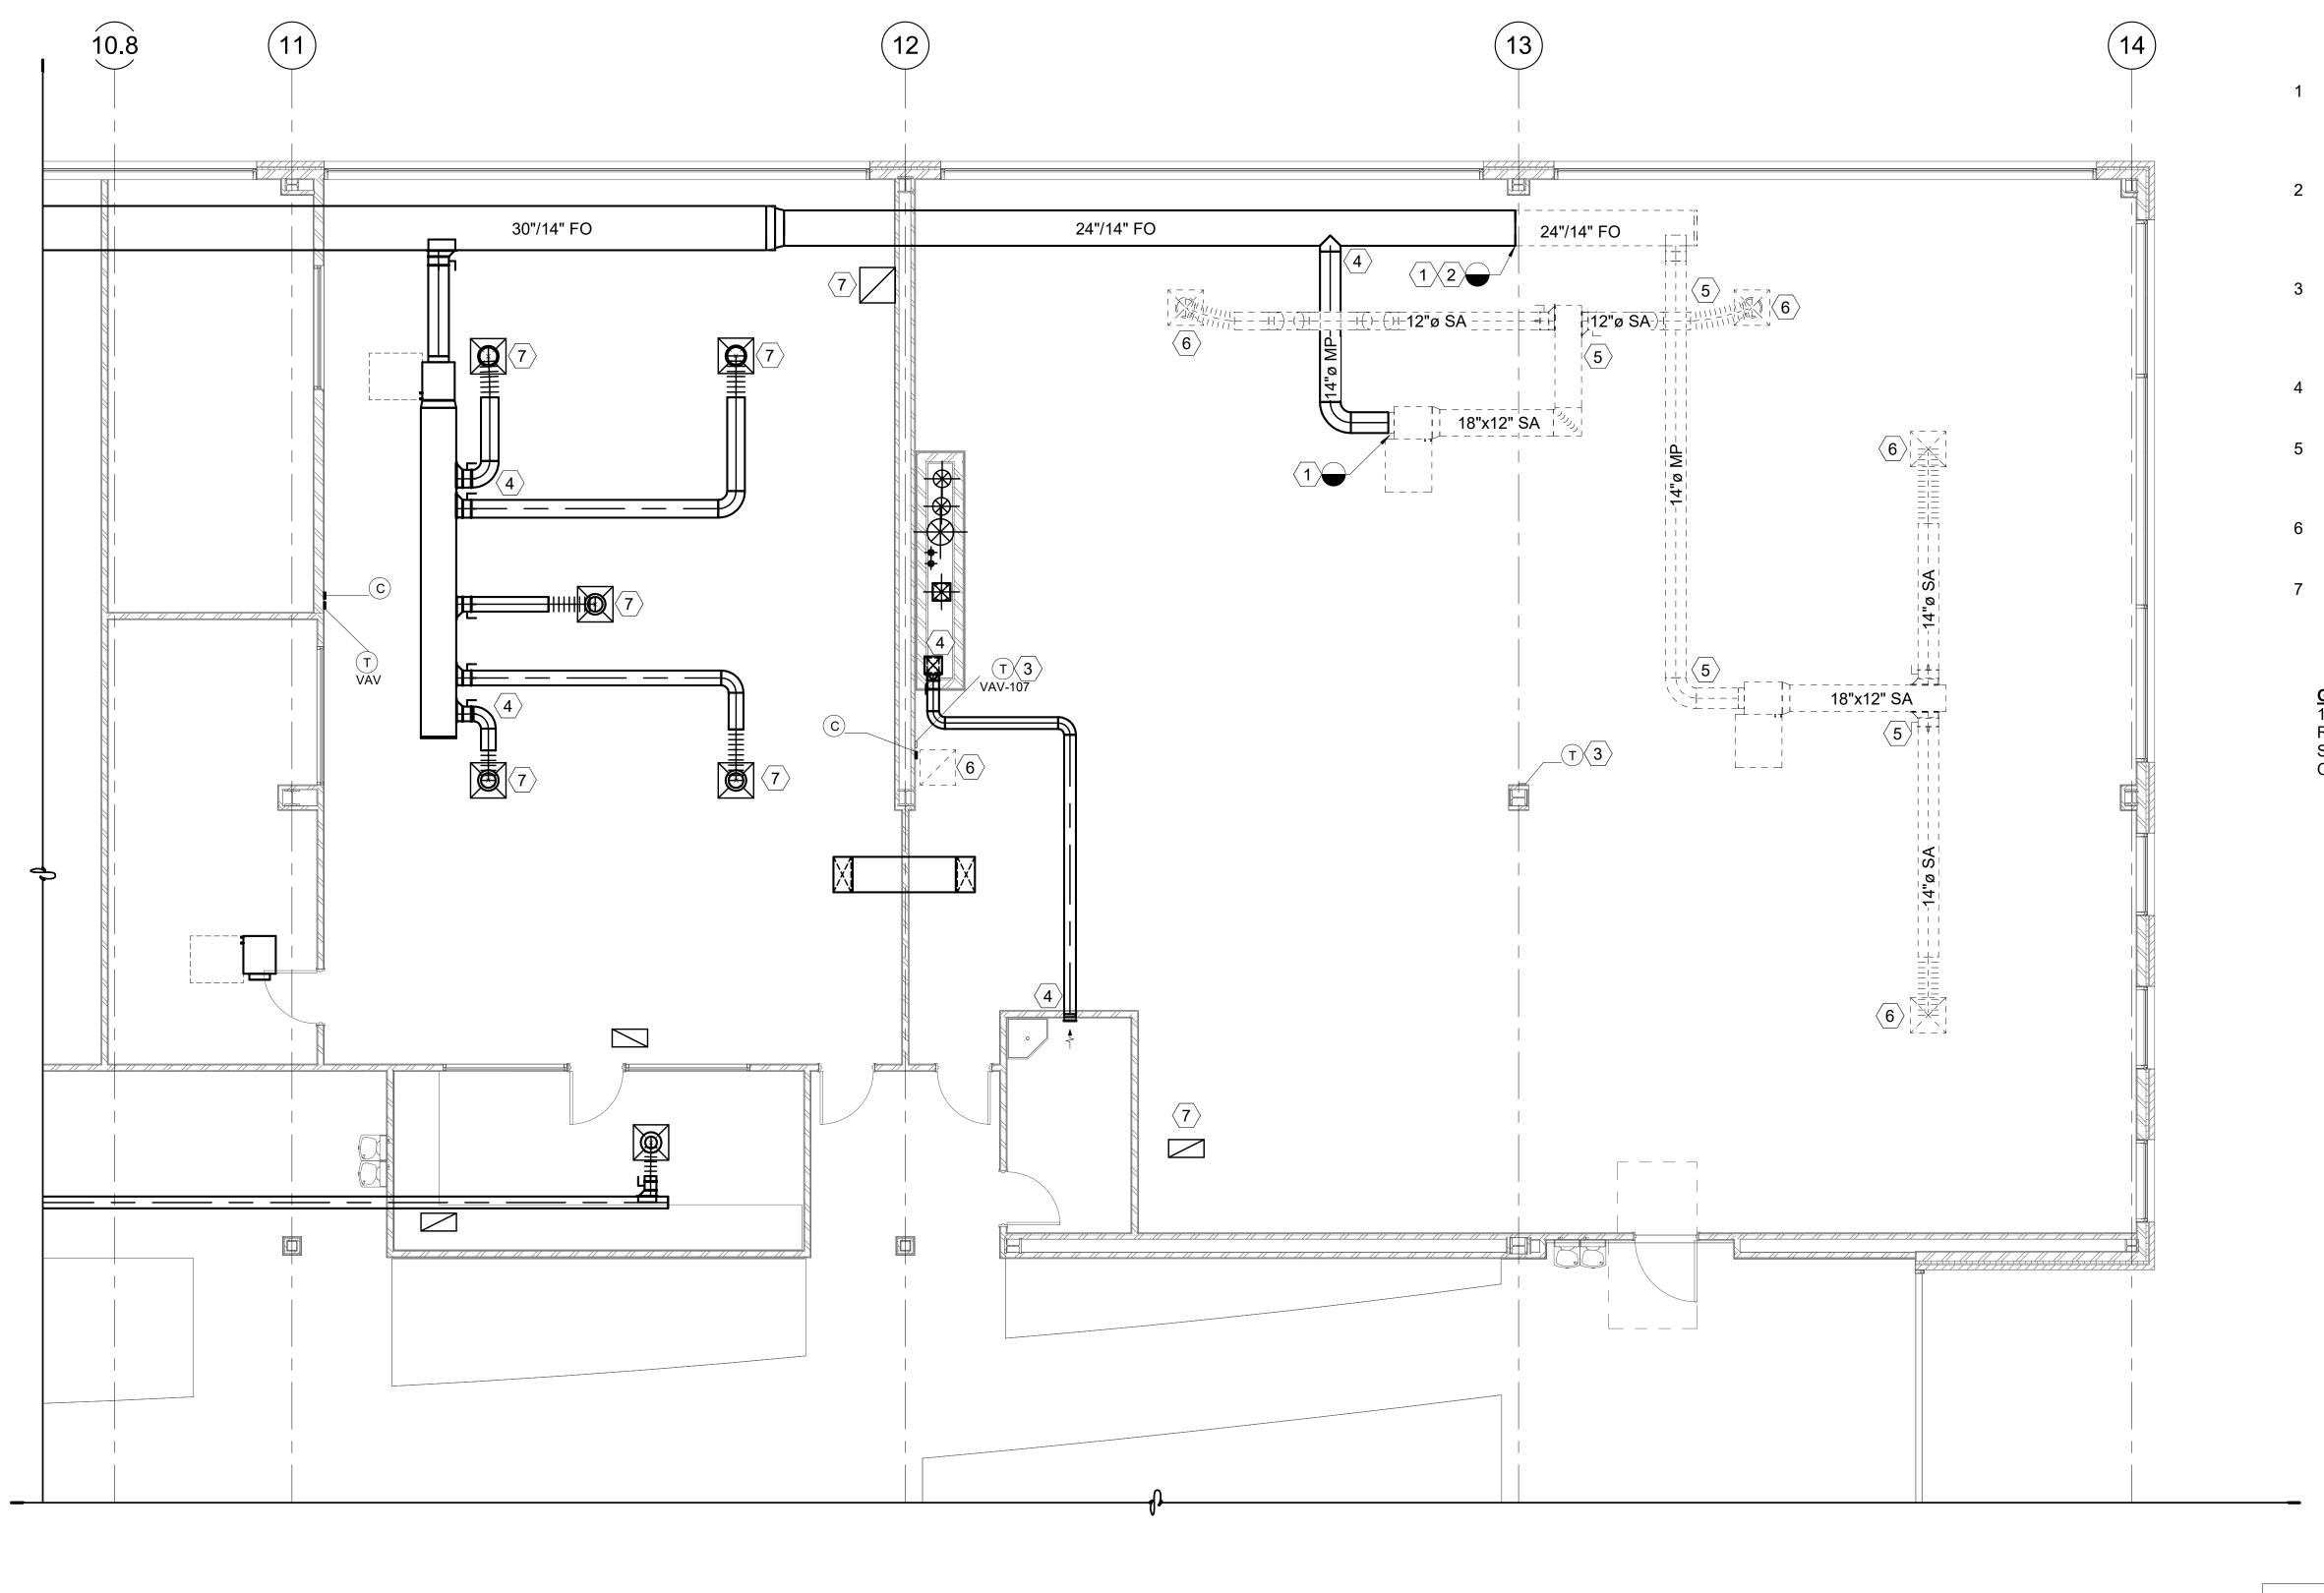
MECHANICAL LEVEL 2 DEMOLITION PLANS AREA A

3/16" = 1'-0"





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**SHEET NOTES** 

**#** 

1 REMOVE ALL EXISTING DUCTWORK AND ASSOCIATED ITEMS BACK TO THIS APPROXIMATE LOCATION. FIELD VERIFY EXISTING DUCT ROUTING AND POINTS OF REMOVAL.

- REMOVE EXISTING FLAT OVAL MEDIUM PRESSURE DUCT BACK TO THIS APPROXIMATE LOCATION. FIELD VERIFY EXISTING DUCT ROUTING AND POINTS OF REMOVAL.
- 3 REMOVE ALL EXISTING TEMPERATURE CONTROLS AND ALL ASSOCIATED ITEMS IN THIS APPROXIMATE LOCATION. FIELD
- 4 EXISTING MECHANICAL EQUIPMENT IN THIS APPROXIMATE LOCATION SHALL REMAIN.
- 5 REMOVE ALL EXISTING DUCTWORK IN THIS APPROXIMATE LOCATION. FIELD VERIFY EXISTING DUCT ROUTING AND POINTS OF REMOVAL.
- 6 REMOVE EXISTING GRILLE IN THIS APPROXIMATE LOCATION. FIELD VERIFY.
- 7 EXISTING GRILLE IN THIS APPROXIMATE LOCATION SHALL REMAIN. FIELD VERIFY.

**GENERAL NOTES**"

1. VAV CONTROLLERS TO BE REMOVED IN THIS PROJECT SHALL BE SALVAGED BACK TO OWNER.

8.24.20 WINWARD M. **PACKER** No. 375080

Consultant



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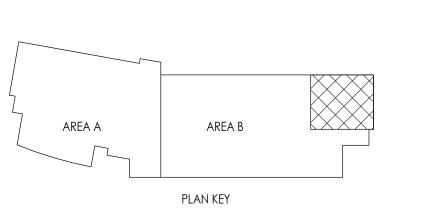
MECHANICAL LEVEL 2 DEMOLITION PLANS AREA B

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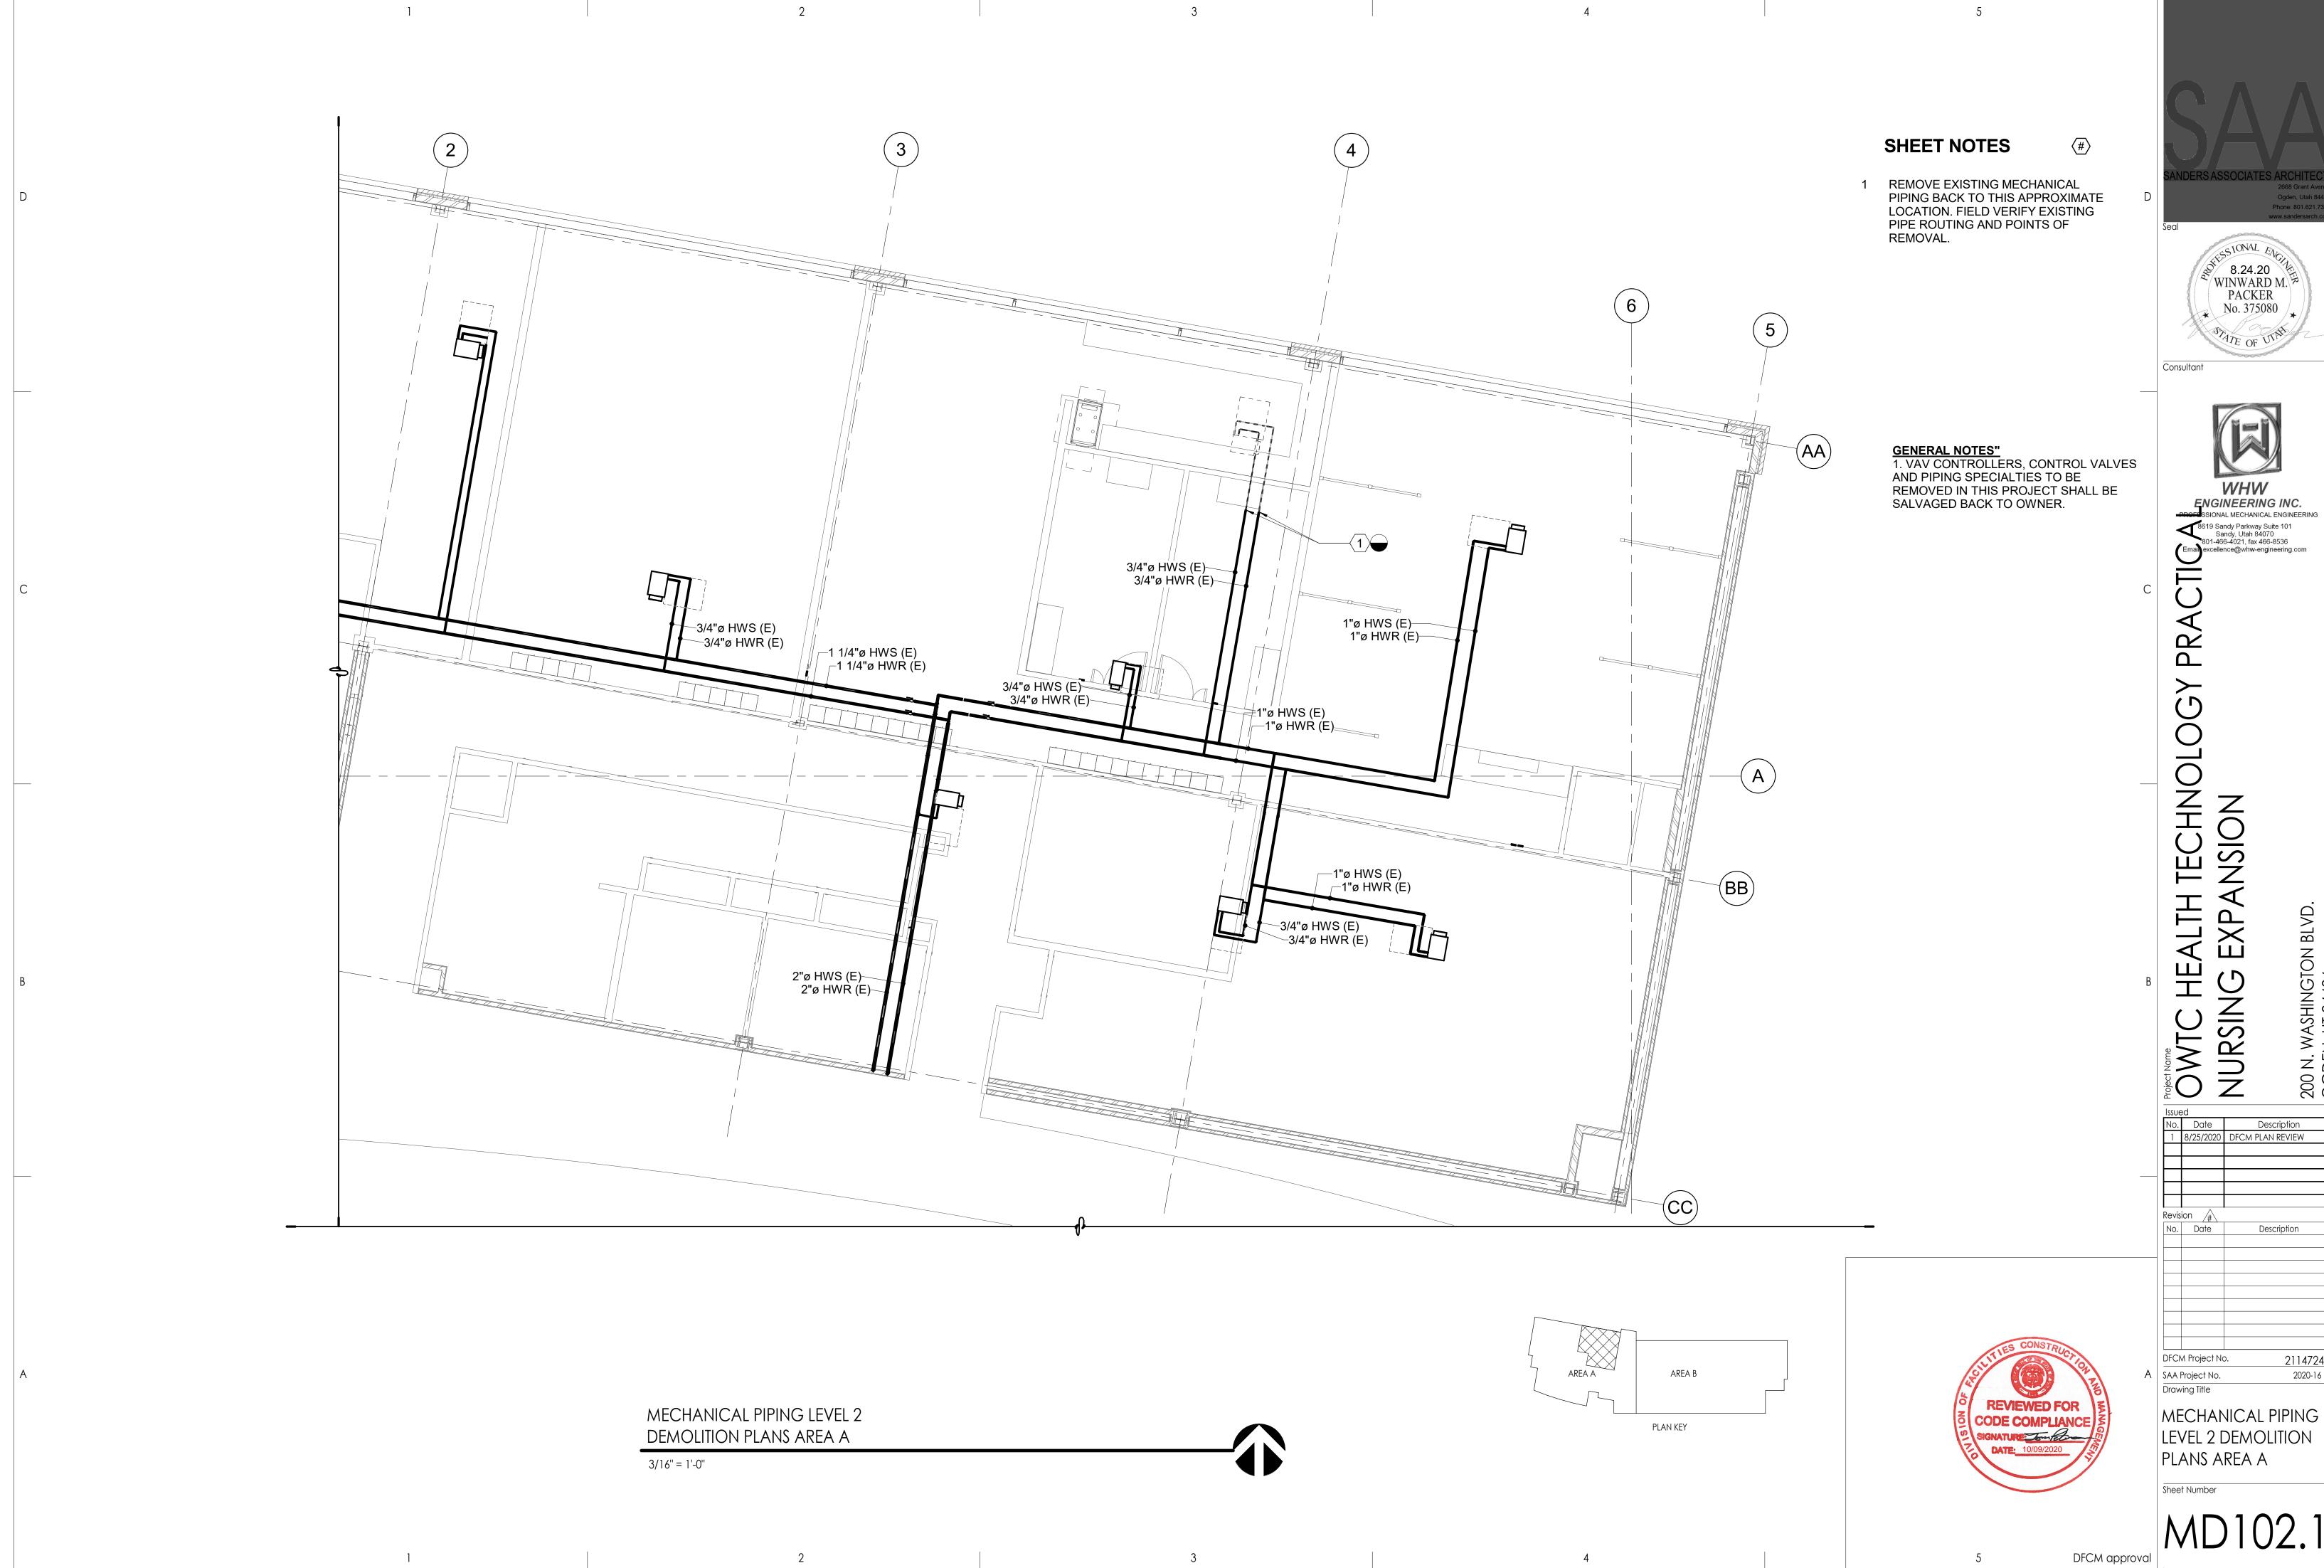
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MECHANICAL LEVEL 2 DEMOLITION PLANS AREA B 3/16" = 1'-0"





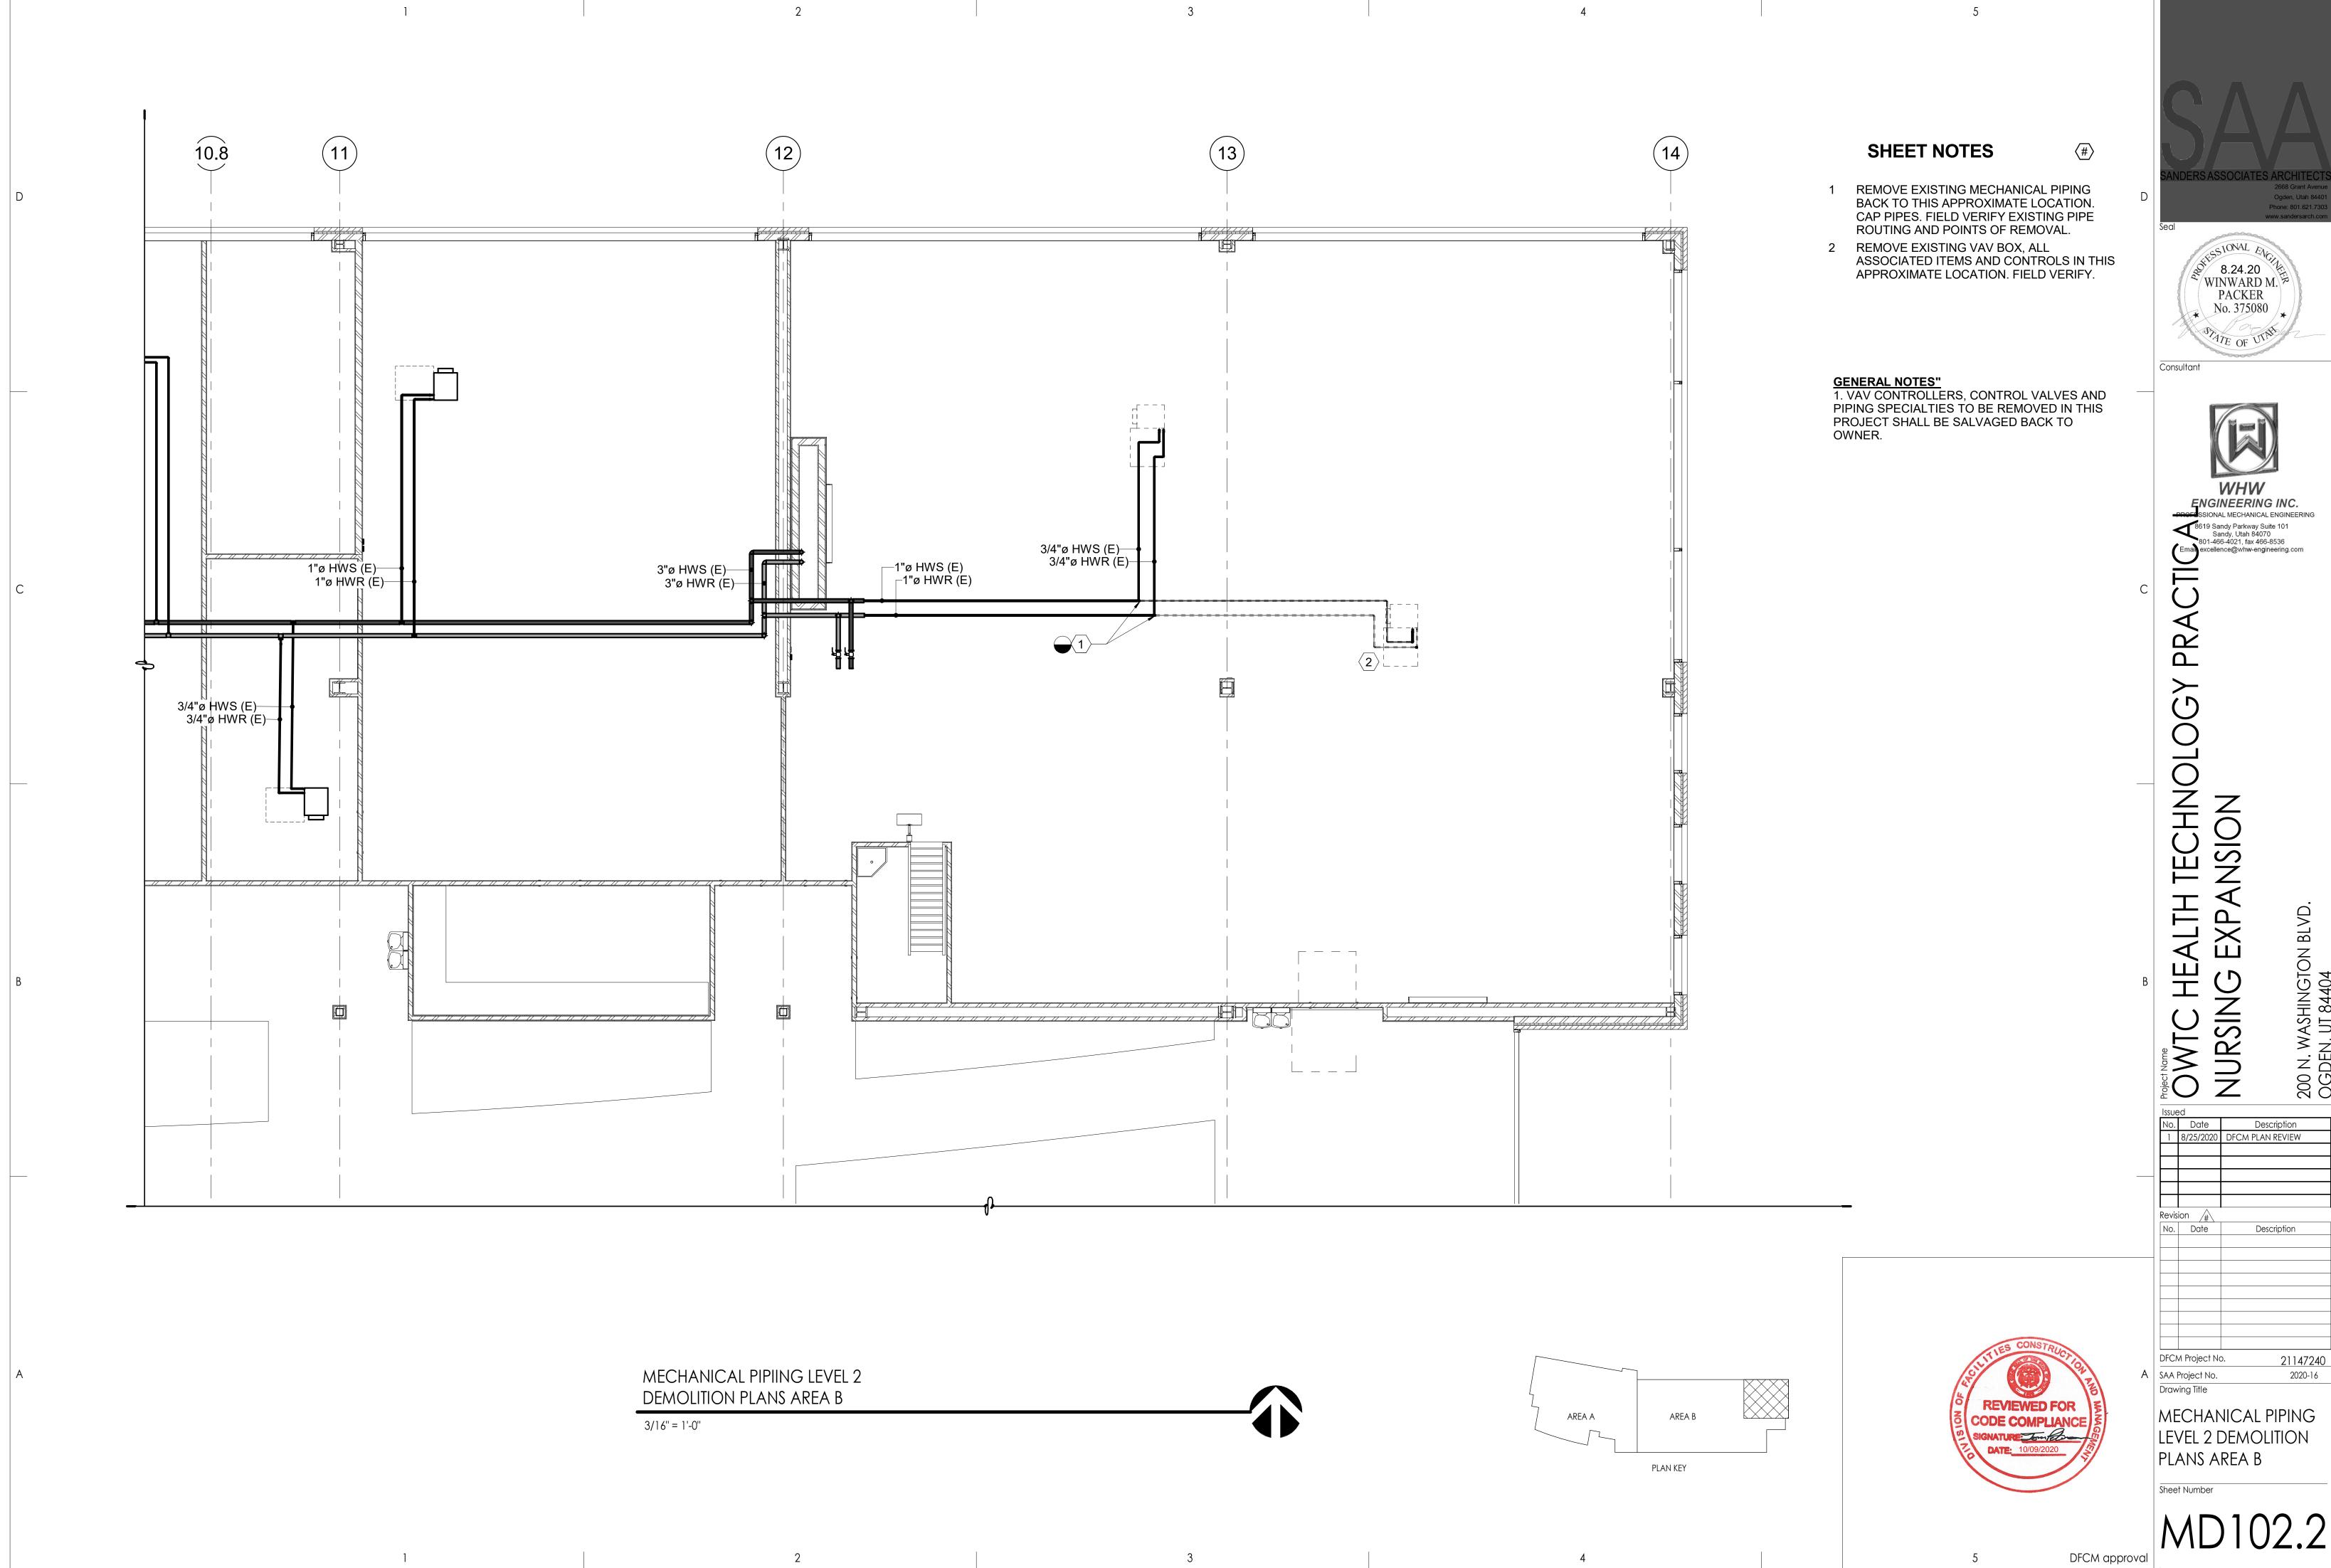


8.24.20 WINWARD M.

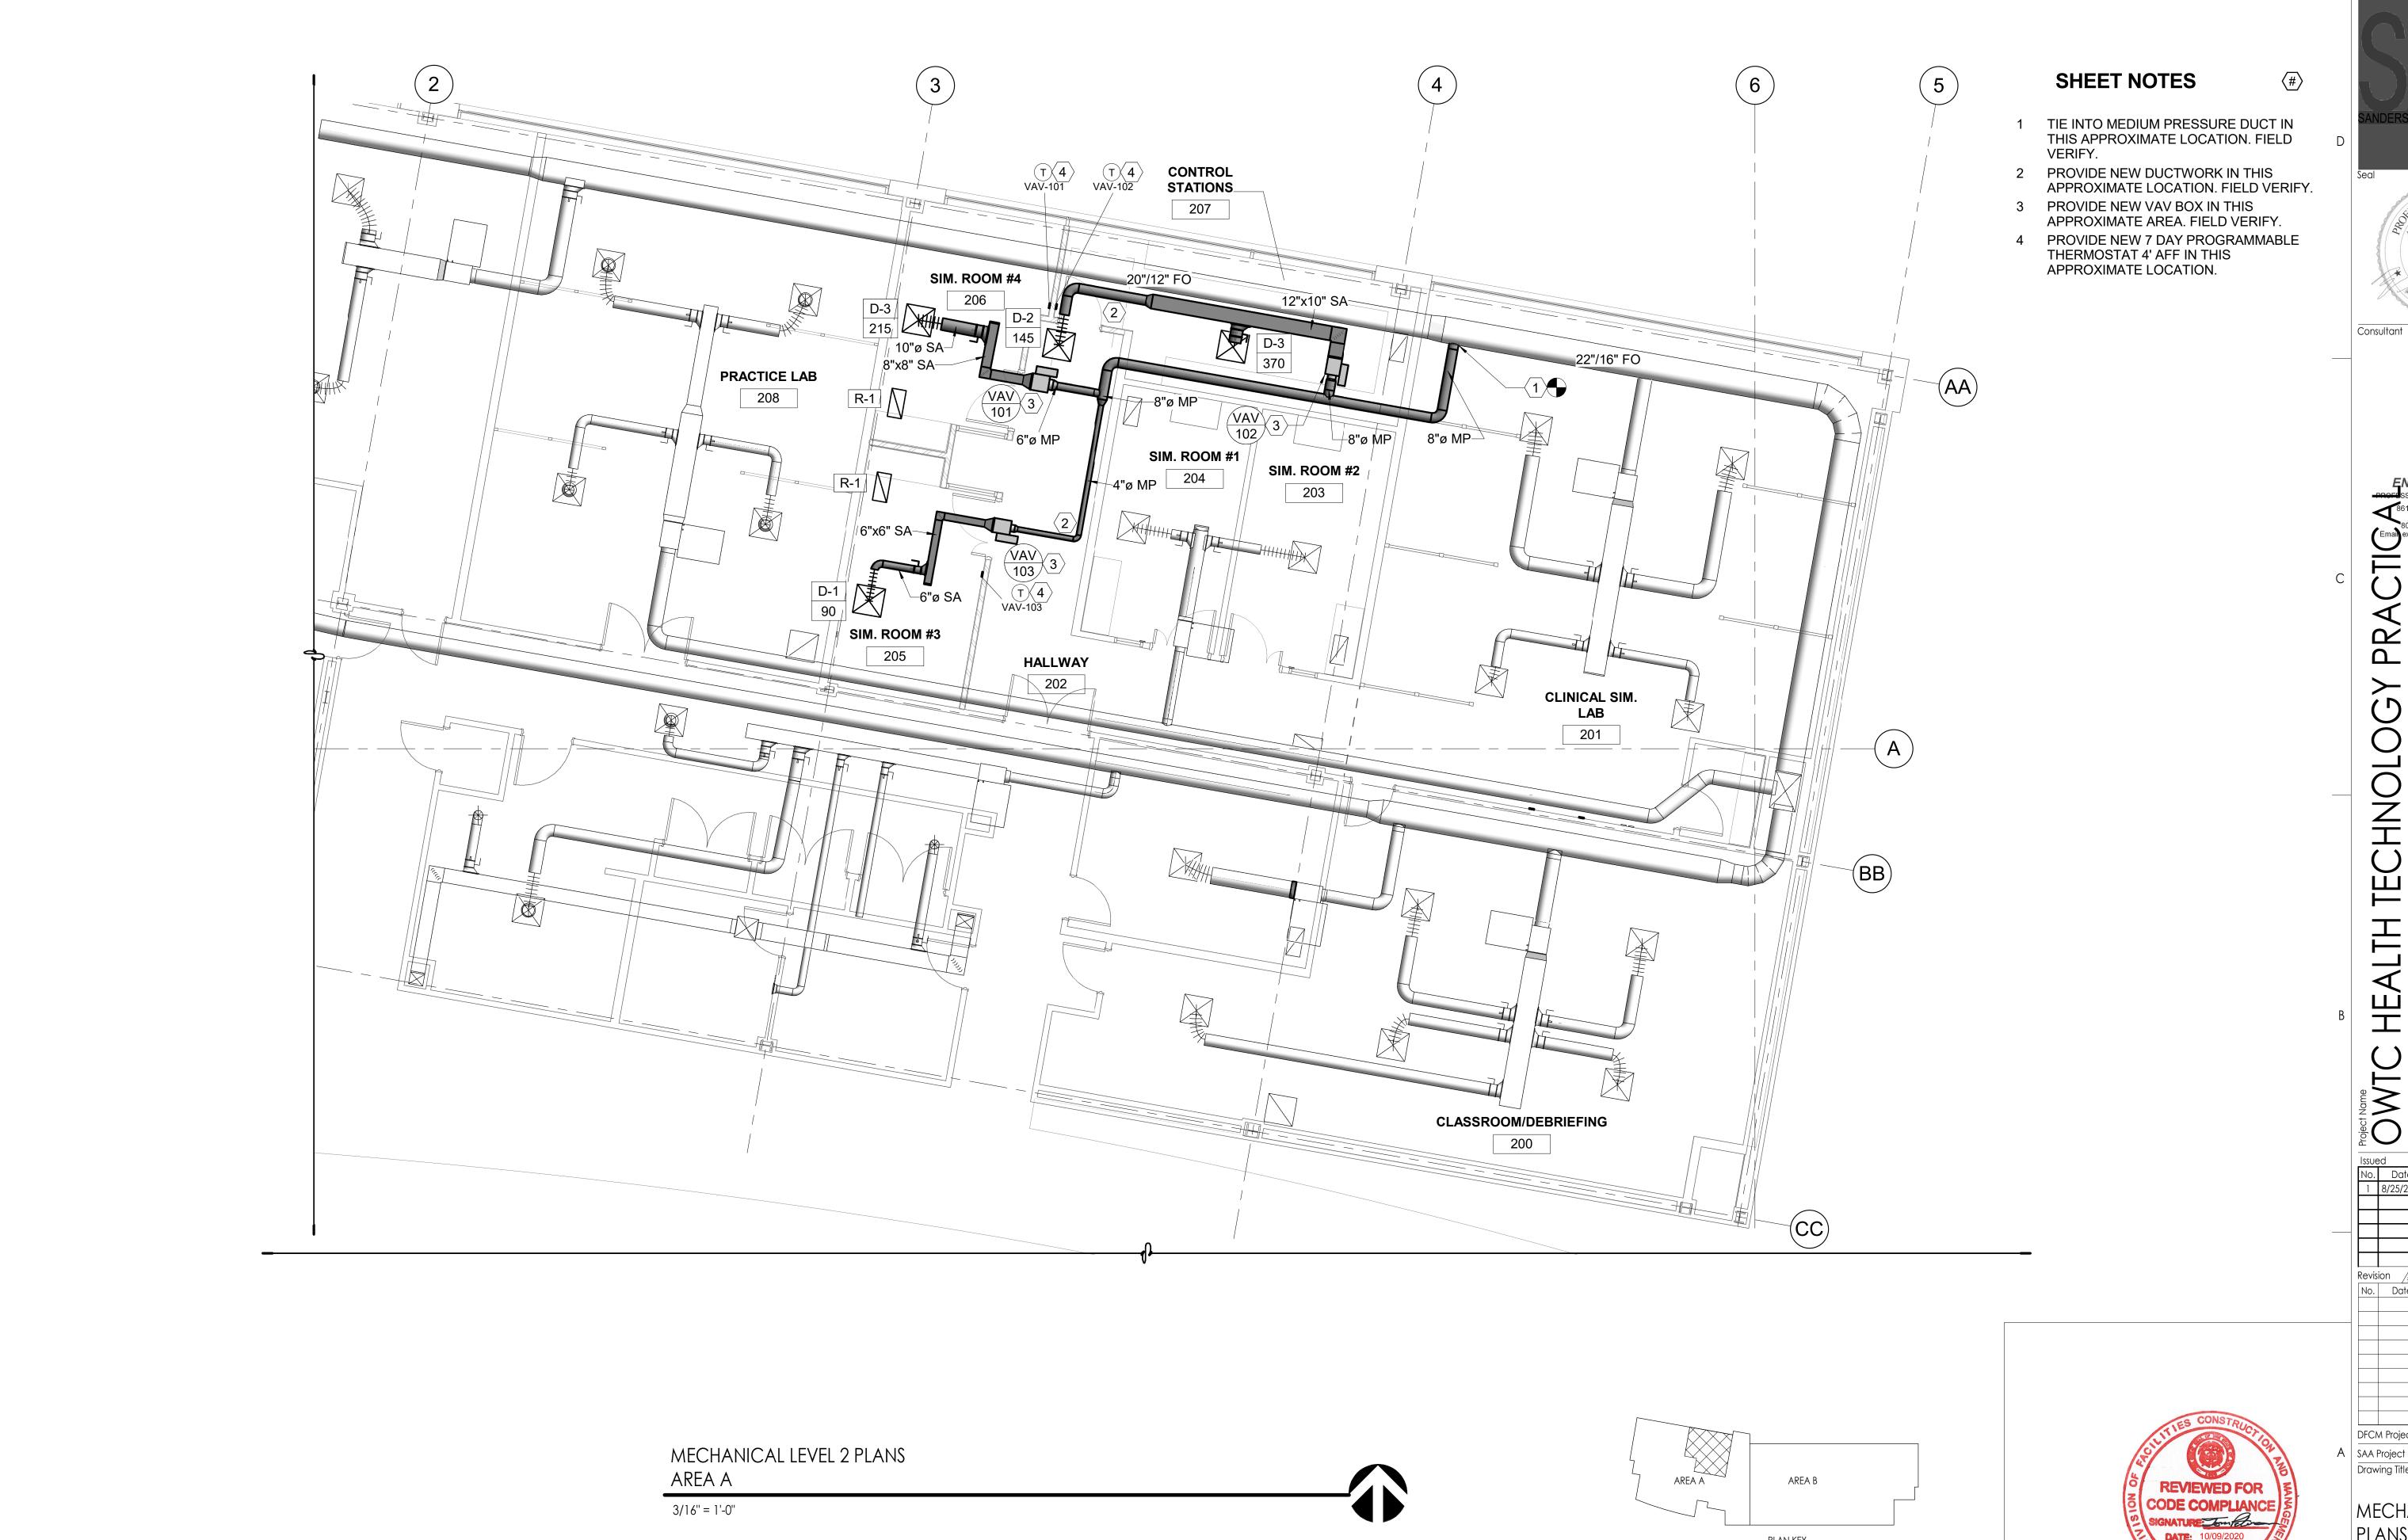
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MECHANICAL PIPING LEVEL 2 DEMOLITION



2020-16





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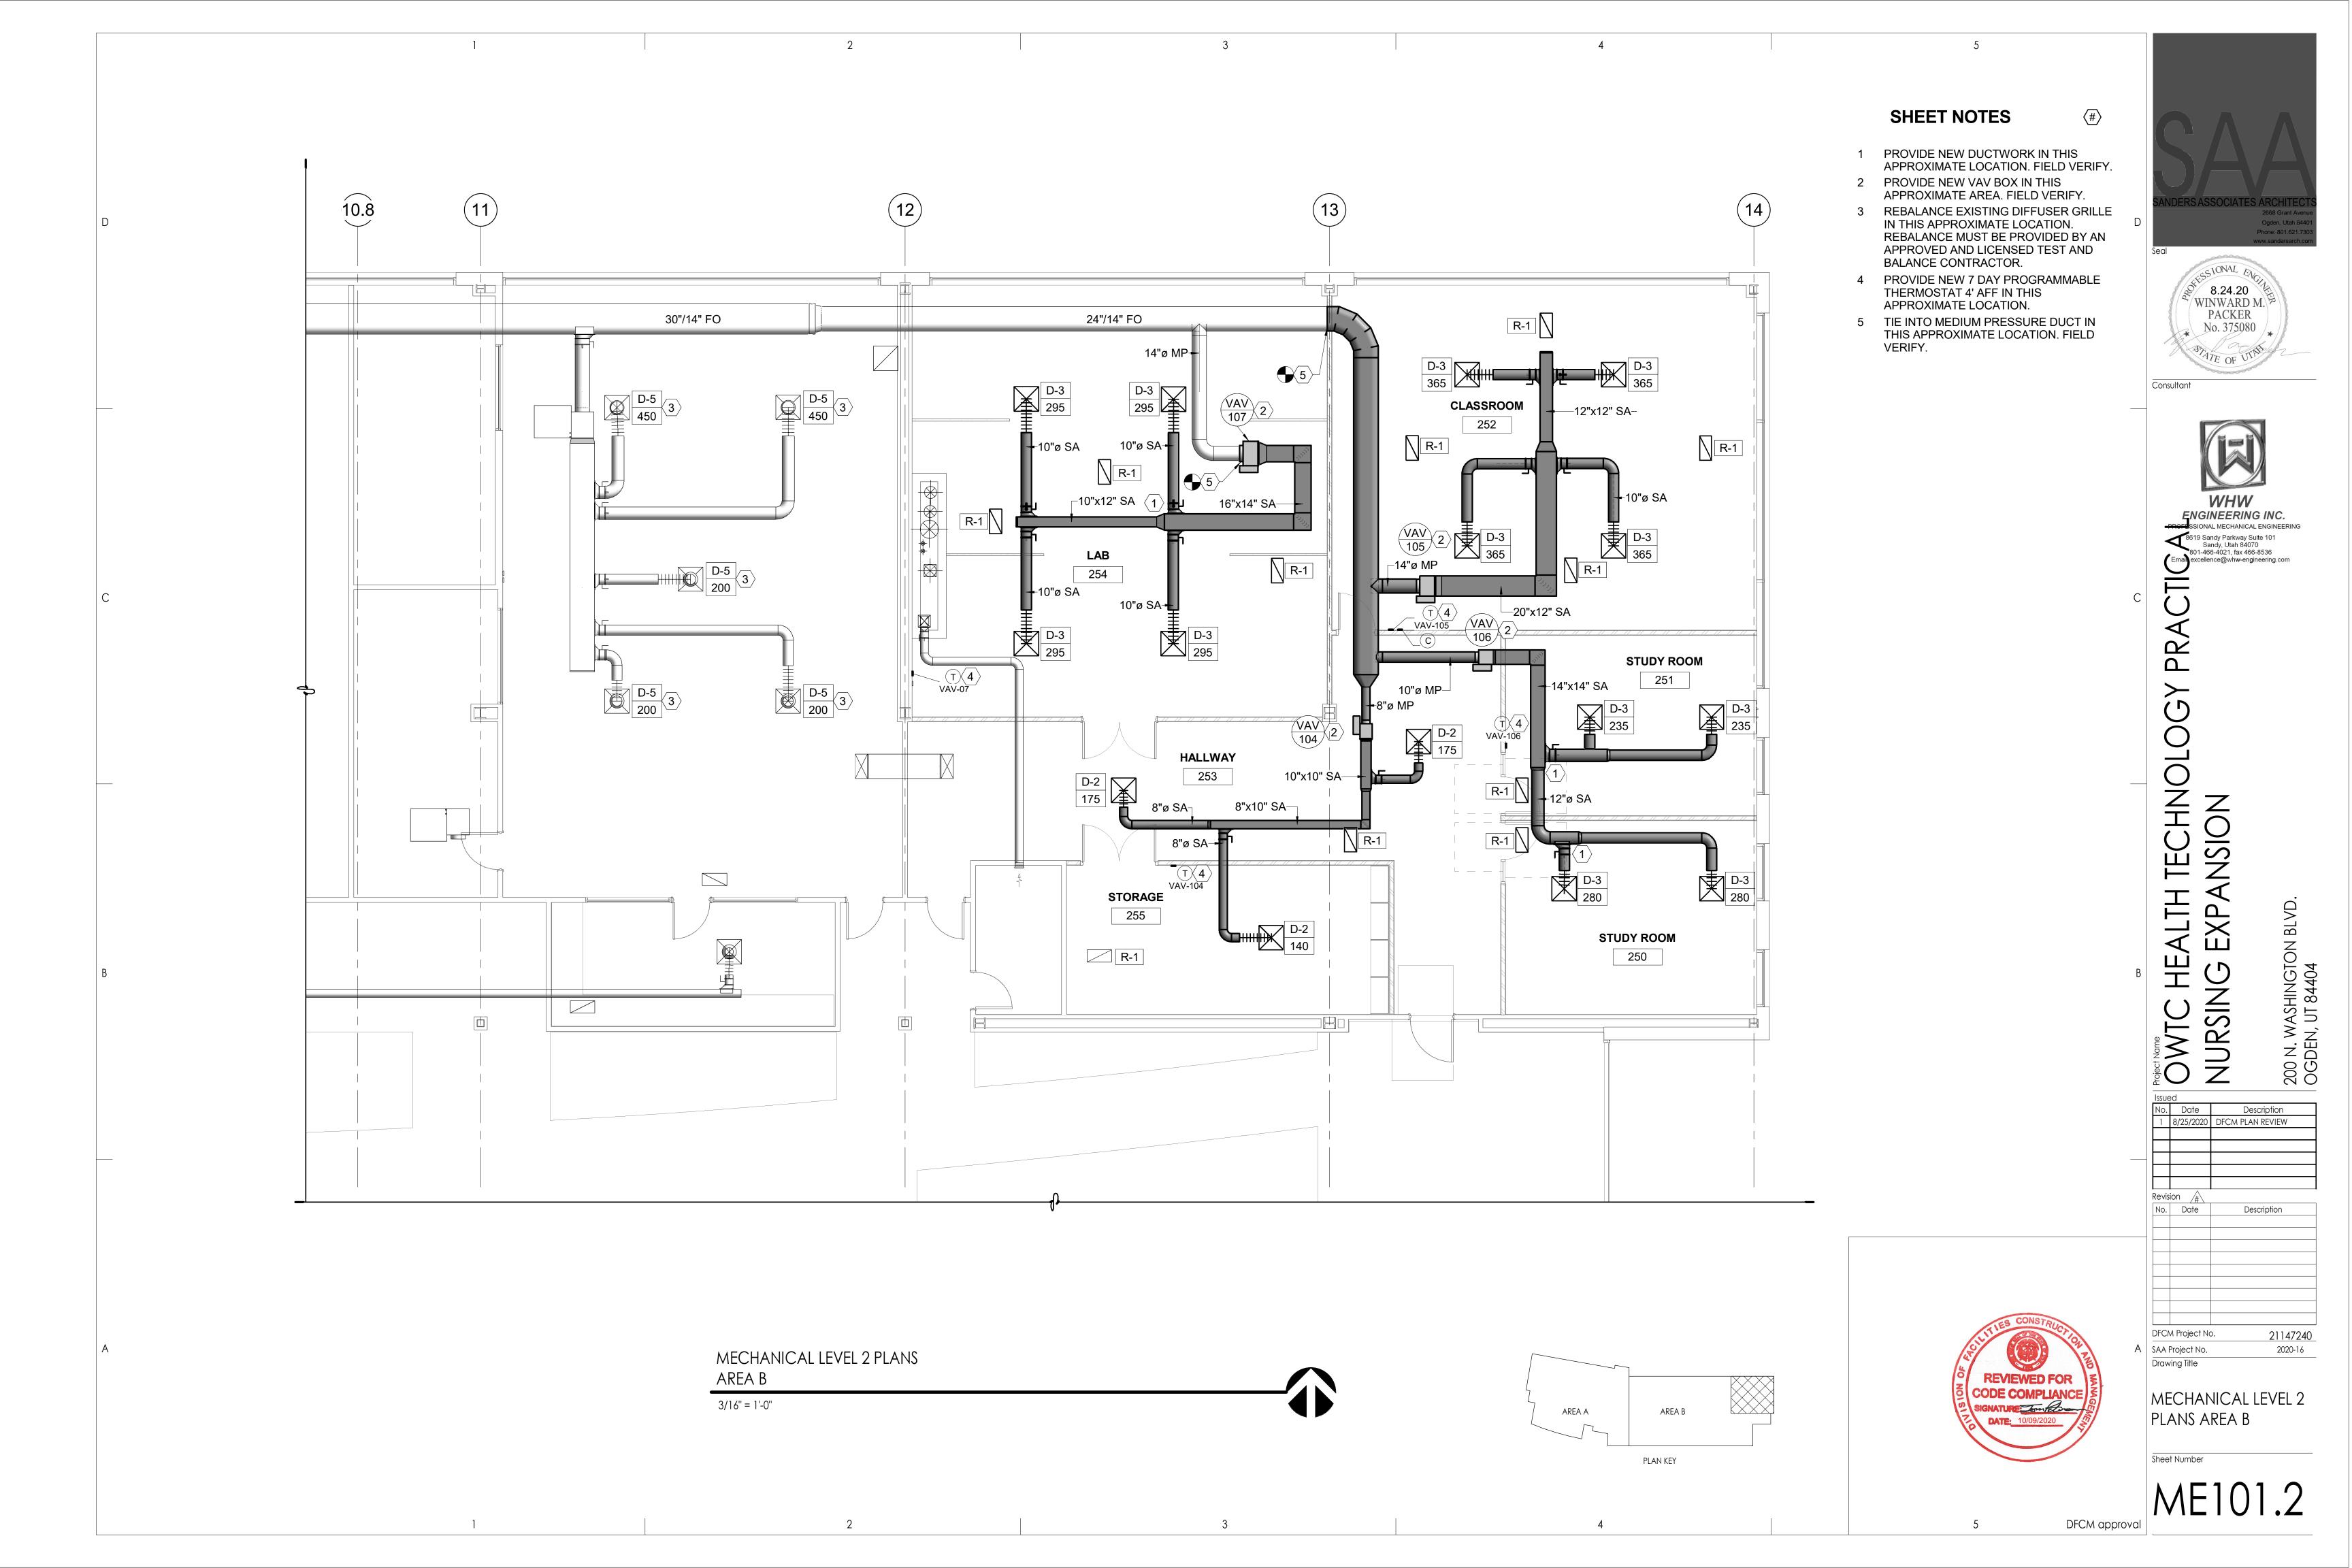
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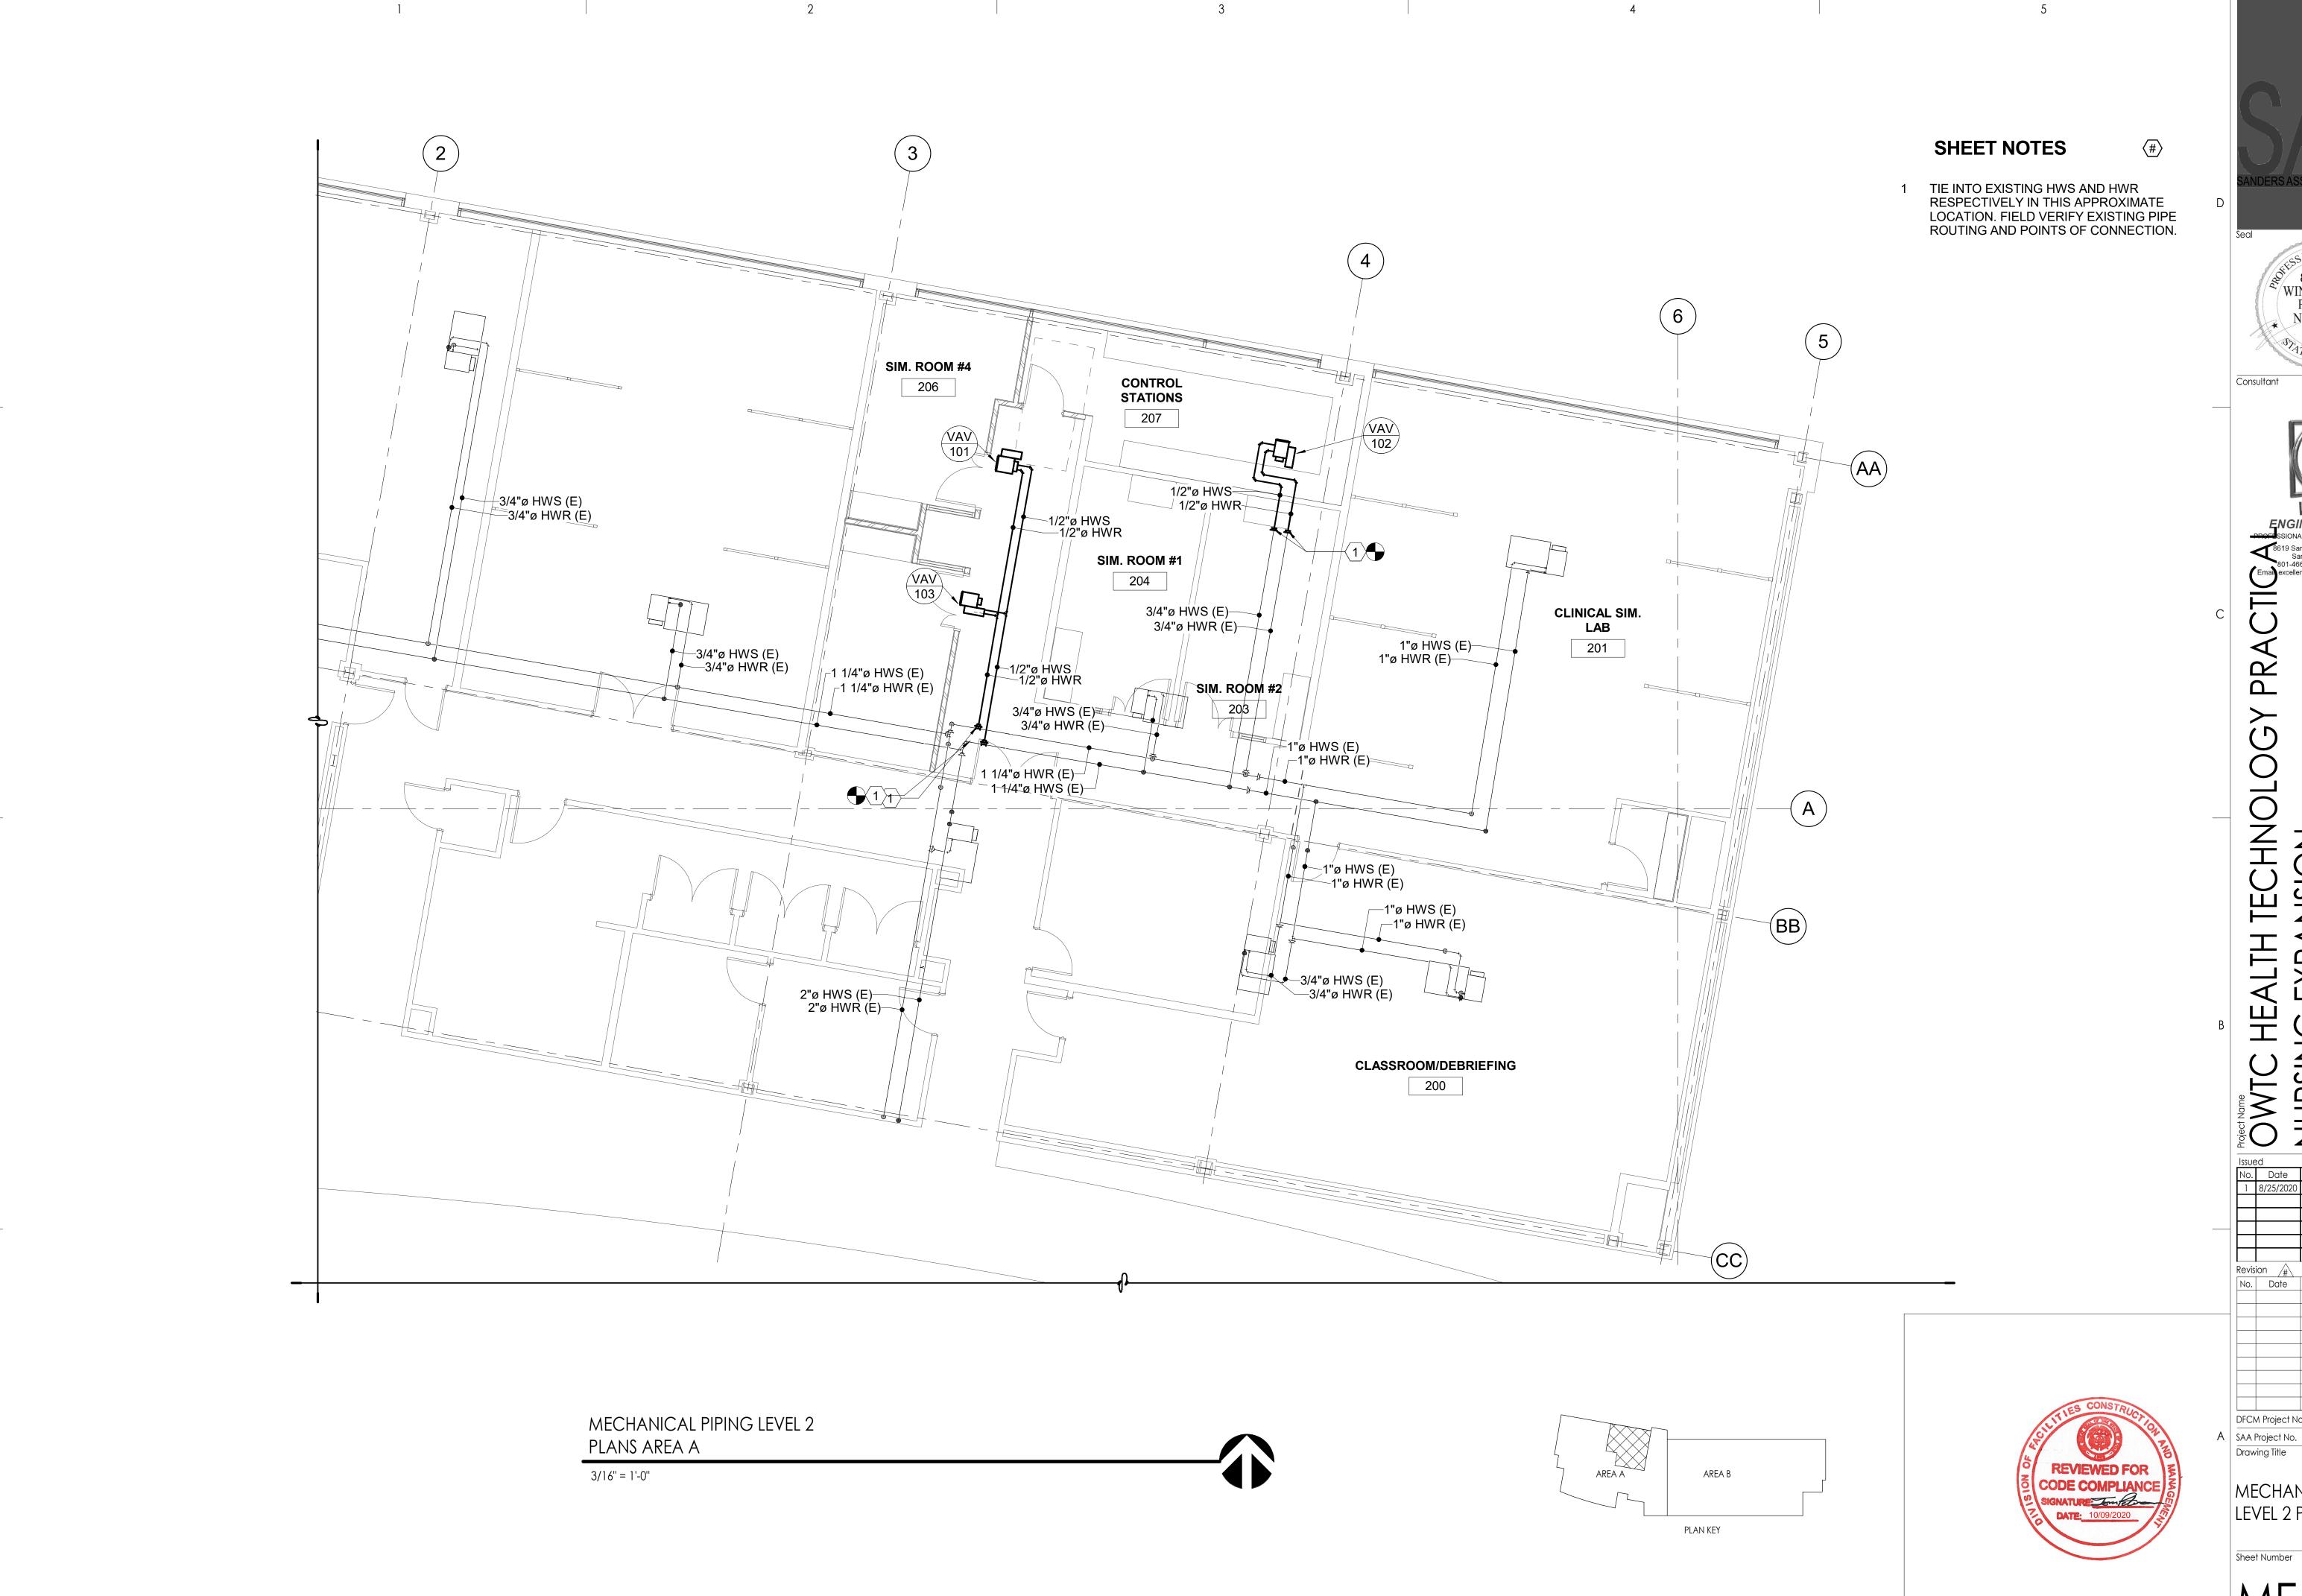
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Drawing Title

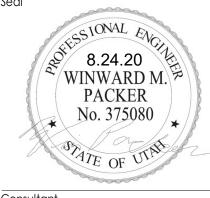
> MECHANICAL LEVEL 2 PLANS AREA A

21147240

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TECHNOLOGY NSION NURSING

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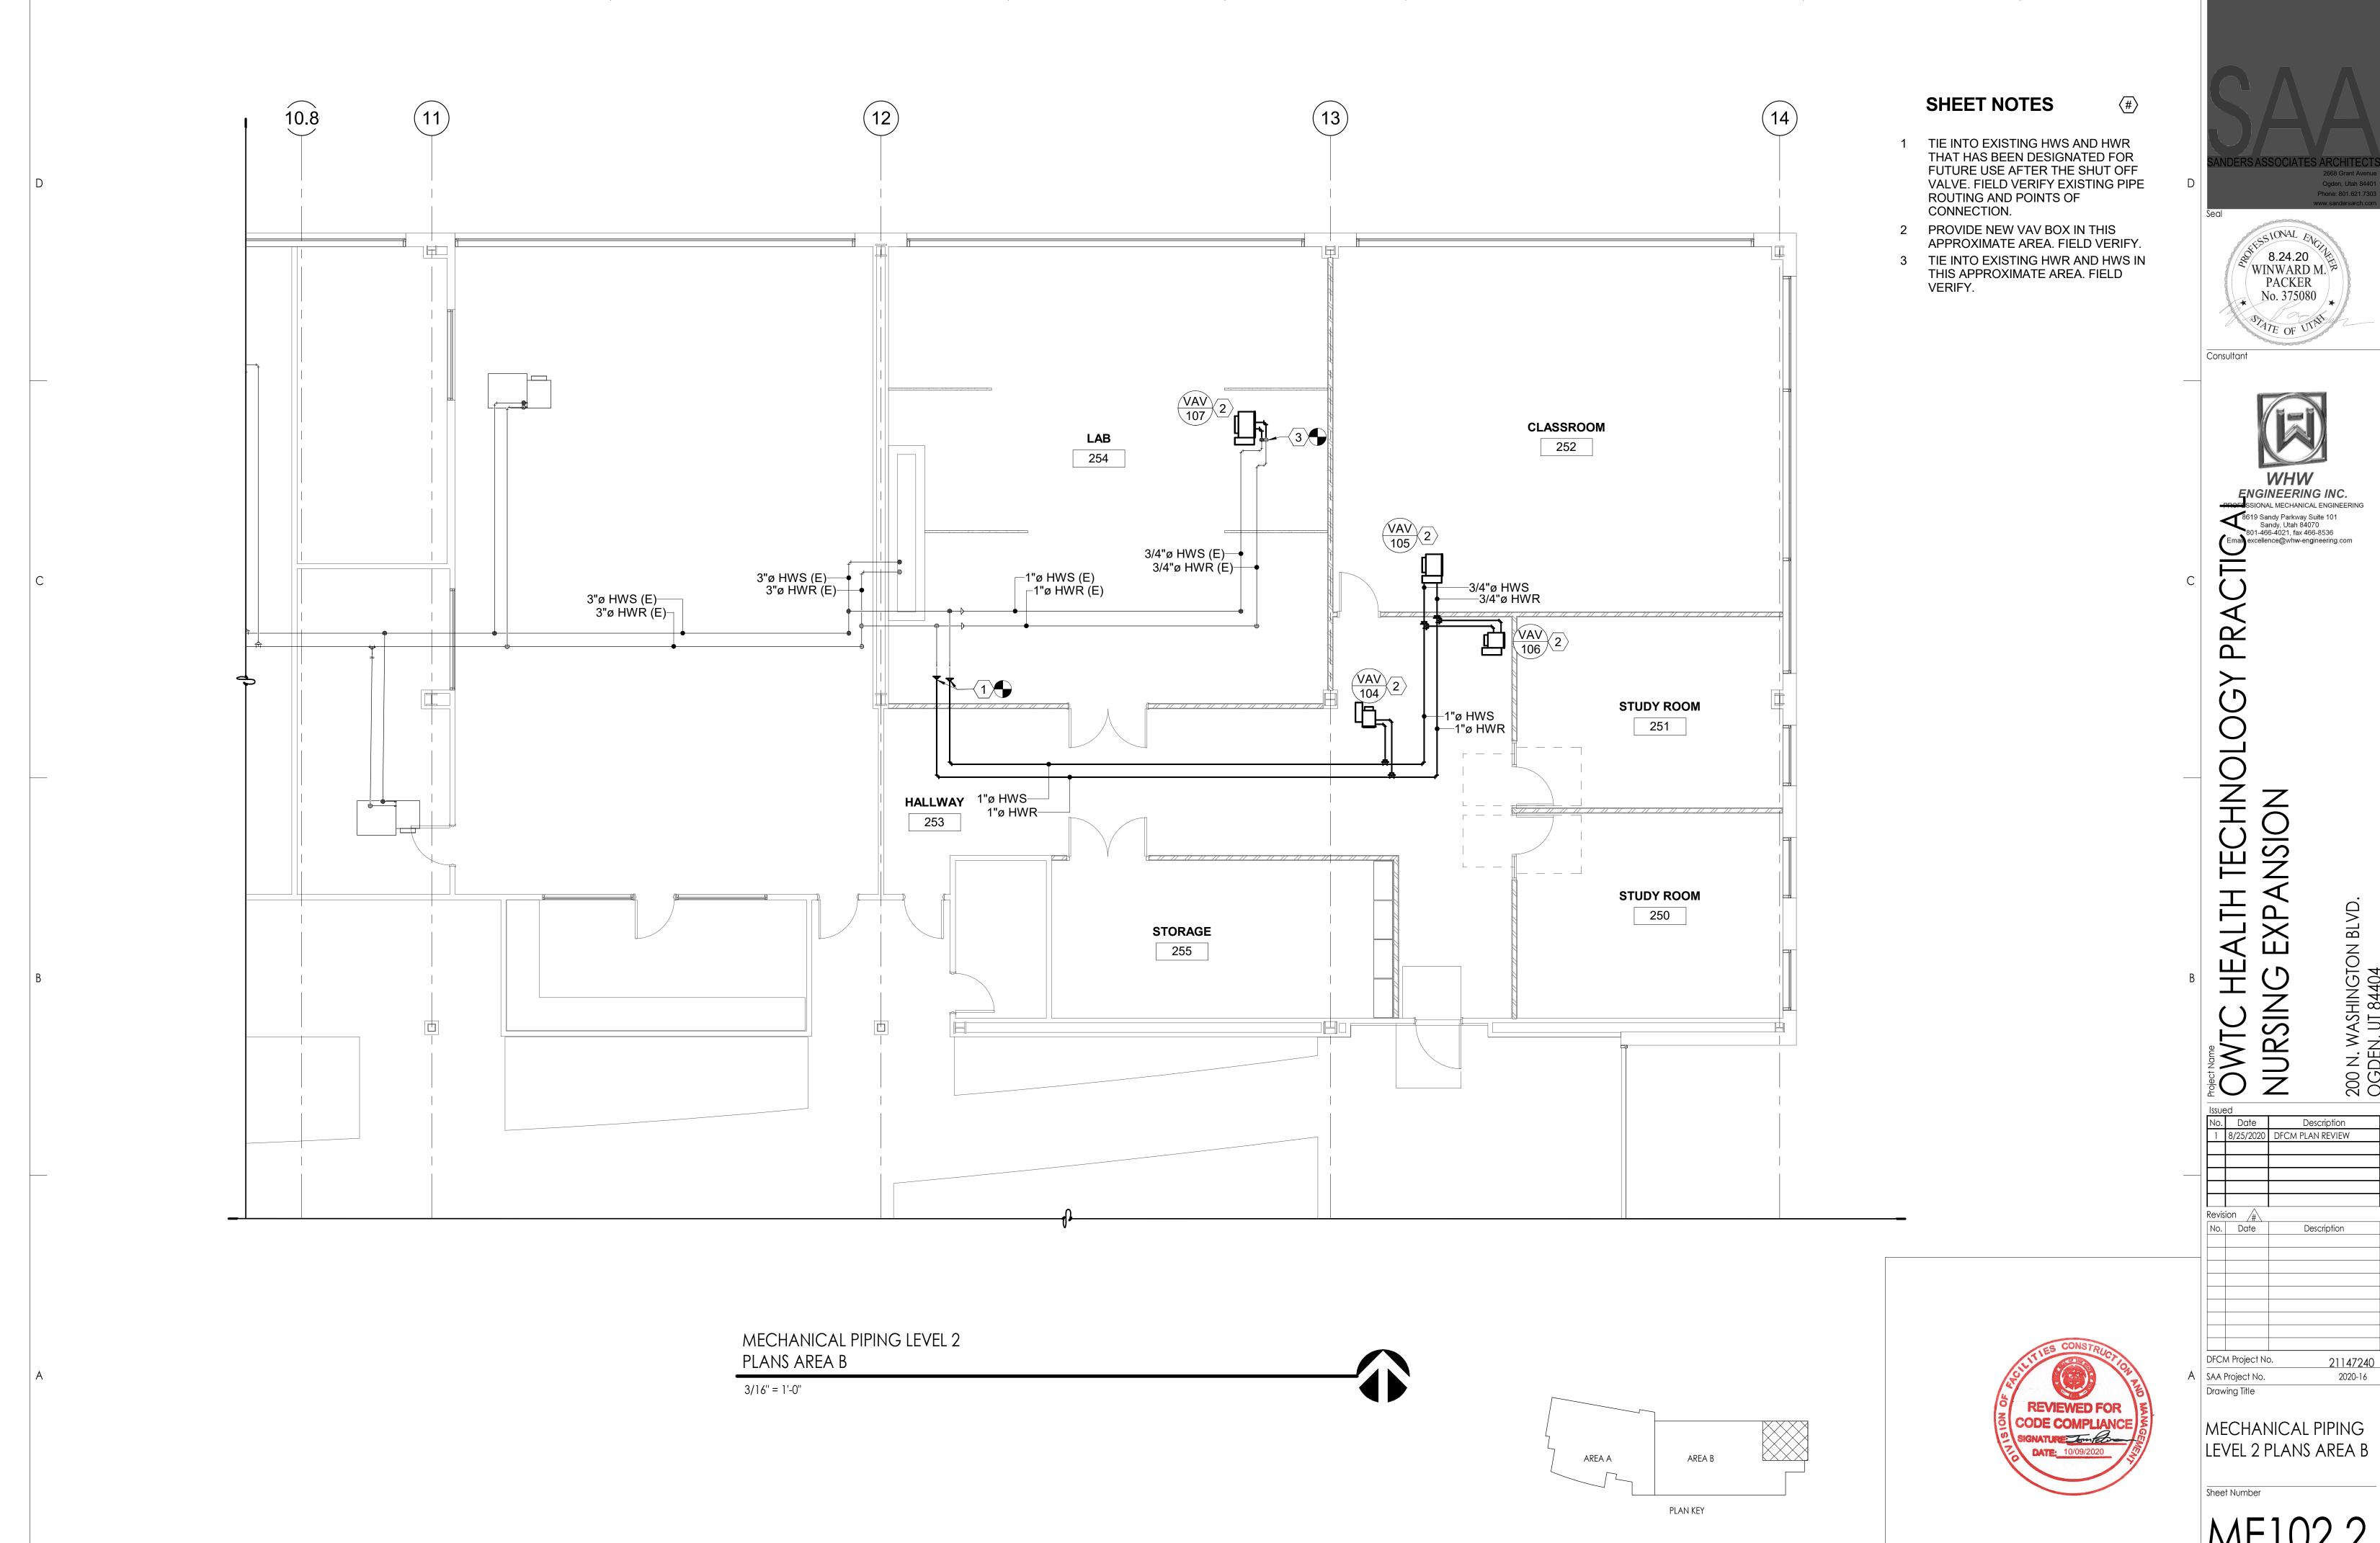
DFCM Project No. 21147240 2020-16

MECHANICAL PIPING LEVEL 2 PLANS AREA A

Sheet Number

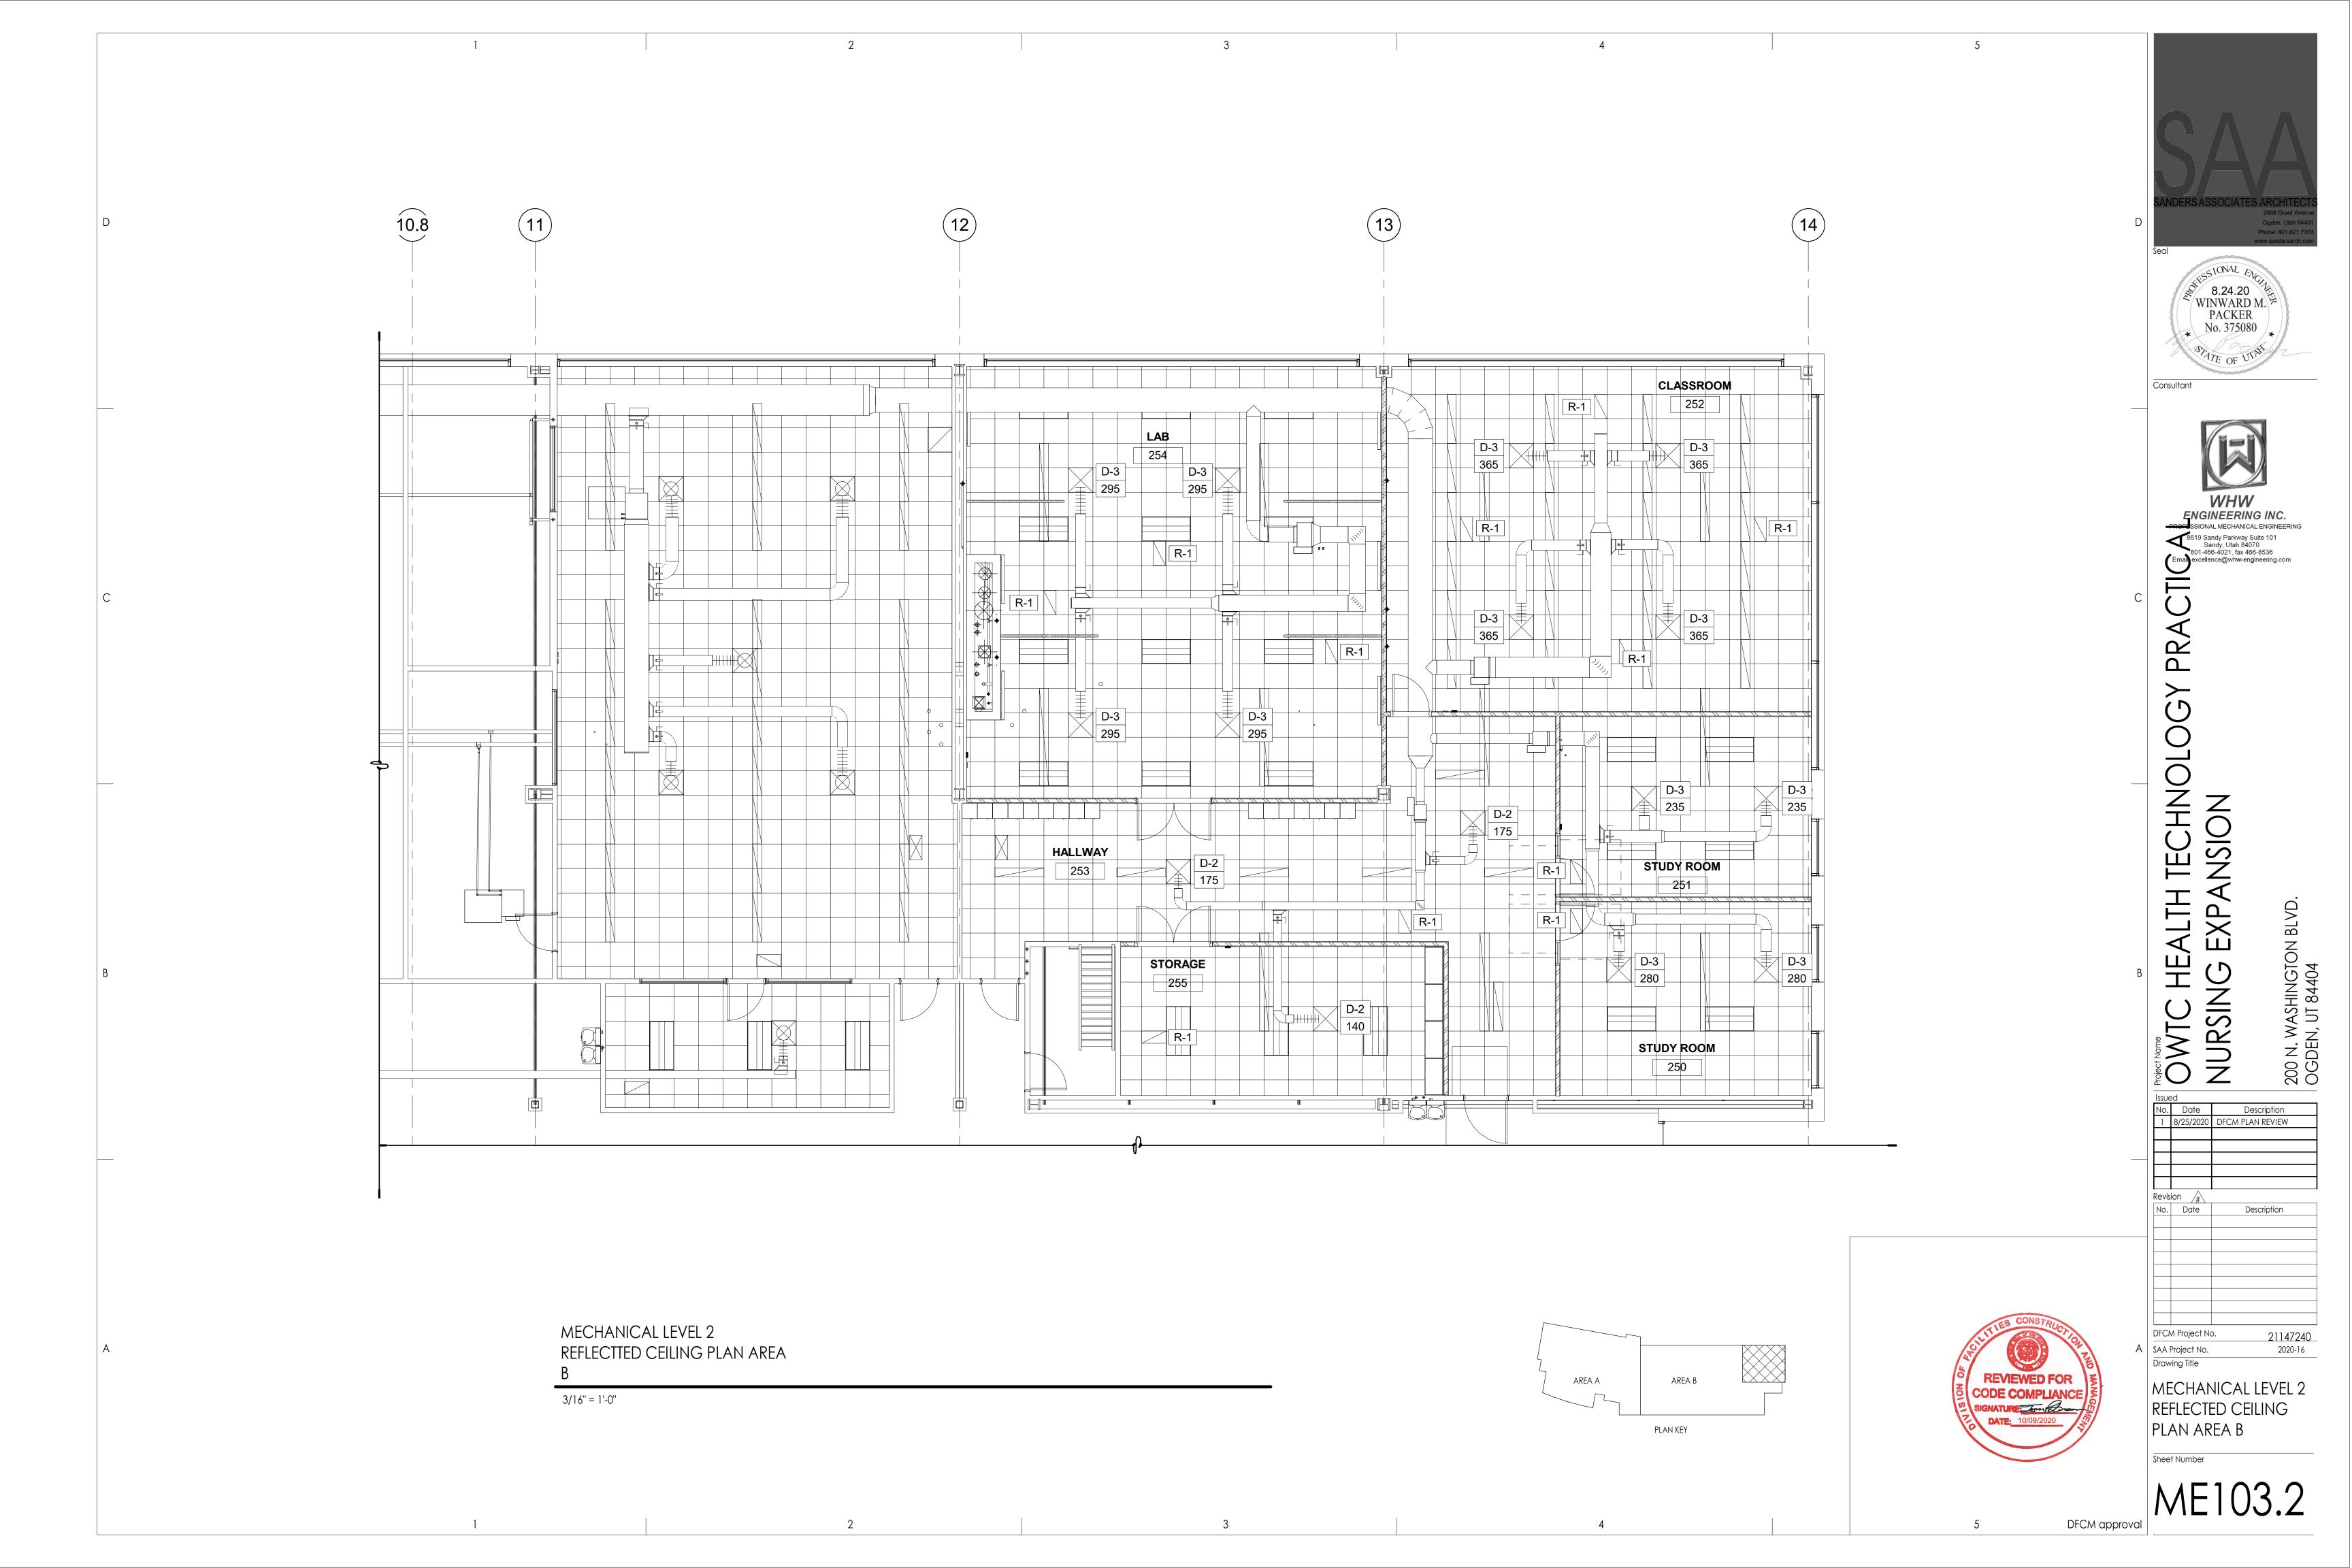
DFCM approval

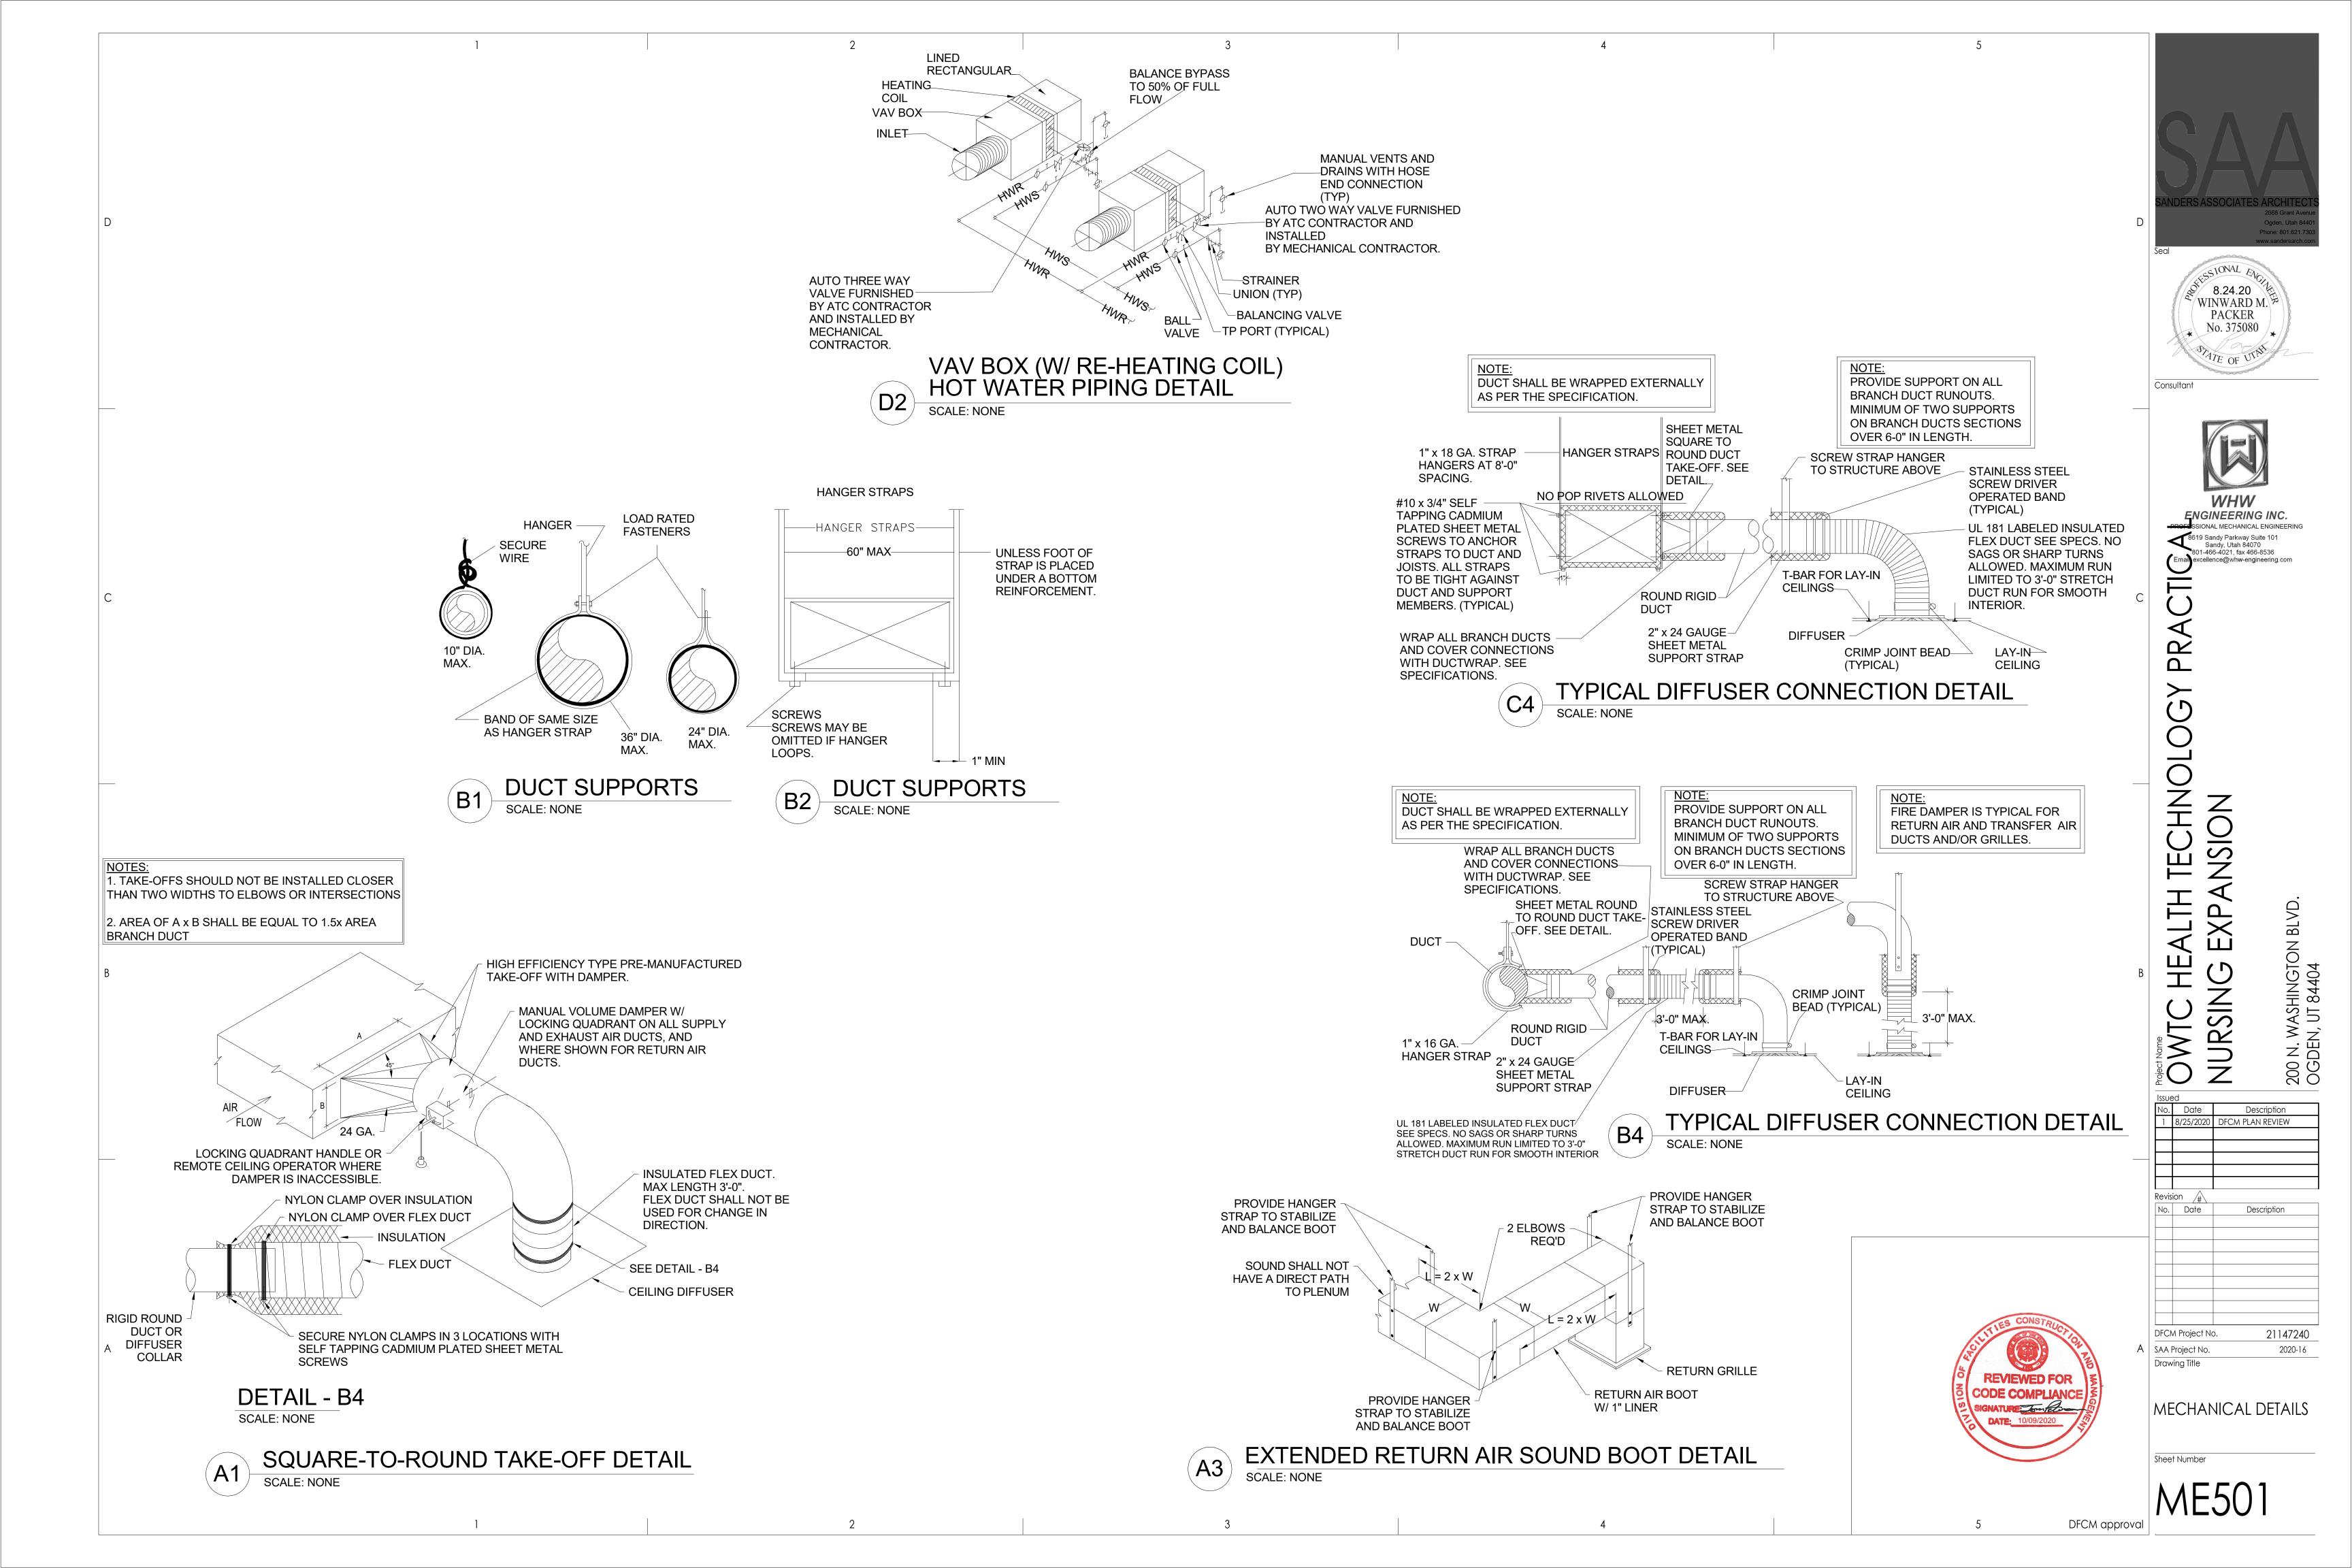
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MEIU2







	DIFFUSER AND GRILLE SCHEDULE  TAG CFM  TAG									TAG
		FACE	SIZE	NECK S	SIZE					
TAG	MAX FLOW	LENGTH	WIDTH	LENGTH/ DIAMETER	WIDTH	CEILING TYPE	BLOW PATTERN	MAX NC	MANUF & MODEL	SCHEDULE NOTES
D-1	225 CFM	24"	24"	6"	0"	LAY-IN	4 WAY	25	PRICE SPD	1
D-2	325 CFM	24"	24"	8"	0"	LAY-IN	4 WAY	25	PRICE SPD	1
D-3	450 CFM	24"	24"	10"	0"	LAY-IN	4 WAY	25	PRICE SPD	1
R-1	600 CFM	24"	12"	24"	12"	LAY-IN	N/A	25	PRICE 535	1

1. SEE SPECIFICATIONS FOR APPROVED MANUFACTURERS.

						V	AV SCHEDU	LE								TYP #
TA	\G								HEA	ΓING						
TYPE	#	AREA SERVED	INLET SIZE	MAX CFM	MIN CFM	EAT	LAT	HTG CFM	HTG BTU/HR	EWT	GPM	PIPE SIZE	ROWS	MAX NC	MANUF. & MODEL	SCHEDULE NOTES
VAV	101	SIM ROOM #4 206	4"	215 CFM	118 CFM	65 °F	105 °F	118 CFM	4400 Btu/h	180 °F	0.5 GPM	1/2"	1	25	TITUS DESV(S)	1,2,3
VAV	102	CONTROLS/HALLWAY 207/202	8"	515 CFM	283 CFM	65 °F	107 °F	283 CFM	11100 Btu/h	180 °F	0.9 GPM	1/2"	2	25	TITUS DESV(S)	1,2,3
VAV	103	SIM ROOM #3 205	4"	90 CFM	50 CFM	65 °F	118 °F	50 CFM	2500 Btu/h	180 °F	0.5 GPM	1/2"	1	25	TITUS DESV(S)	1,2,3
VAV	104	HALL/STORAGE 253/252	8"	490 CFM	267 CFM	65 °F	109 °F	267 CFM	10900 Btu/h	180 °F	0.9 GPM	1/2"	2	25	TITUS DESV(S)	1,2,3
VAV	105	CLASSROOM 252	14"	1,460 CFM	803 CFM	65 °F	106 °F	803 CFM	30400 Btu/h	180 °F	1.9 GPM	3/4"	2	25	TITUS DESV(S)	1,2,3,4
VAV	106	STUDY ROOMS 251/252	10"	1,030 CFM	564 CFM	65 °F	105 °F	564 CFM	21100 Btu/h	180 °F	1.9 GPM	3/4"	2	25	TITUS DESV(S)	1,2,3,4
VAV	107	LAB 254	14"	1,180 CFM	803 CFM	65 °F	112 °F	803 CFM	34800 Btu/h	180 °F	2.8 GPM	3/4"	2	25	TITUS DESV(S)	1,2,3,4

SEE SPECIFICATIONS FOR OTHER APPROVED MANUFACTURERS.
 SIZED AT 1.75 " STATIC PRESSURE DROP ACROSS BOX.
 SIZED USING 30% PROPYLENE GLYCOL.

4. PROVIDE WITH 3 WAY VALVE.



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PRA

OWTC HEALTH TECHNOLOGY NURSING EXPANSION

200 N. WASHINGTON BLVD OGDEN, UT 84404 No. Date Description
1 8/25/2020 DFCM PLAN REVIEW

Description

21147240 DFCM Project No. A SAA Project No.
Drawing Title MECHANICAL SCHEDULES

REVIEWED FOR CODE COMPLIANCE SIGNATURE 10/09/2020

# **GENERAL NOTES**

- CONSULT ARCHITECTURAL REFLECTED CEILING PLANS FOR EXACT LOCATION OF ALL LIGHTING FIXTURES.
- 2. VERIFY ALL EQUIPMENT DIMENSIONS AND LOCATIONS BEFORE BEGINNING ROUGH IN. CONSULT ALL APPLICABLE CONTRACT DRAWINGS AND SHOP DRAWINGS TO INSURE NEC CODE CLEARANCES REQUIRED AROUND ALL ELECTRICAL EQUIPMENT.
- CONTRACTOR SHALL VERIFY ALL ELECTRICAL LOADS (VOLTAGE, PHASE, CONNECTION REQUIREMENTS, ETC) OF ALL EQUIPMENT FURNISHED UNDER ALL DIVISIONS, INCLUDING ALL EXISTING EQUIPMENT TO BE RE-USED. REVIEW ALL SHOP DRAWINGS AND EXISTING EQUIPMENT BEFORE BEGINNING ROUGH-IN.
- SEE SECTION 265100 (16510) OF THE SPECIFICATION FOR REQUIRED COORDINATION MEETINGS WITH MECHANICAL AND CEILING CONTRACTORS.
- 5. SEE APPLICABLE SHOP DRAWINGS FOR ROUGH IN LOCATION OF ALL EQUIPMENT, WIRING DEVICES, ETC. WHERE APPLICABLE MOUNT ALL WIRING DEVICES ABOVE BACK SPLASH EXCEPT THOSE SERVING UNDER COUNTER EQUIPMENT.
- 6. SEE SPECIFICATION FOR ENERGY SAVING LAMP AND BALLAST REQUIREMENTS.
- 7. FINISHES OF ALL LIGHT FIXTURES SHALL BE AS SELECTED BY ARCHITECT.
- 8. THE ELECTRICAL CONTRACTOR SHALL NOTIFY AND COOPERATE WITH THE MECHANICAL CONTRACTOR SUCH THAT NO PIPING, DUCTS, OR EQUIPMENT FOREIGN TO THE OPERATION OF THE ELECTRICAL EQUIPMENT SHALL BE PERMITTED TO BE INSTALLED IN, ENTER OR PASS THRU ELECTRICAL ROOMS OR SPACES, OR ABOVE OR BELOW ELECTRICAL EQUIPMENT IN OTHER AREAS.
- 9. ELECTRICAL BOXES SHALL NOT BE LOCATED IN MASONRY COLUMNS IN BRICK WALLS OR IN GROUTED CELLS ADJACENT TO OPENINGS. COORDINATE LOCATION OF BOXES WITH MASONRY CONTRACTOR.
- 10. ALL PENETRATIONS OF FIRE RATED FLOORS, WALLS, AND CEILINGS SHALL BE SEALED WITH APPROVED MATERIAL TO MAINTAIN FIRE RATING OF SURFACE PENETRATED.
- 11. CIRCUITS EXTENDING OVER 70' FOR 120 VOLT AND 115' FOR 277 VOLT 20 AMP CIRCUITS SHALL BE RUN WITH CONDUCTORS PER TABLE BELOW.

20 AMP MINIMUM BR	ANCH CIRCUIT CONDU	JCTOR SIZING					
MAXIMUM LENGTH BRANCH CIRCUIT VOLTAGE							
CONDUCTOR LENGTH (FT)	120 VOLT	277 VOLT					
<70	MIN. #12 AWG	MIN. #12 AWG					
70 - 115	MIN. #10 AWG	MIN. #12 AWG					
115 - 170	MIN. #8 AWG	MIN. #10 AWG					
170 - 270	MIN. #6 AWG	MIN. #8 AWG					
271 - 380	NOTE B	MIN. #8 AWG					
>380	NOTE B	NOTE B					

- A. THESE ARE BASED ON MAXIMUM LENGTH OF CIRCUIT.
- B. PERFORM VOLTAGE DROP CALCULATIONS AND PROVIDE CONDUCTOR SIZE TO KEEP BRANCH CIRCUIT VOLTAGE DROP LESS THAN 3% WITH A 15 AMP LOAD.
- C. CONTRACTOR SHALL ENSURE THAT THE INSTALLATION OF EACH BRANCH CIRCUIT STAYS WITHIN 3% VOLTAGE DROP FOR A 15 AMP LOAD. IF NECESSARY, CONTRACTOR SHALL INCREASE WIRE AND CONDUIT SIZE TO MEET THE STANDARD AT NO ADDITIONAL COST TO OWNER.
- 12. CONTRACTOR SHALL VERIFY FURNITURE LAYOUT PRIOR TO ANY FLOORBOX OR POKE-THRU INSTALLATION. COORDINATE EXACT LOCATION OF FLOOR BOX OR POKE-THRU WITH OWNER AND FURNITURE PROVIDER PRIOR TO ROUGH-IN.

## **DEMOLITION NOTES**

- COORDINATE ALL NEW ELECTRICAL EQUIPMENT REQUIREMENTS AND MAKE CONNECTION TO EXISTING SYSTEMS. THIS INCLUDES LIGHTING, POWER, SIGNAL, RACEWAY AND OTHER SYSTEMS INCLUDED UNDER DIVISION 26 (16).
- RELOCATE, REWIRE AND/OR RECONNECT EXISTING ELECTRICAL DEVICES AND/OR EQUIPMENT THAT FOR ANY REASON OBSTRUCTS CONSTRUCTION.
- CONCEAL ALL RACEWAY AND WIRING IN EXISTING WALLS, CEILINGS, FLOORS, ETC. EXCEPT WHERE THE USE OF SURFACE METAL RACEWAYS (E.G. WIRE MOLD) IS INDICATED ON DRAWINGS OR IN SPEC.
- 4. LEAVE ALL EXISTING EQUIPMENT, IN PORTIONS OF THE BUILDING NOT BEING REMODELED, IN WORKING CONDITION. RESTORE ALL INTERRUPTED BRANCH CIRCUITS, FEEDERS, ETC. TO WORKING CONDITION.
- 5. EXISTING RACEWAYS MAY BE REUSED (IN PLACE) WHERE POSSIBLE, AND WHERE IN COMPLIANCE WITH THE SPECIFICATIONS AND THE INTENT OF THE CONTRACT DOCUMENTS. INSURE INTEGRITY OF EXISTING RACEWAY BEFORE REUSE.
- REMOVE ALL RACEWAYS, CONDUCTORS, BOXES, DEVICES, EQUIPMENT, ETC. THAT ARE NOT TO BE REUSED.
- 7. REMOVE EXISTING LIGHT FIXTURES WHICH ARE NOT TO BE REUSED, PLACE IN CARTON, LABEL APPROPRIATELY, AND RETURN TO OWNER, OR PROPERLY DISPOSE OF FIXTURES THAT THE OWNER CHOOSES NOT TO KEEP.
- 8. DO NOT PENETRATE STRUCTURAL ELEMENTS OF FLOORS, WALLS, CEILINGS, ROOFS, ETC.
- 9. DISCONNECT AND RECONNECT ANY/ALL FIXTURES, DEVICES, EQUIPMENT, ETC. REQUIRED FOR PROPER COMPLETION OF THE WORK.

# SHEET INDEX

E001 E002 E003	SYMBOLS, SCHEDULES AND NOTES SCHEDULES AND NOTES ELECTRICAL SPECIFICATIONS
E101 E102	LEVEL 02 AREA A DEMOLITION PLAN LEVEL 02 AREA B DEMOLITION PLAN
E201 E202 E203	LEVEL 02 AREA A LIGHTING PLAN LEVEL 02 AREA B LIGHTING PLAN WALLSTATIONS
E301 E302	LEVEL 02 AREA A POWER PLAN LEVEL 02 AREA B POWER PLAN
E401 E402	LEVEL 02 AREA A SYSTEMS PLAN LEVEL 02 AREA B SYSTEMS PLAN
E501	ELECTRICAL DIAGRAMS

# **ELECTRICAL SYMBOL SCHEDULE**

1. SEE FIXTURE SCHEDULE FOR TYPE, MOUNTING AND WATTAGE. 2. HEIGHT MEASURED TO CENTER LINE OF THE BOX FROM THE FINISH FLOOR.

- 3. REFER TO DRAWINGS FOR DIRECTIONAL ARROWS.
- 4. SUBSCRIPT KEYS SWITCH TO FIXTURES CONTROLLED
- 5. NEMA TYPE 'ND' NON-FUSED UNLESS NOTED 'F' (FUSED). USE 'HD' 480 V.
- 6. HEIGHT MEASURED TO TOP OF THE BOX FROM FINISH FLOOR. 7. PROVIDE H.O.A. AND S.S. PUSHBUTTONS AS REQUIRED.
- 8. DOUBLE ARROWS DENOTE A DOUBLE FACE UNIT.
- 9. COORDINATE WITH MILLWORK SHOP DRAWINGS AND ELEVATIONS FOR HEIGHT.
- 10. SUBSCRIPT DENOTES NEMA CONFIGURATION. 11. HEIGHT MEASURED TO BOTTOM OF THE BOX FROM FINISH FLOOR.
- 12. COORDINATE WITH DOOR HARDWARE SUPPLIER.
- 13. FOR WATER COOLER, SEE DIAGRAM R002. FOR ALL OTHER LOCATIONS. MOUNT AT +16" TO BOTTOM OF THE BOX FROM FINISH FLOOR, OR AS NOTED.

STANDARD	MOUNTING HEIGHT UNLESS OTHERWISE NOTED ON PL	ANS						
GENERAL								
SYMBOL	DESCRIPTION	MOUNTING HEIGHT	NOTES		SYMBOL	DESCRIPTION	MOUNTING HEIGHT	NOTES
	ONE CIRCUIT, HOME RUN TO PANEL					CONDUIT STUB LOCATION	CAP CONDUIT	
	2 CIRCUIT, HOME RUN TO PANEL					CONDUIT/CIRCUIT CONTINUATION		
	3 CIRCUIT, HOME RUN TO PANEL				<u> </u> / <u> </u>	CABLE TRAY	AS NOTED	
	CONDUIT RUN CONCEALED IN WALL OR CEILING				A	LIGHT FIXTURE (LETTER DESIGNATES TYPE)		
	CONDUIT RUN CONCEALED IN FLOOR OR GROUND				(EQ) 34	EQUIPMENT NUMBER		
	CONDUIT UP			1	842	ARCHITECTURAL ROOM NUMBER		
•	CONDUIT DOWN					DEVICE/EQUIPMENT (TEXT DESIGNATES TYPE) SEE SCHEDULE		
	EQUIPMENT PANEL, SEE DRAWINGS	TOP AT +6'-0"				SEE SCHEDULE DEVICE/EQUIPMENT (TEXT DESIGNATES TYPE) SEE SCHEDULE		
LIGHTING								
0	CEILING LIGHT FIXTURE	CEILING	1.		\$×	SINGLE POLE SWITCH	+4'-0"	6. 4.
Ю	WALL LIGHT FIXTURE	AS NOTED	1.		<b>\$</b> <sup>3</sup>	THREE-WAY SWITCH	+4'-0"	6.
	RECESSED DOWNLIGHT FIXTURE	CEILING	1.		\$ <sup>4</sup>	FOUR-WAY SWITCH	+4'-0"	6.
$\bigcirc\rangle$	RECESSED WALLWASH DOWNLIGHT FIXTURE	CEILING	1.		\$ <sup>K</sup>	KEY OPERATED SWITCH	+4'-0"	6.
0	LIGHT FIXTURE	AS NOTED	1.	1	\$P	SWITCH WITH PILOT LIGHT	+4'-0"	6.

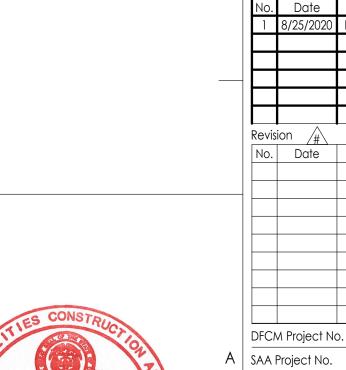
				 •			
0	LIGHT FIXTURE	AS NOTED	1.	\$ <sup>P</sup>	SWITCH WITH PILOT LIGHT	+4'-0"	6.
	EGRESS LIGHT FIXTURE	AS NOTED	UNSWITCHED	\$ <sup>D</sup>	VARIABLE INTENSITY SWITCH	+4'-0"	6.
•-	AREA LIGHT POLE AND FIXTURE	CONCRETE BASE	SEE DIAGRAM	\$ <sup>TM</sup>	TIMER SWITCH	+4'-0"	6.
•	BOLLARD	CONCRETE BASE	1.	<b>\$</b>	MOMENTARY CONTACT SWITCH	+4'-0"	6.
	STEP LIGHT FIXTURE	AS NOTED	1.	Ďx	LOW VOLTAGE WALLSTATION (SUBSCRIPT INDICATES CONFIGURATION & CONTROL SEQUENCE)		2., SEE DIAGRAM, SPEC.
$\Diamond$	FLOOD OR TRACK FIXTURE	AS NOTED			DUAL TECH. CEILING MOUNTED OCCUPANCY SENSOR (PROVIDE WITH ALL PP AND RC CONTROLLERS)	CEILING	SEE DIAGRAM, SPEC.
$\otimes \bowtie$	CEILING/WALL MOUNTED EXIT LIGHT	CEILING/ AS NOTED	1. 3. 8.	Ю	DUAL TECH. WALL MOUNTED OCCUPANCY SENSOR (SUBSCIPT D = DIMMING AND DAYLIGHT CONTROL)	+4'-0"	SEE DIAGRAM, SPEC.
4	EMERGENCY LIGHT FIXTURE	AS NOTED	1.	P	PHOTO-ELECTRIC CONTROL (LOCATE ON ROOF, FACE NORTH)	AS NOTED	MOUNT AS PER MFR.
4⊗>	COMBO EXIT / EMERGENCY LIGHT FIXTURE	AS NOTED			DIGITAL DAYLIGHT SENSOR	CEILING	SEE DIAGRAM, SPEC.
PP	POWER PACK	CEILING	SEE DIAGRAM, SPEC.	TC	TIME CLOCK	+5'-0"	2.
® <sub>X</sub>	DIGITAL ROOM CONTROLLER (SUBSCRIPT INDICATES NUMBER OF RELAYS)	CEILING	SEE DIAGRAM, SPEC.	R	RECEPTACLE SWITCH PACK	CEILING	
(EP)	EMERGENCY LIGHTING CONTROL UNIT	ABOVE CEILING	SEE DIAGRAM, SPEC.				
POWER							

	<del></del>	DUPLEX RECEPTACLE UPPER OUTLET SWITCH CONTROLLED	+16" OR AS NOTED	9. 11.		POWER POLE		
	$\overline{}$	SIMPLEX RECEPTACLE	+16" OR AS NOTED	9. 11.	<u> </u>	PLUGMOLD	+46" OR AS NOTED	
Ī	⊕т	TAMPER-PROOF RECEPTACLE	+16" OR AS NOTED	9. 11.	(P)	FLAT PANEL DISPLAY WALL BOX TVSS RECEPT., DATA AND OTHER DEVICES, REFER TO DIAGRAMS	AS NOTED	SEE DIAGRA SPEC. 26 272
	$\Rightarrow$	DUPLEX RECEPTACLE	+16" OR AS NOTED		(P)	CEILING PROJECTION SYSTEM CEILING BOX	ABOVE CEILING	SEE DIAGRA SPEC.
	<b>⊕</b> υ	DUPLEX RECEPTACLE WITH USB OUTLET	+16" OR AS NOTED		Ю	CLOCK OUTLET	+7'-6"	8.
	=©	CONTROLLED DUPLEX RECEPTACLE	+16" OR AS NOTED	9. 11.	FB	FLOOR BOX - SEE SCHEDULE	FLOOR	SEE DIAGRA SPEC.
	₩A	DUPLEX RECEPTACLE		9.	PT	POKE THRU - SEE SCHEDULE	FLOOR	SEE DIAGRA SPEC.
	⊕ <sub>G</sub>	5mA GFCI CIRCUIT BREAKER PROTECTED RECEPTACLE		13.	J F	JUNCTION BOX ('F' IN FLOOR)	AS NOTED	
	₩P	WEATHERPROOF RECEPTACLE	+24" OR AS NOTED		//	MOTOR OUTLET	TO SUIT EQUIP.	
	⊕ <sub>IG</sub>	ISOLATED GROUND RECEPTACLE	+16" OR AS NOTED			PANEL BOARD	+6'-0"	6.
	-	GROUND FAULT INTERRUPTER DUPLEX RECEPTACLE	+16" OR AS NOTED	9. 11.		MAIN DISTRIBUTION PANEL		
	=	DUPLEX RECEPTACLE EMERGENCY POWER (RED)	+16" OR AS NOTED	9. 11.				
	#	4-PLEX RECEPTACLE	+16" OR AS NOTED	9. 11.				
	#	GROUND FAULT INTERRUPTER 4-PLEX RECEPTACLE	+16" OR AS NOTED	9. 11.				

TELECOMMU	ELECOMMUNICATIONS								
⊳w	WALL PHONE	+60" OR AS NOTED	2.						
$\triangleright$	DATA OUTLET, ONE CABLE	+16" OR AS NOTED	9. 11.						
		+16" OR							

4-PLEX RECEPTACLE EMERGENCY POWER (RED)

	DATA OUTLET, TWO CABLES	AS NOTED	9. 11.
	DATA OUTLET, THREE CABLES	+16" OR AS NOTED	9. 11.
▶x	DATA OUTLET, "X" INDICATES QUANTITY	+16" OR AS NOTED	9. 11.



SYMBOLS, SCHEDULES **AND NOTES** 

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ASF UT

Description DFCM PLAN REVIEW

Description

21147240 2020-16

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Sheet Number

Drawing Title

**REVIEWED FOR** CODE COMPLIANCE SIGNATURE Sometime

DFCM approval

# GENERAL\_LIGHT FIXTURE SCHEDULE

ABOVE FINISH FLOOR WALL@CLG WALL MOUNT AT CORNER OF WALL AND CEILING

CUSTOM PAINTED COLOR AS SELECTED BY THE ARCHITECT

CFBA

CUSTOM FINISH AS SELECTED BY THE ARCHITECT SFBA STANDARD FINISH AS SELECTED BY THE ARCHITECT

### LIGHT FIXTURE GENERAL NOTES

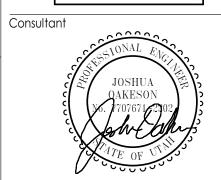
REFER TO ARCHITECTURAL REFLECTED CEILING PLANS FOR LOCATIONS OF LIGHT FIXTURES AND, CONFIRM CEILING TYPES WITH LIGHT FIXTURE TRIMS. BRING ALL DISCREPANCIES OF LOCATIONS AND QUANTITIES TO THE ATTENTION OF THE ARCHITECT AND ELECTRICAL ENGINEER PRIOR TO BIDDING.

- REFER TO ARCHITECTURAL ELEVATIONS FOR MOUNTING HEIGHTS AND LOCATIONS OF LIGHT FIXTURES. BRING ALL DISCREPENCIES TO THE ATTENTION OF THE
- REFER TO THE SPECIFICATIONS FOR OTHER LIGHT FIXTURE, FUSING, LED DRIVERS, AND LAMP REQUIREMENTS AND ACCEPTABLE MANUFACTURERS.
- CONFIRM AVAILABLE MOUNTING DEPTHS OF ALL LIGHT FIXTURES AND COMPARE WITH DEPTHS SHOWN ON SHOP DRAWINGS. BRING ALL POTENTIAL CONFLICT AREAS TO THE ATTENTION OF THE ARCHITECT AND ELECTRICAL ENGINEER PRIOR TO RELEASE.
- REFER TO LIGHTING PLANS FOR ALL LINEAR FIXTURE LENGTHS. THE CATALOG NUMBER IS BASED ON THE FIXTURE SPECIFIED AND MAY NOT REFLECT THE QUANTITY OR OVERALL LENGTH OF LINEAR FIXTURES REQUIRED. CONTRACTOR TO NOTE THAT VARIOUS FIXTURE LENGTHS MAY BE REQUIRED TO ACHIEVE THE OVERALL RUN
- REFER TO LIGHTING PLANS FOR ALL UNDERCABINET FIXTURE LENGTHS. THE CATALOG NUMBER IS BASED ON THE FIXTURE SPECIFIED AND MAY NOT REFLECT THE QUANTITY OR OVERALL LENGTH OF THE UNDERCABINET FIXTURES REQUIRED. CONTRACTOR TO NOTE THAT VARIOUS FIXTURE LENGTHS MAY BE REQUIRED TO ACHIEVE THE OVERALL RUN LENGTH OR TO FIT WITHIN THE MILLWORK. COORDINATE FIXTURE LAYOUT WITH MILLWORK SHOP DRAWINGS PRIOR TO LIGHTING SUBMITTALS.
- WHEN A CONTRADICTION EXISTS BETWEEN A SPECIFIC MODEL NUMBER AND THE DESCRIPTION, NOTIFY THE ELECTRICAL ENGINEER AND/OR LIGHTING DESIGNER. 8. PRIOR APPROVALS ARE REQUIRED BEFORE BIDDING THE PROJECT AND SHALL BE SUBMITTED TO THE ELECTRICAL ENGINEER'S OFFICE AT LEAST (8) EIGHT WORKING
- DAYS BEFORE THE BID. PRIOR APPROVALS RECEIVED AFTER THIS TIME PERIOD SHALL BE REJECTED. 9. REFER TO SPECIFICATIONS 20 0500, 26 5100 & 26 5600 (16001, 16510 & 16551).
- 10. VALUE ENGINEERING CONDUCTED WITHOUT THE DESIGN TEAM IE; ARCHITECT, ENGINEER & LIGHTING CONSULTANT/DESIGNER WILL NOT BE ALLOWED, REVIEWED OR APPROVED.

TYPE	DESCRIPTION	MFR.	CATALOG NUMBER	VOLTS	TOTAL WATTS	LAMP
A2DSC	8' LINEAR PENDANT FOR CLASSROOM	LITECONTRO L	SAE-106-P-LPA-8-SOF-C1-35K-130-2D-D01- 1C-UNV-FA1	277 V	88 VA	LAMP: LED LUMENS: 10,400 CCT: 3500K
A2DSC E	8' LINEAR PENDANT FOR CLASSROOM; EM BATTERY BACKUP	LITECONTRO L	SAE-106-P-LPA-8-SOF-C1-35K-130-2D-D01- 1C-UNV-FA1-EF	277 V	88 VA	LAMP: LED LUMENS: 10,400 CCT: 3500K
G	2X4 LED EDGE-LIT FLAT PANEL, 0-10V DIMMING	COLUMBIA	SRP24-40-HL-G-ED-U	277 V	54 VA	LAMP: LED LUMENS: 5,465 CCT: 4000K
G2	2X4 LED EDGE-LIT FLAT PANEL, 0-10V DIMMING	COLUMBIA	SRP24-35-ML-G-ED-U	277 V	45 VA	LAMP: LED LUMENS: 4,744 CCT: 3500K
GE	2X4 LED EDGE-LIT FLAT PANEL, 0-10V DIMMING, EM BATTERY BACKUP	COLUMBIA	SRP24-40-HL-G-ED-U-ELL14	277 V	54 VA	LAMP: LED LUMENS: 5,465 CCT: 4000K
J2	4' WALL MOUNTED BED LIGHT	HEALTHCAR E SOLUTIONS	RBL-4-8-35K-WH-U-P1L-P1R	277 V	35 VA	LAMP: LED LUMENS: 3,107 CCT: 3500K
L	4' RECESSED HALLWAY LED LIGHT	LITECONTRO L	4L-NG-D-04-BWO-C1-35K-D100-NDM-1C-UN V	277 V	36 VA	LAMP: LED LUMENS: 4,000 CCT: 3500K
LE	4' RECESSED HALLWAY LED LIGHT; EM BATTERY BACKUP	LITECONTRO L	4L-NG-D-04-BWO-C1-35K-D100-NDM-1C-UN V-EF	277 V	36 VA	LAMP: LED LUMENS: 4,000 CCT: 3500K
X1	SINGLE SIDED EDGELIT EXIT SIGN; GREEN LETTERS; UNIVERSAL MOUNTING INCLUDED: BRUSHED ALUMINUM FINISH	DUAL-LITE	SE-S-G-W	277 V	10 VA	LAMP: LED

PROJECT MANAGER: XX STANDARD PAINTED COLOR AS SELECTED BY THE ARCHITECT





NURSING

DFCM PLAN REVIEW Description

DFCM Project No. A SAA Project No. Drawing Title

SCHEDULES AND NOTES

21147240

2020-16

LIGHTING SENSOR GENERAL NOTES

THE ELECTRICAL CONTRACTOR SHALL BE RESPONSIBLE FOR CONTACTING THE SENSOR

MANUFACTURER FOR PROPER PLACEMENT AND ADJUSTMENT OF OCCUPANCY SENSORS.

LIGHT FIXTURE ABBREVIATION SCHEDULE

EACH ZONE SHALL HAVE COVERAGE BY OCCUPANCY SENSOR SUCH THAT NO BLIND SPOT

UPON COMPLETION OF THE INSTALLATION, THE SYSTEM SHALL BE COMPLETELY COMMISSIONED BY THE MANUFACTURER'S FACTORY AUTHORIZED TECHNICIAN WHO WILL VERIFY ALL ADJUSTMENTS AND SENSOR PLACEMENT TO ENSURE A TROUBLE FREE INSTALLATION.

THE LOCATION AND QUANTITIES OF SENSORS SHOWN ON THE DRAWINGS ARE DIAGRAMMATIC AND INDICATE ONLY THE ROOMS WHICH ARE TO BE PROVIDED WITH SENSORS. THE ELECTRICAL CONTRACTOR SHALL PROVIDE ADDITIONAL SENSORS IF REQUIRED TO PROPERLY COVER THE RESPECTIVE ROOM.

PROVIDE DAYLIGHT ZONE CONTROL REQUIREMENTS PER IECC-2015 C405.2.2.3. LOCATE DAYLIGHT SENSOR(S) PER MANUFACTURER'S RECOMMENDATION AND WHERE REQUIRED WITHIN THE ROOM FOR PROPER COVERAGE.

PROVIDE OCCUPANCY SENSOR WITH AN ADDITIONAL SET OF DRY CONTACTS FOR HVAC CONTROL AT EACH VAV BOX LOCATION. COORDINATE WITH MECHANICAL DRAWINGS AND THE MECHANICAL CONTRACTOR FOR EXACT LOCATIONS.

### ARREVIATIONS INDEX

ABBREV.	DESCRIPTION	ABBREV.	DESCRIPTION
#	NUMBER	MH	MANHOLE
AC	ALTERNATING CURRENT	MIC	MICROPHONE
A.F.F.	ABOVE FINISH FLOOR	MIN	MINIMUM
AIC	AMPS INTERRUPTING CAPACITY	MTG	MOUNTING
AM	AMPS METER	MTR	MOTOR
AMP	AMPERE	N/A	NOT APPLICABLE
ANN	ANNUNCIATOR	NC	NORMALLY CLOSED
ATS	AUTOMATIC TRANSFER SWITCH	NEC	NATIONAL ELECTRICAL CODE
AUX			
	AUXILIARY	NEMA	NATIONAL FIRE PROTECTION ASSOC.
AWG BC	AMERICAN WIRE GAUGE	NFPA	NATIONAL FIRE PROTECTION ASSOC
BFG	BARE COPPER	N.I.C.	NOT IN CONTRACT
C C	BELOW FINISH GRADE	NO NTS	NORMALLY OPENED  NOT TO SCALE
	CONDUIT		
CAB	CABINET COMMUNITY ANTENINA TELEVICIONI	OS & Y	OUTSIDE SCREW & YOKE
CATH	COMMUNITY ANTENNA TELEVISION	PB	PUSHBUTTON
CATV	CABLE TELEVISION	PF	POWER FACTOR
CKT	CIRCUIT	PFR	PHASE FAILURE RELAY
CLG	CEILING	PNL	PANEL
CNTR	CONTRACTOR	PT	POTENTIAL TRANSFORMER
C.O.	CONDUIT ONLY	PVC	POLYVINYL CHLORIDE CONDUIT
CRT	COMPUTER TERMINAL	(R)	RELOCATE
СТ	CURRENT TRANSFORMER	RECEP	RECEPTACLE
CU	COPPER	REQ	REQUIREMENT
C/W	COMPLETE WITH	RLA	RATED LOAD AMPS
DB	DECIBEL	RMP	ROCKY MOUNTAIN POWER
DC	DIRECT CURRENT	RMS	ROOT MEAN SQUARE
DWG	DRAWING	SE	SERVICE ENTRANCE
(E)	EXISTING	SPEC	SPECIFICATIONS
EC	EMPTY CONDUIT	SPKR	SPEAKER
EG	EMERGENCY GENERATOR	SS	SELECTOR SWITCH
EMT	ELECTRICAL METALLIC TUBING	SW	SWITCH
EX	EXPLOSION PROOF	SWBD	SWITCHBOARD
FACP	FIRE ALARM CONTROL PANEL	SWGR	SWITCHGEAR
FC	FOOT CANDLE	TTB	TELEPHONE TERMINAL BOARD
FT	FOOT	TTC	TELEPHONE TERMINAL CABINET
GFI	GROUND FAULT INTERRUPTER	TV	TELEVISION
GND	GROUND	TYP	TYPICAL
GRC	GALVANIZED RIGID CONDUIT	UG	UNDERGROUND
HP	HORSE POWER	UPS	UNINTERRUPTED POWER SUPPLY
HZ	HERTZ	V	VOLT (KV-KILOVOLT)
IFC	INTERNATIONAL FIRE CODE	VA/R	VOLT-AMPS/REACTIVE
IG	ISOLATED GROUND	VM	VOLT METER
IMC	INTERMEDIATE METALLIC CONDUIT	W	WATTS
IN	INCH	W/	WITH
J-BOX	JUNCTION BOX	WH	WATTHOUR METER
KV	KILOVOLT	W/O	WITHOUT
KVA	KILOVOLT AMPERES	WP	WEATHERPROOF
KVAR KVAR	KILOVARS	XFMR	TRANSFORMER
KW	KILOWATT	XFMR SW	TRANSFER SWITCH
LRA	LOCKED ROTOR AMPS	XP XP	EXPLOSION PROOF
		1P	
LTG	LIGHTING		SINGLE-PHASE
MNF	MANUFACTURER	2P	TUPEE POLE
MAX	MAXIMUM	3P	THREE-POLE
MB	MAIN BUS	4P	FOUR-POLE
MCC	MOTOR CONTROL CENTER	Ø	PHASE
MCM	1000 CIRCULAR MILLS		

### ELECTRICAL GENERAL PROVISIONS

- **Description of Work**: Extent of electrical work is indicated on drawings. Provide all labor, materials, equipment, supervision and service necessary for a complete electrical system. Work includes, but is not necessarily limited to the following items:
  - Electrical Connections for Equipment
  - Grounding
- Conduit RacewayConductors and Cables
- Electrical Boxes and Fittings
   Supporting Dovices
- Supporting DevicesElectrical Seismic Control
- Wiring DevicesFloor Boxes
- Light Fixtures
- Electrical Identification
- TelecommunicationsFire Alarm and Detection Systems
- Visit the site during the bidding period to determine existing conditions affecting electrical and other work. All costs arising from site conditions and/or preparation shall be included in the base bid. No additional charges will be allowed due to inadequate site inspection.
- Quality Assurance: Perform work in accordance with the National Electrical Code (NEC). Comply with requirements of State and Local Ordinances. Obtain all permits, inspections, etc. from Authority Having Jurisdiction (AHJ). Employ only qualified craftsmen with at least three years of experience. Workmanship shall be neat, have a good mechanical appearance and conform to best electrical state contracting license. Provide equipment and material that are Underwriters Laboratories Inc. (UL) listed and labeled.
- Submittals: After the Contract is awarded but prior to manufacture or installation of any equipment, prepare complete shop drawings.
- Provide submittals in Portable Document Format (PDF).
- Documents must be electronically bookmarked and keyword searchable using Adobe Acrobat (http://www.adobe.com/acrobat) or Bluebeam Revu (http://www.bluebeam.com) for each relevant section. (i.e. Include electronic bookmarks separating "Light Fixtures" from "Panelboards".)
- Electronically highlight <u>all options</u> for light fixtures, electrical equipment, etc. Manual highlighting and scanning of the documents is NOT acceptable and will NOT be reviewed.
- Provide only completed cutsheets for all fixture and equipment types. Blank cutsheets submitted with a schedule are NOT
- acceptable and will NOT be reviewed.
   A maximum of one submittal per specification section is allowed. It is NOT acceptable to provide a product by product submittal. Single product by product submittals will NOT be reviewed.
  - Wiring Devices
- Floorboxes
- Light FixturesElectrical Identification
- Telecommunications
- Fire Alarm and Detection Systems
- Record Drawings: Maintain on a daily basis, a complete set of record drawings, reflecting an accurate dimensional record of all buried or
  concealed work. Mark record drawings to show the precise location of concealed work and equipment, including concealed or embedded
  conduit and junction boxes and all changes and deviations in the work from that shown on the Contract Documents.
- Operation and Maintenance Manuals: Provide operating instruction and maintenance data books for all equipment and materials furnished under this division.
- **Guarantee:** Ensure that electrical systems installed under this contract is in proper wiring order and in compliance with drawings, specifications, and/or authorized changes. Without additional charge, replace any work or materials which develop defects, except from ordinary wear and tear, within one year from the date of substantial completion.
- **Fire Protection Seals:** Seal all penetrations for work of this section through fire rated floors, walls, and ceilings to prevent the spread of smoke, fire, toxic gas, or water through the penetration either before, during and after fire.
- **Power Outages:** All power outages required for execution of this work shall occur during the non-standard working hours and at the convenience of the owner. Include all costs for overtime work in bid.

### ELECTRICAL CONNECTION FOR EQUIPMENT

Verify exact load and location of all equipment before rough-in for each electrical connection. Provide complete assembly of material, including but not necessarily limited to, raceways, conductors, cords, cord caps, plugs, wiring devices, pressure connectors, terminals (lugs), electrical insulating tape, heat-shrinkable insulating tubing, cable ties, solderless wire nuts, and other items and accessories as needed to complete splices, terminations, and connections as required. For permanently installed fixed equipment, provide flexible seal-tite connection. For movable and/or portable equipment, provide wiring device, cord cap, and multi-conductor cord.

### GROUNDING

Provide grounding and bonding of all electrical and communication apparatus, machinery, appliances, building components, and items required by the NEC to provide a permanent, continuous low impedance, grounding system. Provide an NEC bonding/grounding conductor in all raceways used for power distribution.

### CONDUIT RACEWAYS

- Provide metal conduit, tubing, and fittings of types, grades, sizes, and weights (wall thickness) as required; with minimum trade size of 3/4". Install electrical raceway systems in accordance with manufacturer's written instructions and applicable requirements of NEC and NECA "Standard of Installation" in accordance with the following:
  - Feeders: Install feeders rated 100 Amps and greater, in Electrical Mettalic conduit (EMT); Where buried below grade, install in concrete encased non-metallic conduit or duct (Schedule 40 PVC).
- Branch Circuits, and individual Equipment Circuits rated less than 100 Amps: Install in Electrical Metallic Tubing (EMT). Where located in poured walls, below concrete slab-on-grade, or in earth fill, install in non-metallic plastic duct (Schedule 40 PVC). Encase non-metallicplastic duct1-1/4" and larger in concrete.
- Provide rigid metal conduit (RMC) for all bends in buried conduit greater than 30 degrees. Provide protective coating for rigid
  metal conduit bends. Install flexible conduit for connections of motors, transformers, and other electrical equipment where
  subject to movement and vibrations. Provide OZ, expansion fittings on all conduits crossing building expansion joints, both in slab
  and suspended.
- Provide surface raceways of sizes and channels indicated. Provide fittings that match and mate with raceway.

### CONDUCTORS AND CABLES

 Provide factory-fabricated conductors for sized, ratings, material, and types indicated for each service. Provide copper conductors, with THHN/THWN insulation. Size all conductors in accordance with NEC; minimum size to be #12 AWG. Provide stranded conductors for #8 AWG and larger.

### ELECTRICAL BOXES AND FITTINGS

Provide one piece galvanized flat rolled sheet steel interior outlet wiring boxes, corrosion-resistant cast-metal weatherproof outlet wiring boxes, code-gage sheet steel junctions and pull boxes, cast-iron waterproof adjustable floor boxes, galvanized cast-metal conduit bodies, corrosion-resistant punched-steel box knockout closures, conduit lockouts and malleable steel conduit bushings and offset connectors, and all accessories as required to suit each respective location and installation. Fasten boxes rigidly to substrates or structural surfaces to which attached, or solidly embed electrical boxes in concrete or masonry. Use bar hangers for stud construction.

Provide supports, anchors, sleeves and seals as required for a complete raceway support system, including but not limited to: clevis hangers, riser clamps, c-clamps, beam clamps, one and two hole conduit straps, offset conduit clamps, expansion anchors, toggle bolts, threaded rods, U-channel strut system, and all associated accessories. Install in accordance with manufacturer's written instructions and with recognized industry practices to insure supporting devices comply with requirements. Provide rigid attachment of all floor mounted equipment to the floor slab or structural system.

### ELECTRICAL SEISMIC CONTROL

Provide seismic control equipment including but not limited to: vibration isolators, flexible connections, rigid steel frames, anchors, inserts and attachments, seismic snubber and bracing to meet the seismic requirements for the project site.

### WIRING DEVICES

Provide grade factory-fabricated wiring devices, in types, and electrical ratings for applications indicated and complying with NEMA STDS Pub No. WD-1. Provide heavy duty specification grade, 20- amperes rated, grounding type convenience outlets,. Provide 20-amperes rated toggle switches. Construct wiring device of heavy duty high impact nylon and provide cover plates to match. Provide devices in colors selected by Architect.

### EL 000 D0VE0

Provide leveling and fully adjustable floor service receptacle outlets and fittings of time and ratings as indicated on the drawings. All boxes shall comply with UL standard UL514A.

### LIGHTING FIXTURES

Provide lighting fixtures complete with all components for each size, type, and rating indicated. This includes, but not limited to housing, driver, reflectors, and wiring. Size fuses per ballast manufacturer's recommendation. Provide all necessary supports, brackets, and miscellaneous equipment for mounting of fixtures. Support all grid mounted fixtures from the building structure with #12 ga. steel wire attached to each corner; independent of the ceiling system. Provide backing supports. Provide gypsum board protection as required to maintain fire rating of each ceiling in which fixtures are installed. Provide all exterior fixtures with damp or wet location label as required by application. Provide Class 2 wiring for all fixtures indicated to have 0-10v dimming.

### ELECTRICAL IDENTIFICATION

Provide electrical identification products for buried electrical lines, arc-flash hazard labels (ANSI Z535.4), source of supply labels, available

for the support labels and approximate an interest in the labels and approximate the supply labels.

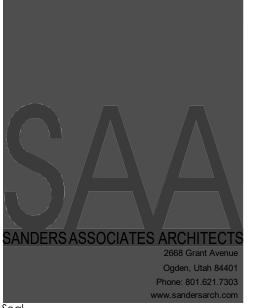
- fault current labels and emergency operating signs to equipment installed as part of this project.
- Provide nylon type coverplates that match devices. Provide metal covers for all devices in unfinished spaces Provide labels on coverplates indicating source of power (i.e. Panel Circuit #).

### TELECOMMUNICATIONS (RACEWAY ONLY)

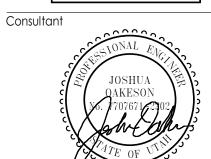
- Provide a complete raceway system including but not limited to: raceway, outlets, coverplates, backboards, grounding, and miscellaneous items as required.
- Provide (1) 3/4" EMT conduit from each telephone and data device to cable tray or telecom rack (whichever is closer). Comply with NEC, BICSI and recoginzed industry practices. Provide nylon pull cord in all installed raceway.
- Provide (1) #6 bare copper ground from each telephone/data system terminal board to the service entrance ground. Coil six feet of conductor at each terminal board.

### FIRE ALARM AND DETECTIONS SYSTEMS

Provide an addressable, electrically supervised fire alarm system with all aplicable provisions of the current NFPA 72, National Fire Alarm Code, IFC International Fire Code and shall meet all requirements of the local authority having jurisdiction. Provide a minimum of #14 AWG copper wiring in 3/4" conduit. Fire Alarm MC is not allowed.







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ELECTRICAL SPECIFICATIONS

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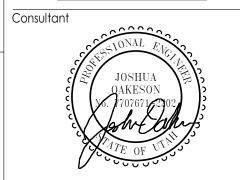
E003



SHEET KEYNOTES

- D1 EXISTING LIGHT FIXTURE TO BE DEMOLISHED BY CONTRACTOR. GIVE 3 FIXTURES TO OWNER FOR STOCK. REUSE WIRE TO CONNECT NEW LIGHT FIXTURE. SEE SHEET E201 FOR NEW LIGHTING FIXTURE PLACEMENTS.
- D2 EXISTING LIGHT SWITCH TO BE REMOVED AND HOLE COVERED UP IN WALL.
- D3 EXISTING MOTORIZED SCREEN TO BE REMOVED AND HOLE COVERED UP IN WALL. REUSE SCREEN IN CLASSROOM/DEBRIEFING ROOM #200
- D4 EXISTING POWER OUTLET TO BE REMOVED AND HOLE COVERED UP IN WALL.
- D5 EXISTING DEVICE(S) TO STAY.
- D6 EXISTING LIGHT FIXTURE TO BE MOVED UP INSIDE CONTROL STATION ROOM.
- D8 EXISTING POWER IN CEILING TO STAY. REUSE PROJECTOR IN CLASSROOM/DEBRIEFING
- D9 EXISTING SCREEN CONTROLLER BUTTON TO BE REMOVED AND HOLE COVERED UP IN WALL
- D10 EXISTING EXTRON TOUCH PANEL TO BE REMOVED AND HOLE COVERED UP IN WALL.
- D12 EXISTING FLOOR BOX TO BE REMOVED. COORDINATE WITH ARCHITECTURAL PLAN TO REPAIR
- D13 OWNER TO DEMOLISH EXISTING CAMERA MONITOR RACK.
- D14 EXISTING OCCUPANCY SENSOR TO BE REMOVED AND HOLE COVERED UP IN CEILING.
- D15 EXISTING LIGHT SWITCH TO STAY. LIGHT FIXTURES IN NEW HALLWAY TO BE CONTROLLED BY THIS LIGHT SWITCH.
- D17 EXISTING DEVICES TO BE REMOVED AND HOLE COVERED UP IN WALL. REUSE THESE DEVICES ON SIDE WALL.





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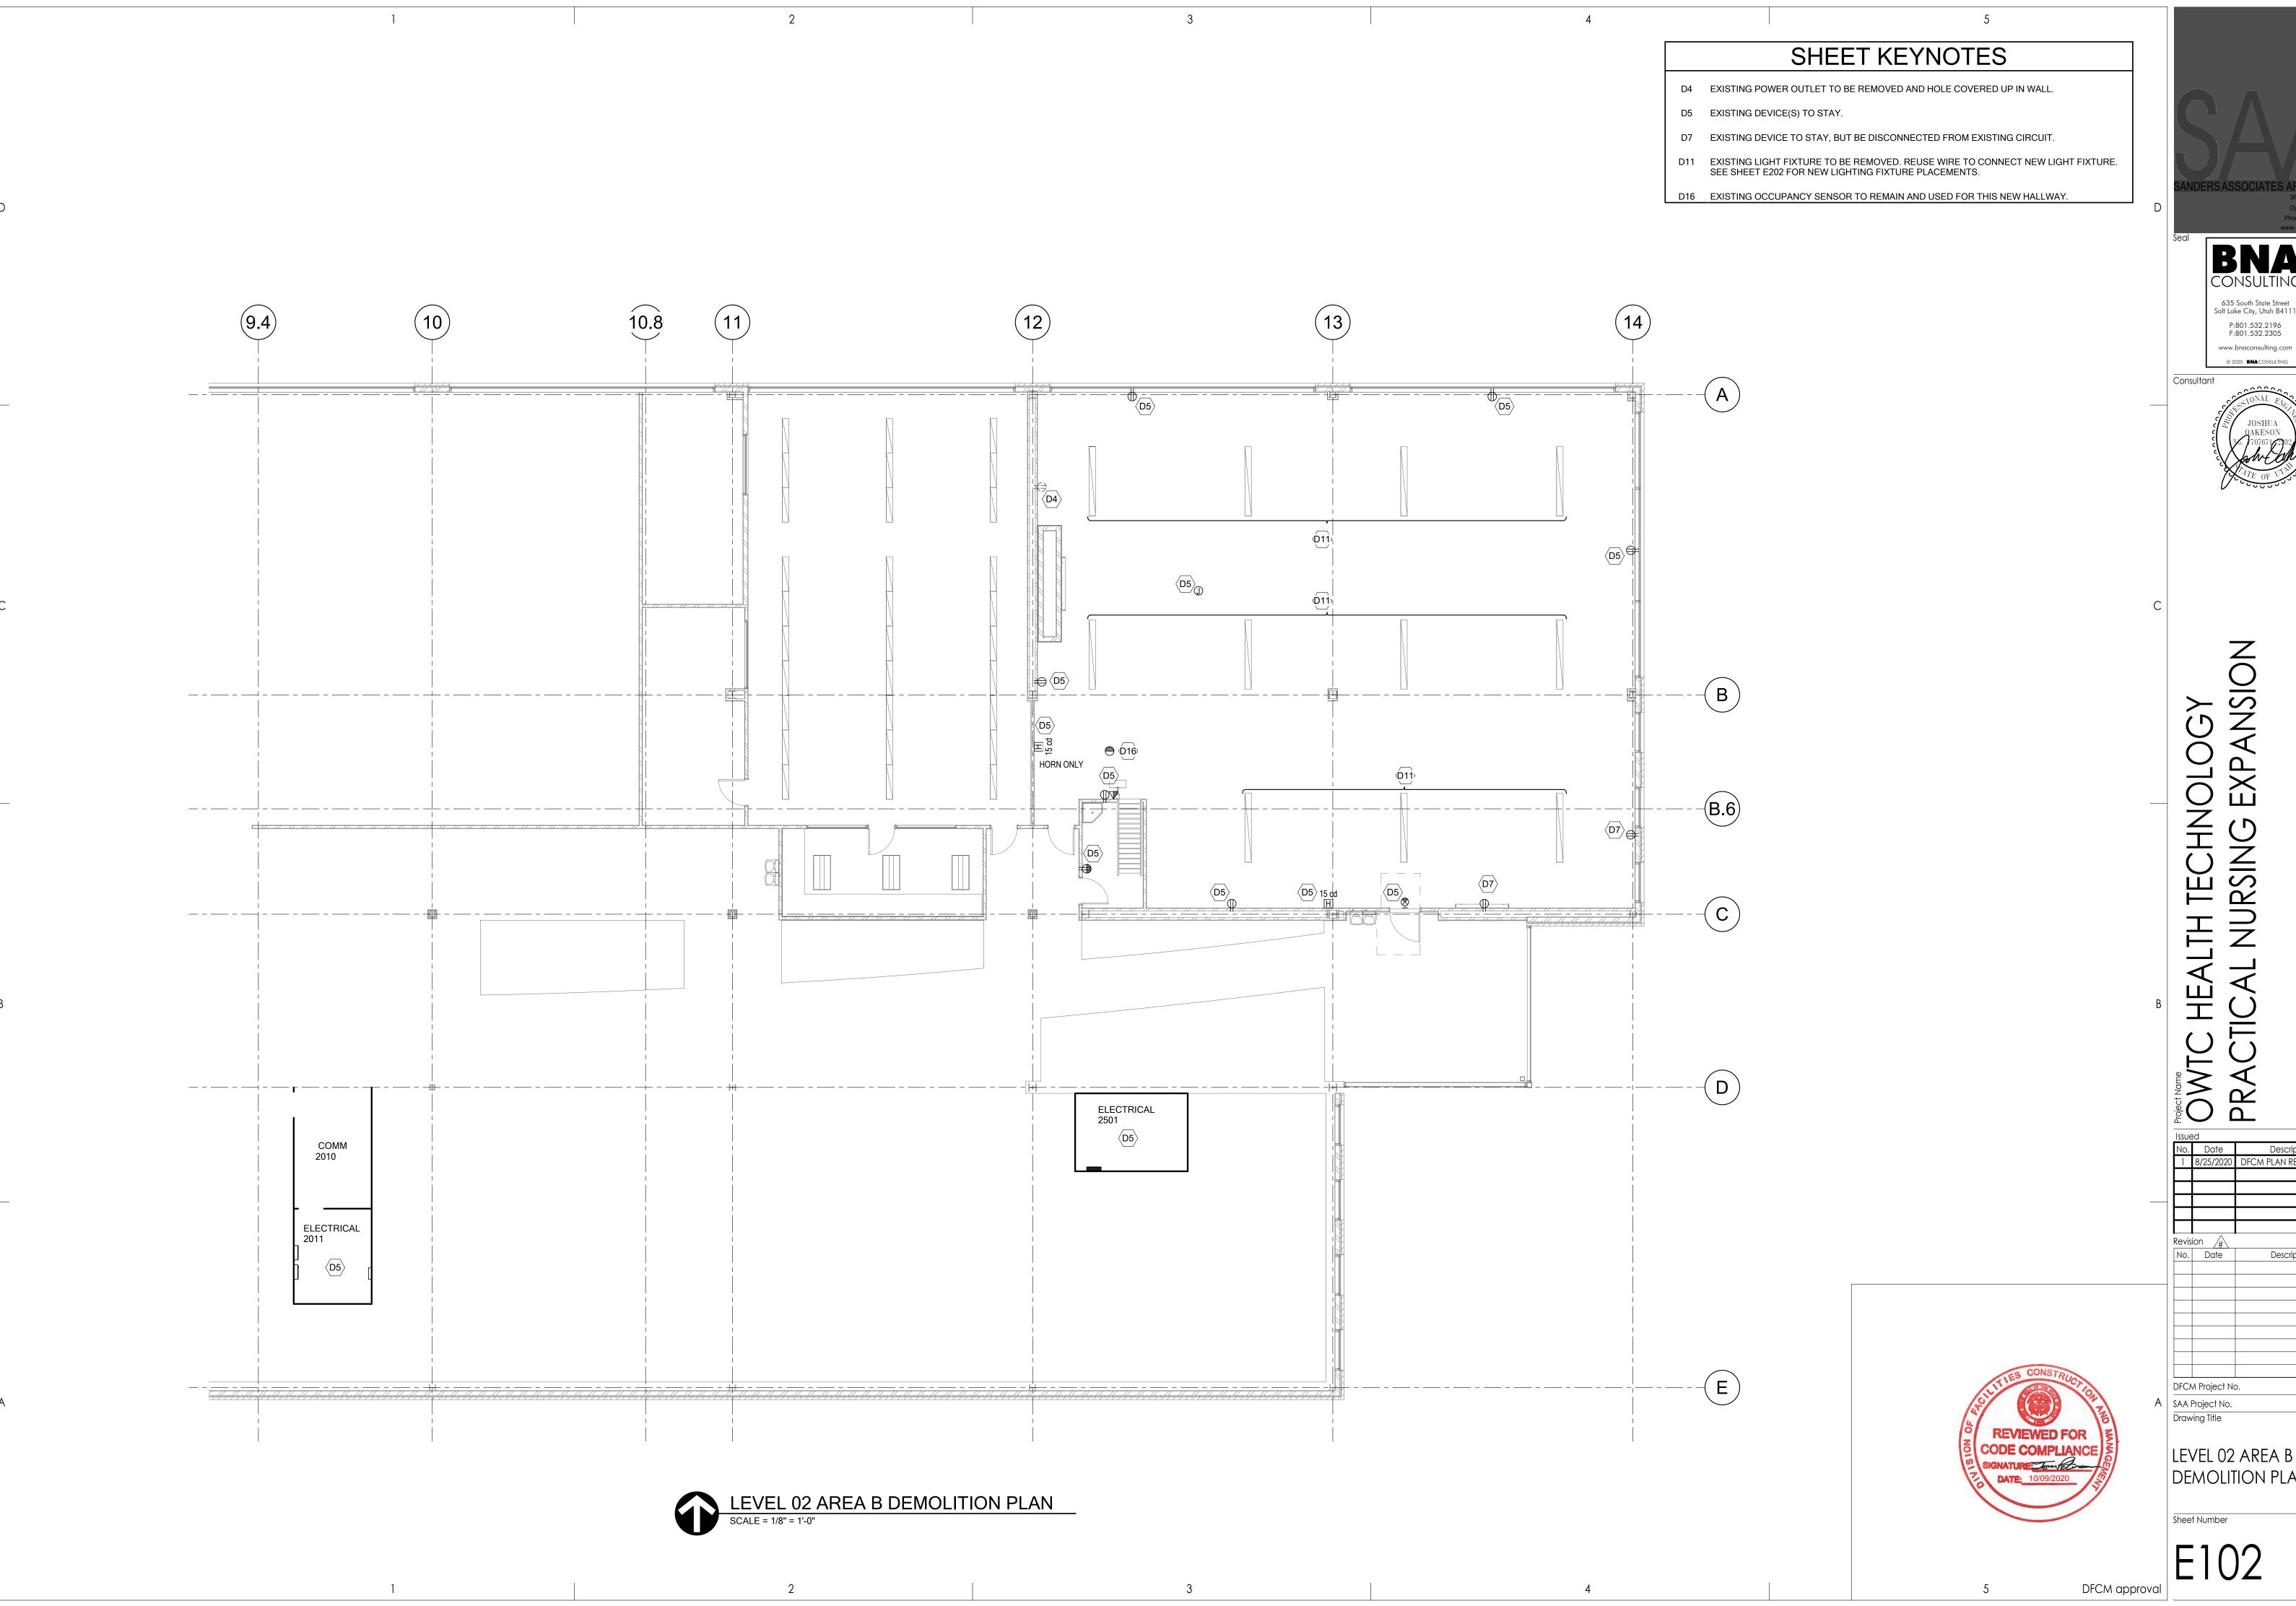
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> LEVEL 02 AREA A DEMOLITION PLAN

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0 DFCM PLAN REVIEW

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DEMOLITION PLAN

L4 EXISTING DEVICE(S) TO STAY. BB (CC) LEVEL 02 AREA A LIGHTING PLAN

SCALE = 1/8" = 1'-0"

SHEET KEYNOTES

- L1 EXISTING LIGHT FIXTURE TO BE MOVED UP INSIDE CONTROL STATION ROOM.
- L3 LIGHT FIXTURES TO BE CONNECTED TO EXISTING LIGHTS IN HALLWAY AND BE CONTROLLED BY THE SAME LIGHT SWITCH.

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LEVEL 02 AREA A LIGHTING PLAN

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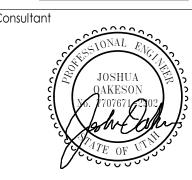
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SHEET KEYNOTES L2 EXISTING OCCUPANCY SENSOR TO REMAIN AND USED FOR THIS HALLWAY. L4 EXISTING DEVICE(S) TO STAY. G ) (IE) ELECTRICAL 2501 COMM 2010 ELECTRICAL 2011 L4 \_\_\_\_\_\_ A SAA Project No.

Drawing Title LEVEL 02 AREA B LIGHTING PLAN

SCALE = 1/8" = 1'-0" DFCM approval



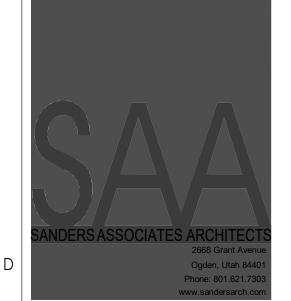


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LEVEL 02 AREA B LIGHTING PLAN

WALLSTATION 'S1' CONFIGURATION ENGRAVING PROGRAMMING FRONT ON/OFF FRONT BUTTON SHALL TURN ON FRONT ROW LIGHTING TO 100% ON/OFF FRONT RAISE FRONT BUTTON SHALL TO RAISE FRONT ROW LIGHTING LEVEL RAISE FRONT BUTTON TO LOWER FRONT ROW LIGHTING LEVEL FRONT LOWER LOWER BACK ON/OFF BUTTON SHALL TURN OFF ALL BACK ROWS LIGHTING BACK ON/OFF CONTROL SEQUENCE UPON ENTERING THE SPACE, OCCUPANCY SENSOR SHALL TURN ALL LIGHTING ON TO 100%. OCCUPANT THEN CAN SET LIGHT LEVELS. LIGHT REMAIN ON TILL END OF DAY TIME OFF. WALLSTATION 'S2' CONFIGURATION 635 South State Street Salt Lake City, Utah 84111 PROGRAMMING ENGRAVING P:801.532.2196 F:801.532.2305 ON BUTTON SHALL TURN ON ALL LIGHTING ON www.bnaconsulting.com OFF BUTTON SHALL TURN OFF ALL LIGHTING © 2020 BNA CONSULTING Consultant OFF CONTROL SEQUENCE UPON ENTERING THE SPACE, OCCUPANCY SENSOR SHALL TURN ALL LIGHTING ON TO 100%. OCCUPANT THEN CAN SET LIGHT LEVELS. LIGHT REMAIN ON TILL END OF DAY TIME OFF. OWTC HEALTH TECHNOLOGY
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E2 MOTOR FOR MOTORIZED SCREEN. REUSE EXISTING MOTORIZED SCREEN THAT WILL BE TAKEN OUT OF DEBRIEFING ROOM.

E5 POWER FOR TIME CLOCK.

E6 POWER FOR SCREEN CONTROL.

E7 POWER PANEL 'L1A4' IS IN LEVEL 01 AREA A ELECTRICAL ROOM #1008. PANEL TO STAY.

E8 TERMINATE POWER CABLE TO NEW RECEPTACLE. TERMINATE 4 DATA CABLES IN OUTLET. COIL WIRES BACK IN WALL AND PROVIDE COVER.

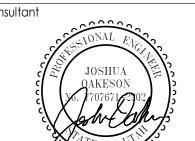
E9 EXISTING FIRE ALARM PANEL IS IN LEVEL 01 ELECTRICAL ROOM. PANEL TO STAY.

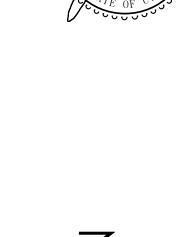
E10 EXISITNG DEVICE(S) TO STAY.

E11 EXISTING DEVICES RELOCATED FROM BEHIND LOCKERS TO THIS WALL.

E12 ALL NEW CABLE/CONDUIT TO RUN CONCEALED EITHER UNDER BRIDGE IN ENCLOSED CEILING OR ABOVE CEILING. PATCH/REPAIR ANY DAMAGE TO CEILINGS.







# ALTH TECHNOLOGY NL NURSING EXPANS

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LEVEL 02 AREA A

POWER PLAN

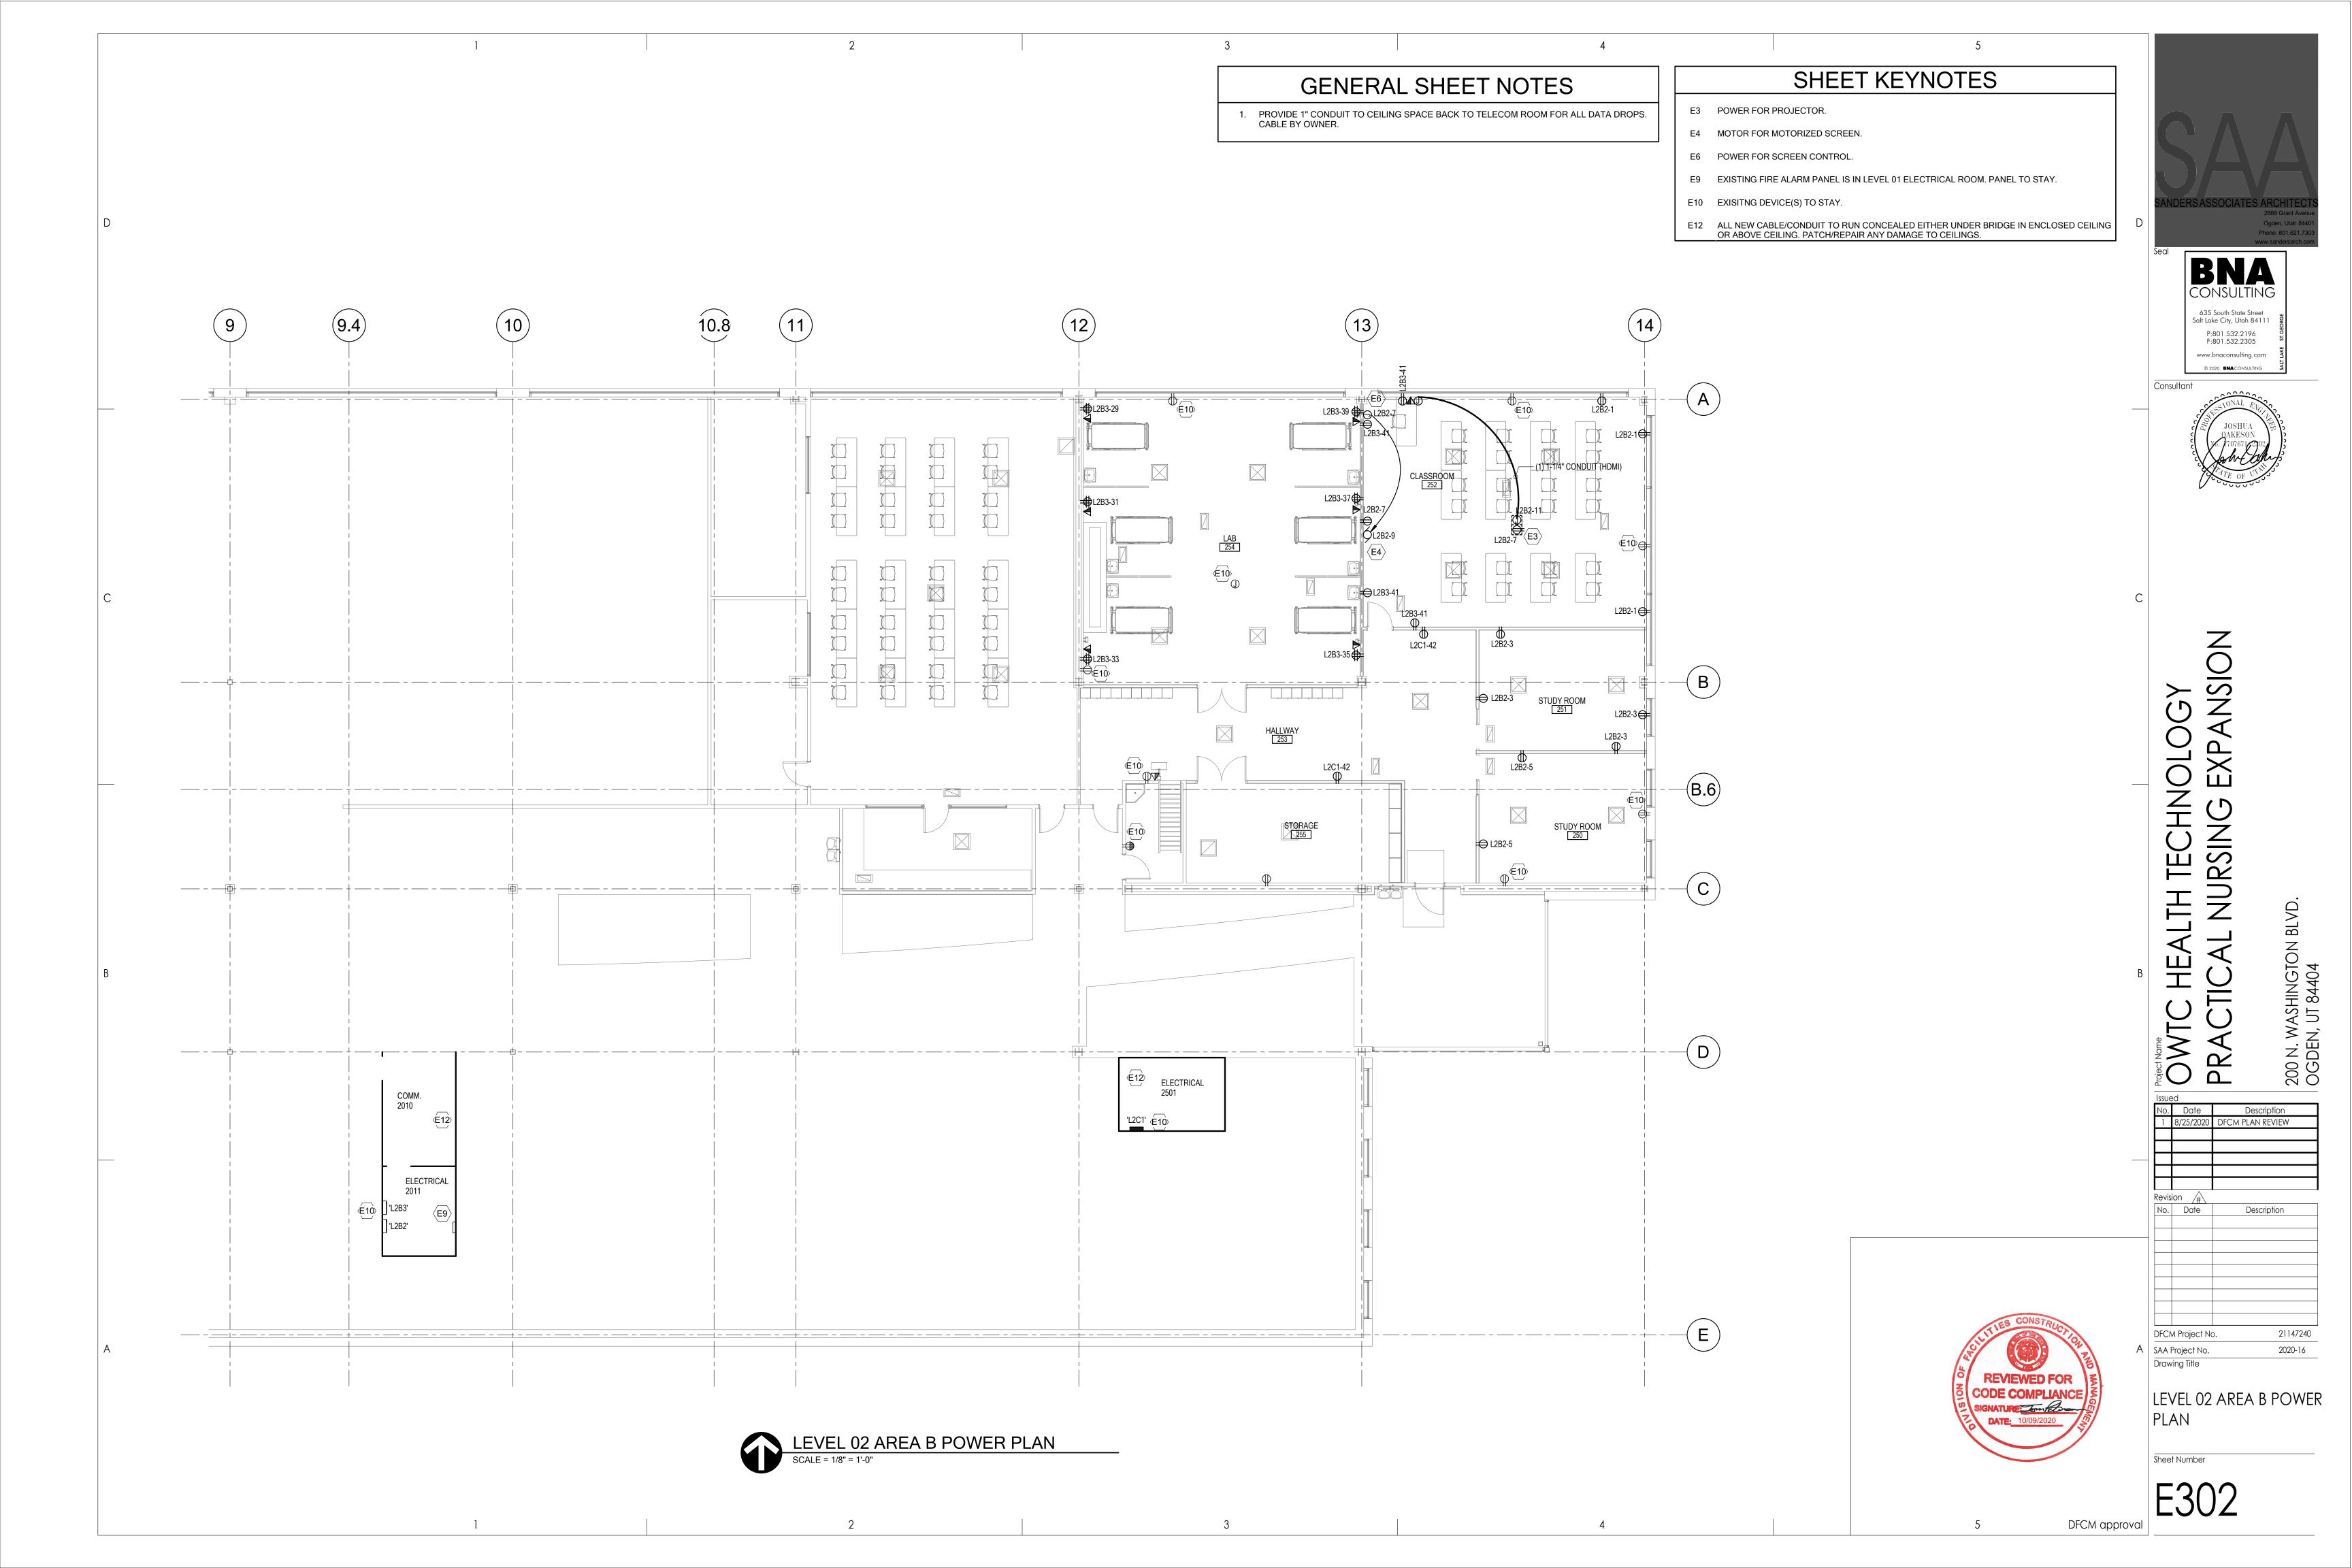
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GENERAL SHEET NOTES 1. PROVIDE 1" CONDUIT TO CEILING SPACE BACK TO TELECOM ROOM FOR ALL DATA DROPS. CABLE BY OWNER.

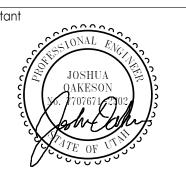
(BB) CLINICAL SIM. (CC) TELECOM. ROOM (DD)

LEVEL 02 AREA A POWER PLAN

SCALE = 1/8" = 1'-0"







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LEVEL 02 AREA A SYSTEMS PLAN

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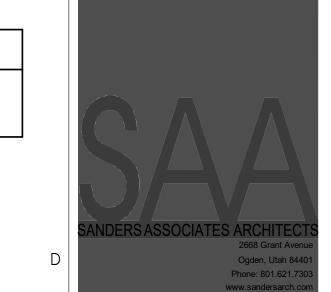
LEVEL 02 AREA A SYSTEMS PLAN

SCALE = 1/8" = 1'-0"

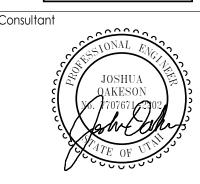
(CC)

(DD)





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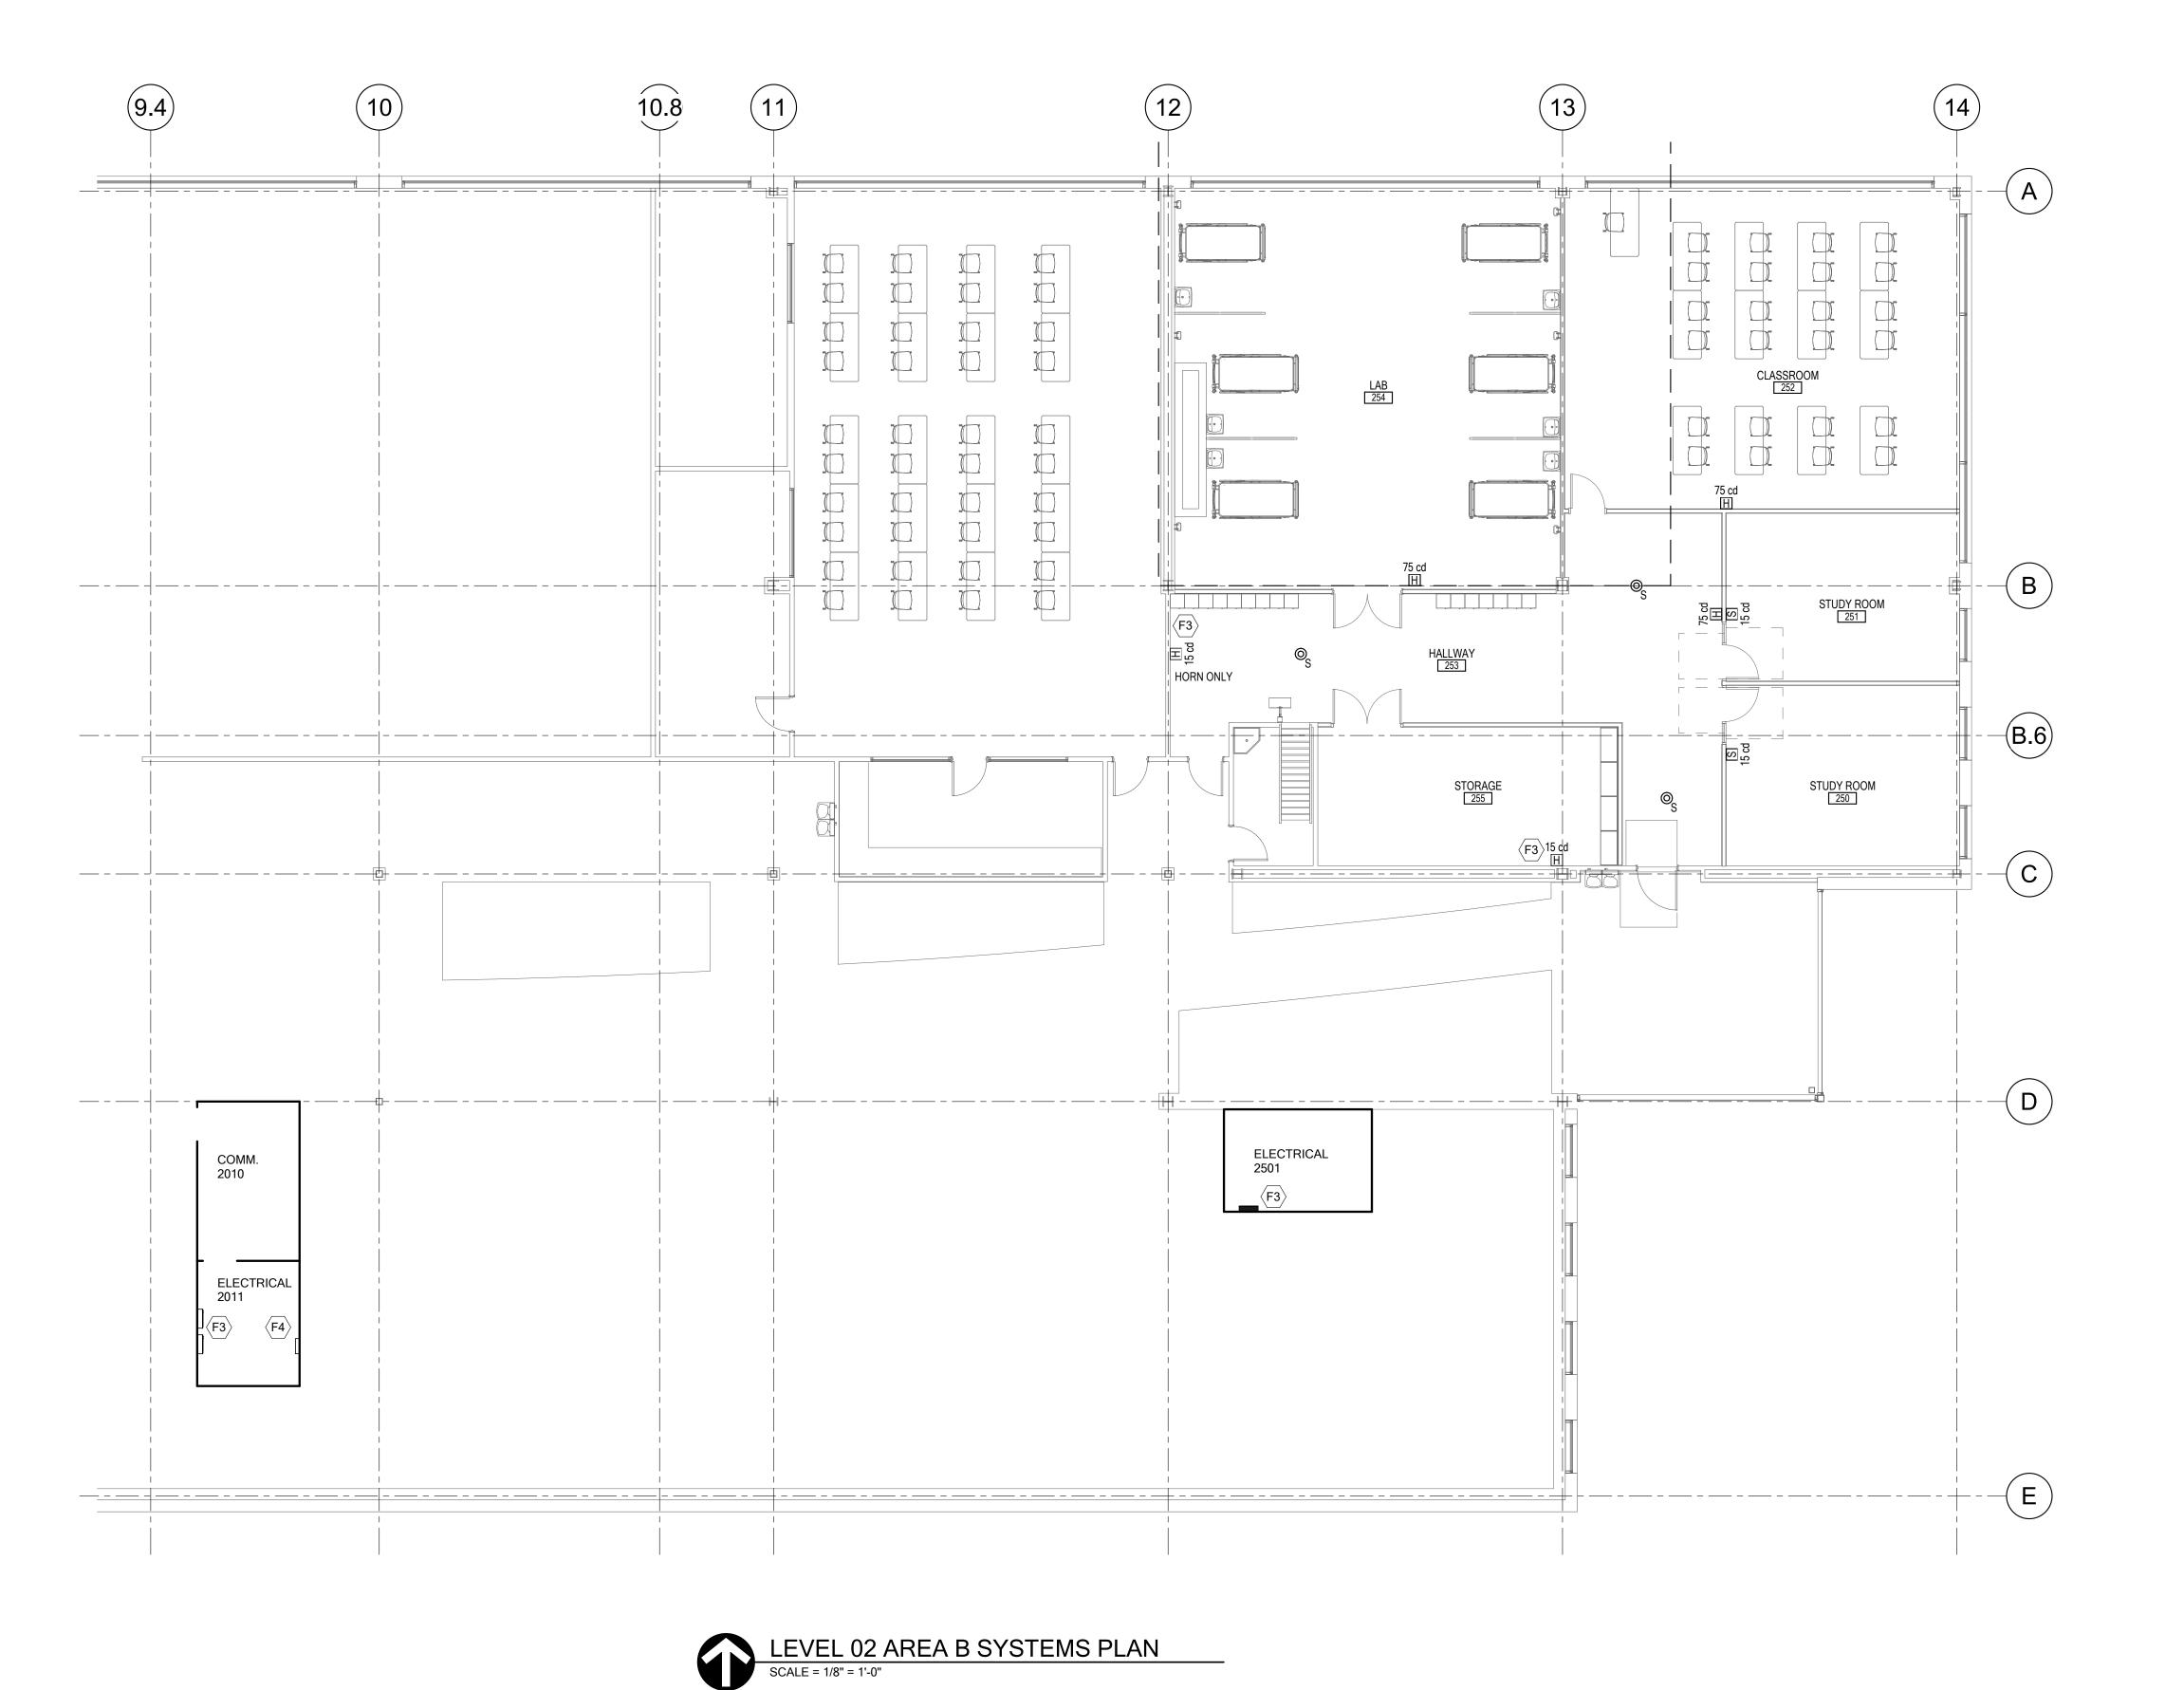
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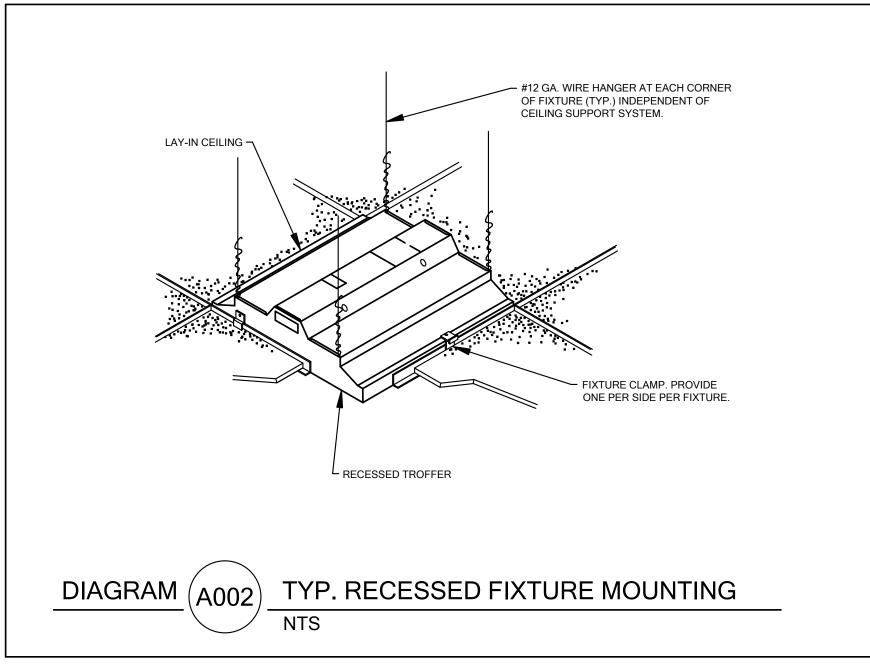
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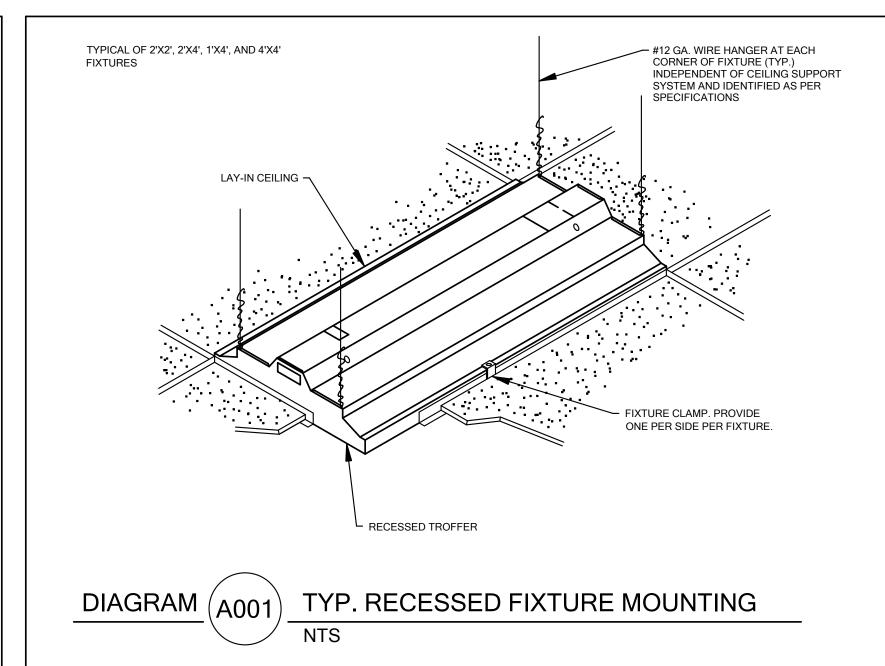
LEVEL 02 AREA B SYSTEMS PLAN

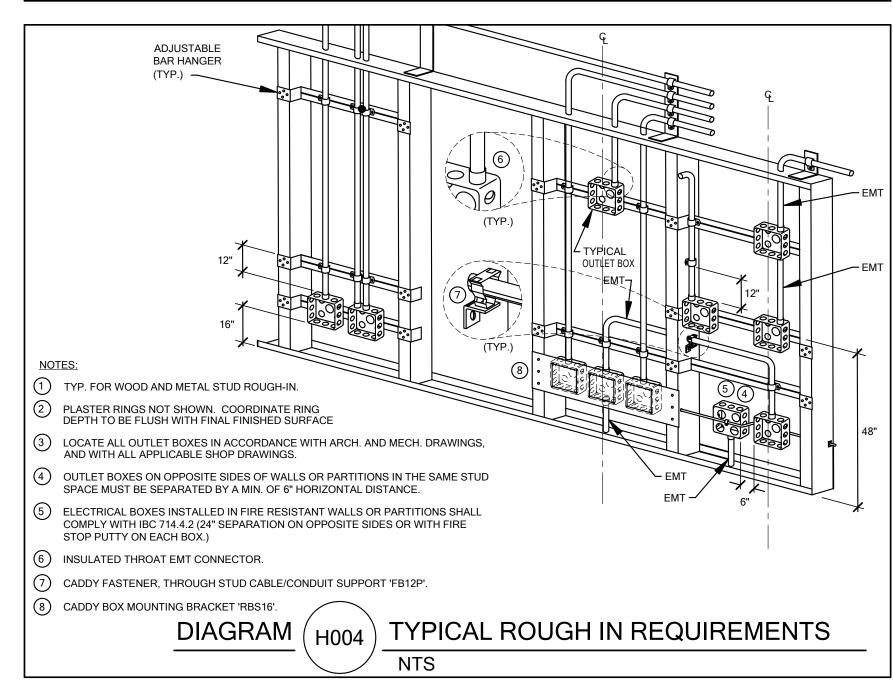
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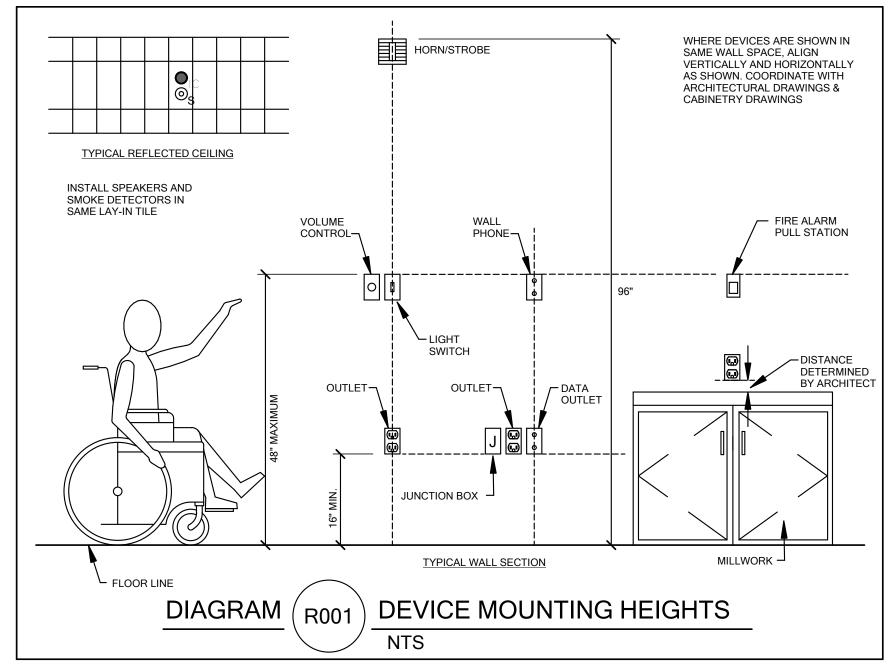
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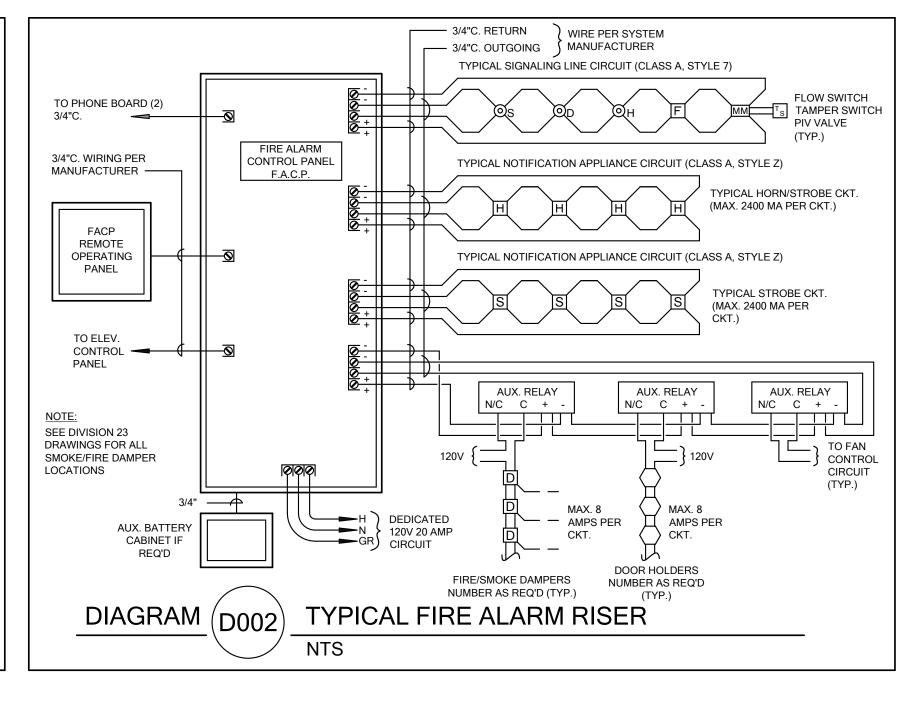






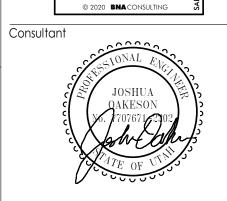








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