						PLU	MBING FIXTURE SCHEDULE
ID	FIXTURE	CW (IN)	HW (IN)	W (IN)	V (IN)	NOTES	SPECIFICATION
FD-1	FLOOR DRAIN			2	1 1/2	GENERAL USE FLOOR DRAIN	FLOOR DRAIN: SMITH FIGURE 2005Y-P050 FLOOR DRAIN WITH CAST IRON BODY AND FLASHING COLLAR WITH 6-INCH ROUND NICKEL BRONZ ADJUSTABLE STRAINER HEAD WITH SECURED GRATE. PROVIDE DEEP SEAL TRAP AND TRAP GUARD TYPE TRAP SEAL DEVICE.
L-1	LAVATORY	1/2	1/2	1 1/2	1 1/2	BASIN INTEGRAL TO COUNTERTOP, GOOSENECK FAUCET WITH WRISTBLADES	LAVATORY (BASIN INTEGRAL TO COUNTERTOP): CHICAGO786-GN8FCXKABCP FACUET, WITH WRIST BLADE HANDLES, GN8FC RIGID/SWING GOOSENECK SPOUT WITH 0.5 GPM LAMINAR FLOW CONTROL IN SPOUT INLET. FLEXIBLE STAINLESS STEEL SUPPLIES WITH WITH LOOSE KEY ANGLE STOPS.; FLEXIBLE STAINLESS STEEL SUPPLIES WITH LOOSE KEY ANGLE STOPS; CHICAGO 327-XCP OPEN-GRID STRAINER AND CAST BRASS P-TRAP WITH CLEAN OUT PLUG. PROVIDE ADA COMPLIANT UNDER COUNTER PIPING WRAP BY TRUE-BRO, COLOR TO BE WHIT
L-2	LAVATORY	1/2	1/2	1 1/2	1 1/2	WALL HUNG, GOOSENECK FAUCET WITH WRISTBLADES	LAVATORY: KOHLER K2030, GREENWICH, 20" X 18", VITREOUS CHINA, WITH FRONT OVERFLOW, 8" CENTERS. CHICAGO 786-GN8FCXKABCP FACUET, WITH WRIST BLADE HANDLES, GN8 RIGID/SWING GOOSENECK SPOUT WITH 0.5 GPM LAMINAR FLOW CONTROL IN SPOUT INLET. WATTS LFUSG-B-M2 THERMOSTATIC MIXING VALVE WITH SLOAN BASYS EFT-470-A CHECK VALVES ON HOT AND COLD LINES. FLEXIBLE STAINLESS STEEL SUPPLIES WITH WITH LOOSE KEY ANGLE STOPS. CHICAGO 327-XCP OPEN-GRID STRAINER AND CAST BRASS P-TRAP WITH CLEAN OUT PLUG. SMITH 0700-Z CONCEALED ARM CHAIR CARRIER WITH FOOT SUPPORT. PROVIDE ADA COMPLIANT UNDER COUNTE PIPING WRAP BY TRUE-BRO, COLOR TO BE WHITE.
S-1	SINK	1/2	1/2	2	1 1/2	BASIN INTEGRAL TO COUNTERTOP, GOOSENECK FAUCET WITH WRISTBLADES	SINK (BASIN INTEGRAL TO COUNTERTOP): CHICAGO 786-GN8FCXKABCP FACUET, WITH WRIST BLADE HANDLES, GN8FC RIGID/SWING GOOSENECK SPOUT WITH 1.5 GPM LAMINAR FLOW CONTROL IN SPOUT. FLEXIBLE STAINLESS STEEL SUPPLIES WITH WITH LOOSE KEY ANGLE STOPS. FLEXIBLE STAINLESS STEEL SUPPLIES WITH LOOSE KEY ANGLE STOPS; CHICAGO 327-XCP OPEN-GRID STRAINER AND CAST BRASS P-TRAP WITH CLEAN OUT PLUG. PROVIDE ADA COMPLIANT UNDER COUNTER PIPING WRAP BY TRUE-BRO, COLOR TO BE WHITE.
S-2	HAND WASH SINK	1/2	1/2	2	1 1/2	WALL HUNG, GOOSENECK FAUCET WITH WRISTBLADES	LAVATORY: KOHLER K2030, GREENWICH, 20" X 18", VITREOUS CHINA, WITH FRONT OVERFLOW, 8" CENTERS. CHICAGO 786-GN8FCXKABCP FACUET, WITH WRIST BLADE HANDLES, GN8 RIGID/SWING GOOSENECK SPOUT WITH 0.5 GPM LAMINAR FLOW CONTROL IN SPOUT INLET. WATTS LFUSG-B-M2 THERMOSTATIC MIXING VALVE WITH SLOAN BASYS EFT-470-A CHECK VALVES ON HOT AND COLD LINES. FLEXIBLE STAINLESS STEEL SUPPLIES WITH WITH LOOSE KEY ANGLE STOPS. CHICAGO 327-XCP OPEN-GRID STRAINER AND CAST BRASS P-TRAP WITH CLEAN OUT PLUG. SMITH 0700-Z CONCEALED ARM CHAIR CARRIER WITH FOOT SUPPORT. PROVIDE ADA COMPLIANT UNDER COUNTEI PIPING WRAP BY TRUE-BRO, COLOR TO BE WHITE.
S-3	NURSE STATION SINK	1/2	1/2	2	1 1/2	COUNTER MOUNTED, STAINLESS STEEL, GOOSENECK FAUCET WITH WRISTBLADES	SINK: ELKAY LRAD 1918 19" X 18" O.D. X 6-1/2" DEEP BOWL, COUNTER MOUNT SINGLE COMPARTMENT 18 GA. STAINLESS STEEL SINK, 8" CENTERS DRILLING, PROVIDE SINK WITH CENTER-REAR DRAIN LOCATION. PROVIDE CHICAGO 786-GN8FCABCP FAUCET, NO. 317 4" WRIST BLADES, GN8 RIGID/SWING CONVERTIBLE GOOSE NECK WITH 1.5 GPM FC LAMINAR FLOW CONTROL IN SPOUT AND PLAIN END SPOUT RING PROVIDE FLEXIBLE STAINLESS STEEL SUPPLIES WITH LOOSE KEY ANGLE STOPS; JUST J-35 STAINLESS STEEL CUP STRAINER AND CAST BRASS P-TRAP WITH CLEAN-OUT PLUG.
S-4	BREAK RM SINK	1/2	1/2	2	1 1/2	COUNTER MOUNTED, STAINLESS STEEL, SINGLE COMPARTMENT,	SINK (STAINLESS STEEL, COUNTER MOUNTED, SINGLE COMPARTMENT): JUST SLADA1921A553-J. TYPE 304 STAINLESS STEEL SINK, 14" X 18 X 5-1/2" DEEP BASIN, SELF RIMMING, 8" CENTERS DRILLING WITH J-35 CUP STRAINER. SYMMONS S-23-BH-1.5 KITCHEN FAUCET WITH 1.5 GPI AERATOR. FLEXIBLE STAINLESS STEEL SUPPLIES WITH LOOSE KEY ANGLE STOPS, CAST BRASS P-TRAP WITH CLEAN-OUT PLUG.
S-5	CUP SINK	1/2	1/2	1 1/2	1 1/2	SPECIMEN DISPOSAL SINK	SINK: ELKAY CUPR6 6.5" DIA. I.D. TYPE 316 16 GA.STAINLESS STEEL, ROUND, COUNTER MOUNT SINGLE BOWL WITH STEEL NIPPLE WITH CROSS BAR DRAIN . CHICAGO 929-LESH SINGLE HOLE HOT AND COLD WATER FAUCET WITH GN2FCJKABCP 5" PLAIN END GOOSENECK SPOUT WITH 1.5 GPM FLOW CONTROL IN BASE OF THE SPOUT AND 317 4" WRIST BLADE HANDLES. FLEXIBLE STAINLESS STEEL SUPPLIES WITH LOOSE KEY ANGLE STOPS AND CAST BRASS P-TRAP WITH CLEAN-OUT PLUG.
S-6	CONFERENCE ROOM SINK	1/2	1/2	2	1 1/2	INTEGRAL SINK, GOOSENECK FAUCET WITH WRISTBLADES	SINK (BASIN INTEGRAL TO COUNTER TOP): PROVIDE CHICAGO 786-GN8FCABCP FAUCET, NO. 317 4" WRIST BLADES, GN8 RIGID/SWING CONVERTIBLE GOOSE NECK WITH 1.5 GPM FC LAMINAR FLOW CONTROL IN SPOUT AND PLAIN END SPOUT RING. PROVIDE FLEXIBLE STAINLESS STEEL SUPPLIES WITH LOOSE KEY ANGLE STOPS; JUST J-35 STAINLESS STEEL CUP STRAINER AND CAST BRASS P-TRAP WITH CLEAN-OUT PLUG.
SH-1	SHOWER	1/2	1/2	2	2	ADA, FIXED AND HAND HELD SHOWER HEADS	SHOWER (ADA COMPLIANT): SYMMONS 1-1170VT-T600B-36-V-X-1.5 VISU-TEMP EXTRA HEAVY DUTY SHOWER SYSTEM WITH PRESSURE BALANCING MIXING VALVE, CLEAR-VUE THERMOMETER, LEVER HANDLE, ADJUSTBABLE STOP SCREW, INTEGRAL SERVICE STOPS, 1.5 GPM SHOWER HEAD WITH ARM AND FLANGE, LEVER DIVERTER WITH INTEGRAL VOLUME CONTROL, 1.5 GPM WALL/HAND SHOWER WITH 6' FLEXIBLE METAL HOSE, INLINE BREAKER, WALL CONNECTION AND FLANGE AND SYMMONS 36" T600B ADA GRAB AND SLIDE BAR FOR HAND SHOWER MOUNTING.
TD-1	TRENCH DRAIN			2	2	PATIENT TOILET ROOM TRENCH DRAIN	TRENCH DRAIN: ZURN MODEL #ZS880-60-ZS-WG TYPE 304 FABRICATED STAINLESS STEEL LINEAR SHOWER DRAIN. COMPLETE WITH VERTICALLY ADJUSTABLE ANCHORING SUPPORT LEGS, ANTI-PONDING V-SHAPED CHANNEL WITH 2 IN. NO-HUB CENTER OUTLET, ADJUSTABLE SECURED LEVELING FRAME WITH BUILT-IN TILE EDGE, AND SECURED, LIGHT DUTY, SLOTTED HEEL-PROOF GRATE, DRAIN IS DESIGNED FOR INSTALLATION IN A MINIMUM 2" CONDRETE PAD AND CAN BE ADJUSTED TO ACCOMMODATE 1/4 AND 3/8 FINISHED TILE THICKNESS.
WB-1	WATER BOX	3/4	3/4	2	1 1/2		WATER OUTLET BOX: WATER-TITE 82112 WASHING MACHINE OUTLET BOX WITH DRAIN, QUARTER TURN BALL VALVE FOR USE WITH ICE MACHINE. INSTALL ONLY COLD WATER BALL VALVE. NOTCH COUNTERTOP BACK-SPLASH AND INSTALL OUTLET BOX DRAIN FLUSH WITH COUNTERTOP. PROVIDE WITH PVC TRAP. WATER LINE CONNECTION TO THE ICEBOX TO BE COPPER PIPING. BOX DIMENSIONS: 7-7/8" X 5-5/ I.D.; FRAME SIZE: 10-7/8 X 8-3/8"
WC-1	WATER CLOSET	1		4	2	FLOOR MOUNTED, MANUAL FLUSH VALVE, ADA, BED PAN WASHER	WATER CLOSET: KOHLER K-4368-L HIGHCLIFF VITREOUS CHINA, FLOOR MOUNTED, ELONGATED BOWL WITH BEDPAN LUGS, 1-1/2" TOP SPU ADA TOILET WITH K-4670-C LUSTRA OPEN-FRONT SEAT. SLOAN MODEL BPW-1150-1.6 LOW CONSUMPTION FLUSH VALVE WITH PULL DOWN BED PAN WASHER AND WES-212 DUAL FLUSH HANDLE KIT, 1-1/2" OFF SET TUBE; INSTALL ACTUATOR ON WIDE SIDE OF FIXTURE.

1. ALL UNDER GROUND WASTE AND VENT SHALL BE 2" OR GREATER PER DRAWINGS.

SYMBOL	ROOM TYPE
MO-1	O2,MV OUTLET
MO-5	O2, MA, MV
MO-6	INFANT RESUS/LDRP
MO-8	O2
MO-20	OR EQUIP BOOM
MO-21	OR ANEST BOOM
UNLESS	NOTED OTHERWISE, AI
OUTLETS	S IN "MEDICAL EQUIPME
1. PIPE	DROP SIZES ARE FOR C
2. WALL	MOUNTED OUTLETS

MEDICAL GAS OUTLETS SCHEDULE

			#	OF OUTLE	TS					PIPE DRO	P SIZE TO (DUTLET(S)			
OM TYPE	OX	MA	MV	N	N20	CO2	WAGD	OX	MA	MV	N	N20	CO2	WAGD	REMARKS
IV OUTLET	1		1					1/2"		3/4"					1,2
, MA, MV	1	1	1					1/2"	1/2"	3/4"					1,2
RESUS/LDRP	3	3	3					1/2"	1/2"	1"					1,2
O2	1							1/2"							1,2
QUIP BOOM		1	2	1		1			1/2"	1"	1/2"		1/2"		1,3
NEST BOOM	3	2	2		1		1	1/2"	1/2"	1"		1/2"		3/4"	1,3
THERWISE, AL	L OUTLETS	ARE CHEM	ETRON-STY	LE QUICK-	CONNECTS	- SEE ARCH	HITECTURAL	DRAWINGS	FOR EXAC	T LOCATION	IS AND ELE	VATIONS			


DICAL EQUIPMENT" ARE SUPPLIED WITH THE PIECE OF EQUIPMENT

IZES ARE FOR ONE SET OF OUTLETS

3. OUTLETS IN OWNER-PROVIDED, CEILING-MOUNTED BOOM.

MEDICAL GAS VALVE SCHEDULE										
	-		PIPE SIZE							
SYMBOL	AREA SERVED	OX	MA	M∨	N	IA	N20	CO2	WAGD	REMARKS
MV-12	BLOOD DRAW	1/2"	-	-	-	-	-	-	-	1



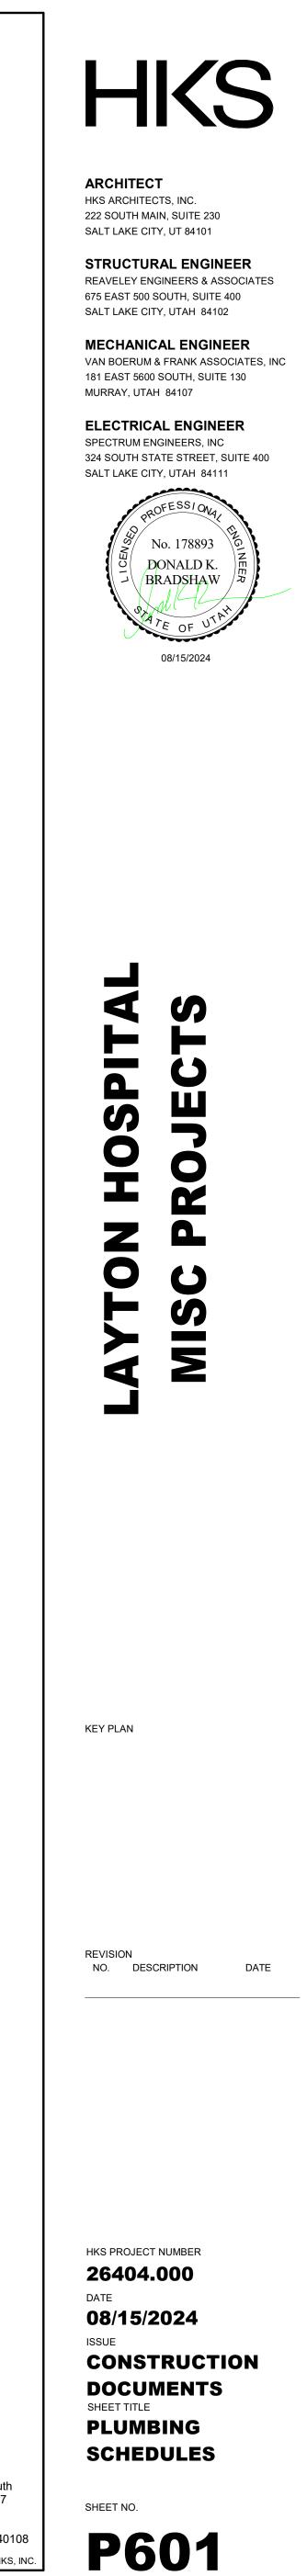



SYMBOL	SYMBOLS LEGEND DESCRIPTION
REFERENC	E AND LINE SYMBOLS
(A5 E-501	DETAIL INDICATOR: A5 INDICATES DETAIL NUMBER, E-501 INDICATES DRAWING SHEET WHERE DETAIL IS SHOWN.
A5 E-201	ELEVATION OR SECTION INDICATOR, EXTERIOR: A5 INDICATES ELEVATION OR SECTION NUMBER, E-201 INDICATES DRAWING SHEET WHERE ELEVATION OR SECTION IS SHOWN.
$\overline{}$	
A5 E-201 ROOM NAME	ELEVATION OR SECTION INDICATOR, INTERIOR: A5 INDICATES ELEVATION OR SECTION NUMBER, E-201 INDICATES DRAWING SHEET WHERE ELEVATION OR SECTION IS SHOWN.
	ROOM IDENTIFIER WITH ROOM NAME AND NUMBER. KEYNOTE INDICATOR.
	REVISION INDICATOR.
CU-1 >	EQUIPMENT INDICATOR.
X-X XMDP	MECHANICAL EQUIPMENT INDICATOR. "X-X" INDICATES EQUIPMENT MARK SHOWN ON EQUIPMENT SCHEDULE. "XMDP" IDENTIFIES PANEL EQUIPMENT IS CIRCUITED TO. REFER TO EQUIPMENT SCHEDULE FOR ADDITIONAL INFORMATION.
	BREAK, STRAIGHT: TO BREAK PARTS OF DRAWING
\sim	BREAK, ROUND
MATCH LINE SEE XX/X-XXX	MATCH LINE INDICATOR: CENTER, EXTRA WIDE LINE.
	NEW LINE: MEDIUM LINE.
	HIDDEN FEATURES LINE: HIDDEN, THIN LINE
	EXISTING TO REMAIN LINE: THIN LINE.
	DEMOLITION LINE: DASHED, MEDIUM LINE
	PROPERTY LINE: DASHED, WIDE LINE.
	CONTRACT LIMIT LINE: DASHDOT, WIDE LINE.
XXX EF-X	ELECTRICAL EQUIPMENT INDICATOR. "XXX" INDICATES TYPE OF EQUIPMENT OR EQUIPMENT ID. "EF-X" IDENTIFIES MECHANICAL EQUIPMENT BEING SERVED. REFER TO EQUIPMENT SCHEDULE FOR ADDITIONAL INFORMATION.
<u>X-X</u> 1LA-3	EQUIPMENT INDICATOR. "X-X" INDICATES EQUIPMENT MARK SHOWN ON EQUIPMENT SCHEDULE. "1LA-3" IDENTIFIES PANEL EQUIPMENT IS CIRCUITED TO. REFER TO EQUIPMENT SCHEDULE FOR ADDITIONAL INFORMATION.
XXXET #	IN-GRADE PULLBOX INDICATOR. "XXXET" INDICATES LABEL SHOWN ON SCHEDULE. "#" IDENTIFIES SEQUENCE NUMBER SHOWN ON SITE AND RISER DIAGRAM. REFER TO PLANS AND EXTERIOR PULLBOX SCHEDULE FOR ADDITIONAL INFORMATION.
	WIRING.
~ ``	WIRING TURNED UP OR TOWARDS OBSERVER.
\frown	WIRING TURNED DOWN OR AWAY FROM OBSERVER.
A-1	SINGLE BRANCH CIRCUIT HOME RUN TO PANELBOARD WITH DEDICATED NEUTRAL CONDUCTOR. LETTER AND NUMBER NOTATION IDENTIFY PANEL AND CIRCUIT NUMBER.
A-1,3,5	BRANCH CIRCUIT HOME RUN TO PANELBOARD: NUMBER OF ARROWS INDICATES NUMBER OF CIRCUITS. LETTER AND NUMBER NOTATIONS IDENTIFY PANEL AND CIRCUIT NUMBERS.
1 A-1,3,5	BRANCH CIRCUIT HOME RUN TO PANELBOARD: NUMBER OF ARROWS INDICATES NUMBER OF CIRCUITS. LETTER AND NUMBER NOTATIONS IDENTIFY PANEL AND CIRCUIT NUMBERS. NUMBER IN BOX REFERS TO THE CONDUCTOR AND CONDUIT SCHEDULE.
	LOW VOLTAGE WIRING: DIVIDE, MEDIUM LINE.
	CONDUIT STUB. DIMENSION RECORD DRAWINGS AND MARK.
۲ 	
	CONDUCTOR & CONDUIT ("CC") SCHEDULE INDICATOR. REFER
	TO ONE-LINE DIAGRAM.
1 HC	
	TO ONE-LINE DIAGRAM.
НС	TO ONE-LINE DIAGRAM. ADA ACCESS PUSH PLATE
HC Ø	TO ONE-LINE DIAGRAM. ADA ACCESS PUSH PLATE JUNCTION BOX.
HC D C D C D SC	TO ONE-LINE DIAGRAM. ADA ACCESS PUSH PLATE JUNCTION BOX. JUNCTION BOX, CEILING. JUNCTION BOX, SYSTEMS FURNITURE COMMUNICATION
HC Q Q C Q _{SC} Q _{SP}	TO ONE-LINE DIAGRAM. ADA ACCESS PUSH PLATE JUNCTION BOX. JUNCTION BOX, CEILING. JUNCTION BOX, SYSTEMS FURNITURE COMMUNICATION CONNECTION. JUNCTION BOX, SYSTEMS FURNITURE POWER CONNECTION.
НС Ф С Ф С Ф SP РВ А"хВ"	TO ONE-LINE DIAGRAM. ADA ACCESS PUSH PLATE JUNCTION BOX. JUNCTION BOX, CEILING. JUNCTION BOX, SYSTEMS FURNITURE COMMUNICATION CONNECTION. JUNCTION BOX, SYSTEMS FURNITURE POWER CONNECTION. PULL BOX. CABLE TRAY ABOVE ACCESSIBLE CEILING. "A" DENOTES CABLE TRAY WIDTH, "B" DENOTES CABLETRAY DEPTH. +/-C'-D" DENOTES CABLE TRAY ELEVATION ABOVE OR
HC O C O C O SP PB	TO ONE-LINE DIAGRAM. ADA ACCESS PUSH PLATE JUNCTION BOX. JUNCTION BOX, CEILING. JUNCTION BOX, SYSTEMS FURNITURE COMMUNICATION CONNECTION. JUNCTION BOX, SYSTEMS FURNITURE POWER CONNECTION. PULL BOX. CABLE TRAY ABOVE ACCESSIBLE CEILING. "A" DENOTES CABLE TRAY WIDTH, "B" DENOTES CABLETRAY DEPTH. +/-C'-D" DENOTES CABLE TRAY ELEVATION ABOVE OR BELOW FINISHED SURFACE.
НС Ф С Ф С Ф SP РВ А"хВ"	TO ONE-LINE DIAGRAM. ADA ACCESS PUSH PLATE JUNCTION BOX. JUNCTION BOX, CEILING. JUNCTION BOX, SYSTEMS FURNITURE COMMUNICATION CONNECTION. JUNCTION BOX, SYSTEMS FURNITURE POWER CONNECTION. PULL BOX. CABLE TRAY ABOVE ACCESSIBLE CEILING. "A" DENOTES CABLE TRAY WIDTH, "B" DENOTES CABLETRAY DEPTH. +/-C'-D" DENOTES CABLE TRAY ELEVATION ABOVE OR BELOW FINISHED SURFACE. LADDER RACK.
НС Ф С Ф С Ф SP РВ А"хВ"	TO ONE-LINE DIAGRAM. ADA ACCESS PUSH PLATE JUNCTION BOX. JUNCTION BOX, CEILING. JUNCTION BOX, SYSTEMS FURNITURE COMMUNICATION CONNECTION. JUNCTION BOX, SYSTEMS FURNITURE POWER CONNECTION. PULL BOX. CABLE TRAY ABOVE ACCESSIBLE CEILING. "A" DENOTES CABLE TRAY WIDTH, "B" DENOTES CABLETRAY DEPTH. +/-C'-D" DENOTES CABLE TRAY ELEVATION ABOVE OR BELOW FINISHED SURFACE. LADDER RACK. CABLE J-HOOKS ABOVE ACCESSIBLE CEILING.
HC ① ① ① ① ① ① ① C ① ③ ② SP PB PB A"xB" +/-C'-D" 1 	TO ONE-LINE DIAGRAM. ADA ACCESS PUSH PLATE JUNCTION BOX. JUNCTION BOX, CEILING. JUNCTION BOX, SYSTEMS FURNITURE COMMUNICATION CONNECTION. JUNCTION BOX, SYSTEMS FURNITURE POWER CONNECTION. PULL BOX. CABLE TRAY ABOVE ACCESSIBLE CEILING. "A" DENOTES CABLE TRAY WIDTH, "B" DENOTES CABLETRAY DEPTH. +/-C'-D" DENOTES CABLE TRAY ELEVATION ABOVE OR BELOW FINISHED SURFACE. LADDER RACK. CABLE J-HOOKS ABOVE ACCESSIBLE CEILING. MECHANICAL EQUIPMENT CONNECTION. REFER TO EQUIPMENT SCHEDULE FOR REQUIREMENTS.
HC ① ① ① ① ① ① ① C ① ③ ② SP PB PB A"xB" +/-C'-D" 1 	TO ONE-LINE DIAGRAM. ADA ACCESS PUSH PLATE JUNCTION BOX. JUNCTION BOX, CEILING. JUNCTION BOX, SYSTEMS FURNITURE COMMUNICATION CONNECTION. JUNCTION BOX, SYSTEMS FURNITURE POWER CONNECTION. PULL BOX. CABLE TRAY ABOVE ACCESSIBLE CEILING. "A" DENOTES CABLE TRAY WIDTH, "B" DENOTES CABLETRAY DEPTH. +/-C'-D" DENOTES CABLE TRAY ELEVATION ABOVE OR BELOW FINISHED SURFACE. LADDER RACK. CABLE J-HOOKS ABOVE ACCESSIBLE CEILING. MECHANICAL EQUIPMENT CONNECTION. REFER TO EQUIPMENT

SYMBOL	DESCRIPTION	SYMBOL	DESCRIPTION
IRING DE	EVICES	SITE ELEC	TRICAL AND COMMUNICATIONS UTILITIES
φ	RECEPTACLE, SINGLE: NEMA 5-20R.	—3ØUP—	ELECTRIC LINE: THIN LINE. $1\emptyset$ = SINGLE PHASE, $2\emptyset$ = 2-PHASE, $3\emptyset$ = 3-PHASE, 0 = OVERHEAD,
₿	RECEPTACLE, DUPLEX: NEMA 5-20R.	U	U = UNDERGROUND, P = PRIMARY, S = SECONDARY
₲ѧ	RECEPTACLE, DUPLEX, ABOVE COUNTER: NEMA 5-20R.	• •	LIGHTNING ARRESTOR.
фс	RECEPTACLE, DUPLEX, CEILING: NEMA 5-20R.	-0-	UTILITY POLE.
₫╻	RECEPTACLE, DUPLEX, DEDICATED CIRCUIT: NEMA 5-20R.		UTILITY, DISTRIBUTION SWITCH OR SWITCHING STATION.
	INTERRUPTER, DRINKING FOUNTAIN: CONCEAL WATER COOLER RECEPTACLE BEHIND WATER COOLER. SEE	E	UTILITY, PRIMARY ELECTRICAL HAND HOLE.
	MECHANICAL/PLUMBING SHOP DRAWINGS FOR INSTALLATION REQUIREMENTS.	M	UTILITY SERVICES, MANHOLE.
	RECEPTACLE, DUPLEX, ISOLATED GROUND: NEMA 5-20R.	(c)	UTILITY, COMMUNICATIONS MANHOLE.
₿s	RECEPTACLE, DUPLEX, SWITCHED: NEMA 5-20R.	(E)	UTILITY, ELECTRICAL MANHOLE.
₩	RECEPTACLE, DUPLEX WITH GROUND FAULT CIRCUIT INTERRUPTER, WET LABEL, "WEATHERPROOF IN USE": NEMA 5-20R.		UTILITY, TELEPHONE MANHOLE.
U	RECEPTACLE, DUPLEX, HOSPITAL GRADE: NEMA 5-20R.		
	RECEPTACLE, DUPLEX ON EMERGENCY POWER: NEMA 5-20R.	E	PRECAST CONCRETE, ELECTRICAL VAULT. PRECAST CONCRETE, TELEPHONE VAULT.
 	RECEPTACLE, DUPLEX, HOSPITAL GRADE ON EMERGENCY	ТМ	PRECAST CONCRETE, MANHOLE, TRANSFORMER VAULT.
	POWER: NEMA 5-20R. RECEPTACLE, DUPLEX, CONNECTED TO UPS: NEMA 5-20R.	ТР	PRECAST CONCRETE, TRANSFORMER PAD.
	RECEPTACLE, DUPLEX WITH GROUND FAULT CIRCUIT INTERRUPTER: NEMA 5-20R.		IN-GRADE PULLBOX, HAND HOLE. OPTIONS WITH SQUARE OR
	RECEPTACLE, DUPLEX WITH GROUND FAULT CIRCUIT INTERRUPTER, HOSPITAL GRADE: NEMA 5-20R.		ROUND CORNERS. REFER TO PLANS AND EXTERIOR PULLBOX SCHEDULE FOR ADDITIONAL INFORMATION.
	RECEPTACLE, DUPLEX WITH GROUND FAULT CIRCUIT	S	SUBSTATION.
₩	INTERRUPTER, HOSPITAL GRADE ON EMERGENCY POWER: NEMA 5-20R.	Т	TRANSFORMER.
∯ wp	RECEPTACLE, DUPLEX WITH GROUND FAULT CIRCUIT INTERRUPTER, WEATHERPROOF: NEMA 5-20R.	ELECTRIC	AL POWER AND DISTRIBUTION
Ф	RECEPTACLE, DUPLEX, RECESSED: NEMA 5-20R.		FUSE WITH RATING (ONE-LINE DIAGRAM).
₫ s	RECEPTACLE, DUPLEX, SWITCHED, RECESSED: NEMA 5-20R.		DISCONNECT, FUSED (ONE-LINE DIAGRAM).
₽	RECEPTACLE, QUADRAPLEX: NEMA 5-20R.		
•	RECEPTACLE, QUADRAPLEX ON EMERGENCY POWER: NEMA 5-20R.		DISCONNECT, NONFUSED (ONE-LINE DIAGRAM).
#	RECEPTACLE, QUADRAPLEX, HOSPITAL GRADE: NEMA 5-20R.		
•	RECEPTACLE, QUADRAPLEX, HOSPITAL GRADE ON EMERGENCY POWER: NEMA 5-20R.		
•	RECEPTACLE, QUADRAPLEX, CONNECTED TO UPS: NEMA 5-20R. RECEPTACLE, QUADRAPLEX WITH GROUND FAULT CIRCUIT	Ţ	DISCONNECT WITH FUSE AND MOTOR STARTER COMBINATION (ONE-LINE DIAGRAM).
	INTERRUPTER: NEMA 5-20R. RECEPTACLE, SPECIAL PURPOSE. PROVIDE RECEPTACLE TO		
<u>&</u>	MATCH EQUIPMENT PLUG. RECEPTACLE, SPECIAL PURPOSE ON EMERGENCY POWER.		
	PROVIDE RECEPTACLE TO MATCH EQUIPMENT PLUG. RECEPTACLE, DRYER: NEMA 14-30R.		
D R	RECEPTACLE, RANGE: NEMA 14-50R.		OVERLOAD RELAY (ONE-LINE DIAGRAM).
	MULTI-OUTLET ASSEMBLY: NEMA 5-20R.	टू	STARTER (ONE-LINE DIAGRAM).
(D)	DROP CORD. SEE DETAIL.		
	THERMOSTAT.		CIRCUIT BREAKER, MOLDED CASE (ONE-LINE DIAGRAM).
	FLUSH FLOOR BOX. "#" SHOWN ON DRAWINGS. REFER TO	Å	CIRCUIT BREAKER, MOLDED CASE WITH SHUNT TRIP
FB#	WIRING DEVICE SCHEDULE IN THE ELECTRICAL SPECIFICATIONS FOR CONFIGURATION AND DEVICES.	v ∖t	(ONE-LINE DIAGRAM).
PP#	POWER POLE. "#" SHOWN ON DRAWINGS. REFER TO WIRING DEVICE SCHEDULE IN THE ELECTRICAL SPECIFICATIONS FOR CONFIGURATION AND DEVICES.		CIRCUIT BREAKER, MOTOR CIRCUIT PROTECTION (ONE-LINE DIAGRAM).
PT#	FLUSH FIRE RATED POKE THRU. "#" SHOWN ON DRAWINGS. REFER TO WIRING DEVICE SCHEDULE IN THE ELECTRICAL SPECIFICATIONS FOR CONFIGURATION AND DEVICES.	(#AF #AT	CIRCUIT BREAKER, ADJUSTABLE TRIP. "225AF" REPRESENTS THE RATING AND "150AT" REPRESENTS THE TRIP SETTING. (ONE-LINE DIAGRAM).
Ф	SWITCH, DIMMER.		
× × \$	SWITCH, SINGLE POLE ("x" INDICATES FIXTURES CONTROLLED).		CIRCUIT BREAKER, SOLID STATE (ONE-LINE DIAGRAM).
× X \$2	SWITCH, DOUBLE POLE ("x" INDICATES FIXTURES CONTROLLED).	, l	
X \$3	SWITCH, THREE-WAY ("x" INDICATES FIXTURES CONTROLLED).		CIRCUIT BREAKER, SOLID STATE WITH GROUND FAULT PROTECTION (ONE-LINE DIAGRAM).
X \$4	SWITCH, FOUR-WAY ("x" INDICATES FIXTURES CONTROLLED).	\sim	MOTOR.
\$DS	SWITCH, DOOR.	ωw	
\$K	SWITCH, KEY OPERATED.		TRANSFORMER (ONE-LINE DIAGRAM).
\$P	SWITCH, PILOT LIGHT.		TRANSFORMER, CURRENT (ONE-LINE DIAGRAM).
\$т	SWITCH, TIMER OPERATED.	+ + <u></u>	BATTERY (ONE-LINE DIAGRAM).
\$WP	SWITCH, WEATHERPROOF.		CAPACITOR (ONE-LINE DIAGRAM).
₿т	RECEPTACLE, DUPLEX, TAMPER RESISTANT: NEMA 5-20R.		DELTA CONNECTION (ONE-LINE DIAGRAM).
€	RECEPTACLE, QUADRAPLEX WITH GROUND FAULT CIRCUIT INTERRUPTER, HOSPITAL GRADE: NEMA 5-20R.		WYE CONNECTION (ONE-LINE DIAGRAM).
	RECEPTACLE, QUADRAPLEX WITH GROUND FAULT CIRCUIT INTERRUPTER, HOSPITAL GRADE ON EMERGENCY POWER: NEMA 5-20R.	"1DPHA"	
	RECEPTACLE, DUPLEX WITH GROUND FAULT CIRCUIT INTERRUPTER, CONNECTED TO UPS: NEMA 5-20R.		DISTRIBUTION PANELBOARD, MOTOR CONTROL CENTER, PLUG-IN BUSWAY, MEDIUM VOLTAGE SWITCHBOARD (ONE-LINE DIAGRAM).
₿.	RECEPTACLE, DUPLEX, WITH USB OUTLET		
ŧ	RECEPTACLE, DUPLEX, RECESSED, NEMA 5-20R, AUTOMATICALLY CONTROLLED THROUGH TIME OR OCCUPANCY BASED CONTROLS (REFER TO PLANS FOR CONTROL METHOD)	"1H"	PANELBOARD (ONE-LINE DIAGRAM).
#	RECEPTACLE, QUADRAPLEX, RECESSED, NEMA 5-20R, AUTOMATICALLY CONTROLLED THROUGH TIME OR OCCUPANCY BASED CONTROLS (REFER TO PLANS FOR CONTROL METHOD)	225/3	
#	INDICATES A RECEPTACLE IS AUTOMATICALLY CONTROLLED THROUGH TIME OR OCCUPANCY BASED CONTROLS (REFER TO PLANS FOR CONTROL METHOD)	"1H"	PANELBOARD WITH MAIN LUGS ONLY. BUS SIZE AND PHASE AS SHOWN (ONE-LINE DIAGRAM).
)225/3 "1H"	PANELBOARD WITH MAIN CIRCUIT BREAKER. SIZE AND PHASE SHOWN (ONE-LINE DIAGRAM).
		225/3	

	SYMBOLS LEGEND
SYMBOL	
ELECTRICA	AL POWER AND DISTRIBUTION
225/3 "1H" ••••••••••••••••••••••••••••••••••	PANELBOARD WITH MAIN LUGS ONLY AND SURGE PROTE WITH CIRCUIT BREAKER (ONE-LINE DIAGRAM).
225/3 "1H" 225/3 "1H"	PANELBOARD WITH SUB FEED LUGS (ONE-LINE DIAGRAM)
)225/3 "1H" "1H"	PANELBOARD WITH CIRCUIT BREAKER AND SUB FEED LUG (ONE-LINE DIAGRAM).
	CT CABINET PER UTILITY'S REQUIREMENTS (ONE-LINE DIA
	CT CABINET PER UTILITY'S REQUIREMENTS (ONE-LINE DIA
	TRANSFER SWITCH (ONE-LINE DIAGRAM).
	DIGITAL MULTIMETER (ONE-LINE DIAGRAM).
<u> </u>	EARTH GROUND (ONE-LINE DIAGRAM).
╸╋╢	SERVICE ENTRANCE SURGE PROTECTION (ONE-LINE DIAC
ANN	GENERATOR, ANNUNCIATOR (ONE-LINE DIAGRAM).
F EPO	PUSH BUTTON, REMOTE EMERGENCY STOP.
G	GENERATOR, POWER (ONE-LINE DIAGRAM).
K	KIRK-KEY MECHANICAL INTERLOCK (ONE-LINE DIAGRAM)
M	METER.
BBF	BROAD BAND FILTER (ONE-LINE DIAGRAM).
VFC VFD	VARIABLE FREQUENCY MOTOR CONTROLLER (ONE-LINE DIAGRAM).
†	DIODE (ONE-LINE DIAGRAM).
Ŀ	DISCONNECT SWITCH, FUSED.
Ŀ	DISCONNECT SWITCH, UNFUSED.
Σ'n	STARTER, COMBINATION WITH DISCONNECT SWITCH.
	STARTER OR MOTOR CONTROLLER.
•	PUSHBUTTON.
•	PUSHBUTTONS, MOTOR CONTROL.
, 777 ,	PANELBOARD CABINET, FLUSH MOUNTED.
	PANELBOARD CABINET, SURFACE MOUNTED, 1 SECTION.
	PANELBOARD CABINET, SURFACE MOUNTED, 2 SECTION.
 DP#	DISTRIBUTION PANEL OR SWITCHBOARD.
	LIGHTING RELAY, CONTACTOR PANEL, OR DIMMING ENCL
\$ST	SWITCH, TOGGLE MOTOR STARTER WITH OVERLOAD PROTECTION.
	TRANSFORMER (SEE ONE-LINE FOR SIZE)
B B	BUSWAY.
	SPECIALIZED TRANSFER SWITCH (ONE-LINE DIAGRAM).
	CIRCUIT BREAKER, DRAW OUT (ONE-LINE DIAGRAM).

)		ABBREV		
	1P	NOTE: ALL ABBREVIAT		Y NOT BE USED.
	1PH	SINGLE-PHASE	kVAR kW	KILOWATT
	1WAY 2/C	ONE-WAY TWO-CONDUCTOR	kWh LED	KILOWATT HOUR LIGHT EMITTING DIODE
E PROTECTION	2WAY 3/C	TWO-WAY THREE-CONDUCTOR	LFMC	LIQUID TIGHT FLEXIBLE ME
	3WAY 4OUT	THREE-WAY QUADRUPLE RECEPTACLE	LFNC	LIQUID TIGHT FLEXIBLE NONMETALLIC CONDUIT
	4PDT	OUTLET FOUR-POLE DOUBLE THROW	LPS LRA	LOW PRESSURE SODIUM LOCKED ROTOR AMPS
DIAGRAM).	4PST	FOUR-POLE SINGLE THROW	LTG LV	LIGHTING LOW VOLTAGE
	4W 4WAY	FOUR-WIRE FOUR-WAY	MATV	MASTER ANTENNA TELEVIS SYSTEM
FEED LUGS	A AC	ABOVE COUNTER ARMORED CABLE	MAX	MAXIMUM
	ACS ADA	ACCESS CONTROL SYSTEM AMERICANS WITH DISABILITIES	MC MCA	METAL CLAD MINIMUM CIRCUIT AMPS
	ADJ	ACT ADJACENT	MCB MCC	MAIN CIRCUIT BREAKER MOTOR CONTROL CENTER
	AFF	ABOVE FINISHED FLOOR	MCP MDP	MOTOR CIRCUIT PROTECTI MAIN DISTRIBUTION PANEL
E-LINE DIAGRAM).	AFG AIC	ABOVE FINISHED GRADE	MG	MOTOR GENERATOR
	ALUM	CAPACITY ALUMINUM	MH MIN	MANHOLE MINIMUM
	AMP ANN	AMPERE ANNUNCIATOR	MLO MOCP	MAIN LUGS ONLY MAXIMUM OVERCURRENT
-LINE DIAGRAM).	AP	ACCESS POINT (WIRELESS DATA)	MTS	PROTECTION MANUAL TRANSFER SWITC
-LINE DIAGRAM).	AR ASC	AS REQUIRED AMPS SHORT CIRCUIT	NA NC	NOT APPLICABLE NORMALLY CLOSED
	ASC	AUTOMATIC TRANSFER SWITCH	NEC	NATIONAL ELECTRICAL CO
	AV	AUDIO VISUAL	NEMA	NATIONAL ELECTRICAL MANUFACTURERS
	AWG BB	AMERICAN WIRE GAGE BUCK-BOOST TRANSFORMER	NFC	ASSOCIATION NATIONAL FIRE CODE
	XFMR BFF	BELOW FINISHED FLOOR	NFPA	NATIONAL FIRE PROTECTIC ASSOCIATION
	BFG C	BELOW FINISHED GRADE CEILING MOUNTED	NIC NL	NOT IN CONTRACT NIGHT LIGHT
	CAT	CATEGORY	NO NTS	NORMALLY OPEN NOT TO SCALE
	CATV	COMMUNITY ANTENNA TELEVISION	ос	ON CENTER
LINE DIAGRAM).	CB CCBA	CIRCUIT BREAKER CUSTOM COLOR AS SELECTED	OCP OE	OVER CURRENT PROTECTION
М).	CCTV	BY ARCHITECT CLOSED CIRCUIT TELEVISION	OF/CI	OWNER FURNISHED/ CONTRACTOR INSTALLED
··· <i>j</i> .	CF/CI	CONTRACTOR FURNISHED/ CONTRACTOR INSTALLED	OF/OI	OWNER FURNISHED/ OWNE
	CF/OI	CONTRACTOR FURNISHED/ OWNER INSTALLED	OFP OH DR	OBTAIN FROM PLANS OVERHEAD (COILING) DOOI
	CFBA	CUSTOM FINISH AS SELECTED BY ARCHITECT	OL	OVERLOAD
AGRAM)	CI CKT	CONTACT INDICATOR	PB PF	PUSHBUTTON POWER FACTOR
	СМ	CONSTRUCTION MANAGER	PH PNL	PHASE PANEL
	CND CO	CONDUIT CONVENIENCE OUTLET	PNM PR	PLENUM PAIR
	COR	CONTRACTING OFFICER'S REPRESENTATIVE	PS	POWER SUPPLY
NE-LINE	CP CR	CONTROL PANEL CARD READER	PT PTZ	POTENTIAL TRANSFORMER PAN/TILT/ZOOM
	СТ	CURRENT TRANSFORMER	PV QTY	PHOTO VOLTAIC QUANTITY
	CTV CU	CABLE TELEVISION COPPER	R RCP	REMOVE REFLECTED CEILING PLAN
	dBA DPDT	UNIT OF SOUND LEVEL DOUBLE POLE, DOUBLE	RMC RNC	RIGID METAL CONDUIT RIGID NONMETAL CONDUIT
	DS	THROW DISCONNECT SWITCH	RO	REMOTE DOOR OPEN
ITCH.	E	ENHANCED EACH	RPM RPP	REVOLUTIONS PER MINUTE RISER PATCH PANEL
	EM	EMERGENCY	RR S/S	REMOVE AND RELOCATE START/STOP
	EMT ENT	ELECTRICAL METALLIC TUBING ELECTRIC NONMETALLIC	SCA SCBA	SHORT CIRCUIT AMPS STANDARD COLOR AS
	EPO	TUBING EMERGENCY POWER OFF		SELECTED BY ARCHITECT
	EQUIP ER	EQUIPMENT EQUIPMENT ROOM	SF SFBA	SQUARE FOOT (FEET) STANDARD FINISH AS
	EX F	EXISTING FURNITURE MOUNTED	SPD	SELECTED BY ARCHITECT SURGE PROTECTIVE DEVIC
SECTION.	FA	FIRE ALARM	SPDT SPEC	SINGLE POLE, DOUBLE THR SPECIFICATION
SECTION.	FCP FLA	FIRE ALARM CONTROL PANEL FULL LOAD AMPS	SPP SPST	STATION PATCH PANEL SINGLE POLE, SINGLE THRO
	FMC FOB	FLEXIBLE METAL CONDUIT FREIGHT ON BOARD	ST SWBD	SINGLE THROW SWITCHBOARD
	FPP FVNR	FIBER PATCH PANEL FULL VOLTAGE	SWGR	SWITCHGEAR
	FVR	NON-REVERSING FULL VOLTAGE REVERSING	TL TP	TWIST LOCK TELEPHONE POLE
NG ENCLOSURE.	GEN	GENERATOR	TP TR	TWISTED PAIR TELECOMMMUNICATIONS
OAD	GFCI GFP	GROUND FAULT INTERRUPTER GROUND FAULT PROTECTION	ТТВ	ROOM TELEPHONE TERMINAL BOA
	GIG GND	GIGA HERTZ GROUND	TV TVSS	TELEVISION TRANSIENT VOLTAGE SURG
	HD HID	HEAVY DUTY HIGH INTENSITY DISCHARGE		SUPPRESSER
	HOA	HAND-OFF-AUTOMATIC	TYP UF	TYPICAL UNDERFLOOR
GRAM).	HP HPF	HORSE POWER HIGH POWER FACTOR	UGND UPS	UNDERGROUND UNINTERRUPTIBLE POWER
	HPS HV	HIGH PRESSURE SODIUM HIGH VOLTAGE	V	SUPPLY VOLTS
	HWM	HORIZONTAL WIRE MANAGEMENT	VA	VOLT AMPERE
	HZ I/O	HERTZ INPUT/ OUTPUT	D	VARIABLE FREQUENCY MO CONTROLLER
AM).	IG	ISOLATED GROUND	VIC VSS	VIDEO INTERCOM SYSTEM VIDEO SURVEILLANCE SYS
	IMC	INTERMEDIATE METAL CONDUIT	VWM W/	VERTICAL WIRE MANAGEM
	IN/IS IR	INSULATED/ ISOLATED INFRARED	W/O WP	WITHOUT WEATHERPROOF
	J-BOX kV	JUNCTION BOX KILOVOLT	WPP	WIRELESS PATCH PANEL
	kVA	KILOVOLT AMPERE	XFMR	TRANSFORMER
	·			

IPERE REACTIVE IIR NG DIODE FLEXIBLE METAL FLEXIBLE C CONDUIT IRE SODIUM OR AMPS ENNA TELEVISION CUIT AMPS Γ BREAKER **FROL CENTER** UIT PROTECTION BUTION PANEL ERATOR NLY ERCURRENT NSFER SWITCH BLE LOSED ECTRICAL CODE ECTRICAL RERS RE CODE RE PROTECTION RACT PEN INT PROTECTION TRONICS NISHED/ R INSTALLED NISHED/ OWNER /I PLANS COILING) DOOR OR RANSFORMER AIC CEILING PLAN CONDUIT TAL CONDUIT OR OPEN S PER MINUTE I PANEL RELOCATE JIT AMPS OLOR AS Y ARCHITECT T (FEET) INISH AS Y ARCHITECT ECTIVE DEVICE , DOUBLE THROW DN CH PANEL , SINGLE THROW W POLE UNICATIONS TERMINAL BOARD OLTAGE SURGE TIBLE POWER EQUENCY MOTOR COM SYSTEM EILLANCE SYSTEM IRE MANAGEMENT OOF ATCH PANEL

NOTE: ALL DEFINITIONS MAY NOT BE USED.

DEFINITIONS

INDICATED: THE TERM "INDICATED" REFERS TO GRAPHIC REPRESENTATIONS, NOTES, OR SCHEDULES ON THE DRAWINGS, OTHER PARAGRAPHS OR SCHEDULES IN THE SPECIFICATIONS, AND SIMILAR REQUIREMENTS IN THE CONTRACT DOCUMENTS. WHERE TERMS SUCH AS "SHOWN", "NOTED", "SCHEDULED", AND "SPECIFIED" ARE USED, IT IS TO HELP THE READER LOCATE THE REFERENCE, NO LIMITATION ON LOCATION IS INTENDED. DIRECTED: TERMS SUCH AS "DIRECTED", "REQUESTED", AUTHORIZED", "SELECTED", "APPROVED", "REQUIRED", AND "PERMITTED" MEAN "DIRECTED BY THE ENGINEER", "REQUESTED BY THE ENGINEER", AND SIMILAR PHRASES. APPROVED: THE TERM "APPROVED", WHERE USED IN CONJUNCTION WITH THE ENGINEER'S ACTION ON THE CONTRACTOR'S SUBMITTALS, APPLICATIONS, AND REQUESTS, IS LIMITED TO THE ENGINEER'S DUTIES AND RESPONSIBILITIES AS STATED IN GENERAL AND SUPPLEMENTARY CONDITIONS. FURNISH: THE TERM "FURNISH" IS USED TO MEAN "SUPPLY AND DELIVER TO THE PROJECT SITE, READY FOR UNLOADING, UNPACKING, ASSEMBLY, INSTALLATION, AND SIMILAR OPERATIONS." INSTALL: THE TERM "INSTALL" IS USED TO DESCRIBE OPERATIONS AT PROJECT SITE INCLUDING THE ACTUAL "UNLOADING, UNPACKING, ASSEMBLY, ERECTION, PLACING, ANCHORING, APPLYING, WORKING TO DIMENSION, FINISHING, CURING, PROTECTING, CLEANING, AND SIMILAR OPERATIONS." PROVIDE: THE TERM "PROVIDE" MEANS "TO FURNISH AND INSTALL, COMPLETE AND READY FOR THE INTENDED USE." INSTALLER: AN "INSTALLER" IS THE CONTRACTOR OR AN ENTITY ENGAGED BY THE CONTRACTOR, EITHER AS AN EMPLOYEE, SUBCONTRACTOR, OR SUB-SUBCONTRACTOR, FOR PERFORMANCE OF A PARTICULAR CONSTRUCTION ACTIVITY, INCLUDING INSTALLATION, ERECTION, APPLICATION, AND SIMILAR OPERATIONS. INSTALLERS ARE REQUIRED TO BE EXPERIENCED IN THE OPERATIONS THEY ARE ENGAGED TO PERFORM.

TECHNOLOGY SYSTEMS: THE TERM "TECHNOLOGY SYSTEMS" IS USED TO DESCRIBE ALL LOW VOLTAGE SYSTEMS GENERALLY REFERRED TO AS "SPECIAL SYSTEMS". THESE SYSTEMS INCLUDE BUT ARE NOT NECESSARILY LIMITED TO ALL SYSTEMS WHICH UTILIZE VOLTAGES OF LESS THAN 71 VOLTS SUCH AS SOUND SYSTEMS, VIDEO SYSTEMS, TV SYSTEMS, SECURITY SYSTEMS, VOICE AND DATA CABLING SYSTEMS, ETC...

GENERAL ELECTRICAL NOTES

THEMSELVES WITH THE DRAWINGS AND SPECIFICATIONS. ANY QUESTIONS, MISUNDERSTANDINGS, CONFLICTS, DELETIONS, DISCONTINUED PRODUCTS, CATALOG NUMBER DISCREPANCIES, DISCREPANCIES BETWEEN THE EQUIPMENT SUPPLIED AND THE INTENT OR FUNCTION OF THE EQUIPMENT, ETC, SHALL BE SUBMITTED TO THE ARCHITECT/ENGINEER IN WRITING FOR CLARIFICATION PRIOR TO ISSUANCE OF THE FINAL ADDENDUM AND BIDDING OF THE PROJECT. WHERE DISCREPANCIES OR MULTIPLE INTERPRETATIONS OCCUR, THE MOST STRINGENT (WHICH IS GENERALLY RECOGNIZED AS THE MOST COSTLY) THAT MEETS THE NTENT OF THE DOCUMENTS SHALL BE ENFORCED.

- OWNER FURNISHED ITEMS: THE OWNER WILL FURNISH MATERIAL AND EQUIPMENT AS INDICATED IN THE CONTRACT DOCUMENTS TO BE INCORPORATED INTO THE WORK. THESE ITEMS ARE ASSIGNED TO THE INSTALLER AND COSTS FOR RECEIVING, HANDLING, STORAGE, IF REQUIRED, AND INSTALLATION ARE INCLUDED IN THE CONTRACT SUM.
- A. THE INSTALLER'S RESPONSIBILITIES ARE THE SAME AS IF THE INSTALLER FURNISHED THE MATERIALS OR EQUIPMENT.
- B. THE OWNER WILL ARRANGE AND PAY FOR DELIVERY OF OWNER FURNISHED ITEMS FREIGHT ON BOARD JOB SITE AND THE INSTALLER WILL INSPECT DELIVERIES FOR DAMAGE. IF OWNER FURNISHED ITEMS ARE DAMAGED, DEFECTIVE OR MISSING, DOCUMENT DAMAGED ITEMS WITH THE TRANSPORT COMPANY AND THE OWNER WILL ARRANGE FOR REPLACEMENT. THE OWNER WILL ALSO ARRANGE FOR MANUFACTURER'S FIELD SERVICES, AND THE DELIVERY OF MANUFACTURER'S WARRANTIES AND BONDS TO THE INSTALLER.
- C. THE INSTALLER IS RESPONSIBLE FOR DESIGNATING THE DELIVERY DATES OF OWNER FURNISHED ITEMS AND FOR RECEIVING, UNLOADING AND HANDLING OWNER FURNISHED ITEMS AT THE SITE. THE INSTALLER IS RESPONSIBLE FOR PROTECTING OWNER FURNISHED ITEMS FROM DAMAGE, INCLUDING DAMAGE FROM EXPOSURE TO THE ELEMENTS, AND TO REPAIR OR REPLACE ITEMS DAMAGED AS A RESULT OF HIS OPERATIONS.
- EXPOSED STRUCTURE AREAS (EXCLUDING MECHANICAL, ELECTRICAL, AND COMMUNICATION SPACES): INSTALL RACEWAYS BETWEEN DECK AND STRUCTURE WHEREVER POSSIBLE IN EXPOSED STRUCTURE CEILING AREAS. ROUTE RACEWAYS IN CONCEALED AREAS WHEREVER POSSIBLE. REFER ALL CONDITIONS WHERE RACEWAYS MUST BE INSTALLED WHICH CANNOT COMPLY WITH THESE REQUIREMENTS TO THE ARCHITECT.
- SUBMITTALS: PROVIDE ORIGINAL ELECTRONIC PDF FORMAT, BOUND, BOOKMARKED (EACH SECTION AND PRODUCT), AND HIGHLIGHTED. JOB NAME AND SUBCONTRACTOR SHALL BE ON THE FRONT COVER. PREPARE INDEX OF EQUIPMENT SUBMITTED IN EACH TAB.
- REFLECTED CEILING PLANS: COORDINATE THE LOCATION OF LIGHT FIXTURES WITH THE ARCHITECTURAL REFLECTED CEILING PLANS. REFER ALL DISCREPANCIES TO THE ARCHITECT AND ENGINEER.
- ALL WORK SHALL BE DONE ACCORDING TO THE CURRENT NATIONAL ELECTRIC CODE (NEC), IBC, NFPA, AND IFC. COMPLIANCE AND FINAL APPROVAL IS SUBJECT TO THE ON SITE FIELD INSPECTION OF THE AHJ.

	ELECTRICAL SHEET INDEX
EE001	ELECTRICAL COVER SHEET
EE002	SYMBOLS LEGEND
EE003	TELECOM SCHEDULES AND NOTES
EE004	AUXILIARY SCHEDULES AND NOTES
EE501	ELECTRICAL DETAILS
EE701	TYPICAL MOUNTING DETAILS
ED101	ED LEVEL 1 DEMOLITION PLANS
ED102	ED TRUAMA ROOMS ELECTRICAL DEMOLITION PLAN
ED103	INFUSION ELECTRICAL DEMOLITION PLAN
ED104	OR ELECTRICAL DEMOLITION PLAN
ED105	LDR ELECTRICAL DEMOLITION PLAN
EP100	LEVEL 1 OVERALL POWER PLAN
EP101	LEVEL 1 ED ELECTRICAL PLANS
EP102	ED OBSERVATION ROOM ELECTRICAL PLANS
EP103	ED TRAUMA ROOM ELECTRICAL PLANS
EP104	LEVEL 2 OVERALL POWER PLAN
EP105	INFUSION ELECTRICAL PLANS
EP106	OR ELECTRICAL PLANS
EP107	LEVEL 3 OVERALL POWER PLAN
EP108	LDR ELECTRICAL PLANS
EP109	LEVEL 3 CONFERENCE ROOM ECTRICAL PLANS
EP501	OR STERIS DRAWINGS
EP502	OR STERIS DRAWINGS
EP551	TELECOM EQUIPMENT RACK ELEVATIONS
EP552	TELECOM EQUIPMENT RACK ELEVATIONS
EP553	TELECOM EQUIPMENT RACK ELEVATIONS
EP554	TELECOM DETAILS
EP601	PANEL SCHEDULES
EP651	TELECOM RISER DIAGRAMS
EL601	INTERIOR LIGHTING FIXTURE SCHEDULE
EL602	LIGHTING CONTROL SCHEDULES
EY101	LEVEL 1 ED AUXILIARY PLANS
EY102	LEVEL 2 INFUSION AUXILIARY PLANS
EY103	LEVEL 3 AUXILIARY PLANS
EY551	AUXILIARY DETAILS
EY601	SYSTEMS SCEHDULES
EY651	AUXILIARY RISER DIAGRAMS

CLARIFICATION METHODS: AT THE TIME OF BIDDING, BIDDERS SHALL FAMILIARIZE




ARCHITECT HKS ARCHITECTS, INC. 222 SOUTH MAIN, SUITE 230 SALT LAKE CITY, UT 84101

STRUCTURAL ENGINEER REAVELEY ENGINEERS & ASSOCIATES 675 EAST 500 SOUTH, SUITE 400 SALT LAKE CITY, UTAH 84102

MECHANICAL ENGINEER VAN BOERUM & FRANK ASSOCIATES, INC 181 EAST 5600 SOUTH, SUITE 130 MURRAY, UTAH 84107

ELECTRICAL ENGINEER SPECTRUM ENGINEERS, INC 324 SOUTH STATE STREET, SUITE 400 SALT LAKE CITY, UTAH 84111



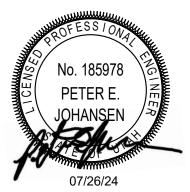





KEY PLAN

REVISION NO. DESCRIPTION

DATE

HKS PROJECT NUMBER 26404.000 DATE 08/15/24 ISSUE CONSTRUCTION DRAWINGS SHEET TITLE ELECTRICAL **COVER SHEET**

SHEET NO.



	SYMBOLS LEGEND
SYMBOL	DESCRIPTION
LIGHTING	
(W-3)	FIXTURE IDENTIFICATION: (W-3) INDICATES FIXTURE TYPE AS SCHEDULED.
(W-3E)	FIXTURE IDENTIFICATION: EMERGENCY LIGHTING FIXTURE WITH BATTERY PACK AND/ OR GENERATOR AND/ OR CENTRALIZED INVERTER AND/ OR CENTRALIZED UPS CONNECTION AS INDICATED IN PLANS. (W-3E) INDICATES FIXTURE TYPE AS SCHEDULED.
EM	EMERGENCY.
NL	NIGHT LIGHT: DO NOT SWITCH.
↑	EGRESS DIRECTION ARROW (EXIT SIGNS).
\bigotimes	EXIT SIGN: SINGLE FACE; CEILING MOUNTED
Ø ₽	EXIT SIGN: SINGLE FACE; WALL MOUNTED
	EXIT SIGN: DOUBLE FACE; CEILING MOUNTED
Ð	EXIT SIGN: DOUBLE FACE; WALL MOUNTED
LIGHTING (CONTROL
×	OCCUPANCY SENSOR, DUAL TECHNOLOGY, OMNI-DIRECTIONAL, CEILING.
×	OCCUPANCY SENSOR, DUAL TECHNOLOGY, WALL.
•	OCCUPANCY SENSOR, DUAL TECHNOLOGY, DIRECTIONAL.
P	PHOTOCELL.
HP	PHOTOCELL, WALL MOUNTED.
¥	VACANCY SENSOR, DUAL TECHNOLOGY, OMNI-DIRECTIONAL, CEILING.
\$∎ ₽	VACANCY SENSOR, DUAL TECHNOLOGY, WALL.
X	CEILING FAN.
**	SWITCH/OCCUPANCY SENSOR COMBO, DUAL TECHNOLOGY, WALL.
	SWITCH/VACANCY SENSOR COMBO, DUAL TECHNOLOGY, WALL.
Ť	DIMMER SWITCH/OCCUPANCY SENSOR COMBO, DUAL TECHNOLOGY, WALL.
	DIMMER SWITCH/VACANCY SENSOR COMBO, DUAL TECHNOLOGY, WALL.
a,b \$	LOW VOLTAGE DIGITAL LIGHTING CONTROL SWITCH: LETTER "a,b" INDICATES ZONING WHERE SHOWN (REFER TO PLANS, SCHEDULES, AND DETAILS FOR EXACT BUTTON CONFIGURATION AND PROGRAMMING REQUIREMENTS)
RC	DIGITAL LIGHTING ROOM CONTROLLER
DC	DIGITAL LIGHTING DIMMING CONTROLLER
LC	DIGITAL PLUG LOAD CONTROLLER
LS	LIGHTING NETWORK SWITCH.
NR	LIGHTING NETWORK ROUTER.
SM	LIGHTING NETWORK SEGMENT MANAGER
NB	LIGHTING NETWORK BRIDGE
ET	LIGHTING EMERGENCY TRANSFER DEVICE
X	LIGHTING SPACE CONTROL TYPE. X INDICATES TYPE. SEE SCHEDULE / DIAGRAM.
TWO-WAY	COMMUNICATIONS
2WA	TWO-WAY COMMUNICATIONS MAIN CONTROL STATION (ANNUNCIATOR)
RCS	TWO-WAY COMMUNICATIONS REMOTE CALL STATION
	DATA CONNECTION: TWO-WAY EMERGENCY COMMUNICATION SYSTEM.

		SYMBOLS LEGEND
	SYMBOL	DESCRIPTION
	FIRE ALARI	M
	FAA	FIRE ALARM ANNUNCIATOR PANEL.
IRE TYPE AS	FACP	FIRE ALARM CONTROL PANEL, SEMI-RECESSED.
		FIRE ALARM TERMINAL CABINET: NAC, SLC, SPEAKER
	FATC	CIRCUITS; AMPLIFIERS, BATTERIES
ION AS INDICATED CHEDULED.	HVAC	CONTROL PANEL FOR HVAC: SMOKE CONTROL, STAIR PRESSURIZATION.
	EVAC	VOICE EVACUATION PANEL.
	PRE	PRE-ACTION CONTROL PANEL.
		REMOTE VOICE EVACUATION MICROPHONE.
	FPC	FIRE PUMP CONTROLLER.
	JPC	JOCKEY PUMP CONTROLLER.
	С	AUTOMATIC DOOR CLOSERS: DOOR CLOSERS SHALL BE FURNISHED WITH DOOR HARDWARE AND CONNECTED BY FIRE ALARM INSTALLER.
	СМ	CONTROL MODULE.
	ММ	MONITOR MODULE.
L	F	FIRE ALARM MANUAL PULL STATION.
CTIONAL.	R	SHUT DOWN RELAY: INSTALL RELAY IN CONTROL CIRCUIT OF EQUIPMENT TO BE CONTROLLED IN THE EVENT OF A FIRE.
	FS	WATER FLOW SWITCH. FLOW SWITCHES SHALL BE PROVIDED AND INSTALLED BY FIRE SPRINKLER CONTRACTOR AND SHALL BE CONNECTED TO LOCATIONS SHOWN ON THE FIRE SPRINKLER SHOP DRAWINGS.
	VS	VALVE SUPERVISORY SWITCH, TAMPER SWITCH. TAMPER SWITCHES SHALL BE PROVIDED AND INSTALLED BY FIRE SPRINKLER CONTRACTOR AND SHALL BE CONNECTED TO LOCATIONS SHOWN ON THE FIRE SPRINKLER SHOP DRAWINGS.
CHNOLOGY, WALL.	PS	PRESSURE SUPERVISORY SWITCH. PRESSURE SWITCHES SHALL BE PROVIDED AND INSTALLED BY FIRE SPRINKLER CONTRACTOR AND SHALL BE CONNECTED TO LOCATIONS SHOWN ON THE FIRE SPRINKLER SHOP DRAWINGS
IOLOGY, WALL.	5	MAGNETIC DOOR HOLDER.
	(2)	DETECTOR, SMOKE.
	H	DETECTOR, SMOKE, WALL MOUNTED.
CH: LETTER TO PLANS,	A S	DETECTOR, SMOKE WITH AUXILIARY CONTACT.
CONFIGURATION	I BR	DETECTOR, SMOKE, BEAM RECEIVER.
		DETECTOR, SMOKE, BEAM TRANSMITTER.
	I	DETECTOR, SMORE, BEAM TRANSMITTER.
	() E	DETECTOR, SMOKE, ELEVATOR RECALL DESIGNATION.
	G	DETECTOR, SMOKE WITH GUARD.
	R	DETECTOR, SMOKE, RESIDENTIAL.
	₹,	DETECTOR, SMOKE WITH STROBE.
	(2) _{RS}	DETECTOR, SMOKE, RESIDENTIAL WITH SOUNDER BASE.
	e _{AS}	DETECTOR, SMOKE, AIR SAMPLING SYSTEM PORT LOCATION.
YPE. SEE		DETECTOR, SMOKE, DUCT WITH HOUSING AND SAMPLING TUBE.
ATION	L SD	SMOKE DAMPER. 120V POWER FROM ELECTRICAL SYSTEM.
	G FSD	COMBINATION FIRE/SMOKE DAMPER. 120V POWER FROM ELECTRICAL SYSTEM.
	RTS	REMOTE ALARM INDICATING AND TEST SWITCH.
		DETECTOR, HEAT.
	CO	DETECTOR, CARBON MONOXIDE.
	X	STROBE, WALL MOUNTED.
	75	STROBE, WALL MOUNTED. SUBSCRIPT INDICATES CANDELA RATING.
		ALARM, HORN/STROBE, WALL MOUNTED, ONE ASSEMBLY.
	75	ALARM, HORN/STROBE, WALL MOUNTED, ONE ASSEMBLY. SUBSCRIPT INDICATES CANDELA RATING.
	⊠<\⊂ ¢	ALARM, CHIME/STROBE, WALL MOUNTED, ONE ASSEMBLY.
		ALARM, HORN/STROBE WITH GUARD, WALL MOUNTED, ONE ASSEMBLY.
		ALARM, MINI HORN/STROBE, WALL MOUNTED, ONE ASSEMBLY.
		SPEAKER, WALL MOUNTED, EVACUATION.
		SPEAKER, WALL MOUNTED, EVACUATION, COMBINATION STROBE.
	75	SPEAKER, WALL MOUNTED, EVACUATION, COMBINATION STROBE. SUBSCRIPT INDICATES CANDELLA RATING.
		ALARM, HORN/STROBE, ONE ASSEMBLY, CEILING MOUNTED.
		SUBSCRIPT INDICATES CANDELA RATING. ALARM, HORN, CEILING MOUNTED. SUBSCRIPT INDICATES
		CANDELA RATING.
	75	SPEAKER/STROBE, CEILING MOUNTED. SUBSCRIPT INDICATES CANDELA RATING.
		SPEAKER, CEILING MOUNTED.
	(2) 75	ALARM, STROBE, CEILING MOUNTED. SUBSCRIPT INDICATES CANDELA RATING.
		BELL, ELECTRIC, 120V FROM ELECTRICAL SYSTEM OR
		24V FROM FIRE ALARM SYSTEM

	SYMBOLS LEGEND
SYMBOL	DESCRIPTION
CLOCK	
нC	CLOCK.
+© _G	CLOCK, SURFACE WITH WIRE GUARD.
NURSE CA	LL
0	JUNCTION BOX.
\square	CORRIDOR LIGHT.
B	BATHROOM PULL CORD STATION.
Ē	DUTY STATION.
Ē	EMERGENCY ASSISTANCE CALL STATION.
Есв	EMERGENCY ASSISTANCE CODE BLUE CALL STATION.
Ē	PATIENT STATION.
S	STAFF STATION.
NCM	TOUCH SCREEN NURSE CALL MASTER STATION.
ZLC	ZONE LIGHT CONTROLLER.
CU	NURSE CALL AREA CONTROL UNIT & POWER SUPPLIES.
ССТУ	
PP	CCTV CABLE, POWER.
	CCTV CABLE, VIDEO SIGNAL.
ССТУ	CCTV HEADEND EQUIPMENT.
М	CCTV MONITOR.
	CCTV CAMERA/ENCLOSURE WITH LENS, TYPICAL. SEE SCHEDULE.
РТZ 🗁	CCTV CAMERA WITH PAN, TILT AND ZOOM.
360°	PANNING CAMERA TRANSVERSE ANGLE.
SECURITY	
X	SECURITY CABLE. SEE EQUIPMENT SCHEDULE FOR CABLE TYPE.
ACC	ACCESS CONTROL HEADEND EQUIPMENT.
CTR	SECURITY CONTROL PANEL.
SEC	INTRUSION DETECTION HEADEND EQUIPMENT.
#1	CARD ACCESS DOOR TYPE #1 OR AS NOTED. SEE SCHEDULE.
CR	CARD READER.
KCR	KEYPAD/CARD READER COMBINATION.
	DOOR SWITCH, BALANCED MAGNETIC CONTROL.
	EXIT REQUEST.
• RL	REMOTE DOOR RELEASE BUTTON.
	BELL.
	BUZZER.
	BUZZER, COMBINATION BELL.
	SENSOR, BURIED VEHICULAR.
(È)	SENSOR, GLASS BREAK.
\Diamond	SENSOR, VOLUMETRIC.
CA)	CONTROLLED ACCESS POINT.
	INTERCOM STATION.
IRU	DUAL TECHNOLOGY PASSIVE INFRARED SENSOR AND ULTRASONIC MOTION DETECTOR.
(R)	PASSIVE INFRARED SENSOR.
P	PANIC DURESS SWITCH.
U	ULTRASONIC MOTION DETECTOR.
AP	ANNUNCIATOR PANEL.
MSI	MASTER STATION, INTERCOM.
TV DISTRIE	BUTION
T	TV DISTRIBUTION CABLE, INDIVIDUAL DROPS.
TR	TV DISTRIBUTION CABLE, TRUNK.
СМВ	COMBINER.
DC	DIRECTIONAL COUPLER.
DA	DISTRIBUTION AMPLIFIER (ONE-LINE DIAGRAM).
SPL	SPLITTER (ONE-LINE DIAGRAM).
	TV OUTLET.
	SATELLITE ANTENNA.
<u> </u>	TV ANTENNA (ONE-LINE DIAGRAM).
ex	TERMINATOR, 75 OHM (TV DISTRIBUTION). HDMI RECEPTACLE WITH SINGLE GANG BACKBOX AND 1.25" CONDUIT STUBBED TO ACCESSIBLE CEILING. PROVIDE 2.1 HDMI CABLE BETWEEN HDMI RECEPTACLES. "X" INDICATES QUANTITY OF HDMI PORTS WHEN GREATER THAN 1.



ARCHITECT HKS ARCHITECTS, INC. 222 SOUTH MAIN, SUITE 230 SALT LAKE CITY, UT 84101

STRUCTURAL ENGINEER REAVELEY ENGINEERS & ASSOCIATES 675 EAST 500 SOUTH, SUITE 400 SALT LAKE CITY, UTAH 84102

MECHANICAL ENGINEER VAN BOERUM & FRANK ASSOCIATES, INC 181 EAST 5600 SOUTH, SUITE 130 MURRAY, UTAH 84107

ELECTRICAL ENGINEER SPECTRUM ENGINEERS, INC 324 SOUTH STATE STREET, SUITE 400 SALT LAKE CITY, UTAH 84111







KEY PLAN



HKS PROJECT NUMBER 26404.000 DATE 08/15/24 ISSUE CONSTRUCTION DRAWINGS SHEET TITLE SYMBOLS LEGEND

REVISION NO. DESCRIPTION DATE

SHEET NO.



CATEGORY INSERT COLOR SCHEDULE

C	ATEGORY INSERT COLOR SCHEDULE	
INSERT COLOR	TYPE/ APPLICATION	
BLACK	TV COAX	
BLUE	ANALOG PHONE	LENGTH (
BLUE	DATA	LENGIN
BLUE	SECURITY CAMERAS	5'
GRAY	SECURITY CARD READERS	
ORANGE	CLINICAL ENGINEERING / NURSE CALL	
RED	FIRE SYSTEMS	7'
RED	FORESEER	
WHITE	PUBLIC ADDRESS	10'
YELLOW	WIRELESS	
GREEN	VENDOR NETWORK	

LENGTH (F
5'
7'

LENGTH (ME 3 5

LENGTH (ME 7'

LENGTH (M
5'
7'

COPPER PATCH CORD SCHEDULE

(CATEGORY 6A F/UTP CABLES W/RJ-45 CONNECTORS)					
LENGTH (FEET)	COLOR	QUANTITY	UNIT COST (EACH)		
5'	BLUE	20% OF TOTAL PORTS IN TDR'S	-		
7'	BLUE	60% OF TOTAL PORTS IN TDR'S	-		
10'	BLUE	20% OF TOTAL PORTS IN TDR'S	-		

COPPER PATCH CORD SCHEDULE

(CATEGORY 5E CABLES W/RJ-45 CONNECTORS)					
NGTH (FEET) COLOR QUANTITY UNIT COST (EACH)					
5'	BLUE	15	-		
7'	BLUE	15	-		
10'	BLUE	15	-		

FIBER PATCH CORD SCHEDULE (SINGLE-MODE W/LC CONNECTORS)

ETER)	COLOR	QUANTITY	UNIT COST (EACH)
	YELLOW	-	-
	YELLOW	-	-

WIRELESS PATCH CORD PATCH CORD SCHEDULE

(CATEGORY 6A F/UTP W RJ/45 CONNECTORS			
IETER)	COLOR	QUANTITY	UNIT COST (EACH)
	YELLOW	100% OF TOTAL PORTS IN TDR'S	-

CLINICAL ENGINEERING PATCH CORD SCHEDULE

(CATEGORY 6A F/UTP W RJ/45 CONNECTORS)				
IETER)	COLOR	QUANTITY	UNIT COST (EACH)	
	ORANGE	70% OF TOTAL PORTS IN TDR'S	-	
	ORANGE	30% OF TOTAL PORTS IN TDR'S	-	

	EQUIPMENT/CABLE LIS	ST
CABLING IN SPECIFIED NUMBERS	INDICATED BELOW SHALL NOT BE CONSTRUED AS A "BILL OF MATERIALS". THIS LIST IDENTIFIES ITEM ISTALLATION. WHERE THE ITEMS INDICATED ARE ONE PORTION OF AN ASSEMBLY, THE ENTIRE ASSEM . PROVIDE ALL MISCELLANEOUS HARDWARE AND SUPPORTS, WHICH MAY NOT BE LISTED HERE, FOR WITH DESCRIPTIONS AND NOTIFY ENGINEER OF DISCREPANCIES PRIOR TO BID. IF CATALOG NUMBER CEDENCE. PROVIDE COMPLETE SUBMITTAL FOR APPROVAL PRIOR TO PURCHASING ANY EQUIPMENT ENTS.	MBLY SHALL BE PROVIDED UNLESS OTHERWISE A COMPLETE INSTALLATION. COMPARE CATALOG S DO NOT MATCH DESCRIPTIONS, THE DESCRIPTIONS
SYMBOL	ITEM DESCRIPTION	ACCEPTABLE TYPES
	STATION CABLE, DATA - CATEGORY 6A F/UTP PLENUM RATED, BLUE, DATA	SIEMON 9A6P4-A5-06-R1A
	STATION CABLE, DATA - CATEGORY 6A F/UTP, PLENUM RATED, YELLOW, WIRELESS DATA	SIEMON 9A6P4-A5-05-R1A
	STATION CABLE, DATA - CATEGORY 6A F/UTP, PLENUM RATED, ORANGE, CLINICAL ENGINEERING	SIEMON 9A6P4-A5-09-R1A
	STATION CABLE, DATA - CATEGORY 6 UTP, PLENUM RATED, ORANGE, NURSE CALL	SIEMON 9C6P4-E3-09-RXA
W	VOICE OUTLET, SINGLE GANG FACEPLATE, WHITE W/WALL HUNG PHONE MOUNTING STUDS, ONE POSITION W/ CATEGORY 6A INSERT	SIEMON MX-WP-Z6AS-SS
	DATA OUTLET, SINGLE GANG FACEPLATE, WHITE, 4 POSITION	SIEMON 10GMX-FPS04-02
\bigtriangledown	CATEGORY 6A JACK - DATA, BLUE	SIEMON Z6A-S06
	BLANK INSERT, WHITE	SIEMON MX-BL-02
V	DATA OUTLET, SINGLE GANG FACEPLATE, WHITE, 4 POSITION	SIEMON 10GMX-FPS04-02
V	CATEGORY 6A JACK - DATA, BLUE	SIEMON Z6A-S06
	BLANK INSERT, WHITE	SIEMON MX-BL-02
	DATA OUTLET, SINGLE GANG FACEPLATE, WHITE, 4 POSITION	SIEMON 10GMX-FPS04-02
▼	CATEGORY 6A JACK - DATA, BLUE	SIEMON Z6A-S06
	BLANK INSERT, WHITE	SIEMON MX-BL-02
4 4C ▼ ▼	DATA OUTLET, SINGLE GANG FACEPLATE, WHITE, 4 POSITION	SIEMON 10GMX-FPS04-02
VV	CATEGORY 6A JACK - DATA, BLUE	SIEMON Z6A-S06
6C	DATA OUTLET, DOUBLE GANG FACEPLATE, WHITE, 6 POSITION	SIEMON 10GMX-FPD06-02
▼	CATEGORY 6A JACK - DATA, BLUE	SIEMON Z6A-S06
(((•)))	DATA OUTLET, SURFACE MOUNT BOX, WHITE, 2 POSITION (C=CEILING MOUNTED BOX)	SIEMON MX-SMZ2-02
(((•))) ▲C	CATEGORY 6A JACK - DATA, YELLOW	SIEMON Z6A-S05
	DATA OUTLET, SINGLE GANG FACEPLATE, WHITE, 4 POSITION (C=CEILING MOUNTED FACEPLATE)	SIEMON 10GMX-FPS04-02
M C-M ▽ ▽	CATEGORY 6A JACK - CLINICAL ENGINEERING, ORANGE	SIEMON Z6A-S09
v v	BLANK INSERT, WHITE	SIEMON MX-BL-02
	DATA OUTLET, SINGLE GANG FACEPLATE, WHITE, 4 POSITION (C=CEILING MOUNTED FACEPLATE)	SIEMON 10GMX-FPS04-02
M C-M	CATEGORY 6A JACK - CLINICAL ENGINEERING, ORANGE	SIEMON Z6A-S09
• •	BLANK INSERT, WHITE	SIEMON MX-BL-02
M C-M	DATA OUTLET, SINGLE GANG FACEPLATE, WHITE, 4 POSITION (C=CEILING MOUNTED FACEPLATE)	SIEMON 10GMX-FPS04-02
M C-M	CATEGORY 6A JACK - CLINICAL ENGINEERING, ORANGE	SIEMON Z6A-S09
	BLANK INSERT, WHITE	SIEMON MX-BL-02
C ▽	DATA OUTLET, SURFACE MOUNT BOX, WHITE, 1 POSITION	SIEMON MX-SMZ1-02
\bigtriangledown	CATEGORY 6A JACK - DATA, BLUE	SIEMON Z6A-S06
	DATA OUTLET, SURFACE MOUNT BOX, WHITE, 1 POSITION	SIEMON MX-SMZ1-02
ىر	CATEGORY 6A JACK - DATA, BLUE	SIEMON Z6A-S06
	BLANK FILLER PANEL, 1RU ANGLED	SIEMON PNL-BLNKA-1
SPP1	48 PORT, 1RU ANGLED PATCH PANEL, WITH OUTLETS - DETACHABLE REAR MNG	SIEMON Z6AS-PA-48
CEPP1	48 PORT, 1RU ANGLED PATCH PANEL, WITH OUTLETS - DETACHABLE REAR MNG	SIEMON Z6AS-PA-48
	PATCH CABLE, CAT 6A SHIELDED, BLUE, 5 FOOT	SIEMON ZM6A-S05-06
	PATCH CABLE, CAT 6A SHIELDED, BLUE, 7 FOOT	SIEMON ZM6A-S07-06
	PATCH CABLE, CAT 6A SHIELDED, BLUE, 10 FOOT	SIEMON ZM6A-S10-06
	PATCH CABLE, CAT 6A SHIELDED, YELLOW, 5 FOOT	SIEMON ZM6A-S05-05
	PATCH CABLE, CAT 6A SHIELDED, YELLOW, 7 FOOT	SIEMON ZM6A-S07-05
	PATCH CABLE, CAT 6A SHIELDED, YELLOW, 10 FOOT	SIEMON ZM6A-S10-05
	PATCH CABLE, CAT 6A SHIELDED, ORANGE, 5 FOOT	SIEMON ZM6A-S05-09
	PATCH CABLE, CAT 6A SHIELDED, ORANGE, 7 FOOT	SIEMON ZM6A-S07-09
	PATCH CABLE, CAT 6A SHIELDED, ORANGE, 10 FOOT	SIEMON ZM6A-S10-09
	PATCH CABLE, CAT 6, ORANGE, 5 FOOT - NURSE CALL ONLY	SIEMON ZM6-S05-09
	PATCH CABLE, CAT 6, ORANGE, 7 FOOT - NURSE CALL ONLY	SIEMON ZM6-S07-09
	PATCH CABLE, CAT 6, ORANGE, 10 FOOT - NURSE CALL ONLY	SIEMON ZM6-S10-09


PATCH CABLE, CAT 6, ORANGE, 10 FOOT - NURSE CALL ONLY NOTE: ALL RACKS, LADDER, PATCH PANELS AND ACCESSORIES SHALL BE BLACK IN COLOR.

EOUIDMENT/OADIEUET

GENERAL SHEET NOTES



"HOOK AND LOOP" FOR BUNDLING OF ALL CABLES.

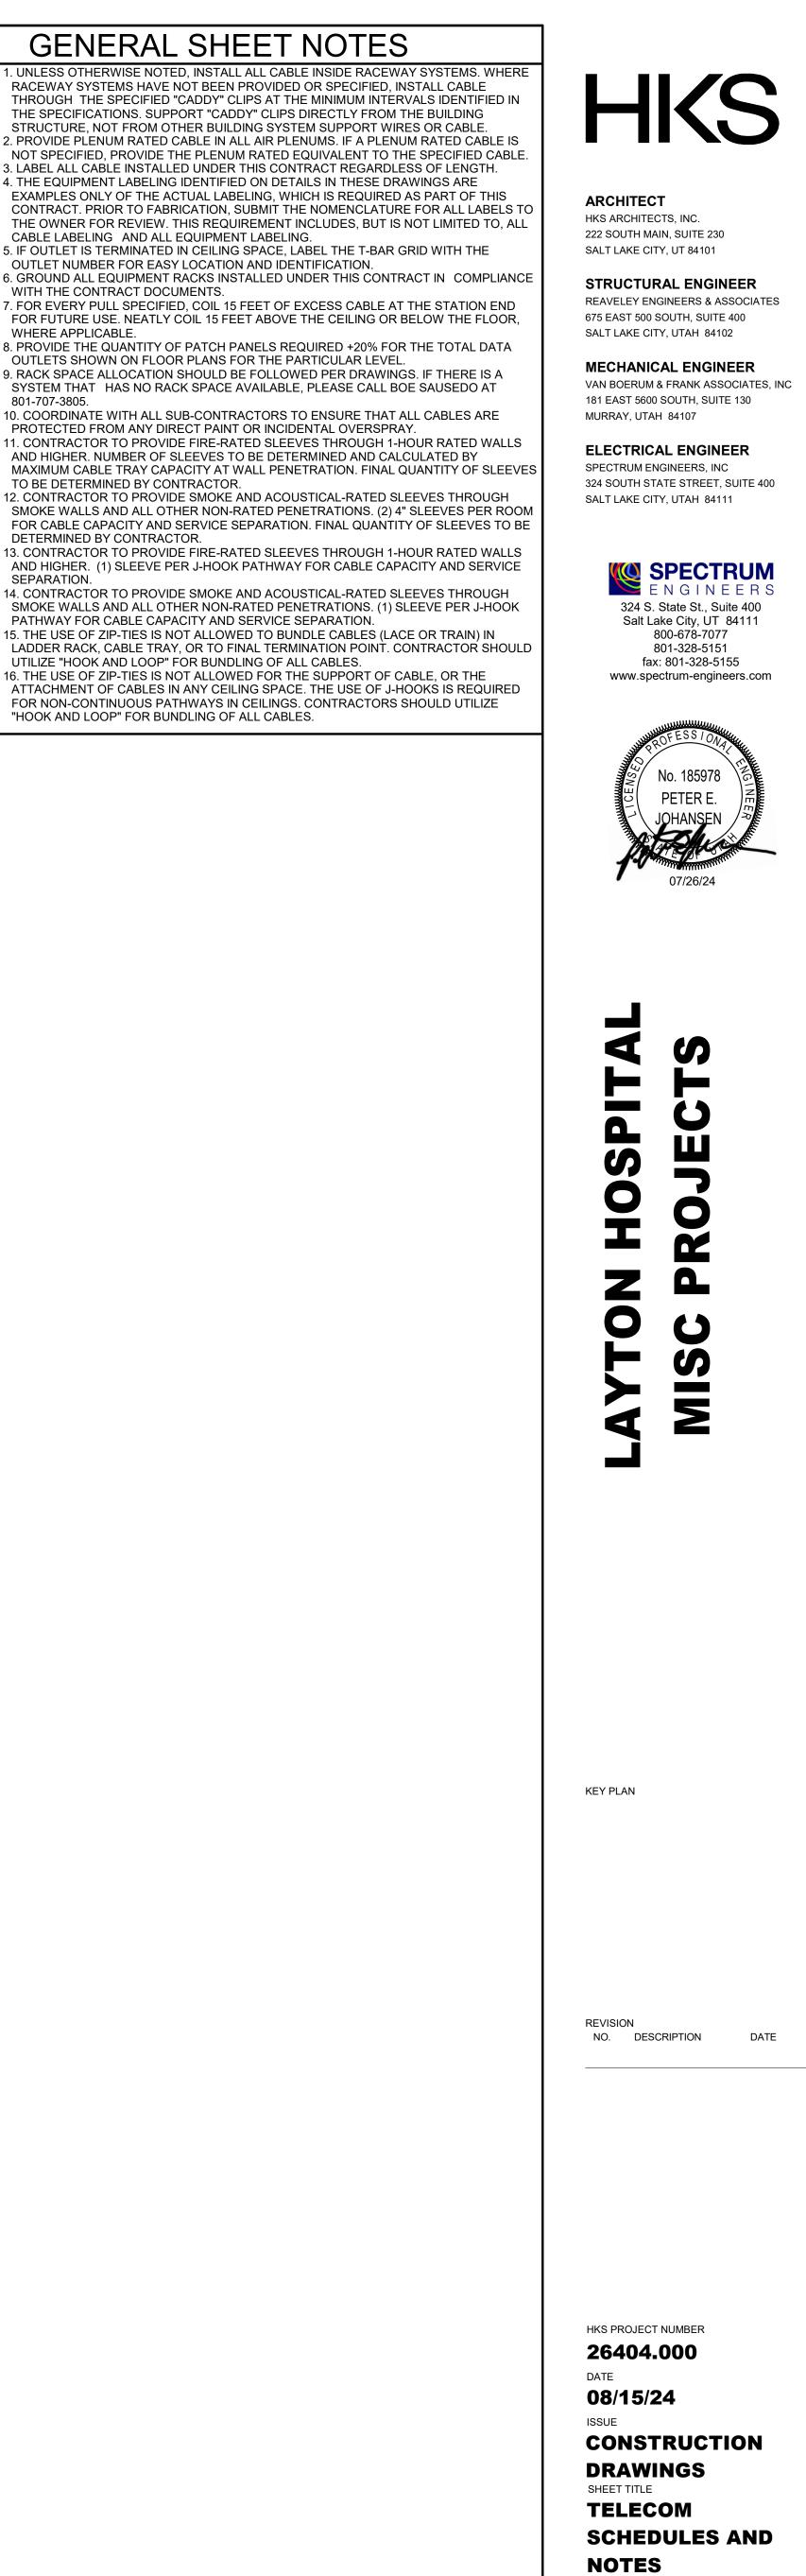

© 2008 HKS, INC.

EE003

		SYM
SYMBOL	DESCRIPTION	ROL
ACS	ACCESS CONTROL SYSTEM HEAD END	SEE
	CARD READER	4SC SEE
	SURVEILLANCE CAMERA	SEE
\bigcirc	DUAL-IMAGER CAMERA	SEE
Ô	PANAORAMIC 360/180 CAMERA	SEE
	DOOR LOCK TYPE [M] - MAG LOCK [L] - LEVER SET LOCK [NO LETTER] - GENERIC LOCK [T] - ELECTRIC TRANSFER HINGE [S] - ELECTRIC STRIKE LOCK [C] - CRASH BAR LOCK [O] - OPERATOR LOCK	SEE
♦	DOOR CONTACT INDICATOR	SEE
#	REQUEST TO EXIT DEVICE [M] - MOTION REX [L] - LEVER SET REX [NO LETTER] - GENERIC REX [C] - CRASH BAR REX [D] - DELAYED EGRESS REX	SEE
IC	INTERCOM STATION	4SC WIT
0	RELEASE FOR MAG LOCK	
		SEC
		SEC
NOTES: * CAMERA H	IAS CAPABILITY OF AUDIO OR NO AUDIO	
ID	DESCRIPTION	IR
DC	TYPE: 2 MP DUAL IMAGER MOUNTING: CEILING FOCAL LENGTH: 3-6mm RESOLUTION: 2X 1920x1080 FRAME RATE: 25/30 OPTIONS: NONE	YES

	RESOLUTION: 2X 1920x1080 FRAME RATE: 25/30 OPTIONS: NONE	
FC	TYPE: 6 MP PANORAMIC MOUNTING: CEILING FOCAL LENGTH: 1.56mm RESOLUTION: 2016 X 2016* FRAME RATE: 25/30 OPTIONS: NONE	YE
XCI	TYPE: 4 MP FIXED MOUNTING: CEILING FOCAL LENGTH: 2.4mm RESOLUTION: 2688 x 1512 FRAME RATE: 25/30 OPTIONS: NONE	N

MBOL S	SCHE	EDUL	E			GENERAL PROJECT NOT
OUGH-IN REQUIRE	EMENTS		N	DTES		1. PROVIDE PLENUM RATED CABLE FOR ALL SPECIFIED CABLE.
EE EY651						2. LABEL ALL CABLE INSTALLED UNDER THIS CONTRACT REGARDLE
SQ J-BOX W/ SING	LE GANG M	IUD RING A	T 40" AFF;			LENGTH. ACCORDING TO WRITTEN SPECIFICATION. 3. THE EQUIPMENT LABELING IDENTIFIED ON DETAILS IN THESE DRA
EE EY651 EE CAMERA SCHE	EDULE EE00)4	SE	E EP SHEETS FOR	RCABLING	EXAMPLES ONLY OF THE ACTUAL LABELING WHICH IS REQUIRED THIS CONTRACT. PRIOR TO FABRICATION, SUBMIT THE NOMENCL
EE CAMERA SCHE		74		E EP SHEETS FOR		ALL LABELS TO THE OWNER FOR REVIEW. THIS REQUIREMENT IN IS NOT LIMITED TO ALL CABLE LABELING, AND ALL EQUIPMENT LA
						4. COORDINATE WITH ALL SUBS TO ENSURE THAT ALL CABLE SHALL PROTECTED FROM ANY DIRECT PAINT OR INCIDENTAL OVERSPRA
EE CAMERA SCHE	EDULE EE00)4	SE	E EP SHEETS FOF	R CABLING	5. CONTRACTOR SHALL REVIEW ALL DOOR HARDWARE ROUGH-IN IN AGAINST THE DOOR HARDWARE SPECIFICATION AND DOOR HARD SCHEDULE TO VERIFY DOOR ROUGH-IN PRIOR TO CONSTRUCTIO
EE DOOR ROUGH		EY551				6. AIM CAMERAS, BACK FOCUS AND DEMONSTRATE VIEW TO OWNE SATISFACTION, RE-AIM AND FOCUS AS REQUESTED BY OWNER.
						CATION ACTION, RE-ANN AND FOODO AC REQUESTED DE OWNER.
EE DOOR ROUGH	IN DETAIL I	EY551				
EE DOOR ROUGH		EY551				
SQ J-BOX; 1" CONI				E EP SHEETS FOR		
/ITH OWNER					CADLING	
OORDINATE ROUG	GH IN BOX \	WITH LOCA	TION. 3/4"			
URITY	CAN	/ER/	A SCHE	DULE		
GENERAL N						
1. ELECTRIC PRIOR TO		ACTOR SHA	ALL REVIEW OTHE	R DIVISION DRAW	NGS FOR ANY ADDITIONAL REQUIRE	MENTS
2. ELECTRIC	CAL CONTR				TTALS FOR ANY EQUIPMENT REQUIRI	
	-					
R WDR	AUDIO	VANDAL	LOCATION	IP RATING	MANUFACTURER (SERIES)	NOTES
S YES	NO*	IK10	INDOOR/OUTDO	OR IP67	AXIS - P4705 - PLVE	
S YES	YES*	IK10	INDOOR/OUTDO	OR IP66	AXIS - P3077 - PLVE	
O YES	NO*	IK08	INDOOR	IP42	AXIS - M3086 - V	




© 2008 HKS, INC.

EE004

SCHEDULES AND


AUXILIARY

NOTES

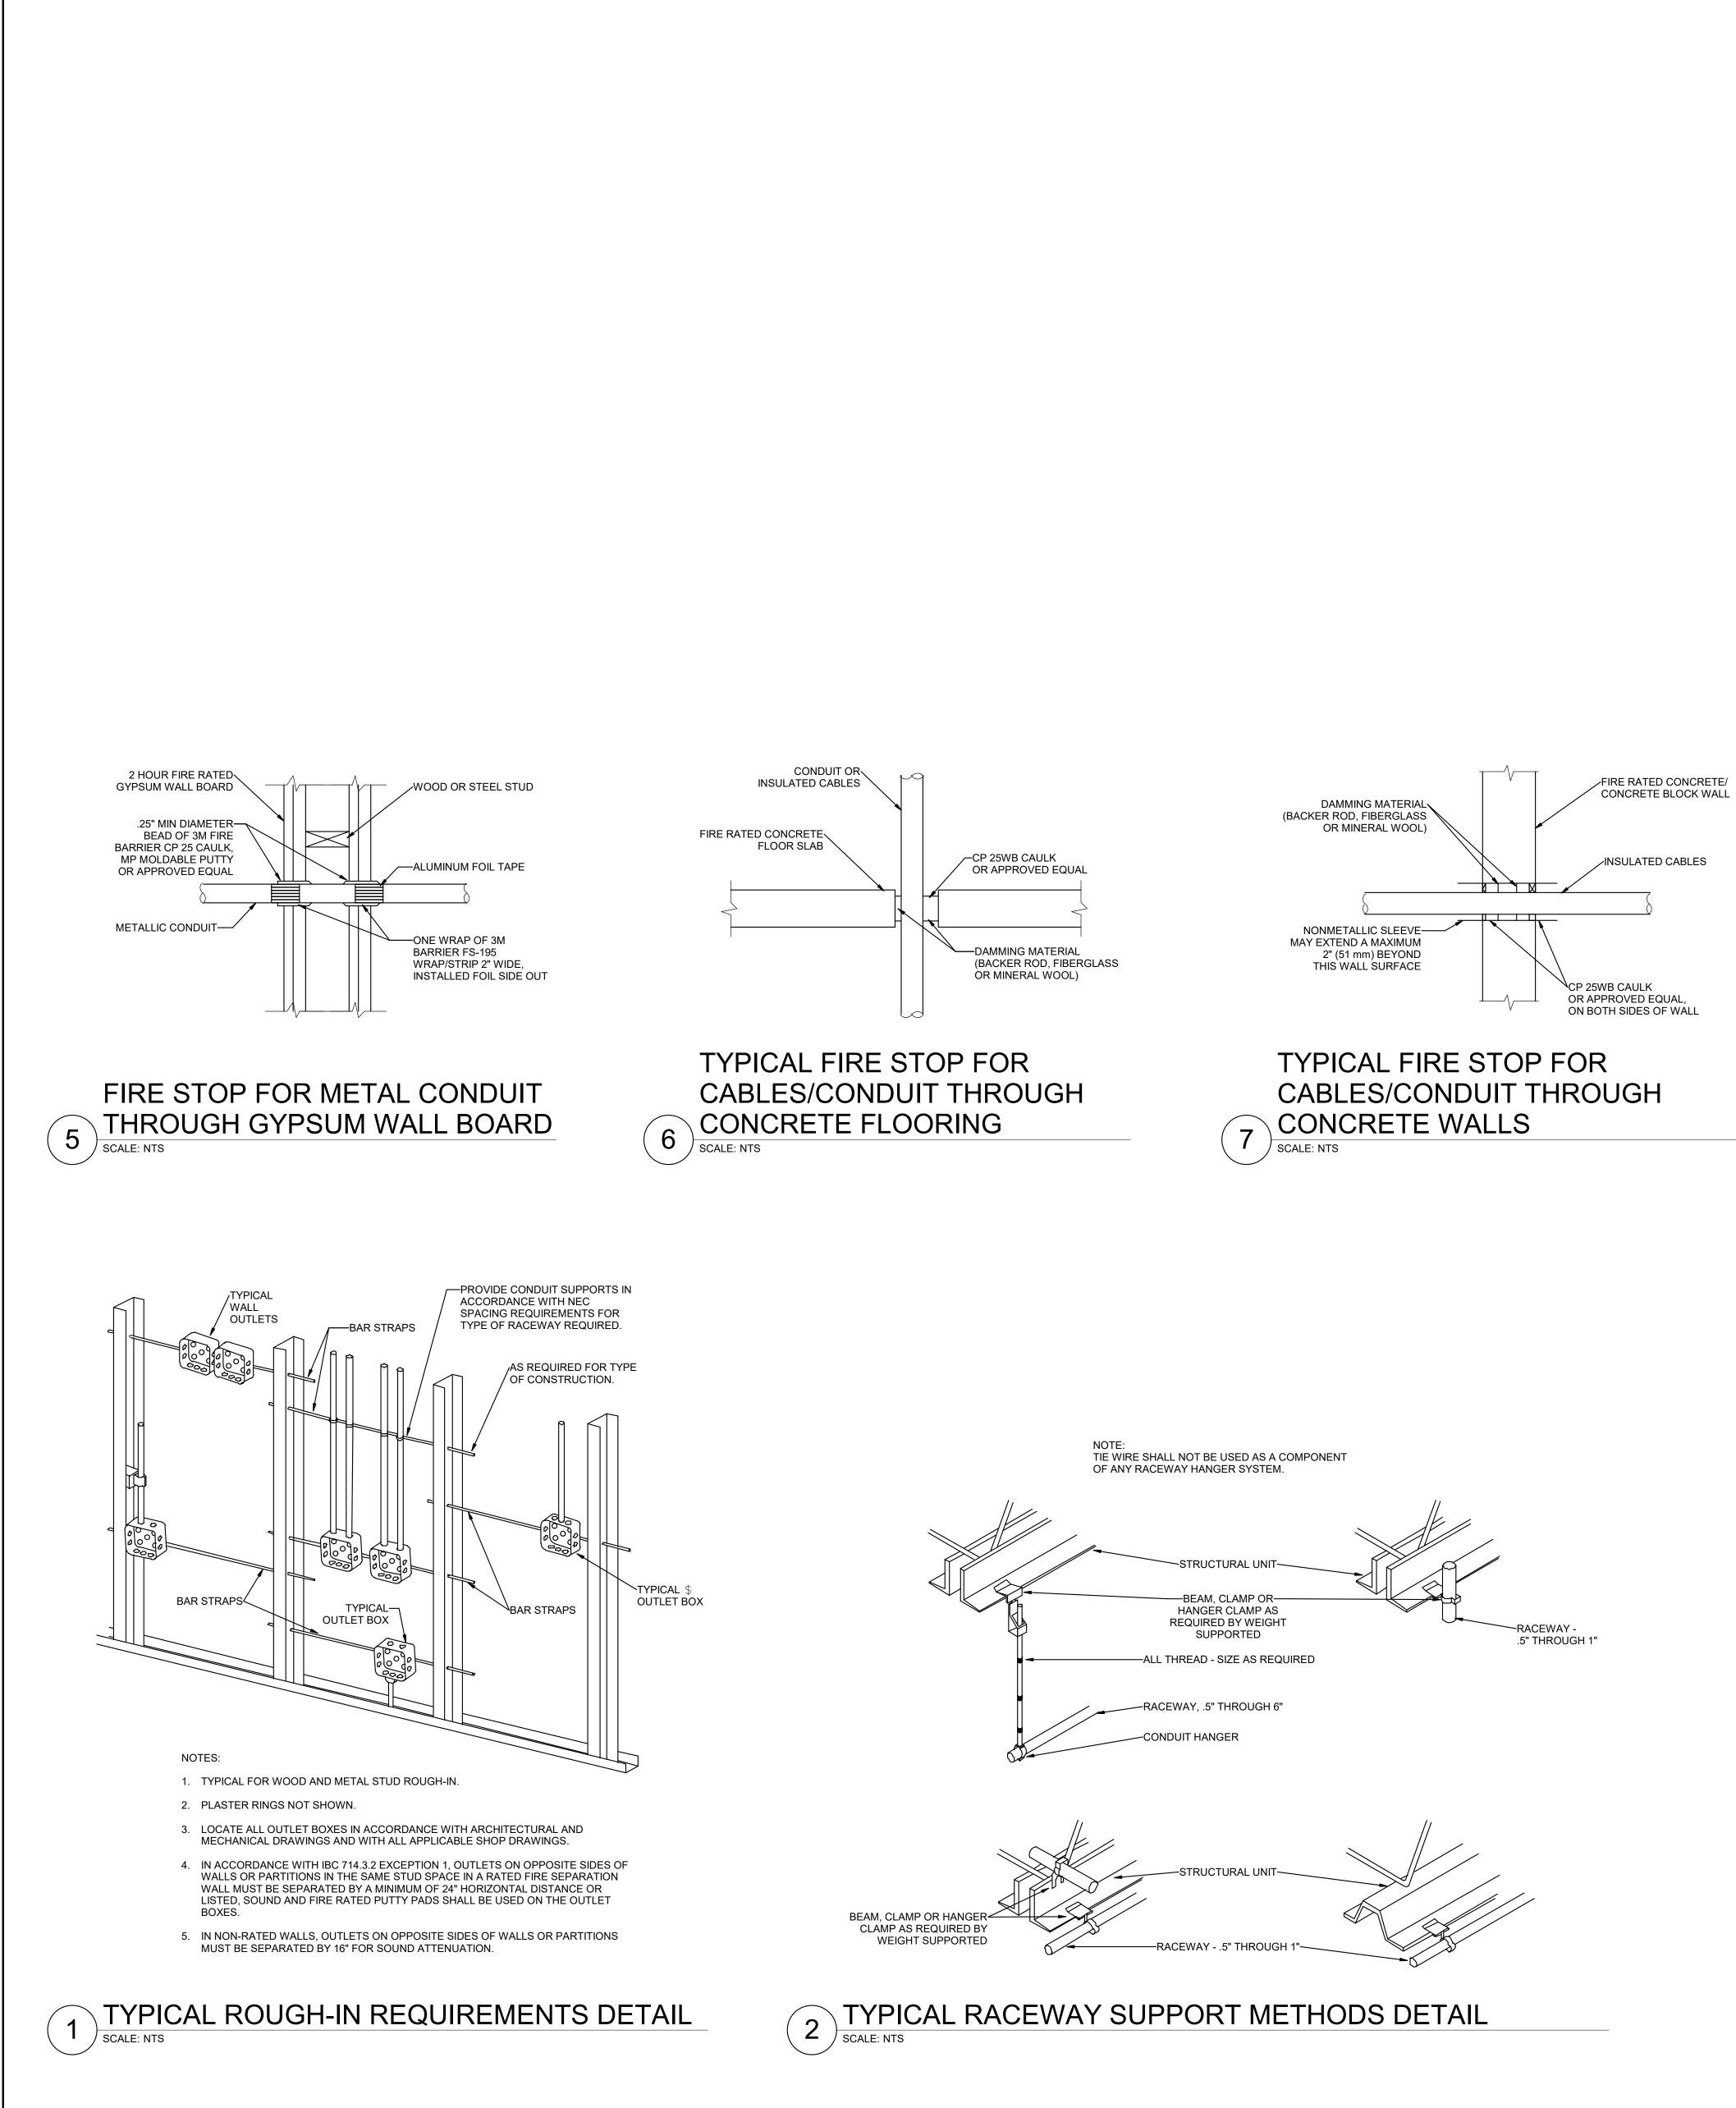




3 TYPICAL CONDUIT RACK DETAIL

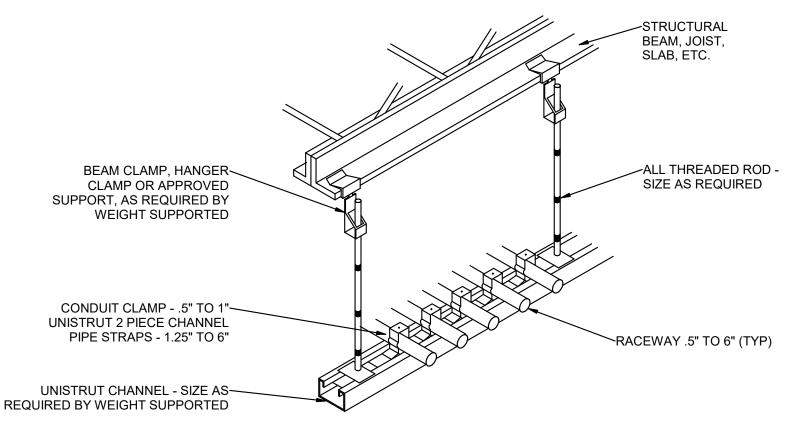

4 RECESSED FIXTURE MOUNTING DETAIL

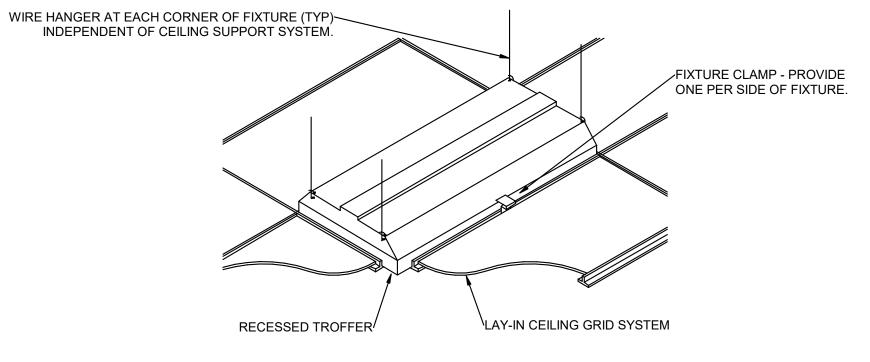



ARCHITECT HKS ARCHITECTS, INC. 222 SOUTH MAIN, SUITE 230 SALT LAKE CITY, UT 84101

STRUCTURAL ENGINEER REAVELEY ENGINEERS & ASSOCIATES 675 EAST 500 SOUTH, SUITE 400 SALT LAKE CITY, UTAH 84102

MECHANICAL ENGINEER VAN BOERUM & FRANK ASSOCIATES, INC 181 EAST 5600 SOUTH, SUITE 130 MURRAY, UTAH 84107

ELECTRICAL ENGINEER SPECTRUM ENGINEERS, INC 324 SOUTH STATE STREET, SUITE 400 SALT LAKE CITY, UTAH 84111











KEY PLAN

REVISION NO. DESCRIPTION DATE

HKS PROJECT NUMBER 26404.000 DATE 08/15/24 ISSUE CONSTRUCTION DRAWINGS SHEET TITLE ELECTRICAL DETAILS




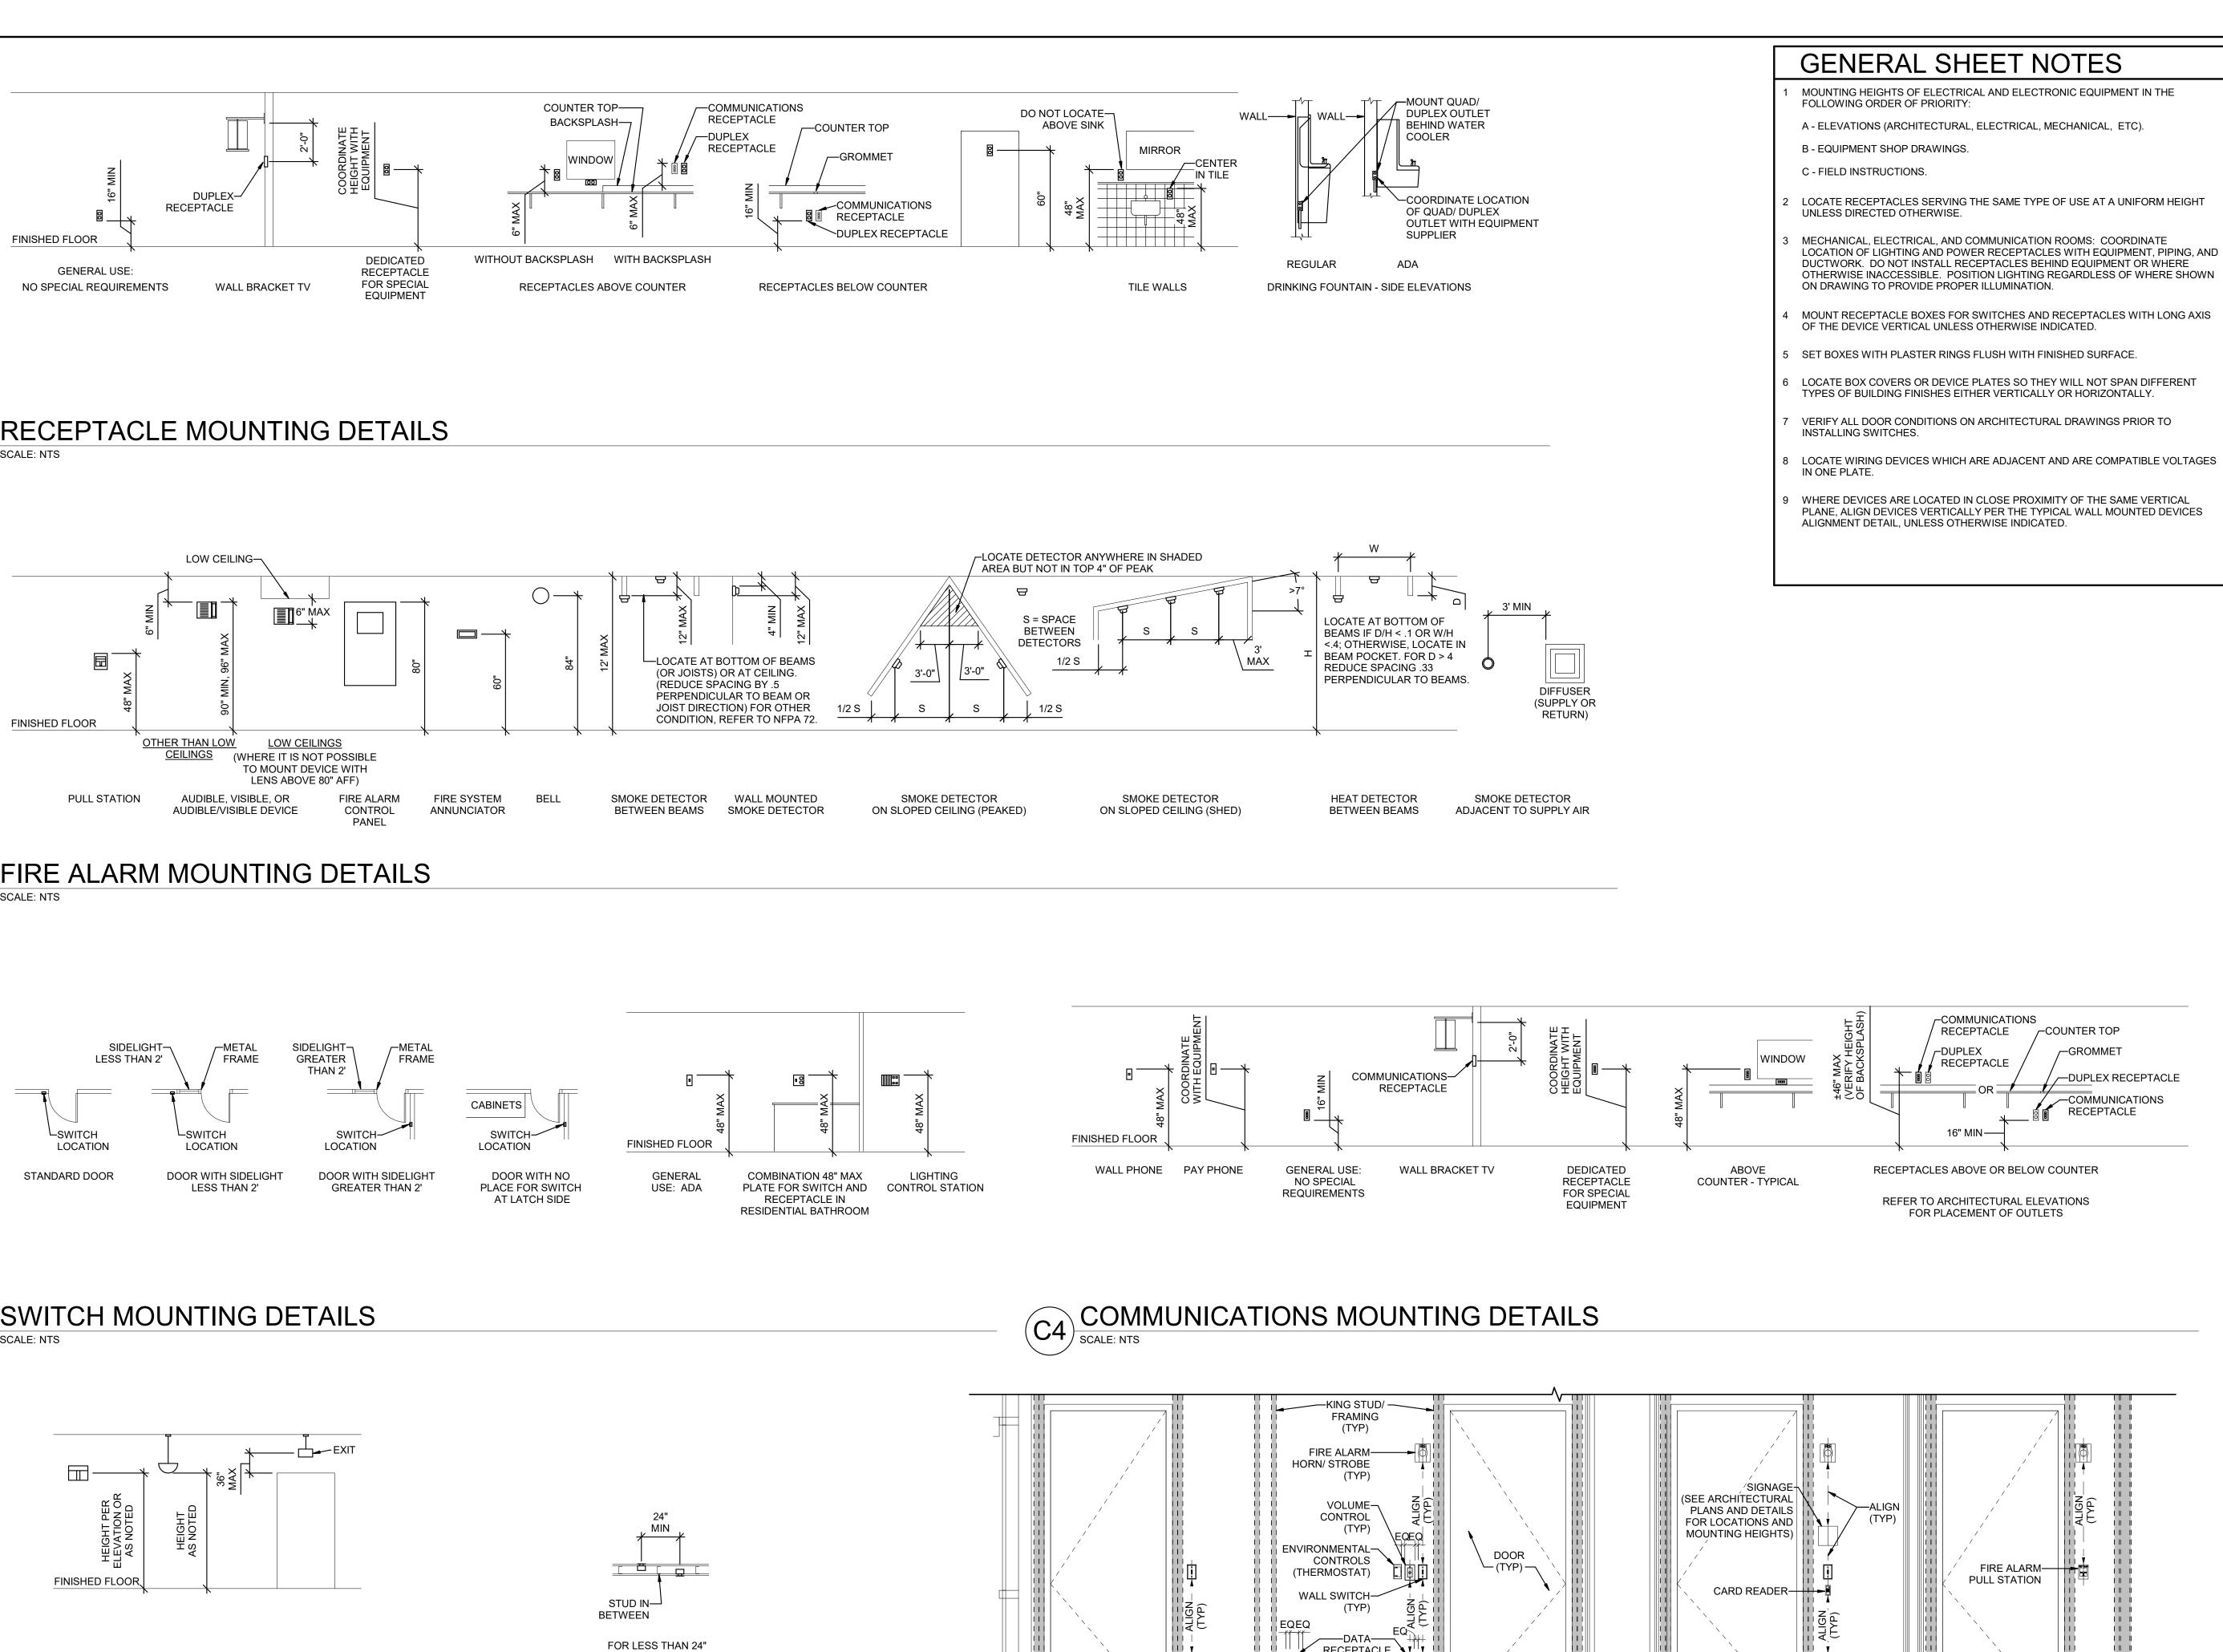


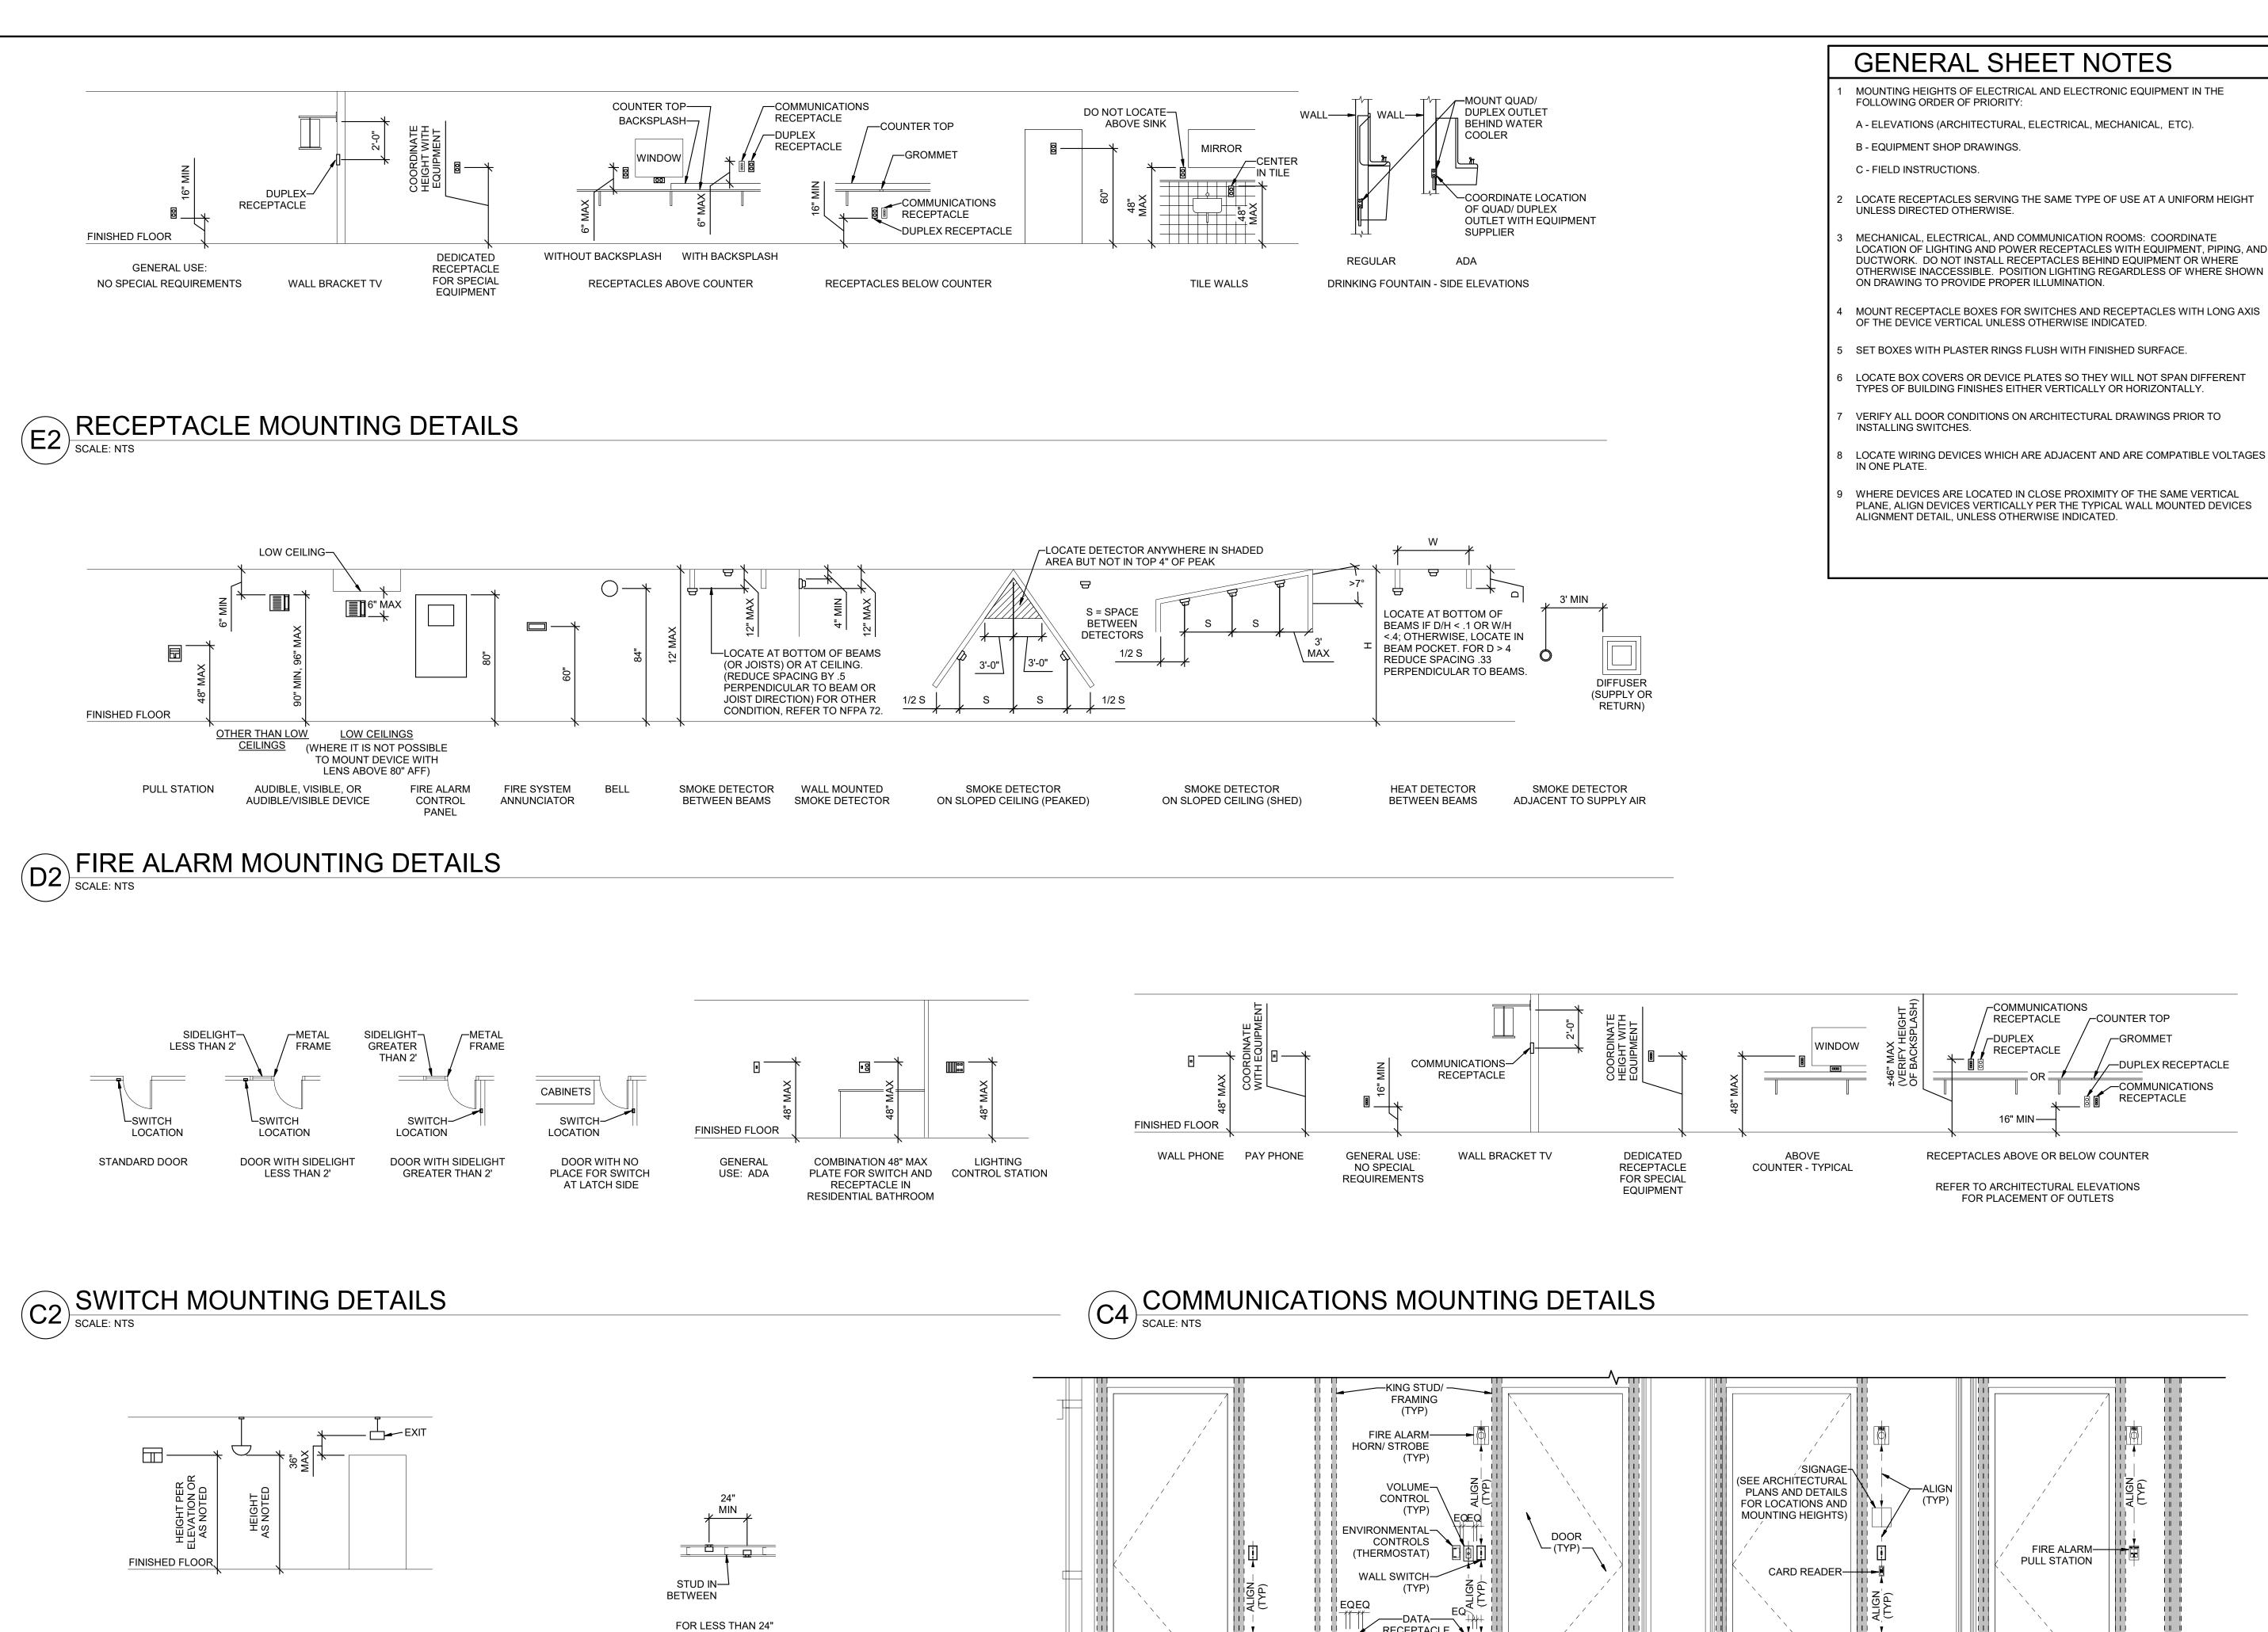

FINISHED

FLOOR

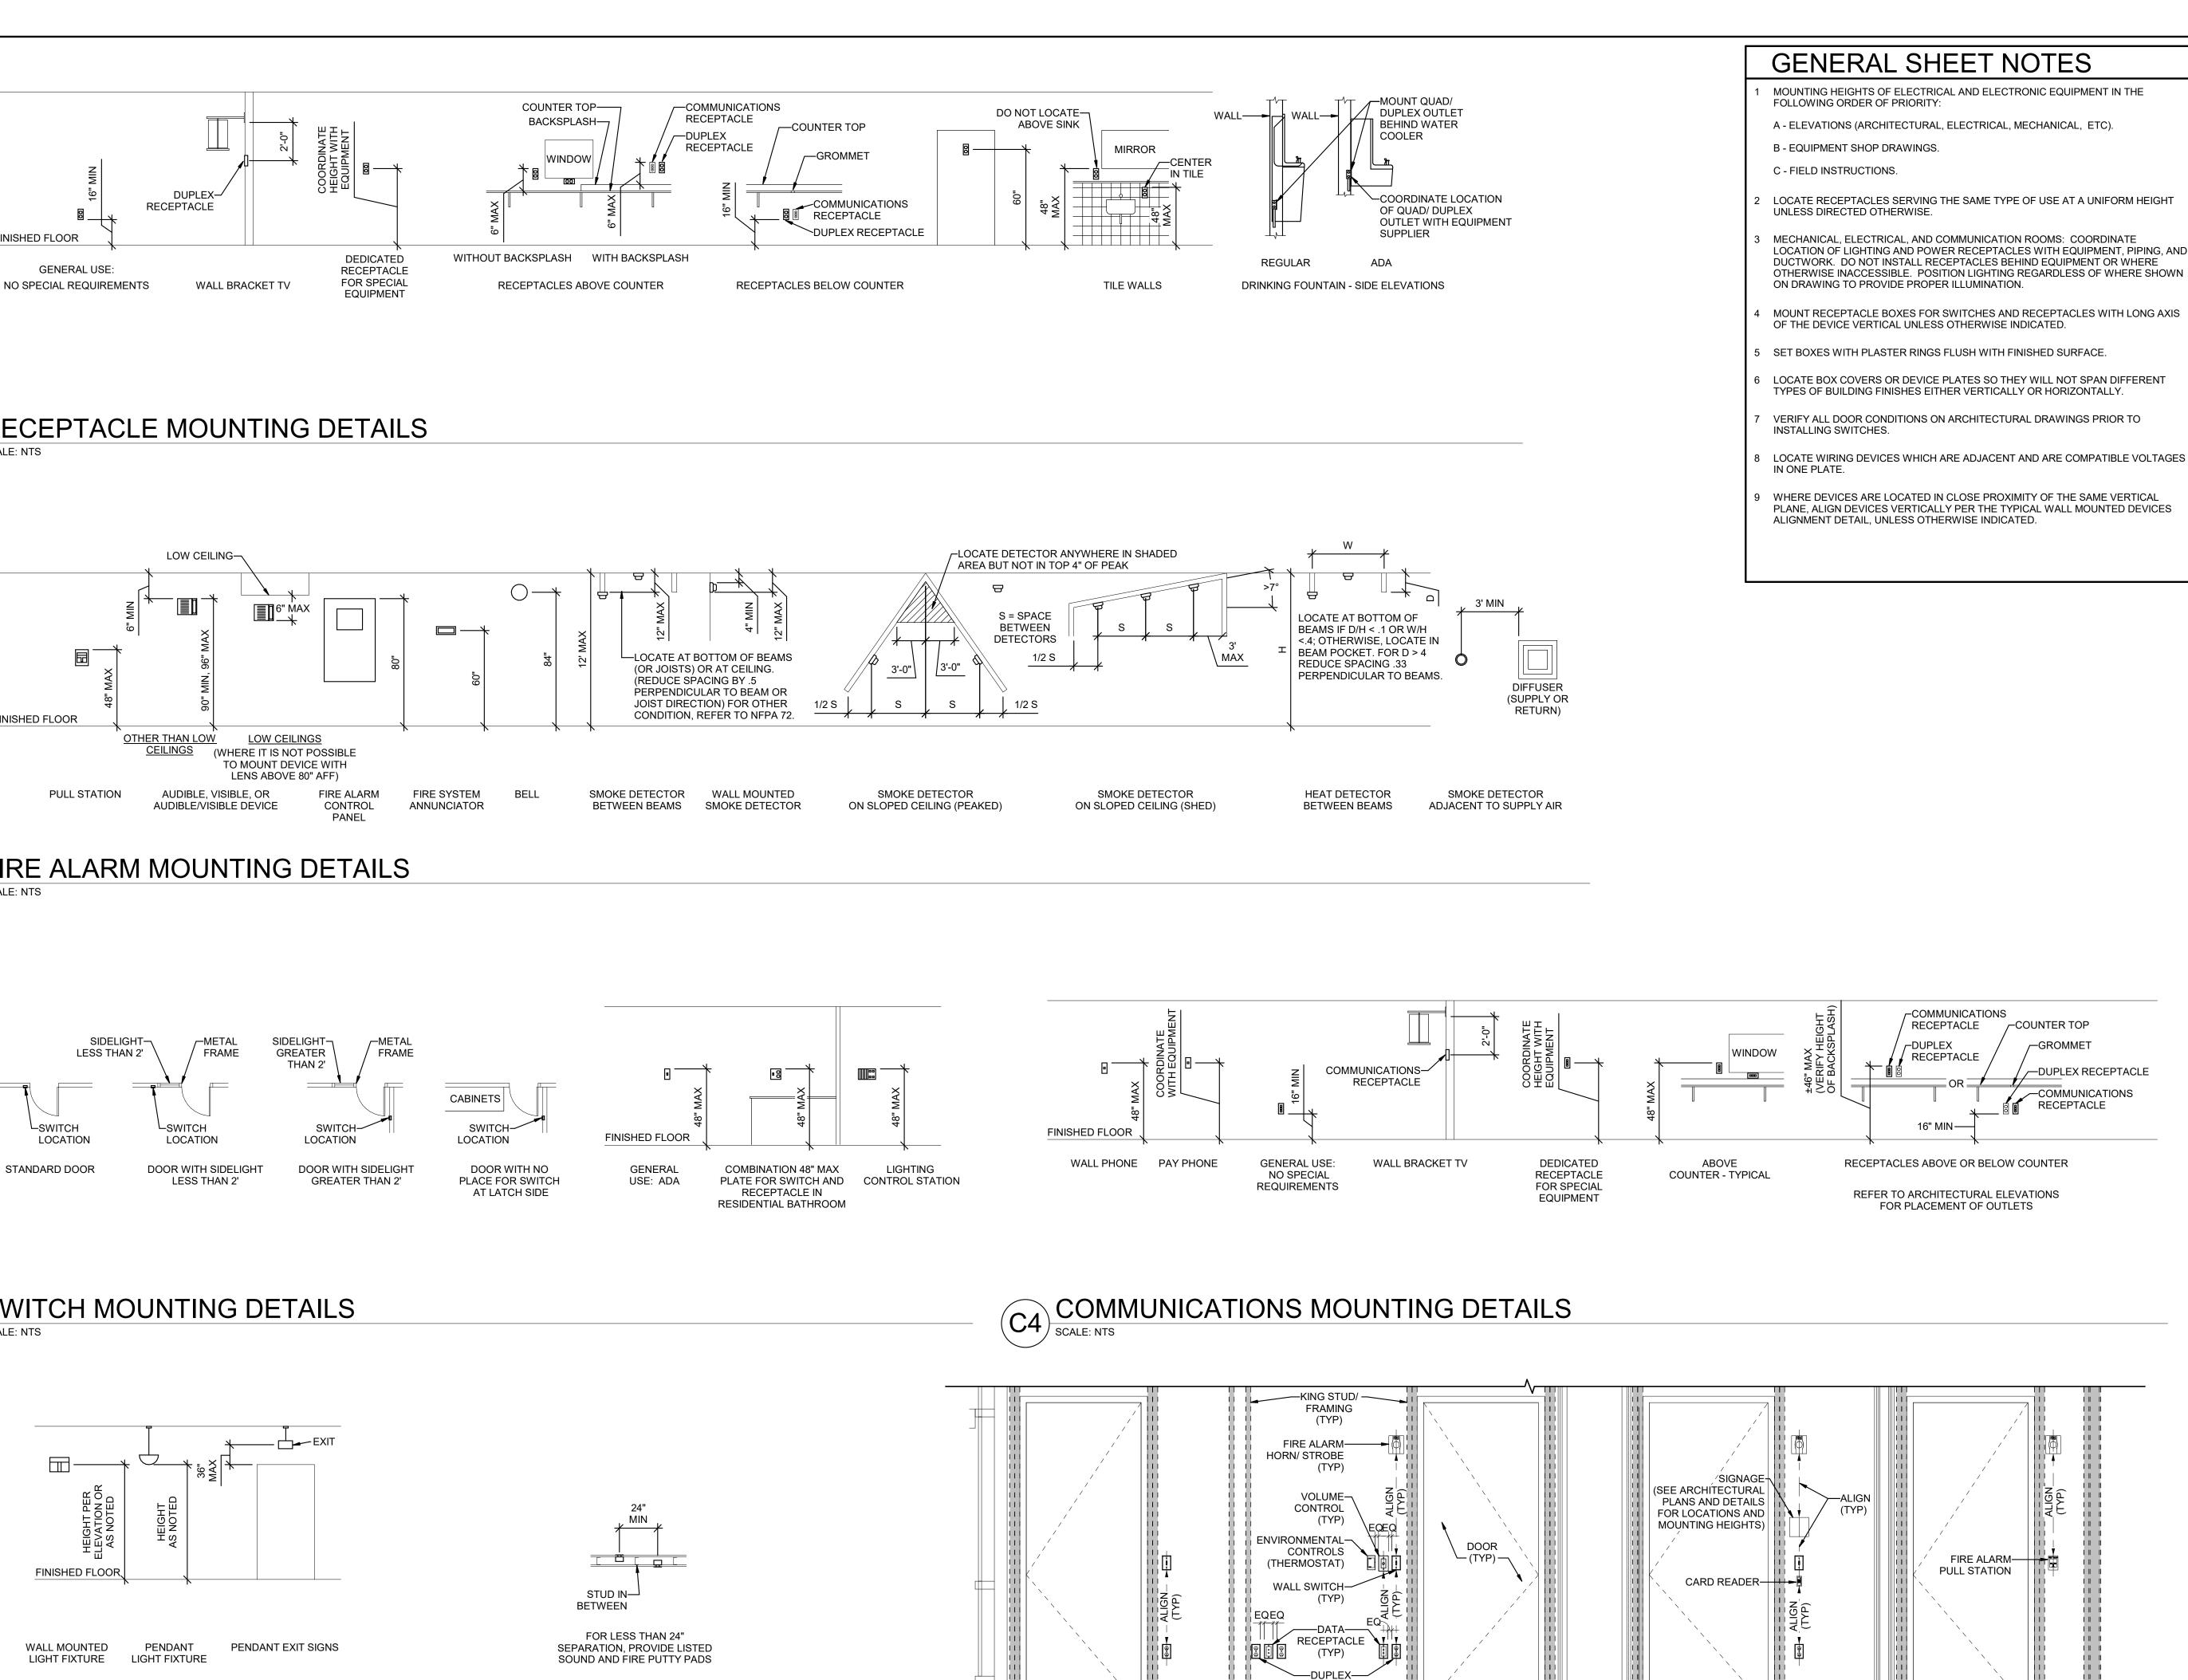

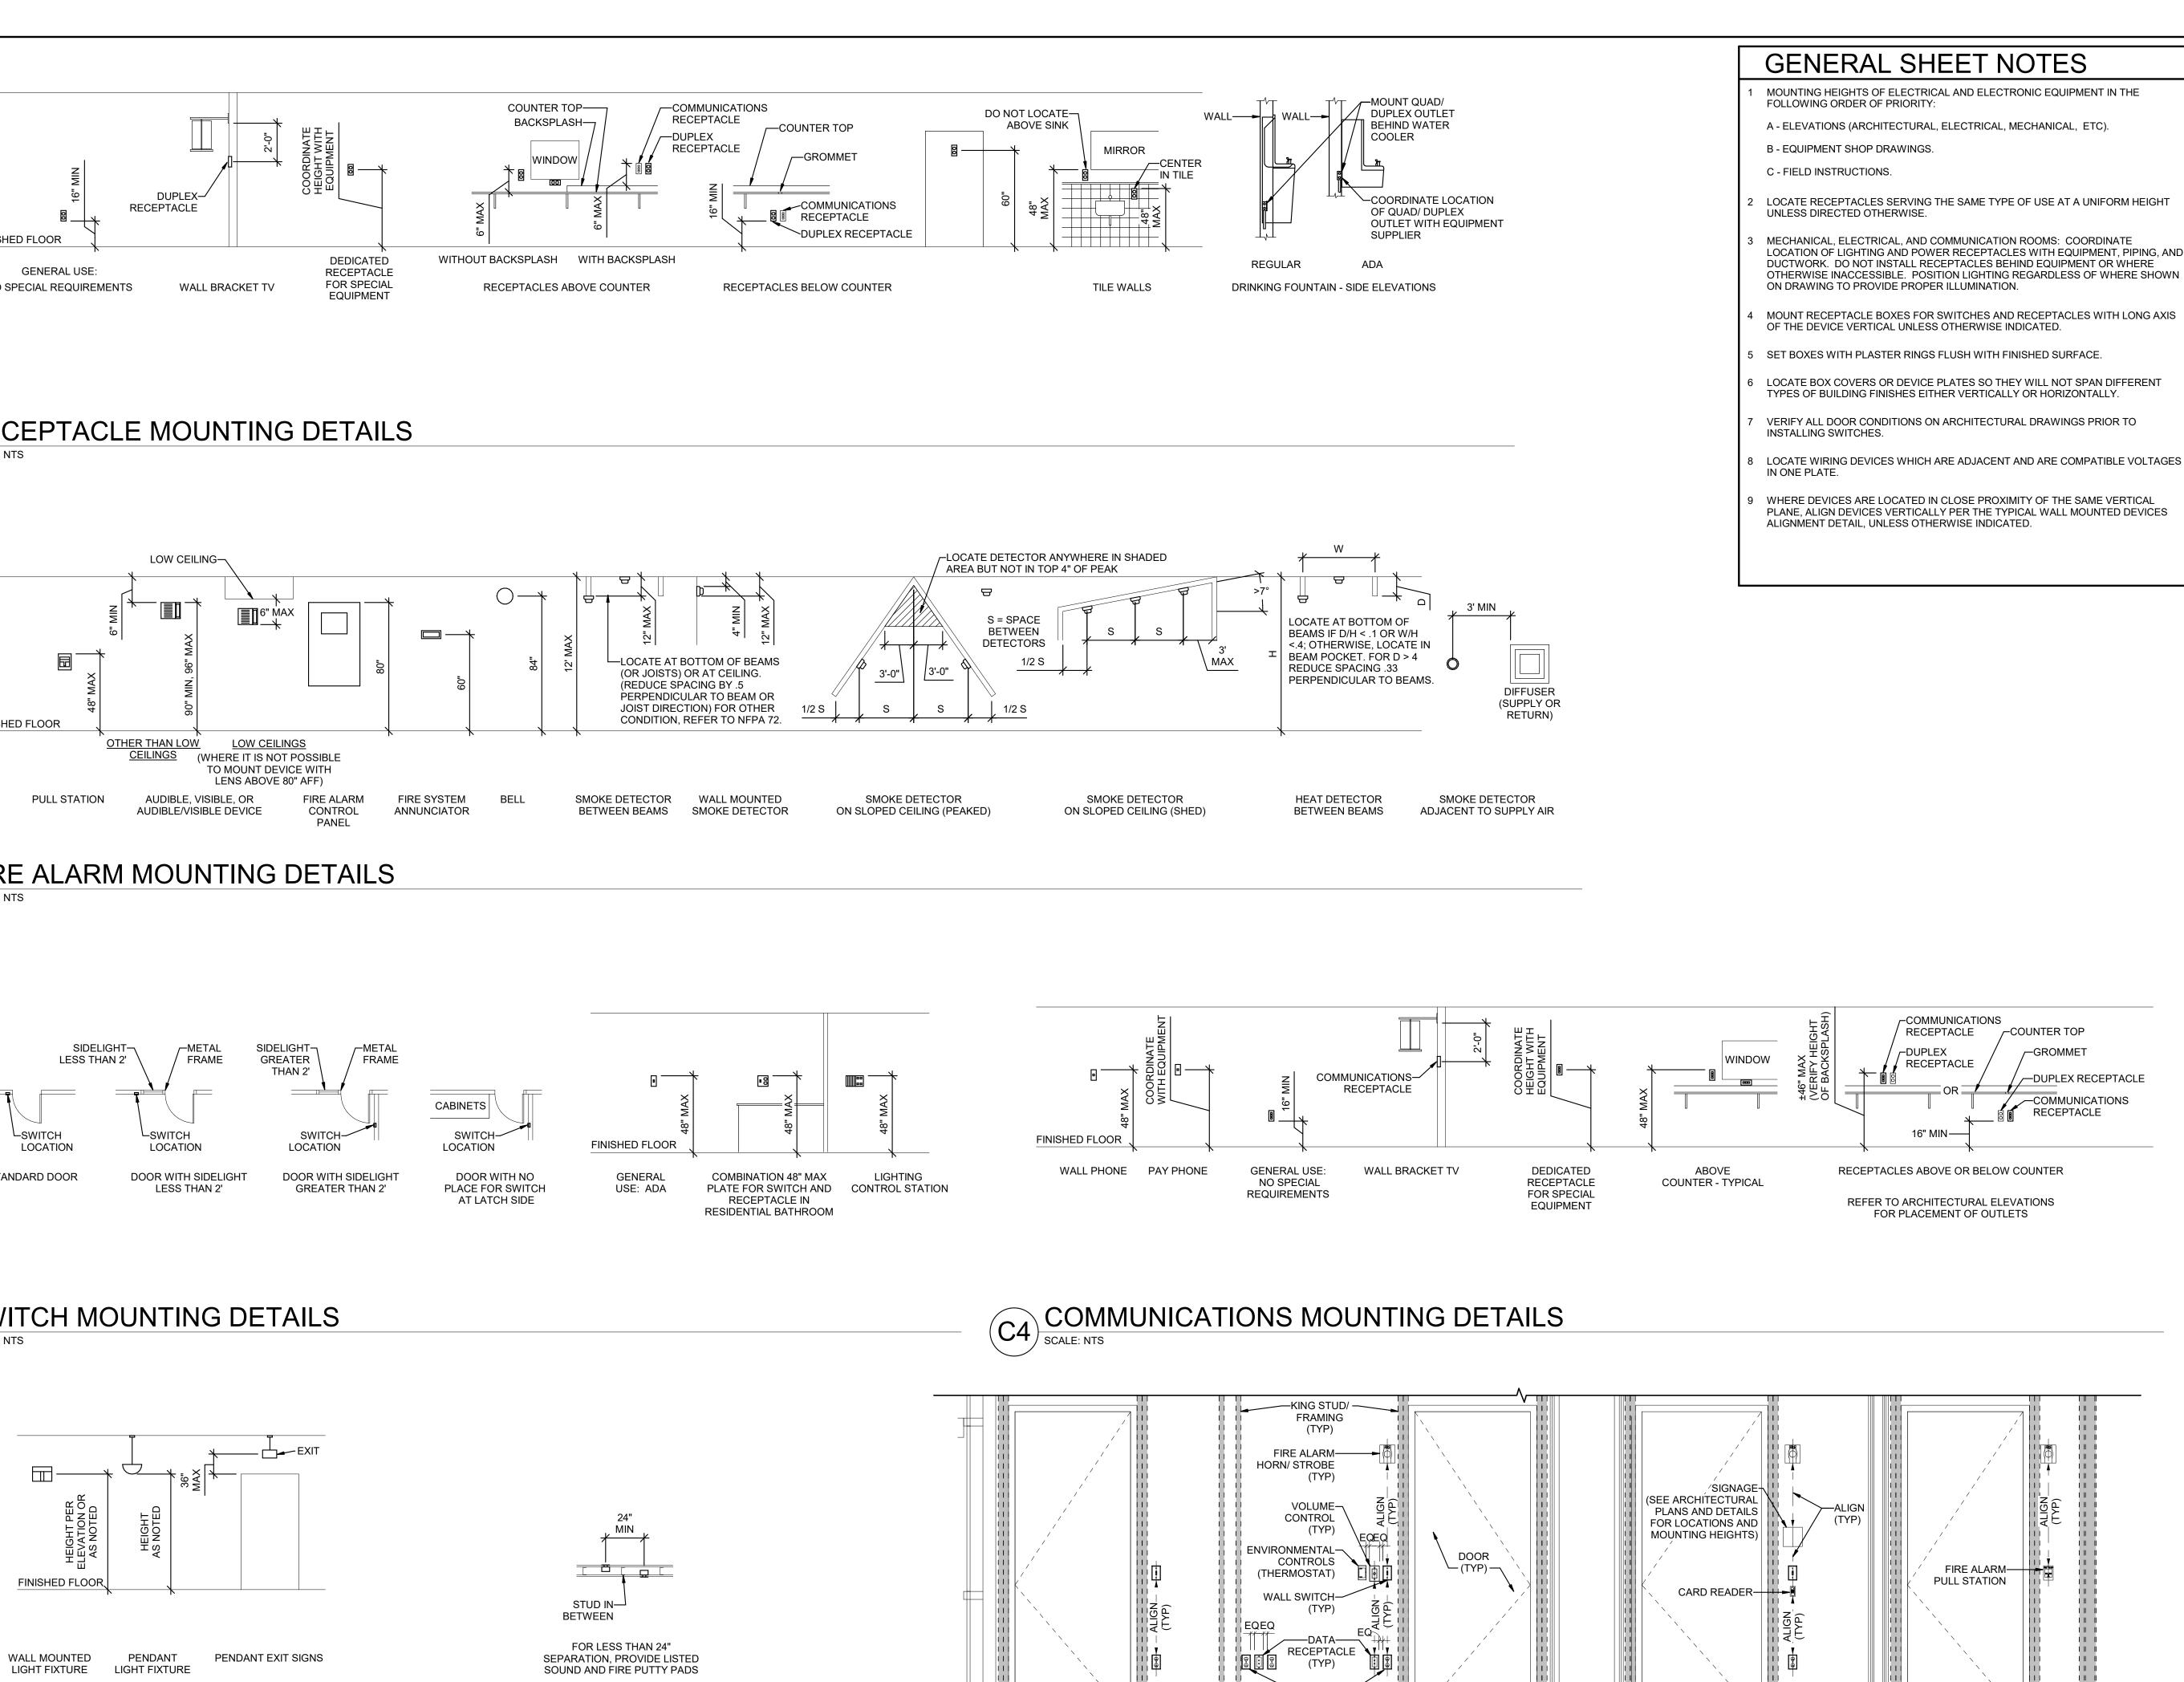



BOXES ON OPPOSITE SIDES OF WALL

(B3) BOX MOUNTING DETAILS SCALE: NTS

(B4) TYPICAL WALL MOUNTED DEVICES ALIGNMENT DETAIL

RECEPTACLE

(TYP)

© 2008 HKS, INC

FINISHED

FLOOR



ARCHITECT HKS ARCHITECTS, INC. 222 SOUTH MAIN, SUITE 230 SALT LAKE CITY, UT 84101

STRUCTURAL ENGINEER **REAVELEY ENGINEERS & ASSOCIATES** 675 EAST 500 SOUTH, SUITE 400 SALT LAKE CITY, UTAH 84102

MECHANICAL ENGINEER VAN BOERUM & FRANK ASSOCIATES, INC 181 EAST 5600 SOUTH, SUITE 130 MURRAY, UTAH 84107

ELECTRICAL ENGINEER SPECTRUM ENGINEERS, INC 324 SOUTH STATE STREET, SUITE 400 SALT LAKE CITY, UTAH 84111










KEY PLAN


REVISION NO. DESCRIPTION


DATE


HKS PROJECT NUMBER 26404.000 DATE 08/15/24 ISSUE CONSTRUCTION DRAWINGS SHEET TITLE TYPICAL MOUNTING DETAILS SHEET NO.

EE701

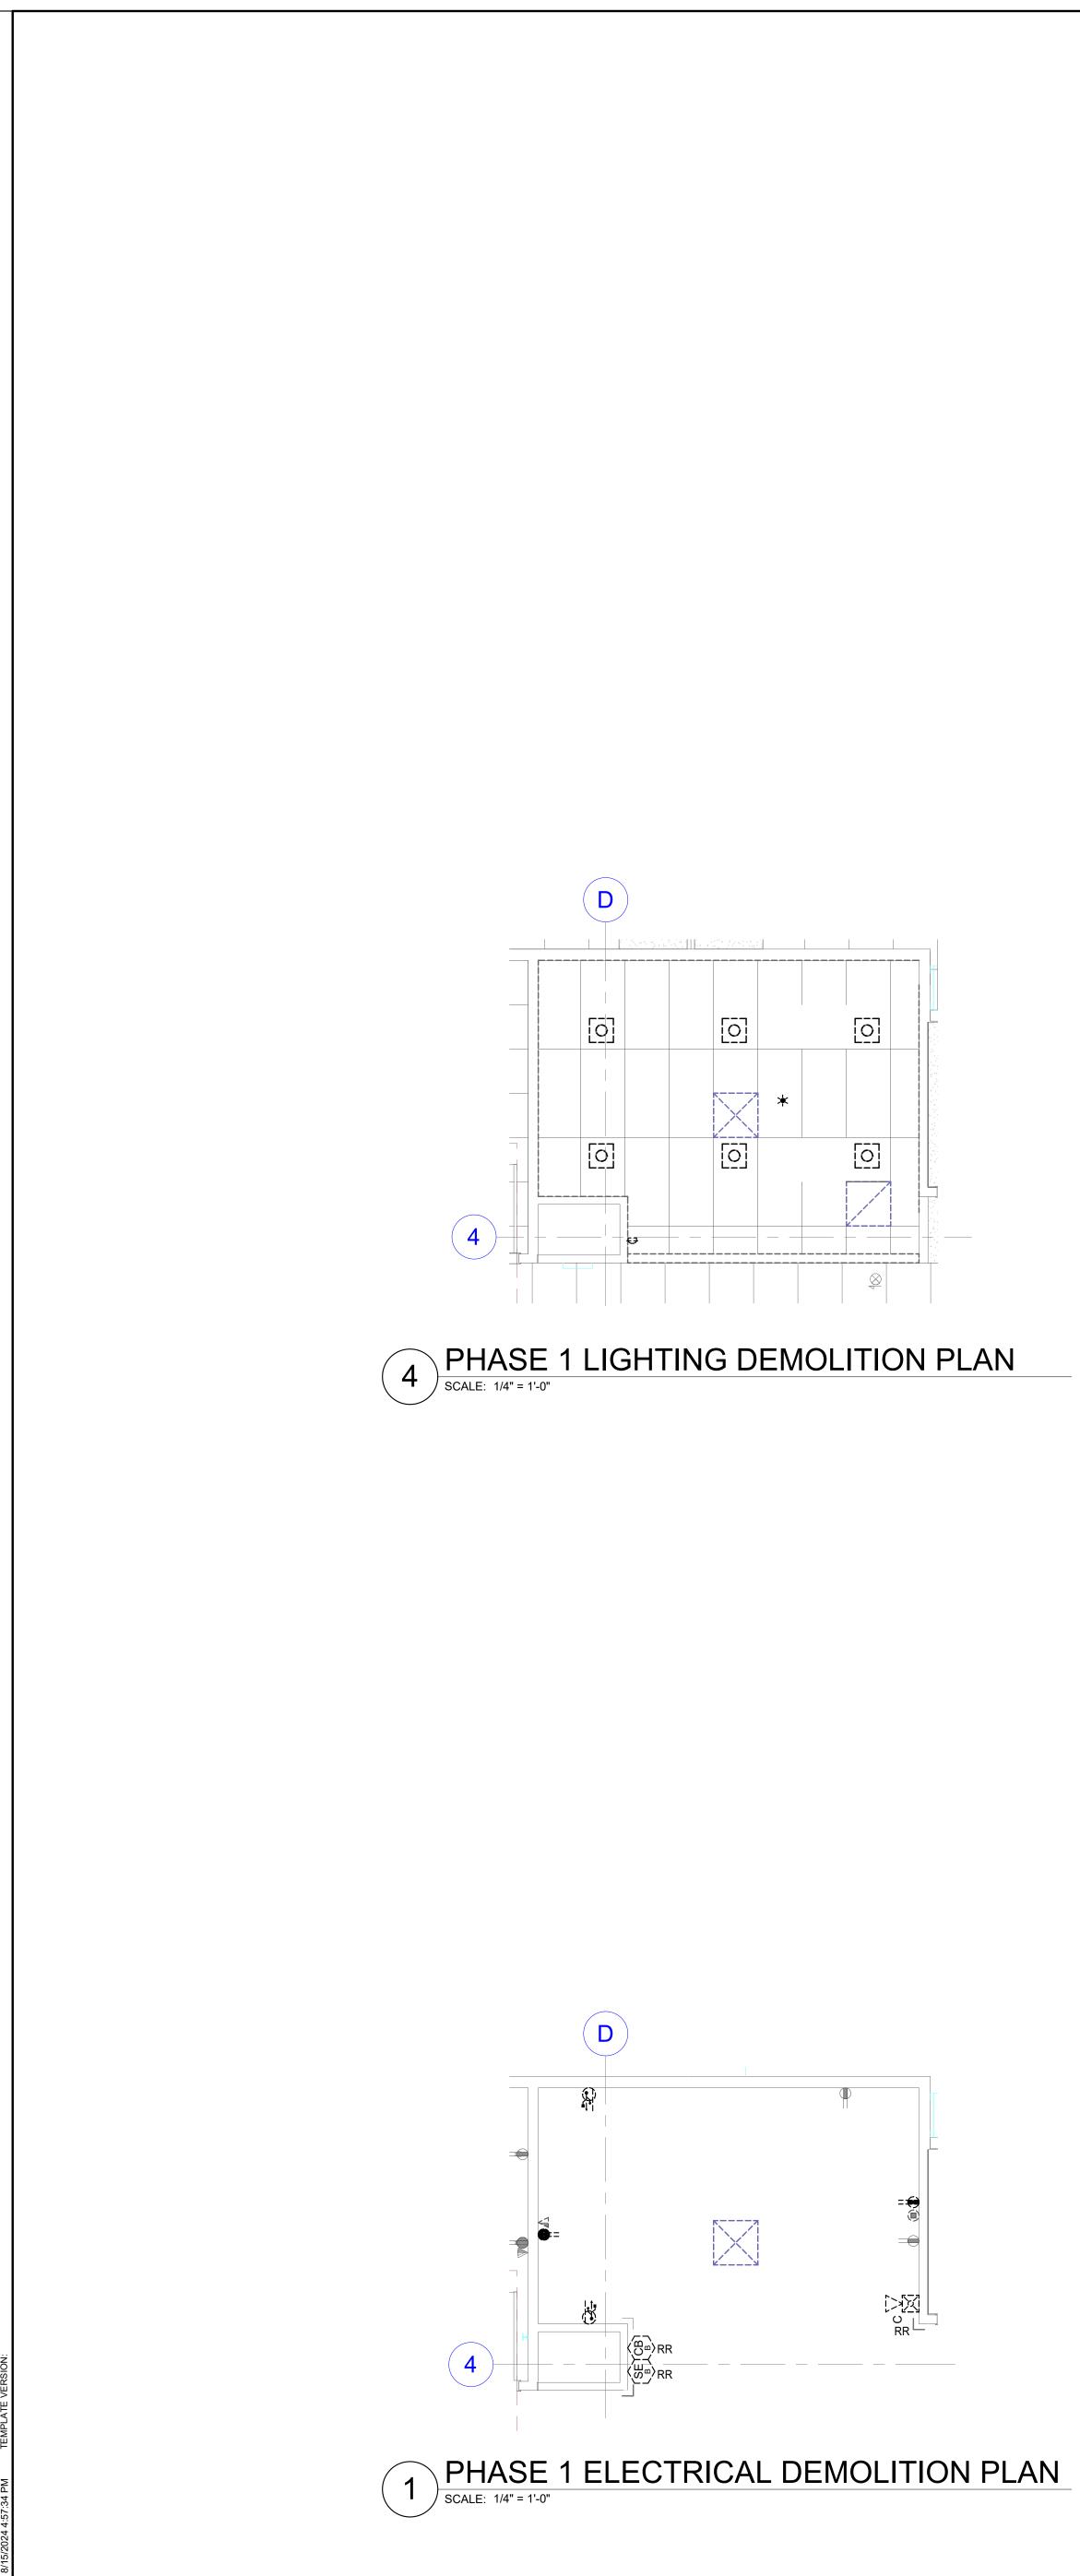

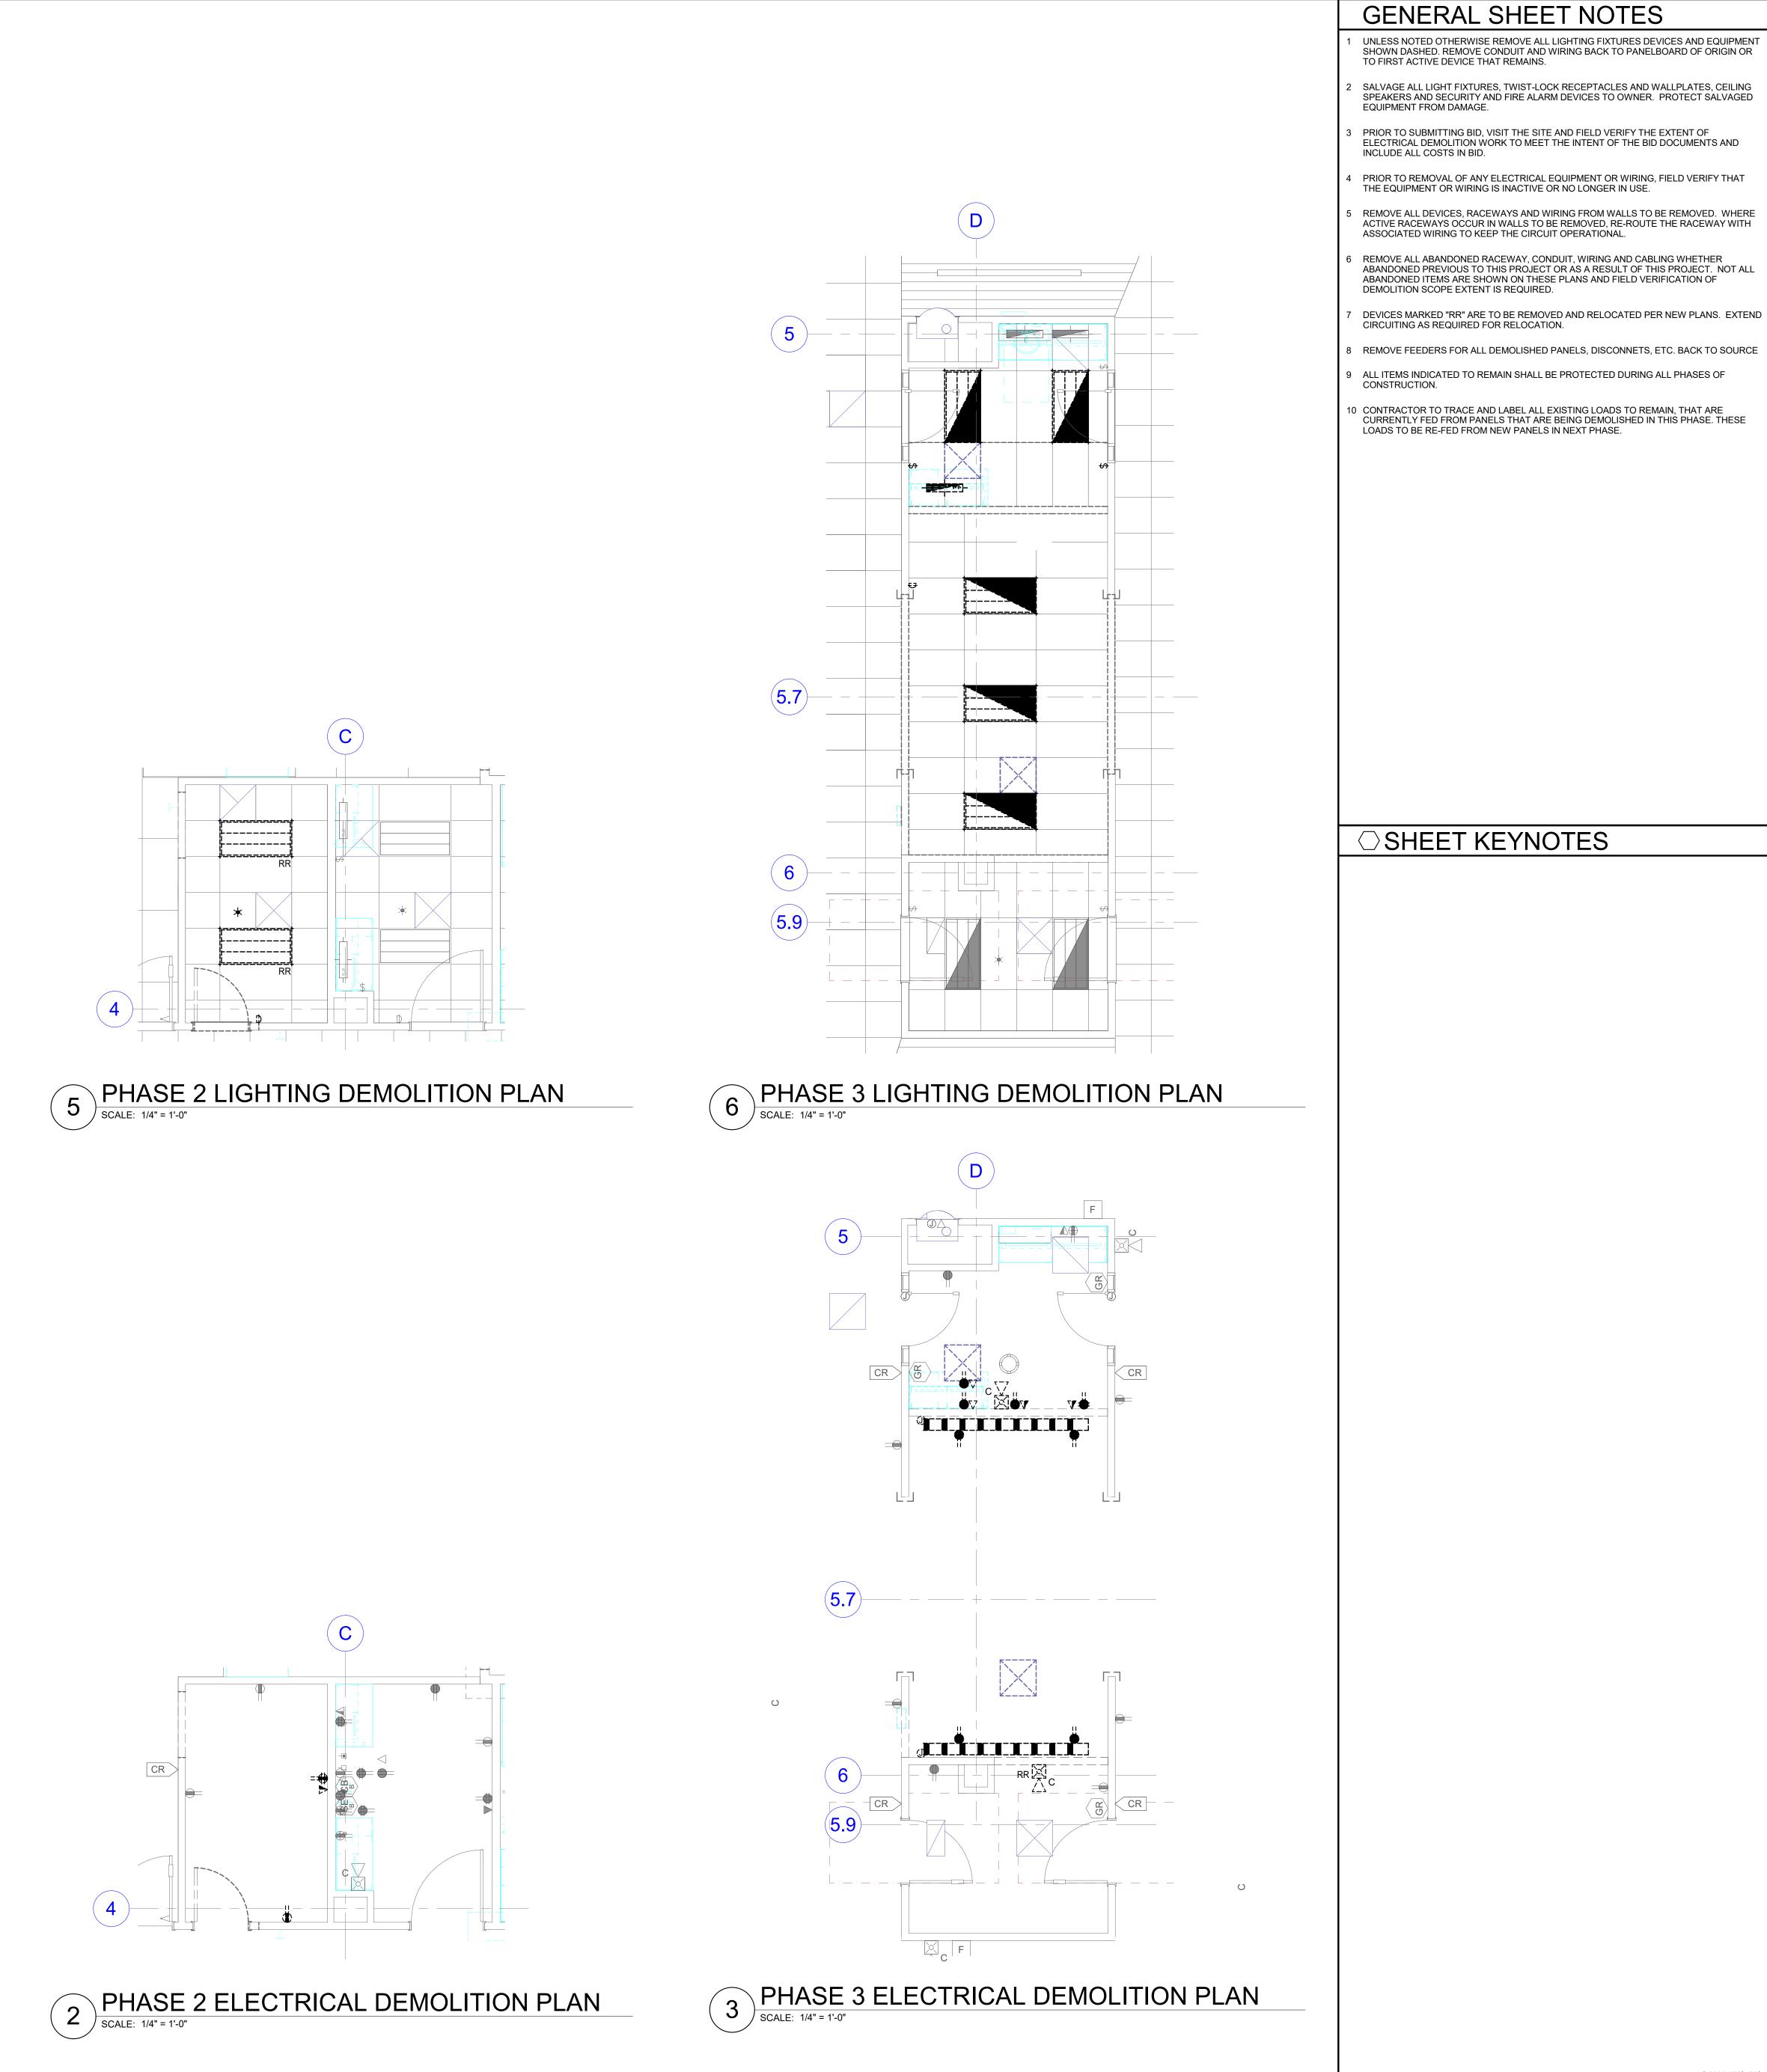

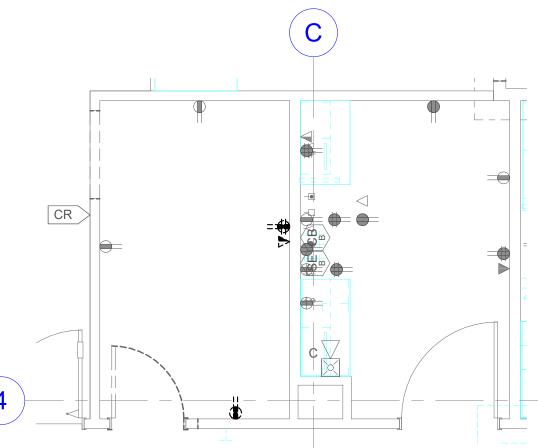

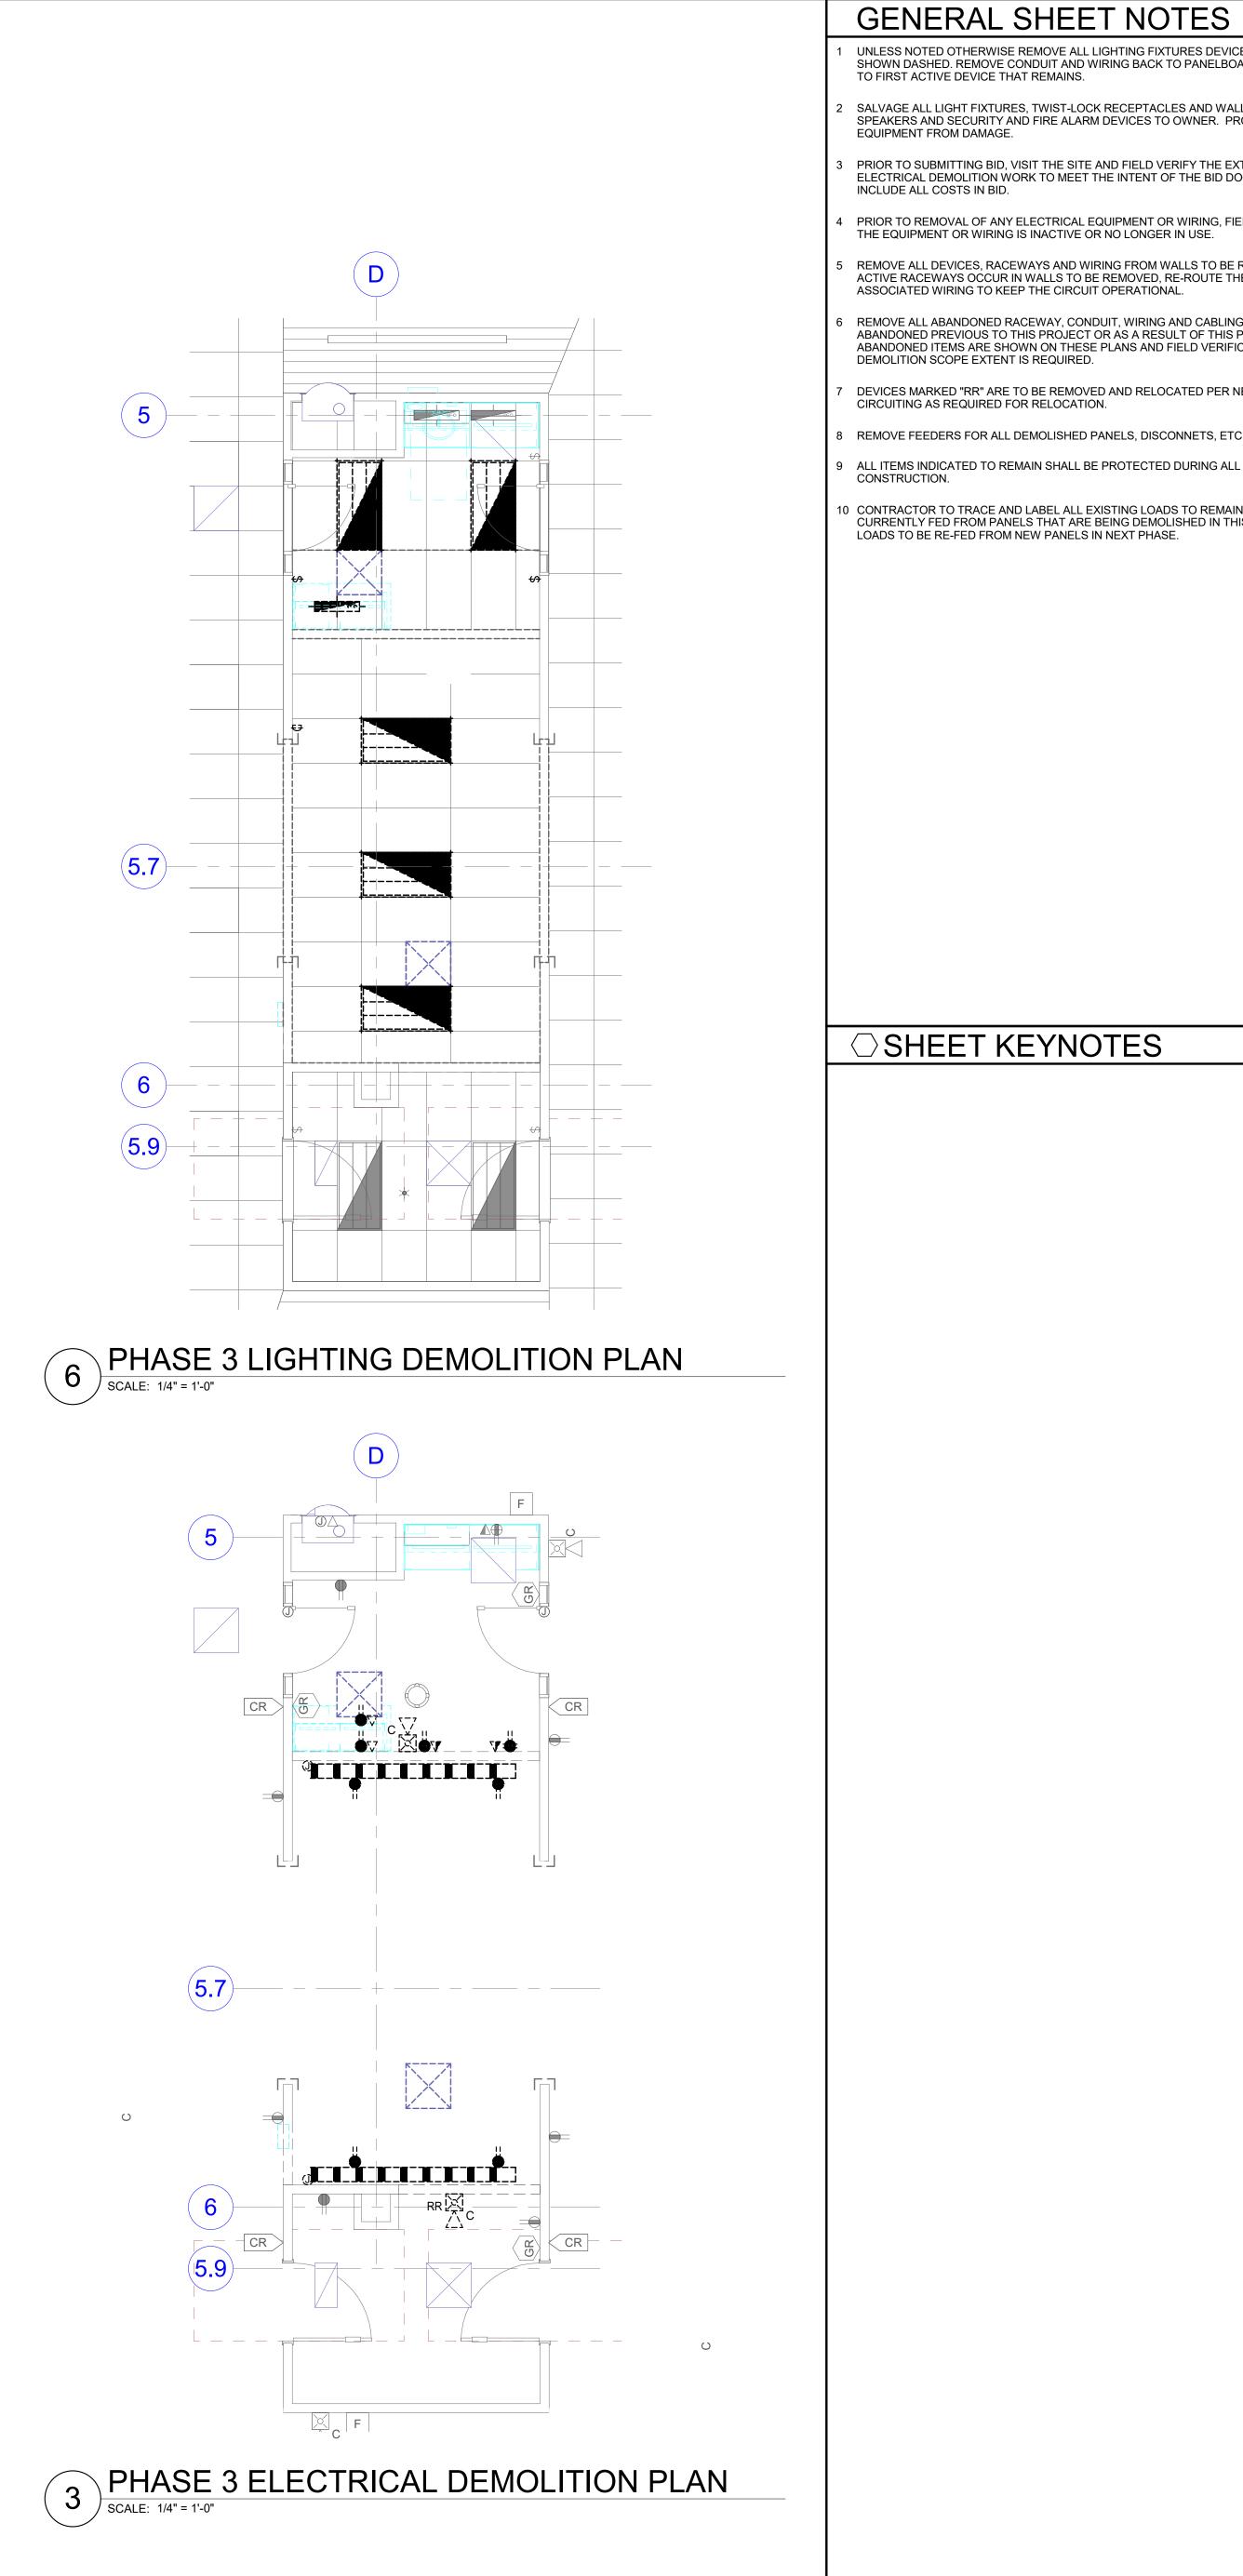



STRUCTURAL ENGINEER REAVELEY ENGINEERS & ASSOCIATES 675 EAST 500 SOUTH, SUITE 400 SALT LAKE CITY, UTAH 84102

MECHANICAL ENGINEER VAN BOERUM & FRANK ASSOCIATES, INC 181 EAST 5600 SOUTH, SUITE 130 MURRAY, UTAH 84107

ELECTRICAL ENGINEER SPECTRUM ENGINEERS, INC 324 SOUTH STATE STREET, SUITE 400 SALT LAKE CITY, UTAH 84111










KEY PLAN

REVISION NO. DESCRIPTION

DAT

HKS PROJECT NUMBER 26404.000 DATE 08/15/24 ISSUE CONSTRUCTION DRAWINGS SHEET TITLE ED LEVEL 1 DEMOLITION PLANS SHEET NO.

ED101

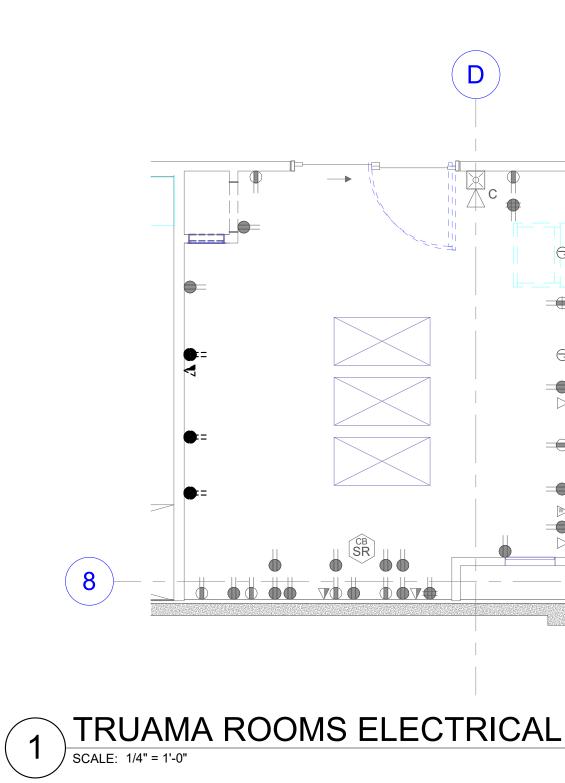

 GENERAL SHEET NOTES INLESS NOTED OTHERWISE REMOVE ALL LIGHTING FUTURES DEVICES AND EQUIPMENT SHOWN DASHED REMOVE CONDUIT AND WIRING BACK TO PANELBOARD OF ORIGIN OR TO FIRST ACTIVE DEVICE THAT REMAINS. SALVAGE ALL LIGHT FIXTURES, TWIST-LOCK RECEPTACLES AND WALLPLATES, CEILING SPEAKERS AND SECURITY AND FIRE ALARM DEVICES TO OWNER. PROTECT SALVAGED EQUIPMENT FROM DAMAGE. PRIOR TO SUBMITTING BID, VISIT THE SITE AND FIELD VERIFY THE EXTENT OF ELECTRICAL DEMOLITION WORK TO MEET THE INTENT OF THE BID DOCUMENTS AND INCLUDE ALL COSTS INN WORK TO MEET THE INTENT OF THE BID DOCUMENTS AND INCLUDE ALL COSTS INN BID. PRIOR TO REMOVAL OF ANY ELECTRICAL EQUIPMENT OR WIRING, FIELD VERIFY THAT THE EQUIPMENT OR WIRING IS INACTIVE OR NO LONGER IN USE. REMOVE ALL DEVICES, RACEWAYS AND WIRING FROM WALLS TO BE REMOVED. WHERE ACTIVE RACEWAYS OCCUR IN WALLS TO BE REMOVED. RE-ROUTE THE RACEWAY WITH ASSOCIATED WIRING TO KEEP THE CIRCUIT OPERATIONAL. REMOVE ALL ABANDONED RACEWAY, CONDUIT, WIRING AND CABLING WHETHER ABANDONED PREVIOUS TO THIS PROJECT OR AS A RESULT OF THIS PROJECT. NOT ALL ABANDONED PREVIOUS TO THIS PROJECT OR AS A RESULT OF THIS PROJECT. NOT ALL ABANDONED PREVIOUS TO THIS PROJUCT ON AS A RESULT OF THIS PROJECT. NOT ALL ABANDONED TREMARED "RR" ARE TO BE REMOVED AND FIELD VERIFICATION OF DEMOLITION SCOPE EXTENT IS REQUIRED. DEVICES MARKED "RR" ARE TO BE REMOVED AND RELOCATED PER NEW PLANS. EXTEND CIRCUITING AS REQUIRED FOR RELOCATION. REMOVE FEEDERS FOR ALL DEMOLISHED PANELS, DISCONNETS, ETC. BACK TO SOURCE ALL ITEMS INDICATED TO REMAIN SHALL BE PROTECTED DURING ALL PHASES OF CONSTRUCTION. CONTRACTOR TO TRACE AND LABEL ALL EXISTING LOADS TO REMAIN, THAT ARE CURRENTLY FED FROM NEW PANELS IN NEXT PHASE.
○SHEET KEYNOTES
© 2008 HKS, INC
© 2008 HKS, INC

AND EQUIPMENT D OF ORIGIN OR

V PLANS. EXTEND BACK TO SOURCE



ARCHITECT HKS ARCHITECTS, INC. 222 SOUTH MAIN, SUITE 230 SALT LAKE CITY, UT 84101

STRUCTURAL ENGINEER REAVELEY ENGINEERS & ASSOCIATES 675 EAST 500 SOUTH, SUITE 400 SALT LAKE CITY, UTAH 84102

MECHANICAL ENGINEER VAN BOERUM & FRANK ASSOCIATES, INC 181 EAST 5600 SOUTH, SUITE 130 MURRAY, UTAH 84107

ELECTRICAL ENGINEER SPECTRUM ENGINEERS, INC 324 SOUTH STATE STREET, SUITE 400 SALT LAKE CITY, UTAH 84111











KEY PLAN

REVISION NO. DESCRIPTION DATE

HKS PROJECT NUMBER 26404.000 DATE 08/15/24 ISSUE CONSTRUCTION DRAWINGS SHEET TITLE ED TRUAMA ROOMS ELECTRICAL **DEMOLITION PLAN**

ED102

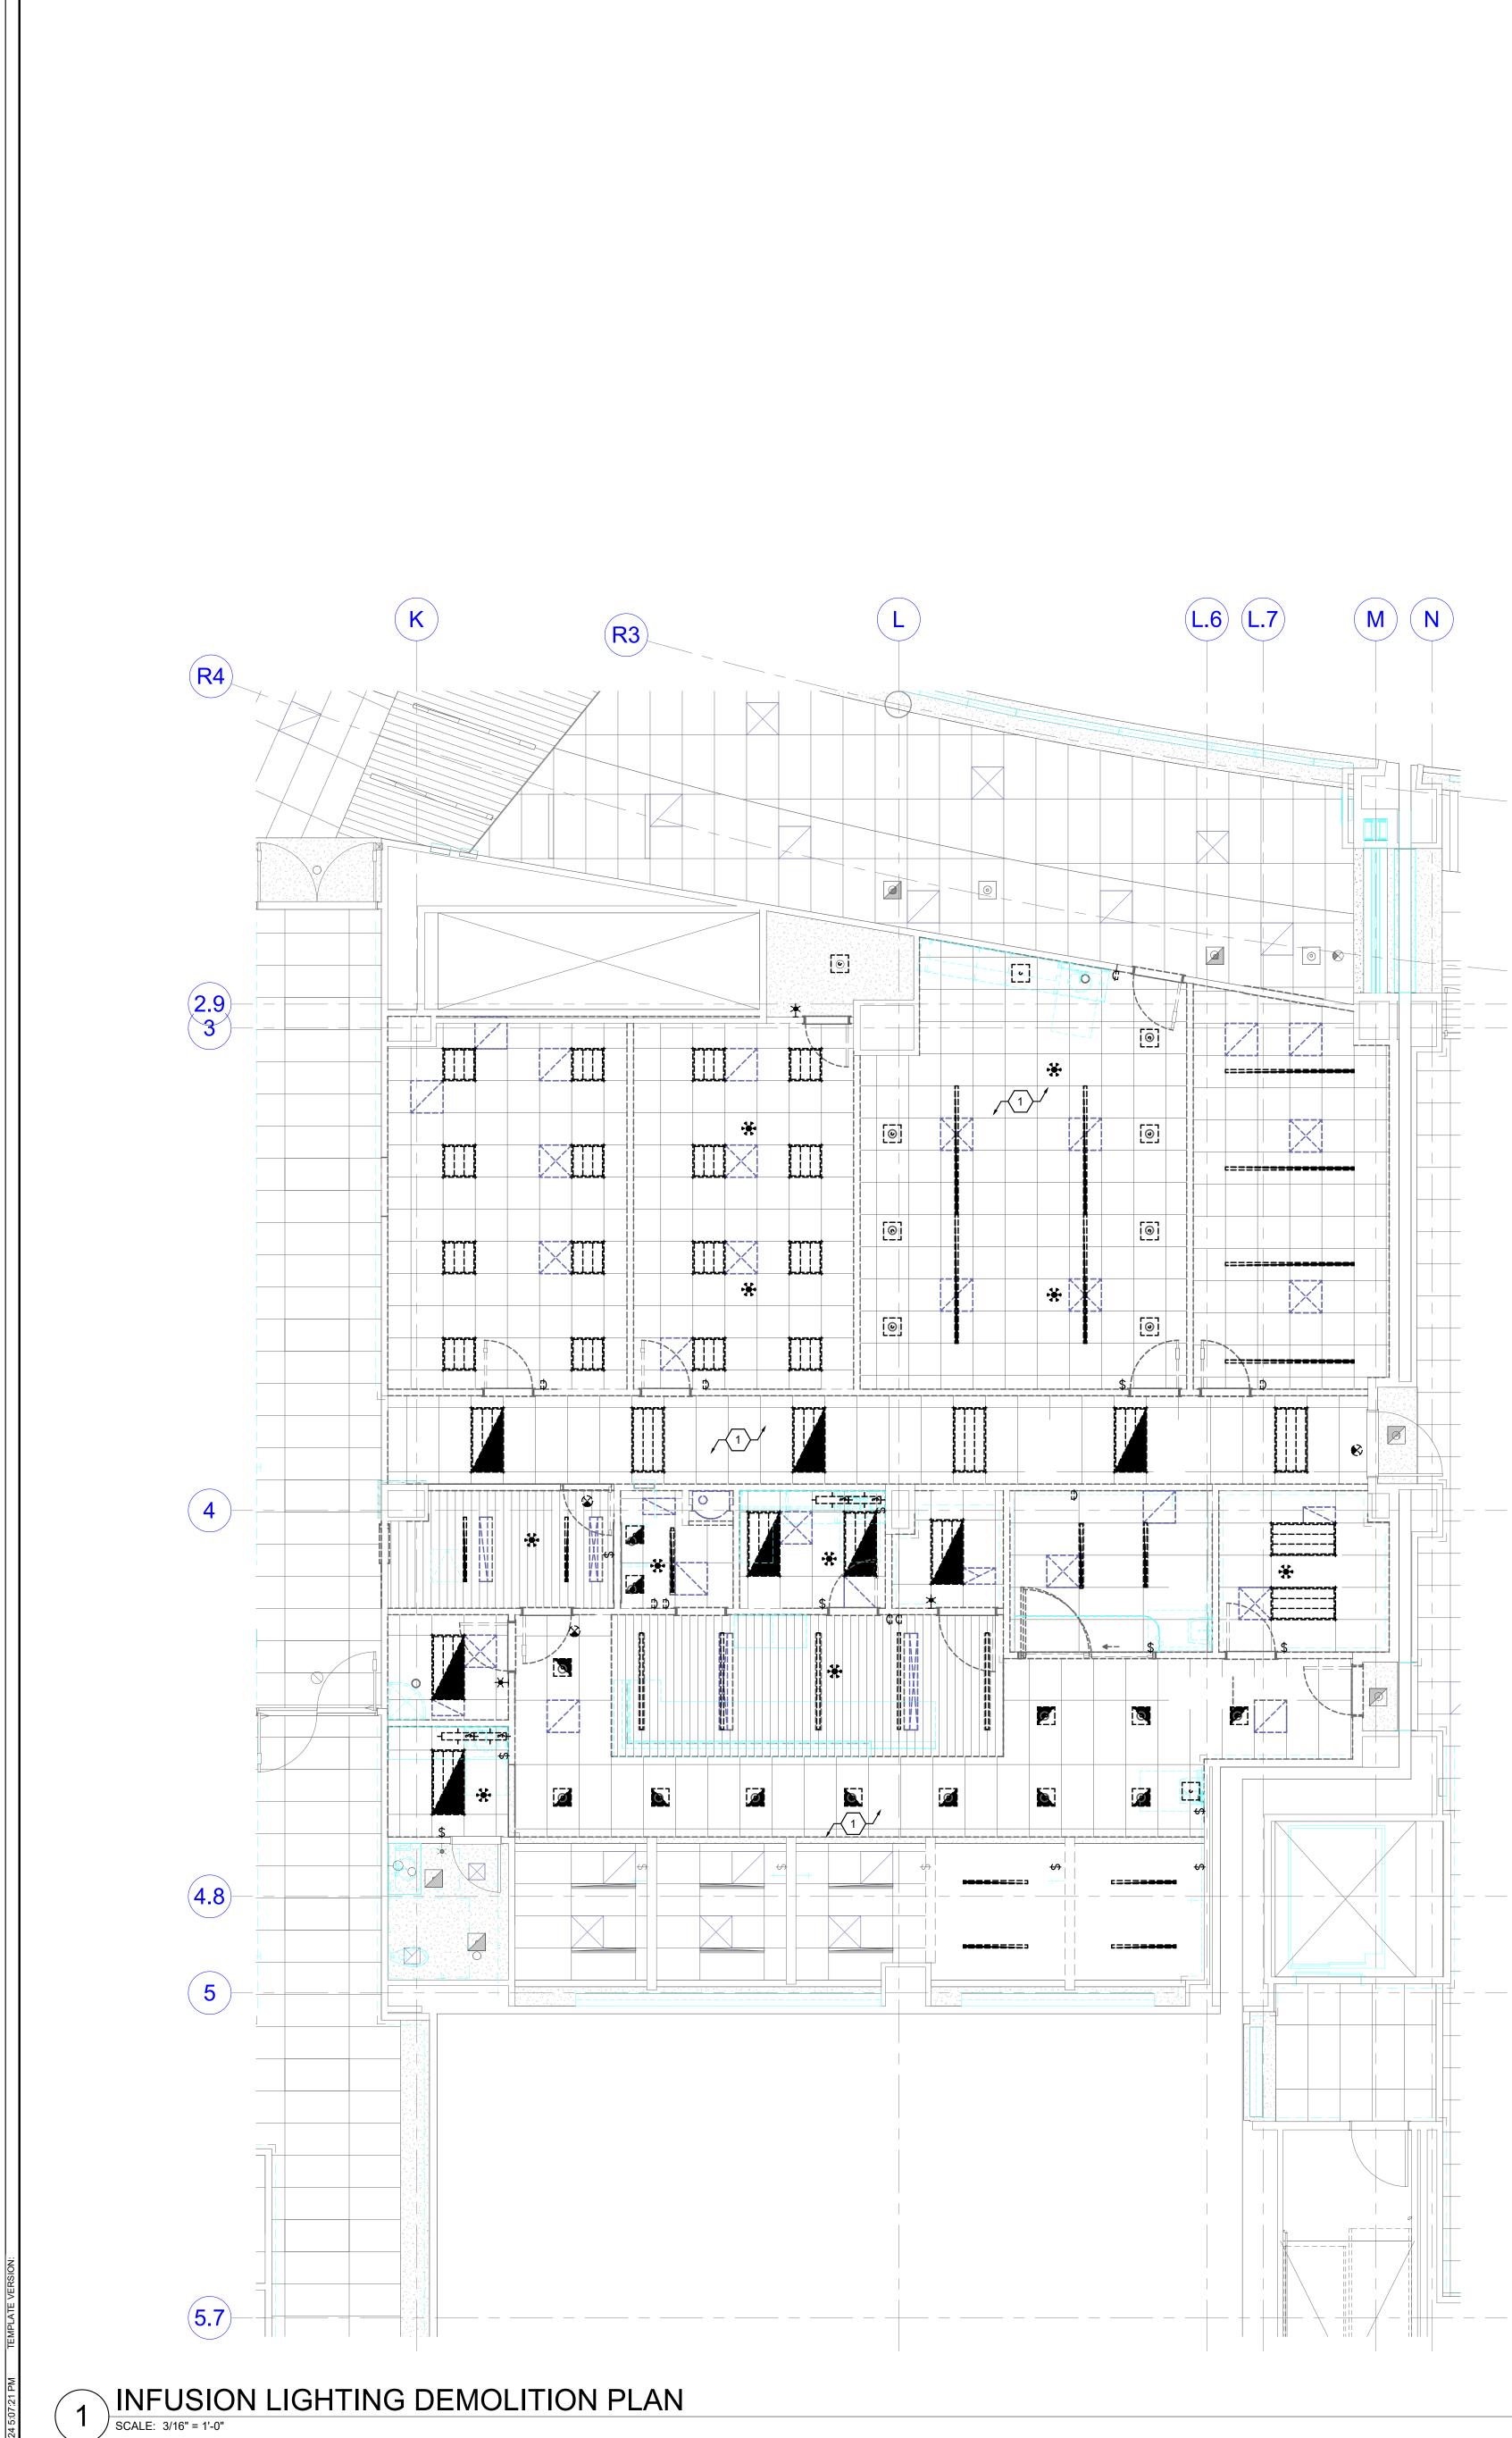

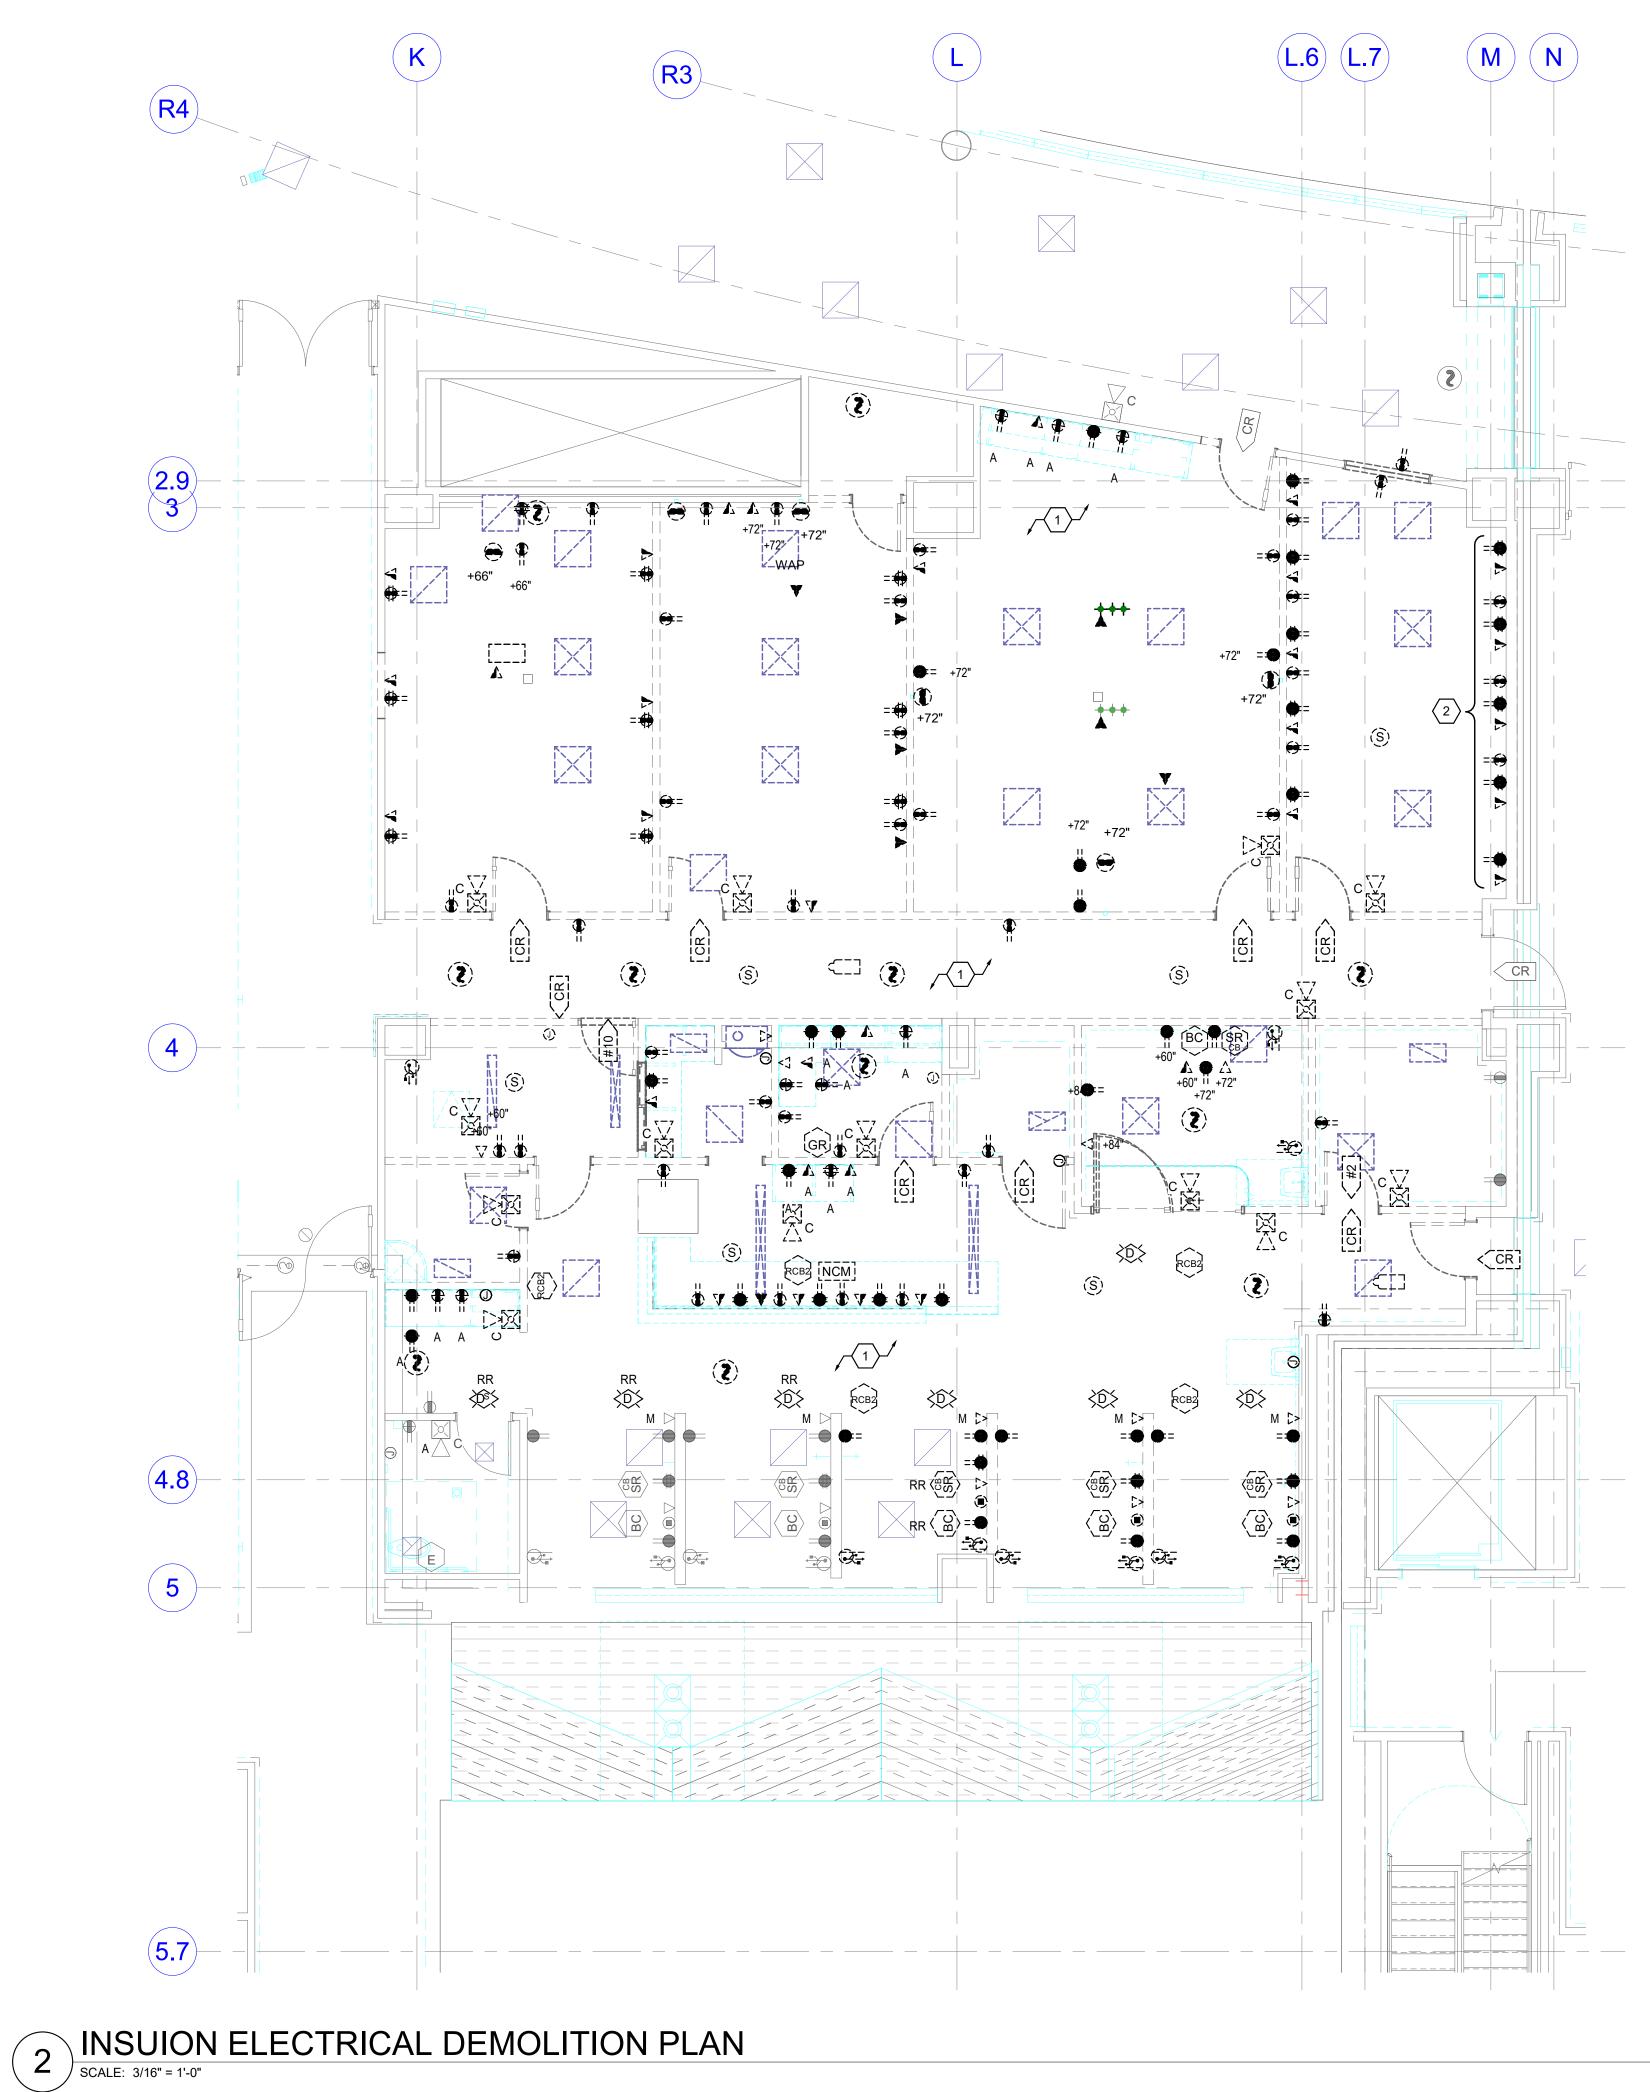

○SHEET KEYNOTES	GENERAL SHEET NOTES
1 REFER TO ARCHITECTUAL PHASING PLAN FOR CONSTRUCITON PHASING IN THIS AREA.	1 UNLESS NOTED OTHERWISE REMOVE ALL LIGHTING FIXTURES DEVICES AND EQUIPMENT SHOWN DASHED. REMOVE CONDUIT AND WIRING BACK TO PANELBOARD OF ORIGIN OR TO FIRST ACTIVE DEVICE THAT REMAINS.
2 DEMOLISH THE CABLING AND PROVIDE A COVER PLATE. LEAVE THE EXISTING JBOX AND RACEWAY TO MAINTAIN THE FIRE RATING.	2 SALVAGE ALL LIGHT FIXTURES, TWIST-LOCK RECEPTACLES AND WALLPLATES, CEILING SPEAKERS AND SECURITY AND FIRE ALARM DEVICES TO OWNER. PROTECT SALVAGED EQUIPMENT FROM DAMAGE.
	3 PRIOR TO SUBMITTING BID, VISIT THE SITE AND FIELD VERIFY THE EXTENT OF ELECTRICAL DEMOLITION WORK TO MEET THE INTENT OF THE BID DOCUMENTS AND INCLUDE ALL COSTS IN BID.
	4 PRIOR TO REMOVAL OF ANY ELECTRICAL EQUIPMENT OR WIRING, FIELD VERIFY THAT THE EQUIPMENT OR WIRING IS INACTIVE OR NO LONGER IN USE.
	5 REMOVE ALL DEVICES, RACEWAYS AND WIRING FROM WALLS TO BE REMOVED. WHERE ACTIVE RACEWAYS OCCUR IN WALLS TO BE REMOVED, RE-ROUTE THE RACEWAY WITH ASSOCIATED WIRING TO KEEP THE CIRCUIT OPERATIONAL.
	6 REMOVE ALL ABANDONED RACEWAY, CONDUIT, WIRING AND CABLING WHETHER ABANDONED PREVIOUS TO THIS PROJECT OR AS A RESULT OF THIS PROJECT. NOT ALL ABANDONED ITEMS ARE SHOWN ON THESE PLANS AND FIELD VERIFICATION OF DEMOLITION SCOPE EXTENT IS REQUIRED.
	7 DEVICES MARKED "RR" ARE TO BE REMOVED AND RELOCATED PER NEW PLANS. EXTEND CIRCUITING AS REQUIRED FOR RELOCATION.
	8 REMOVE FEEDERS FOR ALL DEMOLISHED PANELS, DISCONNETS, ETC. BACK TO SOURCE
	9 ALL ITEMS INDICATED TO REMAIN SHALL BE PROTECTED DURING ALL PHASES OF CONSTRUCTION.
	10 CONTRACTOR TO TRACE AND LABEL ALL EXISTING LOADS TO REMAIN, THAT ARE CURRENTLY FED FROM PANELS THAT ARE BEING DEMOLISHED IN THIS PHASE. THESE LOADS TO BE RE-FED FROM NEW PANELS IN NEXT PHASE.



ARCHITECT HKS ARCHITECTS, INC. 222 SOUTH MAIN, SUITE 230 SALT LAKE CITY, UT 84101

STRUCTURAL ENGINEER **REAVELEY ENGINEERS & ASSOCIATES** 675 EAST 500 SOUTH, SUITE 400 SALT LAKE CITY, UTAH 84102

MECHANICAL ENGINEER VAN BOERUM & FRANK ASSOCIATES, INC 181 EAST 5600 SOUTH, SUITE 130 MURRAY, UTAH 84107

ELECTRICAL ENGINEER SPECTRUM ENGINEERS, INC 324 SOUTH STATE STREET, SUITE 400 SALT LAKE CITY, UTAH 84111










KEY PLAN


REVISION NO. DESCRIPTION

HKS PROJECT NUMBER


26404.000 DATE 08/15/24 ISSUE CONSTRUCTION DRAWINGS SHEET TITLE INFUSION ELECTRICAL **DEMOLITION PLAN** SHEET NO.

ED103

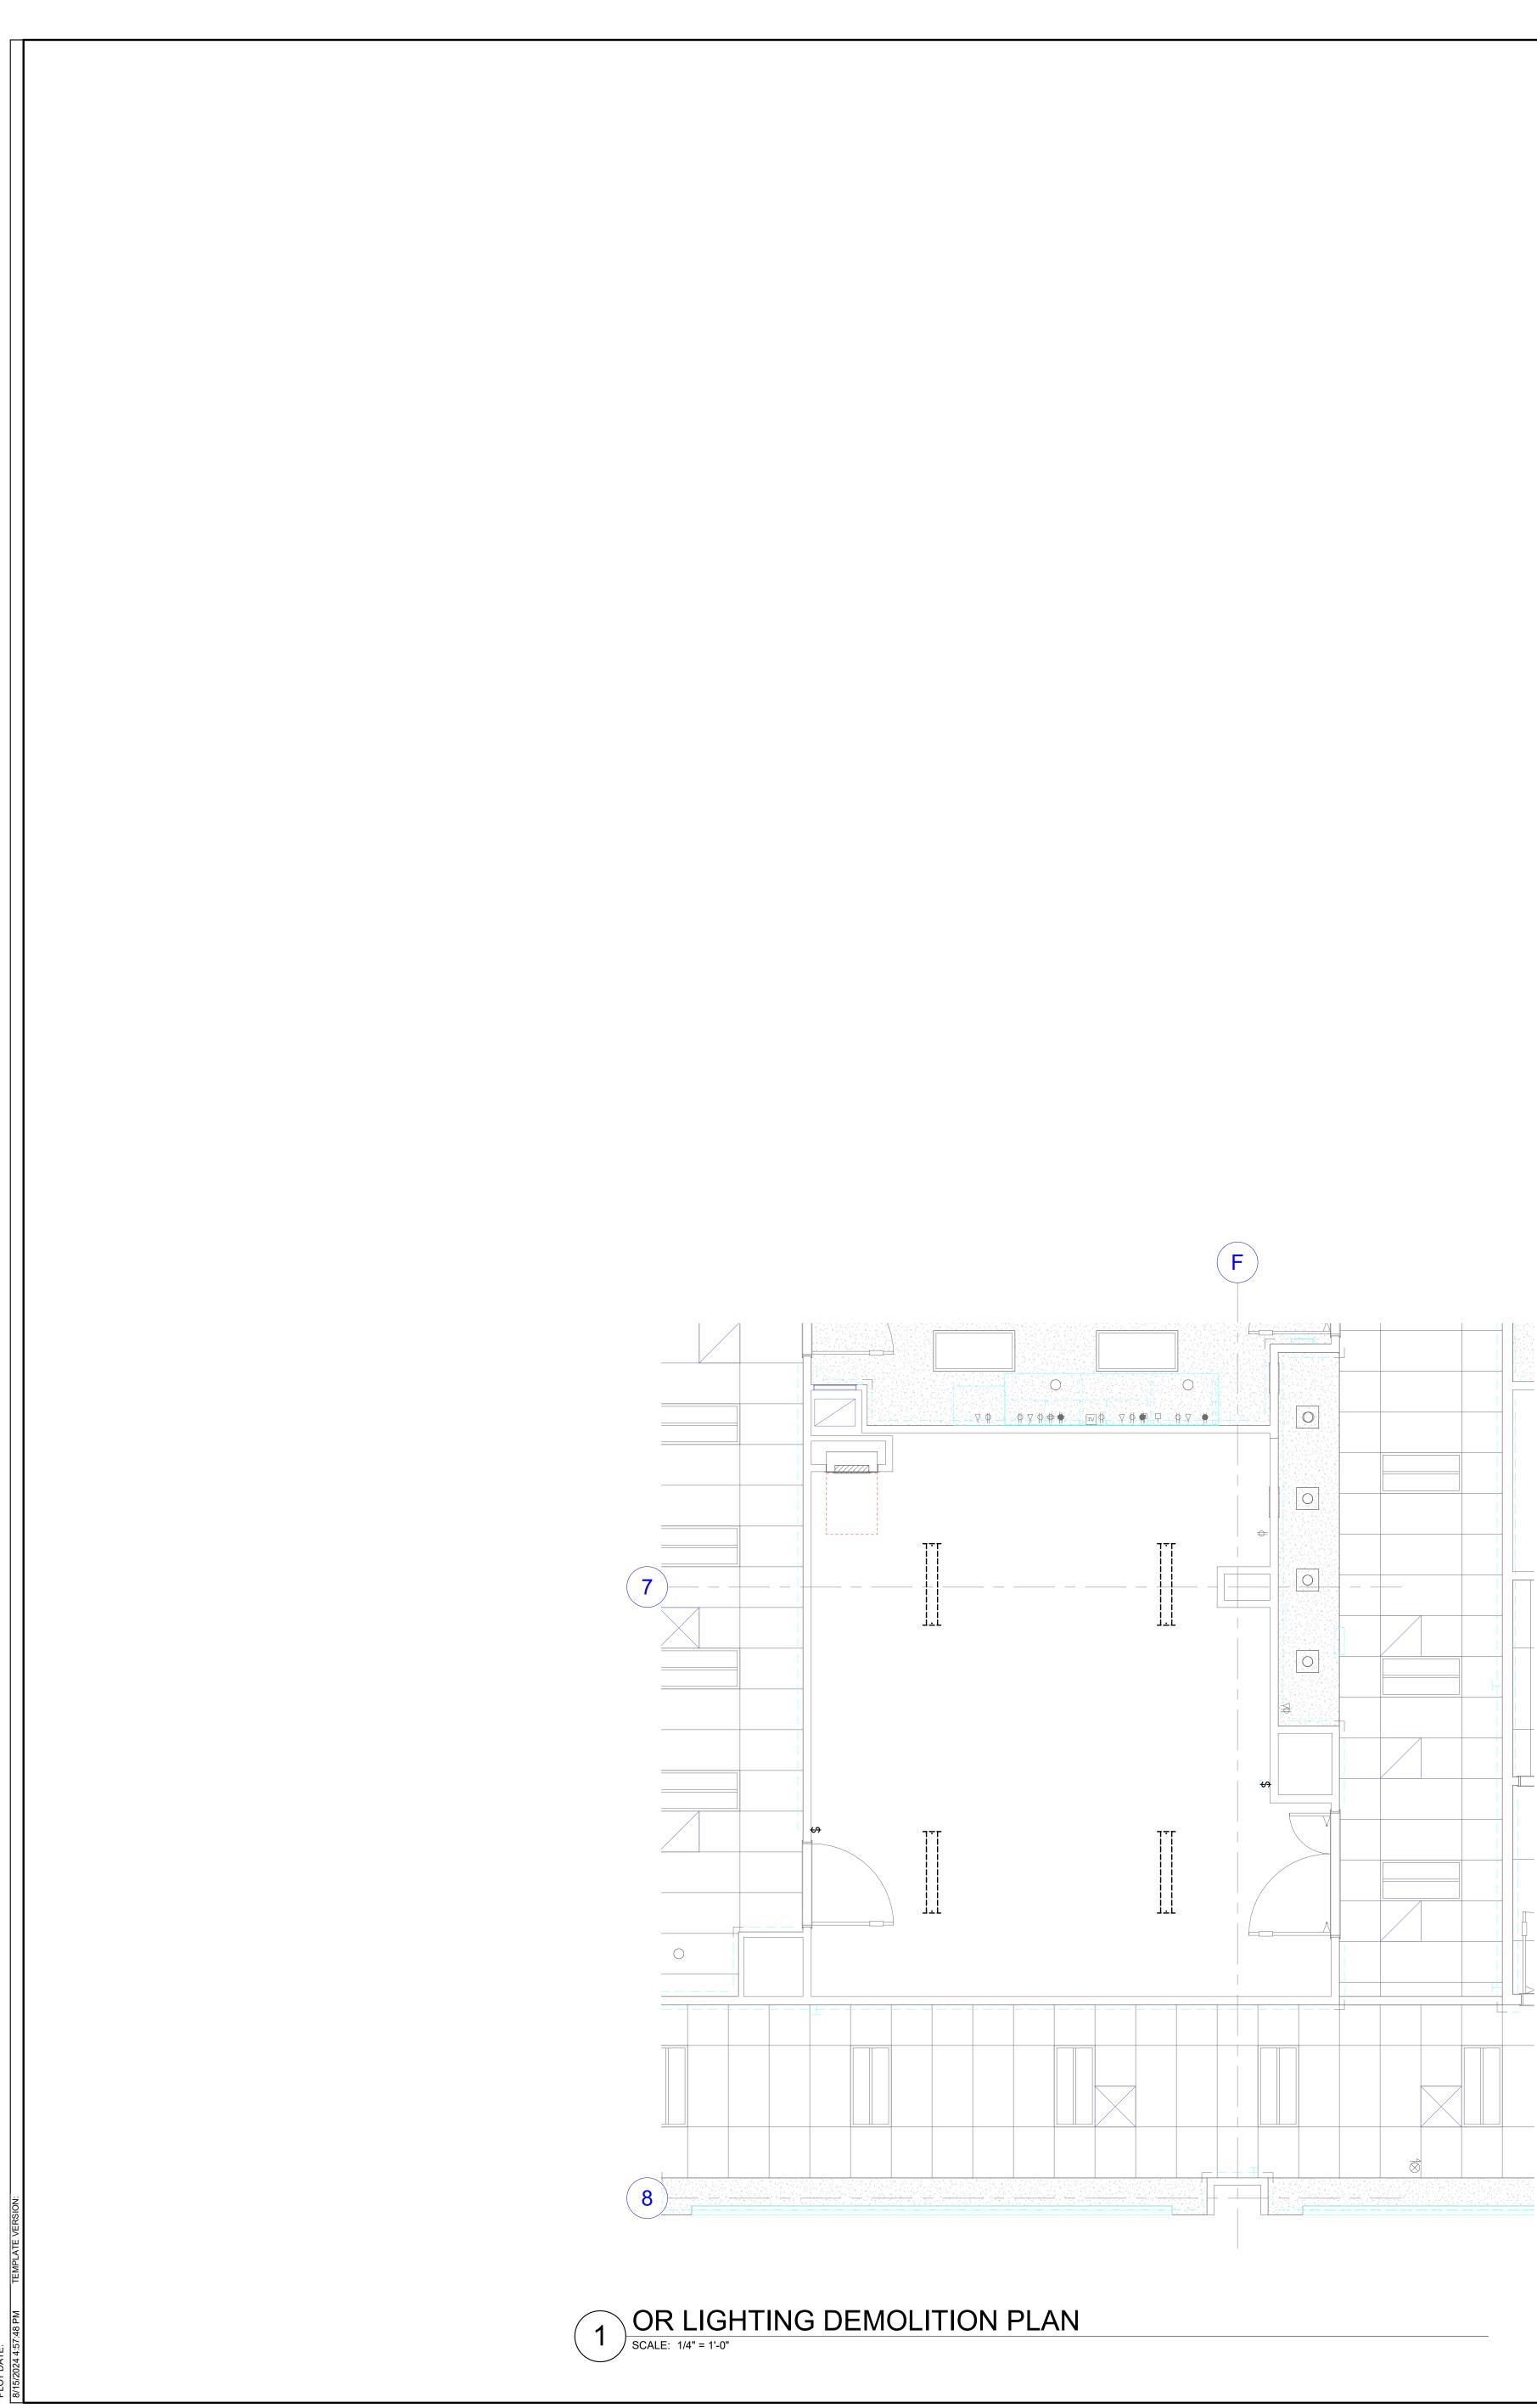

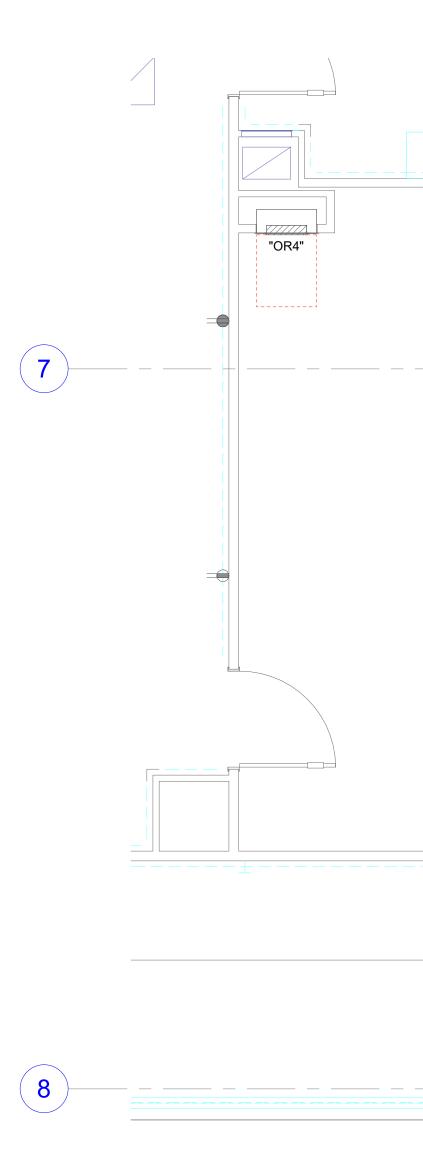



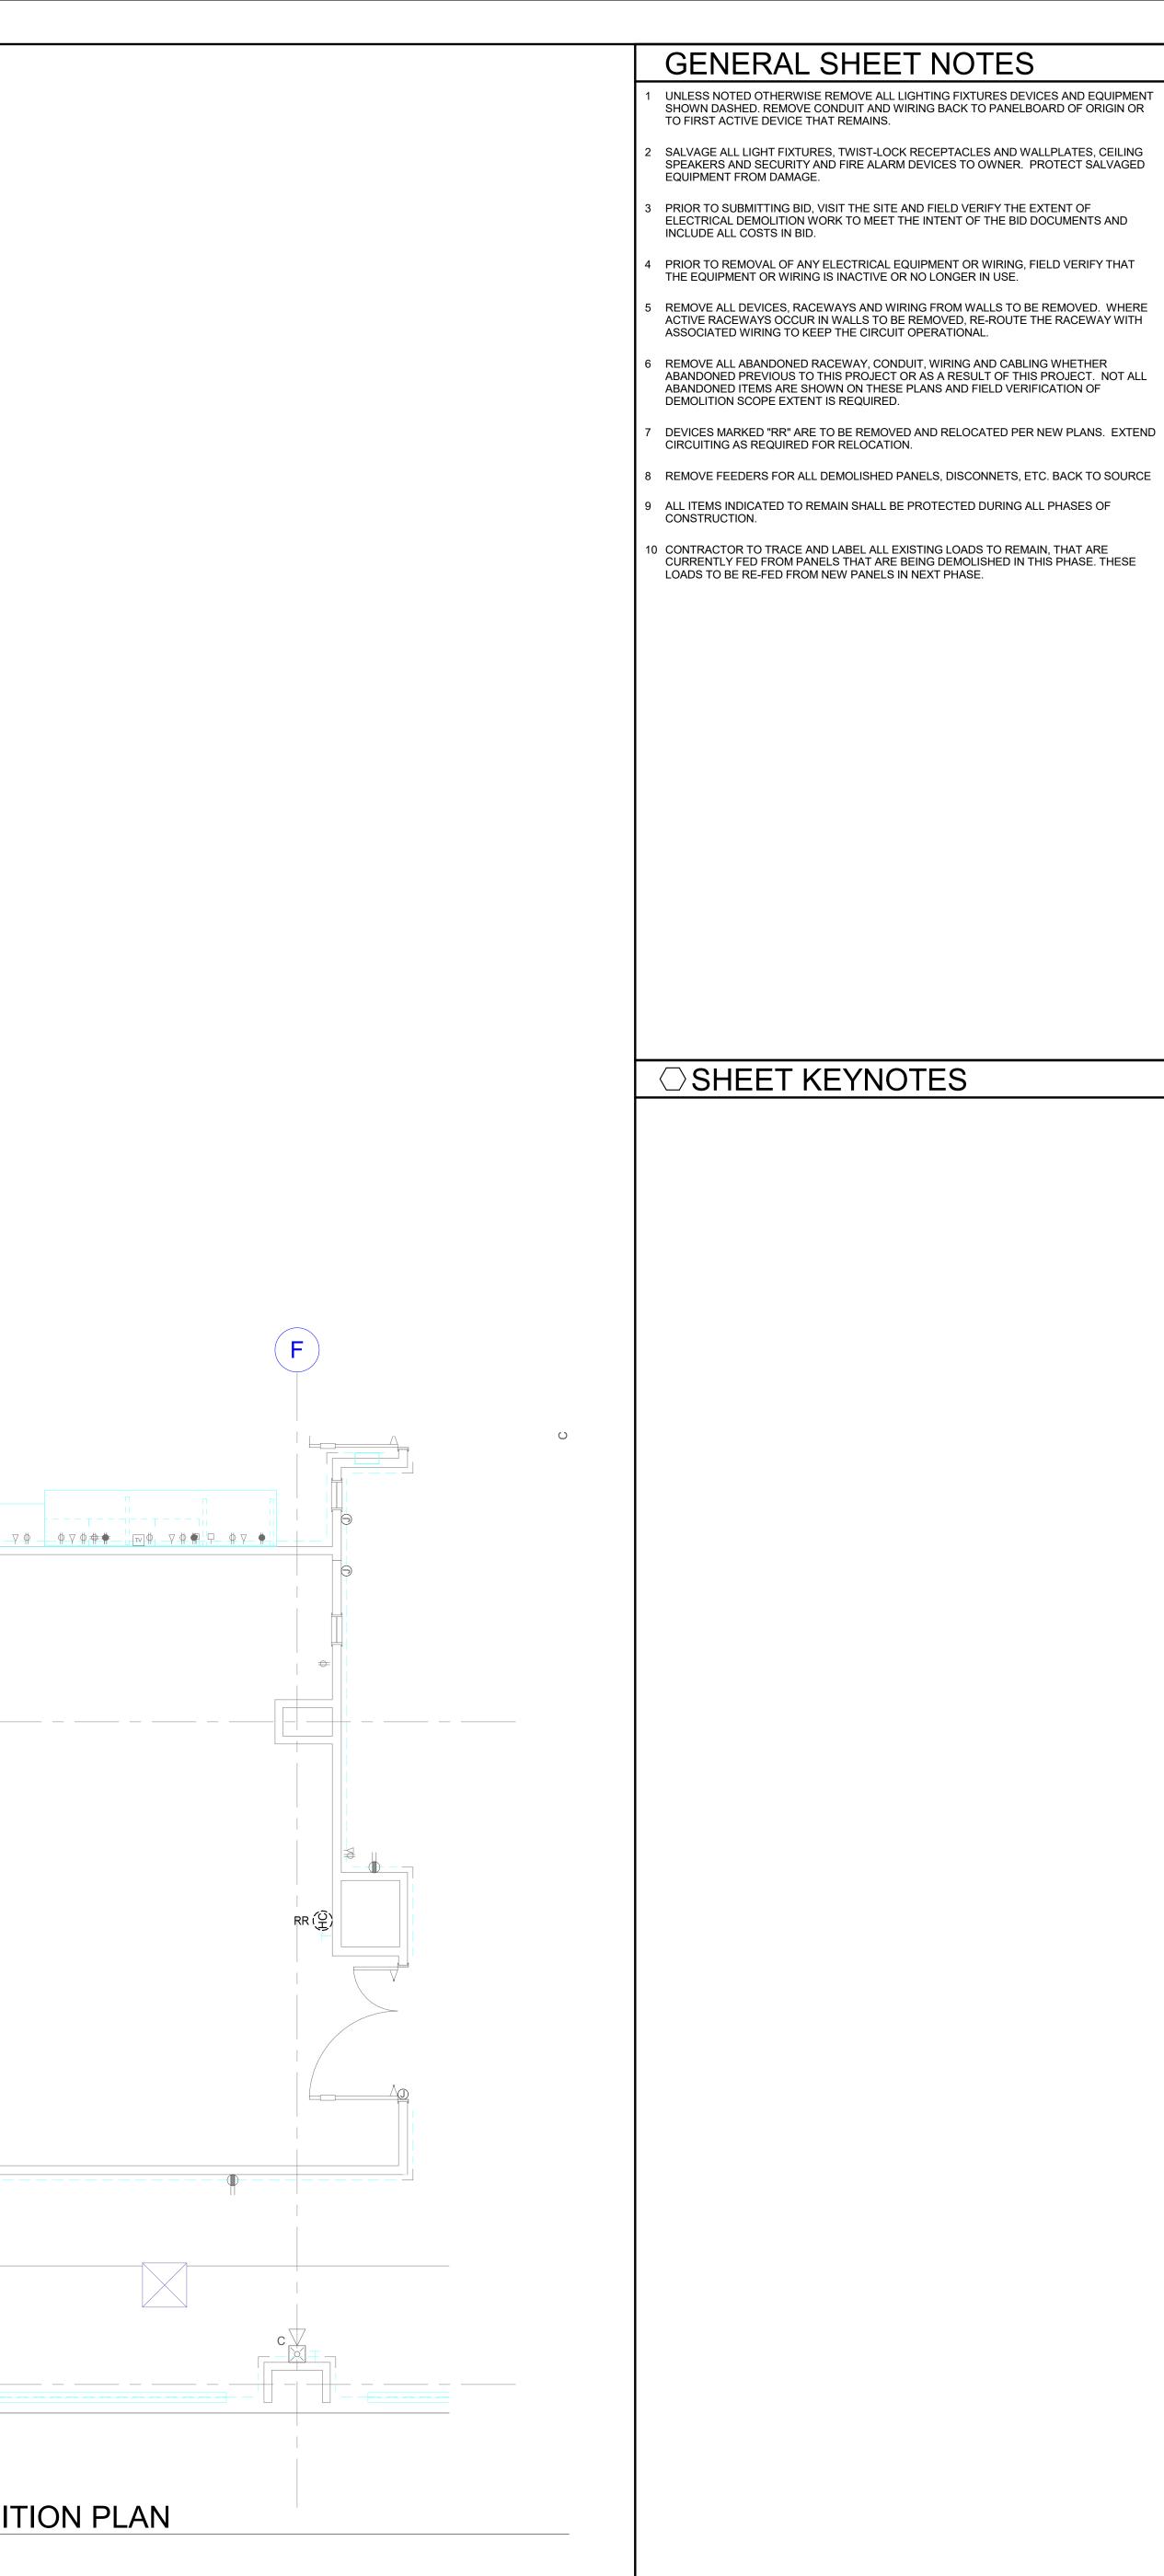

© 2008 HKS, INC.



ARCHITECT HKS ARCHITECTS, INC. 222 SOUTH MAIN, SUITE 230 SALT LAKE CITY, UT 84101

STRUCTURAL ENGINEER REAVELEY ENGINEERS & ASSOCIATES 675 EAST 500 SOUTH, SUITE 400 SALT LAKE CITY, UTAH 84102

MECHANICAL ENGINEER VAN BOERUM & FRANK ASSOCIATES, INC 181 EAST 5600 SOUTH, SUITE 130 MURRAY, UTAH 84107

ELECTRICAL ENGINEER SPECTRUM ENGINEERS, INC 324 SOUTH STATE STREET, SUITE 400 SALT LAKE CITY, UTAH 84111









KEY PLAN

REVISION NO. DESCRIPTION

DATE


26404.000 DATE 08/15/24 ISSUE CONSTRUCTION DRAWINGS SHEET TITLE OR ELECTRICAL **DEMOLITION PLAN**


ED104


HKS PROJECT NUMBER



1 LDR LIGHTING DEMOLITION PLAN SCALE: 1/4" = 1'-0"

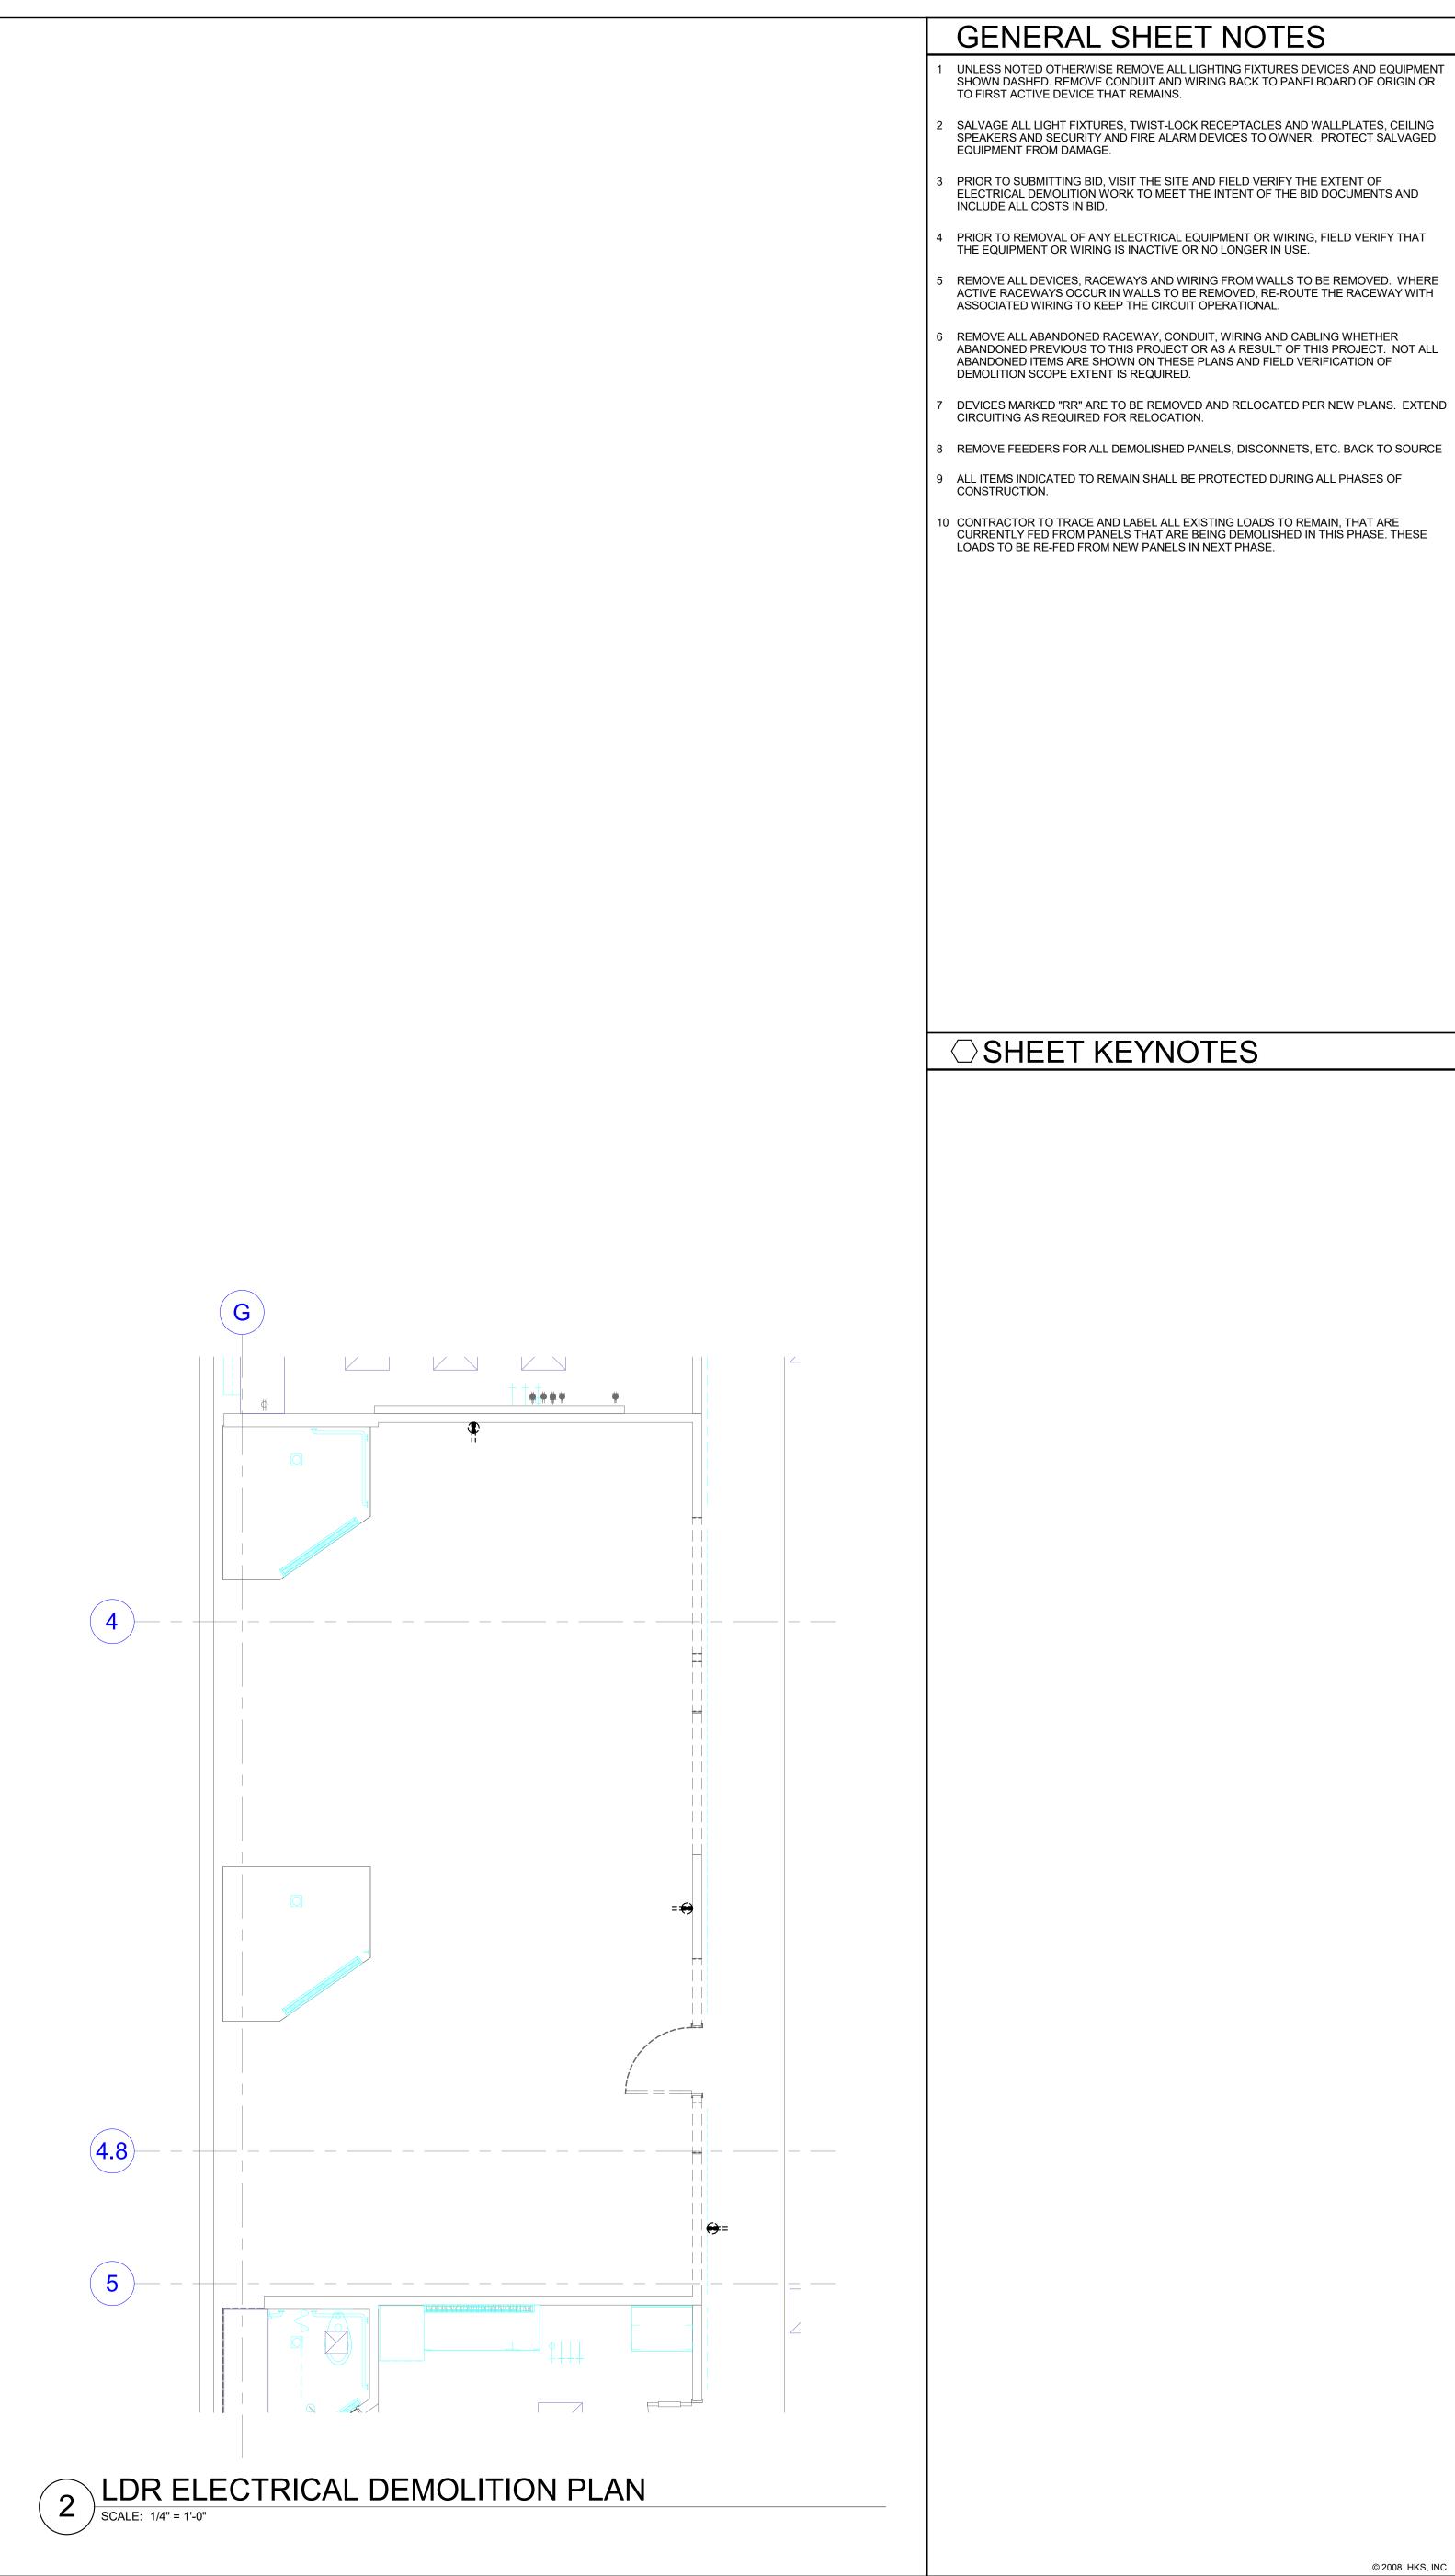

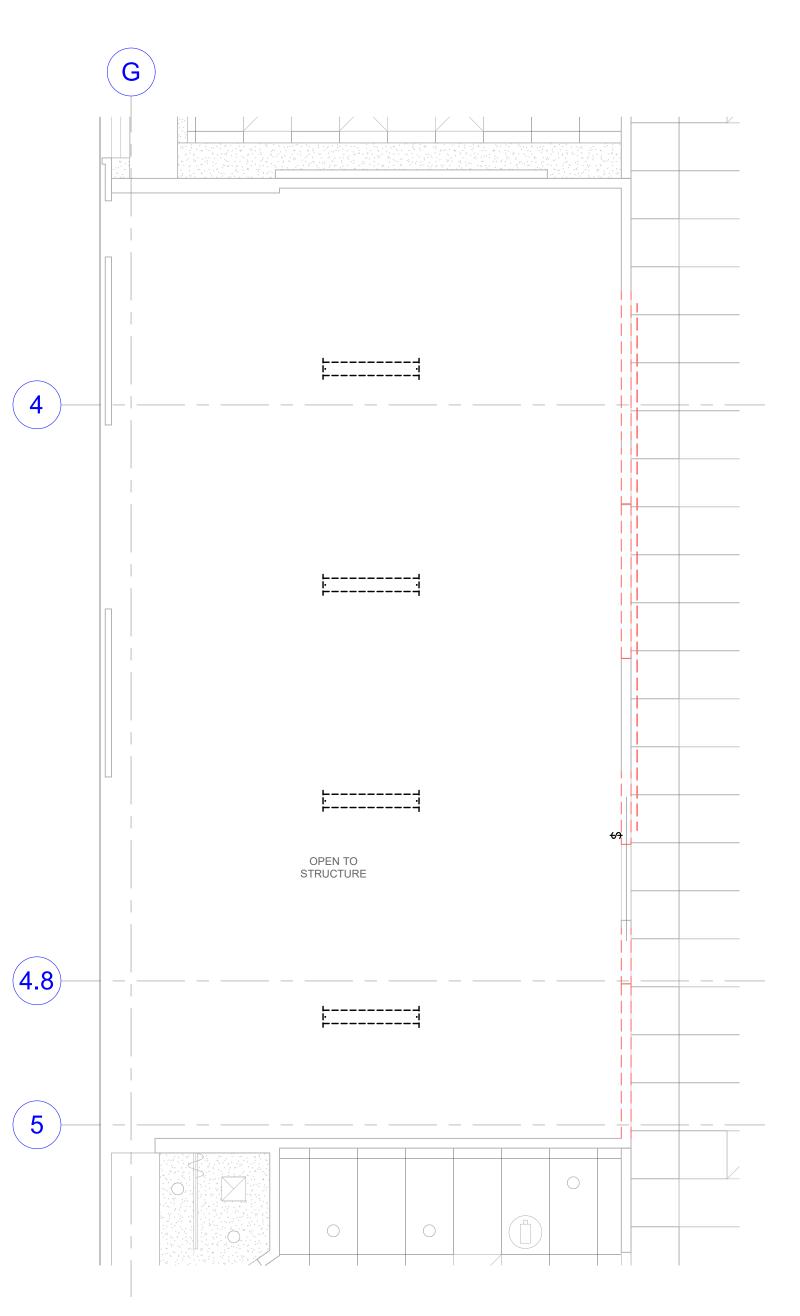

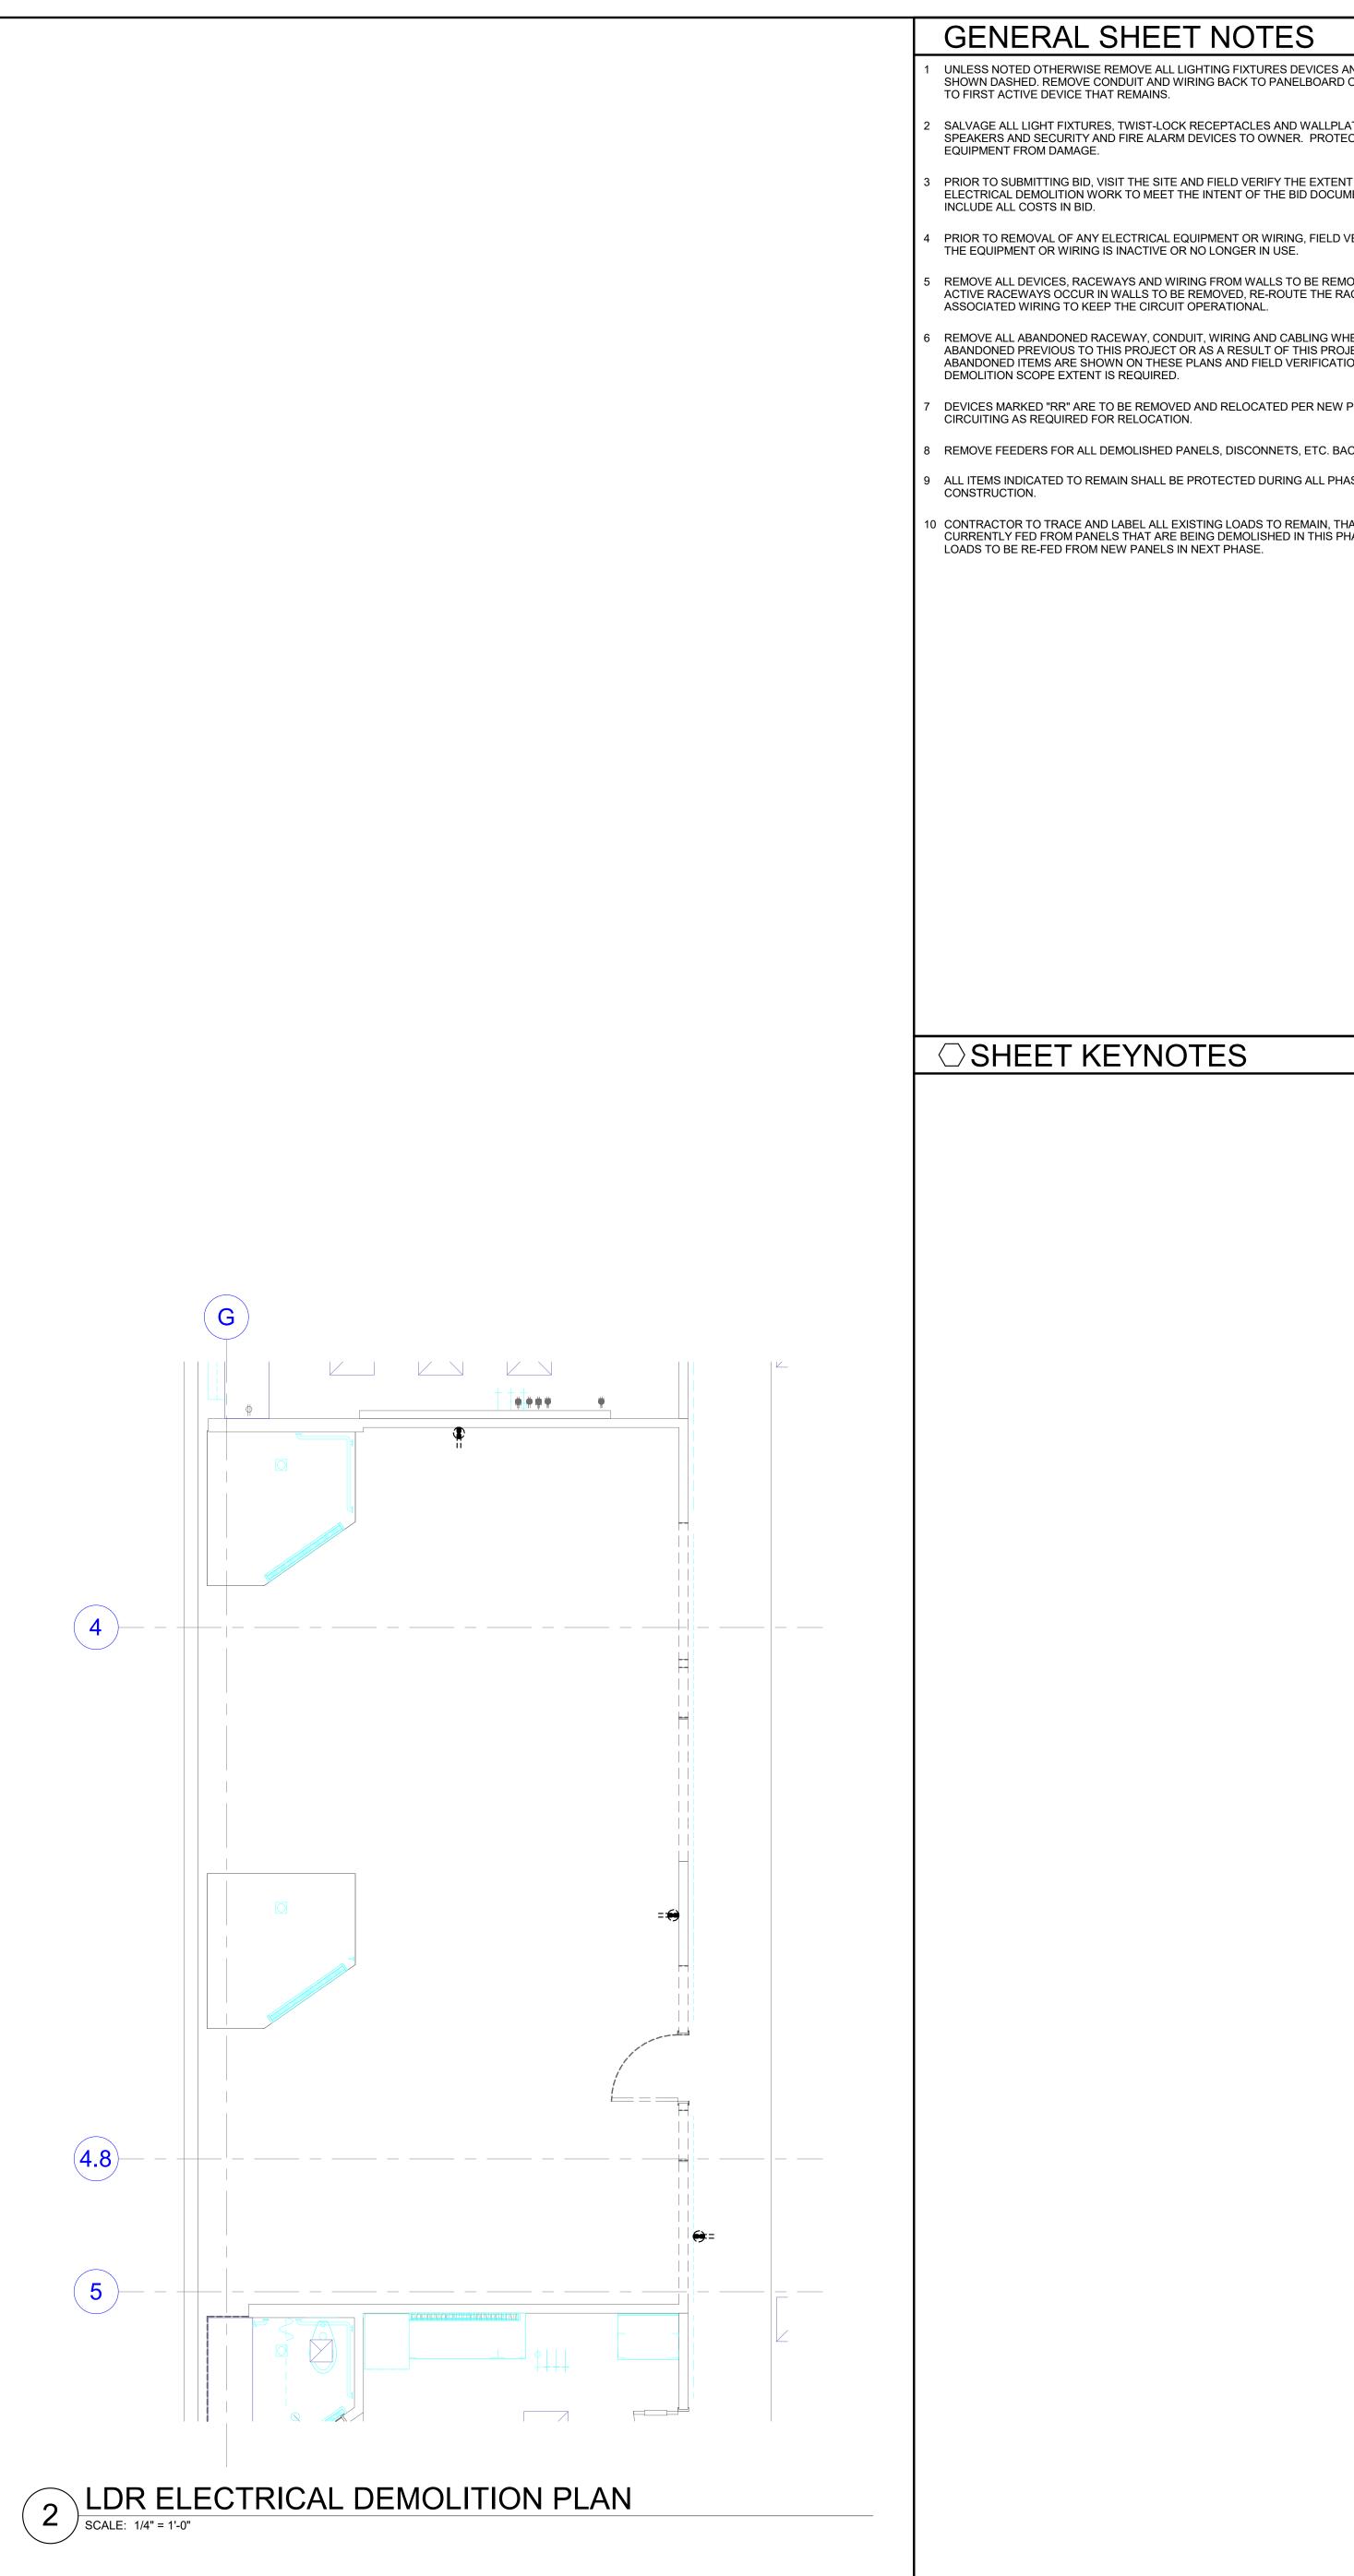



ARCHITECT HKS ARCHITECTS, INC. 222 SOUTH MAIN, SUITE 230 SALT LAKE CITY, UT 84101

STRUCTURAL ENGINEER REAVELEY ENGINEERS & ASSOCIATES 675 EAST 500 SOUTH, SUITE 400 SALT LAKE CITY, UTAH 84102

MECHANICAL ENGINEER VAN BOERUM & FRANK ASSOCIATES, INC 181 EAST 5600 SOUTH, SUITE 130 MURRAY, UTAH 84107

ELECTRICAL ENGINEER SPECTRUM ENGINEERS, INC 324 SOUTH STATE STREET, SUITE 400 SALT LAKE CITY, UTAH 84111









KEY PLAN

REVISION NO. DESCRIPTION

HKS PROJECT NUMBER

DATE

26404.000 DATE 08/15/24 ISSUE CONSTRUCTION DRAWINGS SHEET TITLE LDR ELECTRICAL **DEMOLITION PLAN**

ED105







STRUCTURAL ENGINEER **REAVELEY ENGINEERS & ASSOCIATES** 675 EAST 500 SOUTH, SUITE 400 SALT LAKE CITY, UTAH 84102

MECHANICAL ENGINEER VAN BOERUM & FRANK ASSOCIATES, INC 181 EAST 5600 SOUTH, SUITE 130 MURRAY, UTAH 84107

ELECTRICAL ENGINEER SPECTRUM ENGINEERS, INC 324 SOUTH STATE STREET, SUITE 400 SALT LAKE CITY, UTAH 84111











KEY PLAN


REVISION NO. DESCRIPTION


HKS PROJECT NUMBER 26404.000 DATE 08/15/24 ISSUE CONSTRUCTION DRAWINGS SHEET TITLE LEVEL 1 OVERALL **POWER PLAN**

EP100

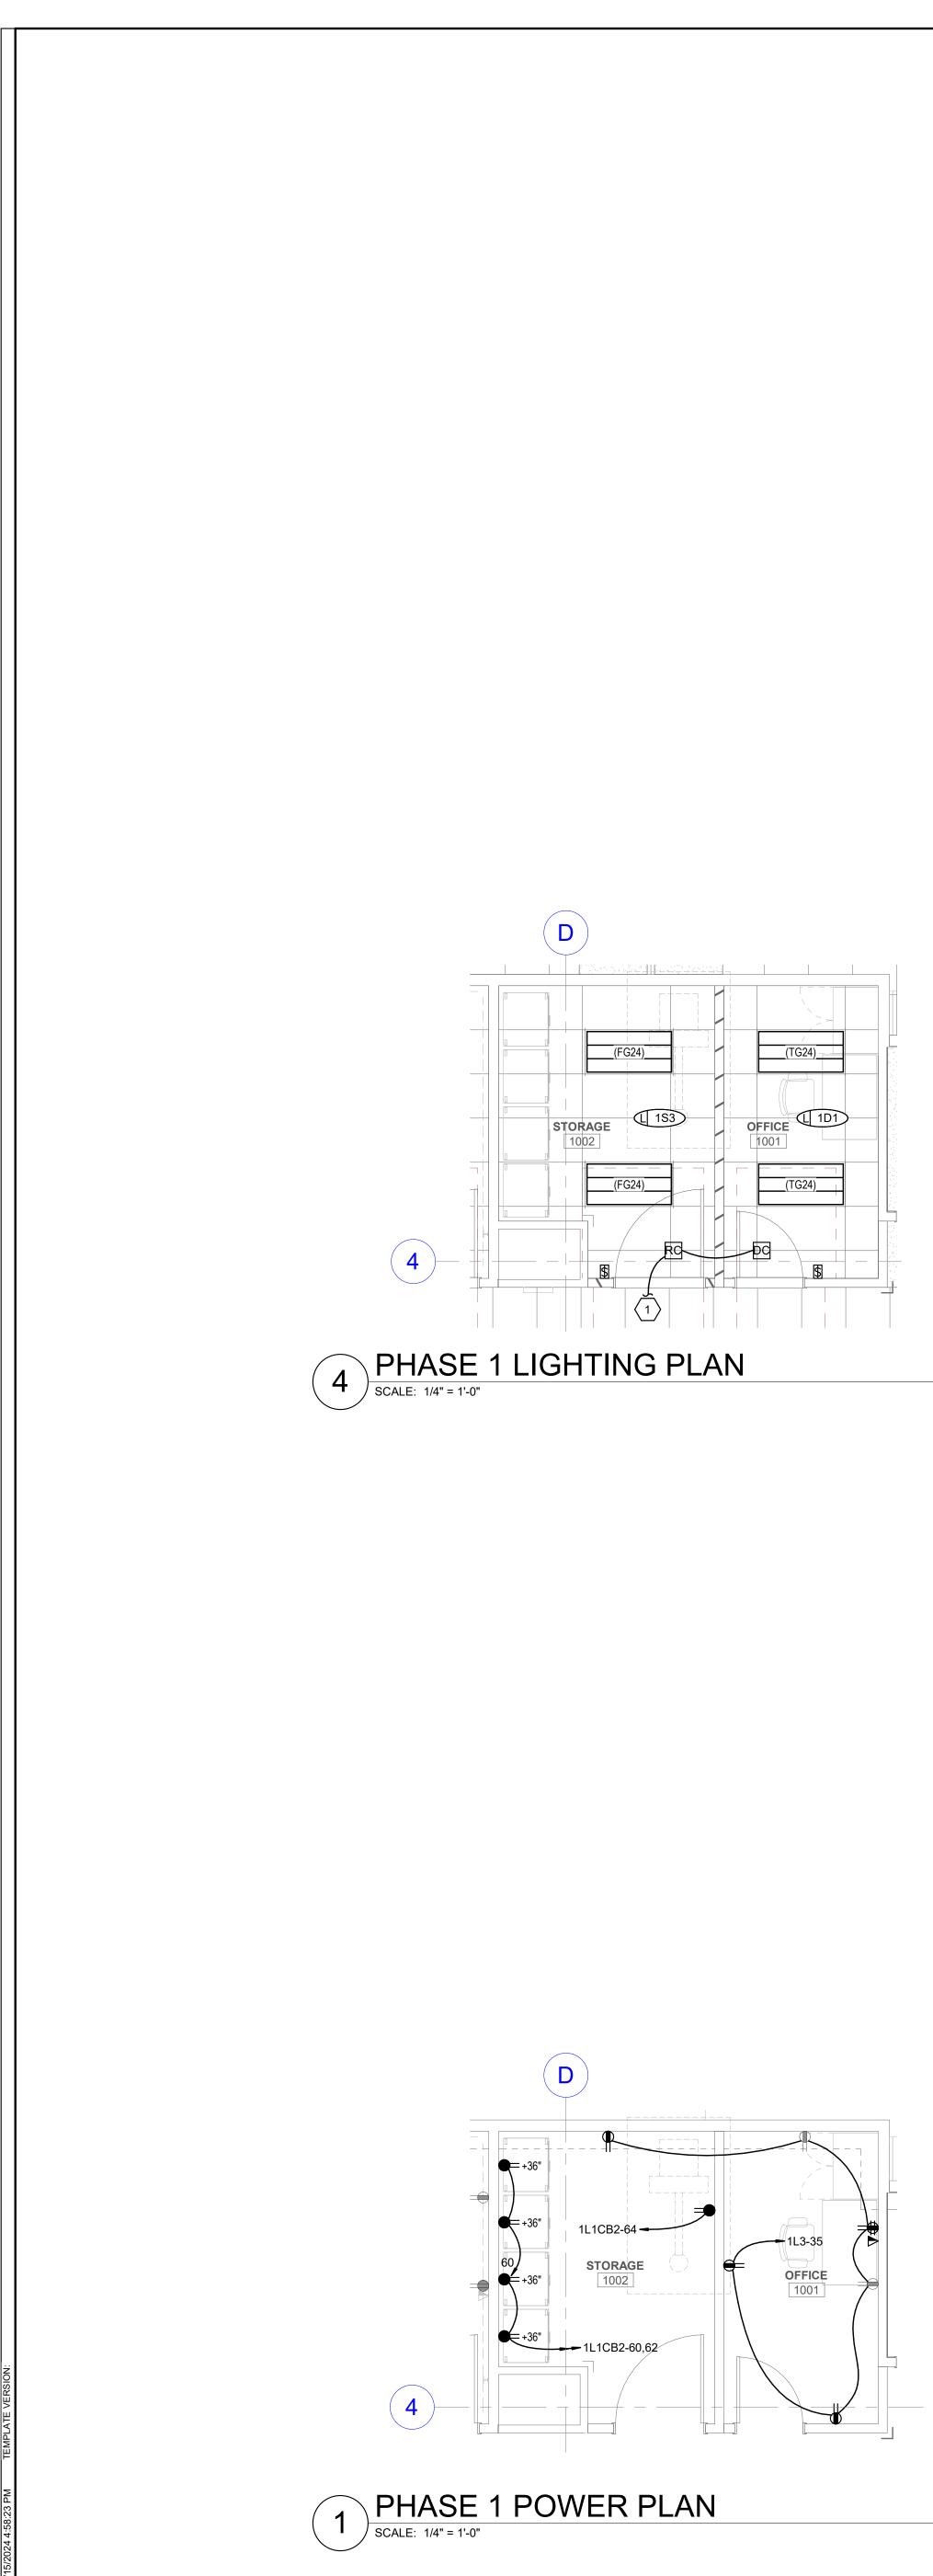


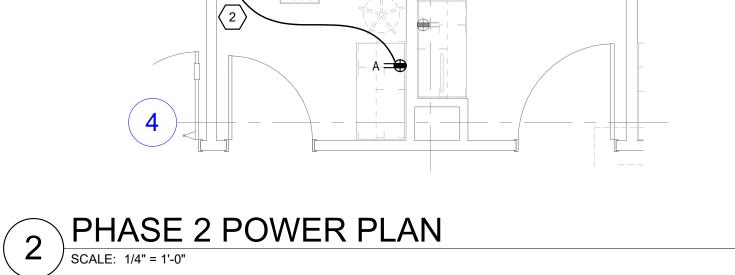


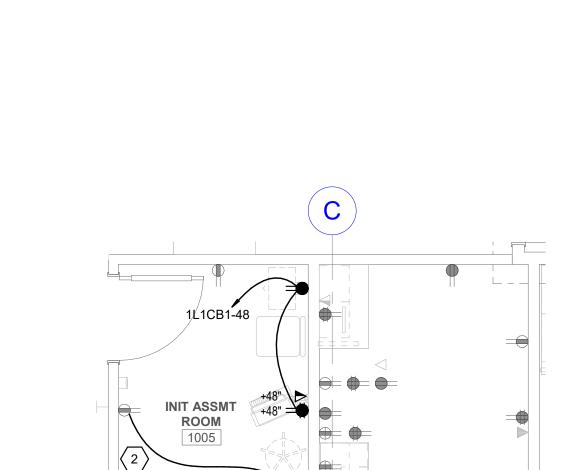


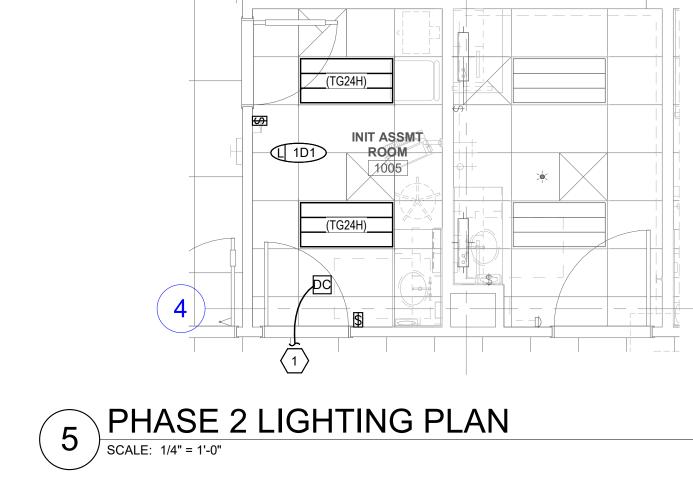



C

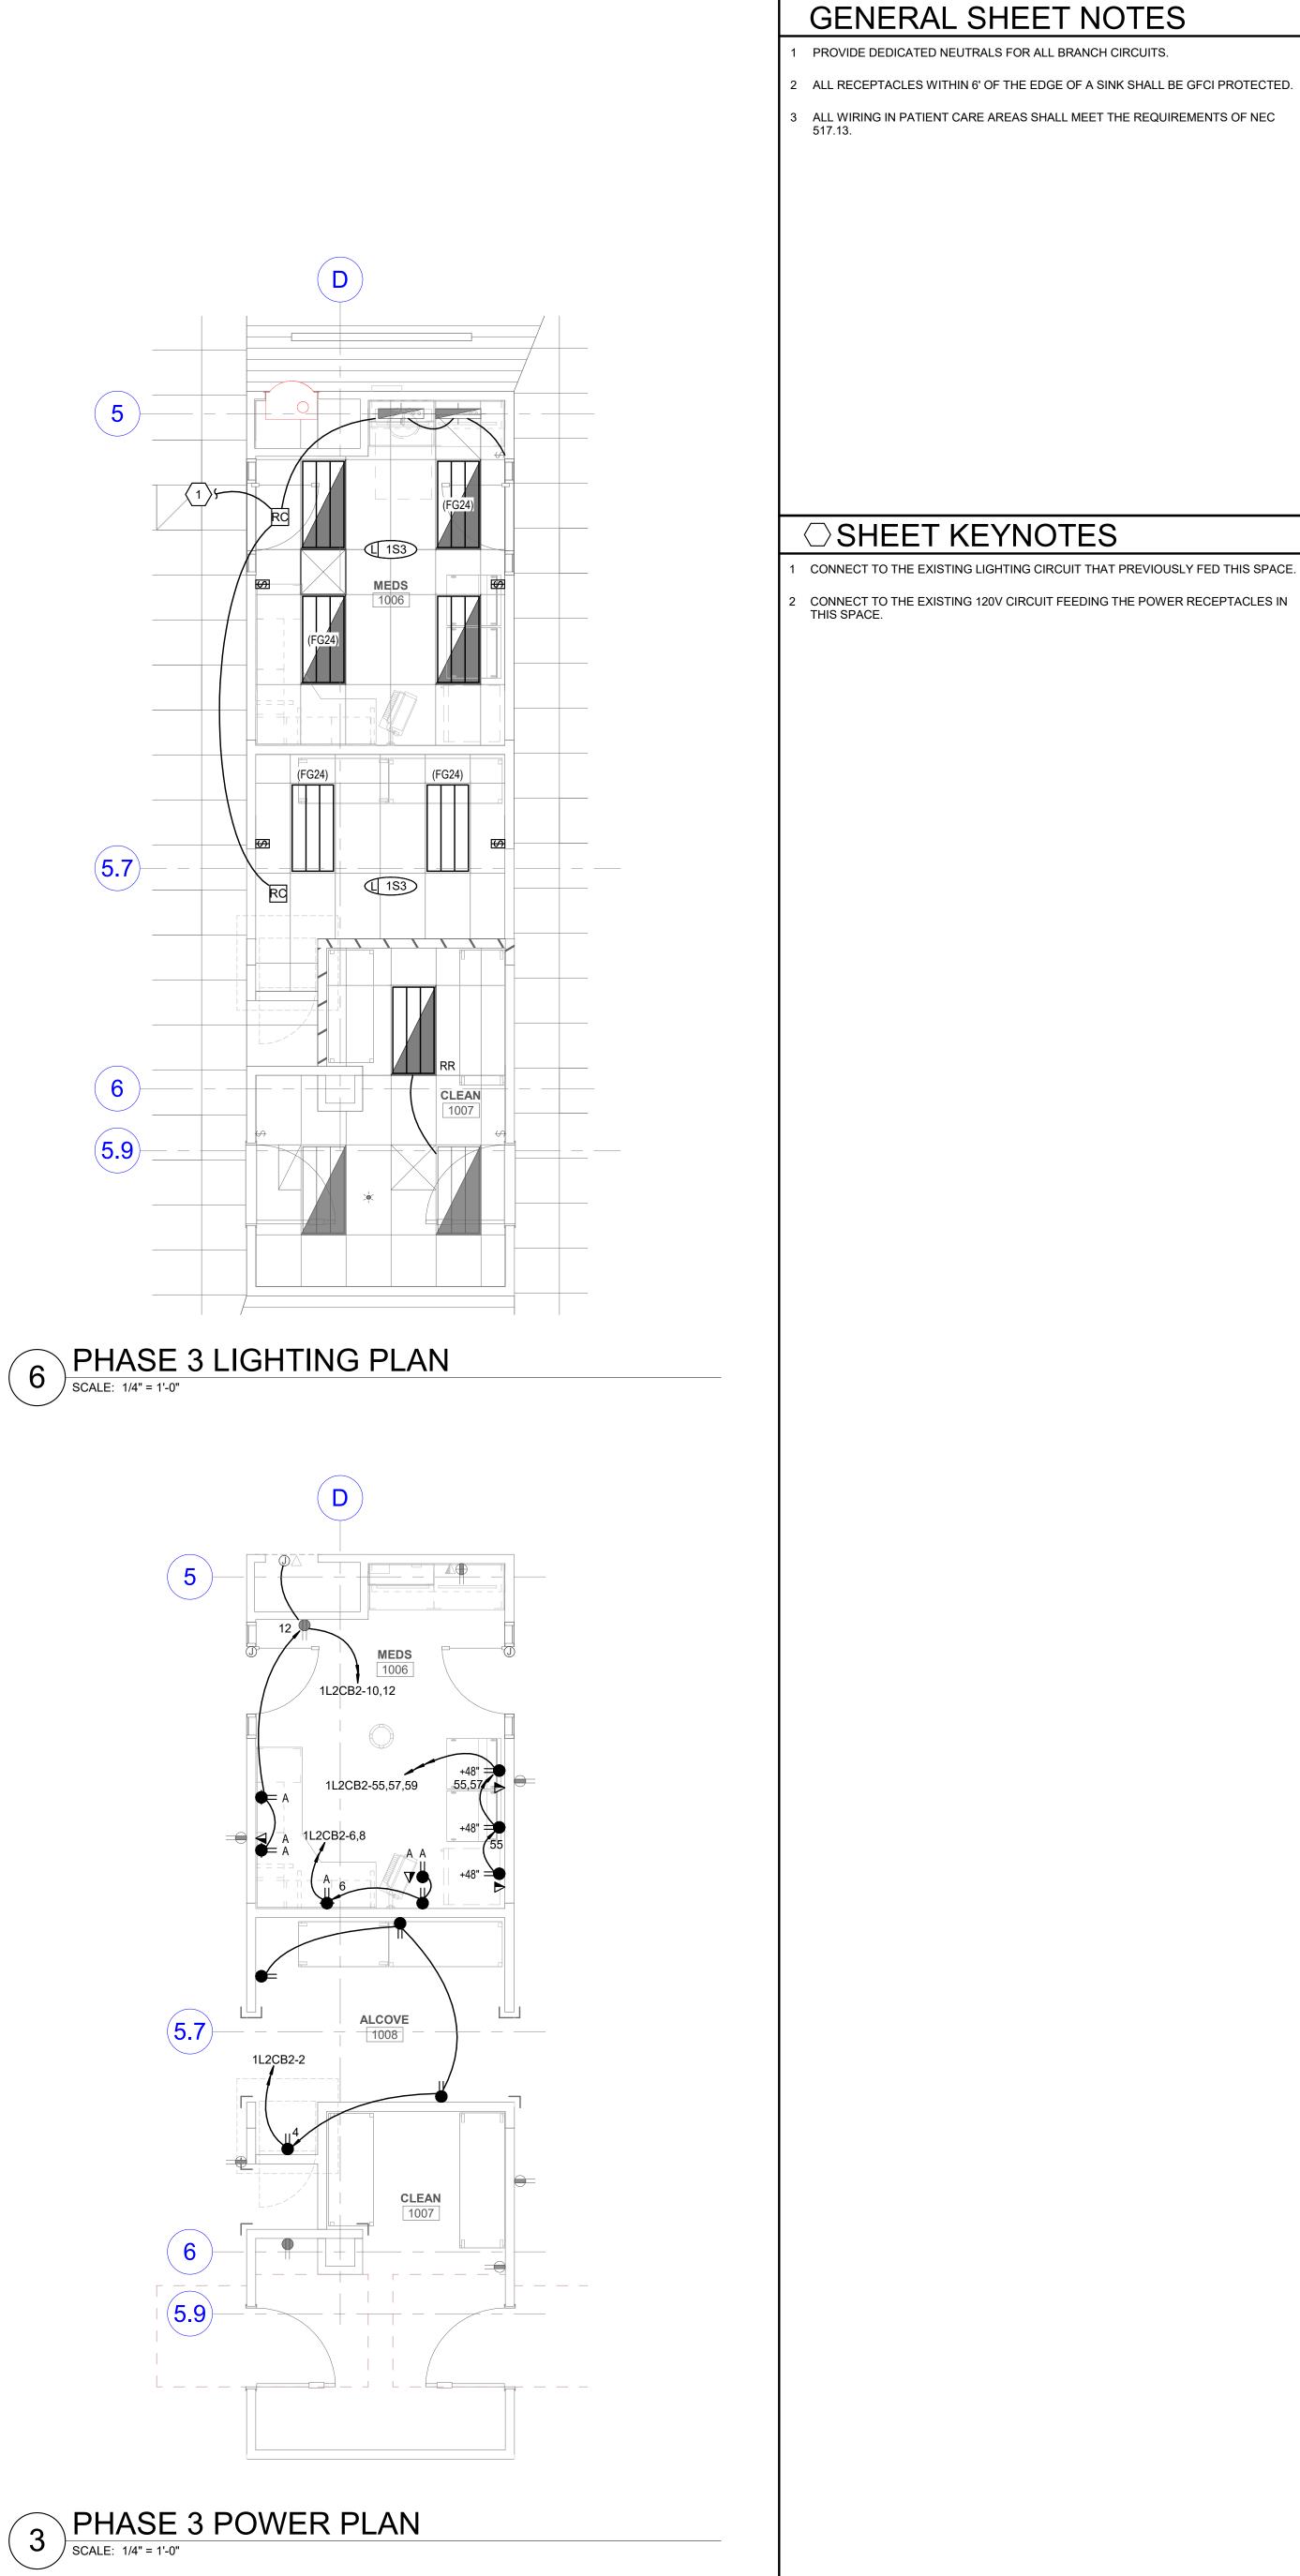


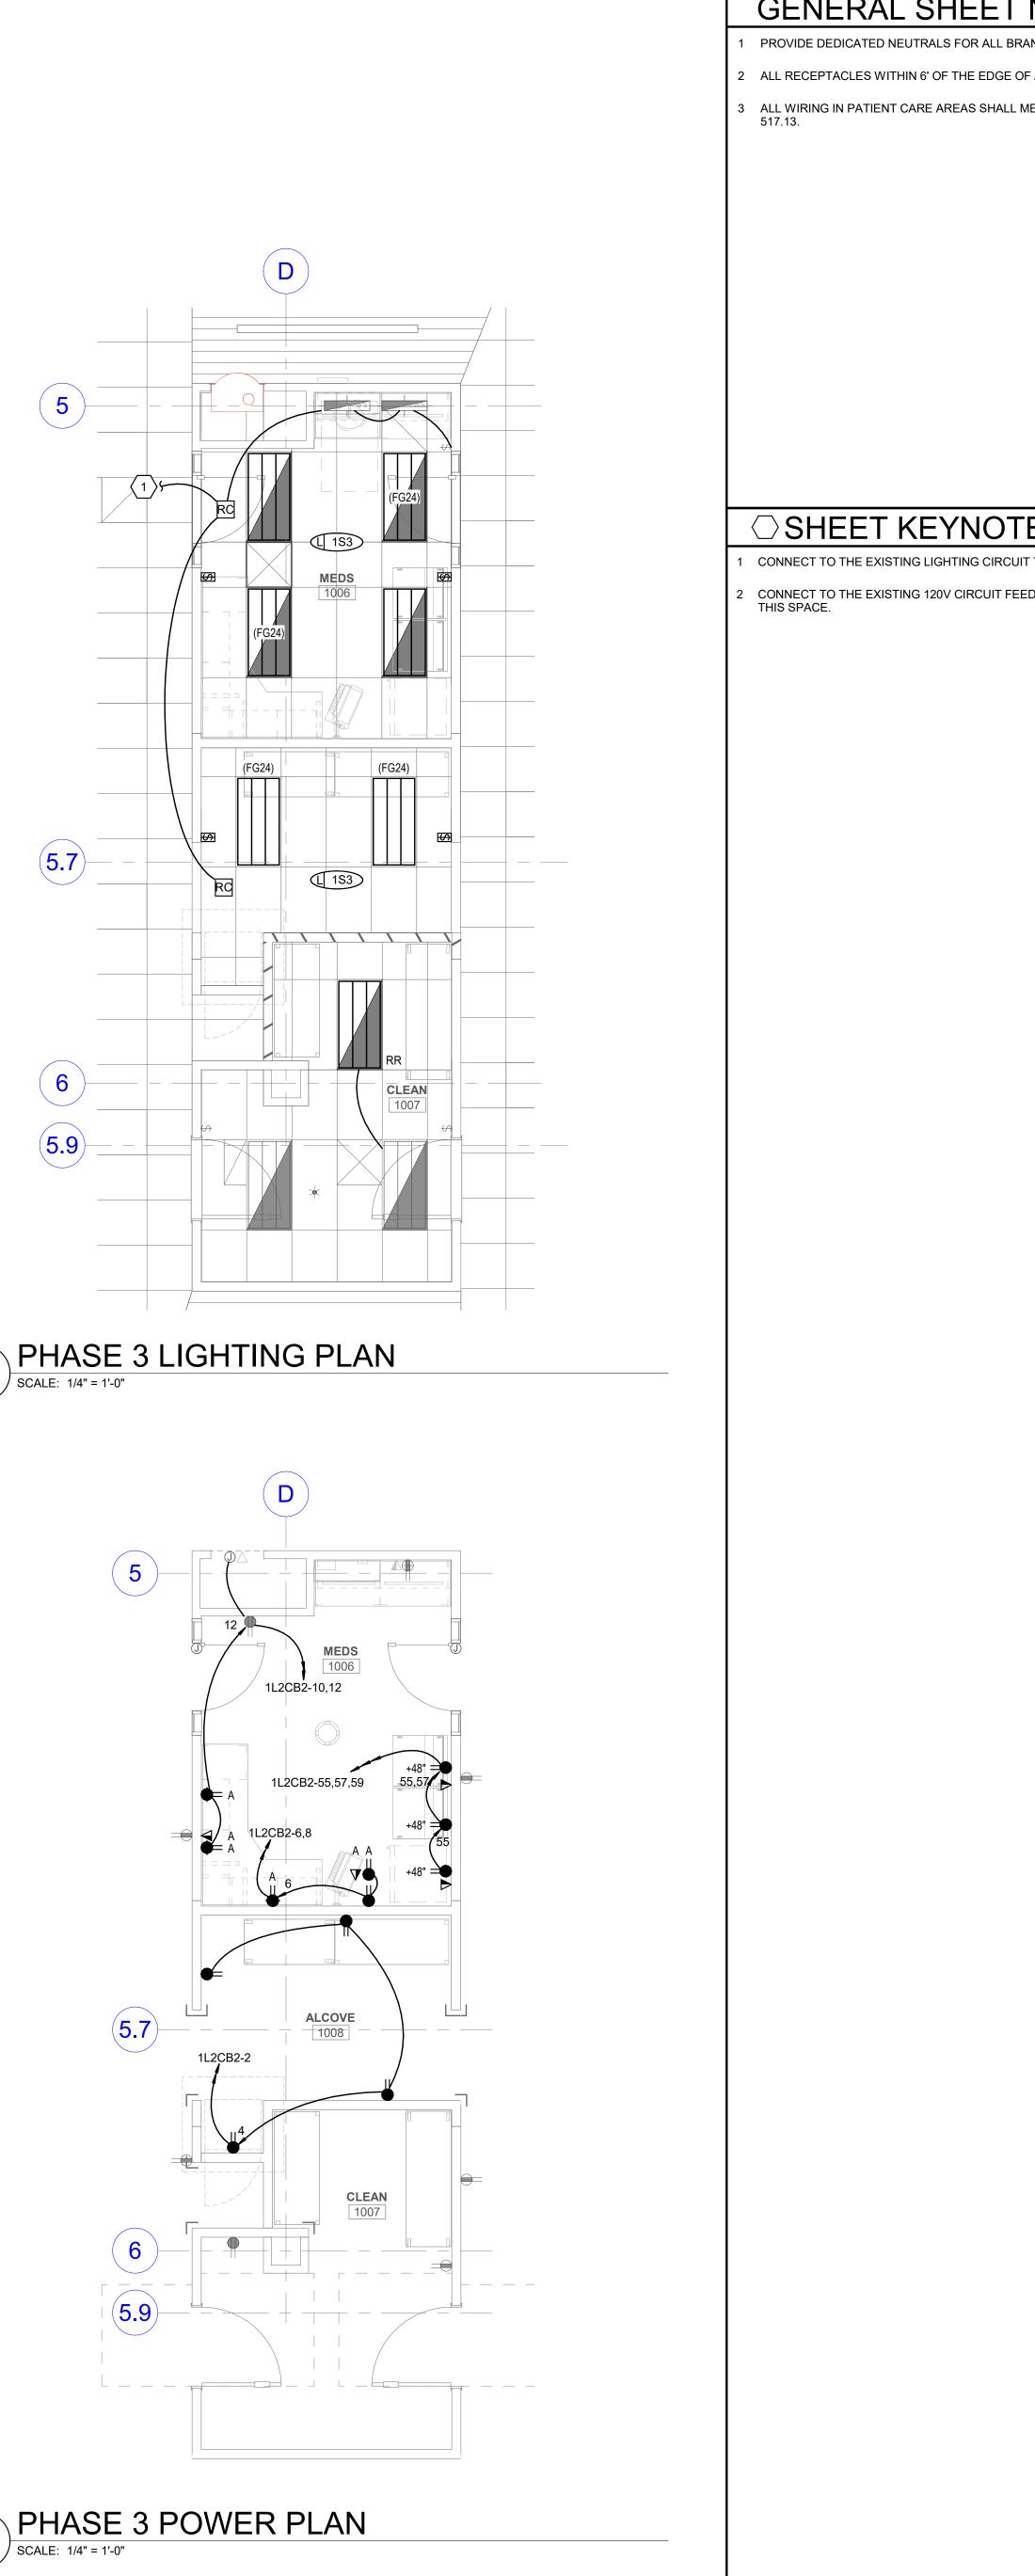

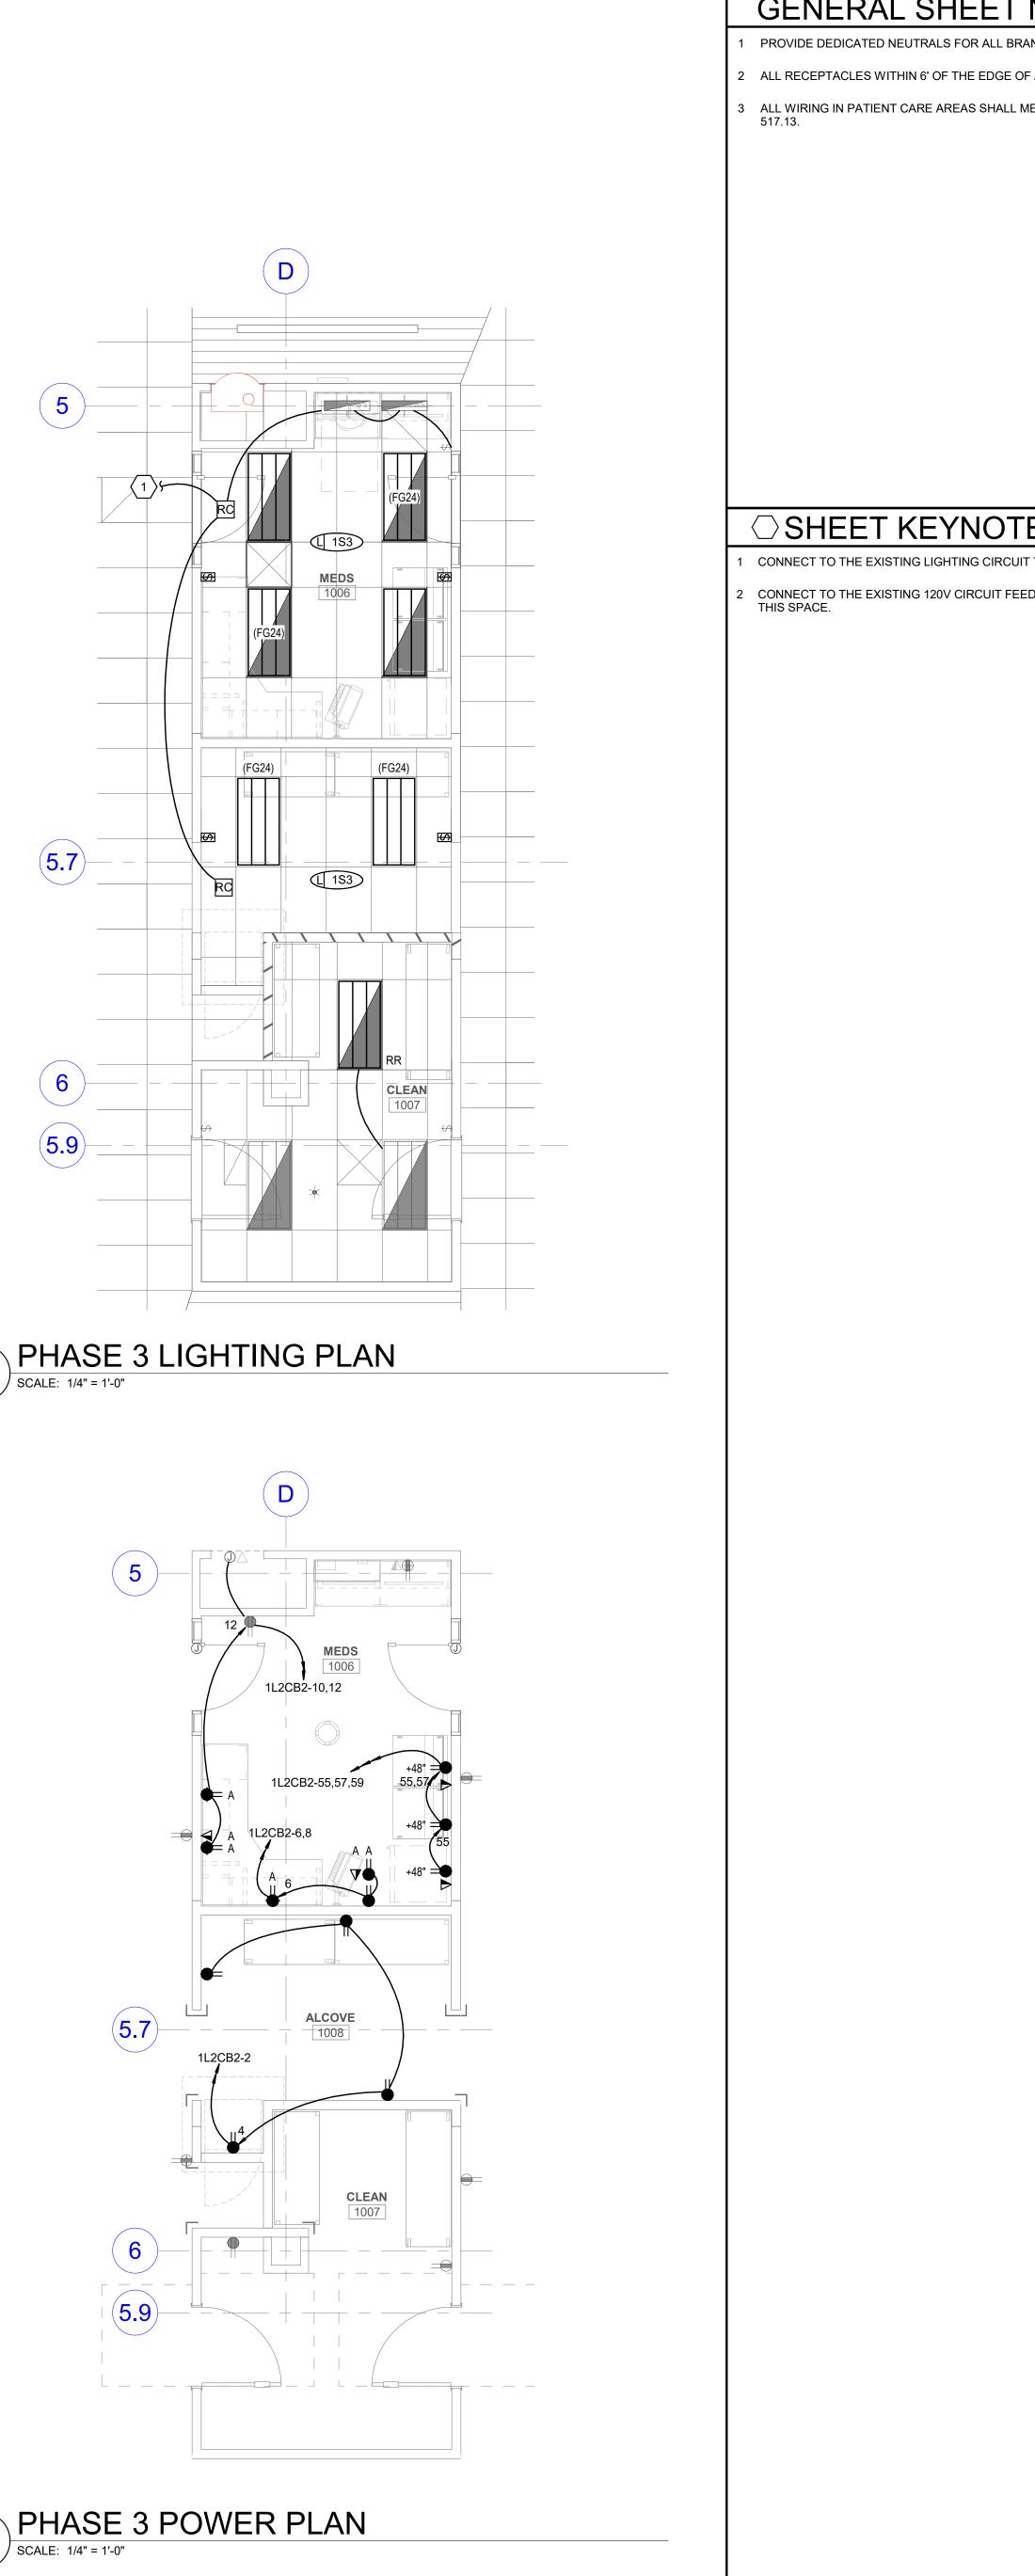

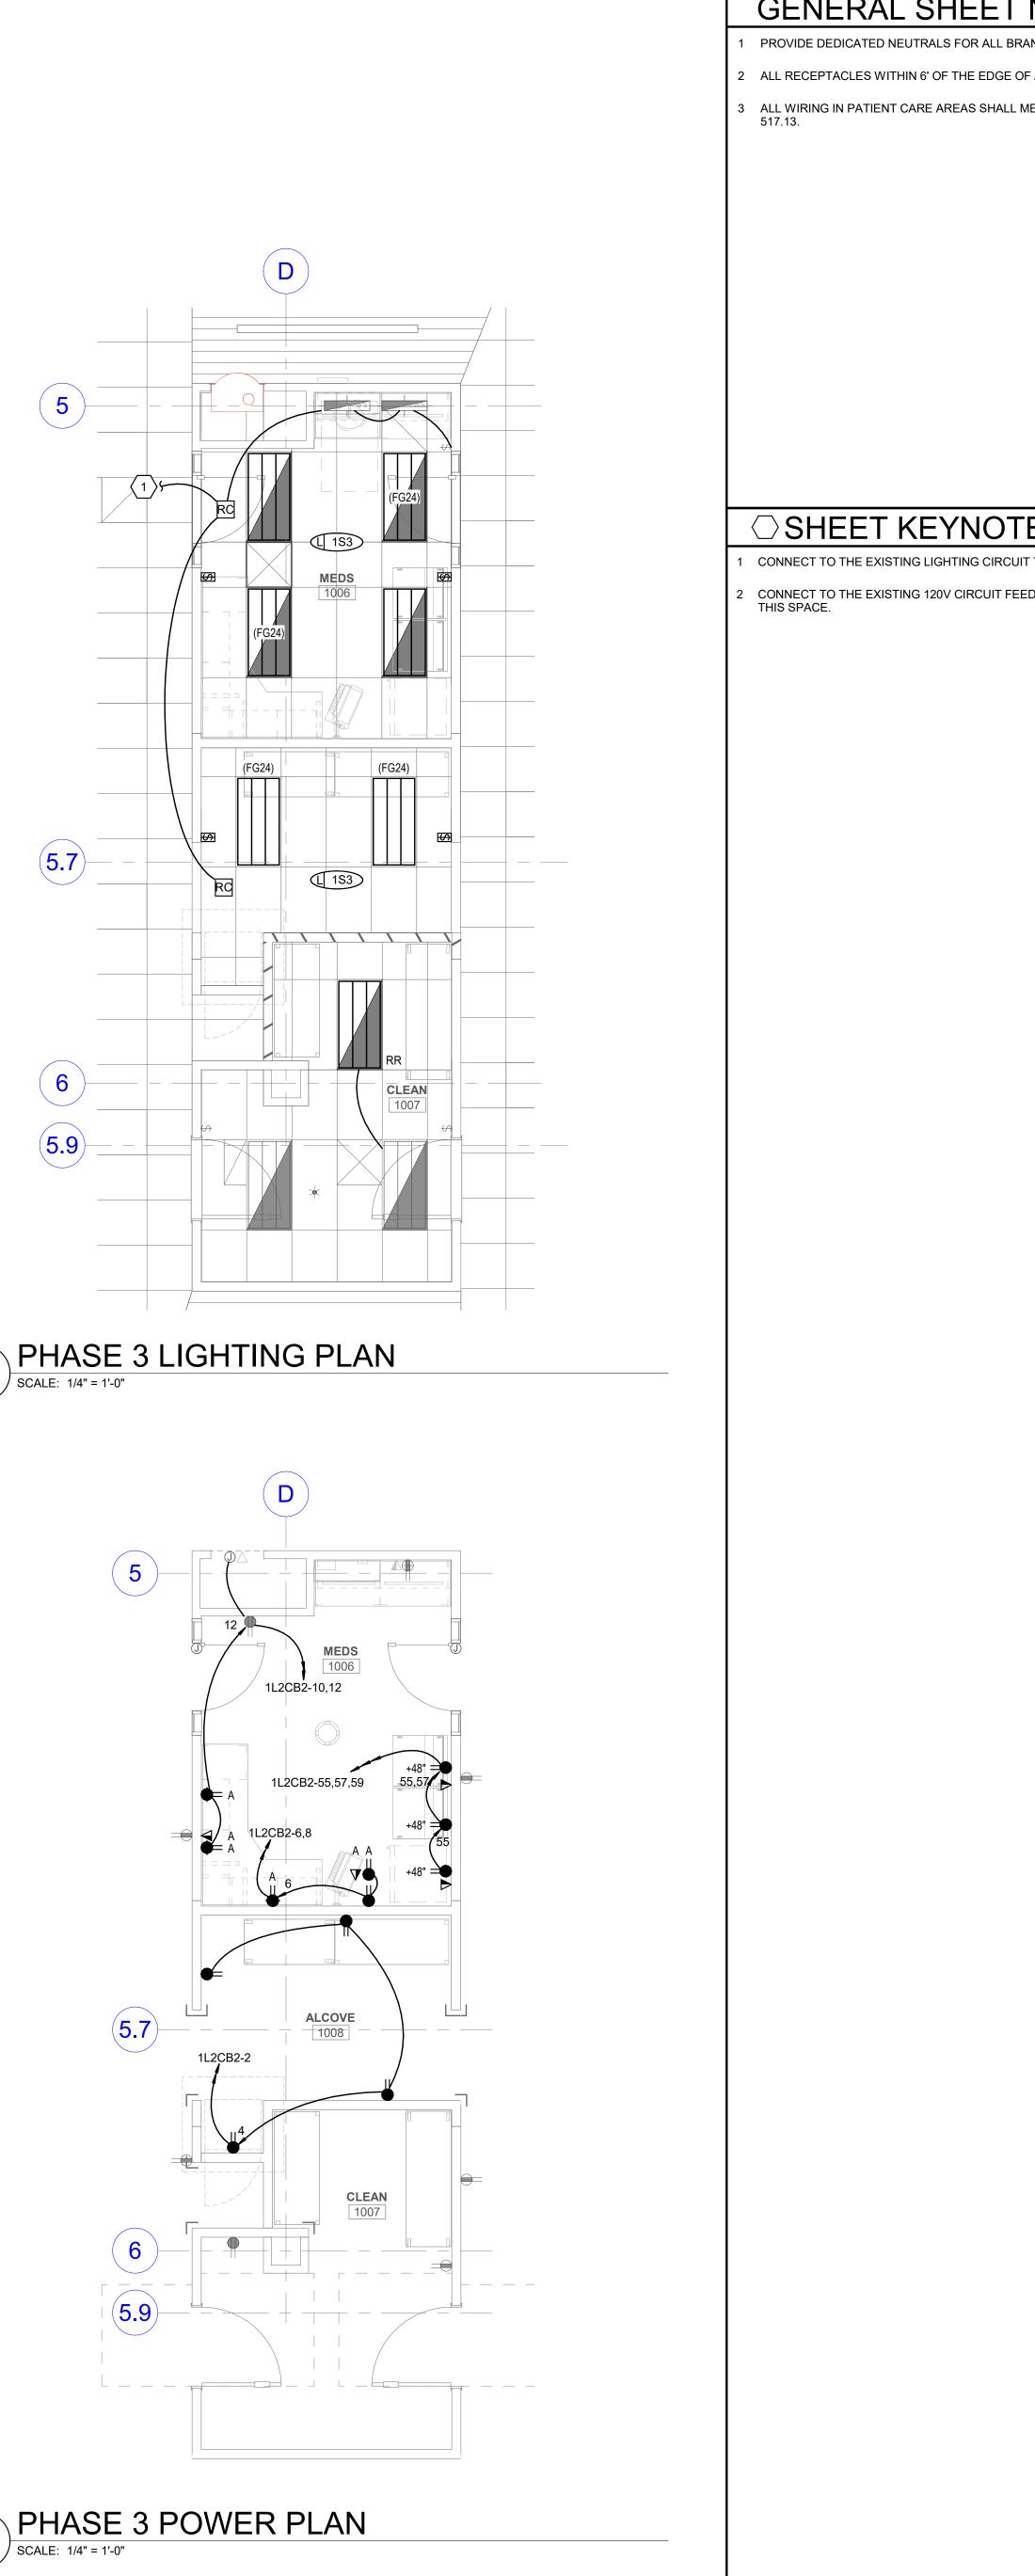

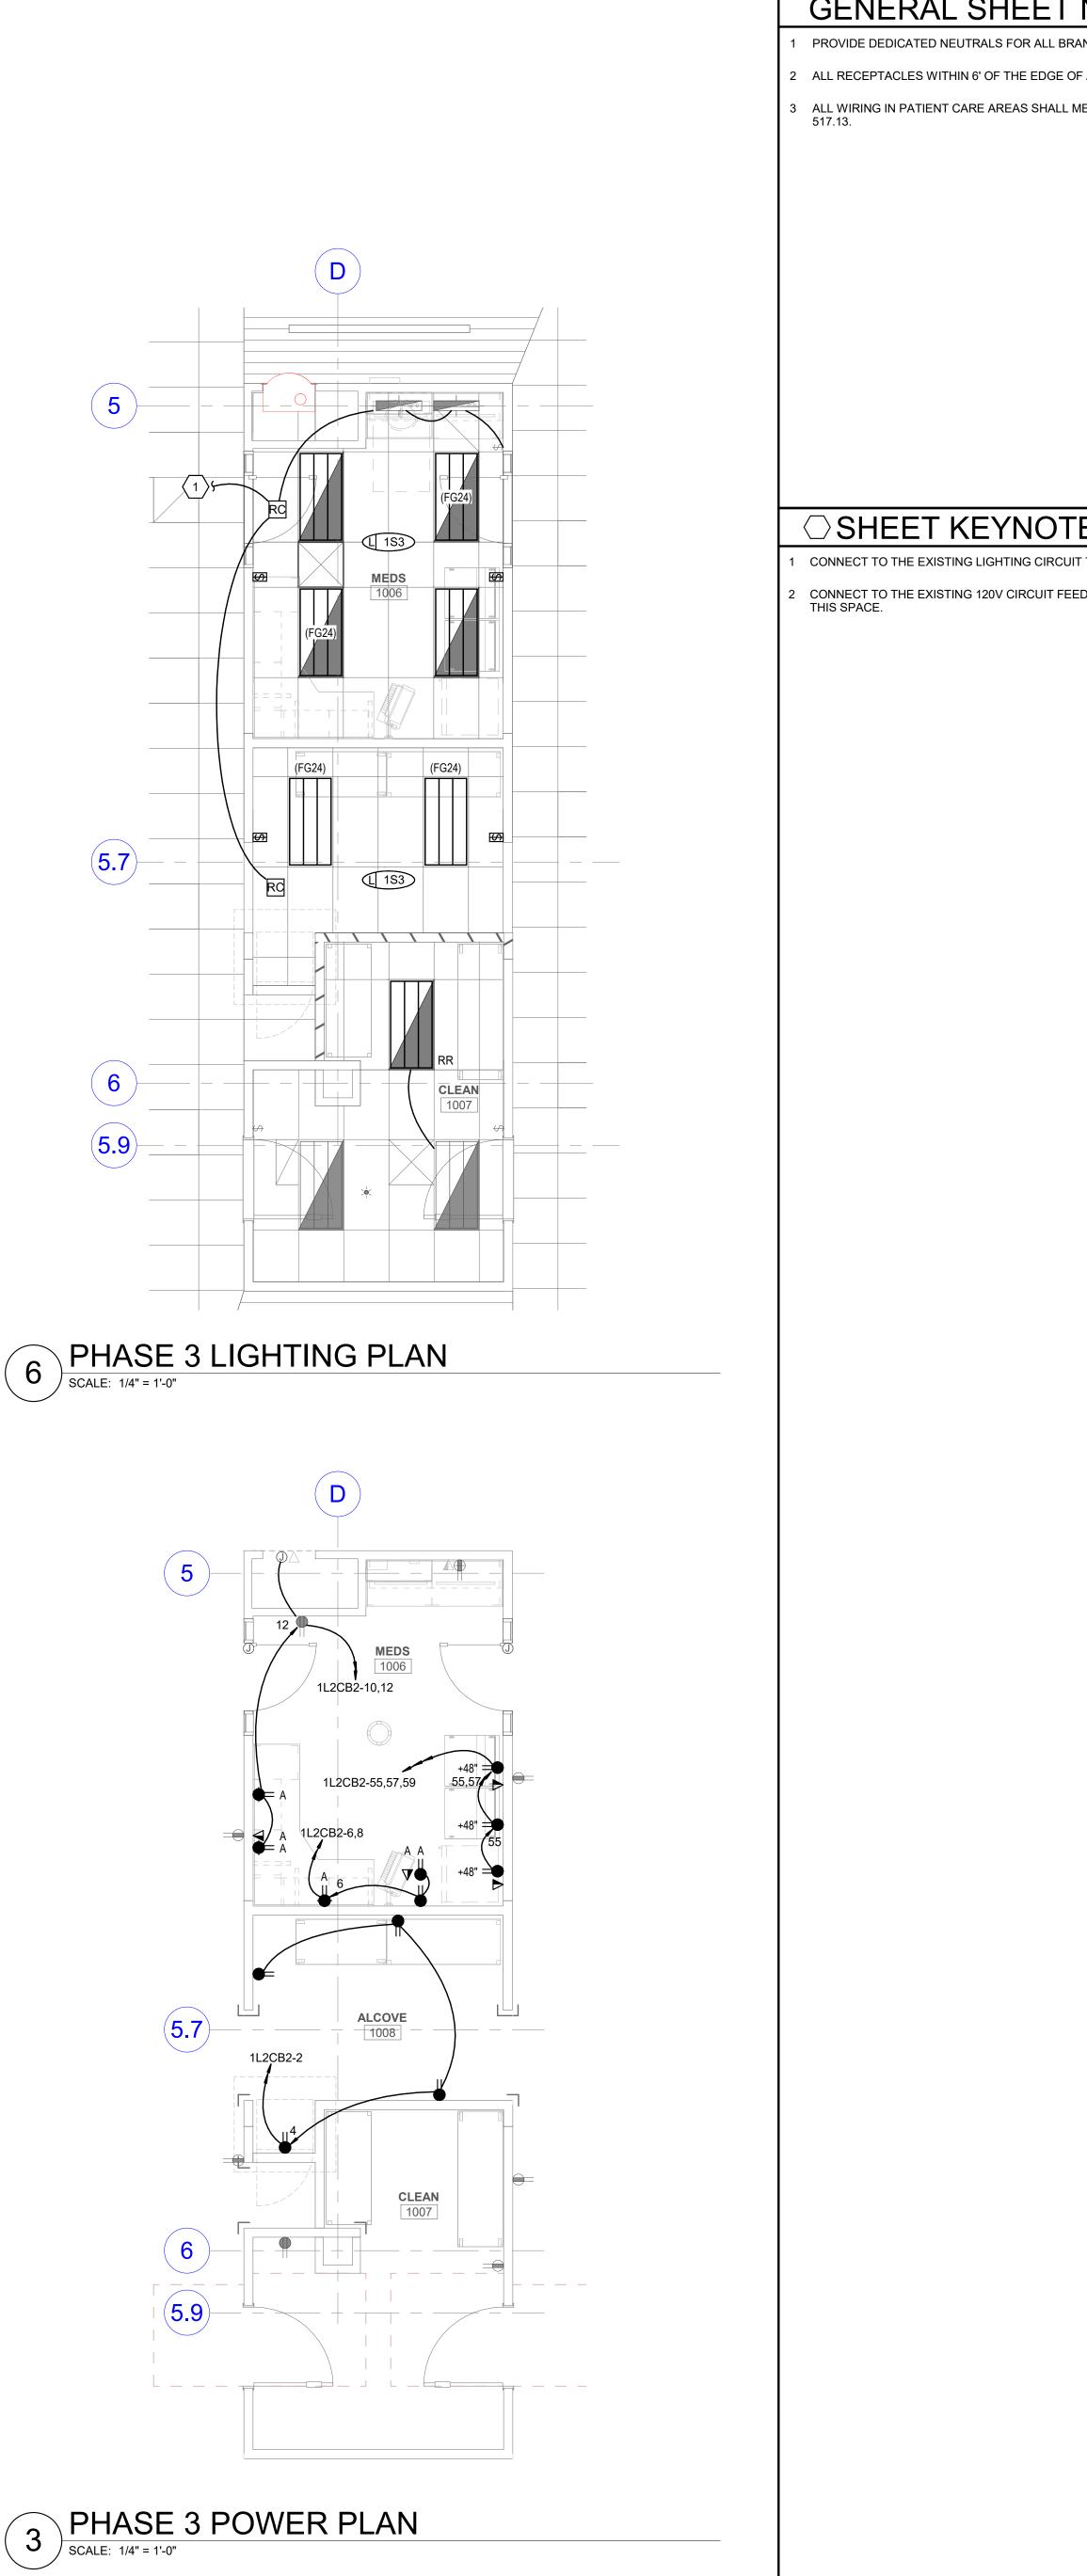

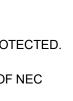










KEY PLAN

REVISION NO. DESCRIPTION

DATE

HKS PROJECT NUMBER 26404.000 DATE 08/15/24 ISSUE CONSTRUCTION DRAWINGS SHEET TITLE LEVEL 1 ED ELECTRICAL PLANS SHEET NO.

EP101

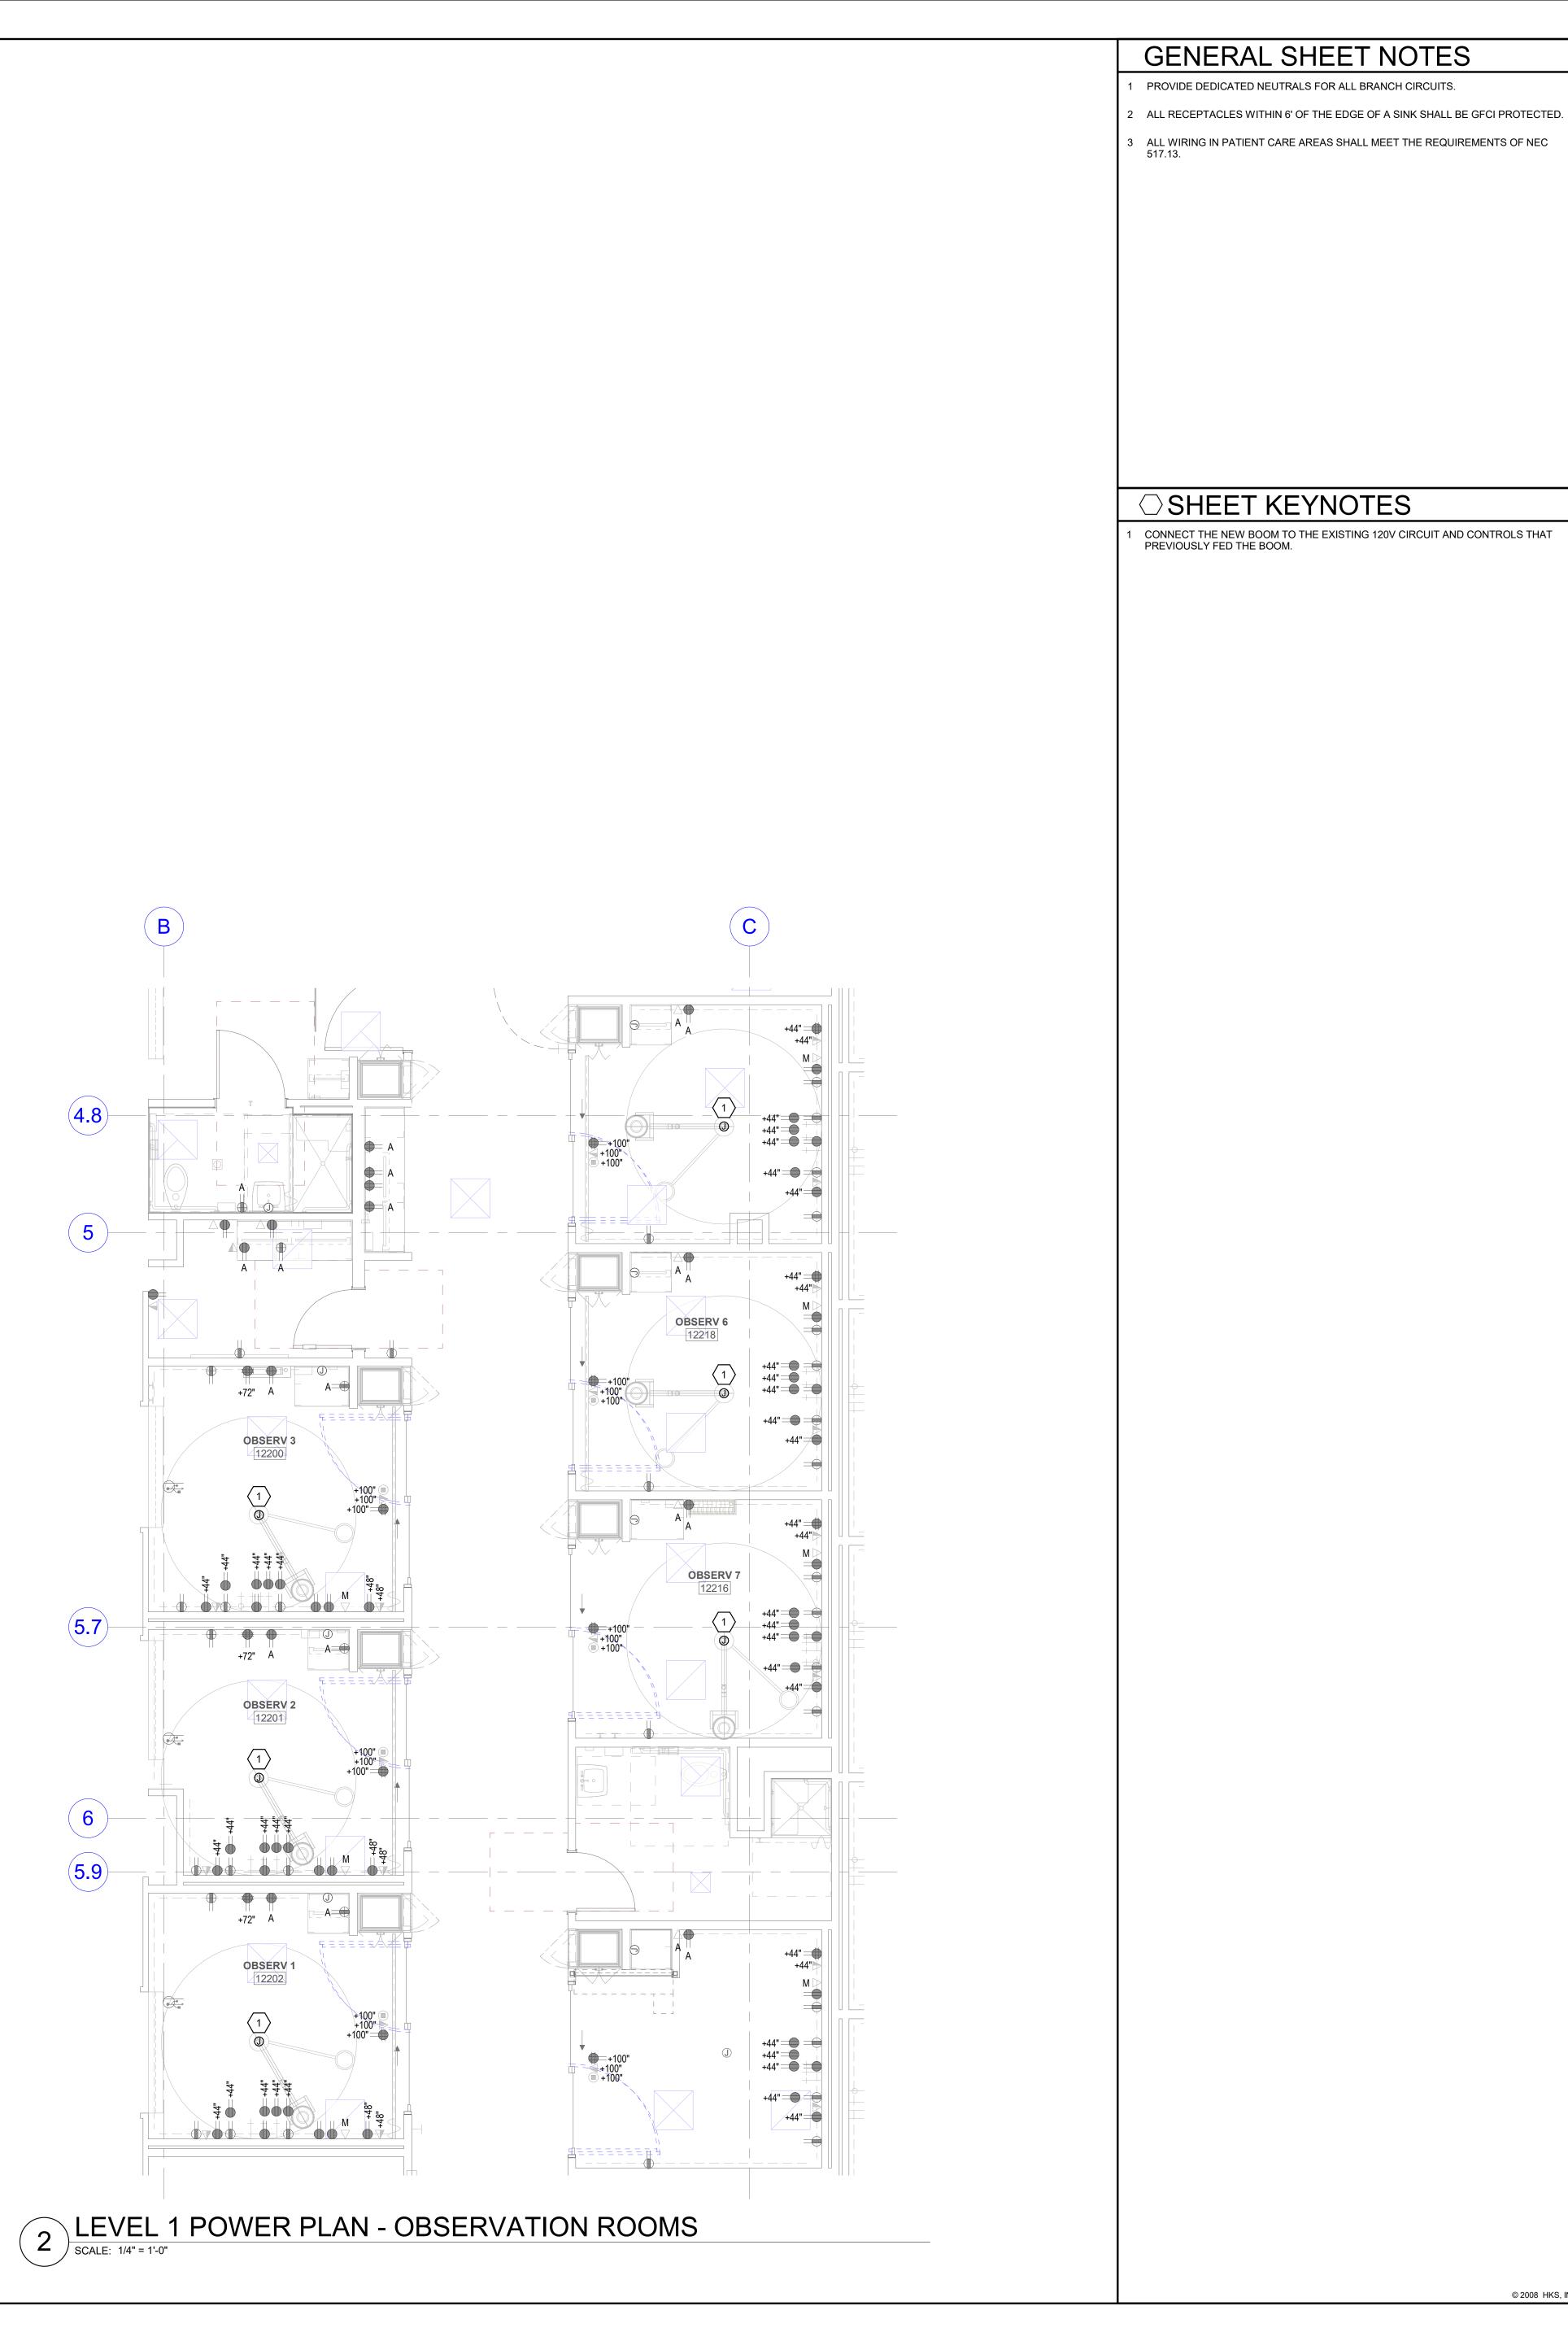






STRUCTURAL ENGINEER **REAVELEY ENGINEERS & ASSOCIATES** 675 EAST 500 SOUTH, SUITE 400 SALT LAKE CITY, UTAH 84102

MECHANICAL ENGINEER VAN BOERUM & FRANK ASSOCIATES, INC 181 EAST 5600 SOUTH, SUITE 130 MURRAY, UTAH 84107

ELECTRICAL ENGINEER SPECTRUM ENGINEERS, INC 324 SOUTH STATE STREET, SUITE 400 SALT LAKE CITY, UTAH 84111



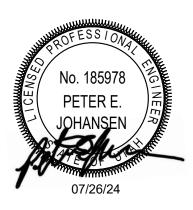





KEY PLAN


REVISION NO. DESCRIPTION


HKS PROJECT NUMBER


DATE

26404.000 DATE 08/15/24 ISSUE CONSTRUCTION DRAWINGS SHEET TITLE ED OBSERVATION **ROOM ELECTRICAL** PLANS SHEET NO.



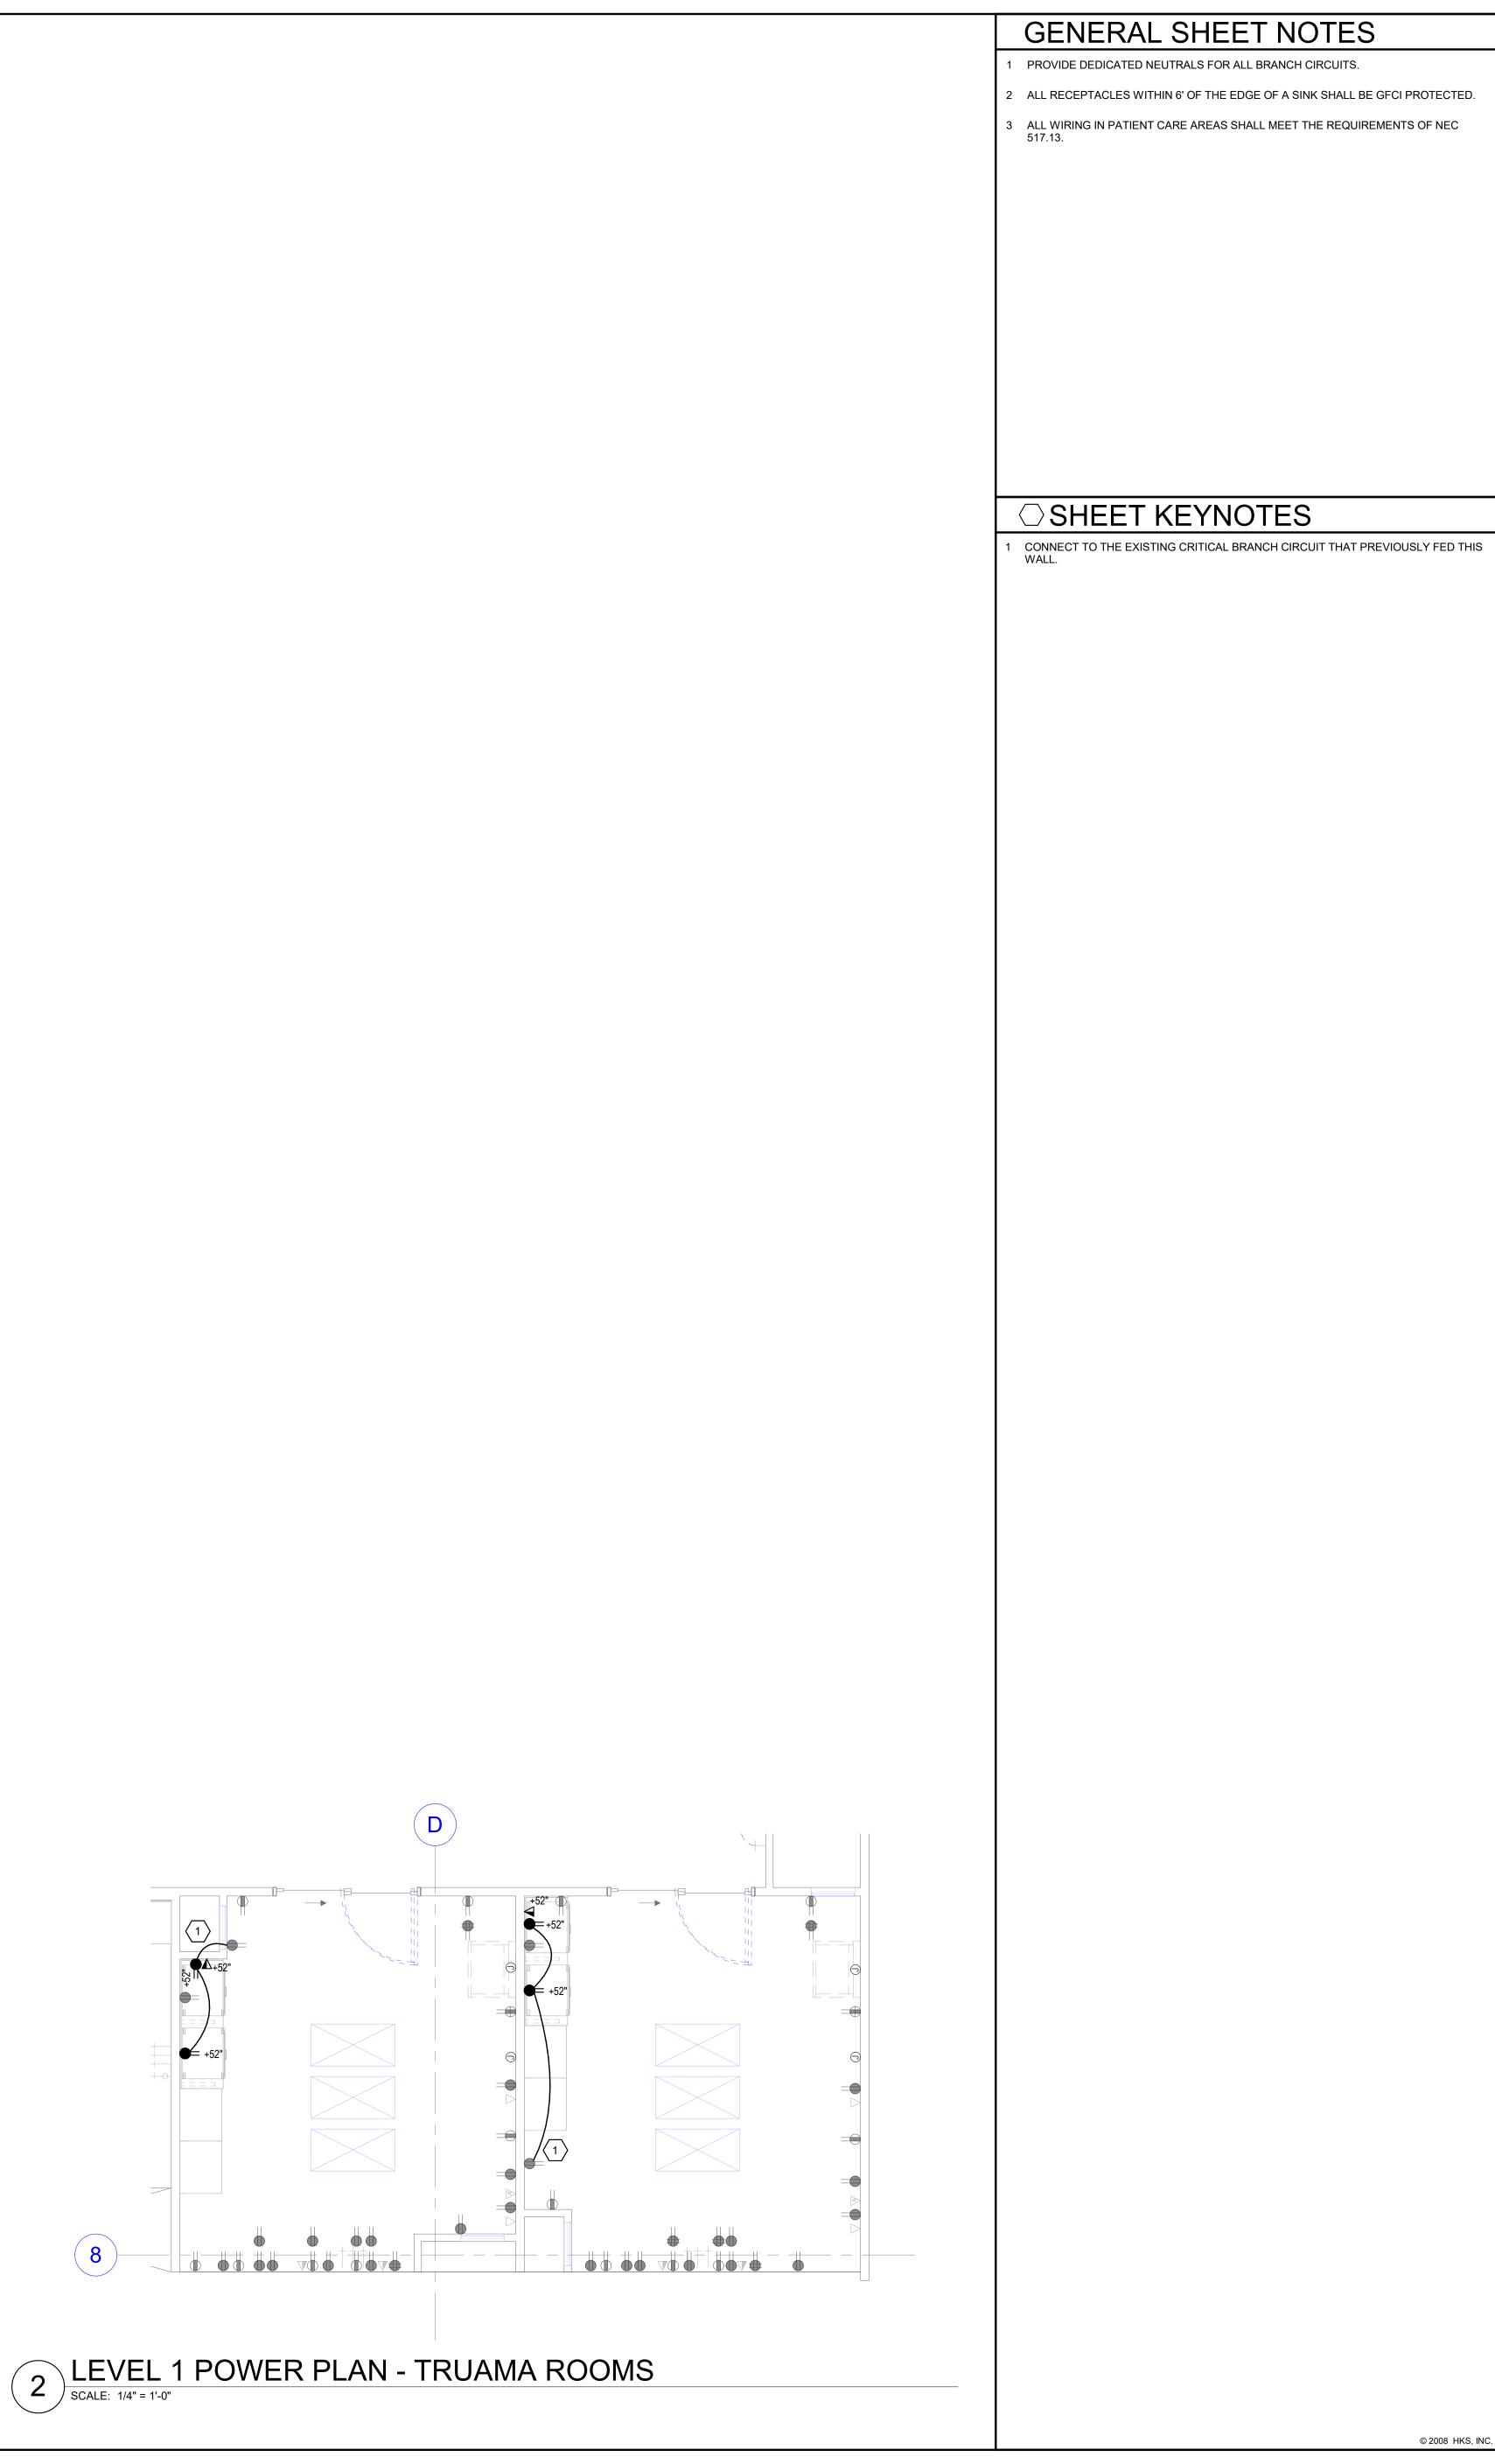

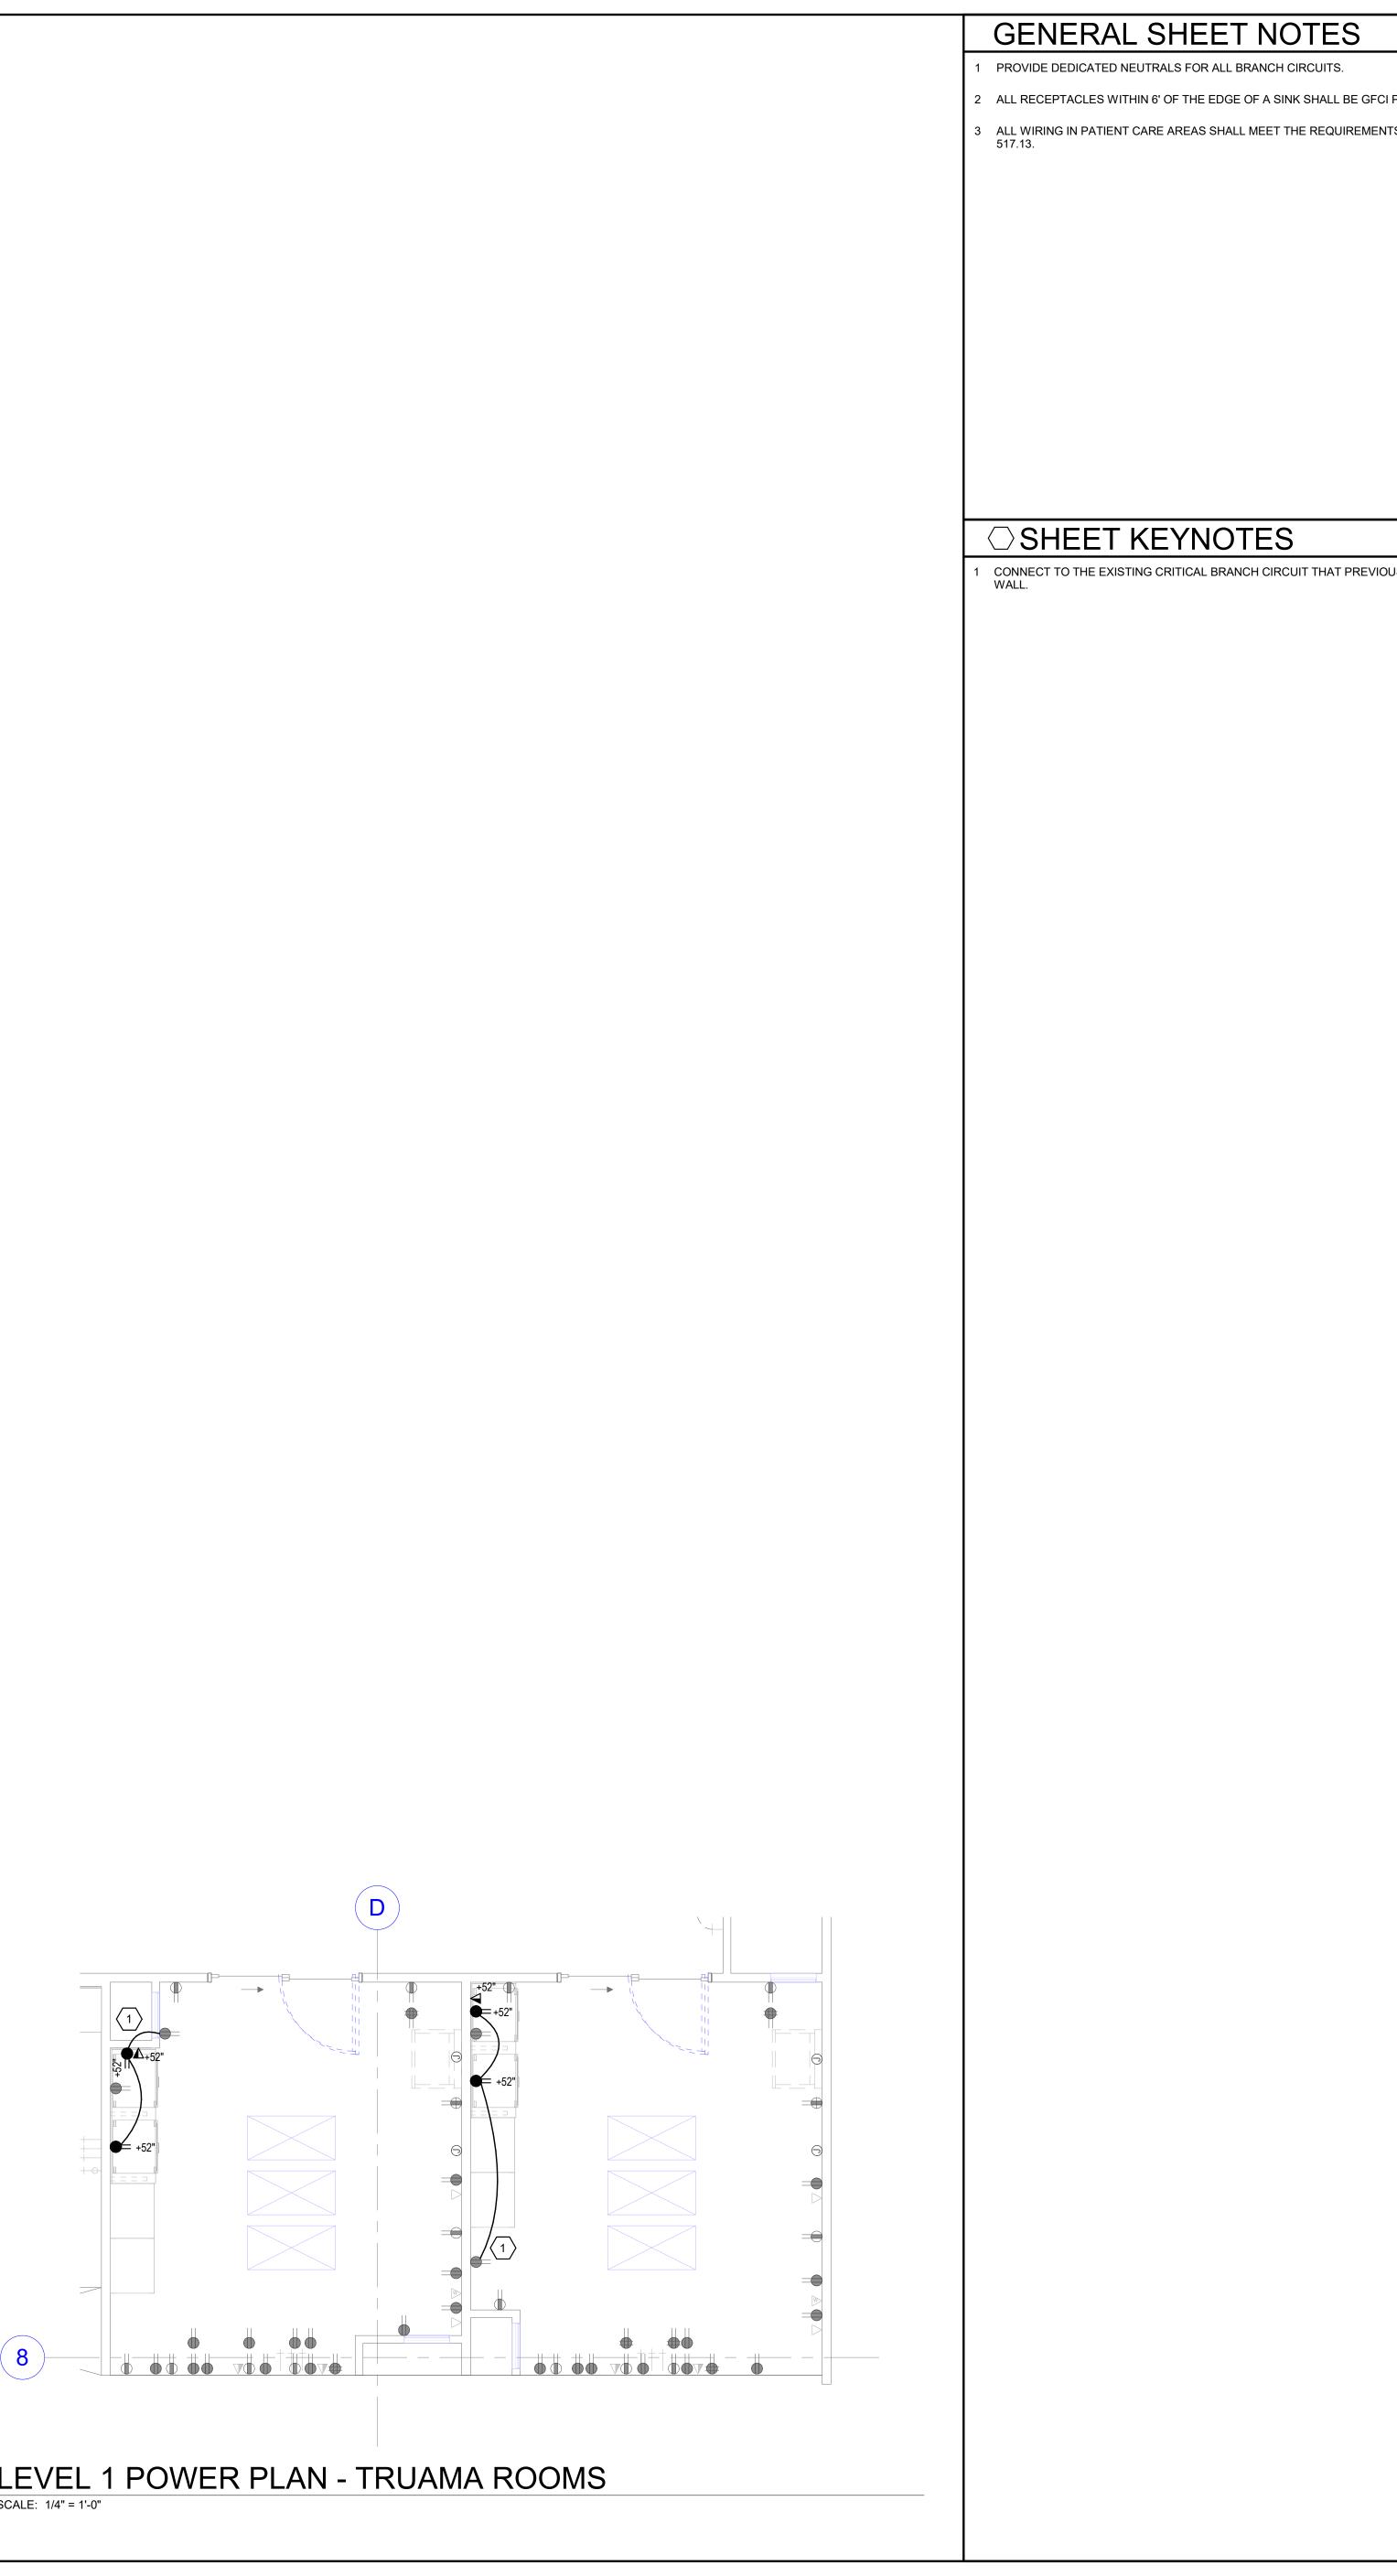

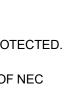



STRUCTURAL ENGINEER **REAVELEY ENGINEERS & ASSOCIATES** 675 EAST 500 SOUTH, SUITE 400 SALT LAKE CITY, UTAH 84102

MECHANICAL ENGINEER VAN BOERUM & FRANK ASSOCIATES, INC 181 EAST 5600 SOUTH, SUITE 130 MURRAY, UTAH 84107

ELECTRICAL ENGINEER SPECTRUM ENGINEERS, INC 324 SOUTH STATE STREET, SUITE 400 SALT LAKE CITY, UTAH 84111










KEY PLAN

REVISION NO. DESCRIPTION DATE

HKS PROJECT NUMBER 26404.000 DATE 08/15/24 ISSUE CONSTRUCTION DRAWINGS SHEET TITLE ED TRAUMA ROOM ELECTRICAL PLANS SHEET NO.



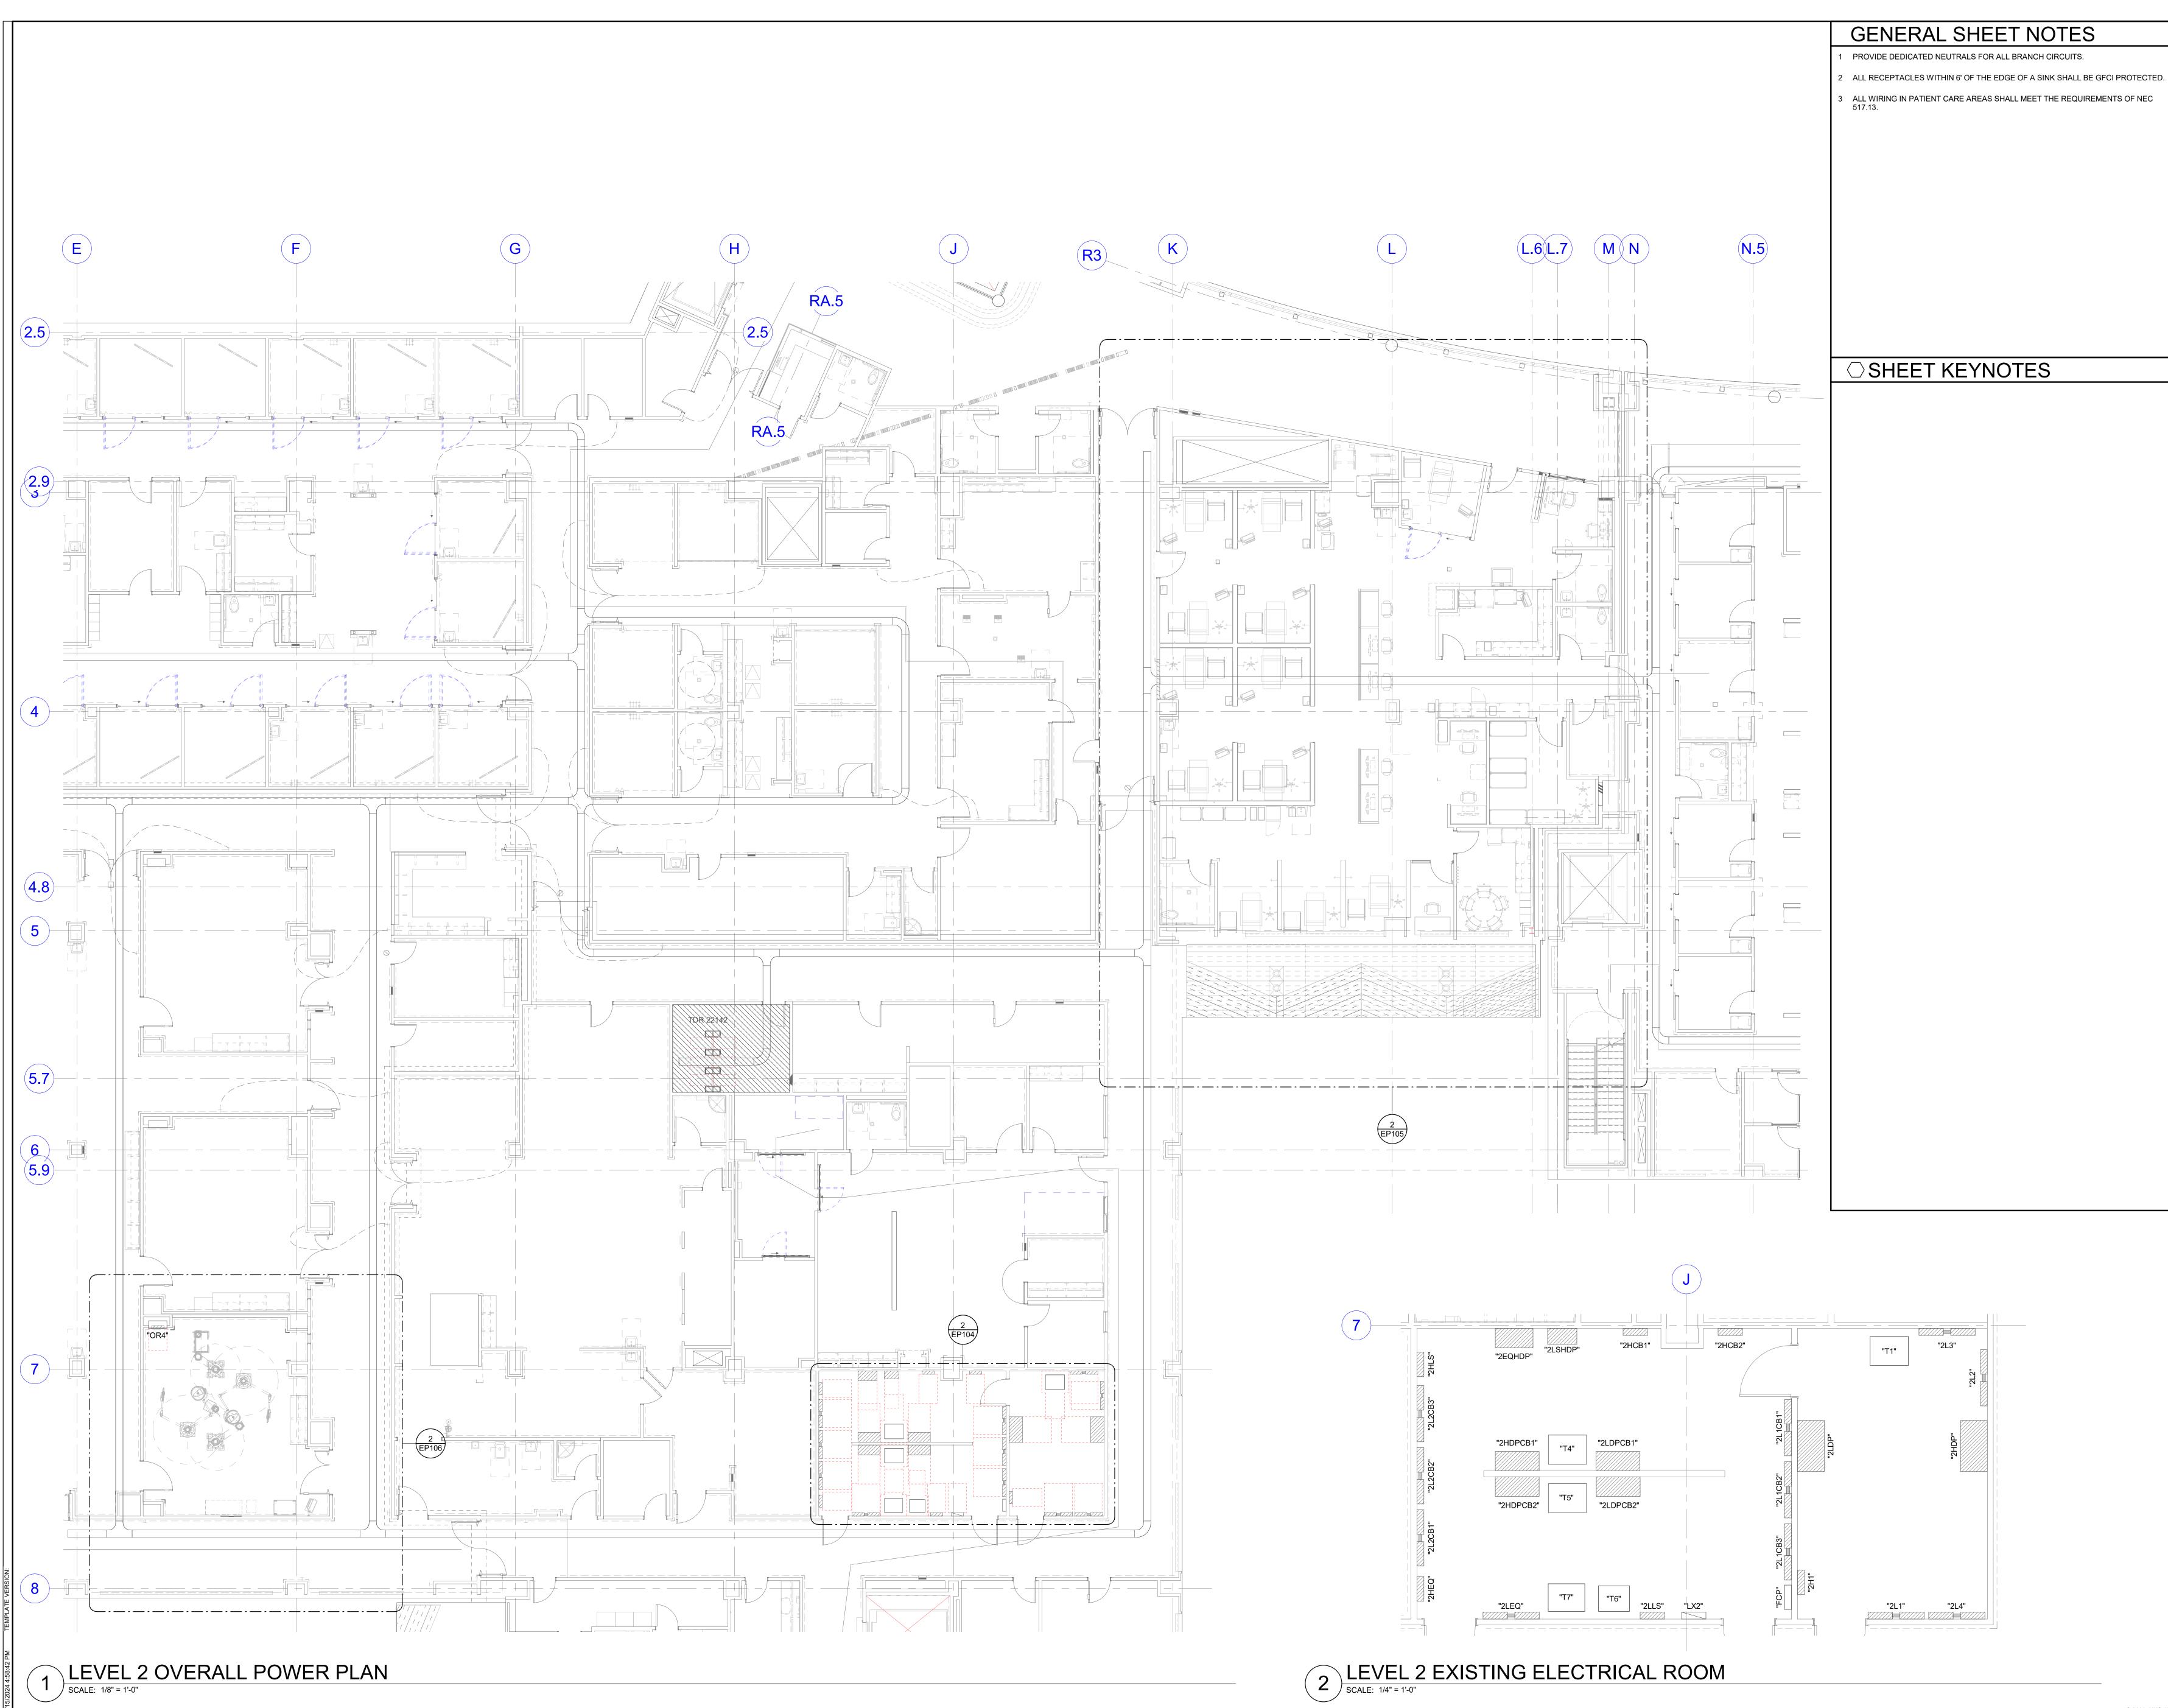



STRUCTURAL ENGINEER **REAVELEY ENGINEERS & ASSOCIATES** 675 EAST 500 SOUTH, SUITE 400 SALT LAKE CITY, UTAH 84102

MECHANICAL ENGINEER VAN BOERUM & FRANK ASSOCIATES, INC 181 EAST 5600 SOUTH, SUITE 130 MURRAY, UTAH 84107

ELECTRICAL ENGINEER SPECTRUM ENGINEERS, INC 324 SOUTH STATE STREET, SUITE 400 SALT LAKE CITY, UTAH 84111










KEY PLAN


REVISION NO. DESCRIPTION


26404.000 DATE 08/15/24 ISSUE CONSTRUCTION DRAWINGS SHEET TITLE **LEVEL 2 OVERALL POWER PLAN**

HKS PROJECT NUMBER



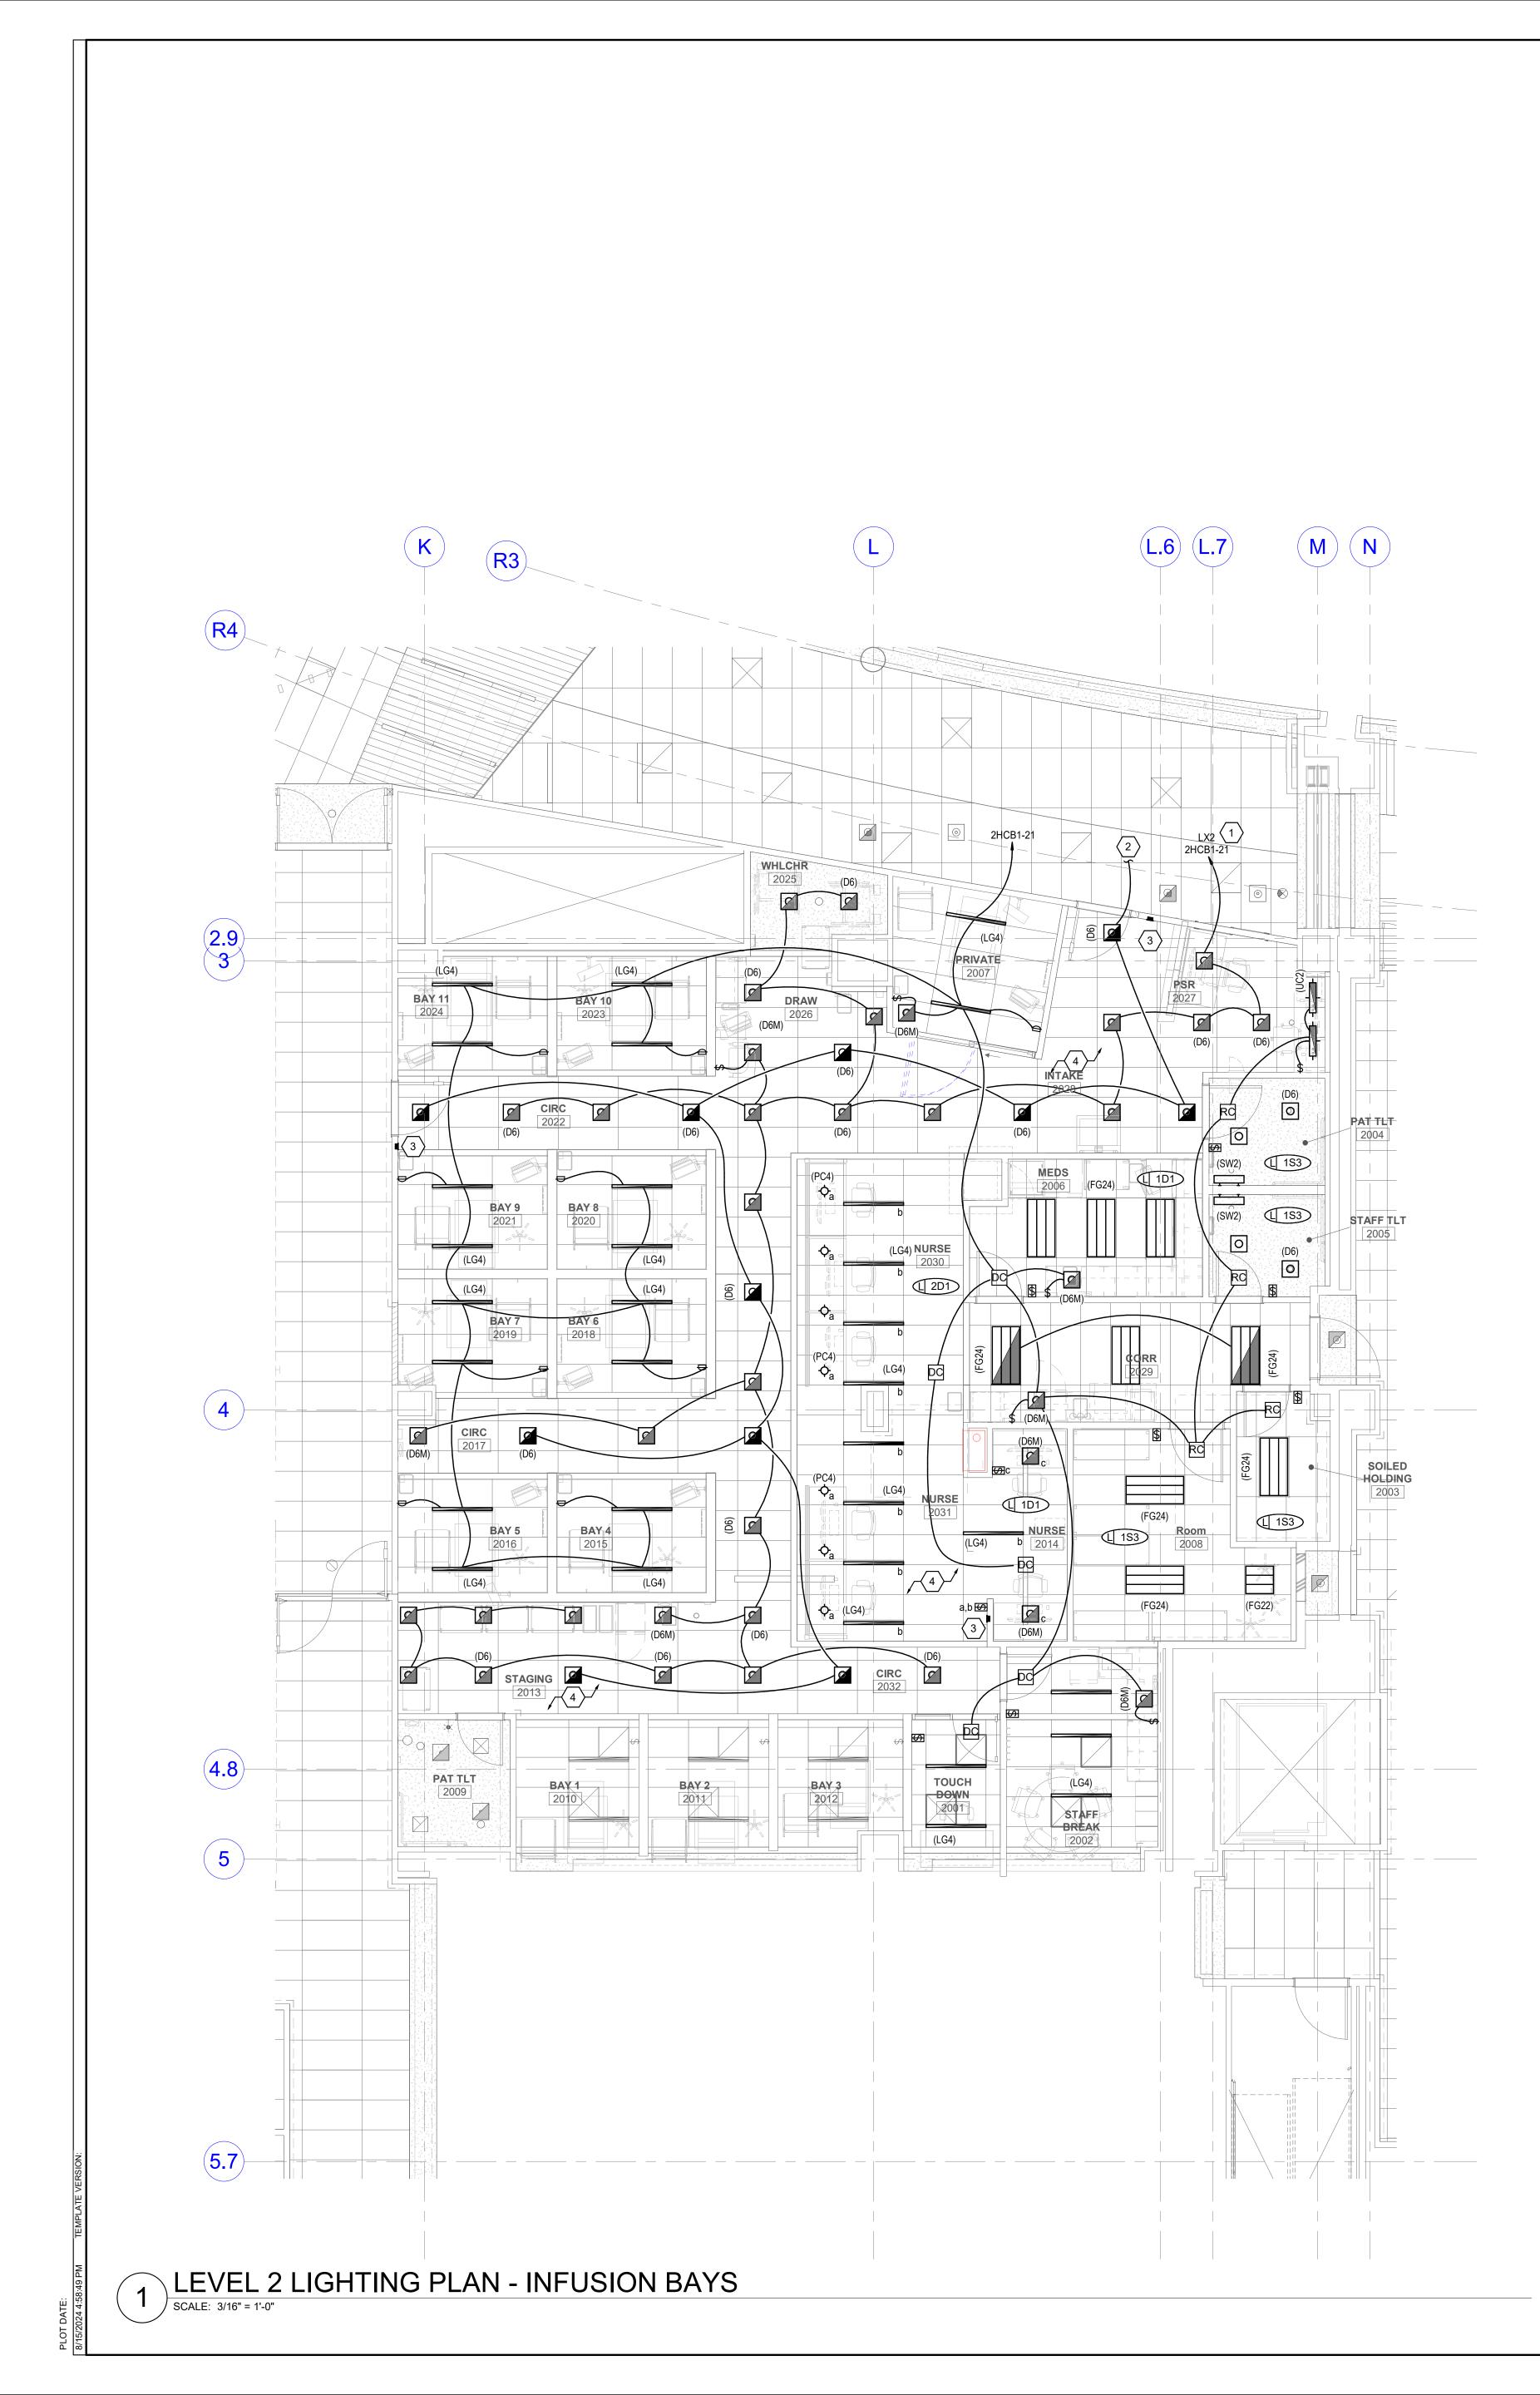

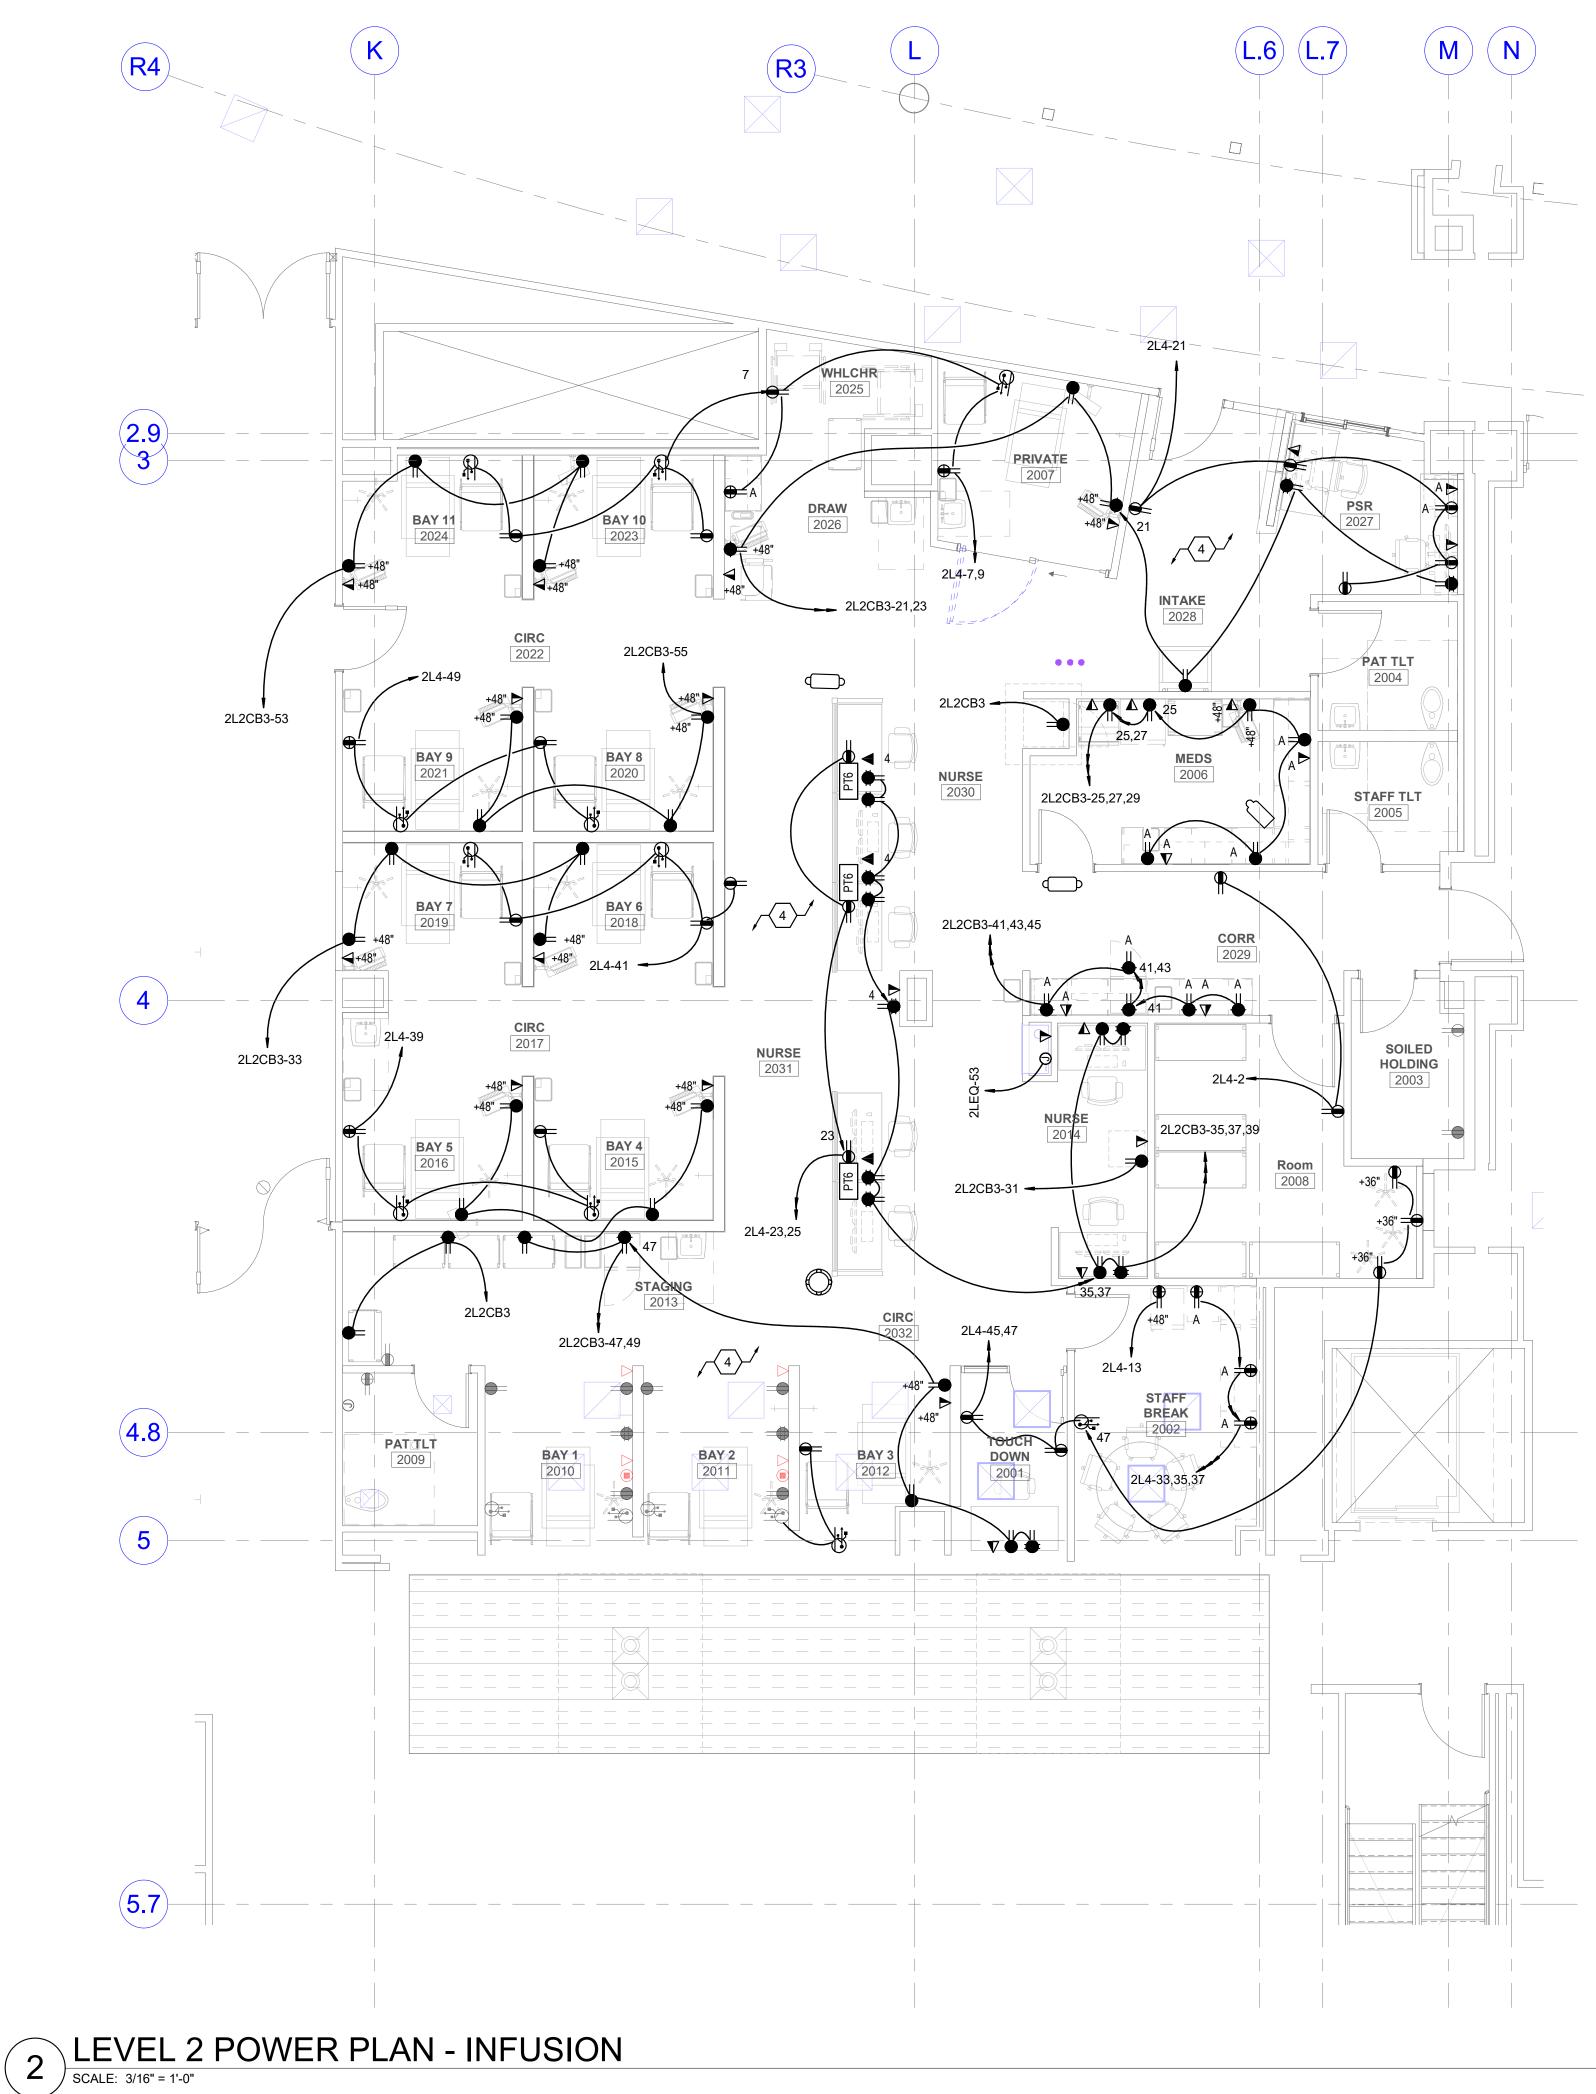

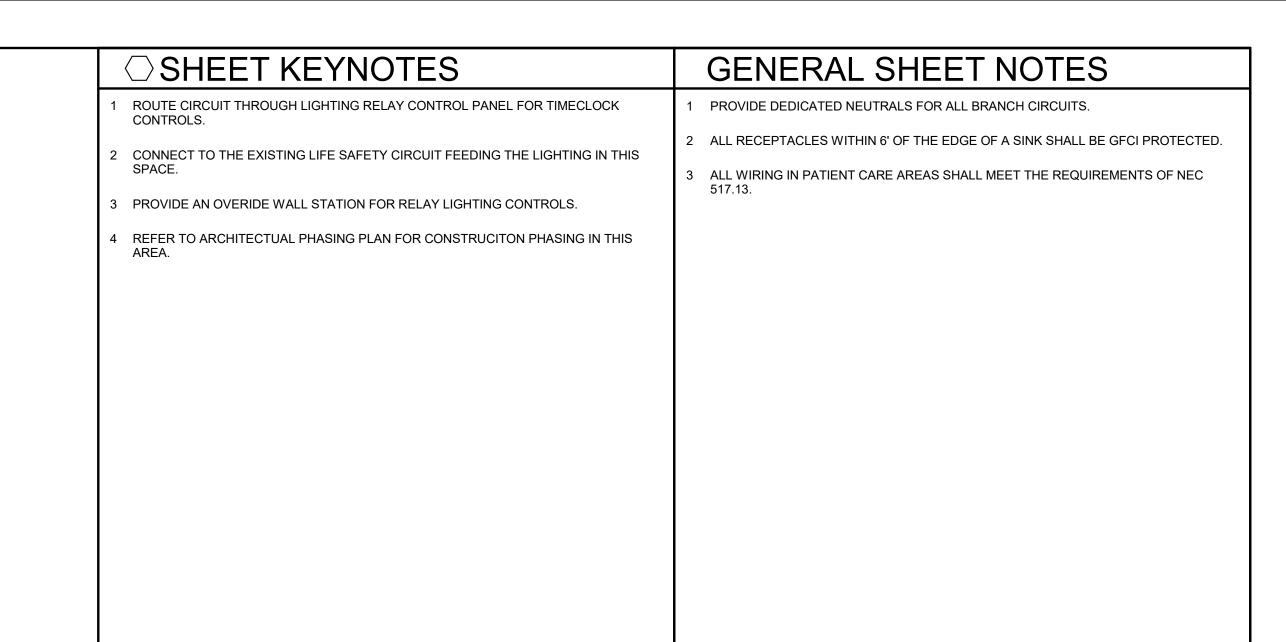



STRUCTURAL ENGINEER **REAVELEY ENGINEERS & ASSOCIATES** 675 EAST 500 SOUTH, SUITE 400 SALT LAKE CITY, UTAH 84102

MECHANICAL ENGINEER VAN BOERUM & FRANK ASSOCIATES, INC 181 EAST 5600 SOUTH, SUITE 130 MURRAY, UTAH 84107

ELECTRICAL ENGINEER SPECTRUM ENGINEERS, INC 324 SOUTH STATE STREET, SUITE 400 SALT LAKE CITY, UTAH 84111









KEY PLAN


REVISION NO. DESCRIPTION


DATE

HKS PROJECT NUMBER 26404.000 DATE 08/15/24 ISSUE CONSTRUCTION DRAWINGS SHEET TITLE INFUSION ELECTRICAL PLANS SHEET NO.





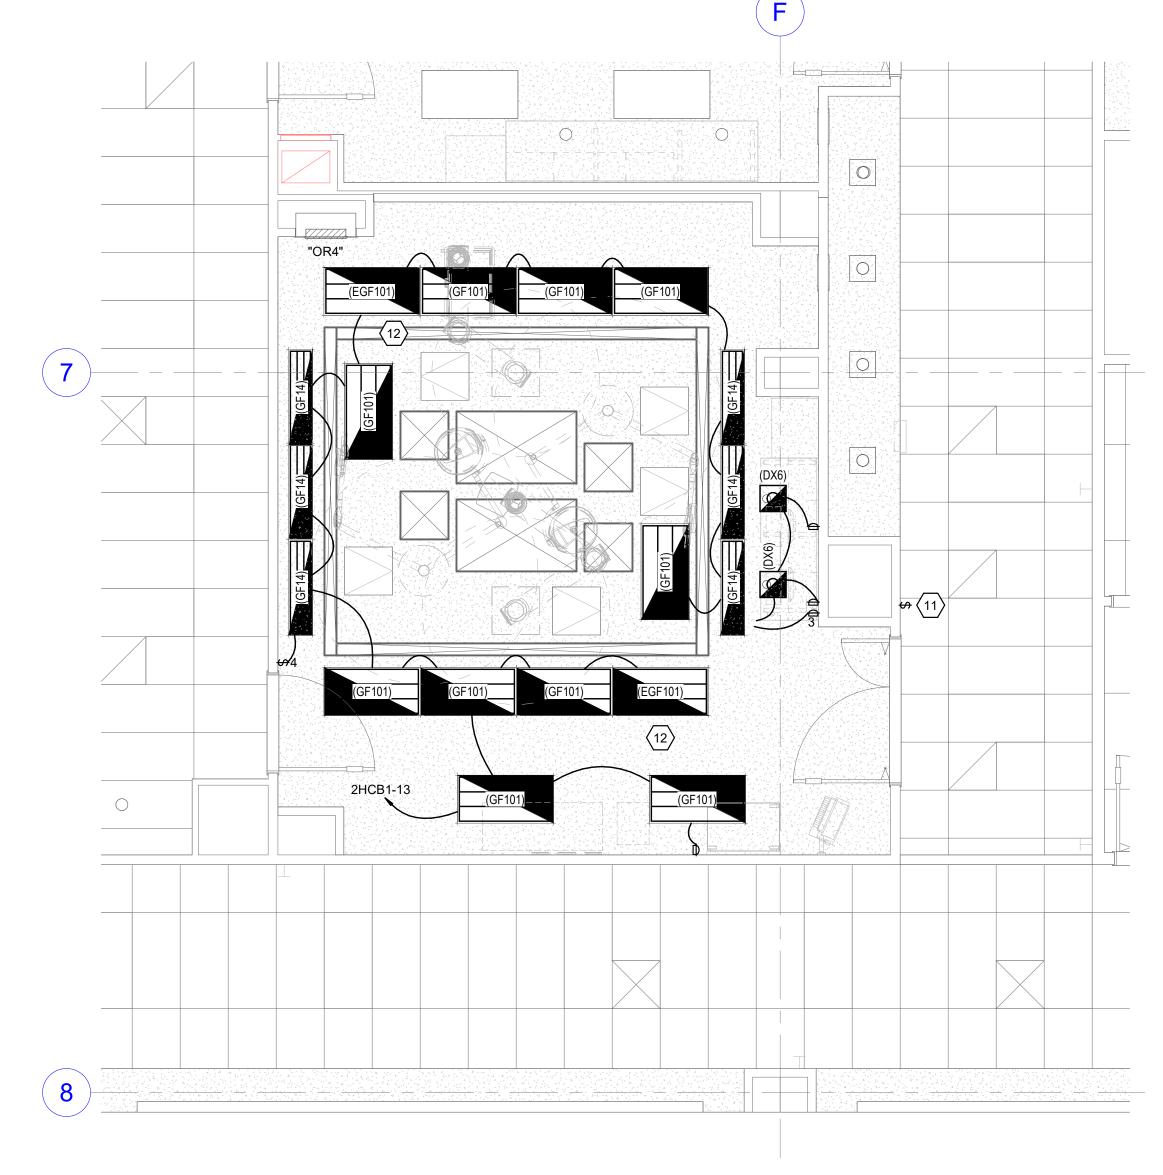

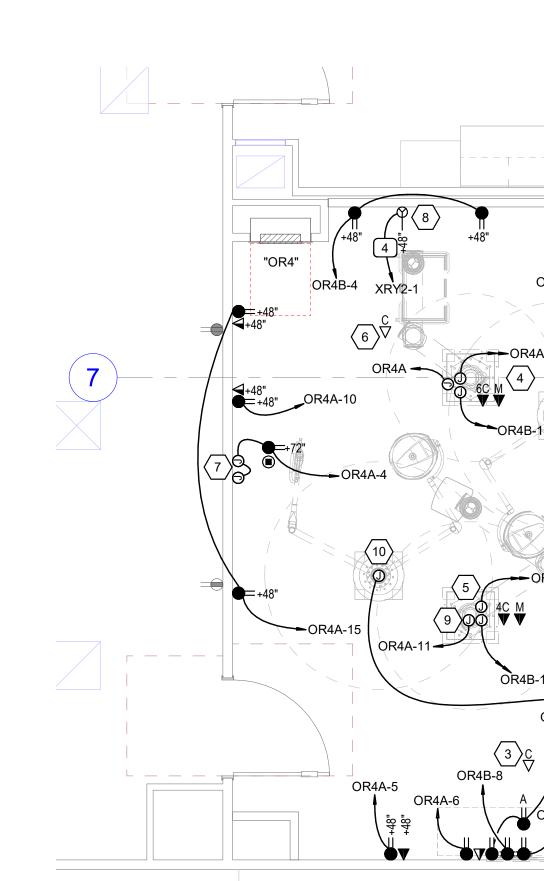

2 LEVEL 2 POWER PLAN - OR SCALE: 1/4" = 1'-0"

8

	GENERAL SHEET NOTES
	 PROVIDE DEDICATED NEUTRALS FOR ALL BRANCH CIRCUITS. ALL RECEPTACLES WITHIN 6' OF THE EDGE OF A SINK SHALL BE GFCI PROTECTED.
	3 ALL WIRING IN PATIENT CARE AREAS SHALL MEET THE REQUIREMENTS OF NEC 517.13.
	SHEET KEYNOTES 1 120 VOLT POWER SUPPLY FOR OR ROOM SURGICAL LIGHT. RUN LOW VOLTAGE
	CABLING TO CONTROL PANEL, AND TO STERIS LIGHTING BOOM. SEE STERIS DRAWINGS FOR INSTALLATION INSTRUCTIONS.
	2 POWER AND DATA FOR PAX.3 DATA IN CEILING FOR CAMERA.
	4 PROVIDE THE FOLLOWING TO ANESTHESIA BOOM: THREE ISOLATED 120 VOLT CIRCUITS, FROM CRITICAL BRANCH #1, AND TWO ISOLATED 20 AMP CIRCUITS FROM
	CRITICAL BRANCH #2 AND SIX DATA DROPS. SEE STERIS DRAWING MGB01 FOR ADDITIONAL CONTRACTOR INSTALLATION RESPONSIBILITIES.
	5 PROVIDE THE FOLLOWING TO EQUIPMENT BOOM: FOUR EMERGENCY ISOLATED 120 VOLT CIRCUITS, FOUR DATA DROPS.
	6 PROVIDE DATA IN CEILING FOR ROOM STATUS CAMERA.7 POWER FOR ELAPSED TIME AND CURRENT TIME DIGITAL CLOCKS. RESET BUTTON
	WILL MOUNT ABOVE COUNTER AT NURSE CHART STATION.
	8 L6 30R GE X-RAY OUTLET W/ DRA-1 LIM SIGNAL AND PLUG CONTROL. TYPE RXO-RGE. CIRCUIT TO LASER ISOLATION PANELS IN STERILE CORE. PROVIDE REMOTE MONITOR WITH RECEPTACLE. XRY2 FEED LASER RECEPTACLES LOCATED IN OR#4, OR#5 AND OR#6.
	9 120V POWER FOR EMS BRAKES.
	10 PROVIDE 120V POWER TO MONITOR/LIGHT BOOM LSD01. SEE STERIS DRAWINGS FOR ADDITIONAL CONTRACTOR INSTALLATION RESPONSIBILITIES AUDIO/VIDEO CONNECTIONS, AC LINE VOLTAGE AND DC CONNECTION AND COMMUNICATION
	 11 PROVIDE KEYED SWITCH AT 72" AFF FOR TESTING BATTERY PACKS IN EACH OR.
	12 PROVIDE BATTERY PACK IN TWO GF101 FIXTURES.
F	
+48" =	
OR4A-2	
RR OR4B-5 OR4A-14	
R4A-8 OR4B-7 OR4B-9	
	•

> ARCHITECT HKS ARCHITECTS, INC. 222 SOUTH MAIN, SUITE 230

SALT LAKE CITY, UT 84101 STRUCTURAL ENGINEER

REAVELEY ENGINEERS & ASSOCIATES 675 EAST 500 SOUTH, SUITE 400 SALT LAKE CITY, UTAH 84102

MECHANICAL ENGINEER VAN BOERUM & FRANK ASSOCIATES, INC 181 EAST 5600 SOUTH, SUITE 130 MURRAY, UTAH 84107

ELECTRICAL ENGINEER SPECTRUM ENGINEERS, INC 324 SOUTH STATE STREET, SUITE 400 SALT LAKE CITY, UTAH 84111









NO. DESCRIPTION

DATE

KEY PLAN

REVISION

HKS PROJECT NUMBER 26404.000 DATE 08/15/24 ISSUE CONSTRUCTION DRAWINGS SHEET TITLE OR ELECTRICAL PLANS

SHEET NO.







STRUCTURAL ENGINEER **REAVELEY ENGINEERS & ASSOCIATES** 675 EAST 500 SOUTH, SUITE 400 SALT LAKE CITY, UTAH 84102

MECHANICAL ENGINEER VAN BOERUM & FRANK ASSOCIATES, INC 181 EAST 5600 SOUTH, SUITE 130 MURRAY, UTAH 84107

ELECTRICAL ENGINEER SPECTRUM ENGINEERS, INC 324 SOUTH STATE STREET, SUITE 400 SALT LAKE CITY, UTAH 84111









KEY PLAN

REVISION NO. DESCRIPTION

HKS PROJECT NUMBER

DATE


26404.000 DATE 08/15/24 ISSUE CONSTRUCTION DRAWINGS SHEET TITLE LEVEL 3 OVERALL **POWER PLAN**







(4)

1 LEVEL 3 LIGHTING PLAN - LDR SCALE: 1/4" = 1'-0"

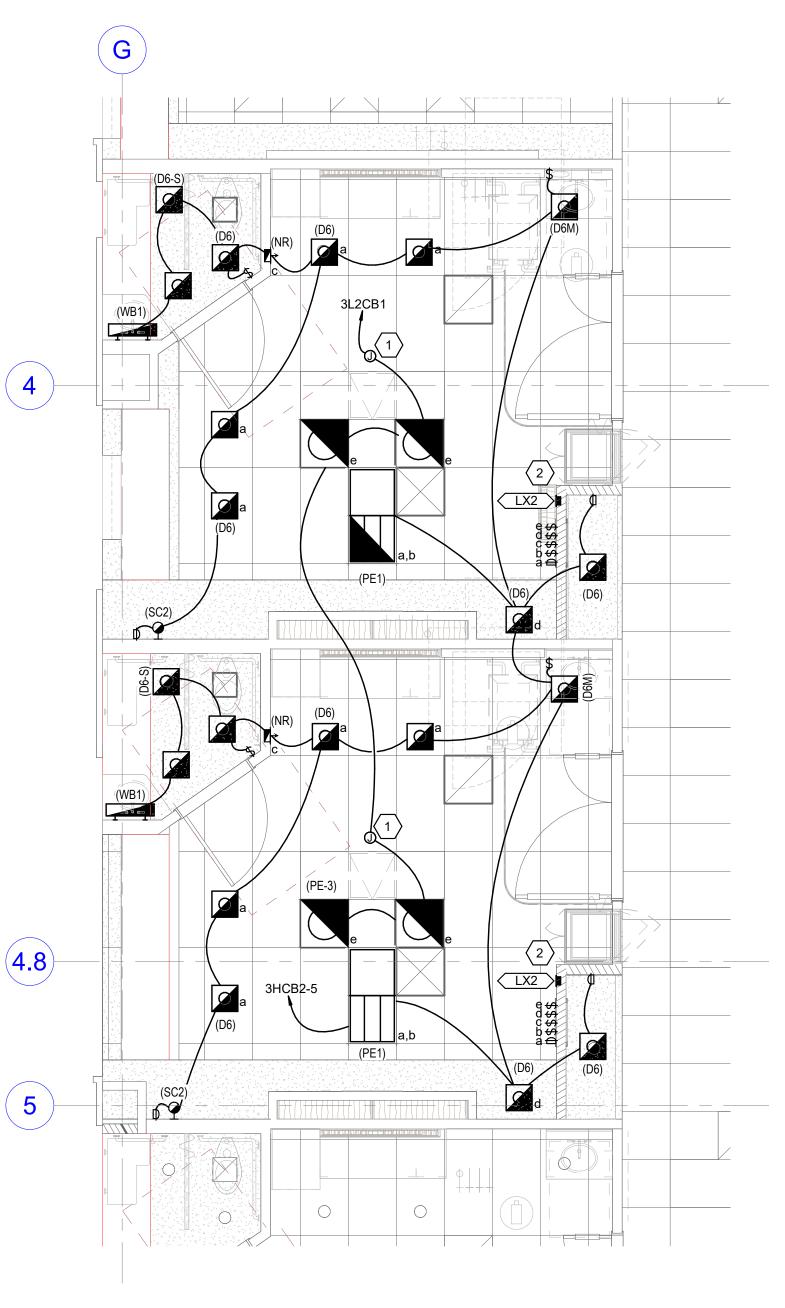

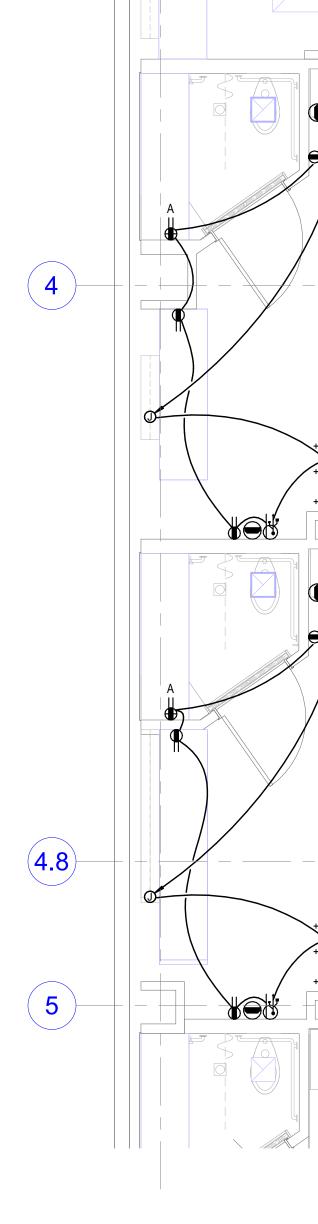

G

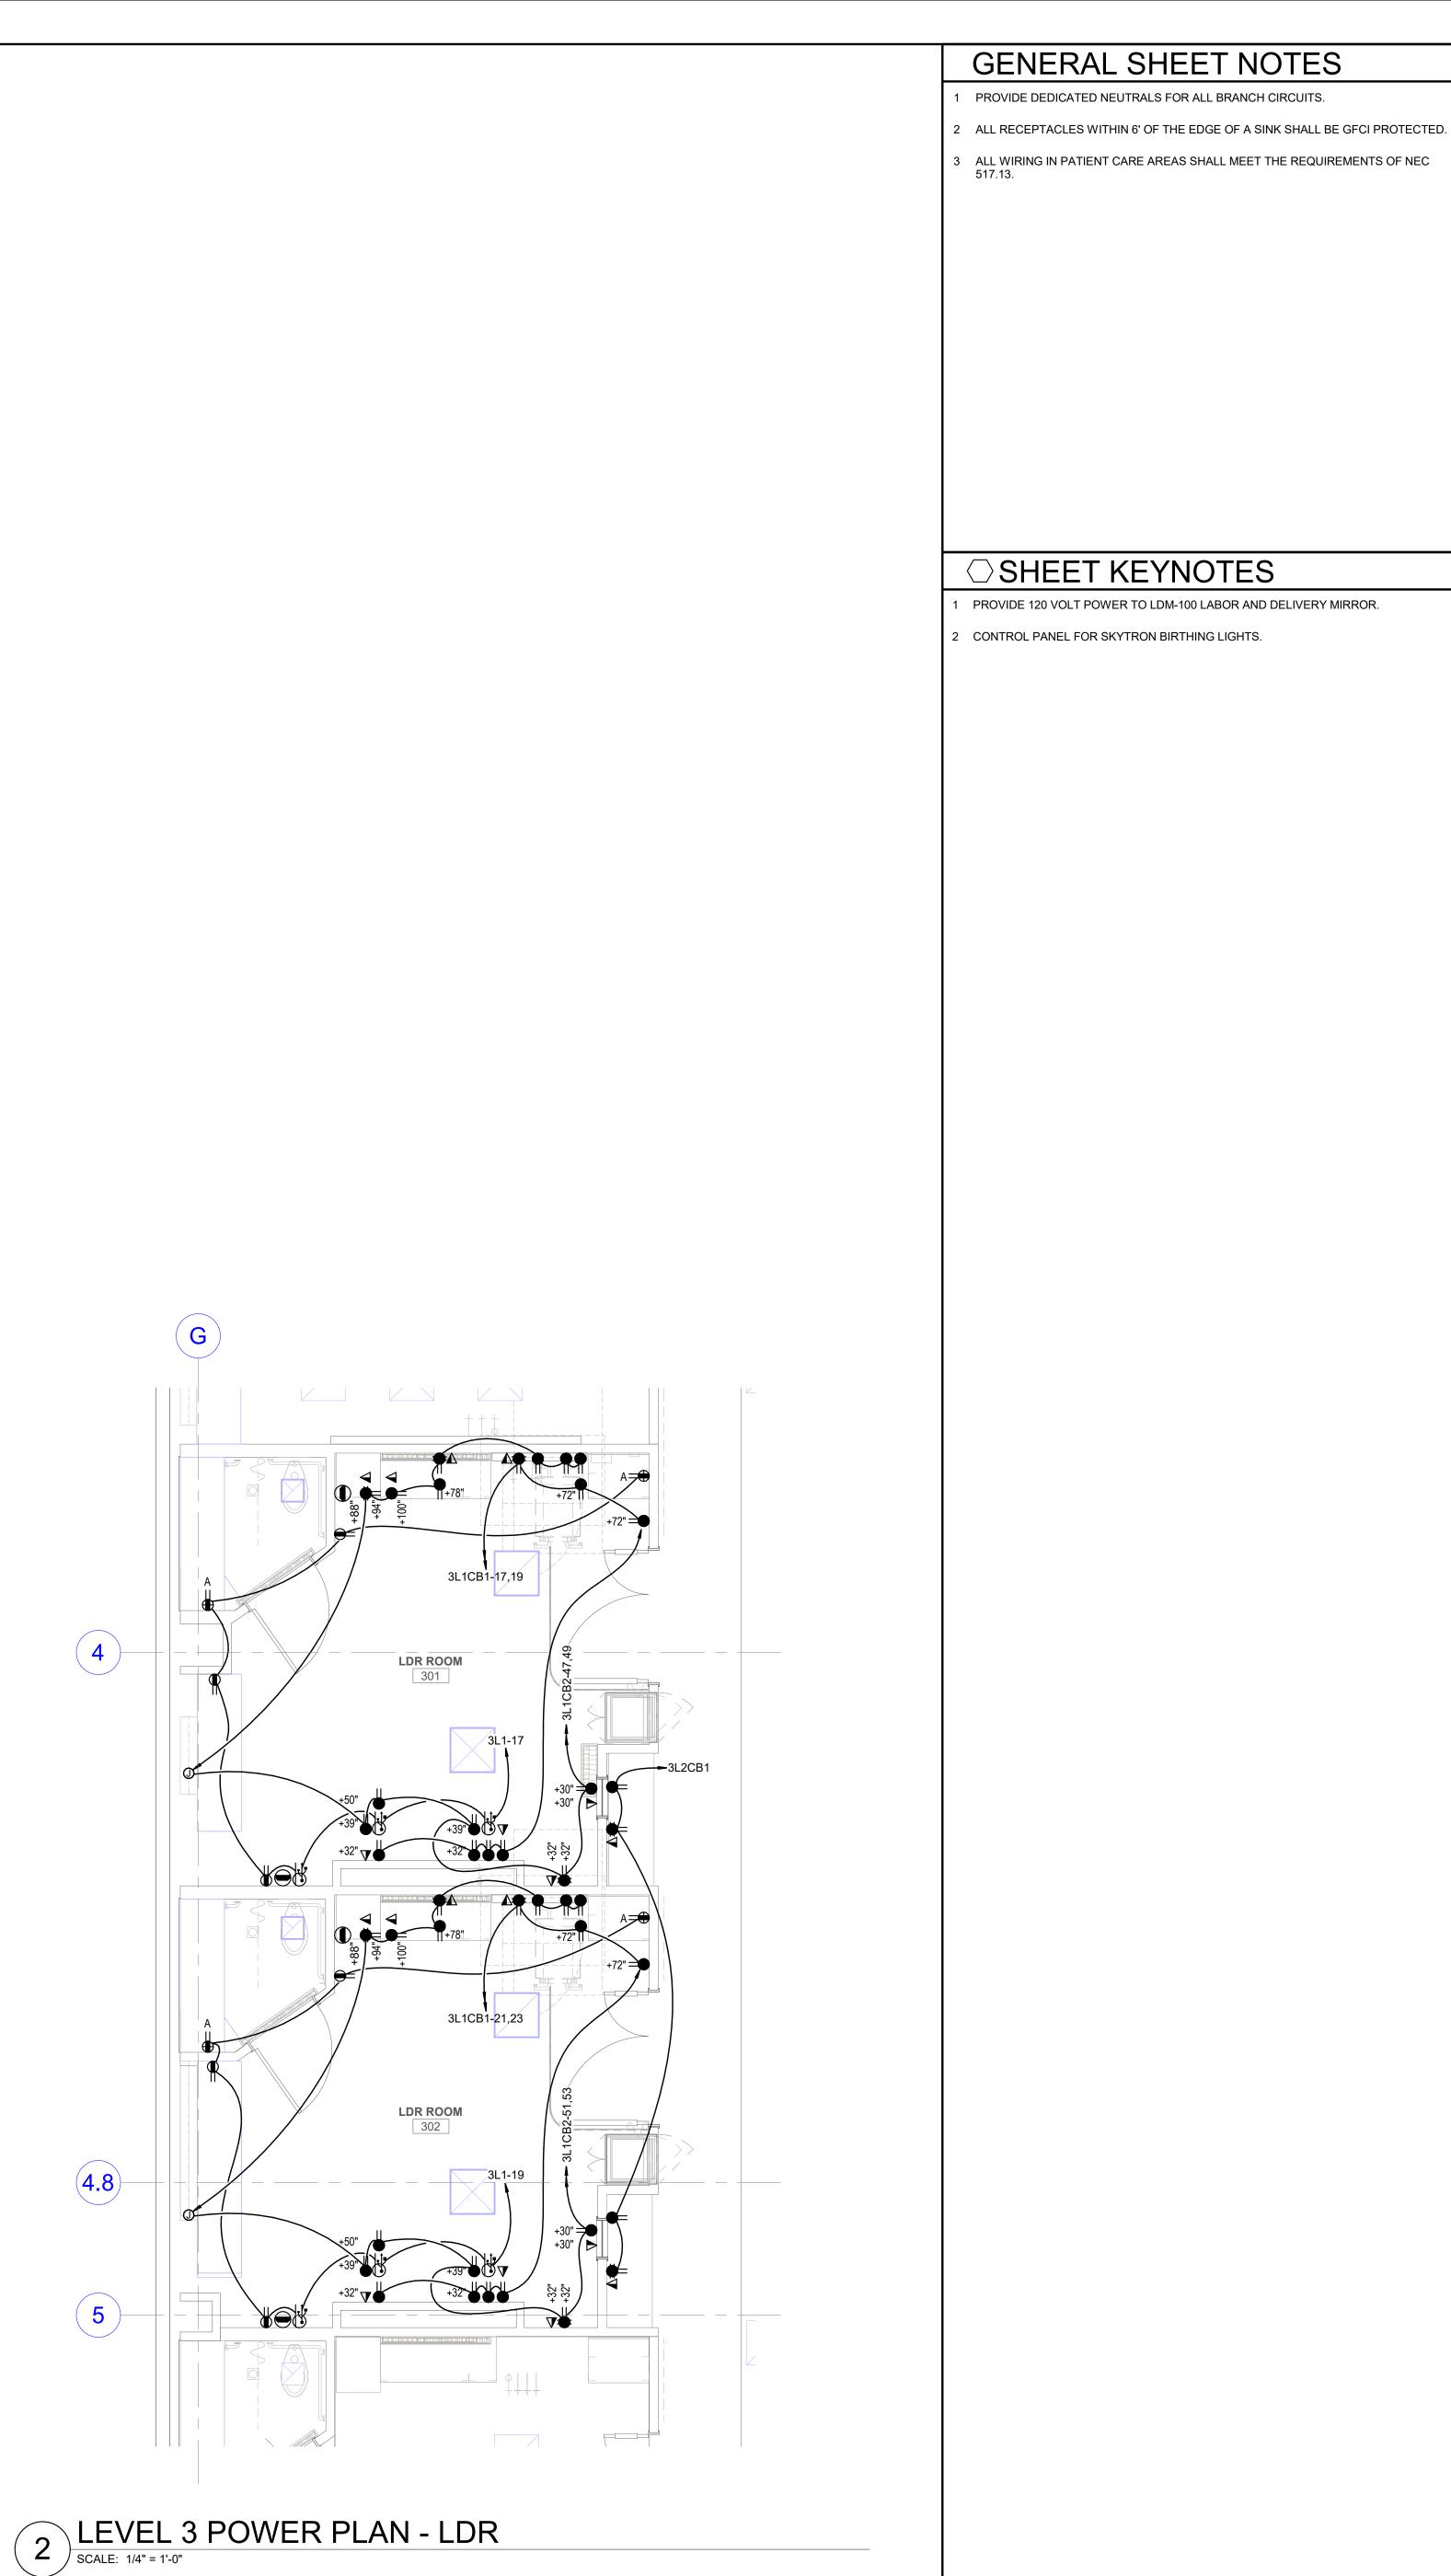





ARCHITECT HKS ARCHITECTS, INC. 222 SOUTH MAIN, SUITE 230 SALT LAKE CITY, UT 84101

STRUCTURAL ENGINEER **REAVELEY ENGINEERS & ASSOCIATES** 675 EAST 500 SOUTH, SUITE 400 SALT LAKE CITY, UTAH 84102

MECHANICAL ENGINEER VAN BOERUM & FRANK ASSOCIATES, INC 181 EAST 5600 SOUTH, SUITE 130 MURRAY, UTAH 84107

ELECTRICAL ENGINEER SPECTRUM ENGINEERS, INC 324 SOUTH STATE STREET, SUITE 400 SALT LAKE CITY, UTAH 84111










KEY PLAN


REVISION NO. DESCRIPTION DATE

HKS PROJECT NUMBER 26404.000 DATE 08/15/24 ISSUE CONSTRUCTION DRAWINGS SHEET TITLE LDR ELECTRICAL PLANS




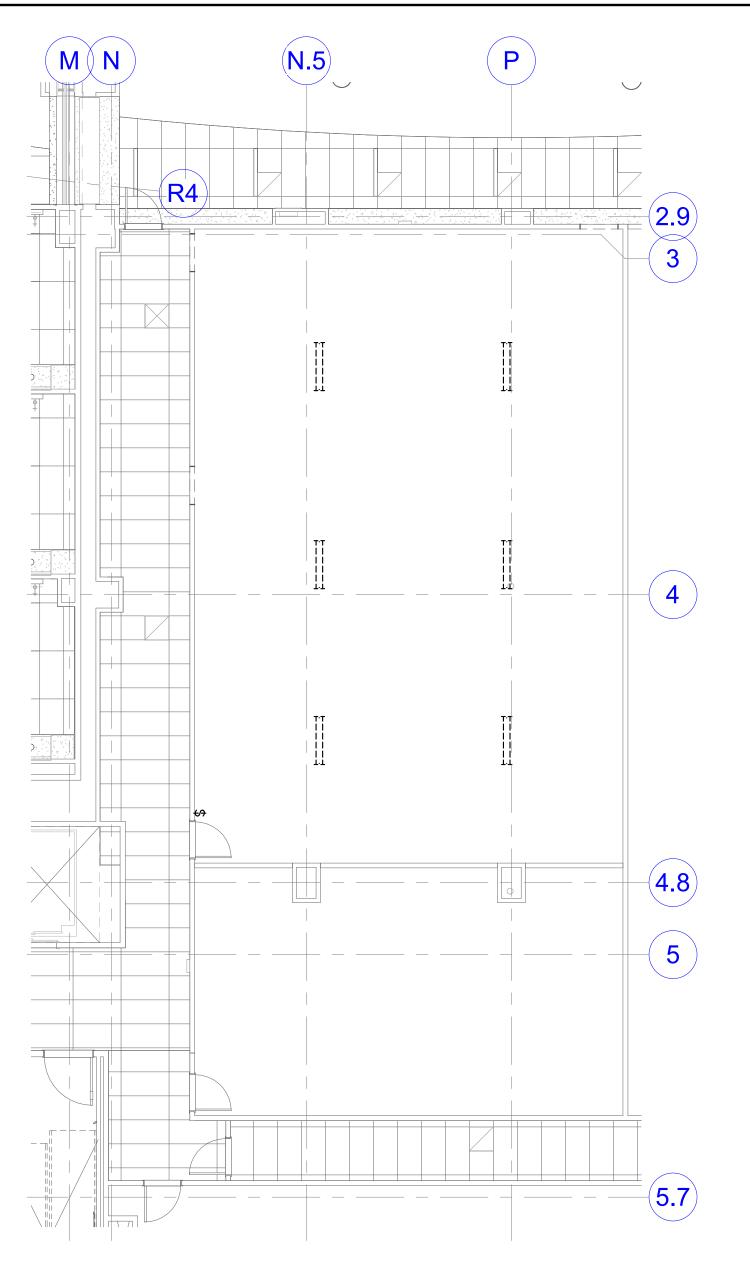


LEVEL 3 CONFERENCE ROOM DEMOLITION a LIGHTING PLAN SCALE: 1/8" = 1'-0"

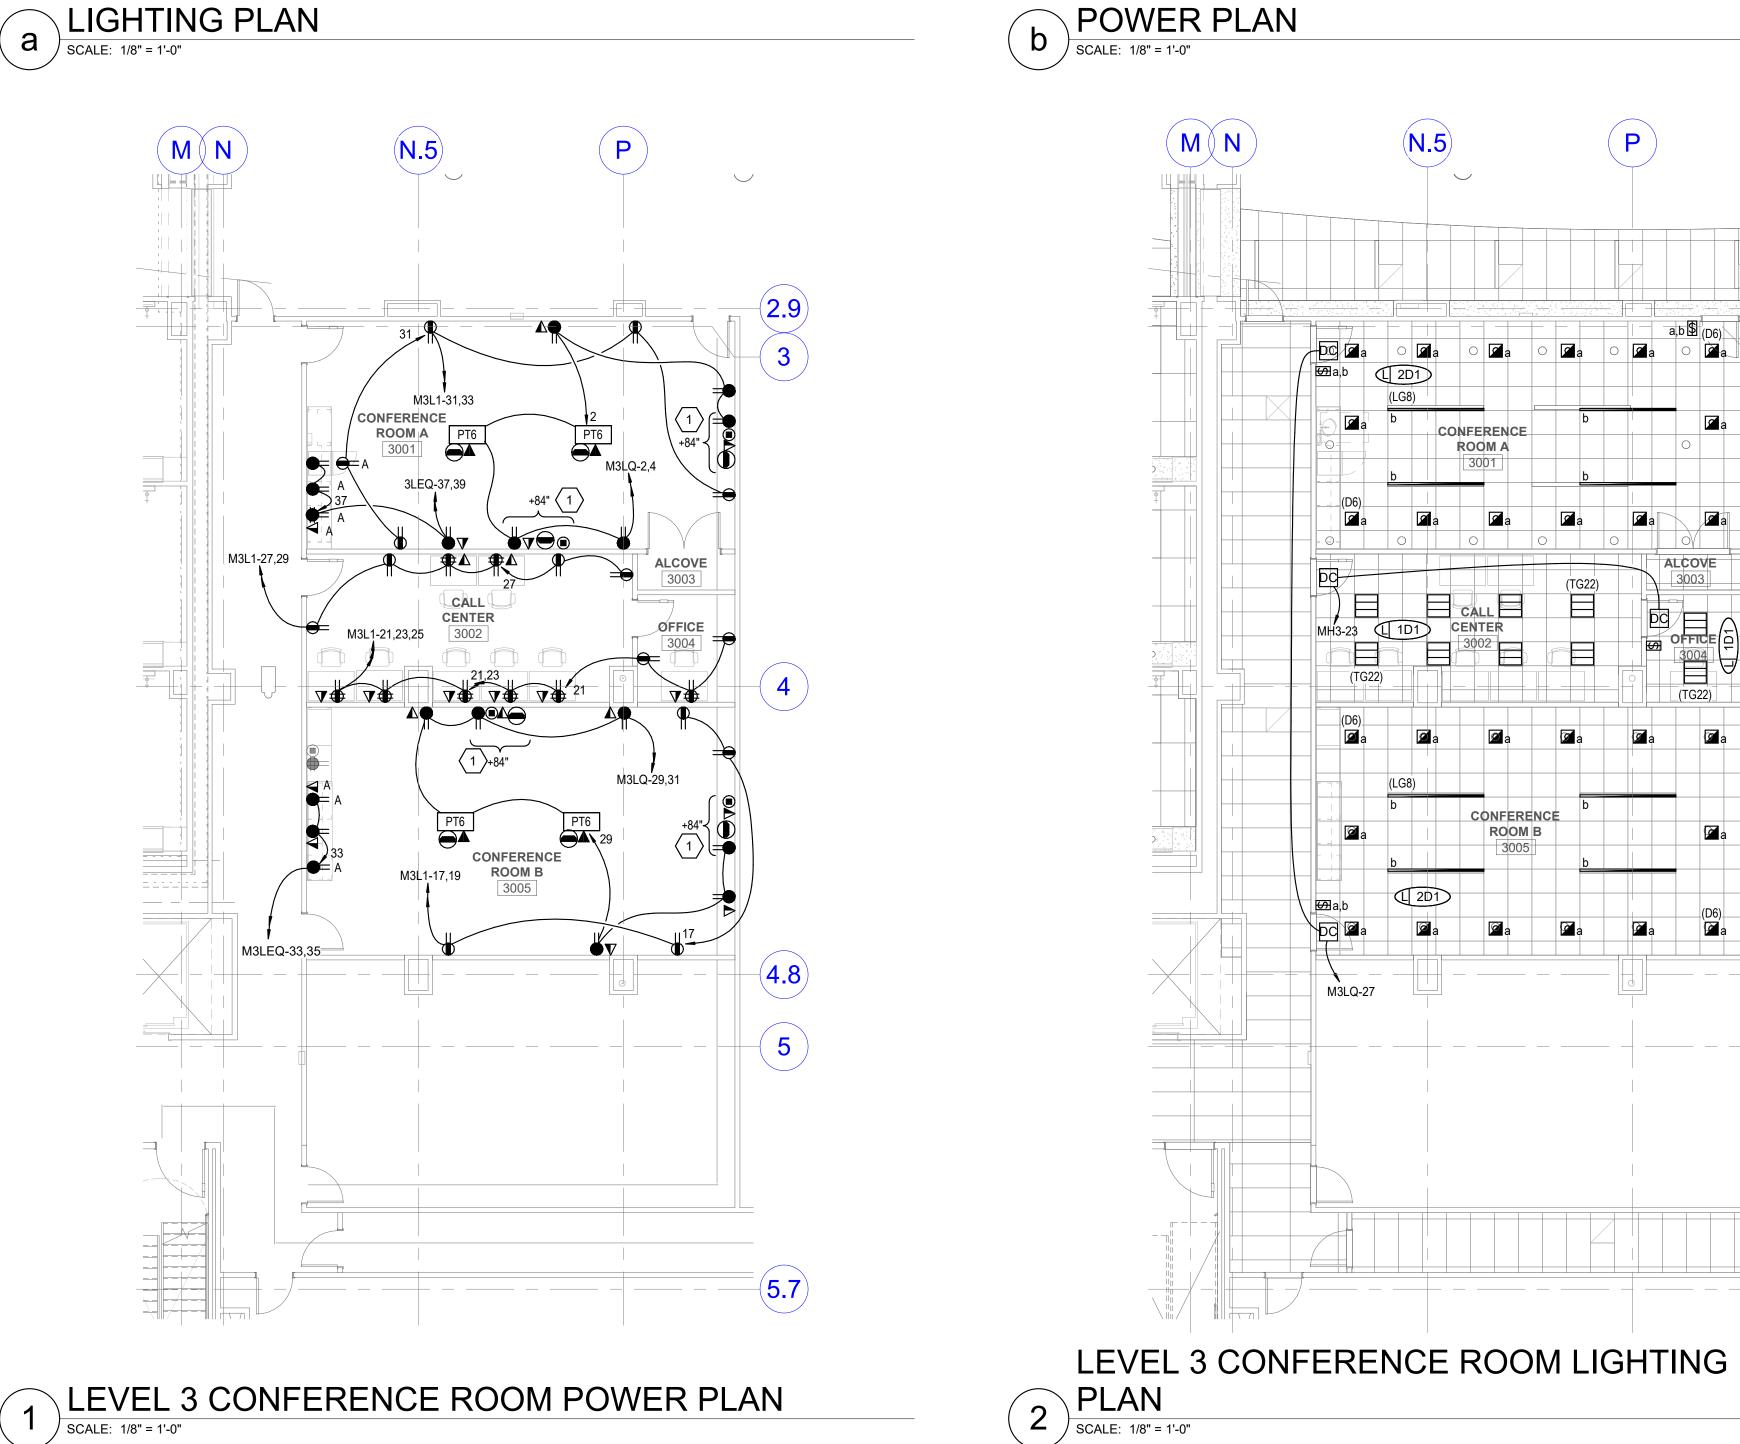

MN P (N.5) $(\mathbf{R4})$ ____ _____ _____ _____ _____ -----

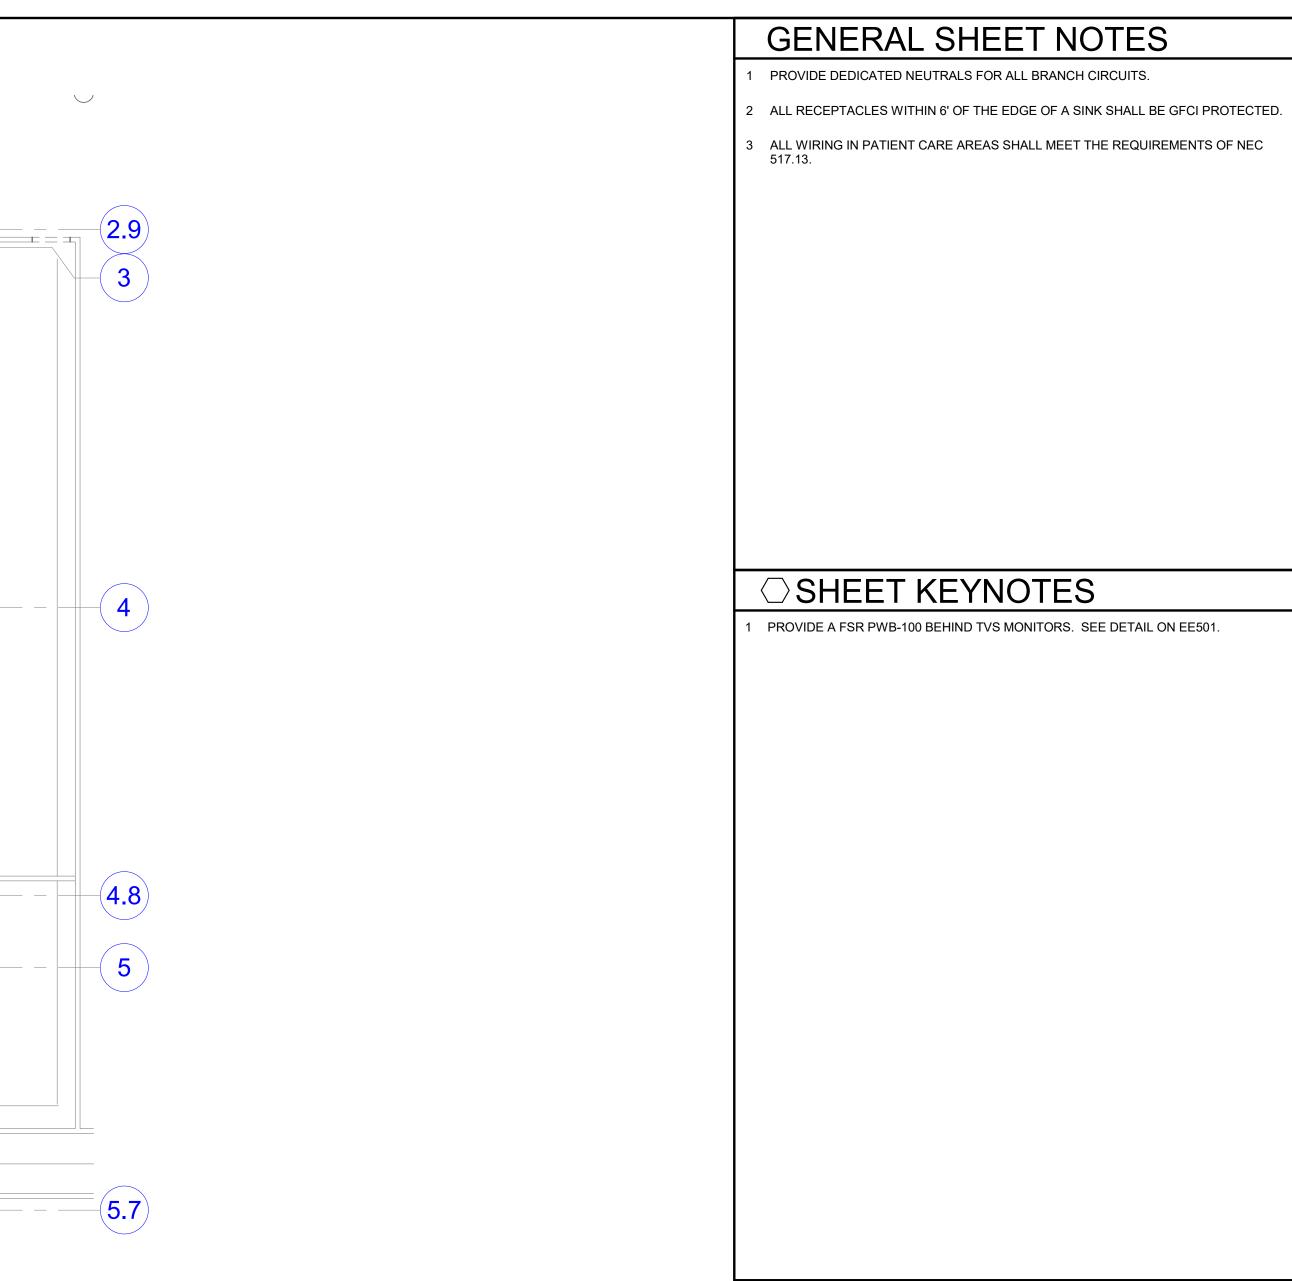



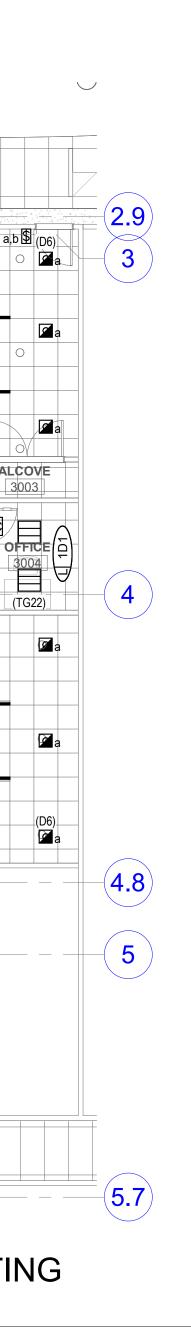



ARCHITECT HKS ARCHITECTS, INC. 222 SOUTH MAIN, SUITE 230 SALT LAKE CITY, UT 84101

STRUCTURAL ENGINEER **REAVELEY ENGINEERS & ASSOCIATES** 675 EAST 500 SOUTH, SUITE 400 SALT LAKE CITY, UTAH 84102

MECHANICAL ENGINEER VAN BOERUM & FRANK ASSOCIATES, INC 181 EAST 5600 SOUTH, SUITE 130 MURRAY, UTAH 84107

ELECTRICAL ENGINEER SPECTRUM ENGINEERS, INC 324 SOUTH STATE STREET, SUITE 400 SALT LAKE CITY, UTAH 84111









KEY PLAN

REVISION NO. DESCRIPTION

HKS PROJECT NUMBER


© 2008 HKS, INC

DATE

26404.000 DATE 08/15/24 ISSUE CONSTRUCTION DRAWINGS SHEET TITLE LEVEL 3 CONFERENCE **ROOM ECTRICAL** PLANS **EP109**

	HexaVue
	HEXAVUE INSTALLATION GUIDELINES
	LAYTON HOSPITAL INTERMOUNTAIN HEALTHCARE
ecord.	LAYTON, UTAH
STERIS drawings do not supersede the drawings from the architect o	GENERAL NOTES 1. SEE INFRASTRUCTURE RESPONSIBILITIES PAGE (IA) FOR ADDITIONAL DE TAUS & DESCRIPTIONS FOR SPECIFIC STAKEHOLDER RESPONSIBILITIES 2. SUPPLY AND INSTALLATION OF ALL CONDUIT, FOWER CIRCUITS, BACK BOXES, ELECTRICAL DEVICES, ELECTRICAL WIRING IS TO BE PROVIDED BY THE CUENTS ELECTRICAL CONTRACTOR UNLESS NOTED OTHERWISE 3. ONE WIRE HANGER FOR CABLE COLD SEQURE DE DROK EACH MOUNT 4. CLEAT CONTRACTOR TO PROVIDE BLANK COVER PLATES FOR ALL LINCTIONS BOXES WHERE NECESSARY 5. ALL CABLE RUNS ONTO BUTSIEN INTEGRATOR COME PLATES FOR ALL LINCTIONS BOXES WHERE NECESSARY 5. CABLE RUNS THEN DENDED WITHIN 30° OF ALL LUNCTION BOXES 7. CABLE RUNS THEN DEVIDED WITHIN 30° OF ALL LUNCTION BOXES 7. CABLE RUNS THEN DEVIDED WITHIN 30° OF ALL LUNCTION BOXES 9. WHERE HADDES 9. WHENE HADDES 9. WHERE HADDE
Healt 5960 Mento	Image: Sterior Summary REVISION SUMMARY Revision # Description Designer/Date CHECKER NUMERAL SHORT DESCRIPTION XXXXXXXXXXXXXXXXXXXXXXXXXXXXXXXXXXXX
STERIS drawings do not supersede the drawings from the architect of record.	<section-header><section-header><section-header><section-header><section-header><section-header><section-header><section-header><section-header><section-header><section-header><section-header><section-header><section-header><section-header><section-header><section-header><section-header><section-header><section-header><text></text></section-header></section-header></section-header></section-header></section-header></section-header></section-header></section-header></section-header></section-header></section-header></section-header></section-header></section-header></section-header></section-header></section-header></section-header></section-header></section-header>

<page-header><page-header><page-header><section-header><page-header><section-header><page-header><text><text><text><text><text><text><text><text></text></text></text></text></text></text></text></text></page-header></section-header></page-header></section-header></page-header></page-header></page-header>	<page-header><section-header><section-header><section-header><section-header><section-header><section-header><section-header><section-header><section-header><section-header><section-header><section-header><section-header><section-header><list-item><list-item><list-item><list-item><list-item><list-item><list-item><list-item><list-item><list-item><list-item><list-item><list-item><list-item><list-item><list-item><list-item><list-item><list-item><list-item><list-item><list-item><list-item><list-item><list-item></list-item></list-item></list-item></list-item></list-item></list-item></list-item></list-item></list-item></list-item></list-item></list-item></list-item></list-item></list-item></list-item></list-item></list-item></list-item></list-item></list-item></list-item></list-item></list-item></list-item></section-header></section-header></section-header></section-header></section-header></section-header></section-header></section-header></section-header></section-header></section-header></section-header></section-header></section-header></page-header>
BEVISION SUMMARY DESIGNER/DATE CHECKER HEXAVUE INTEGRATION SYSTEM LAYTON HOSPITAL INTERMOUNTAIN 11992D7-INT Healthcare Design Group Som backrinon Som backrinon TITLE PAGE, INDEX LAYTON, UTAH Dr TM CK JTP Date ISMAY2024 Som 548-4873 South Sector Form Dr TM CK JTP Date ISMAY2024 South Sector Form Dr TM CK JTP Date ISMAY2024 South Sector Form South Sector	REVISION SUMMARY REVISION SUMMARY Healthcare Design Group Healthcare Design Group S960 Healthcare Agrag HEXAVUE INTEGRATION SYSTEM Netror, CH 44060 USA 800-548-4873 HEXAVUE INTEGRATION SYSTEM
<page-header><page-header><text><list-item><list-item><list-item><list-item><section-header><section-header><section-header><section-header><section-header><section-header><section-header><section-header><section-header><section-header><section-header><section-header><section-header><section-header><section-header><section-header><section-header><section-header><section-header><section-header><section-header></section-header></section-header></section-header></section-header></section-header></section-header></section-header></section-header></section-header></section-header></section-header></section-header></section-header></section-header></section-header></section-header></section-header></section-header></section-header></section-header></section-header></list-item></list-item></list-item></list-item></text></page-header></page-header>	<complex-block> Image: Compare of the second se</complex-block>
Revision summary Revision summary Healthcare Design Group Spece Design Group Number Description Description <thdescription< th=""> Description De</thdescription<>	Revision summary Revision summary HEXAVUE INTEGRATION SYSTEM LAYTON HOSPITAL INTERMOUNTAIN 11992D7-INT Healthcare Design Group Heide Maccondrom Macco

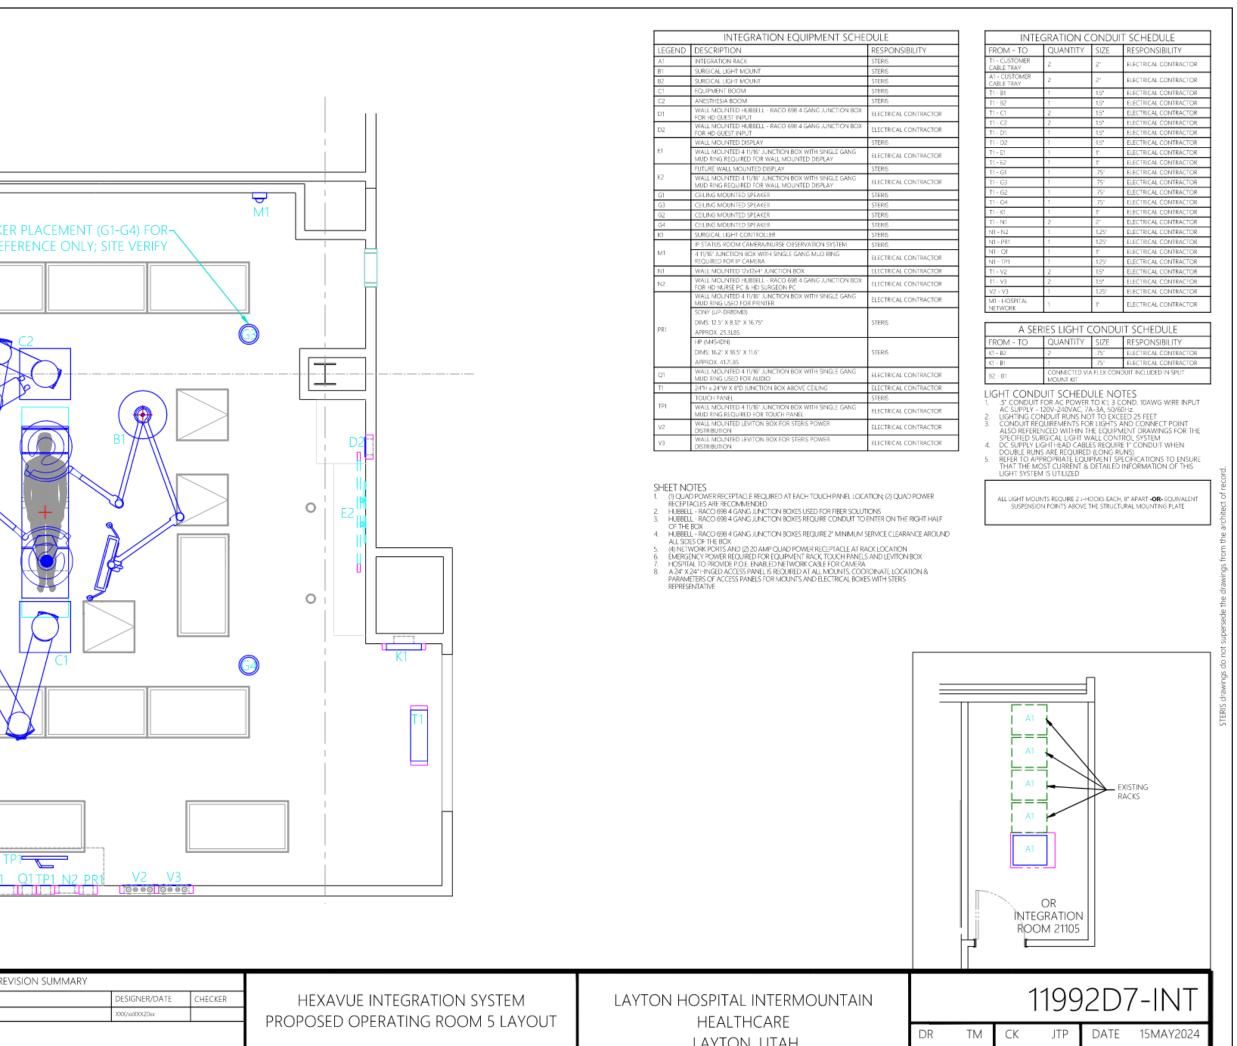



STRUCTURAL ENGINEER **REAVELEY ENGINEERS & ASSOCIATES** 675 EAST 500 SOUTH, SUITE 400 SALT LAKE CITY, UTAH 84102

MECHANICAL ENGINEER VAN BOERUM & FRANK ASSOCIATES, INC 181 EAST 5600 SOUTH, SUITE 130 MURRAY, UTAH 84107

ELECTRICAL ENGINEER SPECTRUM ENGINEERS, INC 324 SOUTH STATE STREET, SUITE 400 SALT LAKE CITY, UTAH 84111







KEY PLAN

-






HKS PROJECT NUMBER 26404.000

08/15/24

DATE


REVISION NO. DESCRIPTION DATE

SHEET NO. EP501

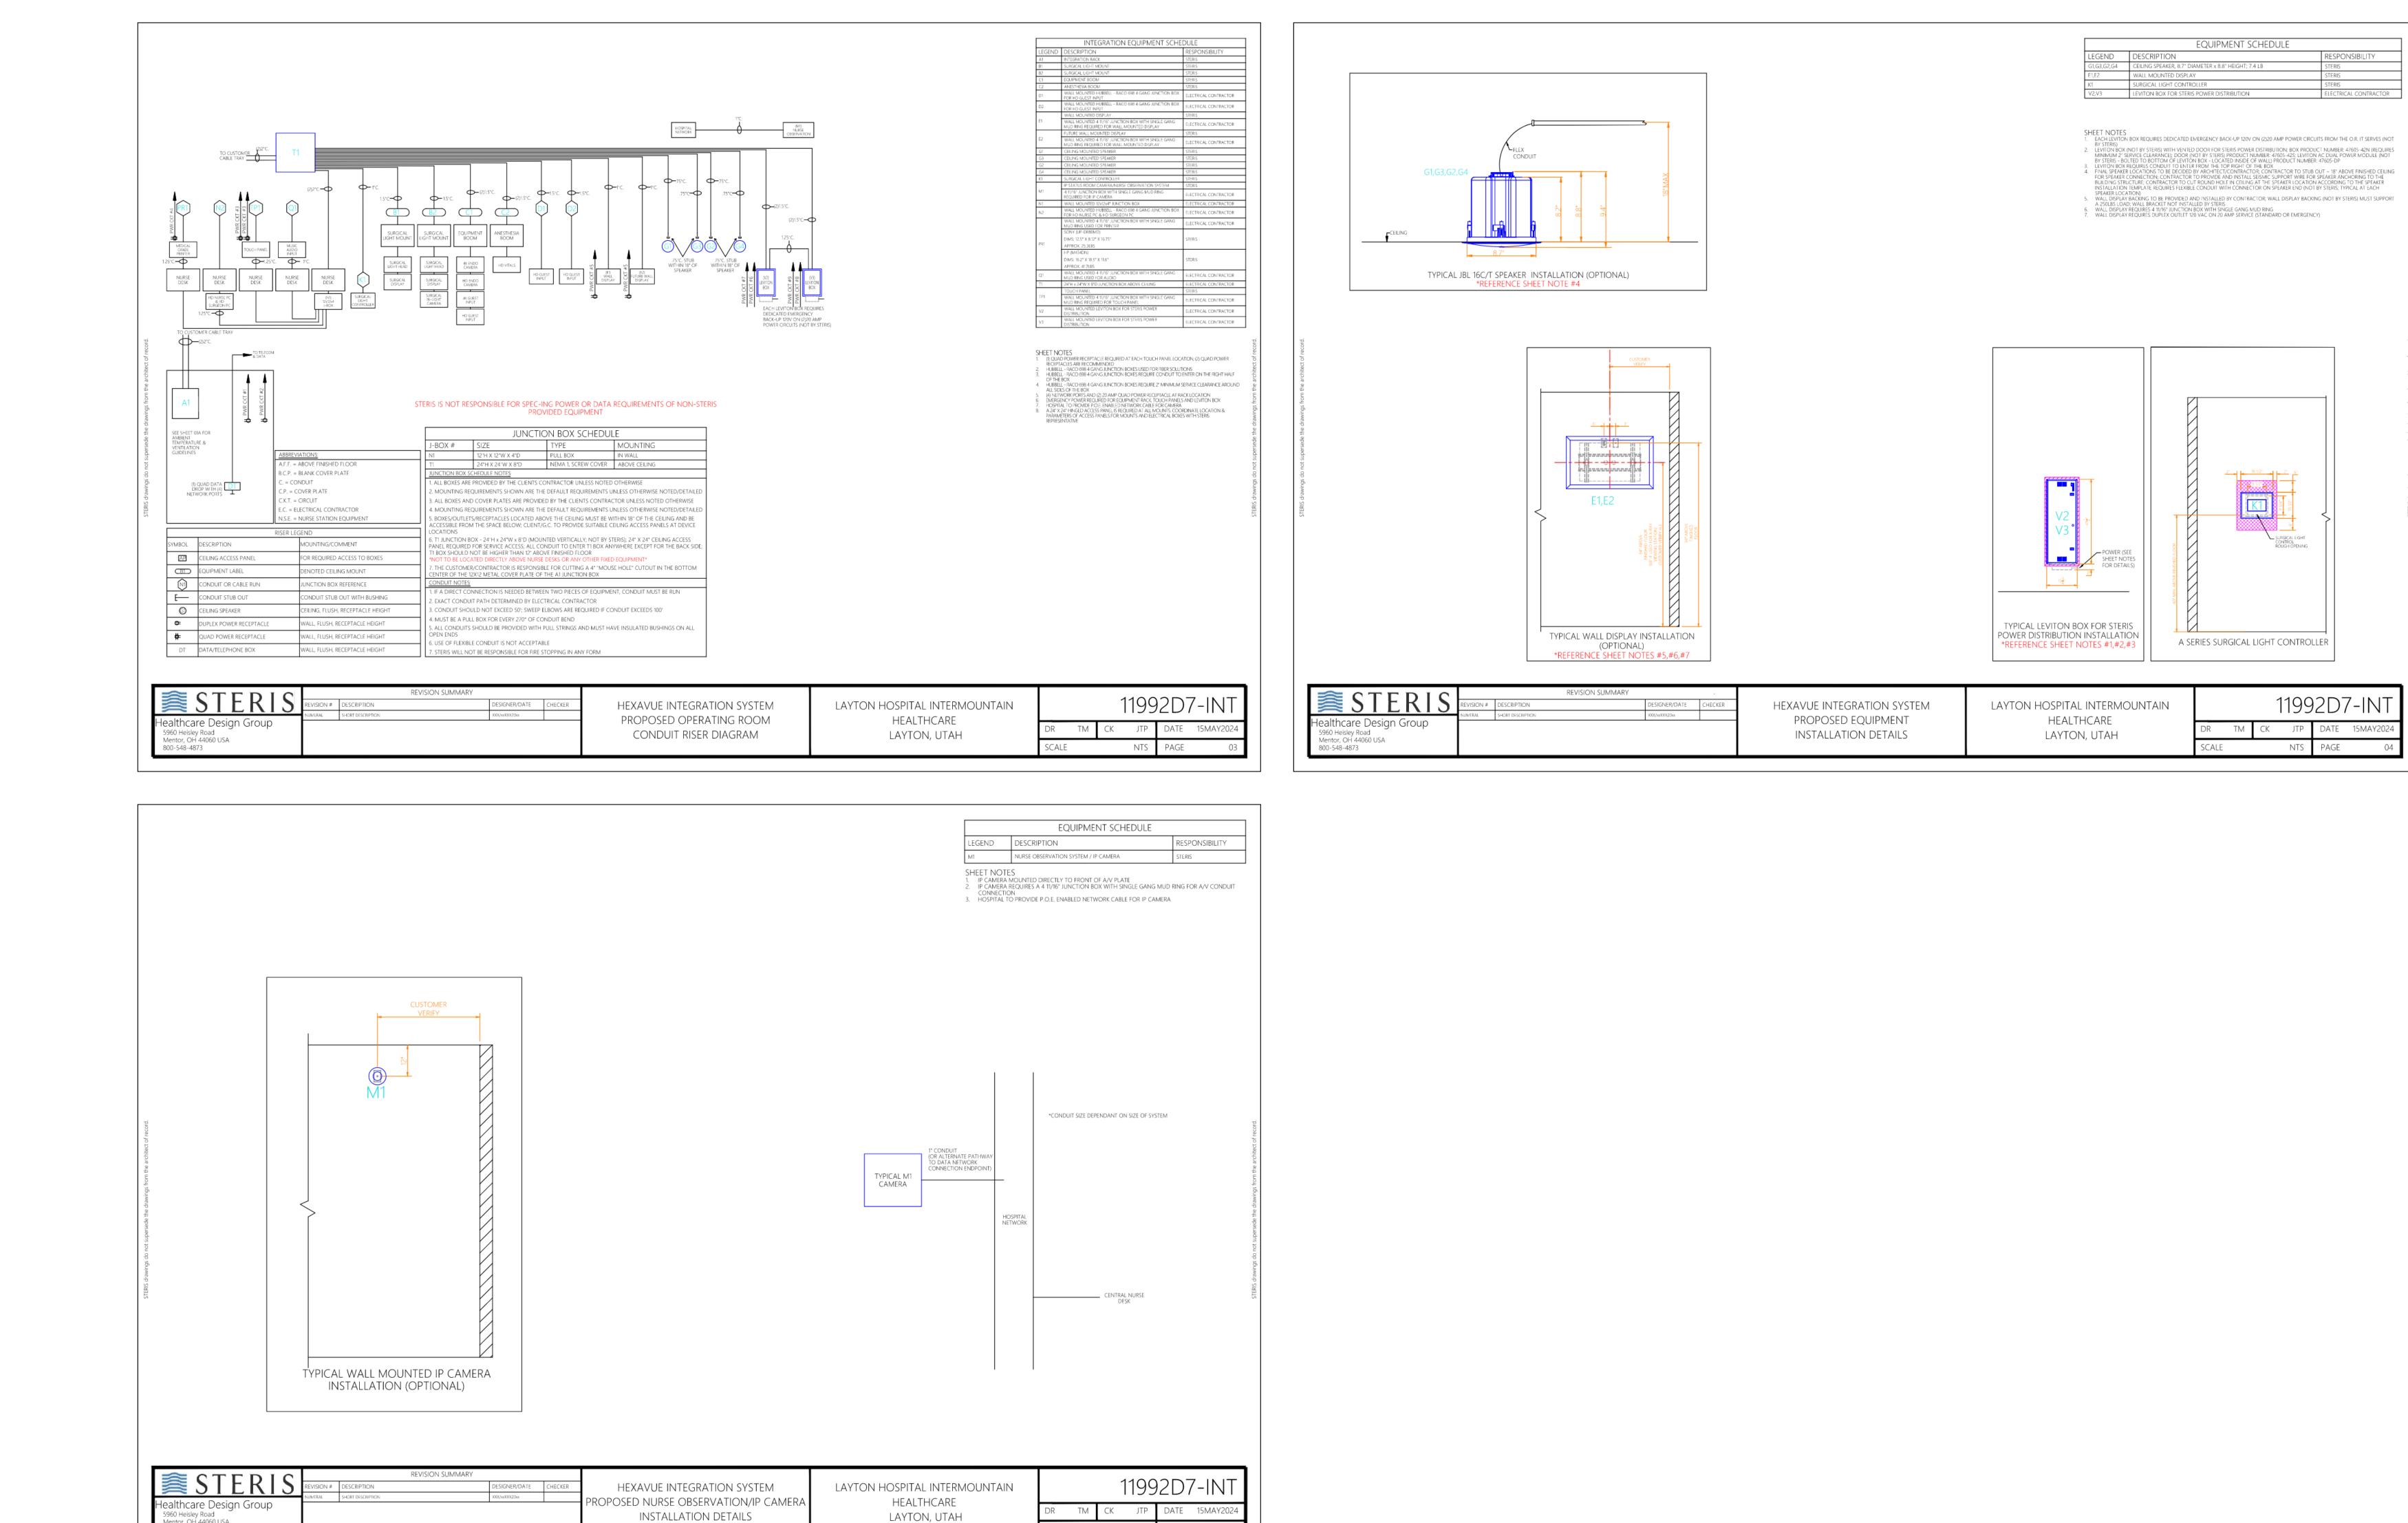

PAGE

NTS

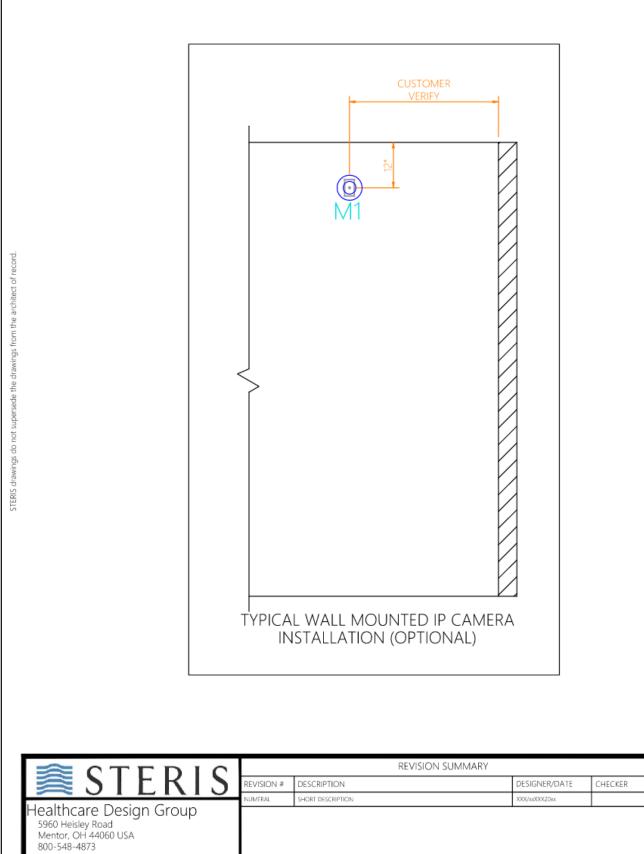



ARCHITECT HKS ARCHITECTS, INC. 222 SOUTH MAIN, SUITE 230 SALT LAKE CITY, UT 84101

STRUCTURAL ENGINEER **REAVELEY ENGINEERS & ASSOCIATES** 675 EAST 500 SOUTH, SUITE 400 SALT LAKE CITY, UTAH 84102

MECHANICAL ENGINEER VAN BOERUM & FRANK ASSOCIATES, INC 181 EAST 5600 SOUTH, SUITE 130 MURRAY, UTAH 84107

ELECTRICAL ENGINEER SPECTRUM ENGINEERS, INC 324 SOUTH STATE STREET, SUITE 400 SALT LAKE CITY, UTAH 84111







KEY PLAN


REVISION NO. DESCRIPTION DATE


HKS PROJECT NUMBER 26404.000 DATE 08/15/24 ISSUE CONSTRUCTION DRAWINGS SHEET TITLE **OR STERIS** DRAWINGS

EP502


SHEET NO.



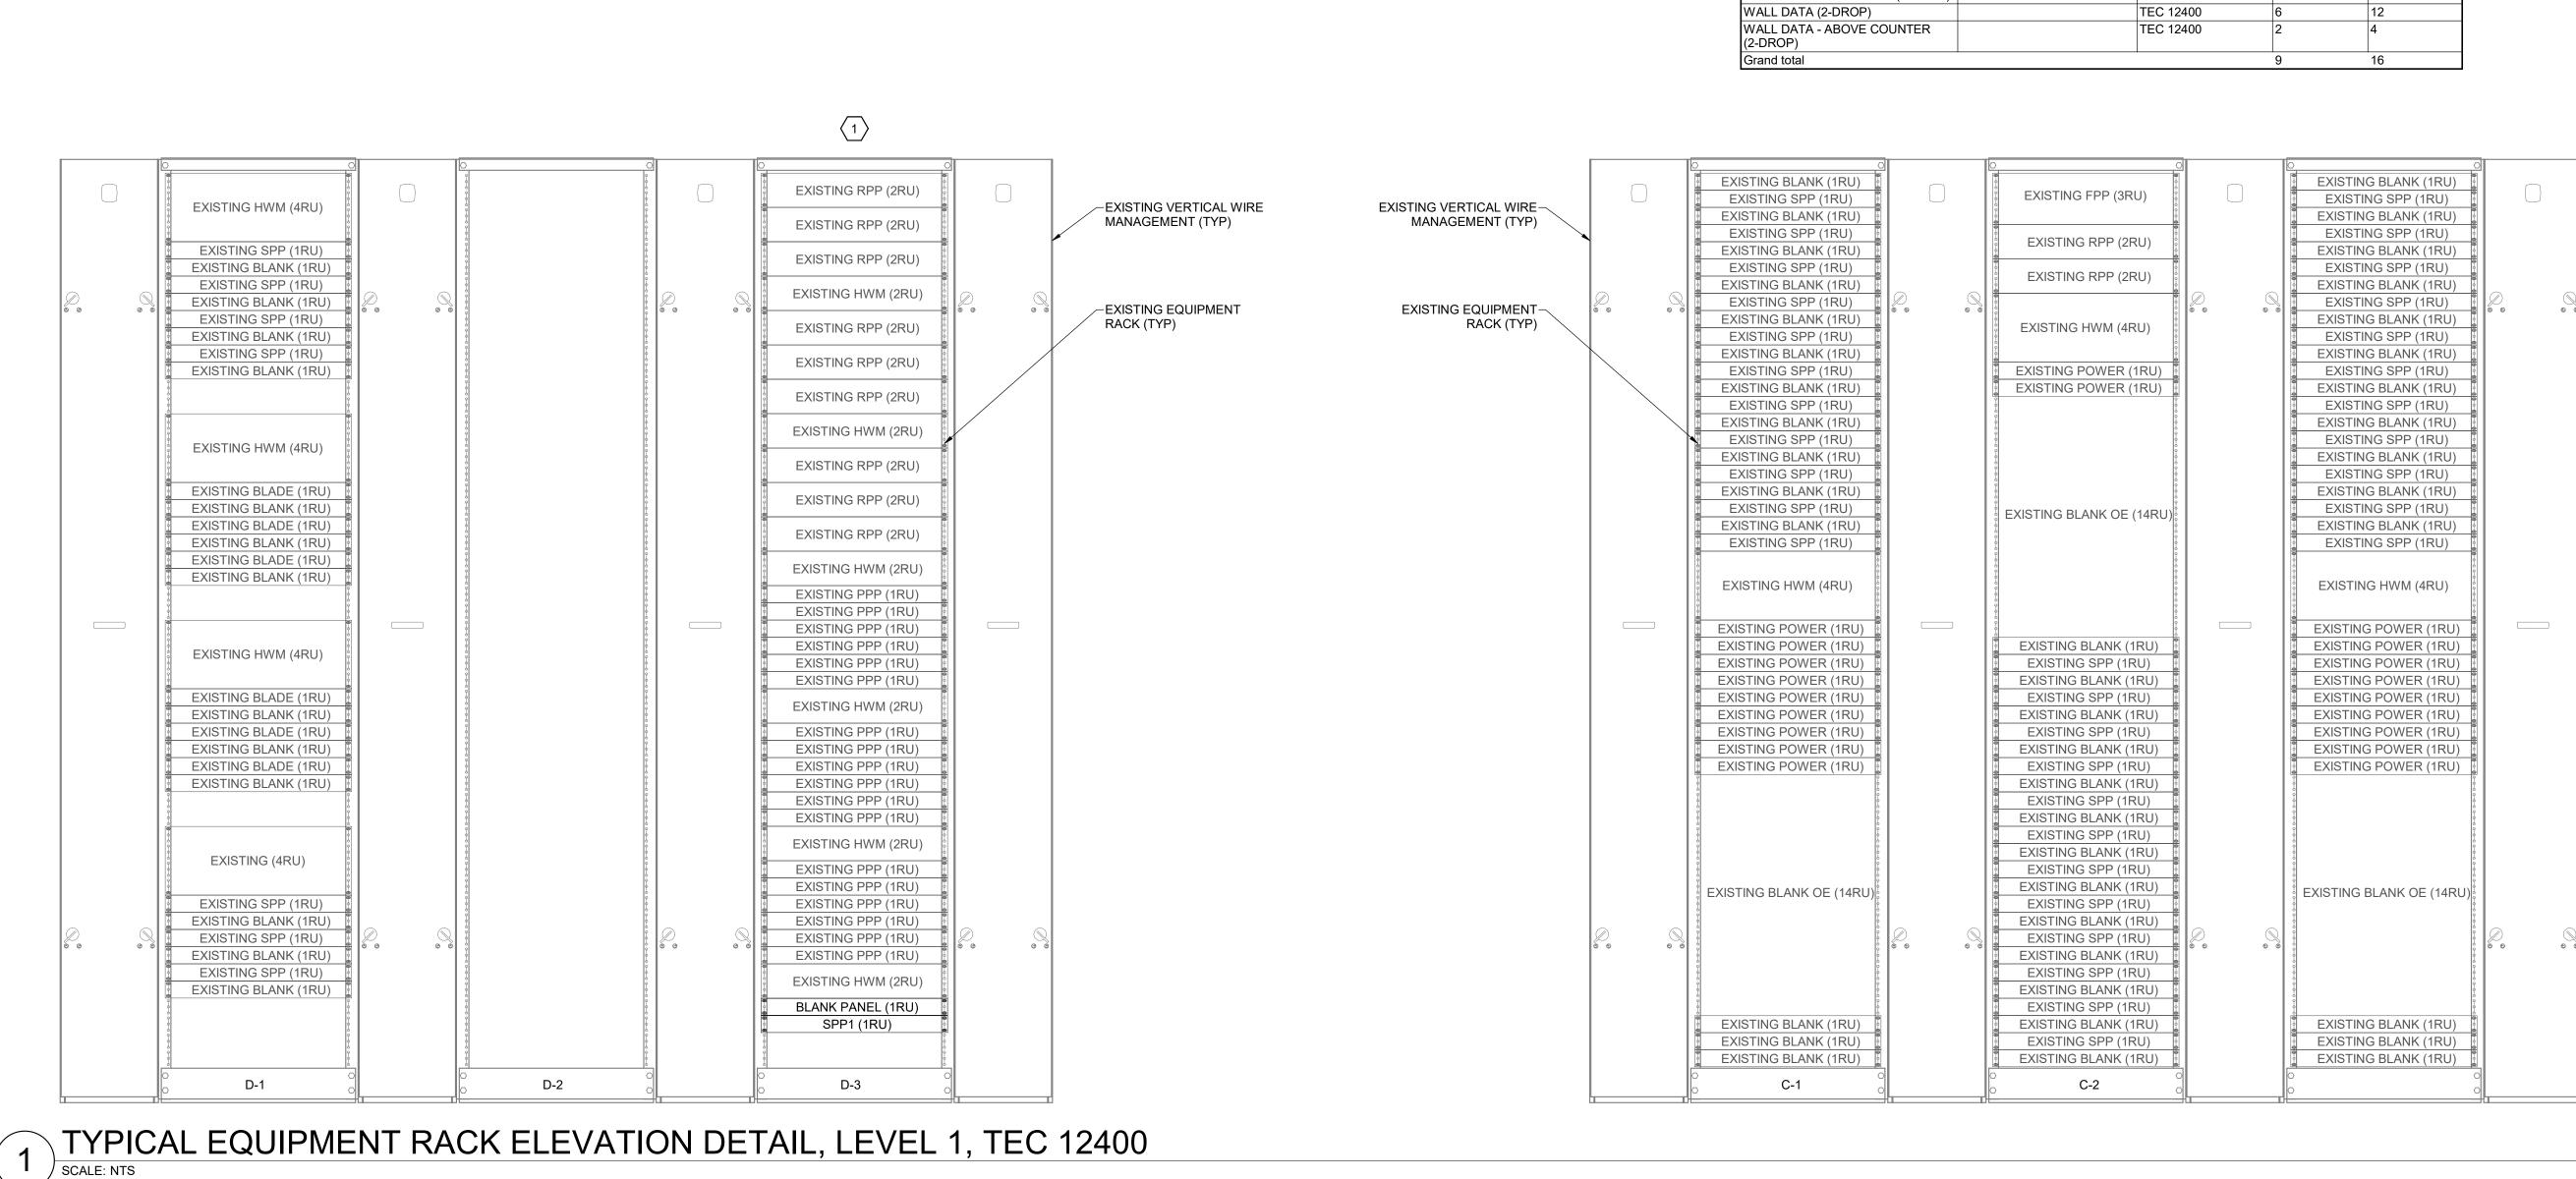

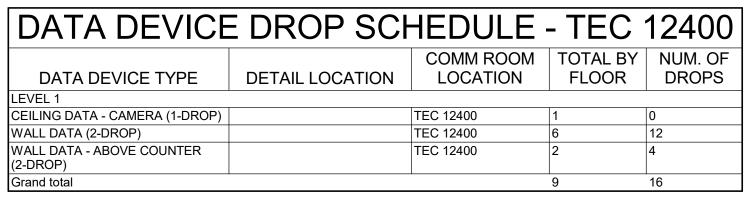

○SHEET KEYNOTES
1 CONTRACTOR TO COORDINATE FINAL TERMINATION LOCATION WITH OWN TO INSTALLATION.

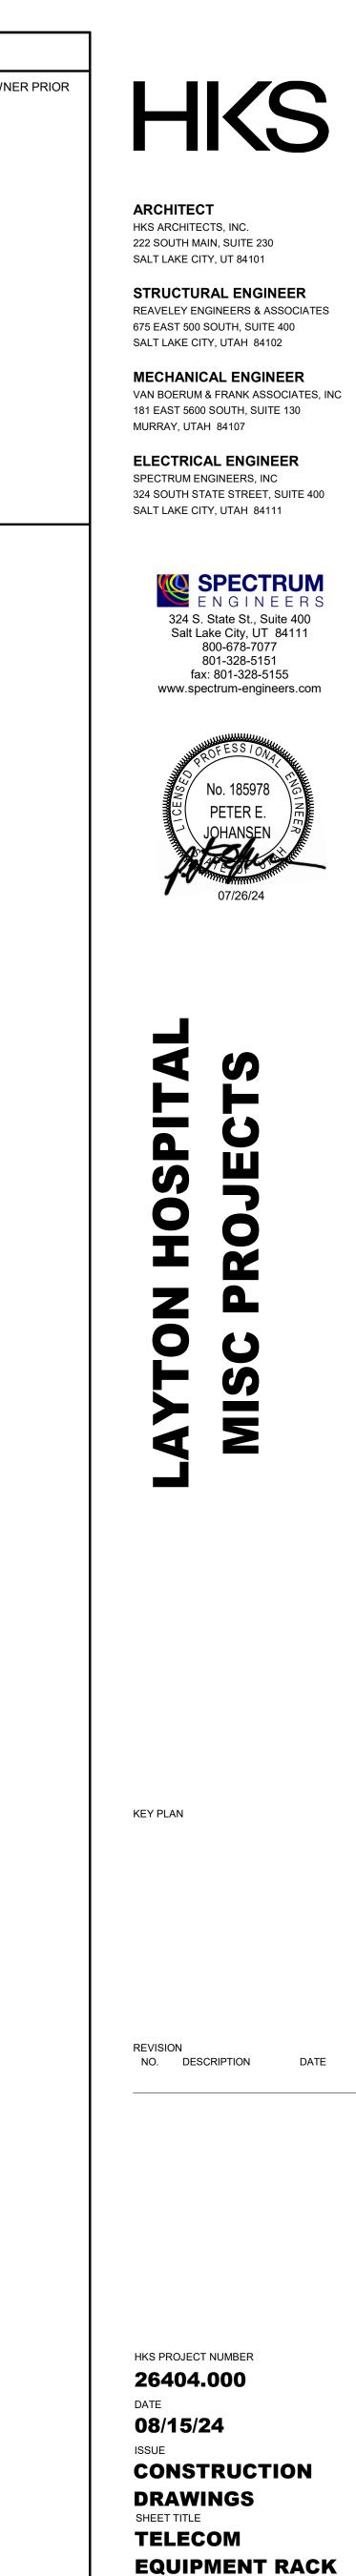


© 2008 HKS, INC.

EP551

ELEVATIONS



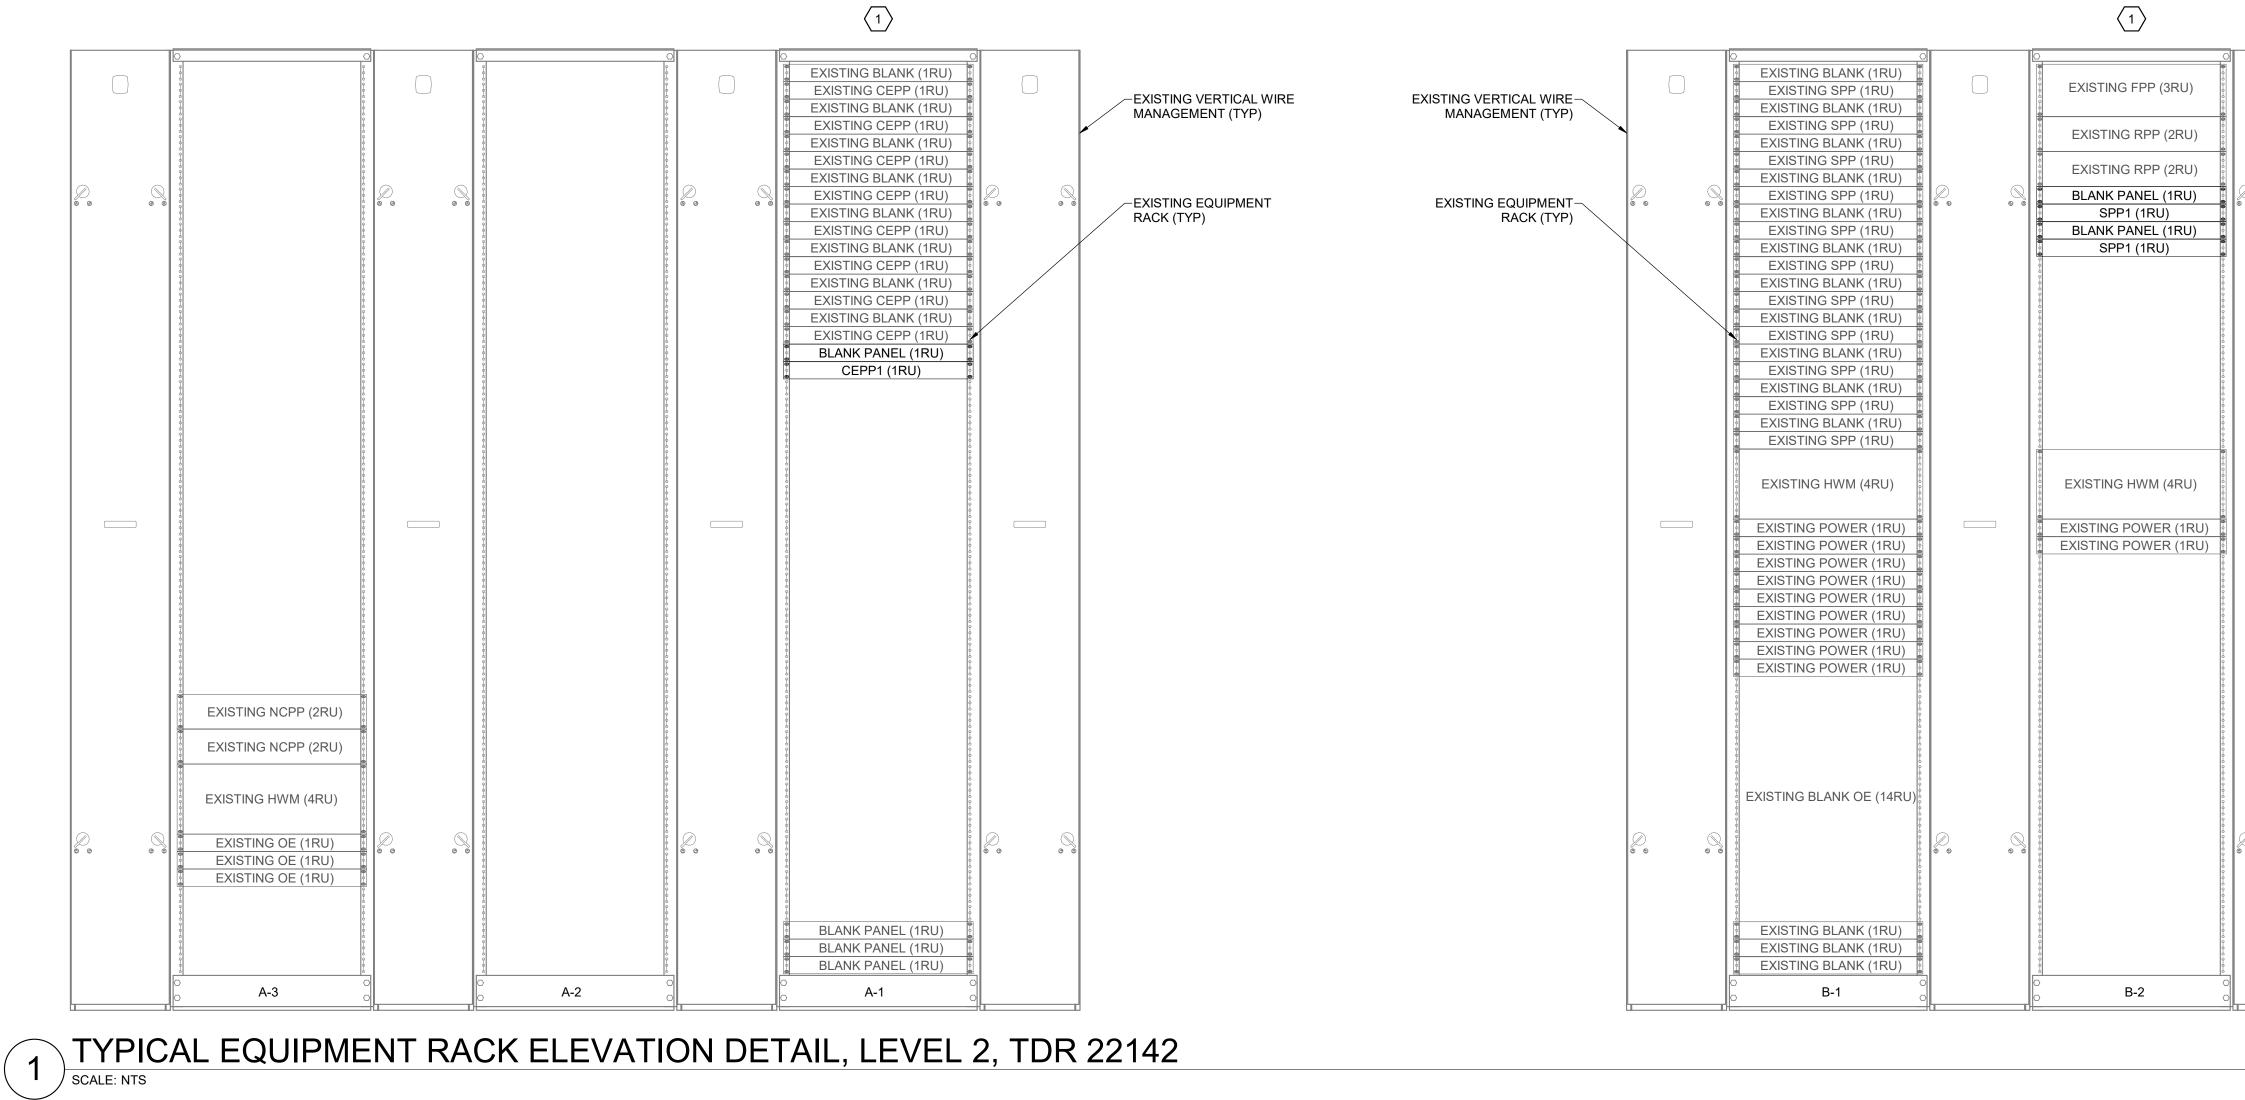


 $\langle 1 \rangle$

DATA DEVICE DROP SCHEDULE - TDR 22142											
COMM ROOM TOTAL BY NUM. O											
DATA DEVICE TYPE	DETAIL LOCATION	LOCATION	FLOOR	DROPS							
LEVEL 2			I								
CEILING DATA (1-DROP)		TDR 22142	2	2							
CEILING DATA (4-DROP)		TDR 22142	1	4							
CEILING DATA (6-DROP)		TDR 22142	1	6							
CEILING DATA - CAMERA (1-DROP)		TDR 22142	4	2							
FLOOR DATA (4-DROP)		TDR 22142	3	12							
WALL DATA (2-DROP)		TDR 22142	27	54							
WALL DATA (4-DROP)		TDR 22142	1	4							
WALL DATA - ABOVE COUNTER (2-DROP)		TDR 22142	5	10							
WALL DATA - MONITOR (3-DROP)		TDR 22142	2	6							
Grand total			46	100							

○SHEET KEYNOTES
1 CONTRACTOR TO COORDINATE FINAL TERMINATION LOCATION WITH OWN TO INSTALLATION.

			hr	
		EXISTING BLANK (1RU)		
\bigcirc		EXISTING SPP (1RU)		
		EXISTING BLANK (1RU) EXISTING SPP (1RU) EXISTING BLANK (1RU) EXISTING SPP (1RU)		
		EXISTING SPP (1RU)		
		EXISTING BLANK (1RU)		
	00	EXISTING SPP (1RU)	00	• •
		EXISTING BLANK (1RU)		
		EXISTING SPP (1RU)		
		EXISTING BLANK (1RU) EXISTING SPP (1RU) EXISTING BLANK (1RU) EXISTING SPP (1RU)		
		EXISTING SPP (1RU)		
		EXISTING BLANK (1RU)		
		EXISTING SPP (1RU)		
		EXISTING BLANK (1RU)		
		EXISTING SPP (1RU)		
		EXISTING BLANK (1RU) EXISTING SPP (1RU) EXISTING BLANK (1RU) EXISTING SPP (1RU)		
		EXISTING SPP (1RU)		
		EXISTING BLANK (1RU)		
		EXISTING SPP (1RU)		
		EXISTING BLANK (1RU)		
		EXISTING BLANK (1RU) EXISTING SPP (1RU) EXISTING BLANK (1RU)		
		EXISTING HWM (4RU)		
		EXISTING POWER (1RU) EXISTING POWER (1RU) EXISTING POWER (1RU) EXISTING POWER (1RU) EXISTING POWER (1RU) EXISTING POWER (1RU) EXISTING POWER (1RU)		
		EXISTING POWER (1RU)		
		EXISTING POWER (1RU)		
		EXISTING POWER (1RU)		
		EXISTING POWER (1RU)		
		EXISTING POWER (1RU)		
		EXISTING POWER (1RU)		
		EXISTING POWER (1RU)		
		EXISTING POWER (1RU)		
		EXISTING BLANK OE (14RU)		
			1	
		EXISTING POWER (1RU) EXISTING BLANK OE (14RU) EXISTING BLANK (1RU) EXISTING BLANK (1RU) EXISTING BLANK (1RU)	1	
		EXISTING BLANK (1RU)		
		EXISTING BLANK (1RU)	1	
		EXISTING BLANK (1RU)		
		о В-3 о		
			H	

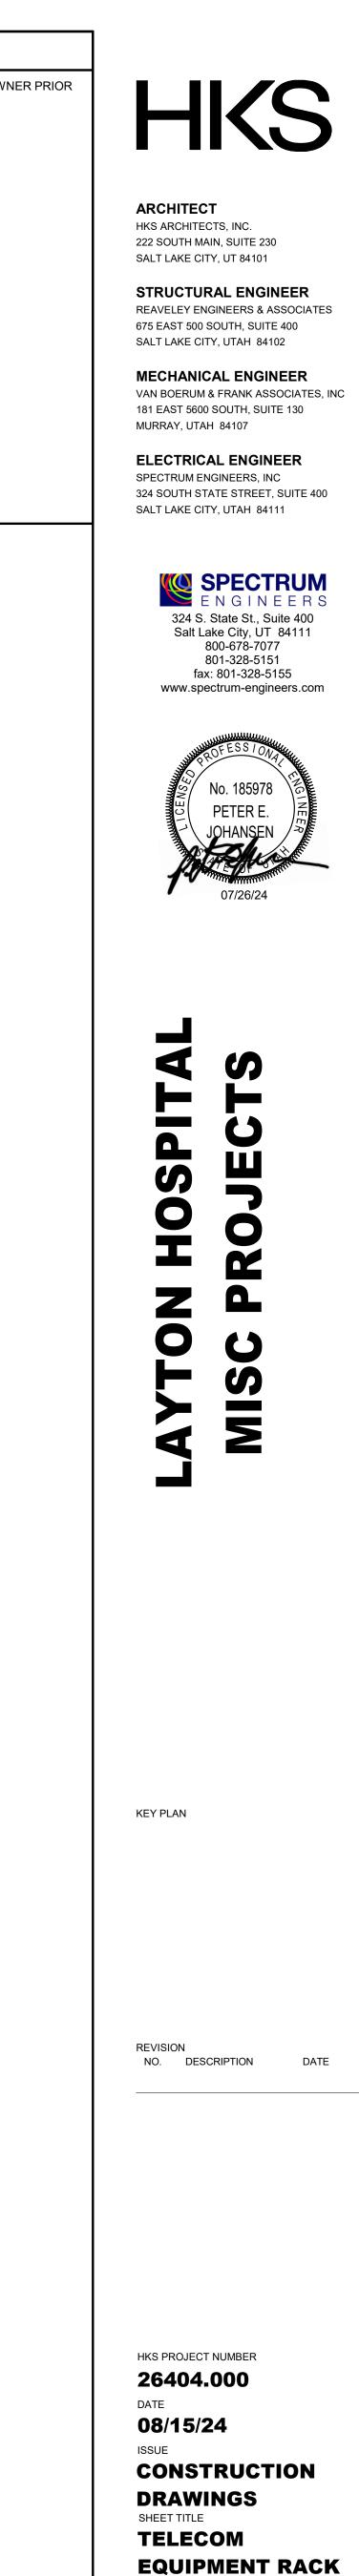


© 2008 HKS, INC.

EP552

ELEVATIONS



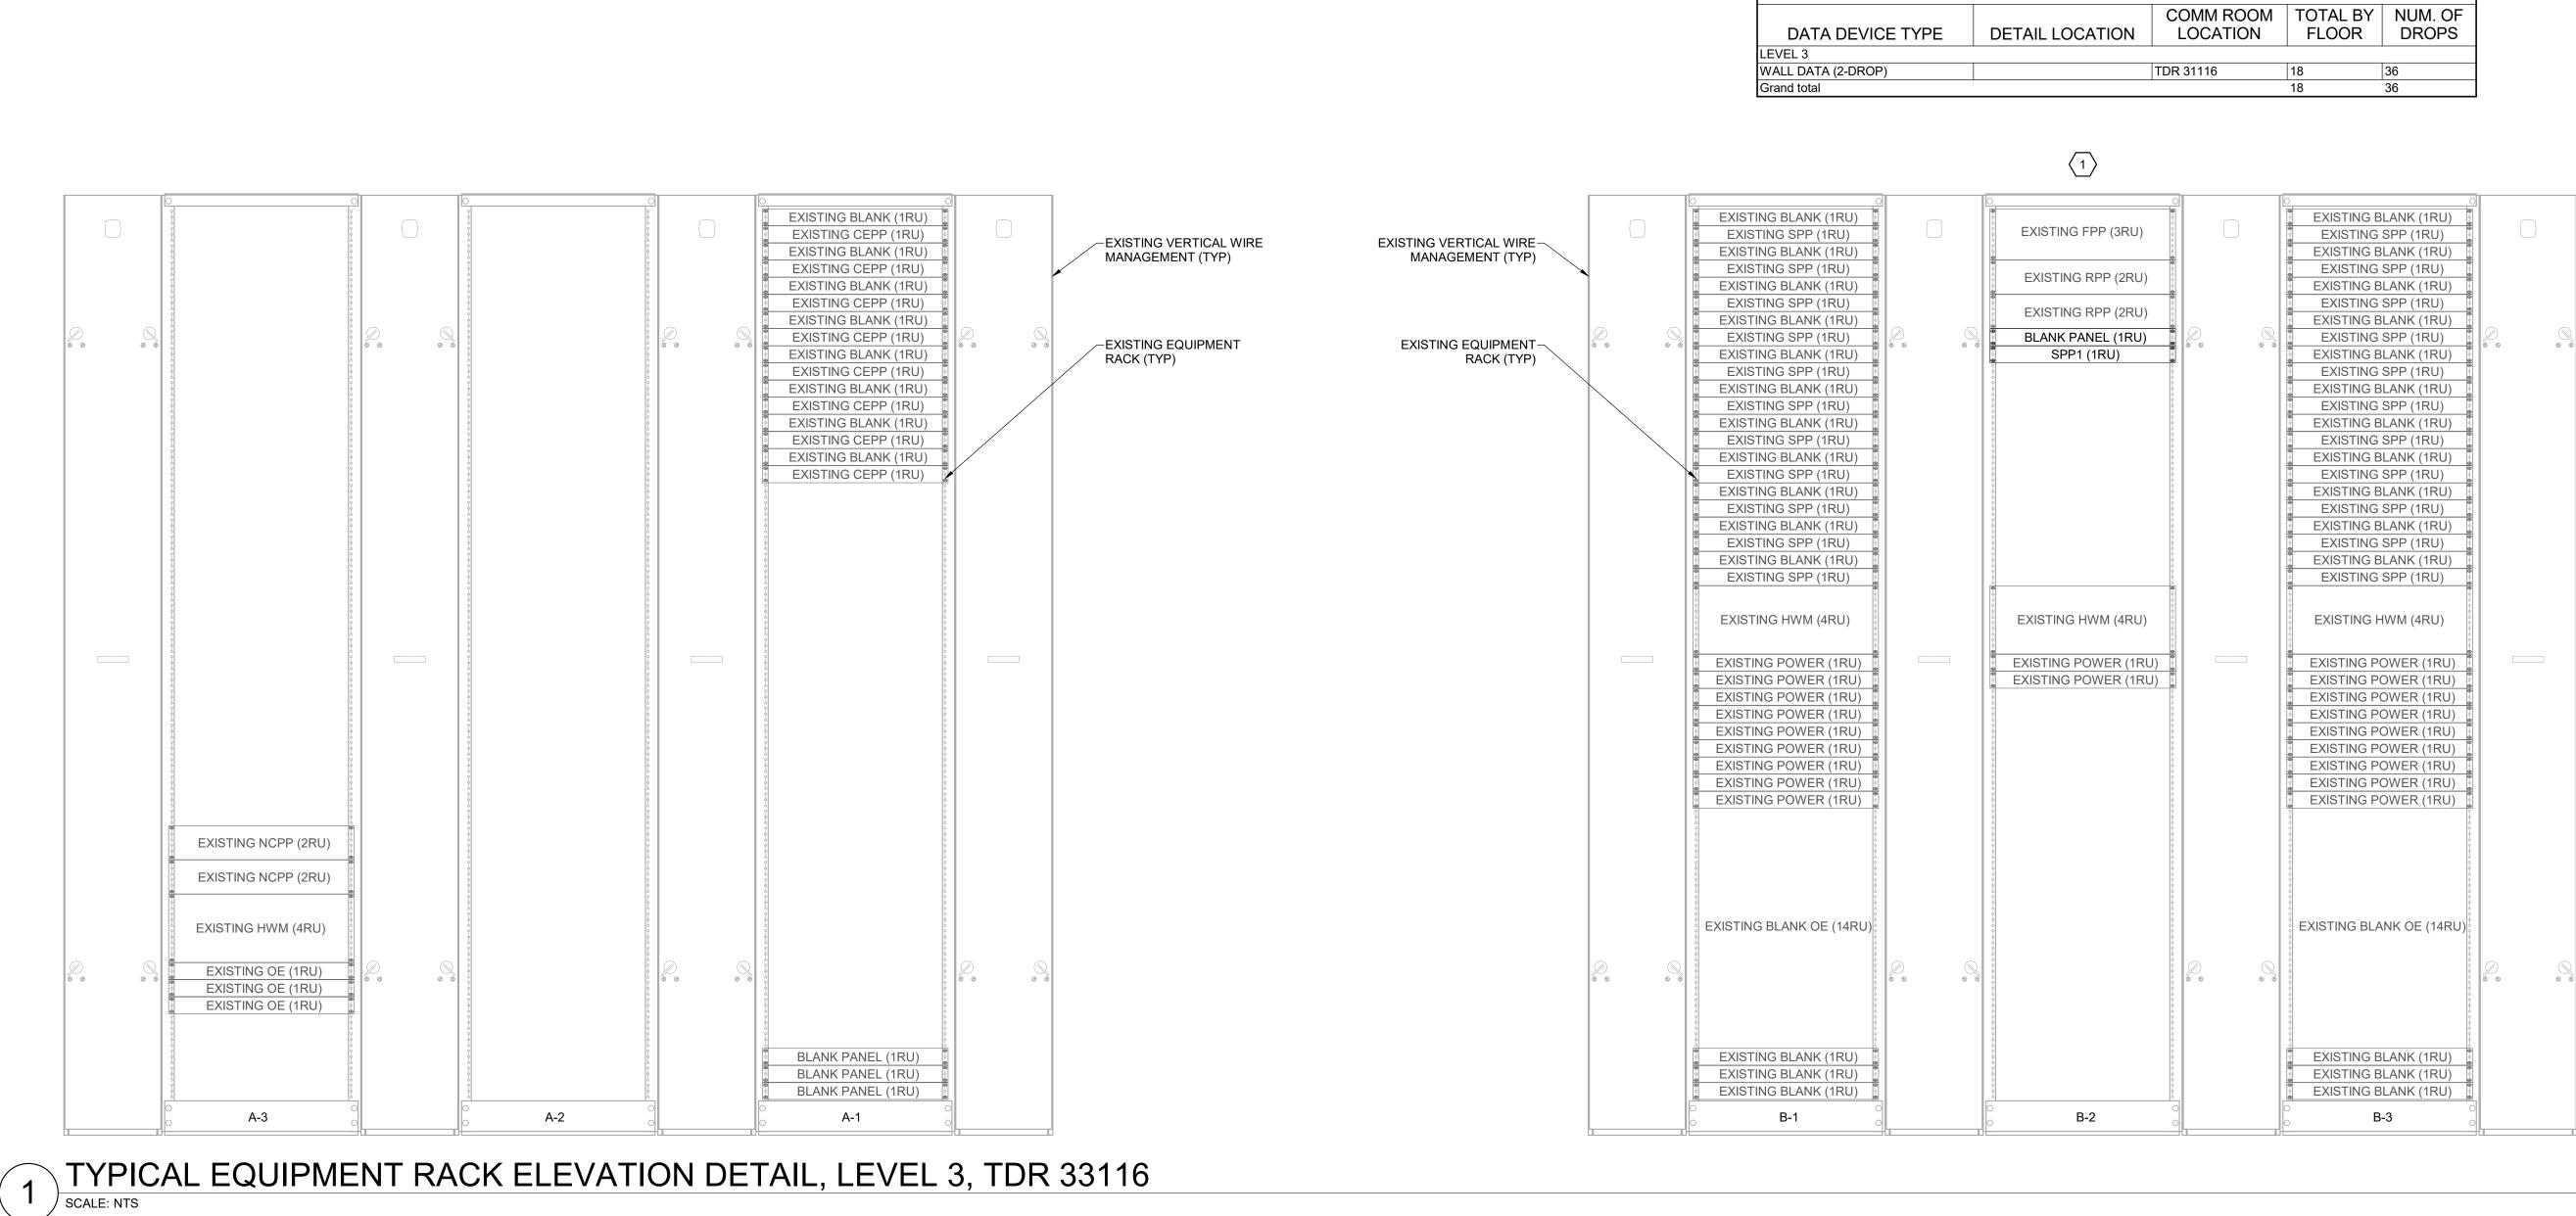



DATA DEVICE TYPE	DETAIL LOCATION	COM LOC
LEVEL 3		
WALL DATA (2-DROP)		TDR 311
Grand total		


○SHEET KEYNOTES
1 CONTRACTOR TO COORDINATE FINAL TERMINATION LOCATION WITH OWN TO INSTALLATION.



© 2008 HKS, INC.

EP553

ELEVATIONS

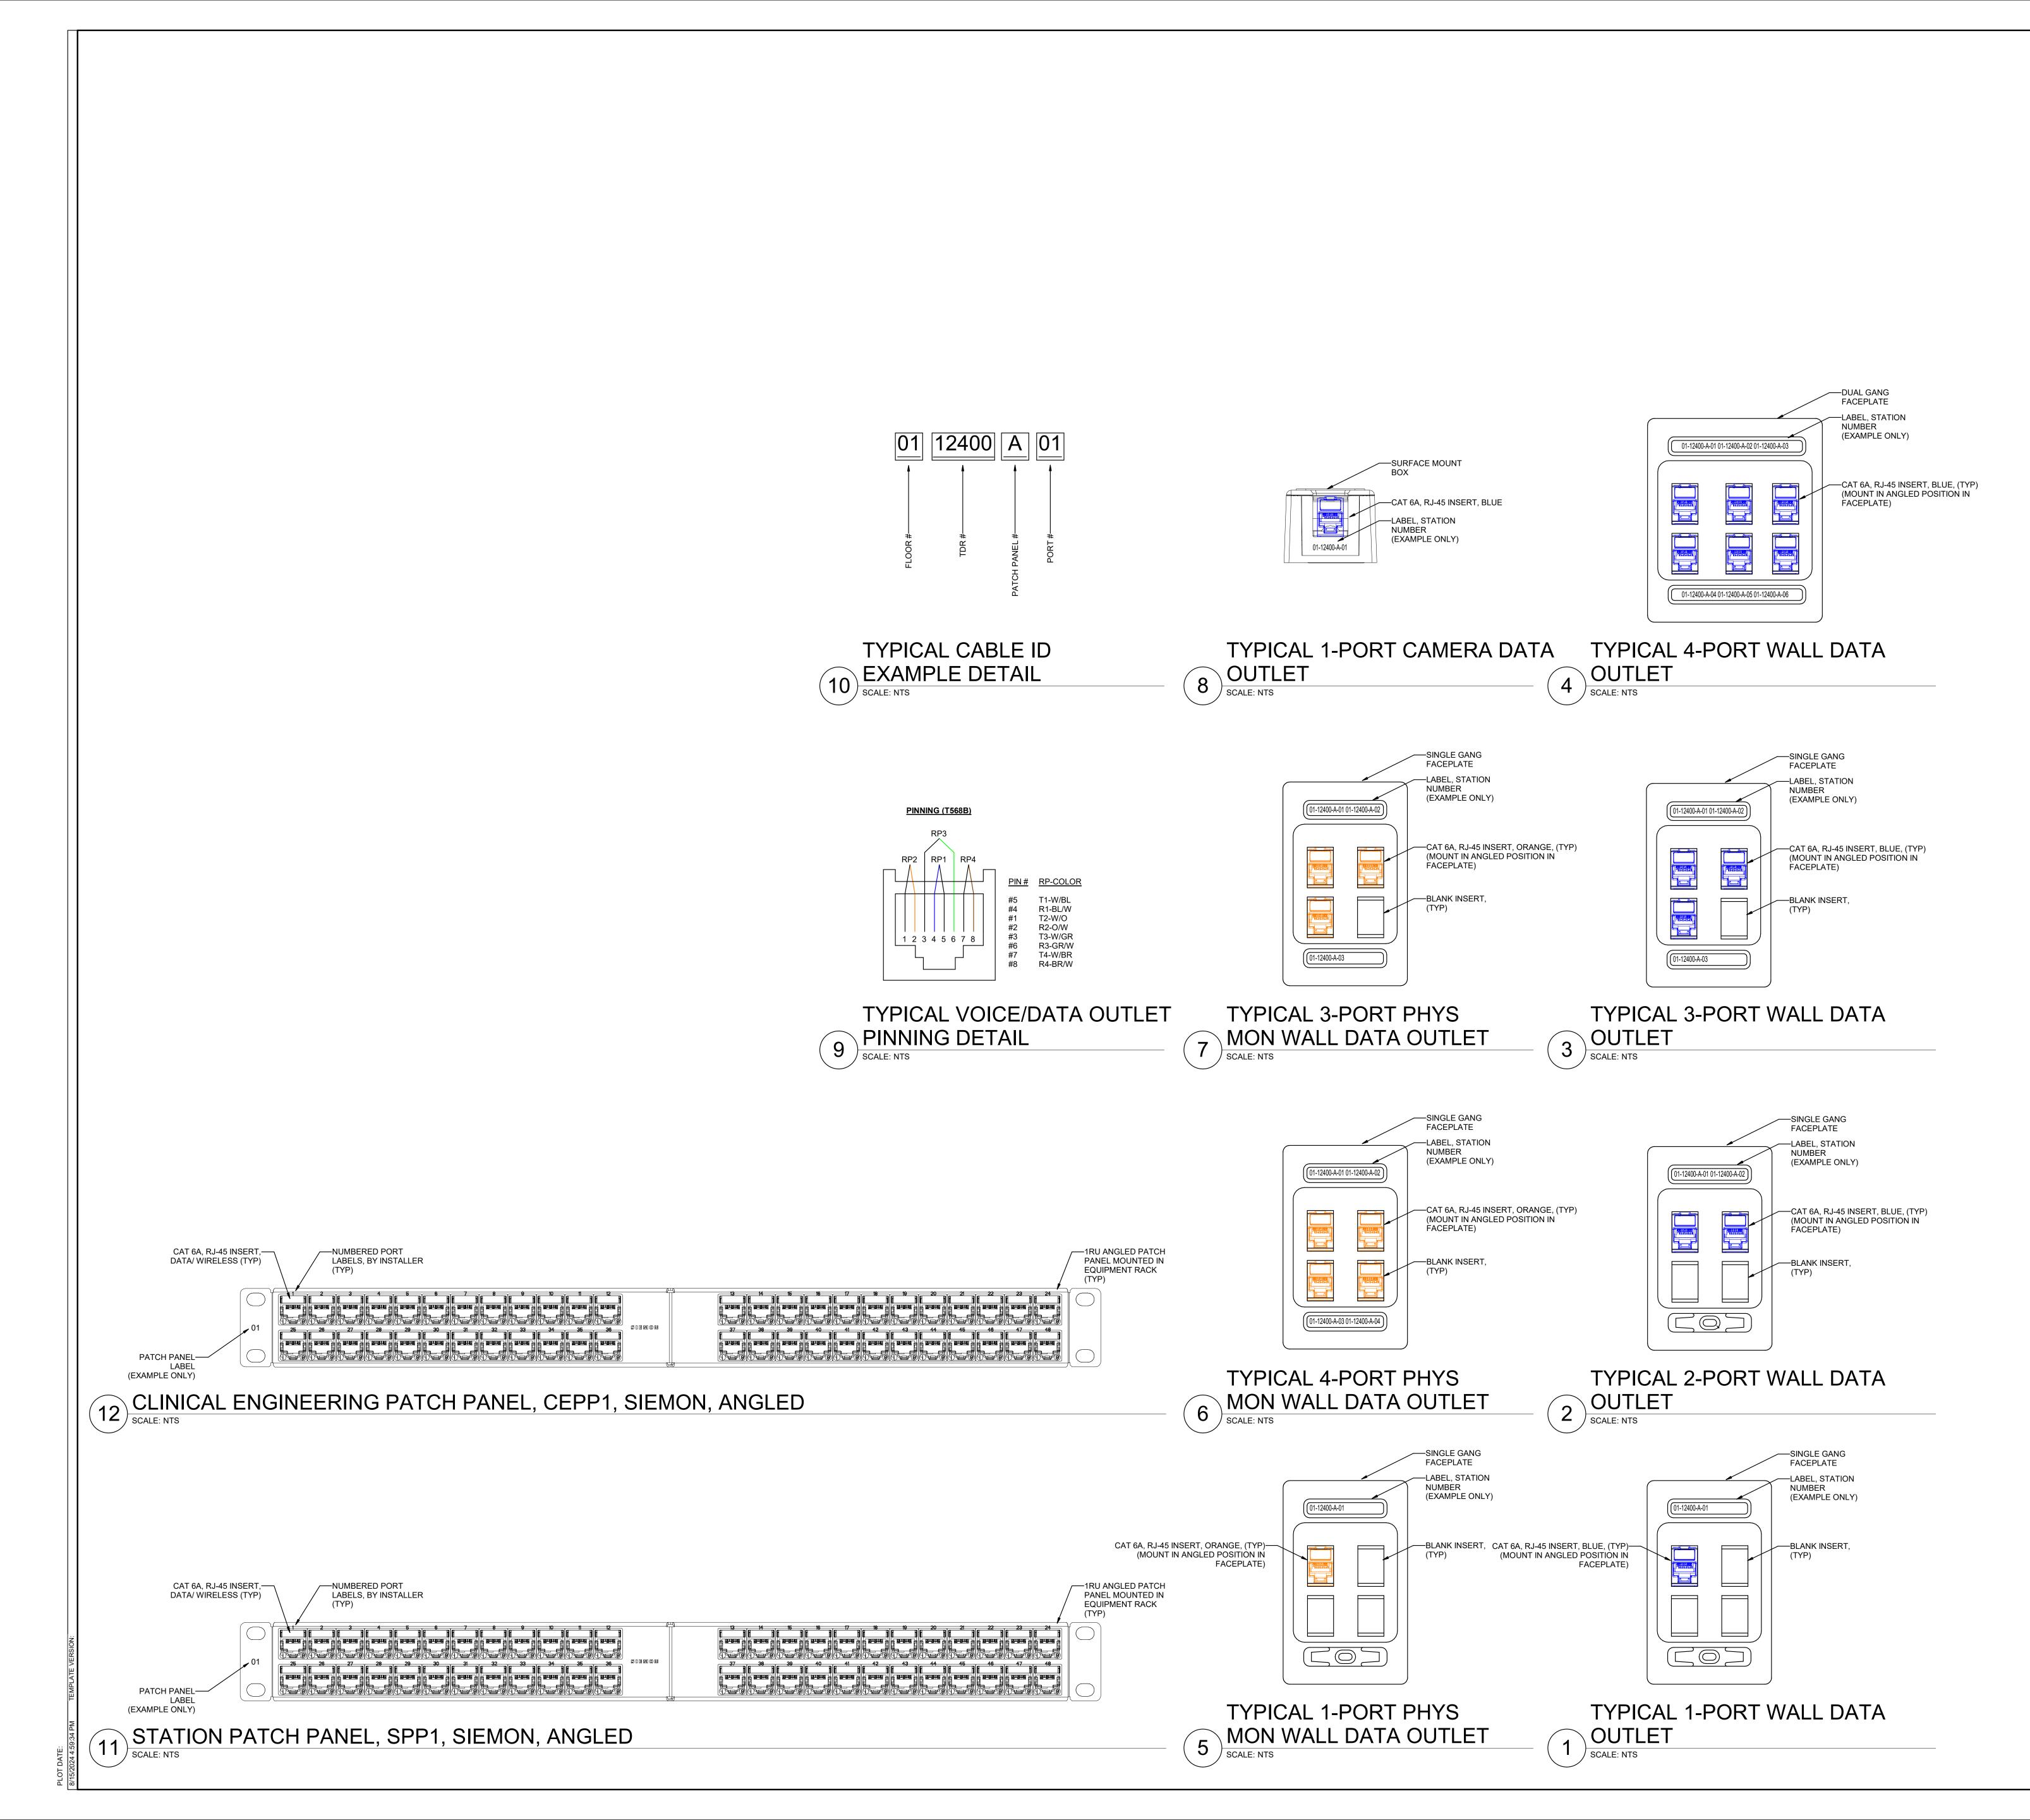



STRUCTURAL ENGINEER REAVELEY ENGINEERS & ASSOCIATES 675 EAST 500 SOUTH, SUITE 400 SALT LAKE CITY, UTAH 84102

MECHANICAL ENGINEER VAN BOERUM & FRANK ASSOCIATES, INC 181 EAST 5600 SOUTH, SUITE 130 MURRAY, UTAH 84107

ELECTRICAL ENGINEER SPECTRUM ENGINEERS, INC 324 SOUTH STATE STREET, SUITE 400 SALT LAKE CITY, UTAH 84111







U n Σ

KEY PLAN

REVISION NO. DESCRIPTION

DATE

HKS PROJECT NUMBER 26404.000 DATE 08/15/24 ISSUE CONSTRUCTION DRAWINGS SHEET TITLE TELECOM DETAILS

EP554

SHEET NO.

CLIE	NT:						JOB:	McKay Dee Ambula	atory Surg	ery Cente			CIRCI	JITS:	
PAN	EL ID:	XRY #	2	MOU	NT:	FLUSH		BOLT-ON BOLT-O		240 VOLT 1 PHASE 3 WIRE	ISOL/	ATION P	ANEL		
70			RE MA			BREAKER	LOCA					EL SIZE		32"Wx´	12"D
						, IDENTIFICATION, GROUND			ON MONI	FORS, 25 KVA, 480-240 VOL	T TRA	NSFOR	MER,		
(1) II	NDICAT	OR AL	1	, ,	í	DICATOR LIGHTS, STAINLES	SS STE	EL COVER							
			CRITIC	CAL B	RANC	H #1 SECTION	SECT	ION 1		_					
CIR	O/C P	ROT	OUTLE	ETS			LCL	LOAD	LCL		OUT	LETS	O/C P	ROT	CIR
#	AMP	POLE	LTG	CO'S	PWR	DESCRIPTION			KVA	DESCRIPTION	LTG	CO'S F	WR AMP	POLE	#
1	30	2		1		OR4 LASER	7	7	0	SPARE			30	2	2
3	30	2		1		OR5 LASER (EXISTING)	0.2	0.2	0	SPARE			30	2	4
4	30	2		1		OR6 LASER (EXISTING)	0.2	0.2	0	SPARE			30	2	4
TOT	ALS:			KVA				7.2	TOTA	L KVA				7.2	
AMPS					60	AVER	AGE AMPS				30				

LIEN	Cucoto	50					JOB:		202			28/2024		UITS:	32
ANEL	1. A. C. C. C. C.	1110 CT (C)		MOU	NT:	FLUSH	10.00 A 400 Z	BOLT-ON BOLT-C	DN	120 VOLT 1 PHASE 3 WIRE	and the second se	10.00 - 10.000			
20			RE M			BREAKER	LOCA				A CONTRACTOR OF	EL SIZE	A Design of the state of the state of the	(32"W)	(12"
-						RY, IDENTIFICATION, GROUI					_T TRA	NSFO	RMERS,		
						LIGHTS, STAINLESS STEEL	COVER	SECTION 1	CTIONS U	NDER COMMON COVER)					
10 million (10 million)	11	ROT			ECTI		LCL	LOAD	LCL	P	OUTI	ETC	O/C	POT	CI
100000	Contraction of the second second	POLE	1		D\//D	DESCRIPTION	LOL	LUAD	KVA	DESCRIPTION	10 a 11 a 11 a 11	1.5.7.1.7.4.7.2.0.1.2.1.1.1.	WRAMP	- WALKER V.	1000
1	20	2	LIU	3	F WVIN	ANESTHIESIA BOOM	0.6	1	0.4	EAST WALL PLGS	LIG	2	20	2	- #
<u>'</u>	20	~		0		AREOTTIEGIA DOOM	0.0	<u>S</u>	0.4	EAST WALLT LOS	20 - 20 Y	-	20	-	1
3	20	2		3		ANESTHESIA BOOM	0.6	1	0.4	MONITOR AND CLKS		2	20	2	
			Ĩ								1				
5	20	2				SOUTH WALL PLGS	0	0.2	0.2	NRS STN PLG		1	20	2	1.3
	12000							9225				[
7	20	2		3		EQUPMENT BOOM C PLGS	0.6	0.8	0.2	NRS STN PLG		1	20	2	1.3
~	00			-						EAST WALL BLOO				-	
9	20	2		3		EQUIPMENT BOOM C PLBS	0.6	0.8	0.2	EAST WALL PLGS		1	20	2	1
11	20	2		1		EQUIPMENT BOOM BREAKS	0.2	0.6	0.4	NORTH WALL PLGS	x	2	20	2	
	20	2		1		EQUIFMENT BOOM BREAKS	0.2	0.0	0.4	NORTH WALL PLOS	×	2	20	2	
13	20	2		2		SPARE	0.4	0.4	0	LITGHT BOOM	×		20	2	
	20	-		-		OT THE	0.1	0.11		LINGITI DOGIN			20	-	1
15	20	2		1	1	SPARE	0	0	0	SPARE	1		20	2	
	-														
DTAL	_S:			KVA				4.8	TOTAL	. KVA				4.	8
								40						2	0
20 CCES	SSOR	AMPE RIES: F	RE M	DIRE	NT: ECTO	FLUSH BREAKER RY, IDENTIFICATION, GROUI LIGHTS, STAINLESS STEEL	LOCA NDING	BOLT-ON BOLT-O			PANE	EL SIZE	: 72"H	<32"W>	
20 CCES	SSOR	ampe Ries: F R Alaf	RE M PANEL RMS, II	Mou Ain Dire Ndic/	NT: ECTO ATOR	BREAKER RY, IDENTIFICATION, GROUI LIGHTS, STAINLESS STEEL	LOCA NDING	BOLT-ON BOLT-O TION: BAR, LINE ISOLAT R (BOTH PANEL SE		120 VOLT 1 PHASE 3 WIRE FORS, 7.5 KVA, 480-120 VOI	PANE	EL SIZE	: 72"H		
20 CCES NDIC	SSOR ATOF	AMPE RIES: F R ALAF CAL B	RE M PANEL RMS, II	MOU AIN DIRE NDIC/	NT: ECTO ATOR	BREAKER RY, IDENTIFICATION, GROUI LIGHTS, STAINLESS STEEL	LOCA NDING COVEI	BOLT-ON BOLT-O TION: BAR, LINE ISOLAT R (BOTH PANEL SE SECTION 2	ON ION MONIT CTIONS U	120 VOLT 1 PHASE 3 WIRE FORS, 7.5 KVA, 480-120 VOI	PANE T TRA	EL SIZE	: 72"H RMERS,	(32"W)	(12"
	SSOR ATOF	AMPE RIES: F R ALAF CAL B ROT	RANEL RANEL RMS, II RANC	MOU AIN DIRE NDIC/ H B S	NT: ECTO ATOR	BREAKER RY, IDENTIFICATION, GROUI LIGHTS, STAINLESS STEEL ON	LOCA NDING COVEI	BOLT-ON BOLT-O TION: BAR, LINE ISOLAT R (BOTH PANEL SE	ION MONIT CTIONS U	120 VOLT 1 PHASE 3 WIRE FORS, 7.5 KVA, 480-120 VOL NDER COMMON COVER)		EL SIZE	:: 72"H RMERS, 0/C I	(32"W)	(12"
	SSOR ATOF CRITIC D/C PI	AMPE RIES: F R ALAF CAL B ROT POLE	RANEL RANEL RMS, II RANC	MOU AIN DIRE NDICA HBS _ETS CO'S	NT: ECTO ATOR	BREAKER RY, IDENTIFICATION, GROUI LIGHTS, STAINLESS STEEL ON DESCRIPTION	LOCA NDING COVEI	BOLT-ON BOLT-O TION: BAR, LINE ISOLAT R (BOTH PANEL SE SECTION 2 LOAD	ION MONIT CTIONS U	120 VOLT 1 PHASE 3 WIRE FORS, 7.5 KVA, 480-120 VOL NDER COMMON COVER) DESCRIPTION		LETS	: 72"H RMERS, O/C I	(32"W)	(12"
	SSOR ATOF	AMPE RIES: F R ALAF CAL B ROT	RANEL RANEL RMS, II RANC	MOU AIN DIRE NDIC/ H B S	NT: ECTO ATOR	BREAKER RY, IDENTIFICATION, GROUI LIGHTS, STAINLESS STEEL ON	LOCA NDING COVEI	BOLT-ON BOLT-O TION: BAR, LINE ISOLAT R (BOTH PANEL SE SECTION 2	ION MONIT CTIONS U	120 VOLT 1 PHASE 3 WIRE FORS, 7.5 KVA, 480-120 VOL NDER COMMON COVER)		EL SIZE	:: 72"H RMERS, 0/C I	(32"W)	(12"
	SSOR ATOF CRITIC D/C PI	AMPE RIES: F R ALAF CAL B ROT POLE	RANEL RANEL RMS, II RANC	MOU AIN DIRE NDICA HBS _ETS CO'S	NT: ECTO ATOR	BREAKER RY, IDENTIFICATION, GROUI LIGHTS, STAINLESS STEEL ON DESCRIPTION	LOCA NDING COVEI	BOLT-ON BOLT-O TION: BAR, LINE ISOLAT R (BOTH PANEL SE SECTION 2 LOAD	ION MONIT CTIONS U	120 VOLT 1 PHASE 3 WIRE FORS, 7.5 KVA, 480-120 VOL NDER COMMON COVER) DESCRIPTION		LETS	: 72"H RMERS, O/C I	(32"W)	(12"
	SSOR ATOF CRITIC D/C PI AMP 20	AMPE RIES: F R ALAF CAL B ROT POLE 2	RANEL RANEL RMS, II RANC	MOU AIN DIRE NDIC/ H B S ETS CO'S 3	NT: ECTO ATOR	BREAKER RY, IDENTIFICATION, GROUI LIGHTS, STAINLESS STEEL ON DESCRIPTION ANESTHESIA BOOM	LOCA NDING COVER LCL KVA 0.6	BOLT-ON BOLT-O TION: BAR, LINE ISOLAT R (BOTH PANEL SE SECTION 2 LOAD	DN ION MONIT CTIONS U LCL KVA 0.6	120 VOLT 1 PHASE 3 WIRE FORS, 7.5 KVA, 480-120 VOL NDER COMMON COVER) DESCRIPTION EAST WALL PLGS		LETS CO'S P	O/C I	(32"W)	(12"
	SSOR ATOF CRITIC D/C PI AMP 20	AMPE RIES: F R ALAF CAL B ROT POLE 2	RANEL RANEL RMS, II RANC	MOU AIN DIRE NDIC/ H B S ETS CO'S 3	NT: ECTO ATOR	BREAKER RY, IDENTIFICATION, GROUI LIGHTS, STAINLESS STEEL ON DESCRIPTION ANESTHESIA BOOM	LOCA NDING COVER LCL KVA 0.6	BOLT-ON BOLT-O TION: BAR, LINE ISOLAT R (BOTH PANEL SE SECTION 2 LOAD	DN ION MONIT CTIONS U LCL KVA 0.6	120 VOLT 1 PHASE 3 WIRE FORS, 7.5 KVA, 480-120 VOL NDER COMMON COVER) DESCRIPTION EAST WALL PLGS		LETS CO'S P	O/C I	(32"W)	(12) E
	SSOR ATOF CRITIC D/C PI AMP 20 20 20	AMPE RIES: F R ALAF CAL B ROT POLE 2 2 2	RANEL RANEL RMS, II RANC	MOU AIN DIRE NDIC/ H B S ETS CO'S 3 3	NT: ECTO ATOR	BREAKER RY, IDENTIFICATION, GROUI LIGHTS, STAINLESS STEEL ON DESCRIPTION ANESTHESIA BOOM LIGHT BOOM	LOCA NDING COVER LCL KVA 0.6 0.6 0.2	BOLT-ON BOLT-O TION: BAR, LINE ISOLAT R (BOTH PANEL SE SECTION 2 LOAD 1.2 1 0.6	DN ION MONIT CTIONS U LCL KVA 0.6 0.4 0.4	120 VOLT 1 PHASE 3 WIRE FORS, 7.5 KVA, 480-120 VOL NDER COMMON COVER) DESCRIPTION EAST WALL PLGS NORTH WALL PLGS		LETS CO'S P 3 2 2	: 72"H RMERS, WR AMF 20 20 20	<32"W) PROT POLI 2 2 2 2 2 2 2 2 2 2 2 2 2 2 2 2 2 2 2	(12"
20 CCES NDIC IR (# 1 3	SSOR ATOF CRITIC D/C PI AMP 20 20	AMPE RIES: F R ALAF CAL B ROT POLE 2 2	RANEL RANEL RMS, II RANC	MOU AIN DIRE NDIC/ H B S ETS CO'S 3	NT: ECTO ATOR	BREAKER RY, IDENTIFICATION, GROUI LIGHTS, STAINLESS STEEL ON DESCRIPTION ANESTHESIA BOOM ANESTHESIA BOOM	LOCA NDING COVEI LCL KVA 0.6	BOLT-ON BOLT-O TION: BAR, LINE ISOLAT R (BOTH PANEL SE SECTION 2 LOAD 1.2	DN ION MONIT CTIONS U LCL KVA 0.6 0.4	120 VOLT 1 PHASE 3 WIRE FORS, 7.5 KVA, 480-120 VOL NDER COMMON COVER) DESCRIPTION EAST WALL PLGS		LETS CO'S P 3	: 72"H RMERS, O/C I WR AMF 20 20	ROT PROT POLI 2	(12"
20 CCES NDIC IR (# 1 3 5 7	SSOR ATOF CRITIC D/C PI AMP 20 20 20 20	AMPE RIES: F R ALAF CAL B ROT POLE 2 2 2 2 2	RANEL RANEL RMS, II RANC	MOU AIN DIRE NDIC/ H B S ETS CO'S 3 3 1 2	NT: ECTO ATOR	BREAKER RY, IDENTIFICATION, GROUI LIGHTS, STAINLESS STEEL ON DESCRIPTION ANESTHESIA BOOM LIGHT BOOM SOUTH WALL PLGS	LOCA NDING COVER LCL KVA 0.6 0.6 0.2 0.4	BOLT-ON BOLT-O TION: BAR, LINE ISOLAT R (BOTH PANEL SE SECTION 2 LOAD 1.2 1 0.6 0.8	DN ION MONIT CTIONS U LCL KVA 0.6 0.4 0.4 0.4	120 VOLT 1 PHASE 3 WIRE FORS, 7.5 KVA, 480-120 VOI NDER COMMON COVER) DESCRIPTION EAST WALL PLGS NORTH WALL PLGS NURSE STATION PLGS		LETS CO'S P 3 2 2 2 2	:: 72"H RMERS, WR AMF 20 20 20 20 20	ROT PROT 2 2 2 2 2 2 2 2 2 2 2 2	(12)
	SSOR ATOF CRITIC D/C PI AMP 20 20 20	AMPE RIES: F R ALAF CAL B ROT POLE 2 2 2	RANEL RANEL RMS, II RANC	MOU AIN DIRE NDIC/ H B S ETS CO'S 3 3	NT: ECTO ATOR	BREAKER RY, IDENTIFICATION, GROUI LIGHTS, STAINLESS STEEL ON DESCRIPTION ANESTHESIA BOOM LIGHT BOOM	LOCA NDING COVER LCL KVA 0.6 0.6 0.2	BOLT-ON BOLT-O TION: BAR, LINE ISOLAT R (BOTH PANEL SE SECTION 2 LOAD 1.2 1 0.6	DN ION MONIT CTIONS U LCL KVA 0.6 0.4 0.4	120 VOLT 1 PHASE 3 WIRE FORS, 7.5 KVA, 480-120 VOL NDER COMMON COVER) DESCRIPTION EAST WALL PLGS NORTH WALL PLGS		LETS CO'S P 3 2 2	: 72"H RMERS, WR AMF 20 20 20	<32"W) PROT POLI 2 2 2 2 2 2 2 2 2 2 2 2 2 2 2 2 2 2 2	(12)
20 CCES NDIC IR (# 1 3 5 7 9	SSOR ATOF CRITIC D/C PI AMP 20 20 20 20 20 20	AMPE RIES: F R ALAF CAL B ROT POLE 2 2 2 2 2 2	RANEL RANEL RMS, II RANC	MOU AIN DIRE NDIC/ H B S ETS CO'S 3 3 1 2 2	NT: ECTO ATOR	BREAKER RY, IDENTIFICATION, GROUI LIGHTS, STAINLESS STEEL ON DESCRIPTION ANESTHESIA BOOM LIGHT BOOM SOUTH WALL PLGS PAX STN PLGS	LOCA NDING COVER LCL KVA 0.6 0.6 0.2 0.4 0.4	BOLT-ON BOLT-O TION: BAR, LINE ISOLAT R (BOTH PANEL SE SECTION 2 LOAD 1.2 1 0.6 0.8	DN ION MONIT CTIONS U LCL KVA 0.6 0.4 0.4 0.4 0.4	120 VOLT 1 PHASE 3 WIRE FORS, 7.5 KVA, 480-120 VOI NDER COMMON COVER) DESCRIPTION EAST WALL PLGS NORTH WALL PLGS NURSE STATION PLGS NURSE STATION PLGS		LETS CO'S P 3 2 2 2 2	:: 72"H RMERS, WR AMF 20 20 20 20 20 20 20	32"W) PROT POLI 2 3	(12)
20 CCES NDIC IR (# 1 3 5 7 9	SSOR ATOF CRITIC D/C PI AMP 20 20 20 20	AMPE RIES: F R ALAF CAL B ROT POLE 2 2 2 2 2	RANEL RANEL RMS, II RANC	MOU AIN DIRE NDIC/ H B S ETS CO'S 3 3 1 2	NT: ECTO ATOR	BREAKER RY, IDENTIFICATION, GROUI LIGHTS, STAINLESS STEEL ON DESCRIPTION ANESTHESIA BOOM LIGHT BOOM SOUTH WALL PLGS	LOCA NDING COVER LCL KVA 0.6 0.6 0.2 0.4 0.4	BOLT-ON BOLT-O TION: BAR, LINE ISOLAT R (BOTH PANEL SE SECTION 2 LOAD 1.2 1 0.6 0.8	DN ION MONIT CTIONS U LCL KVA 0.6 0.4 0.4 0.4	120 VOLT 1 PHASE 3 WIRE FORS, 7.5 KVA, 480-120 VOI NDER COMMON COVER) DESCRIPTION EAST WALL PLGS NORTH WALL PLGS NURSE STATION PLGS		LETS CO'S P 3 2 2 2 2	:: 72"H RMERS, WR AMF 20 20 20 20 20	ROT PROT 2 2 2 2 2 2 2 2 2 2 2 2	(12)
20 CCES NDIC IR (# 7 3 5 7 9 9	SSOR ATOF CRITIC D/C PI AMP 20 20 20 20 20 20 20	AMPE RIES: F R ALAF CAL B ROT POLE 2 2 2 2 2 2 2 2	RANEL RANEL RMS, II RANC	MOU AIN DIRE NDIC/ H B S ETS CO'S 3 3 1 2 2 2 3	NT: ECTO ATOR	BREAKER RY, IDENTIFICATION, GROUI LIGHTS, STAINLESS STEEL ON DESCRIPTION ANESTHESIA BOOM ANESTHESIA BOOM LIGHT BOOM SOUTH WALL PLGS PAX STN PLGS EQUIPMENT BOOM C PLGS	LOCA NDING COVER 0.6 0.6 0.2 0.4 0.4 0.6	BOLT-ON BOLT-O TION: BAR, LINE ISOLAT R (BOTH PANEL SE SECTION 2 LOAD 1.2 1 0.6 0.8 0.8 0.8	DN ION MONIT CTIONS U LCL KVA 0.6 0.4 0.4 0.4 0.4	120 VOLT 1 PHASE 3 WIRE FORS, 7.5 KVA, 480-120 VOI NDER COMMON COVER) DESCRIPTION EAST WALL PLGS NORTH WALL PLGS NURSE STATION PLGS NURSE STATION PLGS SPARE		LETS CO'S P 3 2 2 2 2	:: 72"H RMERS, WR AMF 20 20 20 20 20 20 20 20 20	32"W) PROT POLI 2 3 2 3 4 <p< td=""><td>(12"</td></p<>	(12"
20 CCES NDIC IR (# 7 1 3 5 7 9 9	SSOR ATOF CRITIC D/C PI AMP 20 20 20 20 20 20	AMPE RIES: F R ALAF CAL B ROT POLE 2 2 2 2 2 2	RANEL RANEL RMS, II RANC	MOU AIN DIRE NDIC/ H B S ETS CO'S 3 3 1 2 2	NT: ECTO ATOR	BREAKER RY, IDENTIFICATION, GROUI LIGHTS, STAINLESS STEEL ON DESCRIPTION ANESTHESIA BOOM LIGHT BOOM SOUTH WALL PLGS PAX STN PLGS	LOCA NDING COVER 0.6 0.6 0.2 0.4 0.4 0.6	BOLT-ON BOLT-O TION: BAR, LINE ISOLAT R (BOTH PANEL SE SECTION 2 LOAD 1.2 1 0.6 0.8	DN ION MONIT CTIONS U LCL KVA 0.6 0.4 0.4 0.4 0.4 0.4 0.4	120 VOLT 1 PHASE 3 WIRE FORS, 7.5 KVA, 480-120 VOI NDER COMMON COVER) DESCRIPTION EAST WALL PLGS NORTH WALL PLGS NURSE STATION PLGS NURSE STATION PLGS		LETS CO'S P 3 2 2 2 2	:: 72"H RMERS, WR AMF 20 20 20 20 20 20 20	32"W) PROT POLI 2 3	(12"
20 CCES NDIC (# 7 1 3 5 7 9 11 13	SSOR ATOF CRITIC D/C PI AMP 20 20 20 20 20 20 20	AMPE RIES: F R ALAF CAL B ROT POLE 2 2 2 2 2 2 2 2	RANEL RANEL RMS, II RANC	MOU AIN DIRE NDIC/ H B S ETS CO'S 3 3 1 2 2 2 3	NT: ECTO ATOR	BREAKER RY, IDENTIFICATION, GROUI LIGHTS, STAINLESS STEEL ON DESCRIPTION ANESTHESIA BOOM ANESTHESIA BOOM LIGHT BOOM SOUTH WALL PLGS PAX STN PLGS EQUIPMENT BOOM C PLGS	LOCA NDING COVER 0.6 0.6 0.2 0.4 0.4 0.6	BOLT-ON BOLT-O TION: BAR, LINE ISOLAT R (BOTH PANEL SE SECTION 2 LOAD 1.2 1 0.6 0.8 0.8 0.8	DN ION MONIT CTIONS U LCL KVA 0.6 0.4 0.4 0.4 0.4 0.4 0.4	120 VOLT 1 PHASE 3 WIRE FORS, 7.5 KVA, 480-120 VOI NDER COMMON COVER) DESCRIPTION EAST WALL PLGS NORTH WALL PLGS NURSE STATION PLGS NURSE STATION PLGS SPARE		LETS CO'S P 3 2 2 2 2	:: 72"H RMERS, WR AMF 20 20 20 20 20 20 20 20 20	32"W) PROT POLI 2 3 2 3 4 <p< td=""><td>(12"</td></p<>	(12"
20 CCES NDIC IR (# 7 1 3 5 7 9 11 13 13 15	SSOR ATOF CRITIC D/C PI AMP 20 20 20 20 20 20 20 20 20 20 20 20 20	AMPE RIES: F RALAF CAL B ROT POLE 2 2 2 2 2 2 2 2 2 2 2 2 2 2 2 2 2 2 2	RANC OUTI LTG	MOU AIN DIRE NDIC/ H B S ETS CO'S 3 3 3 1 2 2 3 3 3 3 3 3 3 3 3 3 2 2	NT: ECTO ATOR	BREAKER RY, IDENTIFICATION, GROUI LIGHTS, STAINLESS STEEL ON DESCRIPTION ANESTHESIA BOOM ANESTHESIA BOOM LIGHT BOOM SOUTH WALL PLGS PAX STN PLGS EQUIPMENT BOOM C PLGS	LOCA NDING COVER LCL KVA 0.6 0.2 0.4 0.4 0.4 0.6 0.6	BOLT-ON BOLT-O TION: BAR, LINE ISOLAT R (BOTH PANEL SE SECTION 2 LOAD 1.2 1 0.6 0.8 0.8 0.8 0.6	DN ION MONIT CTIONS U LCL KVA 0.6 0.4 0.4 0.4 0.4 0.4 0.4 0.4 0.4 0.4 0.4	120 VOLT 1 PHASE 3 WIRE FORS, 7.5 KVA, 480-120 VOL NDER COMMON COVER) DESCRIPTION EAST WALL PLGS NORTH WALL PLGS NURSE STATION PLGS NURSE STATION PLGS NURSE STATION PLGS SPARE SPARE SPARE		LETS CO'S P 3 2 2 2 2	:: 72"H RMERS, WR AMF 20 20 20 20 20 20 20 20 20 20 20 20 20	ROT PROT 2 3 2 3 4 <td>(12"</td>	(12"
20 CCES NDIC (# 7 1 3 5 7 9 11 13 13 15	SSOR ATOF CRITIC D/C PI AMP 20 20 20 20 20 20 20 20 20 20 20 20 20	AMPE RIES: F RALAF CAL B ROT POLE 2 2 2 2 2 2 2 2 2 2 2 2 2 2 2 2 2 2 2	RANC PANEL RMS, II OUTL LTG	MOU AIN DIRE NDIC/ H B S ETS CO'S 3 3 1 2 2 3 3 3 3 3 3 3 3 3 4 2 8 5 8 5 7 8 7 8 7 8 7 8 7 8 7 8 7 8 7 8		BREAKER RY, IDENTIFICATION, GROUI LIGHTS, STAINLESS STEEL ON DESCRIPTION ANESTHESIA BOOM ANESTHESIA BOOM LIGHT BOOM SOUTH WALL PLGS PAX STN PLGS EQUIPMENT BOOM C PLGS	LOCA NDING COVER LCL KVA 0.6 0.2 0.4 0.4 0.4 0.6 0.6	BOLT-ON BOLT-O TION: BAR, LINE ISOLAT R (BOTH PANEL SE SECTION 2 LOAD 1.2 1 0.6 0.8 0.8 0.8 0.8 0.8 0.6 0.6 0.6 0.4	DN ION MONIT CTIONS U LCL KVA 0.6 0.4 0.4 0.4 0.4 0.4 0.4 0.4 0.4 0.4 0.4	120 VOLT 1 PHASE 3 WIRE TORS, 7.5 KVA, 480-120 VOI NDER COMMON COVER) DESCRIPTION EAST WALL PLGS NORTH WALL PLGS NURSE STATION PLGS NURSE STATION PLGS NURSE STATION PLGS SPARE SPARE SPARE		LETS CO'S P 3 2 2 2 2	:: 72"H RMERS, WR AMF 20 20 20 20 20 20 20 20 20 20 20 20 20	ROT PROT 2 2 2 2 2 2 2 2 2 2 2 2 2 2 2 2 3 2 4 2 4 2 4 2 4 <td>(12"</td>	(12"
20 CCES NDIC IR (# 1 3 5 7	SSOR ATOF 20 20 20 20 20 20 20 20 20 20 20 20 20	AMPE RIES: F RALAF CAL B ROT POLE 2 2 2 2 2 2 2 2 2 2 2 2 2 2 2 2 2 2 2	RANC PANEL RMS, II OUTL LTG	MOU AIN DIRE NDIC/ H B S ETS CO'S 3 3 3 1 2 2 3 3 3 3 3 3 3 3 3 3 2 2		BREAKER RY, IDENTIFICATION, GROUI LIGHTS, STAINLESS STEEL ON DESCRIPTION ANESTHESIA BOOM ANESTHESIA BOOM LIGHT BOOM SOUTH WALL PLGS PAX STN PLGS EQUIPMENT BOOM C PLGS	LOCA NDING COVER LCL KVA 0.6 0.2 0.4 0.4 0.4 0.6 0.6	BOLT-ON BOLT-O TION: BAR, LINE ISOLAT R (BOTH PANEL SE SECTION 2 LOAD 1.2 1 0.6 0.8 0.8 0.8 0.8 0.6 0.6 0.6	DN ION MONIT CTIONS U LCL KVA 0.6 0.4 0.4 0.4 0.4 0.4 0.4 0.4 0.4 0.4 0.4	120 VOLT 1 PHASE 3 WIRE FORS, 7.5 KVA, 480-120 VOL NDER COMMON COVER) DESCRIPTION EAST WALL PLGS NORTH WALL PLGS NURSE STATION PLGS NURSE STATION PLGS NURSE STATION PLGS SPARE SPARE SPARE		LETS CO'S P 3 2 2 2 2	:: 72"H RMERS, WR AMF 20 20 20 20 20 20 20 20 20 20 20 20 20	ROT PROT 2 3 2 3 4 <td></td>	



STRUCTURAL ENGINEER REAVELEY ENGINEERS & ASSOCIATES 675 EAST 500 SOUTH, SUITE 400 SALT LAKE CITY, UTAH 84102

MECHANICAL ENGINEER VAN BOERUM & FRANK ASSOCIATES, INC 181 EAST 5600 SOUTH, SUITE 130 MURRAY, UTAH 84107

ELECTRICAL ENGINEER SPECTRUM ENGINEERS, INC 324 SOUTH STATE STREET, SUITE 400 SALT LAKE CITY, UTAH 84111










KEY PLAN

REVISION NO. DESCRIPTION DATE

HKS PROJECT NUMBER 26404.000 DATE 08/15/24 ISSUE CONSTRUCTION DRAWINGS SHEET TITLE PANEL SCHEDULES


EP601

SHEET NO.

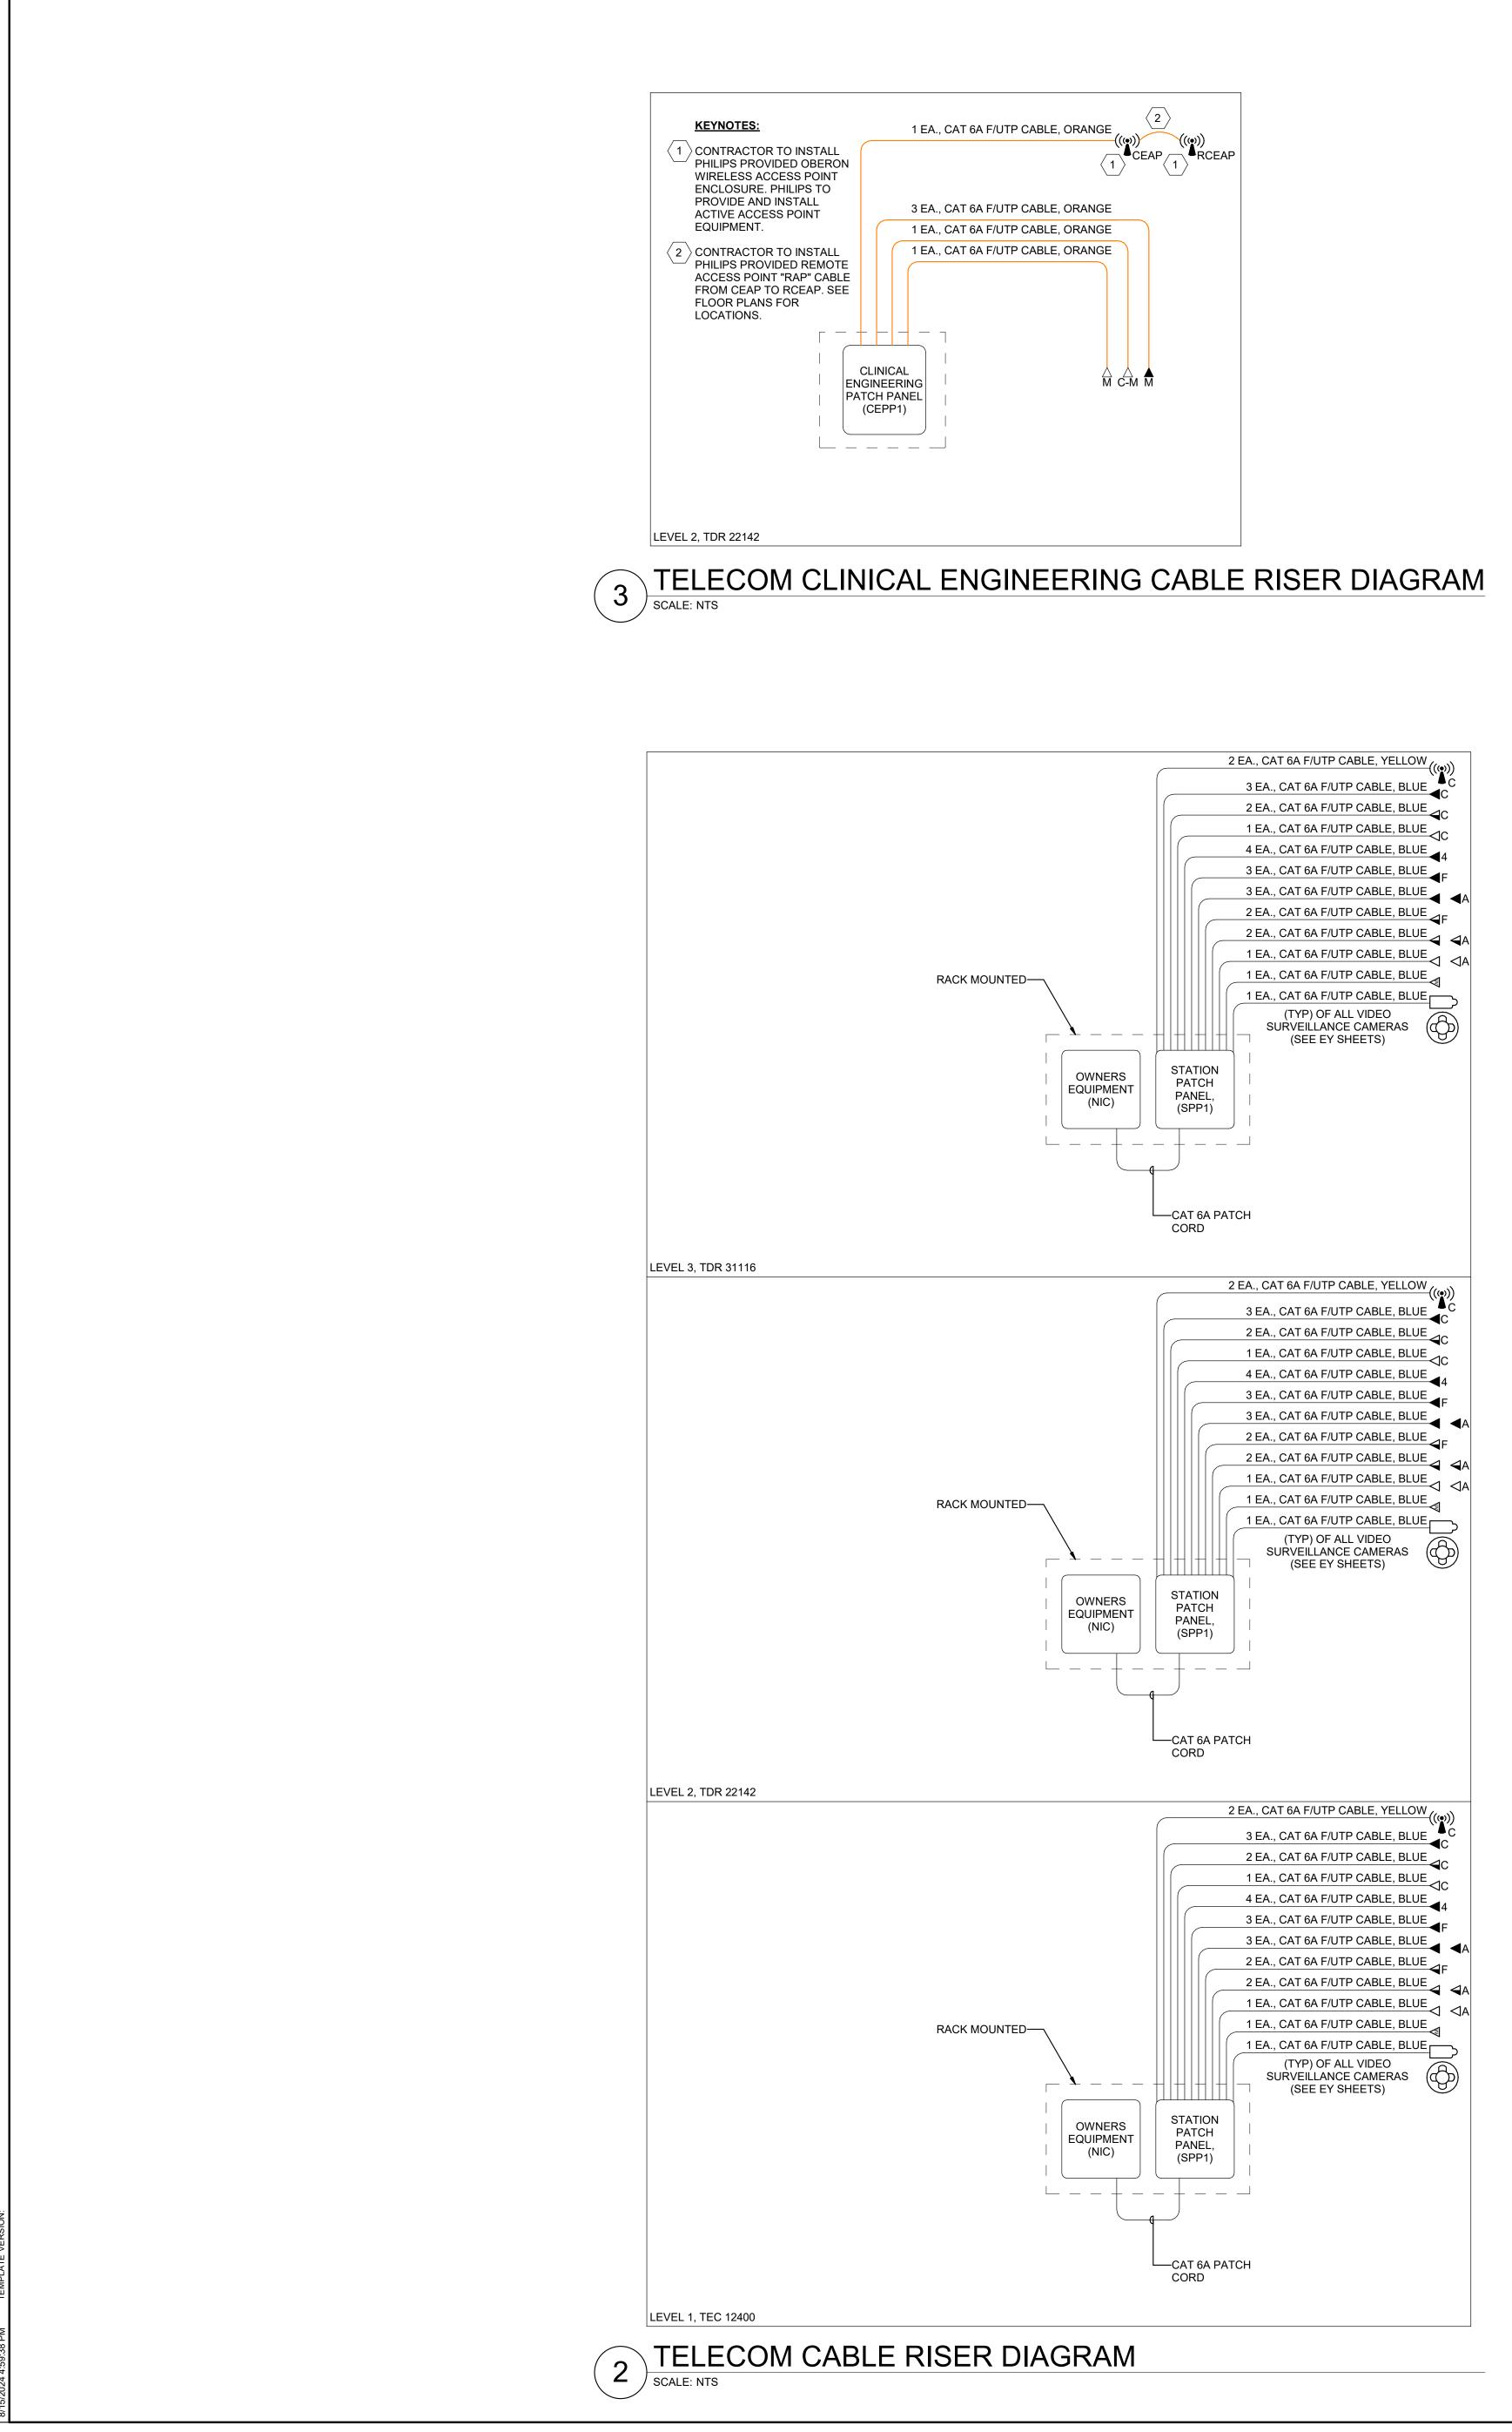

TDR 31116 GROUNDING-ELECTRODE 🗹 LEVEL 3 TDR 22142 GROUNDING ELECTRODE 🗹 LEVEL 2 TEC 21400 LEVEL 1 4

TELECOM CONDUIT RISER DIAGRAM

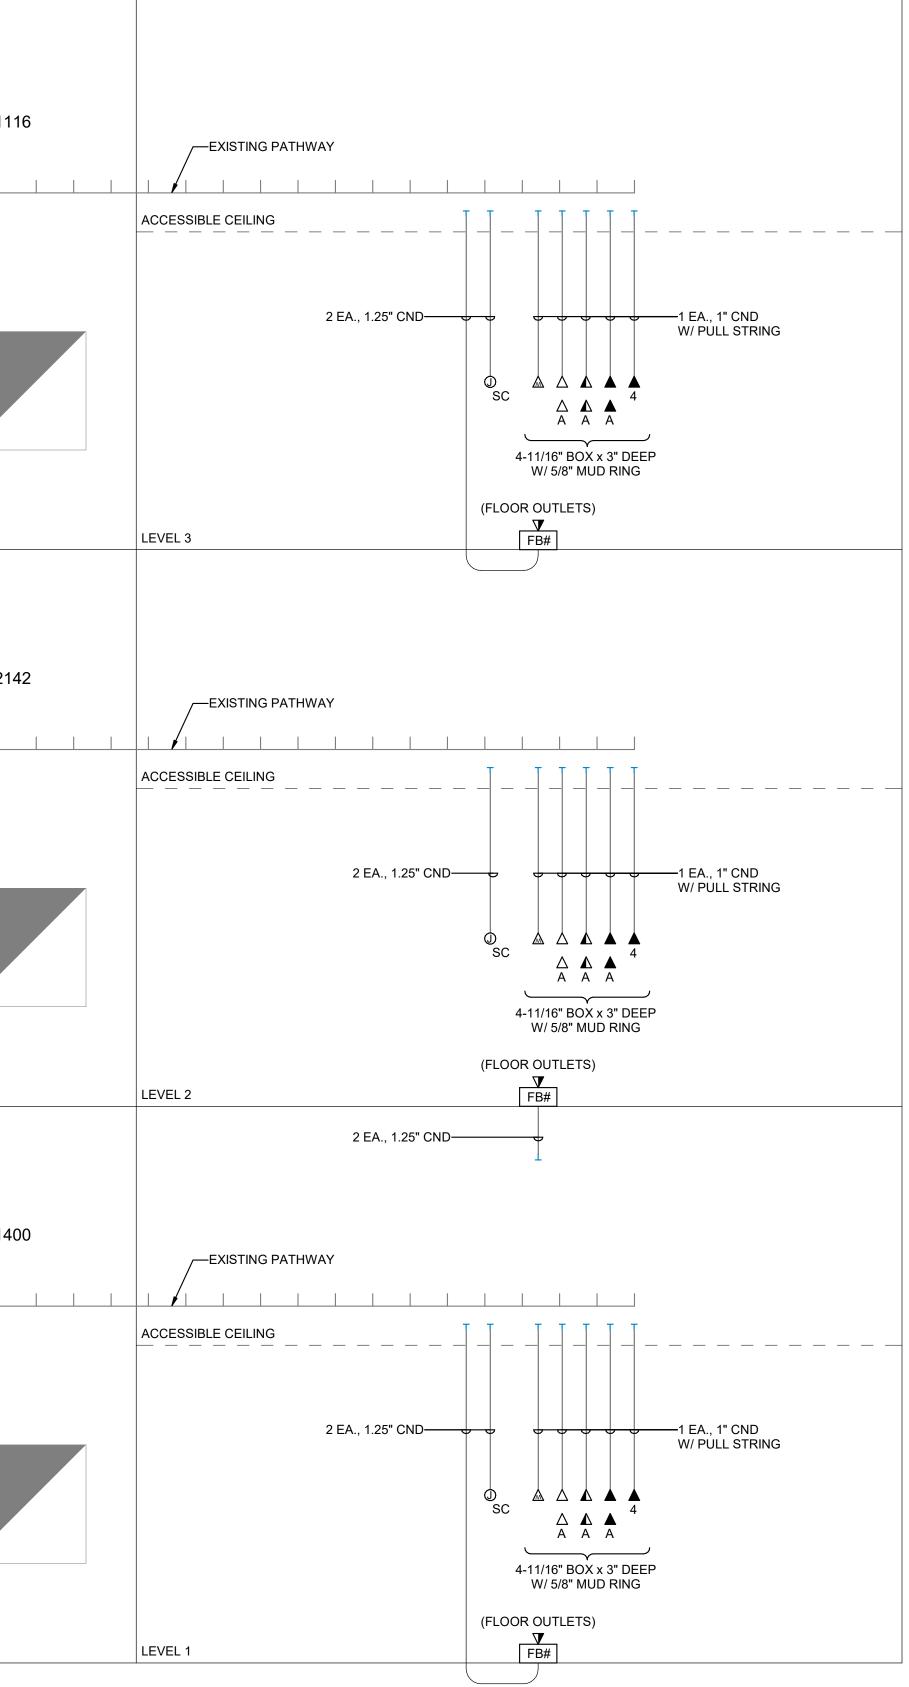



ARCHITECT HKS ARCHITECTS, INC. 222 SOUTH MAIN, SUITE 230 SALT LAKE CITY, UT 84101

STRUCTURAL ENGINEER **REAVELEY ENGINEERS & ASSOCIATES** 675 EAST 500 SOUTH, SUITE 400 SALT LAKE CITY, UTAH 84102

MECHANICAL ENGINEER VAN BOERUM & FRANK ASSOCIATES, INC 181 EAST 5600 SOUTH, SUITE 130 MURRAY, UTAH 84107

ELECTRICAL ENGINEER SPECTRUM ENGINEERS, INC 324 SOUTH STATE STREET, SUITE 400 SALT LAKE CITY, UTAH 84111









KEY PLAN


REVISION NO. DESCRIPTION

DATE

HKS PROJECT NUMBER 26404.000 DATE 08/15/24 ISSUE CONSTRUCTION DRAWINGS SHEET TITLE **TELECOM RISER** DIAGRAMS

EP651

SHEET NO.

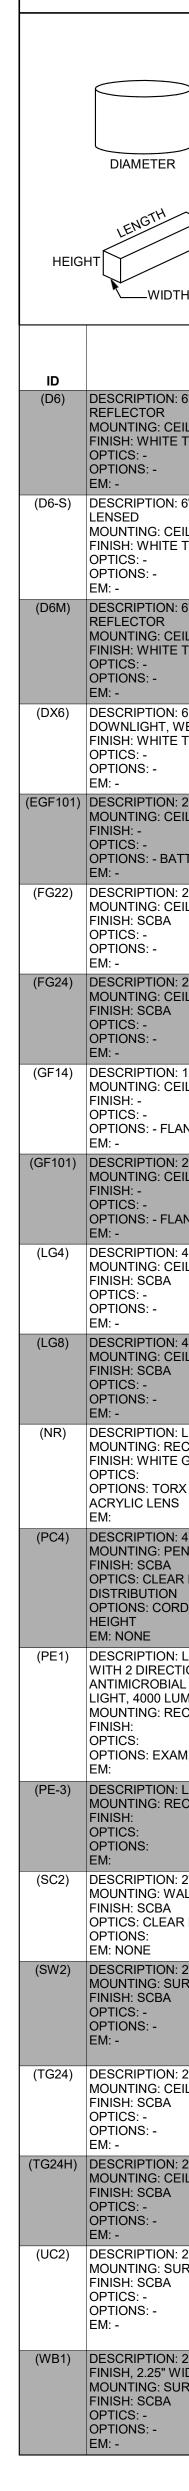

INTERIOR LIGHTING FIXTURE SCHEDULE

HEIGHT	
\bigcirc	
TH	

GENERAL NOTES

. SUBSTITUTIONS AND/OR EQUAL FIXTURES MUST RECEIVE APPROVAL PRIOR TO BIDDING, THEY MUST BE SUBMITTED TO THE ENGINEER NO LESS THAN 2 WEEKS PRIOR TO BID OPENING.

2. SAMPLES MUST BE PROVIDED FOR ANY AND ALL FIXTURES UPON A/E REQUEST PRIOR TO RELEASING FIXTURES.

3. ALL FIXTURES SHALL BE LISTED AND APPROVED FOR THEIR INTENDED USE AND LOCATION.

4. VERIFY THE PROPER MOUNTING KITS OR ACCESSORIES TO FACILITATE INSTALLATION AS SHOWN AT EACH LOCATION ON THE DRAWINGS. 5. COMPLY WITH THE "INTERIOR LIGHTING" SECTION OF THE SPECIFICATIONS.

6. ALL LIGHT FIXTURES TO BE EITHER "DLC" OR "LIGHTING FACTS" LISTED OR TO BE APPROVED BY ARCHITECT/ENGINEER AND OWNER.

. CONTRACTOR ALLOWANCE PRICES ARE ACCURATE WHEN THIS JOB WAS SPECIFIED, CONTRACTOR AND ELECTRICAL DISTRIBUTOR SHALL VERIFY THIS ALLOWANCE AND REPORT ANY PROBLEMS TO THE ENGINEER BEFORE THE BID. ALLOWANCE PRICE MAY OR MAY NOT INCLUDE LAMP(S) OR FREIGHT AS NOTED, AND DO NOT INCLUDE ANY TAXES.

DIH	INGEODE ANT TAXES.									
	DESCRIPTION	SIZE (NOMINAL)	DELIVERED DIRECT LUMENS	LUMINAIRE DELIVERED INDIRECT LUMENS	COLOR TEMP	CRI	TYPE	RIVER VOLTAGE	WATTS	MANUFACTURER (CATALOG SERIES)
N: 6" ROUND, REG CEILING, RECESS TE TRIM FINISH	CESSED LED DOWNLIGHT, SEMI-SPECULAR	LENGTH: - WIDTH: - DEPTH: - DIAMETER: 0' - 6"	1,500		3500K		0-10V DIMMING (1%)	120/277	19	GOTHAM (EVO 35/15 AR LSS MWD MVOLT GZ1 TRW) HALO (HC615D010HM612835 61MDHWF) LIGHTOLIER (6RNP6RDL15835CCZ10U)
N: 6" ROUND, REC CEILING, RECESS TE TRIM FINISH	CESSED LED SHOWER DOWNLIGHT, SED	LENGTH: - WIDTH: - DEPTH: - DIAMETER: 0' - 6"	1,500		3500K		0-10V DIMMING (1%)	120/277	19	GOTHAM (EVO-35/15-6DFR) LITON (LHALD) HALO (HC615) INTENSE (SS6G3DR)
N: 6" ROUND, REC CEILING, RECESS TE TRIM FINISH	CESSED LED DOWNLIGHT, SEMI-SPECULAR	LENGTH: - WIDTH: - DEPTH: - DIAMETER: 0' - 6"	2,000		3500K		0-10V DIMMING (1%)	120/277	23	GOTHAM (EVO 35/15 AR LSS MWD MVOLT GZ1 TRW) HALO (HC615D010HM612835 61MDHWF) LIGHTOLIER (6RNP6RDL15835CCZ10U)
		LENGTH: - WIDTH: - DEPTH: - DIAMETER: 0' - 6"	2,000		3500K		0-10V DIMMING (1%)	120/277	23	GOTHAM (EVO 35/20 6WR WD MVO LT EZ10)
N: 2' X 4' LED SUF CEILING, RECESS BATTERY PACK, F		LENGTH: 4' - 0" WIDTH: 2' - 0" DEPTH: -	16,000		3500K		0-10V DIMMING (1%)	120/277	200	KENALL (M4SEDI-14-76L35K-DCC-DV-2F-PAH- ASYM (LEL)) KURTZON (ML-OR) NEW STAR(SSF24-HCOC-L8351-A-UN-DM)
N: 2' X 2' LED FLA CEILING, RECESS A	T PANEL, GRID LAY-IN SED	LENGTH: 2' - 0" WIDTH: 2' - 0" DEPTH: -	3,400		3500K		0-10V DIMMING (1%)	120/277	40	DAYBRITE (2FPZ38L840WDSUNVDIM) LITHONIA (EPANL) TRULY GREEN SOLUTIONS (882440-35-S-F)
N: 2' X 4' LED FLA CEILING, RECESS A	T PANEL, GRID LAY-IN SED	LENGTH: 4' - 0" WIDTH: 2' - 0" DEPTH: -	4,300		3500K		0-10V DIMMING (1%)	120/277	50	DAYBRITE (2FPZ43L8354DSUNV DIM) LITHONIA (EPANL) TRULY GREEN SOLUTIONS (882440-35-S-F)
N: 1' X 4' LED SUF CEILING, RECESS FLANGE KIT	RGICAL TROFFER SED	LENGTH: 4' - 0" WIDTH: 1' - 0" DEPTH: -	8,000		3500K		0-10V DIMMING (1%)	120/277	100	KENALL (M4SEDI-14-76L35K-DCC-DV-2F-PAH- ASYM (LEL))
DN: 2' X 4' LED SUF CEILING, RECESS FLANGE KIT	RGICAL TROFFER SED	LENGTH: 4' - 0" WIDTH: 2' - 0" DEPTH: -	16,000		3500K		0-10V DIMMING (1%)	120/277	200	KENALL (M4SEDI-24-76L35K-DCC-DV-2F-PAH- ASYM (LEL)) KURTZON (ML-OR) NEW
	RECESSED SLOT, GRID MOUNT SED	LENGTH: 4" - 0" WIDTH: 0' - 4" DEPTH: -	2,000		3500K		0-10V DIMMING (1%)	120/277	22	STAR(SSF24-HCOC-L8351-A-UN-DM) PINNACLE (E4A-835-4'-GX-U-OL1-1-W NEORAY (S124DR) MARK LIGHTING (SL4L)
N: 4" X 8' LINEAR CEILING, RECESS A		LENGTH: 8' - 0" WIDTH: 0' - 4" DEPTH: -	4,000		3500K		0-10V DIMMING (1%)	120/277	48	PINNACLE (E4A-835-8'-GX-U-OL1-1-W NEORAY (S124DR) MARK LIGHTING (SL4L)
RECESSED, WALI TE GLOSS FINISH		LENGTH: 0' - 2.5" WIDTH: 0' - 3" DEPTH: -	150		AMBER		NO DIMMING	120/277	5	KENNAL (MCSL-HR-MW-2L35K-DV) HEALTHCARE (HNL610-MV-LED-AMB-TR-FW) NEW STAR (HNL HH LA UN NF ND AM
)N	TEM CYLINDER MATTE DIFFUSE, MEDIUM WIDE ARCHITECT IN FIELD FOR SUSPENSION	HEIGHT: 9" DIAMETER: 5.5" APERTURE: 4"	1,500		3000K	80	0-10V DIMMING (1%)	120/277V	14	GOTHAM (EVO4PC) PORTFOLIO (LER4B) LIGHTOLIER (C4PDL)
CTIONAL READIN	LIGHT	LENGTH: 4' - 0" WIDTH: 2' - 0" DEPTH: -	11,400		3500K		0-10V DIMMING (1%)	120/277	135	KENALL (MPCADE24-G-45L/90L40K-DCC-DV-1 B-AC-AMF-LRL) NEW STAR (SMDOS-HC-L340-L240-RL-UN) HEALTHCARE (HPT624-G-UNV-PAI-LED40-FC100-LV D-AC-DIM-AM-SL)
N: LABOR AND DI RECESSED		LENGTH: 2' - 0" WIDTH: 2' - 0" DEPTH: -	8,000		3500K	80	-	120/277	280	OWNER FURNISHED CONTRACTOR INSTALLED
N: 2" CYLINDER WALL A EAR REFLECTOR,	MATTE DIFFUSE, MEDIUM DISTRIBUTION	HEIGHT: 5" DIAMETER: 3" APERTURE: 2"	1,500		3000K	80	LED (0-10V DIMMING) 1%	120/277V	14	GOTHAM (EVO4SC) SENSO (652) LIGHTOLIER (C2CPSDL)
N: 2' LED VANITY SURFACE, WALL A	LIGHT, SATIN CHROME FINISH, 2.25" WIDE	LENGTH: 2' - 0" WIDTH: 0' - 2.25" DEPTH: -	2,000		3500K		NO DIMMING	120/277	19	EDGE LIGHT (TW12-S11-1RE-36"-35K-CH) EUREKA (3541-35-LED-17.40-120/277-SC-WH) LBL (LW496-OP-XX-LED-277) WAC (WS-77363) BIRCHWOOD (NOL-LED-225)
N: 2' X 4' LED TRO CEILING, RECESS A	DFFER, EDGE LIT PANELS, GRID LAY-IN SED	LENGTH: 4' - 0" WIDTH: 2' - 0" DEPTH: -	4,300		3500K		0-10V DIMMING (1%)	120/277	60	METALUX (24EN-LD2-45-UNV-L835-CD1-U) HE WILLIAMS (AP-22-L43/835-DIM1-UMV) LITHONIA (EVNX)
N: 2' X 4' LED TRO CEILING, RECESS A	OFFER, EDGE LIT PANELS, GRID LAY-IN SED	LENGTH: 4' - 0" WIDTH: 2' - 0" DEPTH: -	6,700		3500K		0-10V DIMMING (1%)	120/277	60	METALUX (24EN-LD2-45-UNV-L835-CD1-U) HE WILLIAMS (AP-22-L43/835-DIM1-UMV) LITHONIA (EVNX)
N: 2' LED UNDER(SURFACE A		LENGTH: 2' - 0" WIDTH: - DEPTH: -	600		3500K		ELV DIMMING	120/277	8	DAY-BRITE (LINCS100E-L28-935-UNV-WHG-DIM) KENALL (AUCLED-1-MW-11L35K-24-277) AIREY-THOMPSON (13HC-N-35K-24-2-3-D11) KELVIX (UC22 3040 010V 120/277 WH)
N: 2' LED PATIEN ' WIDE SURFACE, WALL A		LENGTH: 2' - 0" WIDTH: 0' - 2.25" DEPTH: -	2,000		3500K		LED (0-10V DIMMING) 1%	120/277	21	LUMINII (EXPV 24 HE48MO 40 F WN) BROWNLEE (1276 NT H16 40K AMF)



ARCHITECT HKS ARCHITECTS, INC. 222 SOUTH MAIN, SUITE 230 SALT LAKE CITY, UT 84101

STRUCTURAL ENGINEER REAVELEY ENGINEERS & ASSOCIATES 675 EAST 500 SOUTH, SUITE 400 SALT LAKE CITY, UTAH 84102

MECHANICAL ENGINEER VAN BOERUM & FRANK ASSOCIATES, INC 181 EAST 5600 SOUTH, SUITE 130 MURRAY, UTAH 84107

ELECTRICAL ENGINEER SPECTRUM ENGINEERS, INC 324 SOUTH STATE STREET, SUITE 400 SALT LAKE CITY, UTAH 84111









KEY PLAN

REVISION NO. DESCRIPTION DATE

HKS PROJECT NUMBER

26404.000 DATE 08/15/24 ISSUE CONSTRUCTION DRAWINGS SHEET TITLE INTERIOR LIGHTING FIXTURE SCHEDULE SHEET NO.

EL601

						LIGH	TING/S	SPACE		TRO
	WIRING LEGEND		LIGHTING CONTROL ID 1. # = NUMBER OF ZONES		AL NOTES DINATE INITIAL	PROGRAMMIN	IG WITH OWNE	R AND MODIFY	CONTROL TIM	ES AND O
			 D = DIMMING, S = SWITCHING P = DAYLIGHT PHOTOCELL 						N REQUEST BY S ON EACH SW	
		4. GREENGATE	4. L = PLUG LOAD CONTROLLER	4. PART I FUNCTIO	NUMBERS SHO NS AND CAPAB	WN ARE BASE ILITIES OF THI	D ON WATTST	OPPER AS THE SIGN SYSTEM A	BASIS OF DESI	
	NETWORK CABLING		5. # = INSTANCE	PROVIDE	A SYSTEM THA	I DOES AT NO	JT ADDITIONAL	LCOST.		
	ID			LIGHTS ON	LIGHTS OFF CONTROL	LIGHTING CONTROL	DAYLIGHT SENSOR	TIME DELAY TO OFF (MIN.)	BAS AUX RELAY	PLUG CONTF
	1D1	DETAIL		CONTROL MANUAL & OCCUPANCY			SETTING (FC)	15	RELAY	CONTF
				OCCUPANCY	OCCUPANCY	0-10V			CLOSED ON OCCUPANCY	
		UNSWITCH HOT DIMMING CONTROLL LMRC-21	LER							
			SWITCH LMDM-101							
	TO BUILDING AUTOMATION SYSTEM (BAS)									
	Ĺ	O (TYP) OCCUPANCY SENSOR LMDC-100								
		SENSOR LMDC-100								
	1S3			MANUAL & OCCUPANCY	MANUAL OR	ON/OFF	-	15	RELAY CLOSED ON OCCUPANCY	-
									OCCUPANCY	
		ROOL CONTRO LMRC-								
	TO BUILDING ISOLATED		-101 (TYP) 2-BUTTON WALL SWITCH LMSW-102							
	TO BUILDING AUTOMATION - ISOLATED AUX RELAY SYSTEM (BAS)									
		O O (TYP) OCCUPANCY SENSOR	ا دـــــــــــــــــــــــــــــــــــ							
		LMDC-100								
	2D1			MANUAL & OCCUPANCY	MANUAL OR OCCUPANCY	DIMMING 0-10V	-	15	RELAY CLOSED ON OCCUPANCY	-
			LIGHTING LOAD "a"						OCCOPANCI	
			LIGHTING LOAD "b"							
		DIMMING CONTROLLEI LMRC-212								
	TO BUILDING ISOLATED	~	(TYP) 5-BUTTON SCENE SWITCH LMSW-105							
	AUTOMATION - AUX RELA SYSTEM (BAS)									
	Ĺ									
		SENSOR LMDC-100								
ERSION:										
MPLATE VI										
₹ E										
14:58:11 PL										
8/15/2024										

WITHIN FIRST 6 MONTHS AFTER SUBSTANTIAL COMPLETION. BEL TO MATCH BUTTON LABEL ID OR AS DIRECTED BY OWNER. APPROVED MANUFACTURERS ARE SUBJECT TO MEETING ALL RE TO MEET THESE SHALL REQUIRE THE CONTRACTOR TO

OL TYPE SCHEDULE

OPERATION AS REQUESTED BY OWNER.

GENERAL NOTES 5. REFER TO PLANS FOR LOCATIONS AND QUANTITIES OF DEVICES.

6. INSTALL ONE OF EACH CONTROL TYPE WITH PROGRAMMING, ADJUST, AND OBTAIN OWNERS APPROVAL PRIOR TO

PROGRAMMING THE REMAINING CONTROLS. 7. WIRING MAY VARY BETWEEN MANUFACTURERS. CONTRACTOR IS RESPONSIBLE FOR PROVIDING THE REQUIRED WIRING THAT WILL BOTH MEET THE MANUFACTURERS REQUIREMENTS AND MATCH WITH THE SHOWN SYSTEM.

8. PROVIDE COMPLETE SHOP DRAWING SUBMITTALS INCLUDING OCCUPANCY SENSOR LAYOUT AND COVERAGE PATTERNS. PROVIDE ADDITIONAL SENSORS AS REQUIRED FOR 100% COVERAGE OF SPACES WITH OCCUPANCY SENSOR CONTROL.

IG LOAD TROLLER	NETWORKED CONTROLS	BUTTON_1	BUTTON_2	BUTTON_3	BUTTON_4	BUTTON_5	BUTTON_6	BUTTON_7	BUTTON_8	BUTTON_9	NOTES
	-	FUNCTION: PRESS TOP-ON, HOLD TOP-RAISE LABEL ID: TOP- "ON/RAISE" BOTTOM-"OFF/ LOWER"	-	-	-	-	-	-	-	-	
	-	FUNCTION: PRESS-ON LABEL ID: "ON"	FUNCTION: PRESS-OFF LABEL ID: "OFF"	-	-	-	-	-	-	-	
	-	PRESS TOP-ON, PRESS BOTTOM-OFF, HOLD	PRESS- PRESET SCENE #01 ZONE "a" 75% ZONE "b" 75% LABEL ID:	PRESS- PRESET SCENE #02 ZONE "a" 0%	PRESS- SELECT ZONE "a" FOR DIMMING	FUNCTION: PRESS- SELECT ZONE "b" FOR DIMMING LABEL ID: "ZONE b"	-	-	-	-	



ARCHITECT HKS ARCHITECTS, INC. 222 SOUTH MAIN, SUITE 230 SALT LAKE CITY, UT 84101

STRUCTURAL ENGINEER **REAVELEY ENGINEERS & ASSOCIATES** 675 EAST 500 SOUTH, SUITE 400 SALT LAKE CITY, UTAH 84102

MECHANICAL ENGINEER VAN BOERUM & FRANK ASSOCIATES, INC 181 EAST 5600 SOUTH, SUITE 130 MURRAY, UTAH 84107

ELECTRICAL ENGINEER SPECTRUM ENGINEERS, INC 324 SOUTH STATE STREET, SUITE 400 SALT LAKE CITY, UTAH 84111










KEY PLAN


REVISION NO. DESCRIPTION DATE


HKS PROJECT NUMBER 26404.000

DATE 08/15/24 ISSUE CONSTRUCTION DRAWINGS SHEET TITLE LIGHTING CONTROL SCHEDULES SHEET NO.

EL602

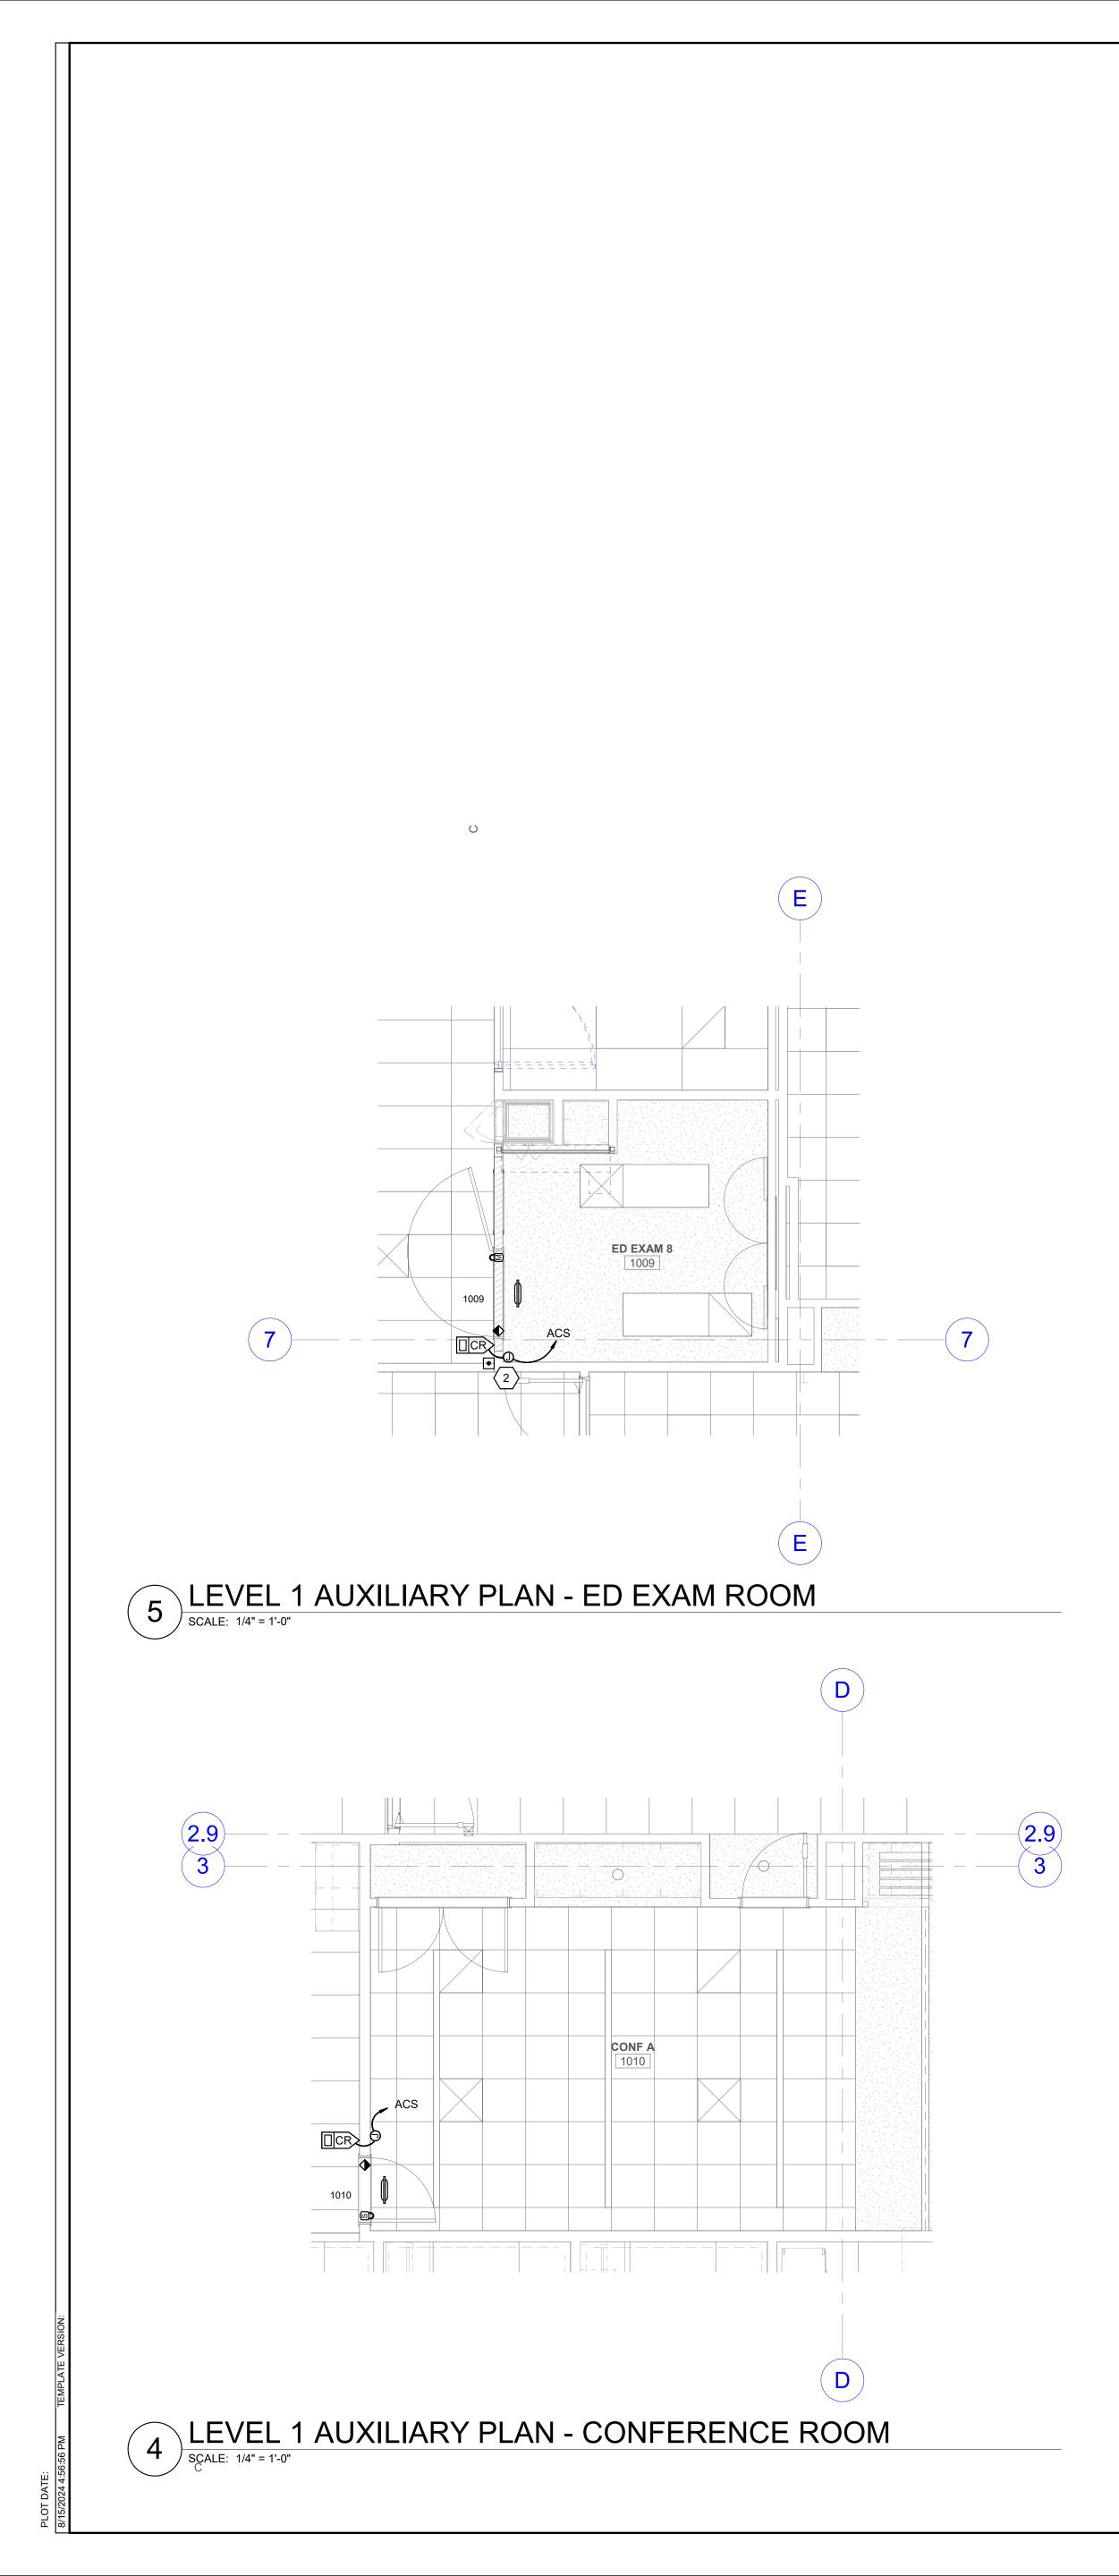

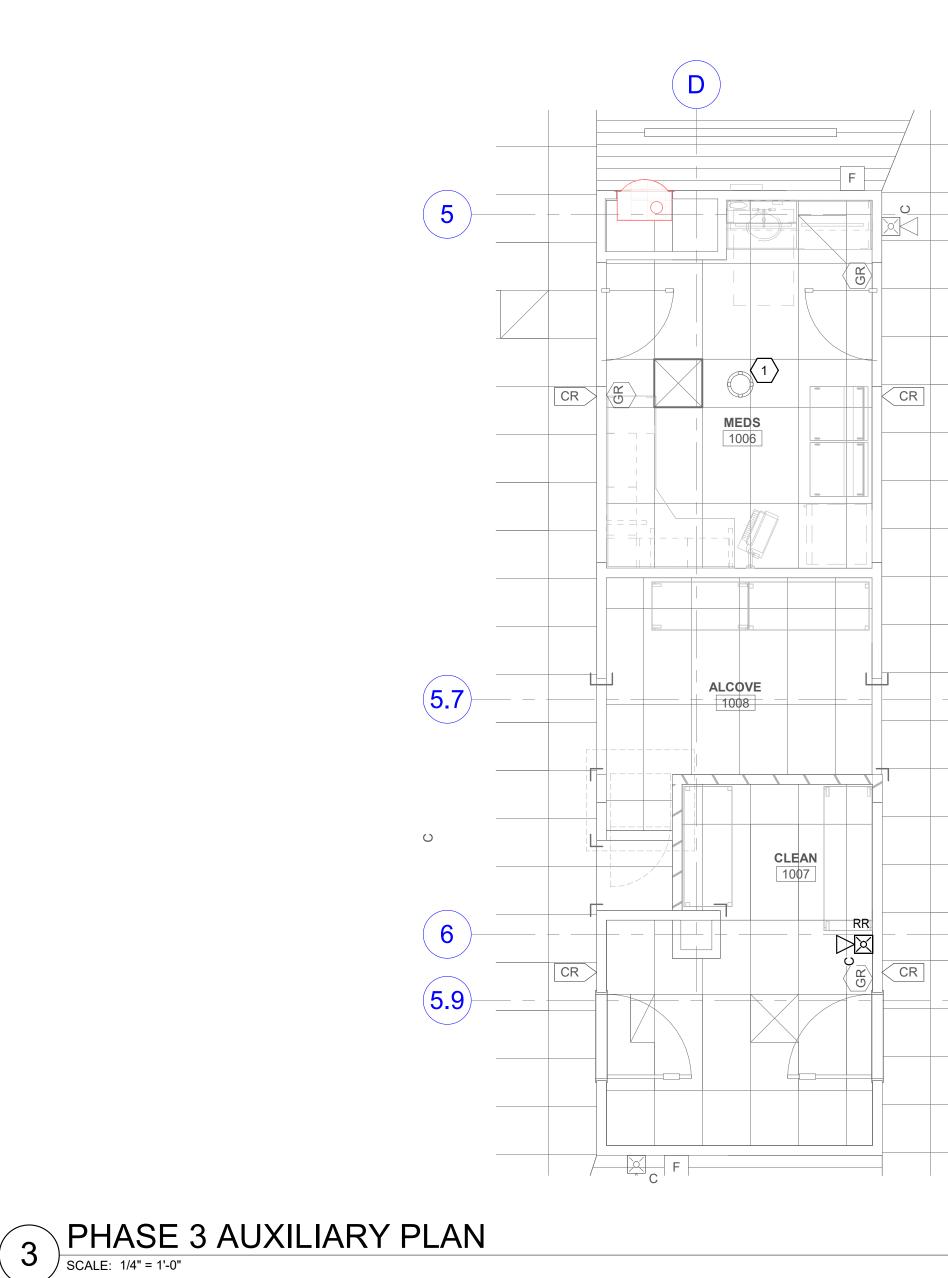

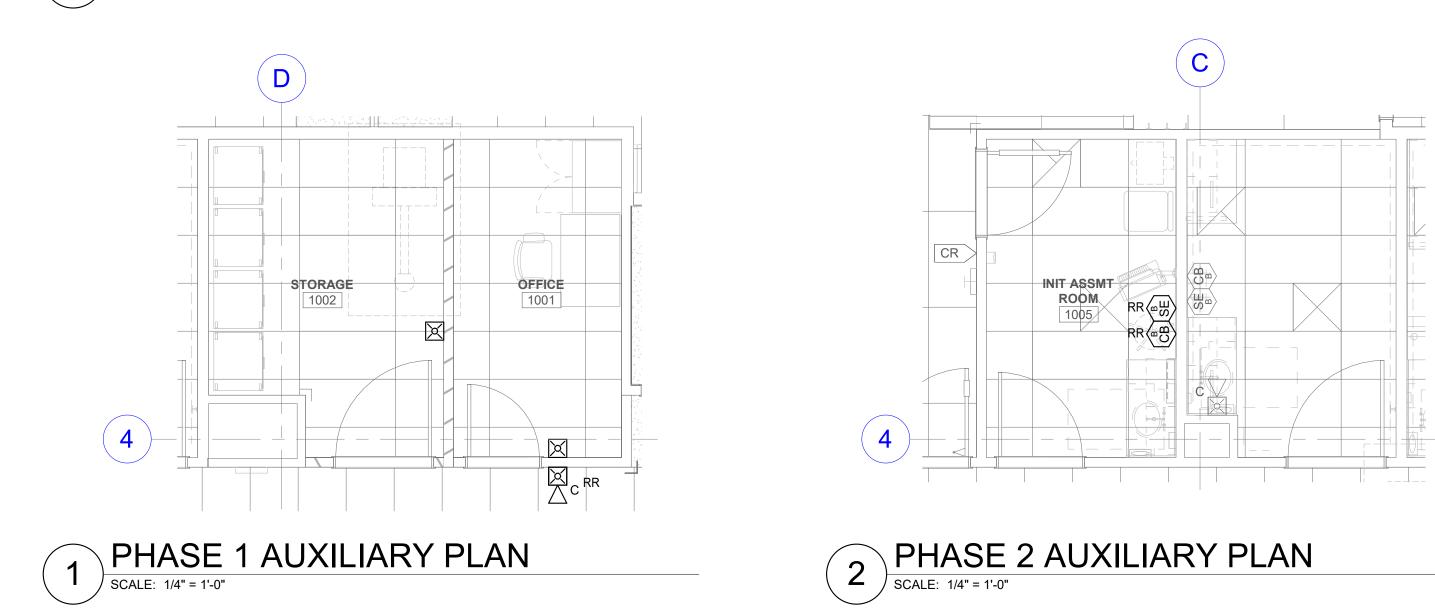

GENERAL SHEET NOTES

- ALL PATHWAYS FOR LOW VOLTAGE CABLING NOT REQUIRED TO BE IN CONDUITS SHALL BE ROUTED IN J-HOOK PATHWAYS. CONCEAL ALL PATHWAYS ABOVE ACCESSIBLE CEILING SPACES. DO NOT RUN CABLES IN EXPOSED AREAS. WHERE CONCEALMENT IS NOT POSSIBLE IN EXPOSED AREAS, CONTRACTOR SHALL PROVIDE CONDUIT TO ROUTE CABLING WHERE VISIBLE. ALL CONDUIT SHALL BE PAINTED TO MATCH CEILING AND PROVIDED WITH PROTECTIVE BUSHINGS.
- SECURITY JUNCTION BOXES LOCATION ARE FOR REFERENCE PURPOSES ONLY. LOCATION OF JUNCTION BOX TO BE INSTALLED IN AN ACCESSIBLE CEILING SPACE ALLOWING FOR SERVICABILITY.
- ACCESS CONTROL CABLING TO BE PLENUM RATED.
- SECURITY CONTRACTOR TO COORDINATE WITH DOOR HARDWARE CONTRACTOR FOR ELECTRIC LOCK TYPE, INTERFACE, AND VOLTAGE REQUIREMENTS.
- SECURITY CABLING SHALL BE RATED FOR THE AREA AND ENVIRONMENT IT IS INSTALLED. REFER TO SPECIFICATONS FOR CABLING REQUIREMENTS.
- PATHWAYS FOR ACCESS CONTROL MAY SHARE JUNCTION BOXES AND CONDUIT. CONDUIT MUST BE SIZED APPROPRIATELY BASED ON CABLE FILL.

- 1 RE-USE SECURITY CAMERA.
- 2 BUTTON TO TURN ON/OFF MAGNETIC LOCK.



SALT LAKE CITY, UT 84101 STRUCTURAL ENGINEER **REAVELEY ENGINEERS & ASSOCIATES**

675 EAST 500 SOUTH, SUITE 400 SALT LAKE CITY, UTAH 84102

MECHANICAL ENGINEER VAN BOERUM & FRANK ASSOCIATES, INC 181 EAST 5600 SOUTH, SUITE 130 MURRAY, UTAH 84107

ELECTRICAL ENGINEER SPECTRUM ENGINEERS, INC 324 SOUTH STATE STREET, SUITE 400 SALT LAKE CITY, UTAH 84111









KEY PLAN

REVISION NO. DESCRIPTION

DAT


26404.000 DATE 08/15/24 ISSUE CONSTRUCTION DRAWINGS SHEET TITLE LEVEL 1 ED **AUXILIARY PLANS**

EY101

HKS PROJECT NUMBER


SHEET NO.



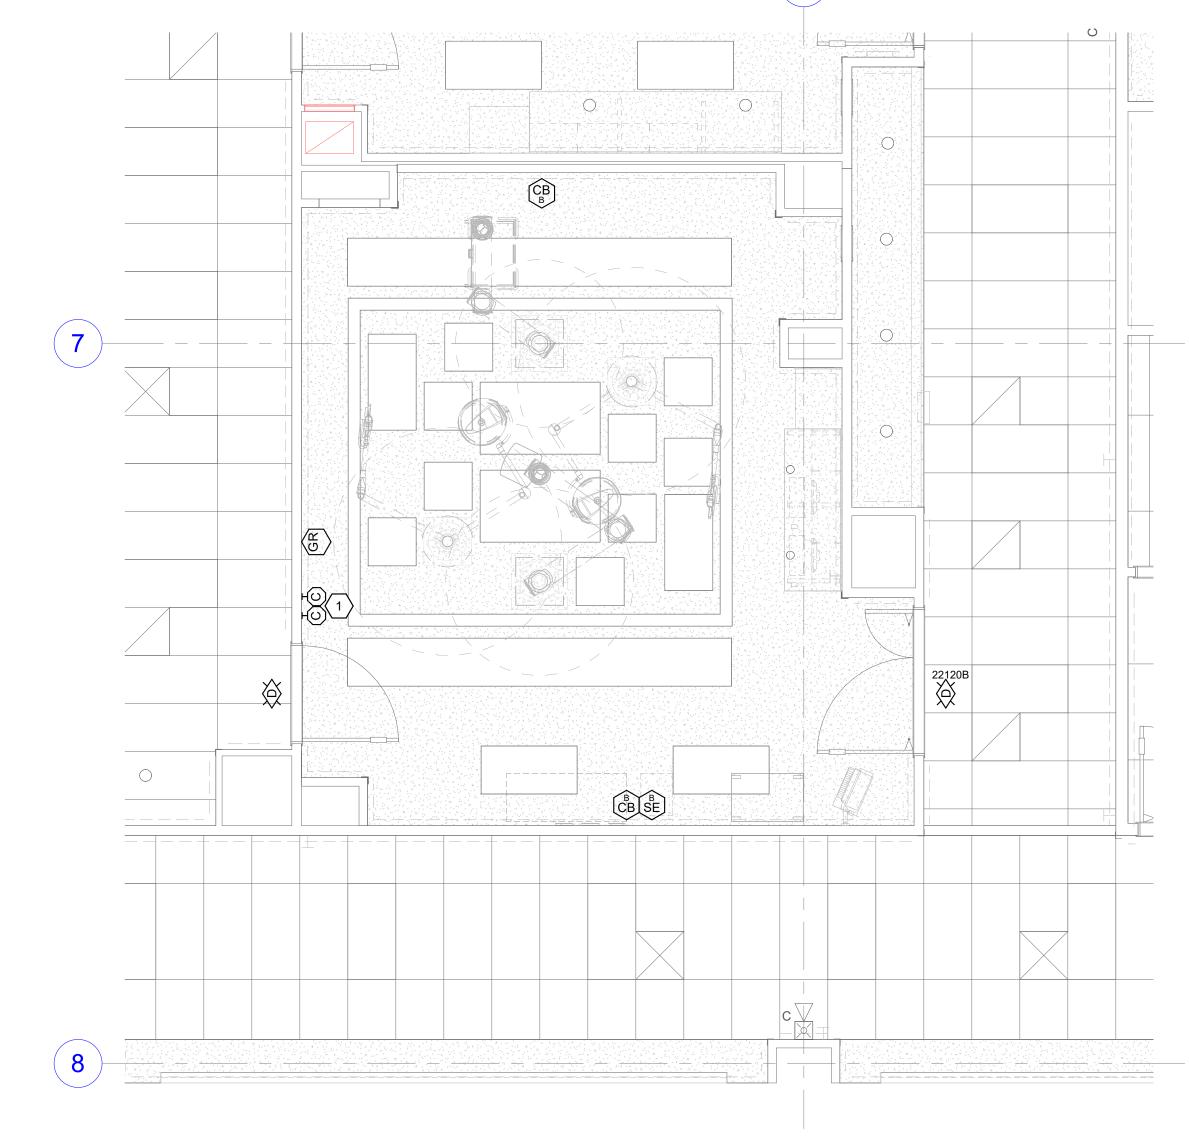





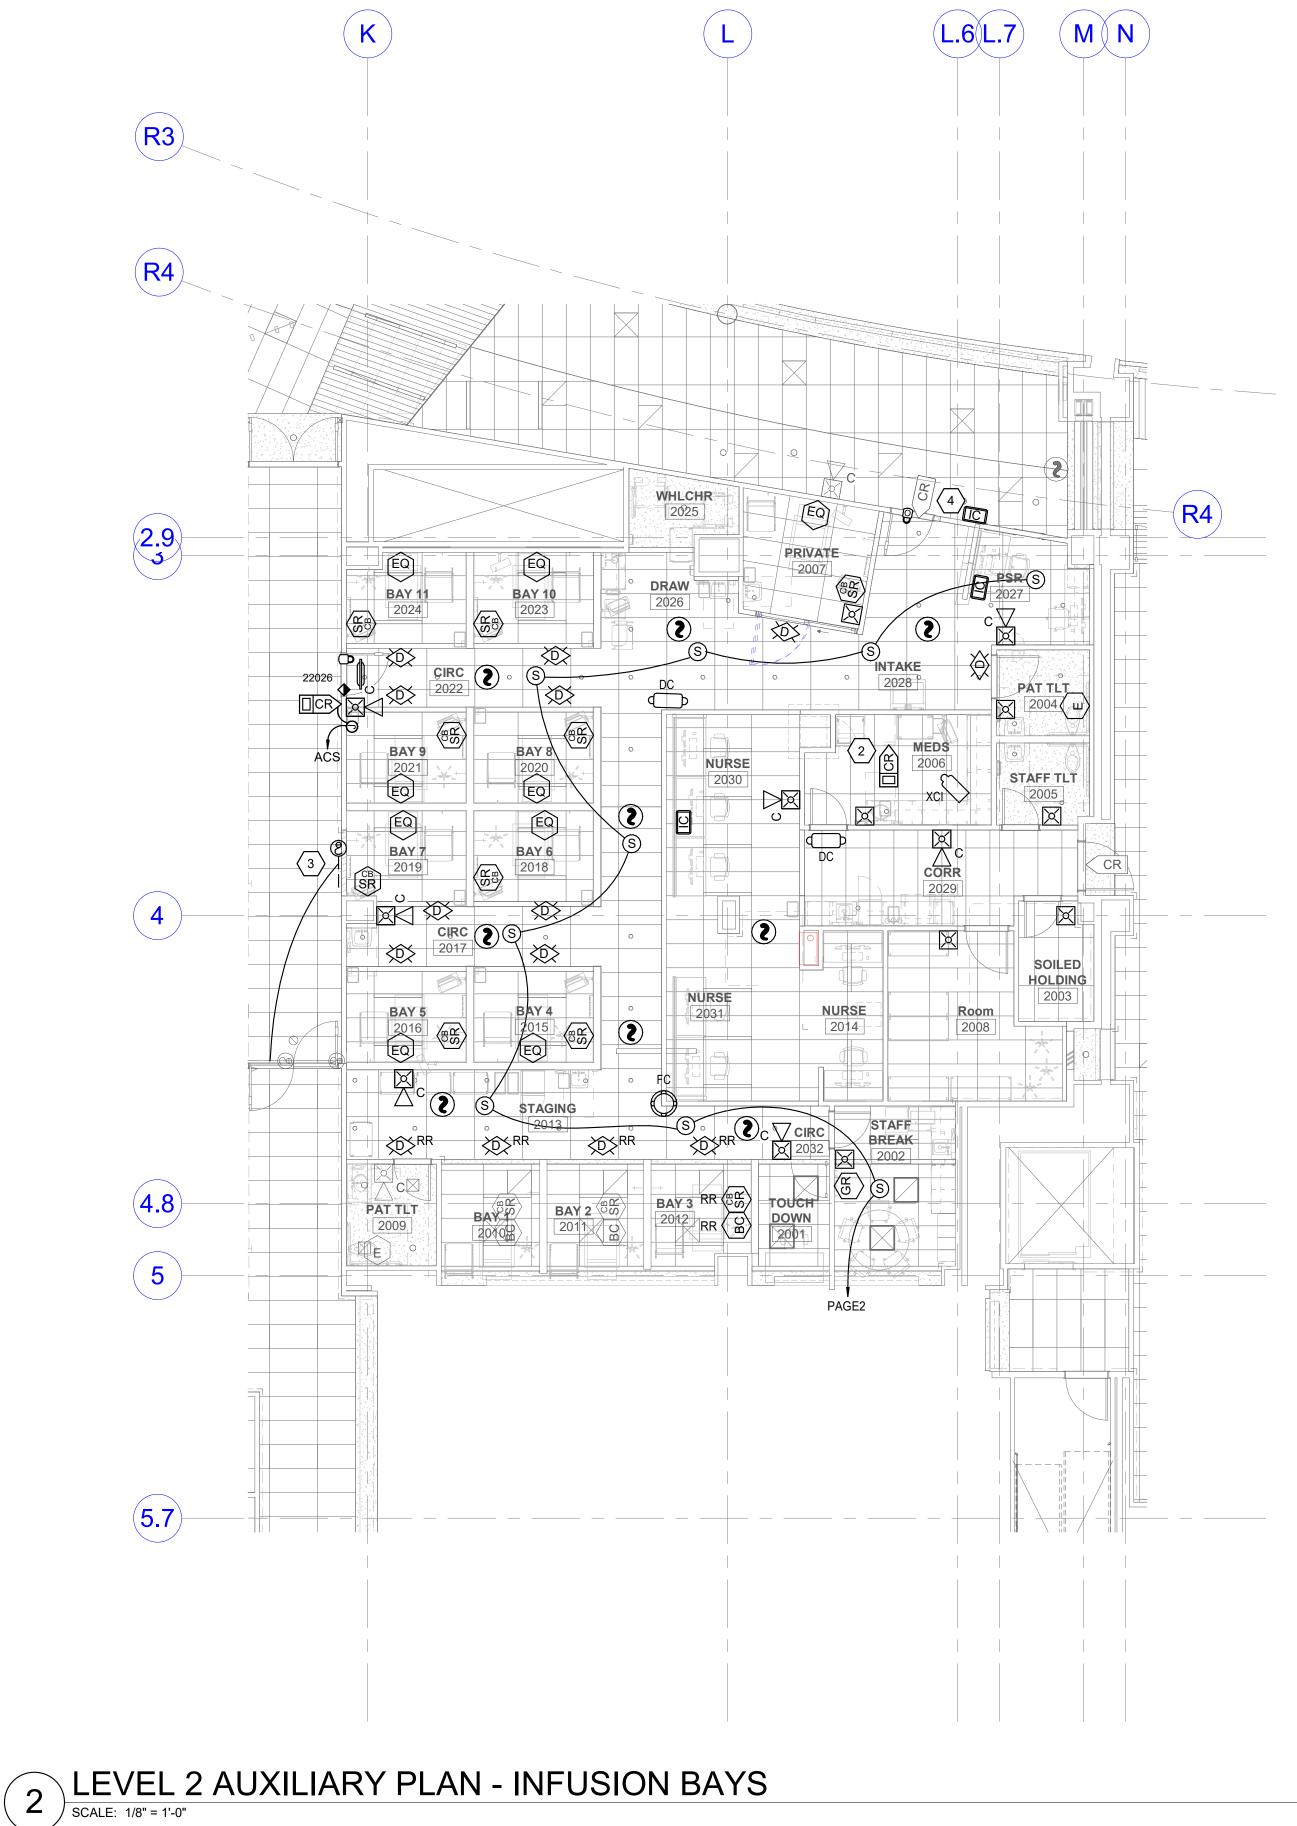

GENERAL SHEET NOTES

- ALL PATHWAYS FOR LOW VOLTAGE CABLING NOT REQUIRED TO BE IN CONDUITS SHALL BE ROUTED IN J-HOOK PATHWAYS. CONCEAL ALL PATHWAYS ABOVE ACCESSIBLE CEILING SPACES. DO NOT RUN CABLES IN EXPOSED AREAS. WHERE CONCEALMENT IS NOT POSSIBLE IN EXPOSED AREAS, CONTRACTOR SHALL PROVIDE CONDUIT TO ROUTE CABLING WHERE VISIBLE. ALL CONDUIT SHALL BE PAINTED TO MATCH CEILING AND PROVIDED WITH PROTECTIVE BUSHINGS.
- SECURITY JUNCTION BOXES LOCATION ARE FOR REFERENCE PURPOSES ONLY. LOCATION OF JUNCTION BOX TO BE INSTALLED IN AN ACCESSIBLE CEILING SPACE ALLOWING FOR SERVICABILITY.
- 3 ACCESS CONTROL CABLING TO BE PLENUM RATED.
- SECURITY CONTRACTOR TO COORDINATE WITH DOOR HARDWARE CONTRACTOR FOR ELECTRIC LOCK TYPE, INTERFACE, AND VOLTAGE REQUIREMENTS.
- SECURITY CABLING SHALL BE RATED FOR THE AREA AND ENVIRONMENT IT IS INSTALLED. REFER TO SPECIFICATONS FOR CABLING REQUIREMENTS.
- PATHWAYS FOR ACCESS CONTROL MAY SHARE JUNCTION BOXES AND CONDUIT. CONDUIT MUST BE SIZED APPROPRIATELY BASED ON CABLE FILL.

- 1 CLOCKS TO BE OFCI.
- 2 CARD READER TO PROVIDE ACCESS TO UNDER COUNTER CABINET.
- 3 CIRCUIT THE NEW SMOKE DAMPER WITH THE EXISTING FIRE/SMOKE DAMPERS.
- NEW WIDER DOOR IN EXISTING LOCATION, RE-USE EXISTING HARDWARE, INTERFACE EXISTING CARD READER WITH NEW AUTO OPERATOR FOR ACTIVATION.



SPECTRUM ENGINEERS, INC 324 SOUTH STATE STREET, SUITE 400 SALT LAKE CITY, UTAH 84111









KEY PLAN

REVISION NO. DESCRIPTION

26404.000 DATE 08/15/24 ISSUE CONSTRUCTION DRAWINGS SHEET TITLE

HKS PROJECT NUMBER


LEVEL 2 INFUSION **AUXILIARY PLANS**


EY102

SHEET NO.



1 LEVEL 3 AUXILIARY PLAN - LDR SCALE: 1/4" = 1'-0"

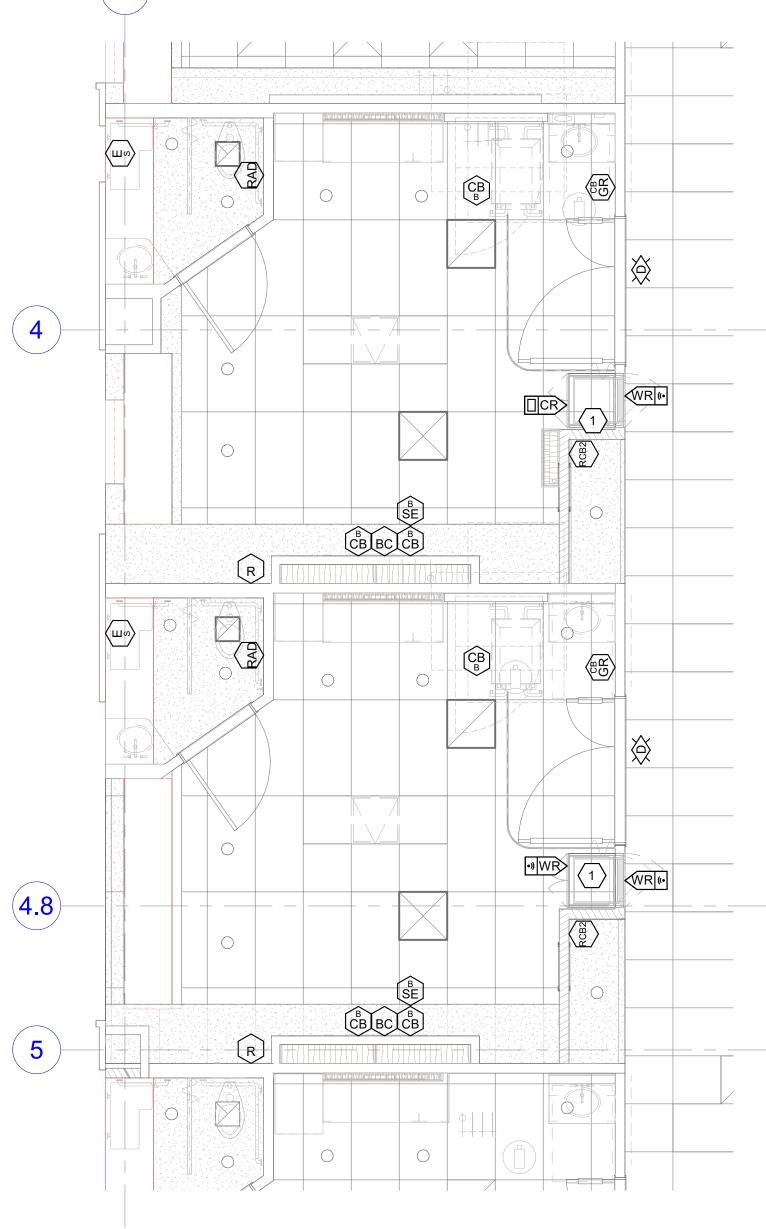

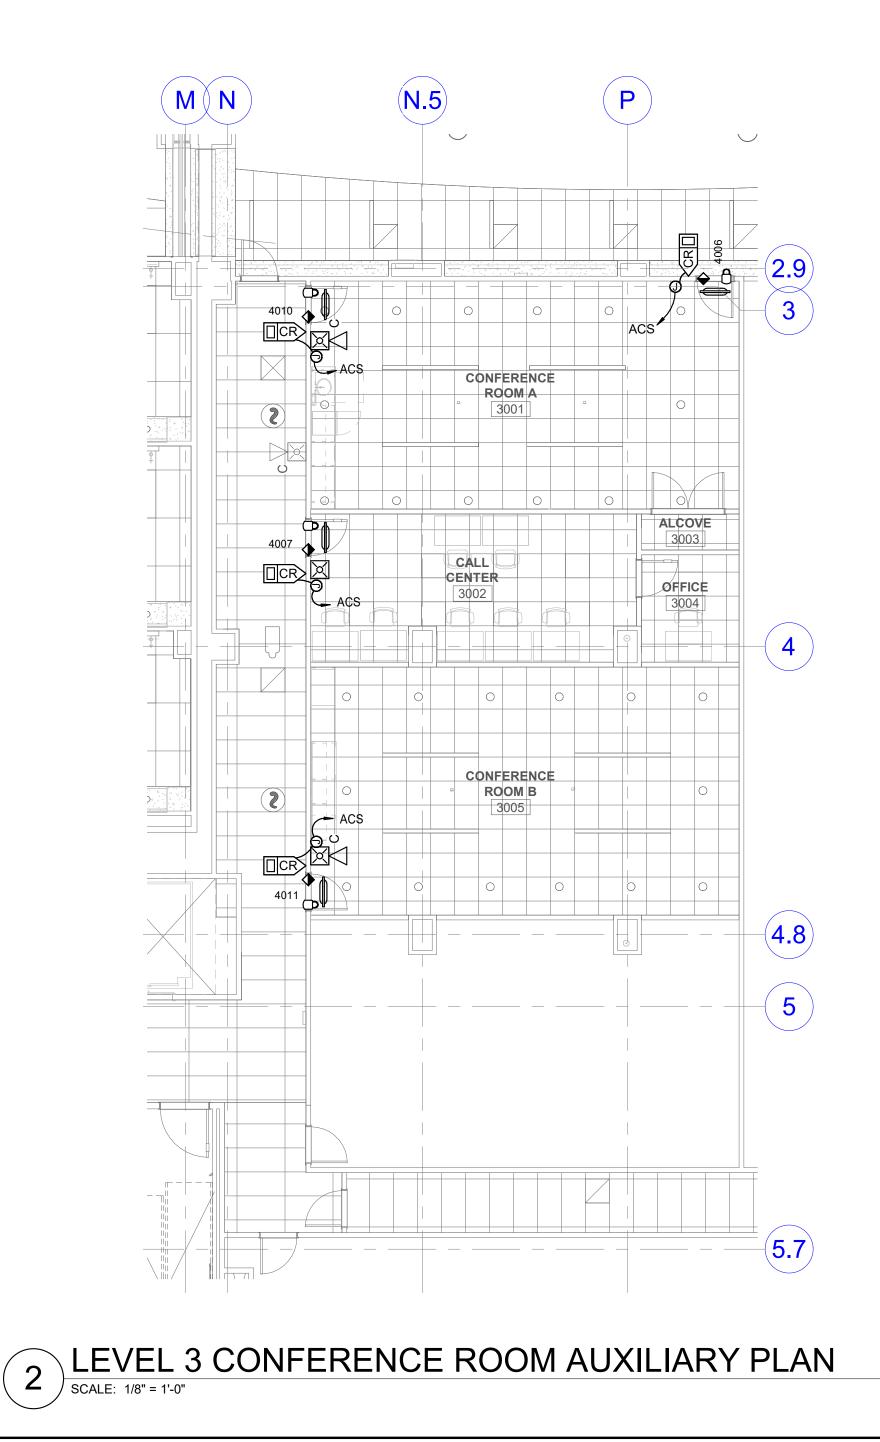

GENERAL SHEET NOTES

- 1 ALL PATHWAYS FOR LOW VOLTAGE CABLING NOT REQUIRED TO BE IN CONDUITS SHALL BE ROUTED IN J-HOOK PATHWAYS. CONCEAL ALL PATHWAYS ABOVE ACCESSIBLE CEILING SPACES. DO NOT RUN CABLES IN EXPOSED AREAS. WHERE CONCEALMENT IS NOT POSSIBLE IN EXPOSED AREAS, CONTRACTOR SHALL PROVIDE CONDUIT TO ROUTE CABLING WHERE VISIBLE. ALL CONDUIT SHALL BE PAINTED TO MATCH CEILING AND PROVIDED WITH PROTECTIVE BUSHINGS.
- SECURITY JUNCTION BOXES LOCATION ARE FOR REFERENCE PURPOSES ONLY. LOCATION OF JUNCTION BOX TO BE INSTALLED IN AN ACCESSIBLE CEILING SPACE ALLOWING FOR SERVICABILITY.
- 3 ACCESS CONTROL CABLING TO BE PLENUM RATED.
- 4 SECURITY CONTRACTOR TO COORDINATE WITH DOOR HARDWARE CONTRACTOR FOR ELECTRIC LOCK TYPE, INTERFACE, AND VOLTAGE REQUIREMENTS.
- 5 SECURITY CABLING SHALL BE RATED FOR THE AREA AND ENVIRONMENT IT IS INSTALLED. REFER TO SPECIFICATONS FOR CABLING REQUIREMENTS.
- 6 PATHWAYS FOR ACCESS CONTROL MAY SHARE JUNCTION BOXES AND CONDUIT. CONDUIT MUST BE SIZED APPROPRIATELY BASED ON CABLE FILL.

1 WIRELESS CARD READERS FOR CABINETRY.



HKS ARCHITECTS, INC. 222 SOUTH MAIN, SUITE 230 SALT LAKE CITY, UT 84101

STRUCTURAL ENGINEER REAVELEY ENGINEERS & ASSOCIATES 675 EAST 500 SOUTH, SUITE 400 SALT LAKE CITY, UTAH 84102

MECHANICAL ENGINEER VAN BOERUM & FRANK ASSOCIATES, INC 181 EAST 5600 SOUTH, SUITE 130 MURRAY, UTAH 84107

ELECTRICAL ENGINEER SPECTRUM ENGINEERS, INC 324 SOUTH STATE STREET, SUITE 400 SALT LAKE CITY, UTAH 84111







 \mathbf{C} 5 Σ

KEY PLAN

REVISION NO. DESCRIPTION

HKS PROJECT NUMBER

26404.000


DATE

DATE


08/15/24 ISSUE CONSTRUCTION DRAWINGS SHEET TITLE LEVEL 3 **AUXILIARY PLANS**

EY103


SHEET NO.

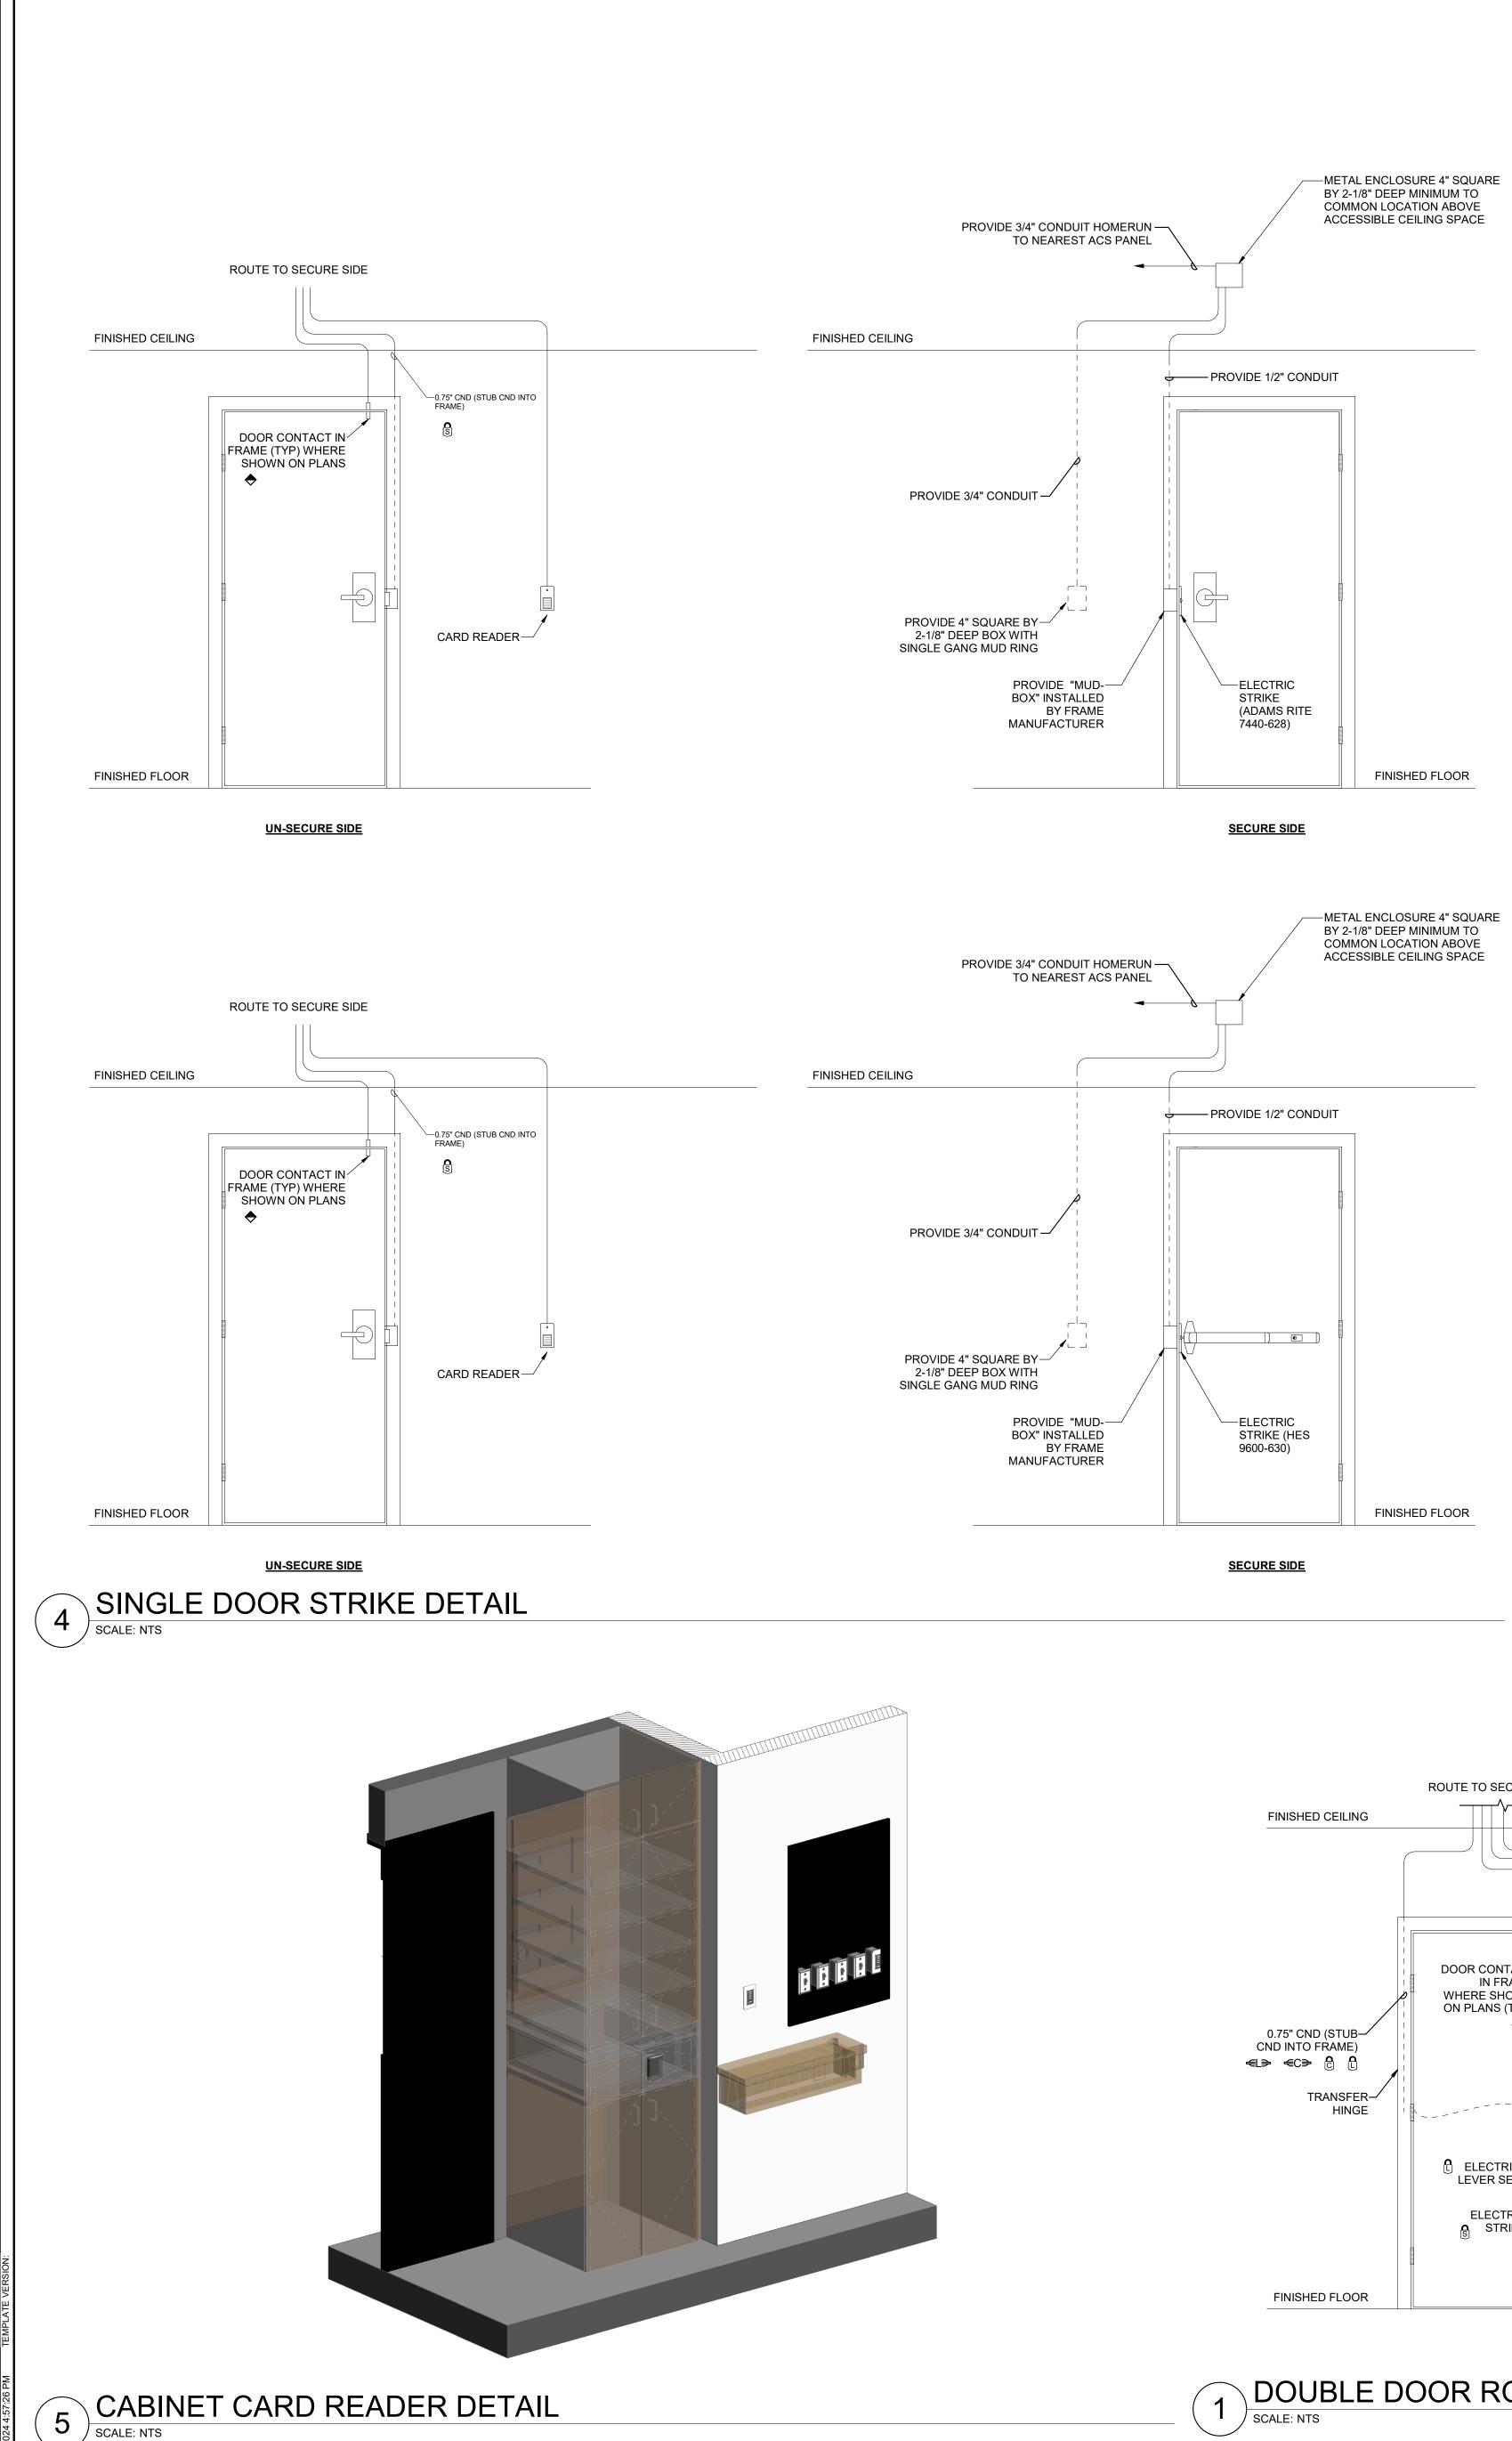




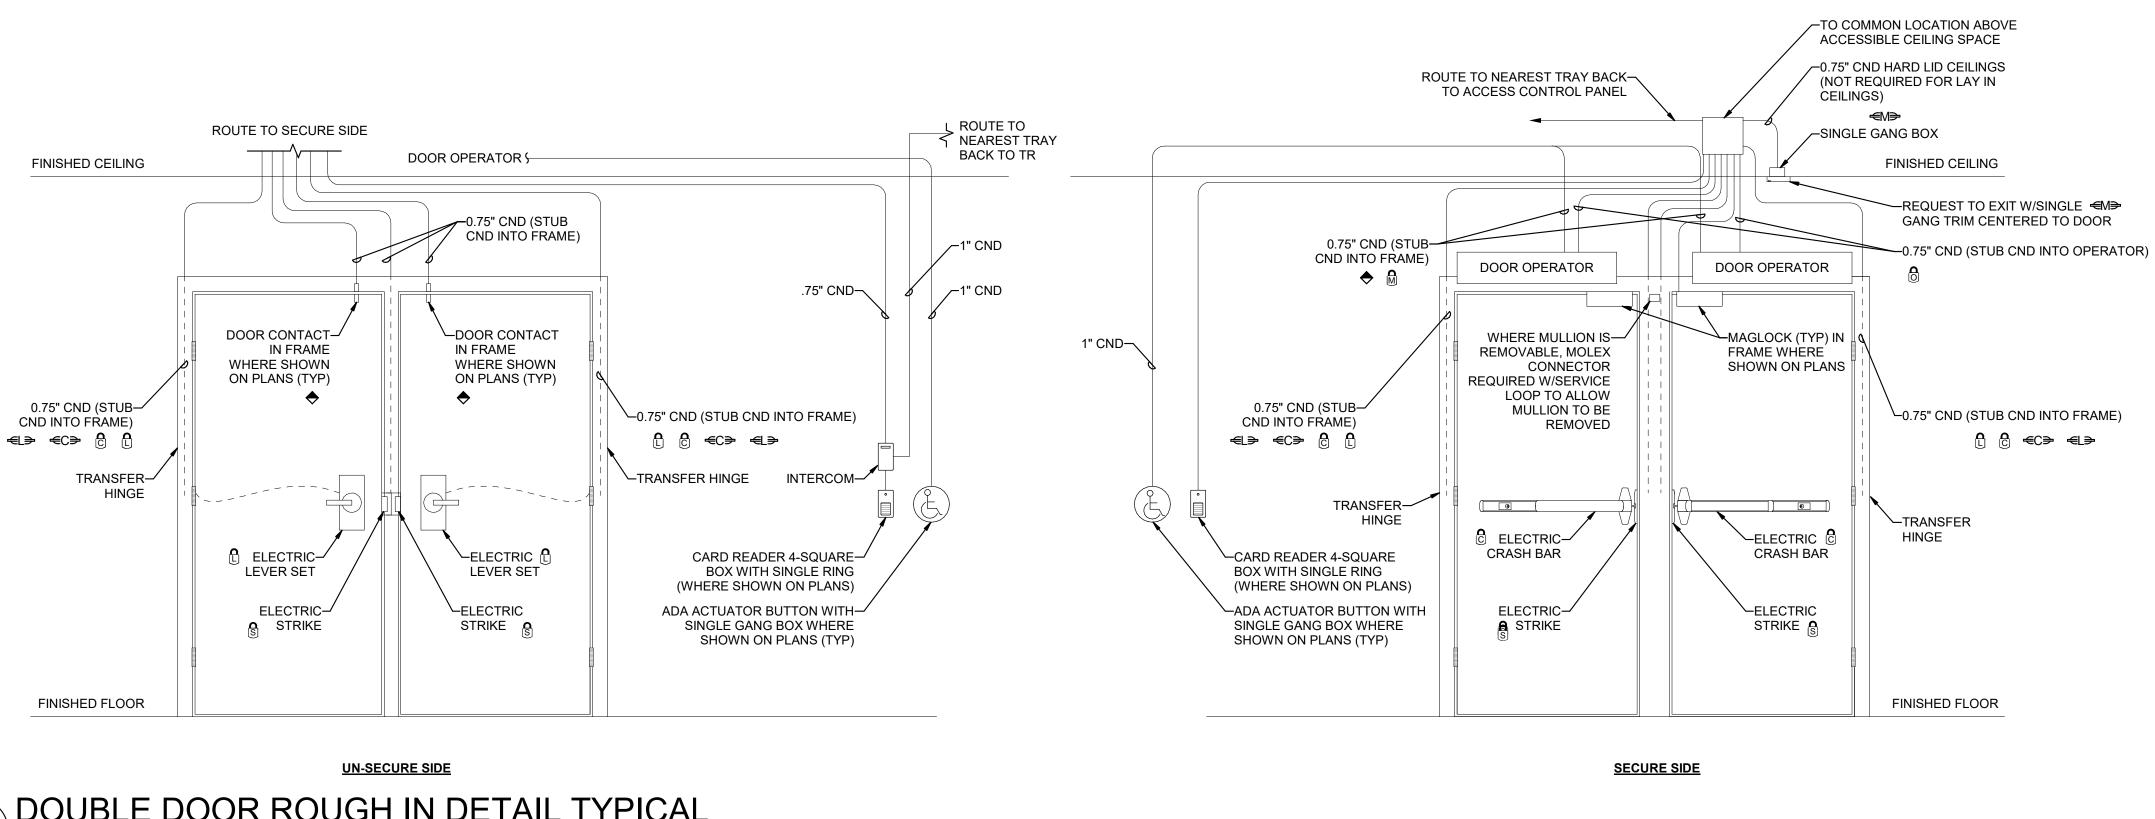



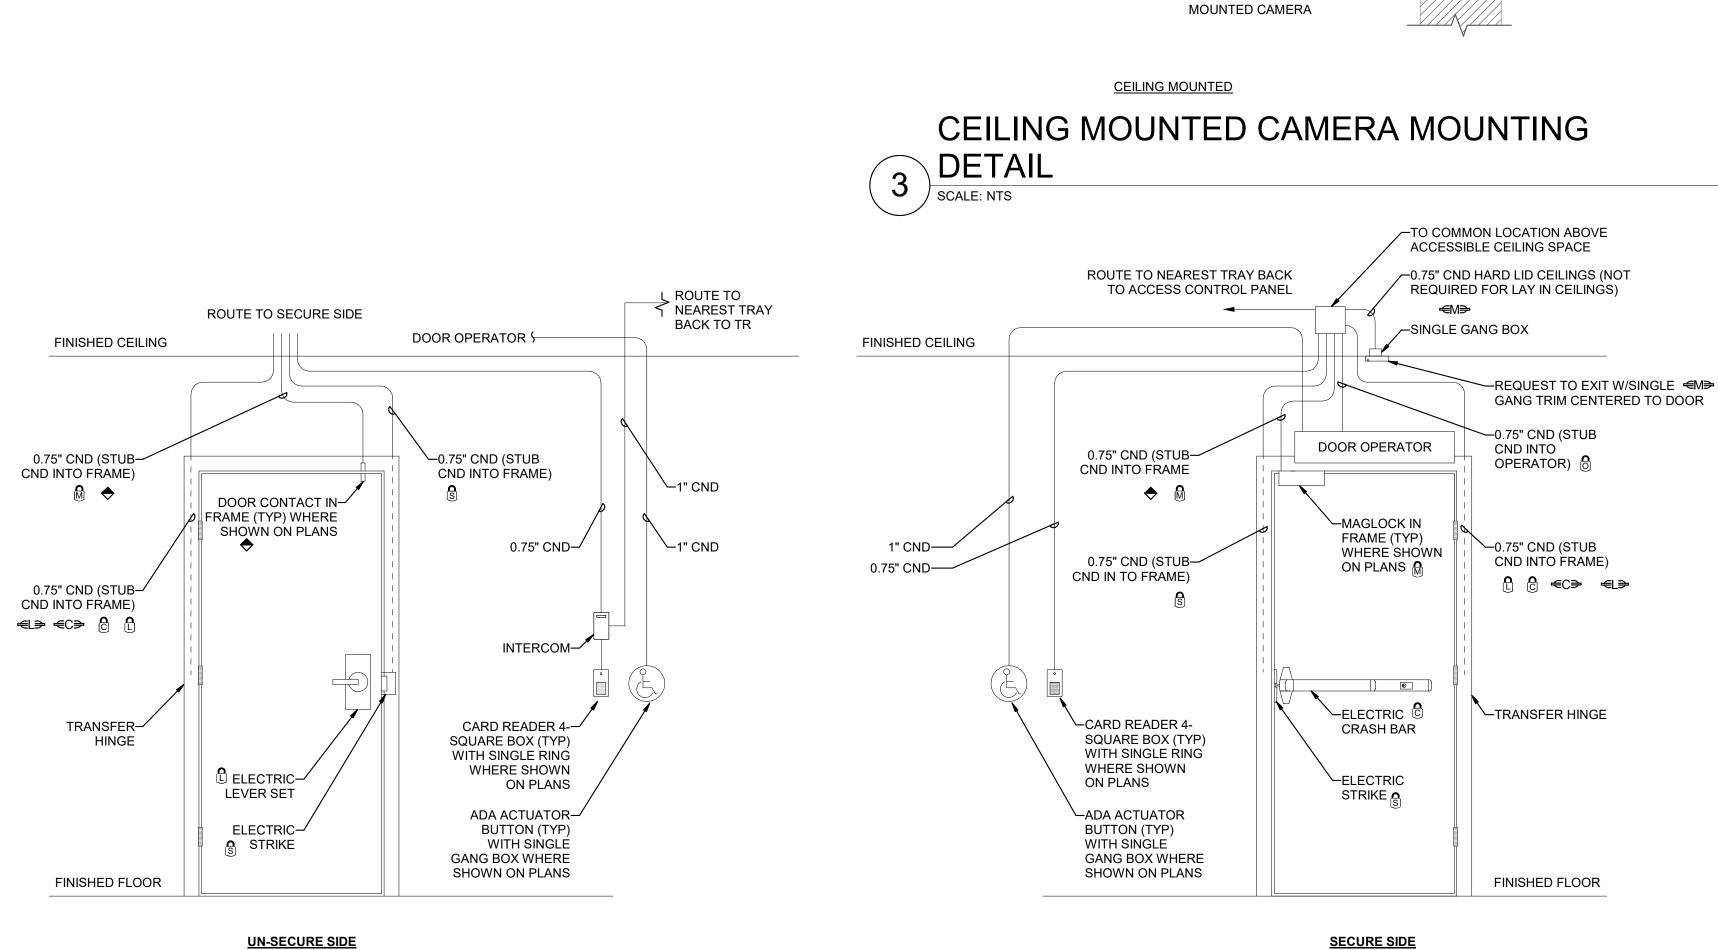

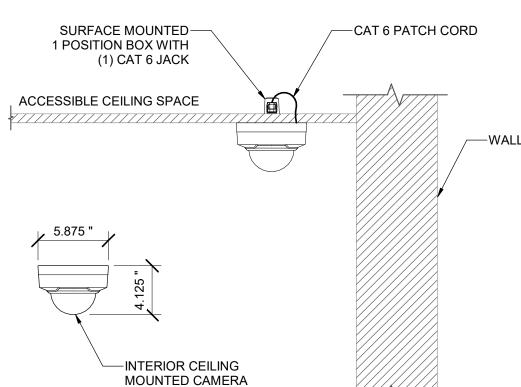



STRUCTURAL ENGINEER **REAVELEY ENGINEERS & ASSOCIATES** 675 EAST 500 SOUTH, SUITE 400 SALT LAKE CITY, UTAH 84102

MECHANICAL ENGINEER VAN BOERUM & FRANK ASSOCIATES, INC 181 EAST 5600 SOUTH, SUITE 130 MURRAY, UTAH 84107

ELECTRICAL ENGINEER SPECTRUM ENGINEERS, INC 324 SOUTH STATE STREET, SUITE 400 SALT LAKE CITY, UTAH 84111









NO. DESCRIPTION

DATE

KEY PLAN

REVISION


HKS PROJECT NUMBER 26404.000 DATE 08/15/24 ISSUE CONSTRUCTION DRAWINGS SHEET TITLE AUXILIARY DETAILS

SHEET NO.

© 2008 HKS, INC

EY551

SYMBOL	MANUF.	PART #	DESCRIPTION	ВАСКВОХ	BOX MOUNTING HEIGHT
NCM	HILL-ROM	P2500NNC1B00	STAFF CONSOLE, DESK MOUNT	STEEL CITY 58371 3/4R, RACO 561, OR ANY OTHER SINGLE GANG BACK BOX.	REFER TO ELEVATION DRAWINGS
NCM	HILL-ROM	P2594NNC3A00	STAFF CONSOLE, WALL MOUNT	STEEL CITY 58371 3/4R, RACO 561, OR ANY OTHER SINGLE GANG BACK BOX.	REFER TO ELEVATION DRAWINGS
GA	HILL-ROM	P2594NNC3B00	GRAPHICAL ANNUNCIATOR	STEEL CITY 58371 3/4R, RACO 561, OR ANY OTHER SINGLE GANG BACK BOX.	REFER TO ELEVATION DRAWINGS
BC	HILL-ROM	P2505NNC1B00	AUDIO STATION BED CONNECTOR (ASBC)	GARVIN 52181-3/4, WITH GARVIN 52C13 RING, OR ANY OTHER 4" SQUARE 3.5" DEEP BACK BOX WITH SINGLE GANG MUD RING.	REFER TO ELEVATION DRAWINGS
EQ	HILL-ROM	P2516A01	EQUIPMENT RECEPTACLE, WITH CALL CORD	STEEL CITY 58371 3/4R, RACO 561, OR ANY OTHER SINGLE GANG BACK BOX.	REFER TO ELEVATION DRAWINGS
D _s	HILL-ROM	P2506NNC1B00	DOME LIGHT, SINGLE LED	RACO 231, WITH RACO 778 RING, OR ANY OTHER 4" SQUARE 2 1/8" DEEP BACK BOX.	REFER TO ELEVATION DRAWINGS
	HILL-ROM	P2506NNC8A00-D	ICON BASED-LIGHT LED DOME LIGHT	STEEL CITY CYLE-3/4, RACO 591, OR ANY OTHER 3.5" DEEP SINGLE GANG BACK BOX.	REFER TO ELEVATION DRAWINGS
Z>	HILL-ROM	P2506NNC8A00-7	ICON BASED-LIGHT LED ZONE LIGHT	STEEL CITY CYLE-3/4, RACO 591, OR ANY OTHER 3.5" DEEP SINGLE GANG BACK BOX.	REFER TO ELEVATION DRAWINGS
POE-24	HILL-ROM	P2519NNC1A24	POE SWITCH		REFER TO ELEVATION DRAWINGS
CB B	HILL-ROM	P2520A07	CODE BLUE PUSH BUTTON SWITCH	RACO 561 BACK BOX,	REFER TO ELEVATION
CP B	HILL-ROM	P2520A07	CODE PINK PUSH BUTTON SWITCH	RACO 561 BACK BOX,	REFER TO ELEVATION
PC B	HILL-ROM	P2520A07	PUSH FOR ASSISTANCE PUSH BUTTON SWITCH	RACO 561 BACK BOX, OR ANY OTHER 2.5" DEEP SINGLE GANG BACK BOX.	REFER TO ELEVATION DRAWINGS
SE B	HILL-ROM	P2520A08	STAFF EMERGENCY PUSH BUTTON SWITCH	RACO 561 BACK BOX, OR ANY OTHER 2.5" DEEP SINGLE GANG BACK BOX.	REFER TO ELEVATION DRAWINGS
E	HILL-ROM	P2520B01	BATH SWITCH, W/CANCEL, SUPERVISED	RACO 561 BACK BOX, OR ANY OTHER 2.5" DEEP SINGLE GANG BACK BOX.	REFER TO ELEVATION DRAWINGS
Es	HILL-ROM	P2520B02	BATH SWITCH, W/O CANCEL, SUPERVISED	RACO 561 BACK BOX, OR ANY OTHER 2.5" DEEP SINGLE GANG BACK BOX.	REFER TO ELEVATION DRAWINGS
UPS, APC ackmount Non-Seisr	HILL-ROM	P2521B02	UPS, RACK MOUNTABLE, 2U - NON-SEISMIC		REFER TO ELEVATION DRAWINGS
CB	HILL-ROM	P2594NNC1B01	STAFF STATION - STANDARD ROOM STATION W/ CODE	STEEL CITY GW-225G, RACO 691 OR ANY OTHER 2.5" DEEP, TWO OR THREE GANG BACK BOX.	REFER TO ELEVATION DRAWINGS
SR	HILL-ROM	P2594NNC1B01	STAFF STATION - STANDARD ROOM STATION W/O CODE	STEEL CITY GW-225G, RACO 691 OR ANY OTHER 2.5" DEEP, TWO OR THREE GANG BACK BOX.	REFER TO ELEVATION DRAWINGS
GR	HILL-ROM	P2594NNC2C00	GRAPHICAL ROOM STATION (GRS) - STAFF	STEEL CITY GW-225G, RACO 691 OR ANY OTHER 2.5" DEEP, TWO OR THREE GANG BACK BOX.	REFER TO ELEVATION DRAWINGS
GR	HILL-ROM	P2594NNC2C11	GRAPHICAL ROOM STATION (GRS) - PATIENT	STEEL CITY GW-225G, RACO 691 OR ANY OTHER 2.5" DEEP, TWO OR THREE GANG BACK BOX.	REFER TO ELEVATION DRAWINGS
RAD	HILL-ROM	P2594NNC4A10	REMOTE AUDIO DEVICE	STEEL CITY GW-225G, RACO 691 OR ANY OTHER 2.5" DEEP, TWO OR THREE GANG BACK BOX.	REFER TO ELEVATION DRAWINGS
RCB2	HILL-ROM	P2599NNC2A00	RCB2 ROOM CONTROL BOARD	STEEL CITY GW-235G, RACO 696 OR ANY OTHER 3.5" DEEP, TWO OR THREE GANG BACK BOX.	REFER TO ELEVATION DRAWINGS
Staff	HILL-ROM	RTLS-CLOSED	RTLS - STAFF LOCATING LOCATION-CLOSED AREA	STEEL CITY GW-225G, RACO 691 OR ANY OTHER TWO GANG BACK BOX.	REFER TO ELEVATION DRAWINGS
OPEN Staff	HILL-ROM	RTLS-OPEN	RTLS - STAFF LOCATING LOCATION-GLASS/OPEN AREA	STEEL CITY GW-225G, RACO 691 OR ANY OTHER TWO GANG BACK BOX.	REFER TO ELEVATION DRAWINGS
BAY Staff	HILL-ROM	RTLS-BAY	RTLS - STAFF LOCATING LOCATION-BAY	STEEL CITY GW-225G, RACO 691 OR ANY OTHER TWO GANG BACK BOX.	REFER TO ELEVATION DRAWINGS
	HILL-ROM		PILLOW SPEAKEKER, REQUIRES ASBC.		
R	CURBELL	MAP985A	REMOTE ENTERTAINMENT STATION	STEEL CITY GW-225C, RACO 691 OR ANY OTHER TWO GANG BACK BOX.	REFER TO ELEVATION DRAWINGS

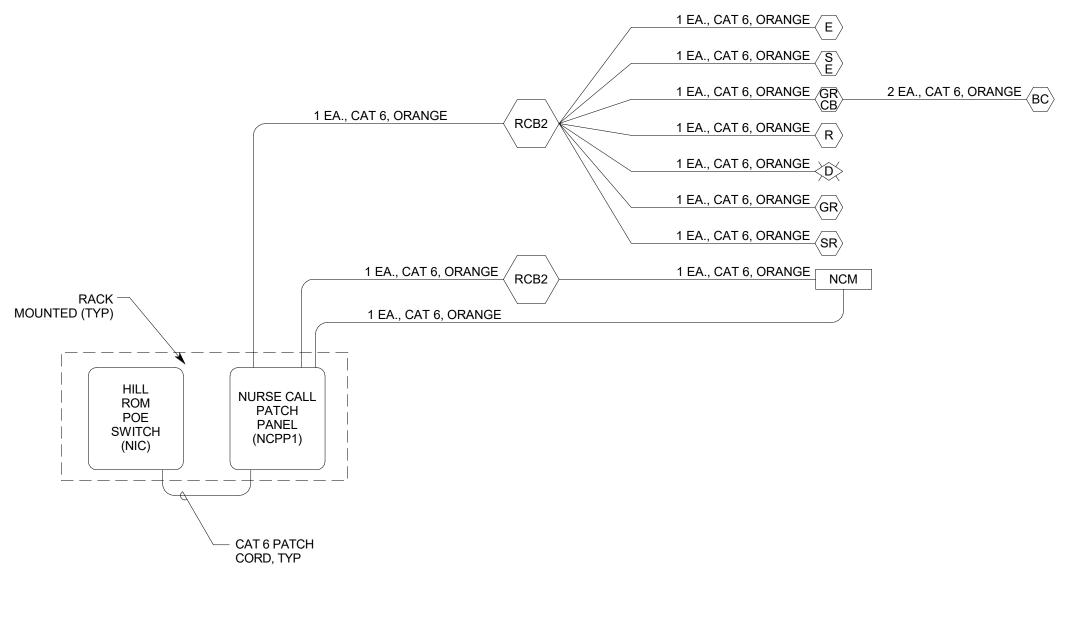

1 TYPICAL HILL-ROM NURSE CALL RISER DIAGRAM NO SCALE



ARCHITECT HKS ARCHITECTS, INC. 222 SOUTH MAIN, SUITE 230 SALT LAKE CITY, UT 84101

STRUCTURAL ENGINEER **REAVELEY ENGINEERS & ASSOCIATES** 675 EAST 500 SOUTH, SUITE 400 SALT LAKE CITY, UTAH 84102

MECHANICAL ENGINEER VAN BOERUM & FRANK ASSOCIATES, INC 181 EAST 5600 SOUTH, SUITE 130 MURRAY, UTAH 84107

ELECTRICAL ENGINEER SPECTRUM ENGINEERS, INC 324 SOUTH STATE STREET, SUITE 400 SALT LAKE CITY, UTAH 84111







С Ш 7 0 R U 5 Σ

KEY PLAN


REVISION NO. DESCRIPTION DATE

-

HKS PROJECT NUMBER 26404.000 DATE 08/15/24 ISSUE CONSTRUCTION DRAWINGS SHEET TITLE SYSTEMS SCEHDULES

EY601

SHEET NO.

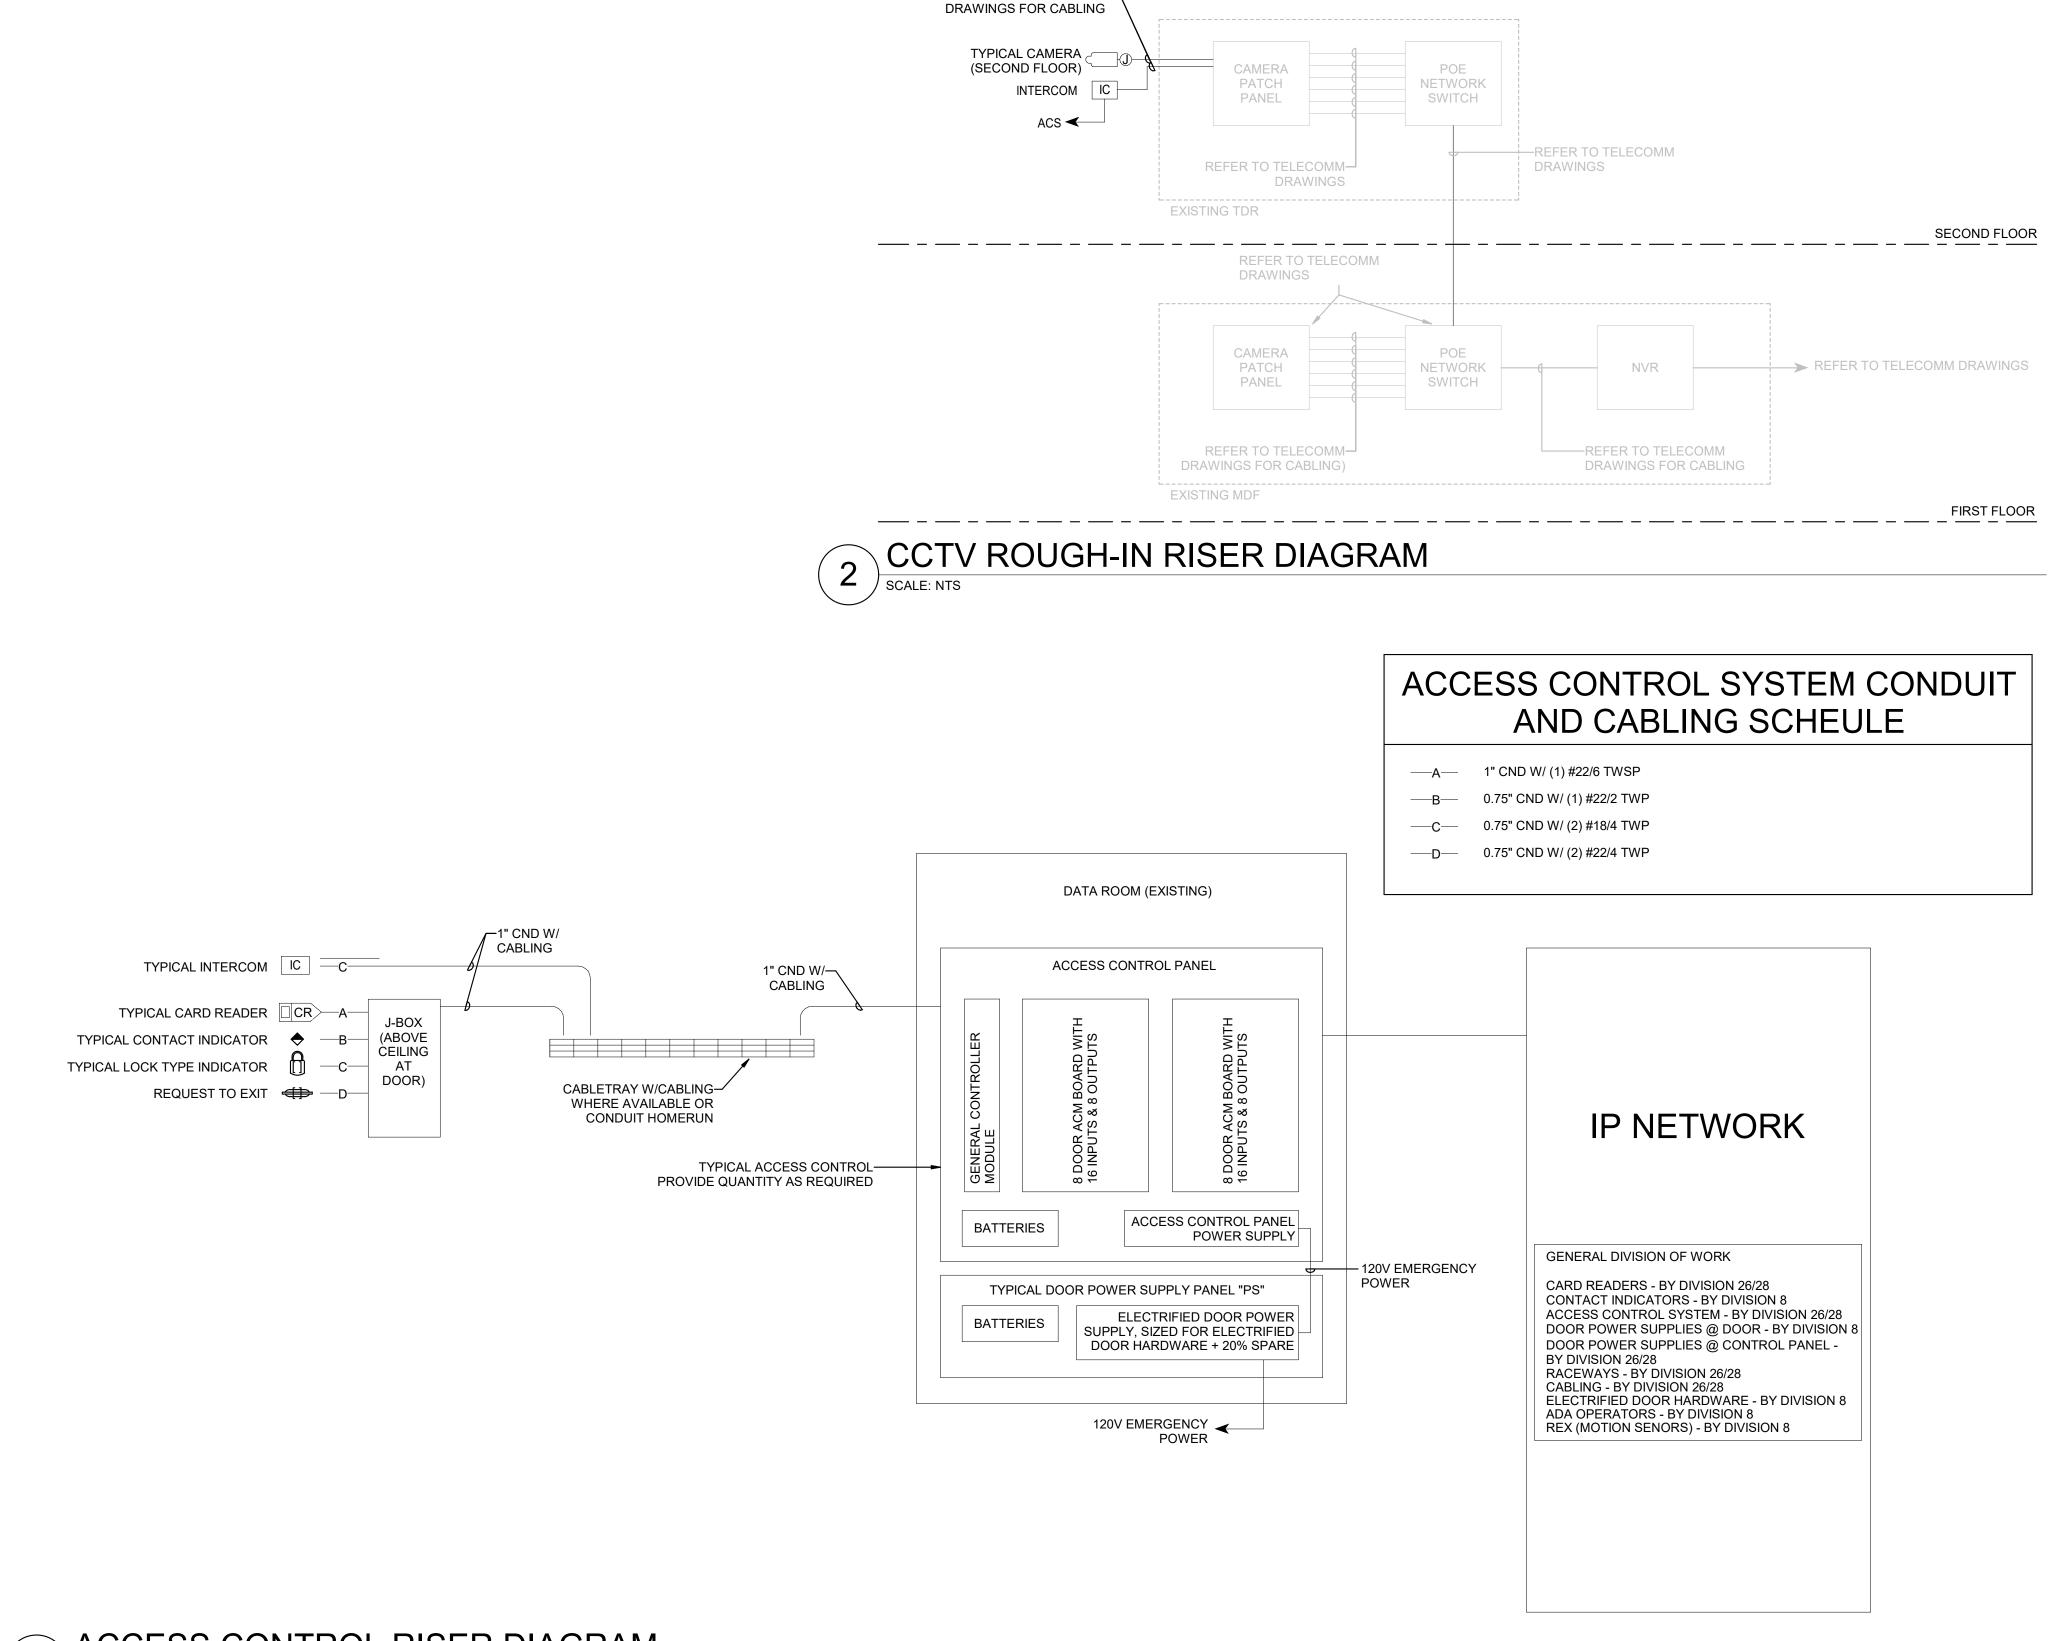

REFER TO TELECOMM-

ACCESS CONTROL RISER DIAGRAM SCALE: NTS



ARCHITECT HKS ARCHITECTS, INC. 222 SOUTH MAIN, SUITE 230 SALT LAKE CITY, UT 84101

STRUCTURAL ENGINEER REAVELEY ENGINEERS & ASSOCIATES 675 EAST 500 SOUTH, SUITE 400 SALT LAKE CITY, UTAH 84102

MECHANICAL ENGINEER VAN BOERUM & FRANK ASSOCIATES, INC 181 EAST 5600 SOUTH, SUITE 130 MURRAY, UTAH 84107

ELECTRICAL ENGINEER SPECTRUM ENGINEERS, INC 324 SOUTH STATE STREET, SUITE 400 SALT LAKE CITY, UTAH 84111







7 0 U **MIS**

KEY PLAN

REVISION NO. DESCRIPTION

DATE

HKS PROJECT NUMBER 26404.000 DATE 08/15/24 ISSUE CONSTRUCTION DRAWINGS SHEET TITLE **AUXILIARY RISER** DIAGRAMS

SHEET NO.

© 2008 HKS, INC

EY651