# SALT LAKE CITY INTERNATIONAL AIRPORT SLCDA NATIONAL WEATHER

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## SERVICE TI SALT LAKE INTERNATIONAL AIRPORT SALT LAKE CITY, UTAH

PROJECT NO. 2023573



SSISTANT DIRECTOR, DESIGN & PROJECT MANAGEMENT

STATUS

PROJECT NO .: 2023573 SHEET

### SLCDA NATIONAL WEATHER SERVICE TI SALT LAKE INTERNATIONAL AIRPORT SALT LAKE CITY, UTAH



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### **CONSTRUCTION DOCUMENTS - BID SET** MAY 02, 2024

**LANDSCAPE** 

### **STRUCTURAL**

### **MECHANICAL**

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### Ц Ц 0 U А П И П ល Z S 02023 MHTN ARCHITECTS, IN Confidentiality Notice: This document is intended for use on the Project identified herein by individuals and companies involved in the design, permitting, bidding and construction of the Project. MHTN Architects, Inc. grants limited rights to distribute and reproduce this document for this express purpose only. Distribution, printing or copying this document for purposes other than those indicated is strictly prohibited. If a digital copy of this document is received in error, please delete it. PINON 5480267-030 MHTN PROJECT NO.2023573 **VIEW AND PRINT THIS DRAWING IN COLOR** Driginal drawing is 24 x 36. Do not scale contents of this drawing NO. DATE DESCRIPTION Oct 27, 2023 SCHEMATIC DESIGN Nov 14, 2023 60% CONSTRUCTION DOCS Dec 15, 2023 90% CONSTRUCTION DOCS Jan 31, 2024 100% CONSTRUCTION DOCS CONTRACTOR TO VERIFY DRAWINGS IN FIELD USE REFLI LAST REVISION DATE. NO. DESCRIPTIO CONSTRUCTION DOCUMENTS - BID SET

MAY 02, 2024

COVER SHEET

SHEET NAME

SHEET NUMBER

G000

AIR CONDITI		KD	KNOCK DOWN	
F ABOVE FINIS T ALTERNATE		KD LAB LAV	KNOCK DOWN LABORATORY LAVATORY	
UM ALUMINUM PROX APPROXIMA	TF	MAINT MAX	MAINTENANCE	
CH ARCHITECTU BOARD		MECH	MECHANICAL	
DG BUILDING KG BLOCKING		MFR MH	MANUFACTURER MANHOLE	
BOTTOM OF T BOTTOM		MIN MISC	MINIMUM MISCELLANEOUS	
	ESTRAINED BRACE	MO NIC	MASONRY OPENING NOT IN CONTRACT	
	ED METAL FRAMING	NO NOM	NUMBER NOMINAL	
OI CONTRACTO P CAST-IN-PLA	OR FURNISHED OWNER INSTALLED	NTS OC	NOT TO SCALE ON CENTER	
CONTROL JO CENTER LIN		OD OFOI	OUTSIDE DIAMETER OWNER FURNISHED OWNER INSTALLED	
g ceiling R clear		OFCI OH	OWNER FURNISHED CONTRACTOR INSTALLED OVERHEAD	
CLEANOUT,	MASONRY UNIT CLEAR OPENING	OH DR OPP	OVERHEAD DOOR OPPOSITE	
OL COLUMN	TION	PERP PL	PERPENDICULAR PLATE, PROPERTY LINE	
ONC CONCRETE	E	PLAM PLBG	PLASTIC LAMINATE PLUMBING	
ONT CONTINUOU		PR	PLYWOOD PAIR	
ORD COORDINAT	E	QTY	PREFABRICATED QUANTITY	
	NG ELEVATION	RD RE:	ROOF DRAIN REFER TO	
MO DEMOLITION DRINKING F		REINF REQD	REINFORCE, REINFORCING REQUIRED	
a diameter Ag diagonal		REF RM	REFRIGERATOR ROOM	
M DIMENSION DOWN		RO RTU	ROUGH OPENING ROOF TOP UNIT	GENERAL NOTES
DOOR L DETAIL		RV SF	ROOF VENT SQUARE FEET	
	SULATION AND FINISH SYSTEM	SIM SPEC	SIMILAR SPECIFICATION	1. PRIOR TO SUBMITTING A BID OR PROCEED CONTRACTOR SHALL VERIFY ALL DIMENSION
EXPANSION ELEVATION		SQ STD	SQUARE STANDARD	THAT DIMENSIONS AND FINISHES COMPLY W DISCOVERED, THE CONTRACTOR SHALL NOT
EC ELECTRICAL EV ELEVATOR		STL STRUCT	STEEL STRUCTURAL	WRITING. THE ABSENCE OF SUCH NOTIFICAT PRIOR WORK AND LATER CLAIMS OF DEFECT
EQUAL UIP EQUIPMENT		SUSP THK	SUSPENDED THICK, THICKNESS	2. CUT AND PATCH EXISTING BUILDING CONS
/C ELECTRICAL P EXPANSION	WATER COOLER	TO TOB	TOP OF TOP OF BEAM	STRUCTURAL MEMBERS NOT DETAILED REQUENT
T EXTERIOR FLOOR DRAI		TOD TOS	TOP OF DECK TOP OF SLAB, TOP OF STRUCTURE	3. WHENEVER QUESTIONS ARISE OR CONDIT
C FIRE EXTING	GUISHER CABINET	TOW TYP	TOP OF WALL TYPICAL	OR ARE IN CONFLICT WITH THE CONTRACT D TAKING ANY FURTHER ACTION.
NFLR FINISH FLOO R FLOOR		UNO VCT	UNLESS NOTED OTHERWISE VINYL COMPOSITION TILE	4. ALL DEMOLISHED OR REMOVED EXISTING
FOOT, FEET GAUGE, GAO	ЭЕ	VERT VEST	VERTICAL VESTIBULE	CONTRACTOR, UNLESS OTHERWISE NOTED.
GALVANIZED ULAM GLUED-LAMI	) IRON NATED TIMBER	VTR W/	VENT THROUGH ROOF WITH	5. EXIST. MATERIAL NOTED TO BE RETURNE THE OWNER; CONTRACTOR SHALL COORDIN
P BD GYPSUM BO AC HEATING, VE	ARD ENTILATION, AIR CONDITIONING	W/O WC	WITHOUT WATER CLOSET	6. ALL CONSTRUCTION ACTIVITY IS TO BE CO
INSIDE DIAM	ETER	WD W	WOOD WIDE FLANGE	SHALL PROTECT ALL EXISTING SURFACES, E CONSTRUCTION. AFTER WORK OF THIS CON
) ISOMETRIC N JANITOR		WH WWF	WATER HEATER WELDED WIRE FABRIC	CONTRACTOR SHALL CLEAN AND RETURN TO BY THE WORK TO THE OWNER'S SATISFACTION
JOINT		XFMR	TRANSFORMER	7. CONTRACTOR SHALL REPAIR OR REPLACE
ENERAL	<u>_SYMBOLS</u>			PART OF THIS CONTRACT AT NO COST TO TH MATERIAL.
E PLUMBING, I	MECHANICAL AND ELECTRIC		R DISCIPLINE SYMBOLS	8. MAINTAIN A SAFE AND CLEAR ACCESS WA
E PLUMBING, I				8. MAINTAIN A SAFE AND CLEAR ACCESS WA TRAFFIC AREAS.
E PLUMBING, I	MECHANICAL AND ELECTRIC MHTN SHEET NUMBER Sheet Number Sequencce		$\sim$	TRAFFIC AREAS. 9. DEBRIS SHALL BE REMOVED FROM SITE D DEMOLISHED OR REMOVED EXISTING MATER
E PLUMBING, I	MHTN SHEET NUMBER Sheet Number Sequencce	( B)	1       2       GRID REFERENCE MARK         -       -       A1 Starts at lower left         corner Number Horizontal       -	9. DEBRIS SHALL BE REMOVED FROM SITE D DEMOLISHED OR REMOVED EXISTING MATER CONTRACTOR, UNLESS OTHERWISE NOTED.
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E PLUMBING, I	MHTN SHEET NUMBER Sheet Number Sequencce Sheet Type Discipline	( B)	1 2 GRID REFERENCE MARK A1 Starts at lower left corner Number Horizontal Letters Vertical	<ul> <li>TRAFFIC AREAS.</li> <li>9. DEBRIS SHALL BE REMOVED FROM SITE D DEMOLISHED OR REMOVED EXISTING MATER CONTRACTOR, UNLESS OTHERWISE NOTED.</li> <li>10. SUPPORT AND PROTECT EXISTING CEILIN INTERCOM SYSTEMS DURING CONSTRUCTION 11. CONTRACTOR SHALL NOT SCALE DRAWING</li> </ul>
A 1 01 (ACT1)	MHTN SHEET NUMBER Sheet Number Sequencce Sheet Type Discipline CEILING TYPE TAG	( B)	1       2       GRID REFERENCE MARK         4       -       A1 Starts at lower left         corner Number Horizontal       Letters Vertical         1       SIM         1       BUILDING SECTION	<ul> <li>TRAFFIC AREAS.</li> <li>9. DEBRIS SHALL BE REMOVED FROM SITE D DEMOLISHED OR REMOVED EXISTING MATER CONTRACTOR, UNLESS OTHERWISE NOTED.</li> <li>10. SUPPORT AND PROTECT EXISTING CEILIN INTERCOM SYSTEMS DURING CONSTRUCTION</li> <li>11. CONTRACTOR SHALL NOT SCALE DRAWIN CONTRACTORS REQUIRING DIMENSIONS NOT</li> </ul>
<u>A 1 01</u>	MHTN SHEET NUMBER Sheet Number Sequencce Sheet Type Discipline	( B)	1       2       GRID REFERENCE MARK         4       -       A1 Starts at lower left         corner Number Horizontal       Letters Vertical         1       SIM         1       BUILDING SECTION         A101       SHEET WHERE DRAWN	<ul> <li>TRAFFIC AREAS.</li> <li>9. DEBRIS SHALL BE REMOVED FROM SITE D DEMOLISHED OR REMOVED EXISTING MATER CONTRACTOR, UNLESS OTHERWISE NOTED.</li> <li>10. SUPPORT AND PROTECT EXISTING CEILIN INTERCOM SYSTEMS DURING CONSTRUCTIO</li> <li>11. CONTRACTOR SHALL NOT SCALE DRAWIN CONTRACTORS REQUIRING DIMENSIONS NOT SUCH INFORMATION PRIOR TO PROCEEDING</li> </ul>
A 1 01 (ACT1) (ACT1)	MHTN SHEET NUMBER Sheet Number Sequencce Sheet Type Discipline CEILING TYPE TAG 1 CEILING TAG	( B)	1       2       GRID REFERENCE MARK         A1 Starts at lower left       A1 Starts at lower left         corner Number Horizontal       Letters Vertical         1       SIM         1       BUILDING SECTION         A101       SIM         SIM         SIM	<ul> <li>TRAFFIC AREAS.</li> <li>9. DEBRIS SHALL BE REMOVED FROM SITE E DEMOLISHED OR REMOVED EXISTING MATER CONTRACTOR, UNLESS OTHERWISE NOTED.</li> <li>10. SUPPORT AND PROTECT EXISTING CEILIN INTERCOM SYSTEMS DURING CONSTRUCTIO</li> <li>11. CONTRACTOR SHALL NOT SCALE DRAWIN CONTRACTORS REQUIRING DIMENSIONS NO' SUCH INFORMATION PRIOR TO PROCEEDING</li> <li>12. ASBESTOS TESTING SHALL BE DONE ON REMODEL. INCLUDING BUT NOT LIMITED TO:</li> </ul>
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A <u>1</u> <u>01</u> (ACT1)	MHTN SHEET NUMBER Sheet Number Sequencce Sheet Type Discipline CEILING TYPE TAG 1 CEILING TAG	( B)	1       2       GRID REFERENCE MARK         A1 Starts at lower left       corner Number Horizontal         Letters Vertical       Letters Vertical         1       BUILDING SECTION         A101       SHEET WHERE DRAWN         1       WALL SECTION         SIM       WALL SECTION         SHEET WHERE DRAWN         1       DETAIL	<ul> <li>TRAFFIC AREAS.</li> <li>9. DEBRIS SHALL BE REMOVED FROM SITE D DEMOLISHED OR REMOVED EXISTING MATER CONTRACTOR, UNLESS OTHERWISE NOTED.</li> <li>10. SUPPORT AND PROTECT EXISTING CEILIN INTERCOM SYSTEMS DURING CONSTRUCTIO</li> <li>11. CONTRACTOR SHALL NOT SCALE DRAWIN CONTRACTORS REQUIRING DIMENSIONS NOT SUCH INFORMATION PRIOR TO PROCEEDING</li> <li>12. ASBESTOS TESTING SHALL BE DONE ON REMODEL. INCLUDING BUT NOT LIMITED TO: INSULATION, ETC., CONTRACTOR TO PERFOF</li> <li>13. COORDINATE OPTIMAL WORKING HOURS OPERATIONAL NATURE OF THIS FACILITY.</li> <li>14. A LEGIBLE FULL SET OF APPROVED PLAN</li> </ul>
A 1 01 (ACT1)	MHTN SHEET NUMBER Sheet Number Sequencce Sheet Type Discipline CEILING TYPE TAG (1) CEILING TAG SPOT ELEVATION VERTICAL ELEVATION	( B)	1       2       GRID REFERENCE MARK         A1 Starts at lower left       Corner Number Horizontal         Letters Vertical       Letters Vertical         1       BUILDING SECTION         A101       SIM         1       WALL SECTION         SIM       WALL SECTION         SIM       SHEET WHERE DRAWN         SIM       SHEET WHERE DRAWN	<ul> <li>TRAFFIC AREAS.</li> <li>9. DEBRIS SHALL BE REMOVED FROM SITE D DEMOLISHED OR REMOVED EXISTING MATER CONTRACTOR, UNLESS OTHERWISE NOTED.</li> <li>10. SUPPORT AND PROTECT EXISTING CEILIN INTERCOM SYSTEMS DURING CONSTRUCTIO</li> <li>11. CONTRACTOR SHALL NOT SCALE DRAWIN CONTRACTORS REQUIRING DIMENSIONS NOT SUCH INFORMATION PRIOR TO PROCEEDING</li> <li>12. ASBESTOS TESTING SHALL BE DONE ON REMODEL. INCLUDING BUT NOT LIMITED TO: INSULATION, ETC., CONTRACTOR TO PERFOR</li> <li>13. COORDINATE OPTIMAL WORKING HOURS OPERATIONAL NATURE OF THIS FACILITY.</li> </ul>
A 1 01 (ACT1) ↔ 10'-0" EL: 100'-0" LEVEL	MHTN SHEET NUMBER Sheet Number Sequencce Sheet Type Discipline CEILING TYPE TAG (1) CEILING TAG SPOT ELEVATION VERTICAL ELEVATION NORTH ARROW	( B)	1       2       GRID REFERENCE MARK         A1 Starts at lower left       corner Number Horizontal         Letters Vertical       Letters Vertical         1       BUILDING SECTION         A101       SHEET WHERE DRAWN         1       WALL SECTION         SIM       ULL SECTION         SIM       DETAIL         A101       DETAIL         SHEET WHERE DRAWN         1       DETAIL         SHEET WHERE DRAWN         EXTERIOR ELEVATION	<ul> <li>TRAFFIC AREAS.</li> <li>9. DEBRIS SHALL BE REMOVED FROM SITE I DEMOLISHED OR REMOVED EXISTING MATER CONTRACTOR, UNLESS OTHERWISE NOTED.</li> <li>10. SUPPORT AND PROTECT EXISTING CEILII INTERCOM SYSTEMS DURING CONSTRUCTIO</li> <li>11. CONTRACTOR SHALL NOT SCALE DRAWIN CONTRACTORS REQUIRING DIMENSIONS NOT SUCH INFORMATION PRIOR TO PROCEEDING</li> <li>12. ASBESTOS TESTING SHALL BE DONE ON REMODEL. INCLUDING BUT NOT LIMITED TO: INSULATION, ETC., CONTRACTOR TO PERFOR</li> <li>13. COORDINATE OPTIMAL WORKING HOURS OPERATIONAL NATURE OF THIS FACILITY.</li> <li>14. A LEGIBLE FULL SET OF APPROVED PLAN</li> </ul>
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A 1 01 (ACT1)	MHTN SHEET NUMBER Sheet Number Sequencce Sheet Type Discipline CEILING TYPE TAG ( 1 CEILING TA	( B)	1       2       GRID REFERENCE MARK         A1 Starts at lower left       corner Number Horizontal         Letters Vertical       1         1       BUILDING SECTION         A101       BUILDING SECTION         SIM       BUILDING SECTION         A101       SHEET WHERE DRAWN         1       WALL SECTION         SIM       DETAIL         A101       DETAIL         SHEET WHERE DRAWN         1       DETAIL         SHEET WHERE DRAWN         1       DETAIL         SHEET WHERE DRAWN         1       SIM         1       SIM         1       SIM         1       SIM	<ul> <li>TRAFFIC AREAS.</li> <li>9. DEBRIS SHALL BE REMOVED FROM SITE D DEMOLISHED OR REMOVED EXISTING MATER CONTRACTOR, UNLESS OTHERWISE NOTED.</li> <li>10. SUPPORT AND PROTECT EXISTING CEILIN INTERCOM SYSTEMS DURING CONSTRUCTIO</li> <li>11. CONTRACTOR SHALL NOT SCALE DRAWIN CONTRACTORS REQUIRING DIMENSIONS NOT SUCH INFORMATION PRIOR TO PROCEEDING</li> <li>12. ASBESTOS TESTING SHALL BE DONE ON REMODEL. INCLUDING BUT NOT LIMITED TO: INSULATION, ETC., CONTRACTOR TO PERFOR</li> <li>13. COORDINATE OPTIMAL WORKING HOURS OPERATIONAL NATURE OF THIS FACILITY.</li> <li>14. A LEGIBLE FULL SET OF APPROVED PLAN</li> </ul>
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A 1 01 (ACT1)	MHTN SHEET NUMBER Sheet Number Sequencce Sheet Type Discipline CEILING TYPE TAG ( 1 CEILING TA	( B)	1       2       GRID REFERENCE MARK         A1 Starts at lower left       corner Number Horizontal         Letters Vertical       1         1       A101         BUILDING SECTION         A101       BUILDING SECTION         A101       BUILDING SECTION         SIM       BUILDING SECTION         A101       SHEET WHERE DRAWN         1       DETAIL         A101       DETAIL         SIM       DETAIL         A101       EXTERIOR ELEVATION         SHEET WHERE DRAWN       SHEET WHERE DRAWN         1       SHEET WHERE DRAWN	<ul> <li>TRAFFIC AREAS.</li> <li>9. DEBRIS SHALL BE REMOVED FROM SITE ID DEMOLISHED OR REMOVED EXISTING MATER CONTRACTOR, UNLESS OTHERWISE NOTED.</li> <li>10. SUPPORT AND PROTECT EXISTING CEILININTERCOM SYSTEMS DURING CONSTRUCTION</li> <li>11. CONTRACTOR SHALL NOT SCALE DRAWING CONTRACTORS REQUIRING DIMENSIONS NOT SUCH INFORMATION PRIOR TO PROCEEDING</li> <li>12. ASBESTOS TESTING SHALL BE DONE ON REMODEL. INCLUDING BUT NOT LIMITED TO: INSULATION, ETC., CONTRACTOR TO PERFOR</li> <li>13. COORDINATE OPTIMAL WORKING HOURS OPERATIONAL NATURE OF THIS FACILITY.</li> <li>14. A LEGIBLE FULL SET OF APPROVED PLANINSPECTIONS.</li> </ul>
A 1 01 (ACT1)	MHTN SHEET NUMBER Sheet Number Sequencce Sheet Type Discipline CEILING TYPE TAG (1) A101 SPOT ELEVATION VERTICAL ELEVATION NORTH ARROW PLAN NORTH TRUE NORTH TRUE NORTH DRAWING REVISION REVISION NUMBER ROOM NAME ROOM NAME ROOM NAME	( B)	1       2       GRID REFERENCE MARK         A1 Starts at lower left       corner Number Horizontal         Letters Vertical       1         1       A101         BUILDING SECTION         A101       BUILDING SECTION         A101       BUILDING SECTION         SIM       BUILDING SECTION         A101       SHEET WHERE DRAWN         1       DETAIL         A101       DETAIL         SIM       DETAIL         A101       EXTERIOR ELEVATION         SHEET WHERE DRAWN       SHEET WHERE DRAWN         1       SHEET WHERE DRAWN	TRAFFIC AREAS.          9. DEBRIS SHALL BE REMOVED FROM SITE ID DEMOLISHED OR REMOVED EXISTING MATER CONTRACTOR, UNLESS OTHERWISE NOTED.         10. SUPPORT AND PROTECT EXISTING CELLININTERCOM SYSTEMS DURING CONSTRUCTION         11. CONTRACTOR SHALL NOT SCALE DRAWING CONTRACTORS REQUIRING DIMENSIONS NOT SUCH INFORMATION PRIOR TO PROCEEDING         12. ASBESTOS TESTING SHALL BE DONE ON REMODEL. INCLUDING BUT NOT LIMITED TO: INSULATION, ETC., CONTRACTOR TO PERFOR         13. COORDINATE OPTIMAL WORKING HOURS OPERATIONAL NATURE OF THIS FACILITY.         14. A LEGIBLE FULL SET OF APPROVED PLAINSPECTIONS.
A 1 01 (ACT1)	MHTN SHEET NUMBER Sheet Number Sequencce Sheet Type Discipline CEILING TYPE TAG ( 1 CEILING TA	( B)	1       2       GRID REFERENCE MARK A1 Starts at lower left corner Number Horizontal Letters Vertical         1       SIM A101       BUILDING SECTION SHEET WHERE DRAWN         1       SIM A101       WALL SECTION SHEET WHERE DRAWN         1       DETAIL SHEET WHERE DRAWN         1       DETAIL SHEET WHERE DRAWN         1       DETAIL SHEET WHERE DRAWN         1       DETAIL SHEET WHERE DRAWN         1       SIM SHEET WHERE DRAWN         1       SHEET WHERE DRAWN         1       SHEET WHERE DRAWN         2       DOOR NUMBER	TRAFFIC AREAS.          9. DEBRIS SHALL BE REMOVED FROM SITE ID DEMOLISHED OR REMOVED EXISTING MATEFIC CONTRACTOR, UNLESS OTHERWISE NOTED.         10. SUPPORT AND PROTECT EXISTING CELLININTERCOM SYSTEMS DURING CONSTRUCTION         11. CONTRACTOR SHALL NOT SCALE DRAWING CONTRACTORS REQUIRING DIMENSIONS NOT SUCH INFORMATION PRIOR TO PROCEEDING         12. ASBESTOS TESTING SHALL BE DONE ON REMODEL. INCLUDING BUT NOT LIMITED TO: INSULATION, ETC., CONTRACTOR TO PERFOR         13. COORDINATE OPTIMAL WORKING HOURS OPERATIONAL NATURE OF THIS FACILITY.         14. A LEGIBLE FULL SET OF APPROVED PLAINSPECTIONS.
A 1 01 (ACT1)	MHTN SHEET NUMBER Sheet Number Sequencce Sheet Type Discipline CEILING TYPE TAG (1) A101 SPOT ELEVATION VERTICAL ELEVATION NORTH ARROW PLAN NORTH TRUE NORTH TRUE NORTH DRAWING REVISION REVISION NUMBER ROOM NAME ROOM NAME ROOM NAME	( B)	1       2       GRID REFERENCE MARK A1 Starts at lower left corner Number Horizontal Letters Vertical         1       SIM BUILDING SECTION SHEET WHERE DRAWN         1       SIM VALL SECTION SHEET WHERE DRAWN         1       MALL SECTION SHEET WHERE DRAWN         1       DETAIL SHEET WHERE DRAWN         1       DETAIL SHEET WHERE DRAWN         1       DETAIL SHEET WHERE DRAWN         1       SIM DETAIL SHEET WHERE DRAWN         1       Image: Callout SHEET WHERE DRAWN         1       SIM SHEET WHERE DRAWN         1       Image: Callout SHEET WHERE DRAWN         2       Image: Callout SHEET WHERE DRAWN         2       Image: Callout SHEET WHERE DRAWN         2       Image	TRAFFIC AREAS.          9. DEBRIS SHALL BE REMOVED FROM SITE IDEMOLISHED OR REMOVED EXISTING MATEFIC CONTRACTOR, UNLESS OTHERWISE NOTED.         10. SUPPORT AND PROTECT EXISTING CELLINTERCOM SYSTEMS DURING CONSTRUCTION         11. CONTRACTOR SHALL NOT SCALE DRAWING CONTRACTORS REQUIRING DIMENSIONS NO SUCH INFORMATION PRIOR TO PROCEEDING         12. ASBESTOS TESTING SHALL BE DONE ON REMODEL. INCLUDING BUT NOT LIMITED TO: INSULATION, ETC., CONTRACTOR TO PERFORMATION, ETC., CONTRACTOR, CONTRACTOR, CONTRACT, CONTRACTOR, CONTRACT, CONTRAC
A 1 01 (ACT1)	MHTN SHEET NUMBER Sheet Number Sequencce Sheet Type Discipline CEILING TYPE TAG (1) CEILING TAG SPOT ELEVATION VERTICAL ELEVATION VERTICAL ELEVATION NORTH ARROW PLAN NORTH TRUE NORTH TRUE NORTH DRAWING REVISION REVISION NUMBER ROOM NAME ROOM NAME ROOM NAME ROOM NUMBER ROOM VOLUME / AREA KEYED NOTES	( B)	1       2       GRID REFERENCE MARK A1 Starts at lower left corner Number Horizontal Letters Vertical         1       SIM A101       BUILDING SECTION SHEET WHERE DRAWN         1       SIM A101       WALL SECTION SHEET WHERE DRAWN         1       DETAIL SHEET WHERE DRAWN         1       DETAIL SHEET WHERE DRAWN         1       DETAIL SHEET WHERE DRAWN         1       DETAIL SHEET WHERE DRAWN         1       SIM SHEET WHERE DRAWN         1       SHEET WHERE DRAWN         1       SHEET WHERE DRAWN         2       DOOR NUMBER	TRAFFIC AREAS.          9. DEBRIS SHALL BE REMOVED FROM SITE ID DEMOLISHED OR REMOVED EXISTING MATEFIC CONTRACTOR, UNLESS OTHERWISE NOTED.         10. SUPPORT AND PROTECT EXISTING CELLINITERCOM SYSTEMS DURING CONSTRUCTION         11. CONTRACTOR SHALL NOT SCALE DRAWING CONTRACTORS REQUIRING DIMENSIONS NOT SUCH INFORMATION PRIOR TO PROCEEDING         12. ASBESTOS TESTING SHALL BE DONE ON REMODEL. INCLUDING BUT NOT LIMITED TO: INSULATION, ETC., CONTRACTOR TO PERFOR         13. COORDINATE OPTIMAL WORKING HOURS OPERATIONAL NATURE OF THIS FACILITY.         14. A LEGIBLE FULL SET OF APPROVED PLANINSPECTIONS.
A 1 01 (ACT1)	MHTN SHEET NUMBER Sheet Number Sequencce Sheet Type Discipline CEILING TYPE TAG CEILING TAG SPOT ELEVATION VERTICAL ELEVATION VERTICAL ELEVATION NORTH ARROW PLAN NORTH TRUE NORTH TRUE NORTH DRAWING REVISION REVISION NUMBER ROOM NAME ROOM NAME ROOM NAME ROOM NUMBER ROOM VOLUME / AREA KEYED NOTES CASEWORK TYPE	( B)	1       2       GRID REFERENCE MARK A1 Starts at lower left corner Number Horizontal Letters Vertical         1       SIM BUILDING SECTION SHEET WHERE DRAWN         1       NM SHEET WHERE DRAWN         1       WALL SECTION SHEET WHERE DRAWN         1       DETAIL SHEET WHERE DRAWN         1       DETAIL SHEET WHERE DRAWN         1       DETAIL SHEET WHERE DRAWN         1       DETAIL SHEET WHERE DRAWN         1       SIM DETAIL SHEET WHERE DRAWN         1       NTERIOR ELEVATION SHEET WHERE DRAWN         1       SIM CALLOUT SHEET WHERE DRAWN         1       INTERIOR ELEVATION SHEET WHERE DRAWN         1       INTERIOR ELEVATION SHEET WHERE DRAWN         1       INTERIOR ELEVATION SHEET WHERE DRAWN         1       INTERIOR WHERE DRAWN         1       INTERIOR WALL TYPE CORE MATERIAL CORE THICKNESS FIRE RATING, IF NEEDED	TRAFFIC AREAS.          9. DEBRIS SHALL BE REMOVED FROM SITE ID DEMOLISHED OR REMOVED EXISTING MATEFIC CONTRACTOR, UNLESS OTHERWISE NOTED.         10. SUPPORT AND PROTECT EXISTING CELLINITERCOM SYSTEMS DURING CONSTRUCTION         11. CONTRACTOR SHALL NOT SCALE DRAWING CONTRACTORS REQUIRING DIMENSIONS NOT SUCH INFORMATION PRIOR TO PROCEEDING         12. ASBESTOS TESTING SHALL BE DONE ON REMODEL. INCLUDING BUT NOT LIMITED TO: INSULATION, ETC., CONTRACTOR TO PERFOR         13. COORDINATE OPTIMAL WORKING HOURS OPERATIONAL NATURE OF THIS FACILITY.         14. A LEGIBLE FULL SET OF APPROVED PLANINSPECTIONS.
A 1 01 (ACT1) (ACT1	MHTN SHEET NUMBER Sheet Number Sequencce Sheet Type Discipline CEILING TYPE TAG (1) CEILING TAG SPOT ELEVATION VERTICAL ELEVATION VERTICAL ELEVATION NORTH ARROW PLAN NORTH TRUE NORTH TRUE NORTH DRAWING REVISION REVISION NUMBER ROOM NAME ROOM NAME ROOM NAME ROOM NUMBER ROOM VOLUME / AREA KEYED NOTES	( B)	1       2       GRID REFERENCE MARK         A1 Starts at lower left       corner Number Horizontal         Letters Vertical       1         A101       BUILDING SECTION         A101       BUILDING SECTION         A101       SHEET WHERE DRAWN         1       MALL SECTION         A101       SHEET WHERE DRAWN         1       DETAIL         A101       SHEET WHERE DRAWN         1       DETAIL         A101       SHEET WHERE DRAWN         1       SHEET WHERE DRAWN         2       DOOR NUMBER         1       INTERIOR WALL TYPE         CORE MATERIAL       CORE THICKNESS         FIRE RATING, IF NEEDED       HEIGHT & STC         0       HEIGHT & STC	TRAFFIC AREAS.          9. DEBRIS SHALL BE REMOVED FROM SITE ID DEMOLISHED OR REMOVED EXISTING MATEFIC CONTRACTOR, UNLESS OTHERWISE NOTED.         10. SUPPORT AND PROTECT EXISTING CELLININTERCOM SYSTEMS DURING CONSTRUCTION         11. CONTRACTOR SHALL NOT SCALE DRAWING CONTRACTORS REQUIRING DIMENSIONS NOT SUCH INFORMATION PRIOR TO PROCEEDING         12. ASBESTOS TESTING SHALL BE DONE ON REMODEL. INCLUDING BUT NOT LIMITED TO: INSULATION, ETC., CONTRACTOR TO PERFOR         13. COORDINATE OPTIMAL WORKING HOURS OPERATIONAL NATURE OF THIS FACILITY.         14. A LEGIBLE FULL SET OF APPROVED PLAINSPECTIONS.
A 1 01 (ACT1) (ACT1	MHTN SHEET NUMBER Sheet Number Sequencce Sheet Type Discipline CEILING TYPE TAG 1 CEILING TAG SPOT ELEVATION VERTICAL ELEVATION VERTICAL ELEVATION NORTH ARROW PLAN NORTH TRUE NORTH TRUE NORTH DRAWING REVISION REVISION NUMBER ROOM NAME ROOM NAME ROOM NUMBER ROOM VOLUME / AREA KEYED NOTES CASEWORK TYPE DEPTH	( B)	1       2       GRID REFERENCE MARK         A1 Starts at lower left       corner Number Horizontal         Letters Vertical       Letters Vertical         1       SIM         A101       BUILDING SECTION         A101       SHEET WHERE DRAWN         1       MALL SECTION         A101       SHEET WHERE DRAWN         1       DETAIL         A101       SHEET WHERE DRAWN         1       SHEET WHERE DRAWN         A101       EXTERIOR ELEVATION         SHEET WHERE DRAWN       SHEET WHERE DRAWN         1       INTERIOR ELEVATION         3       SHEET WHERE DRAWN         2       DOOR NUMBER         1       INTERIOR WALL TYPE         CORE MATERIAL       CORE THICKNESS         5       FIRE RATING, IF NEEDED         4       HEIGHT & STC         9       QUALIFIER, IF NEEDED	TRAFFIC AREAS.          9. DEBRIS SHALL BE REMOVED FROM SITE ID DEMOLISHED OR REMOVED EXISTING MATER CONTRACTOR, UNLESS OTHERWISE NOTED.         10. SUPPORT AND PROTECT EXISTING CELLININTERCOM SYSTEMS DURING CONSTRUCTION         11. CONTRACTOR SHALL NOT SCALE DRAWING CONTRACTORS REQUIRING DIMENSIONS NOT SUCH INFORMATION PRIOR TO PROCEEDING         12. ASBESTOS TESTING SHALL BE DONE ON REMODEL. INCLUDING BUT NOT LIMITED TO: INSULATION, ETC., CONTRACTOR TO PERFOR         13. COORDINATE OPTIMAL WORKING HOURS OPERATIONAL NATURE OF THIS FACILITY.         14. A LEGIBLE FULL SET OF APPROVED PLAINSPECTIONS.
A 1 01 (ACT1)	MHTN SHEET NUMBER Sheet Number Sequencce Sheet Type Discipline CEILING TYPE TAG (1) CEILING TAG SPOT ELEVATION VERTICAL ELEVATION VERTICAL ELEVATION NORTH ARROW PLAN NORTH TRUE NORTH TRUE NORTH DRAWING REVISION REVISION NUMBER ROOM NAME ROOM NAME ROOM NAME ROOM NUMBER ROOM VOLUME / AREA KEYED NOTES CASEWORK TYPE DEPTH HEIGHT WIDTH	( B)	1       2       GRID REFERENCE MARK         A1 Starts at lower left       corner Number Horizontal         Letters Vertical       Letters Vertical         1       SIM         A101       BUILDING SECTION         A101       SHEET WHERE DRAWN         1       MALL SECTION         A101       SHEET WHERE DRAWN         1       DETAIL         A101       SHEET WHERE DRAWN         1       SHEET WHERE DRAWN         A101       EXTERIOR ELEVATION         SHEET WHERE DRAWN       SHEET WHERE DRAWN         1       INTERIOR ELEVATION         3       SHEET WHERE DRAWN         2       DOOR NUMBER         1       INTERIOR WALL TYPE         CORE MATERIAL       CORE THICKNESS         FIRE RATING, IF NEEDED       HEIGHT & STC         3       QUALIFIER, IF NEEDED	TRAFFIC AREAS.          9. DEBRIS SHALL BE REMOVED FROM SITE ID DEMOLISHED OR REMOVED EXISTING MATER CONTRACTOR, UNLESS OTHERWISE NOTED.         10. SUPPORT AND PROTECT EXISTING CELLININTERCOM SYSTEMS DURING CONSTRUCTION         11. CONTRACTOR SHALL NOT SCALE DRAWING CONTRACTORS REQUIRING DIMENSIONS NOT SUCH INFORMATION PRIOR TO PROCEEDING         12. ASBESTOS TESTING SHALL BE DONE ON REMODEL. INCLUDING BUT NOT LIMITED TO: INSULATION, ETC., CONTRACTOR TO PERFOR         13. COORDINATE OPTIMAL WORKING HOURS OPERATIONAL NATURE OF THIS FACILITY.         14. A LEGIBLE FULL SET OF APPROVED PLAINSPECTIONS.
A 1 01 (ACT1)	MHTN SHEET NUMBER Sheet Number Sequencce Sheet Type Discipline CEILING TYPE TAG (1) CEILING TAG SPOT ELEVATION VERTICAL ELEVATION VERTICAL ELEVATION NORTH ARROW PLAN NORTH TRUE NORTH TRUE NORTH DRAWING REVISION REVISION NUMBER ROOM NAME ROOM NAME ROOM NUMBER ROOM NUMBER ROOM VOLUME / AREA KEYED NOTES CASEWORK TYPE DEPTH HEIGHT	( B)	1       2       GRID REFERENCE MARK         A1 Starts at lower left       corner Number Horizontal         Letters Vertical       1         A101       BUILDING SECTION         A101       SHEET WHERE DRAWN         1       MALL SECTION         A101       SHEET WHERE DRAWN         1       DETAIL         A101       SHEET WHERE DRAWN         1       DETAIL         A101       SHEET WHERE DRAWN         1       INTERIOR ELEVATION         SHEET WHERE DRAWN       SHEET WHERE DRAWN         2       DOOR NUMBER         INTERIOR WALL TYPE       CORE MATERIAL         CORE MATERIAL       CORE THICKNESS         SIAX       QUALIFIER, IF NEEDED         1       HEIGHT & STC         2       QUALIFIER, IF NEEDED         5       STUD SPACING,	TRAFFIC AREAS. 9. DEBRIS SHALL BE REMOVED FROM SITE ID DEMOLISHED OR REMOVED EXISTING MATEFIC CONTRACTOR, UNLESS OTHERWISE NOTED. 10. SUPPORT AND PROTECT EXISTING CELLININTERCOM SYSTEMS DURING CONSTRUCTION 11. CONTRACTOR SHALL NOT SCALE DRAWING CONTRACTORS REQUIRING DIMENSIONS NOT SUCH INFORMATION PRIOR TO PROCEEDING 12. ASBESTOS TESTING SHALL BE DONE ON REMODEL. INCLUDING BUT NOT LIMITED TO: INSULATION, ETC., CONTRACTOR TO PERFOR 13. COORDINATE OPTIMAL WORKING HOURS OPERATIONAL NATUBE OF THIS FACILITY. 14. A LEGIBLE FULL SET OF APPROVED PLANINS PERFORMANCE VICINITY MAP VICINITY MA
A 1 01 (ACT1) (ACT1	MHTN SHEET NUMBER Sheet Number Sequencce Sheet Type Discipline CEILING TYPE TAG (1) CEILING TAG SPOT ELEVATION VERTICAL ELEVATION VERTICAL ELEVATION NORTH ARROW PLAN NORTH TRUE NORTH TRUE NORTH DRAWING REVISION REVISION NUMBER ROOM NAME ROOM NAME ROOM NAME ROOM NUMBER ROOM VOLUME / AREA KEYED NOTES CASEWORK TYPE DEPTH HEIGHT WIDTH	( B)	1       2       GRID REFERENCE MARK         A1 Starts at lower left       corner Number Horizontal         Letters Vertical         1       BUILDING SECTION         A101       BUILDING SECTION         A101       BUILDING SECTION         SIM       BUILDING SECTION         A101       BUILDING SECTION         SIM       BUILDING SECTION         A101       SHEET WHERE DRAWN         1       DETAIL         A101       SHEET WHERE DRAWN         A101       EXTERIOR ELEVATION         SHEET WHERE DRAWN       SHEET WHERE DRAWN         1       SHEET WHERE DRAWN         1       INTERIOR ELEVATION         SHEET WHERE DRAWN       SHEET WHERE DRAWN         2       DOOR NUMBER         1       INTERIOR WALL TYPE         CORE MATERIAL       CORE THICKNESS         FIRE RATING, IF NEEDED       HEIGHT & STC         QUALIFIER, IF NEEDED       HEIGHT & STC         3.1 A.X       QUALIFIER, IF NEEDED         12/133       THICKNESS (MIL), IF OTHER         14/1733       THICKNESS (MIL), IF OTHER         15/10       STUD SPACING, IF OTHER THAN 16" OC <td>TRAFFIC AREAS.          9. DEBRIS SHALL BE REMOVED FROM SITE ID DEMOLISHED OR REMOVED EXISTING MATEFIC CONTRACTOR, UNLESS OTHERWISE NOTED.         10. SUPPORT AND PROTECT EXISTING CELLININTERCOM SYSTEMS DURING CONSTRUCTION         11. CONTRACTOR SHALL NOT SCALE DRAWING CONTRACTORS REQUIRING DIMENSIONS NOT SUCH INFORMATION PRIOR TO PROCEEDING         12. ASBESTOS TESTING SHALL BE DONE ON REMODEL. INCLUDING BUT NOT LIMITED TO: INSULATION, ETC., CONTRACTOR TO PERFOR         13. COORDINATE OPTIMAL WORKING HOURS OPERATIONAL NATURE OF THIS FACILITY.         14. A LEGIBLE FULL SET OF APPROVED PLAINSPECTIONS.</td>	TRAFFIC AREAS.          9. DEBRIS SHALL BE REMOVED FROM SITE ID DEMOLISHED OR REMOVED EXISTING MATEFIC CONTRACTOR, UNLESS OTHERWISE NOTED.         10. SUPPORT AND PROTECT EXISTING CELLININTERCOM SYSTEMS DURING CONSTRUCTION         11. CONTRACTOR SHALL NOT SCALE DRAWING CONTRACTORS REQUIRING DIMENSIONS NOT SUCH INFORMATION PRIOR TO PROCEEDING         12. ASBESTOS TESTING SHALL BE DONE ON REMODEL. INCLUDING BUT NOT LIMITED TO: INSULATION, ETC., CONTRACTOR TO PERFOR         13. COORDINATE OPTIMAL WORKING HOURS OPERATIONAL NATURE OF THIS FACILITY.         14. A LEGIBLE FULL SET OF APPROVED PLAINSPECTIONS.
A 1 01 (ACT1)	MHTN SHEET NUMBER Sheet Number Sequencce Sheet Type Discipline CEILING TYPE TAG (1) CEILING TAG SPOT ELEVATION VERTICAL ELEVATION VERTICAL ELEVATION NORTH ARROW PLAN NORTH TRUE NORTH TRUE NORTH DRAWING REVISION REVISION NUMBER ROOM NAME ROOM NAME ROOM NAME ROOM NUMBER ROOM VOLUME / AREA KEYED NOTES CASEWORK TYPE DEPTH HEIGHT WIDTH	( B)	1       2       GRID REFERENCE MARK         A1 Starts at lower left       corner Number Horizontal         Letters Vertical         1       BUILDING SECTION         A101       BUILDING SECTION         SIM       BUILDING SECTION         A101       SHEET WHERE DRAWN         1       DETAIL         A101       EXTERIOR ELEVATION         SIM       DETAIL         A101       EXTERIOR ELEVATION         SHEET WHERE DRAWN       SHEET WHERE DRAWN         1       SHEET WHERE DRAWN         1       SHEET WHERE DRAWN         1       INTERIOR ELEVATION         SHEET WHERE DRAWN       SHEET WHERE DRAWN         1       INTERIOR ELEVATION         SHEET WHERE DRAWN       SHEET WHERE DRAWN         1       INTERIOR WALL TYPE         DOOR NUMBER       INTERIOR WALL TYPE         CORE MATERIAL       CORE THICKNESS         12/33       FIRE RATING, IF NEEDED         12/33       THICKNESS (MIL), IF OTHER         14/2/33       THICKNESS (MIL), IF OTHER         12/33       EXTERIOR WALL TYPE	TRAFFIC AREAS. 9. DEBRIS SHALL BE REMOVED FROM SITE ID DEMOLISHED OR REMOVED EXISTING MATER CONTRACTOR, UNLESS OTHERWISE NOTED. 10. SUPPORT AND PROTECT EXISTING CEILIN INTERCOM SYSTEMS DURING CONSTRUCTIO 11. CONTRACTOR SHALL NOT SCALE DRAWN CONTRACTORS REQUIRING DIMENSIONS NO SUCH INFORMATION PRIOR TO PROCEEDING 12. ASBESTOS TESTING SHALL BE DONE ON REMODEL. INCLUDING BUT NOT LIMITED TO: INSULATION, ETC., CONTRACTOR TO PERFOR 13. COORDINATE OPTIMAL WORKING HOURS OPERATIONAL NATUBE OF THIS FACILITY. 14. A LEGIBLE FULL SET OF APPROVED PLAN INSPECTIONS.
A 1 01 (ACT1)	MHTN SHEET NUMBER Sheet Number Sequencce Sheet Type Discipline CEILING TYPE TAG (1) CEILING TAG SPOT ELEVATION VERTICAL ELEVATION NORTH ARROW PLAN NORTH TRUE NORTH TRUE NORTH DRAWING REVISION NUMBER ROOM NAME ROOM NAME ROOM NUMBER ROOM NUMBER ROOM VOLUME / AREA KEYED NOTES CASEWORK TYPE DEPTH HEIGHT WIDTH WINDOW TYPE SIGNAGE TYPE	( B)	1       2       GRID REFERENCE MARK         A1 Starts at lower left       corner Number Horizontal         Letters Vertical         1       BUILDING SECTION         A101       BUILDING SECTION         A101       BUILDING SECTION         SIM       BUILDING SECTION         A101       BUILDING SECTION         SIM       BUILDING SECTION         A101       SHEET WHERE DRAWN         1       DETAIL         A101       SHEET WHERE DRAWN         A101       EXTERIOR ELEVATION         SHEET WHERE DRAWN       SHEET WHERE DRAWN         1       SHEET WHERE DRAWN         1       INTERIOR ELEVATION         SHEET WHERE DRAWN       SHEET WHERE DRAWN         2       DOOR NUMBER         1       INTERIOR WALL TYPE         CORE MATERIAL       CORE THICKNESS         FIRE RATING, IF NEEDED       HEIGHT & STC         QUALIFIER, IF NEEDED       HEIGHT & STC         3.1 A.X       QUALIFIER, IF NEEDED         12/133       THICKNESS (MIL), IF OTHER         14/1733       THICKNESS (MIL), IF OTHER         15/10       STUD SPACING, IF OTHER THAN 16" OC <td>TRAFFIC AREAS. 9. DEBRIS SHALL BE REMOVED FROM SITE ID DEMOLISHED OR REMOVED EXISTING MATER CONTRACTOR, UNLESS OTHERWISE NOTED. 10. SUPPORT AND PROTECT EXISTING CELLIN INTERCOM SYSTEMS DURING CONSTRUCTION 11. CONTRACTOR SHALL NOT SCALE DRAWIN CONTRACTORS REQUIRING DIMENSIONS NOT SUCH INFORMATION PRIOR TO PROCEEDING 12. ASBESTOS TESTING SHALL BE DONE ON REMODEL. INCLUDING BUT NOT LIMITED TO: INSULATION, ETC., CONTRACTOR TO PERFOR 13. COORDINATE OPTIMAL WORKING HOURS OPERATIONAL NATURE OF THIS FACILITY. 14. A LEGIBLE FULL SET OF APPROVED PLAN INSPECTIONS. VICINITY MAP VICINITY MAP VICINITY MAP VICINITY INFORMATION INFORMATION FIGURA OF THIS FACILITY INFORMATION OF THIS</td>	TRAFFIC AREAS. 9. DEBRIS SHALL BE REMOVED FROM SITE ID DEMOLISHED OR REMOVED EXISTING MATER CONTRACTOR, UNLESS OTHERWISE NOTED. 10. SUPPORT AND PROTECT EXISTING CELLIN INTERCOM SYSTEMS DURING CONSTRUCTION 11. CONTRACTOR SHALL NOT SCALE DRAWIN CONTRACTORS REQUIRING DIMENSIONS NOT SUCH INFORMATION PRIOR TO PROCEEDING 12. ASBESTOS TESTING SHALL BE DONE ON REMODEL. INCLUDING BUT NOT LIMITED TO: INSULATION, ETC., CONTRACTOR TO PERFOR 13. COORDINATE OPTIMAL WORKING HOURS OPERATIONAL NATURE OF THIS FACILITY. 14. A LEGIBLE FULL SET OF APPROVED PLAN INSPECTIONS. VICINITY MAP VICINITY MAP VICINITY MAP VICINITY INFORMATION INFORMATION FIGURA OF THIS FACILITY INFORMATION OF THIS
A 1 01 (ACT1) (ACT1	MHTN SHEET NUMBER Sheet Number Sequencce Sheet Type Discipline CEILING TYPE TAG (1) CEILING TAG SPOT ELEVATION VERTICAL ELEVATION NORTH ARROW PLAN NORTH TRUE NORTH TRUE NORTH DRAWING REVISION NUMBER ROOM NAME ROOM NAME ROOM NUMBER ROOM NUMBER ROOM VOLUME / AREA KEYED NOTES CASEWORK TYPE DEPTH HEIGHT WIDTH WINDOW TYPE SIGNAGE TYPE	( B)	1       2       GRID REFERENCE MARK A1 Starts at lower left corner Number Horizontal Letters Vertical         1       1       BUILDING SECTION SHEET WHERE DRAWN         1       NM       BUILDING SECTION SHEET WHERE DRAWN         1       NM       MALL SECTION SHEET WHERE DRAWN         1       NM       DETAIL SHEET WHERE DRAWN         1       DETAIL SHEET WHERE DRAWN         1       DETAIL SHEET WHERE DRAWN         1       SIM DETAIL SHEET WHERE DRAWN         1       SIM SHEET WHERE DRAWN         1       SHEET WHERE DRAWN         1       SHEET WHERE DRAWN         1       SHEET WHERE DRAWN         1       SHEET WHERE DRAWN         1       INTERIOR ELEVATION SHEET WHERE DRAWN         1       INTERIOR ELEVATION SHEET WHERE DRAWN         1       INTERIOR WALL TYPE         0OOR NUMBER       INTERIOR WALL TYPE         1       CORE MATERIAL CORE THICKNESS FIRE RATING, IF NEEDED THICKNESS (MIL), IF OTHER THAN 30 MIL (20 GA) STUD SPACING, IF OTHER THAN 16" OC         2       EXTERIOR WALL TYPE ROOF TYPE	TRAFFIC AREAS. 9. DEBRIS SHALL BE REMOVED FROM SITE ID EMOLISHED OR REMOVED EXISTING MATER CONTRACTOR, UNLESS OTHERWISE NOTED. 10. SUPPORT AND PROTECT EXISTING CELLIN INTERCOM SYSTEMS DURING CONSTRUCTION 11. CONTRACTOR SHALL NOT SCALE DRAWIN CONTRACTORS REQUIRING DIMENSIONS NOT SUCH INFORMATION PRIOR TO PROCEEDING 12. ASBESTOS TESTING SHALL BE DONE ON REMODEL. INCLUDING BUT NOT LIMITED TO: INSULATION, ETC., CONTRACTOR TO PERFOR 13. COORDINATE OPTIMAL WORKING HOURS OPERATIONAL NATURE OF THIS FACILITY. 14. A LEGIBLE FULL SET OF APPROVED PLAN INSPECTIONS. VICINITY MAP VICINITY MAP VICINITY MAP VICINITY INFORMATION INFORMATION ENTRY INFORMATION
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### SLCDA NATIONAL WEATHER SERVICE TI SALT LAKE INTERNATIONAL AIRPORT SALT LAKE CITY, UTAH

### **CONSTRUCTION DOCUMENTS - BID SET** MAY 02, 2024


RAL NOTES	PROJECT DATA	INDE
SUBMITTING A BID OR PROCEEDING WITH ANY PORTION OF THE WORK, THE R SHALL VERIFY ALL DIMENSIONS & EXISTING CONDITIONS AT THE SITE AND VERIFY SIONS AND FINISHES COMPLY WITH THE CONTRACT DOCUMENTS. IF ANY VARIANCE IS , THE CONTRACTOR SHALL NOTIFY THE AIRPORT ARCHITECT IMMEDIATELY AND IN E ABSENCE OF SUCH NOTIFICATION WILL BE CONSTRUED AS AN ACCEPTANCE OF THE AND LATER CLAIMS OF DEFECTS WILL NOT BE CONSIDERED.	APPLICABLE CODES International Building Code, including Appendix J (IBC), 2021 ed. International Mechanical Code (IMC), 2021 ed.	GENE G000 G001 G101
AND LATER CLAIMS OF DEFECTS WILL NOT BE CONSIDERED. ATCH EXISTING BUILDING CONSTRUCTION AS REQUIRED. CUTTING AND DRILLING OF MEMBERS NOT DETAILED REQUIRES THE WRITTEN PERMISSION OF THE STRUCTURAL	International Plumbing Code (IPC), 2021 ed. National Electrical Code (NEC), 2020 ed. International Energy Conservation Code (IECC), 2021 ed.,	G200 CIVIL
R QUESTIONS ARISE OR CONDITIONS ARE ENCOUNTERED WHICH ARE NOT COVERED BY ONFLICT WITH THE CONTRACT DOCUMENTS, CONSULT WITH THE ARCHITECT PRIOR TO FURTHER ACTION.	International Existing Building Code (IEBC), 2021 ed., Prescriptive/Work Area/Performance International Fire Code (IFC), 2021 ed. International Fuel Gas Code (IFGC), 2021 ed. ICC/ANSI A117.1, 2017 ed.	C000 C100 C200
LISHED OR REMOVED EXISTING MATERIAL SHALL BE LEGALLY DISPOSED OF BY THE R, UNLESS OTHERWISE NOTED.	CRITERIA	C500
TERIAL NOTED TO BE RETURNED TO THE OWNER SHALL BE REMOVED FROM THE SITE BY CONTRACTOR SHALL COORDINATE WITH THE OWNER	Occupancy Classification B - No Change in occupancy	ARCH
TRUCTION ACTIVITY IS TO BE CONTAINED WITHIN CONSTRUCTION AREA. CONTRACTOR ECT ALL EXISTING SURFACES, EQUIPMENT, ETC. DURING DEMOLITION AND ON. AFTER WORK OF THIS CONTRACT, AND PER PHASE (OR DAILY) AS APPLIES, THE R SHALL CLEAN AND RETURN TO ACCEPTABLE CONDITION EXISTING AREAS EFFECTED & TO THE OWNER'S SATISFACTION.	Separation of Occupancies Non-separated Construction Type V-B	AD10 AD70
FOR SHALL REPAIR OR REPLACE ANY DAMAGE TO ADJOINING SURFACES OR AREAS NOT S CONTRACT AT NO COST TO THE OWNER. MATCH EXISTING SURFACE FINISH OR	Construction Type V-B Sprinkled No	ARCH A101
A SAFE AND CLEAR ACCESS WAY AT ALL TIMES THRU CORRIDOR AREAS AND MAIN AS.	Building Area/Height Allowable Height (Stories/Feet) 2 / 40 ftAllowable Height (Stories/Feet) 2 / 40 ft	A101A A101E A410
HALL BE REMOVED FROM SITE DAILY OR AS DIRECTED BY THE PROJECT MANAGER. ALL OR REMOVED EXISTING MATERIAL SHALL BE LEGALLY DISPOSED OF BY THE R, UNLESS OTHERWISE NOTED.	Actual Building Height (Stories/Feet) 1 / 20 ft	A411 A412 A413
AND PROTECT EXISTING CEILINGS, SIGNAGE, FIRE ALARM SYSTEMS, SOUND AND (STEMS DURING CONSTRUCTION, UNLESS OTHERWISE NOTED.	1st Floor (Area of Work) 6,466 s.f. 1st Floor (Total) 13,044 s.f.	<b>A</b> 414
TOR SHALL NOT SCALE DRAWINGS. WRITTEN DIMENSIONS SHALL ALWAYS GOVERN. RS REQUIRING DIMENSIONS NOT NOTED SHALL CONTACT THE PROJECT MANAGER FOR MATION PRIOR TO PROCEEDING WITH THE WORK.	Allowable Building Area Calculation Not Applicable (Existing building with no increase in square footage and no change in Occupancy) Building Perimeter (P) x	A415 A416 A417
S TESTING SHALL BE DONE ON ALL BUIDING FINISHES WHERE IMPACTED BY DEMO AND ICLUDING BUT NOT LIMITED TO: CEILING TILES, RESLIENT TILE FLOORING, PIPE ETC., CONTRACTOR TO PERFORM TESTING AND REPORT RESULTS TO OWNER.	Building Perimeter on 20' min Public Way (F) x Width of Public Way or Open Space (W) x Weighted Average W = (L1xw1 + L2xw2 + L3xw3)F =	A418 A419 A430
ATE OPTIMAL WORKING HOURS AND AREA PHASING WITH OWNER DUE TO 24/7	Frontage Increase If = $(F/P - 0.25)W/30 = (.75 is the maximum value)$	A600
E FULL SET OF APPROVED PLANS AND DOCUMETNS IS REQUIRED TO BE ON-SITE FOR	Single Occupancy, One Story At = 9,000 s.f. NS = 9,000 s.f. Allowable Area Aa = 15,039 s.f. = At + (NS x lf) = (.61) - 9,000 + (9,000 x .67) If = (F/P-0.25)W/30 = (448/523 - 0.25) $33/30 = (.61)x1.1 = .67$ W = (76'x12' + 42'x80' + 34'x160' + 120'x189' + 76'x65' + 42'x100' + 50'x90' + 100'x110') / 448' = 100	A610 A640 A651 A701 A702
	Scope of Work Description	MECH MD10 M101
	Livil 1. A new driveway from the existing roadway for light duty delivery trucks.	M401
Y MAP	Structural	M501 M601
httled Map He a description for your max	Architectural <ol> <li>New finishes throughout the 6,466 SF.</li> <li>Demolition and installation of new millwork in Break Room 109</li> <li>Demolition of existing an existing door and installation of new door in WCM Office 104,</li> <li>Converting existing closet to storage</li> <li>Converting the existing storage into 3 spaces (Quite Room 127, Corridor 126, Training/Office 128, and Storage 129).</li> <li>Demolition and installation of new toilet partitions.</li> <li>New Shower Room 110</li> </ol>	PD10 <sup>7</sup> P101 P401 P501 ELEC EG00 <sup>7</sup> ED10 <sup>7</sup> EL101
	Mechanical/Plumbing 1. Demolition and installation of new plumbing fixtures Mens Restroom 122 and Womens	EL501 EL601 EP10 <sup>2</sup>
	restroom 118. 2. Demolition and installation of new sink and faucet in Break Room 109. 3. Demolition of wall mounted humidifiers 4. Demolition and installation of new drinking fountain.	EP501
	5. Installation of accessible shower.	
NAME, TITLE DATE:	Electrical  1. Added power and data in specified locations.  2. Relocated light switches in specified locations.	)
NAME, TITLE DATE:		)
NAME, TITLE DATE:	_ ····································	



MHTN ARCHITECTS **MHTN Architects, Inc** 280 South 400 West Suite 250 Salt Lake City, Utah 84101

Telephone (801) 595-6700 www.mhtn.com

GENERAL	O DRAWINGS -CONSTRUCTION DOCUMENTS - BID SET			
GENERAL G000	COVER SHEET			
G001	INDEX SHEET			⊢
G101	FIRST FLOOR LIFE SAFETY PLAN			Ĭ
G200	MOUNTING HEIGHTS & CLEARANCES			AIRPORT
CIVIL			出	AIF
C000	CIVIL DEMOLITION PLAN		Ē	Ļ
C100	SITE PLAN			<b>₹</b>
C200 C500	GRADING & DRAINAGE PLAN DETAILS		Ц	TERNATIONAL TY, UTAH
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AD701	DEMOLITION RCP		żΰ	
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A101	FIRST FLOOR PLAN			
A101A A101B	FIRST FLOOR PLAN - AREA A FIRST FLOOR PLAN - AREA B			$\vdash$
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A412	INTERIOR ELEVATIONS		ARCHITECTS, INC.	
A413	INTERIOR ELEVATIONS	Confidentiality N This document is and companies i	otice: s intended for use on the Project identifie nvolved in the design, permitting, bidding	d herein by individuals and construction of the
A414	INTERIOR ELEVATIONS	Project. MHTN A this document fo	Architects, Inc. grants limited rights to dis or this express purpose only. Distribution, rposes other than those indicated is stric	tribute and reproduce printing or copying this
A415	INTERIOR ELEVATIONS	copy of this docu	ument is received in error, please delete it	t.
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A418	INTERIOR ELEVATIONS		1 States	1
A419 A430	INTERIOR ELEVATIONS DETAILS		ROBERTO G.	18000
A430 A600	DOOR, FRAME AND WALL TYPE SCHEDULE		PINON 6480267-0301	4840
A610	DOOR DETAILS		Eal Stand	se <sup>er</sup>
A640	FINISH SCHEDULE		SED ARCHI 1000	
A651	FIRST FLOOR PATTERN PLAN		19 Feb. 2024	
A701	REFLECTED CEILING PLAN			
A702	REFLECTED CEILING PLAN Copy 1		CT NO.2023573 D PRINT THIS DRAWING	IN COLOR
MECHANI	CAL / PLUMBING		is 24 x 36. Do not scale contents of this	drawing.
MD101	MECHANICAL DEMOLITION FLOOR PLAN	ISSUED: NO. DAT	E DESCRIPTION	
M101	MECHANICAL FLOOR PLAN	02 Nov	27, 2023 SCHEMATIC DESIGN 14, 2023 60% CONSTRUCTION D	
M401	ENLARGED MECHANICAL PLANS		15, 2023         90% CONSTRUCTION I           31, 2024         100% CONSTRUCTION	
M501	MECHANICAL SCHEDULES			
M601	MECHANICAL DETAILS		R TO VERIFY DRAWINGS IN FIELD U	ISE REFLECT
PD101	PLUMBING DEMOLITION FLOOR PLAN	LAST REVISIO	E DESCRIPTION	
P101 P401	PLUMBING FLOOR PLAN ENLARGED PLUMBING PLAN	4 Apr 1	16, 204 City Review Comments	
P501	PLUMBING SCHEDULES & DETAILS			
ELECTRIC	AL			
EG001	GENERAL NOTES AND SYMBOLS LIST			
ED101	DEMOLITION PLAN	SET	RUCTION DOCUMI	ENTS - BID
EL101	FLOOR PLAN - LIGHTING	MAY 02	. 2024	
EL501	DETAILS		, _0_ !	
EL601	SCHEDULES, DETAILS. AND WIRING DIAGRAMS			<b>—</b>
EP101 EP501	FLOOR PLAN - POWER AND SYSTEMS DETAILS		EX SHEE	
		G	001	

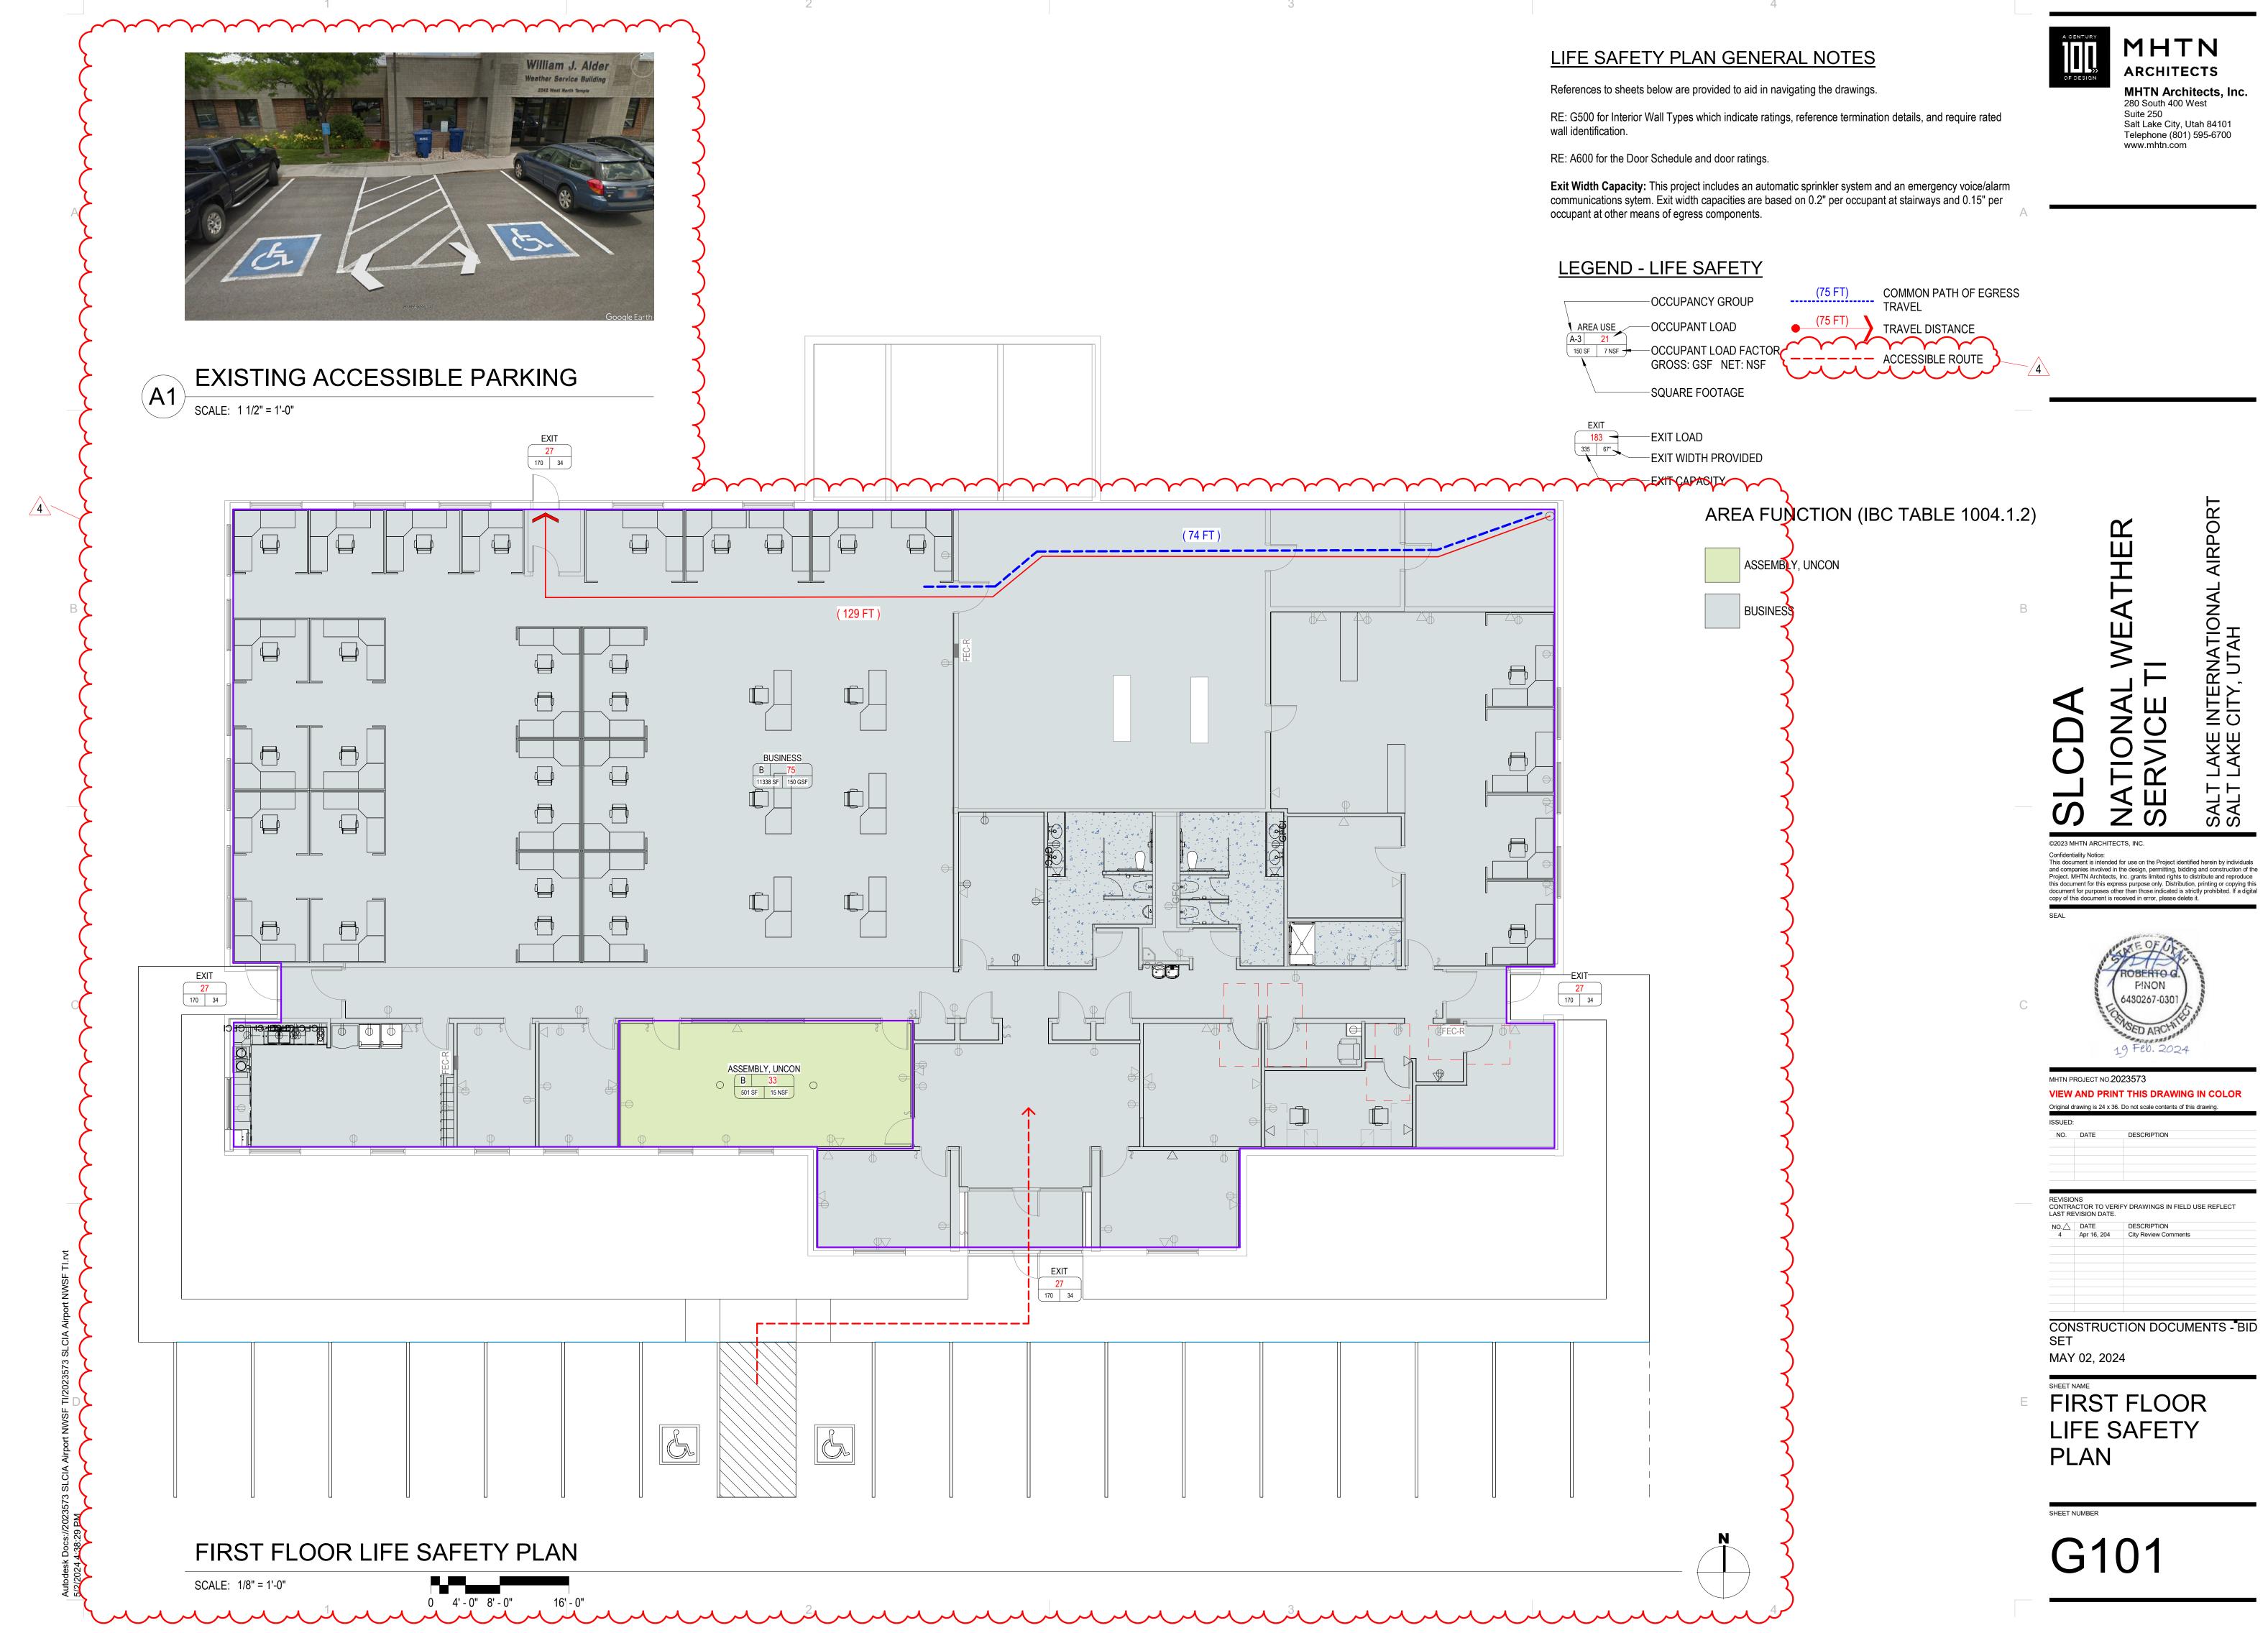



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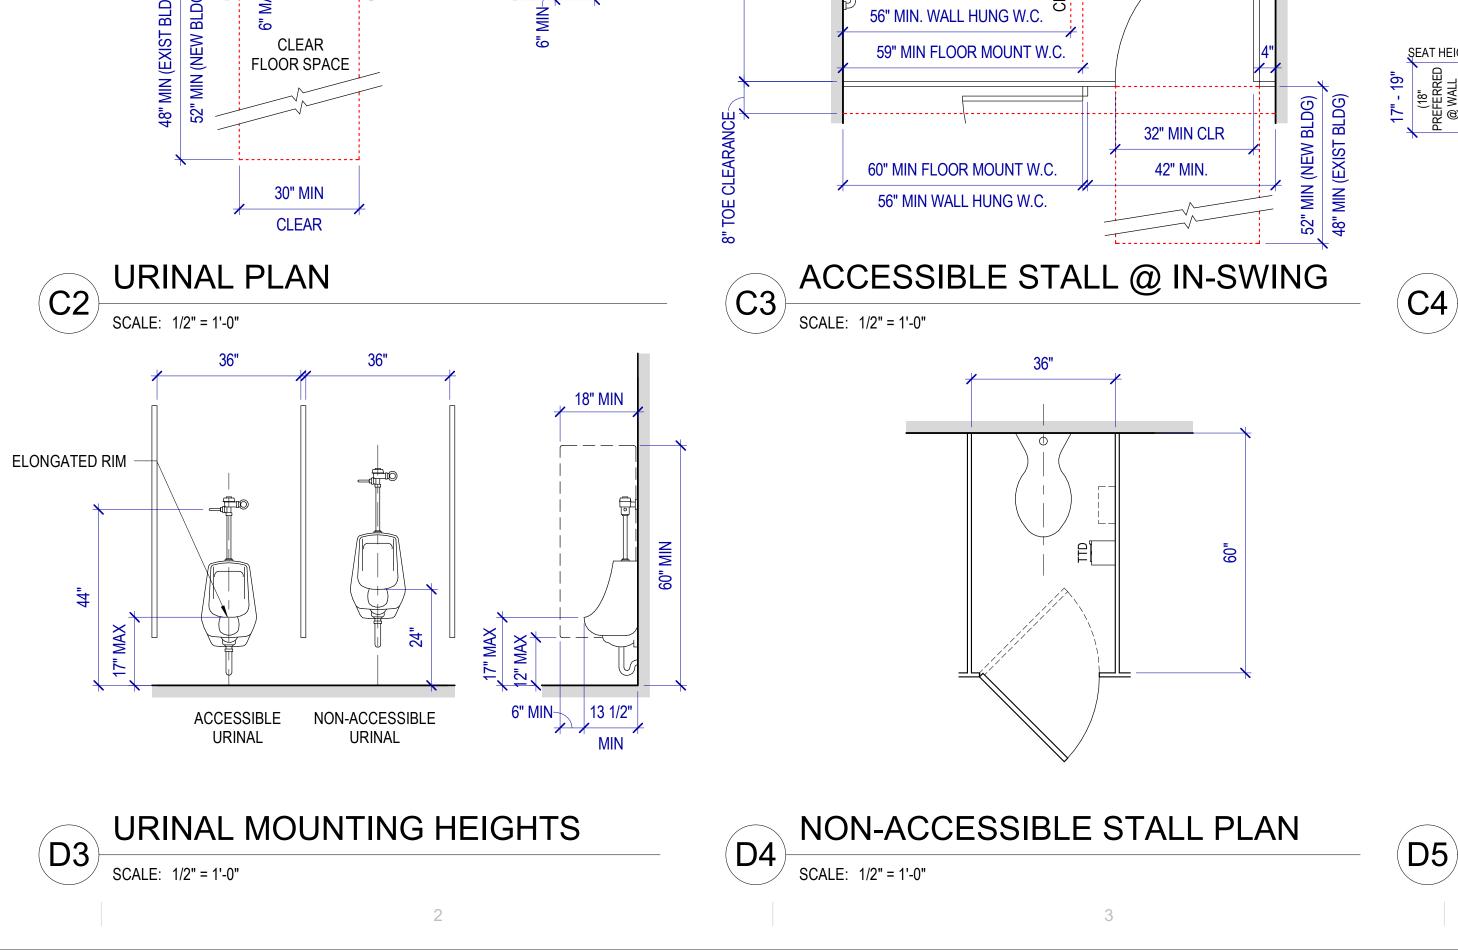
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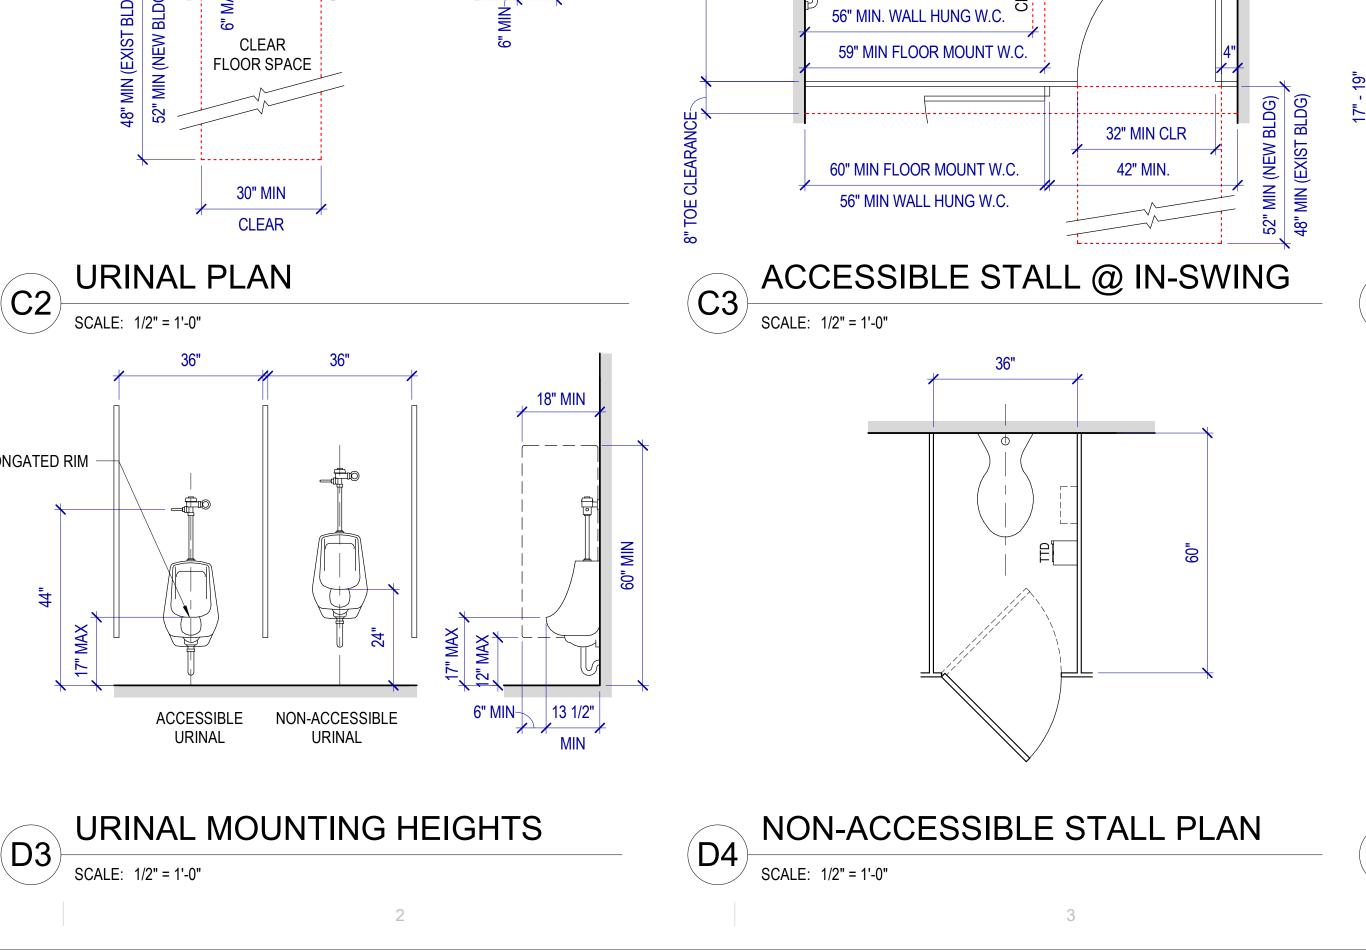
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36" <u>36</u>" ★ ★


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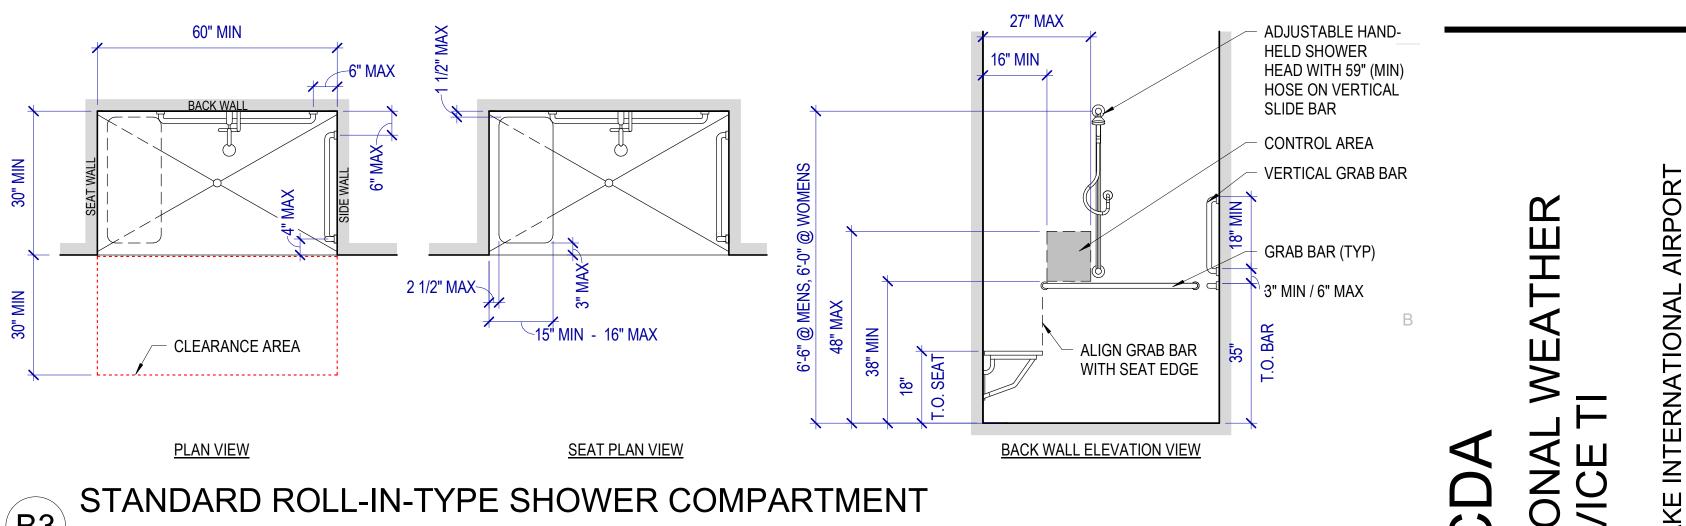




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### **MOUNTING HEIGHTS & CLEARANCES GENERAL NOTES**


Diagrams on this sheet incorporate the ADA Standard, 2010 edition and ICC/ANSI A117.1, 2009 edition requirements for accessibility. The most restrictive requirement is shown where the two standards differ.

The purpose of this sheet is to provide general clearance, size and mounting height dimensions. If other drawings provide different information, that doesn't violate the accessibility standards, that information shall govern, however, nothing shown herein shall supersede the requirement of the standards listed above, nor of the IBC.

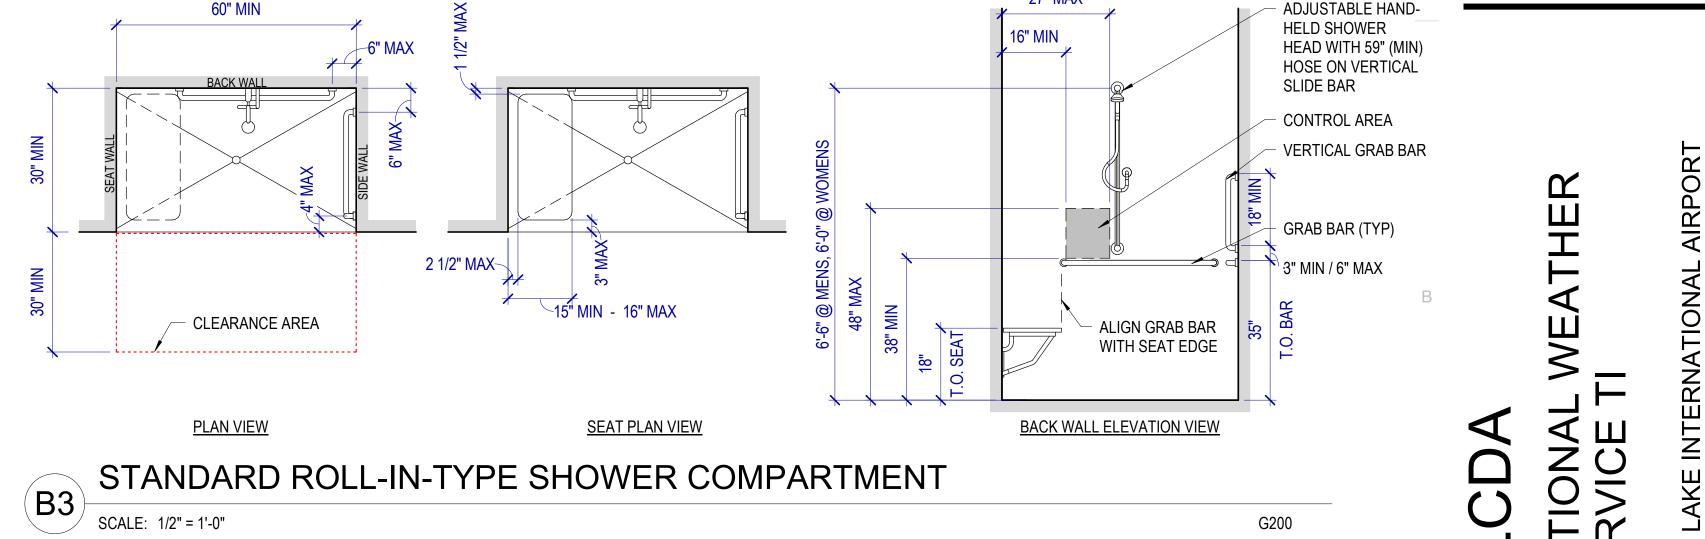Prior to installation, coordinate toilet and bath accessory mounting heights with manufacturer's recommended heights and adjust as required to comply with ADA & ANSI requirements.


Where the accessibility standards indicate ranges of dimensions, or minimum or maximum dimensions, the dimensions on this sheet have been modified to indicate the preferred or the most restrictive of the dimensions. Where it is impractical to comply with a dimension, the dimension may be adjusted after review with the Architect and, provided the proposed change does not violate the accessibility standards.

Dimensions shown herein indicate face of wall, floor, ceiling and other building elements.

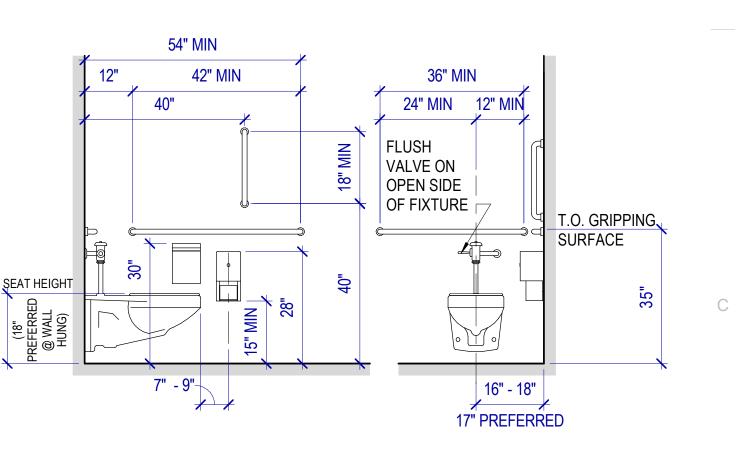

### ACCESSIBLE STALL MTG HEIGHTS

SCALE: 1/2" = 1'-0"

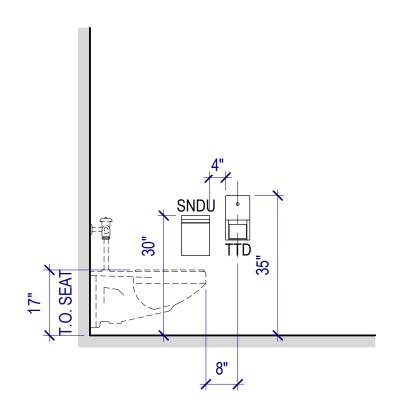

### D5 NON-ACC STALL MTG HEIGHTS

SCALE: 1/2" = 1'-0"




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ARCHITECTS MHTN Architects, Inc. 280 South 400 West Suite 250 Salt Lake City, Utah 84101 Telephone (801) 595-6700 www.mhtn.com

SALT LAKE INTERNATIONAL SALT LAKE CITY, UTAH NATIONAI SERVICE 5 ©2023 MHTN ARCHITECTS, INC Confidentiality Notice: This document is intended for use on the Project identified herein by individuals and companies involved in the design, permitting, bidding and construction of the Project. MHTN Architects, Inc. grants limited rights to distribute and reproduce this document for this express purpose only. Distribution, printing or copying this document for purposes other than those indicated is strictly prohibited. If a digital copy of this document is received in error, please delete it. SEAL PINON 6480267-0301 L9 FED. 2024 MHTN PROJECT NO.2023573 VIEW AND PRINT THIS DRAWING IN COLOR Driginal drawing is 24 x 36. Do not scale contents of this drawing. 
 NO.
 DATE
 DESCRIPTION

 01
 Oct 27, 2023
 SCHEMATIC DESIGN

 02
 Nov 14, 2023
 60% CONSTRUCTION DOCS
 Dec 15, 2023 90% CONSTRUCTION DOCS 4 Jan 31, 2024 100% CONSTRUCTION DOCS CONTRACTOR TO VERIFY DRAWINGS IN FIELD USE REFLEC LAST REVISION DATE. CONSTRUCTION DOCUMENTS - BID SET MAY 02, 2024 SHEET NAME MOUNTING HEIGHTS & CLEARANCES SHEET NUMBER G200

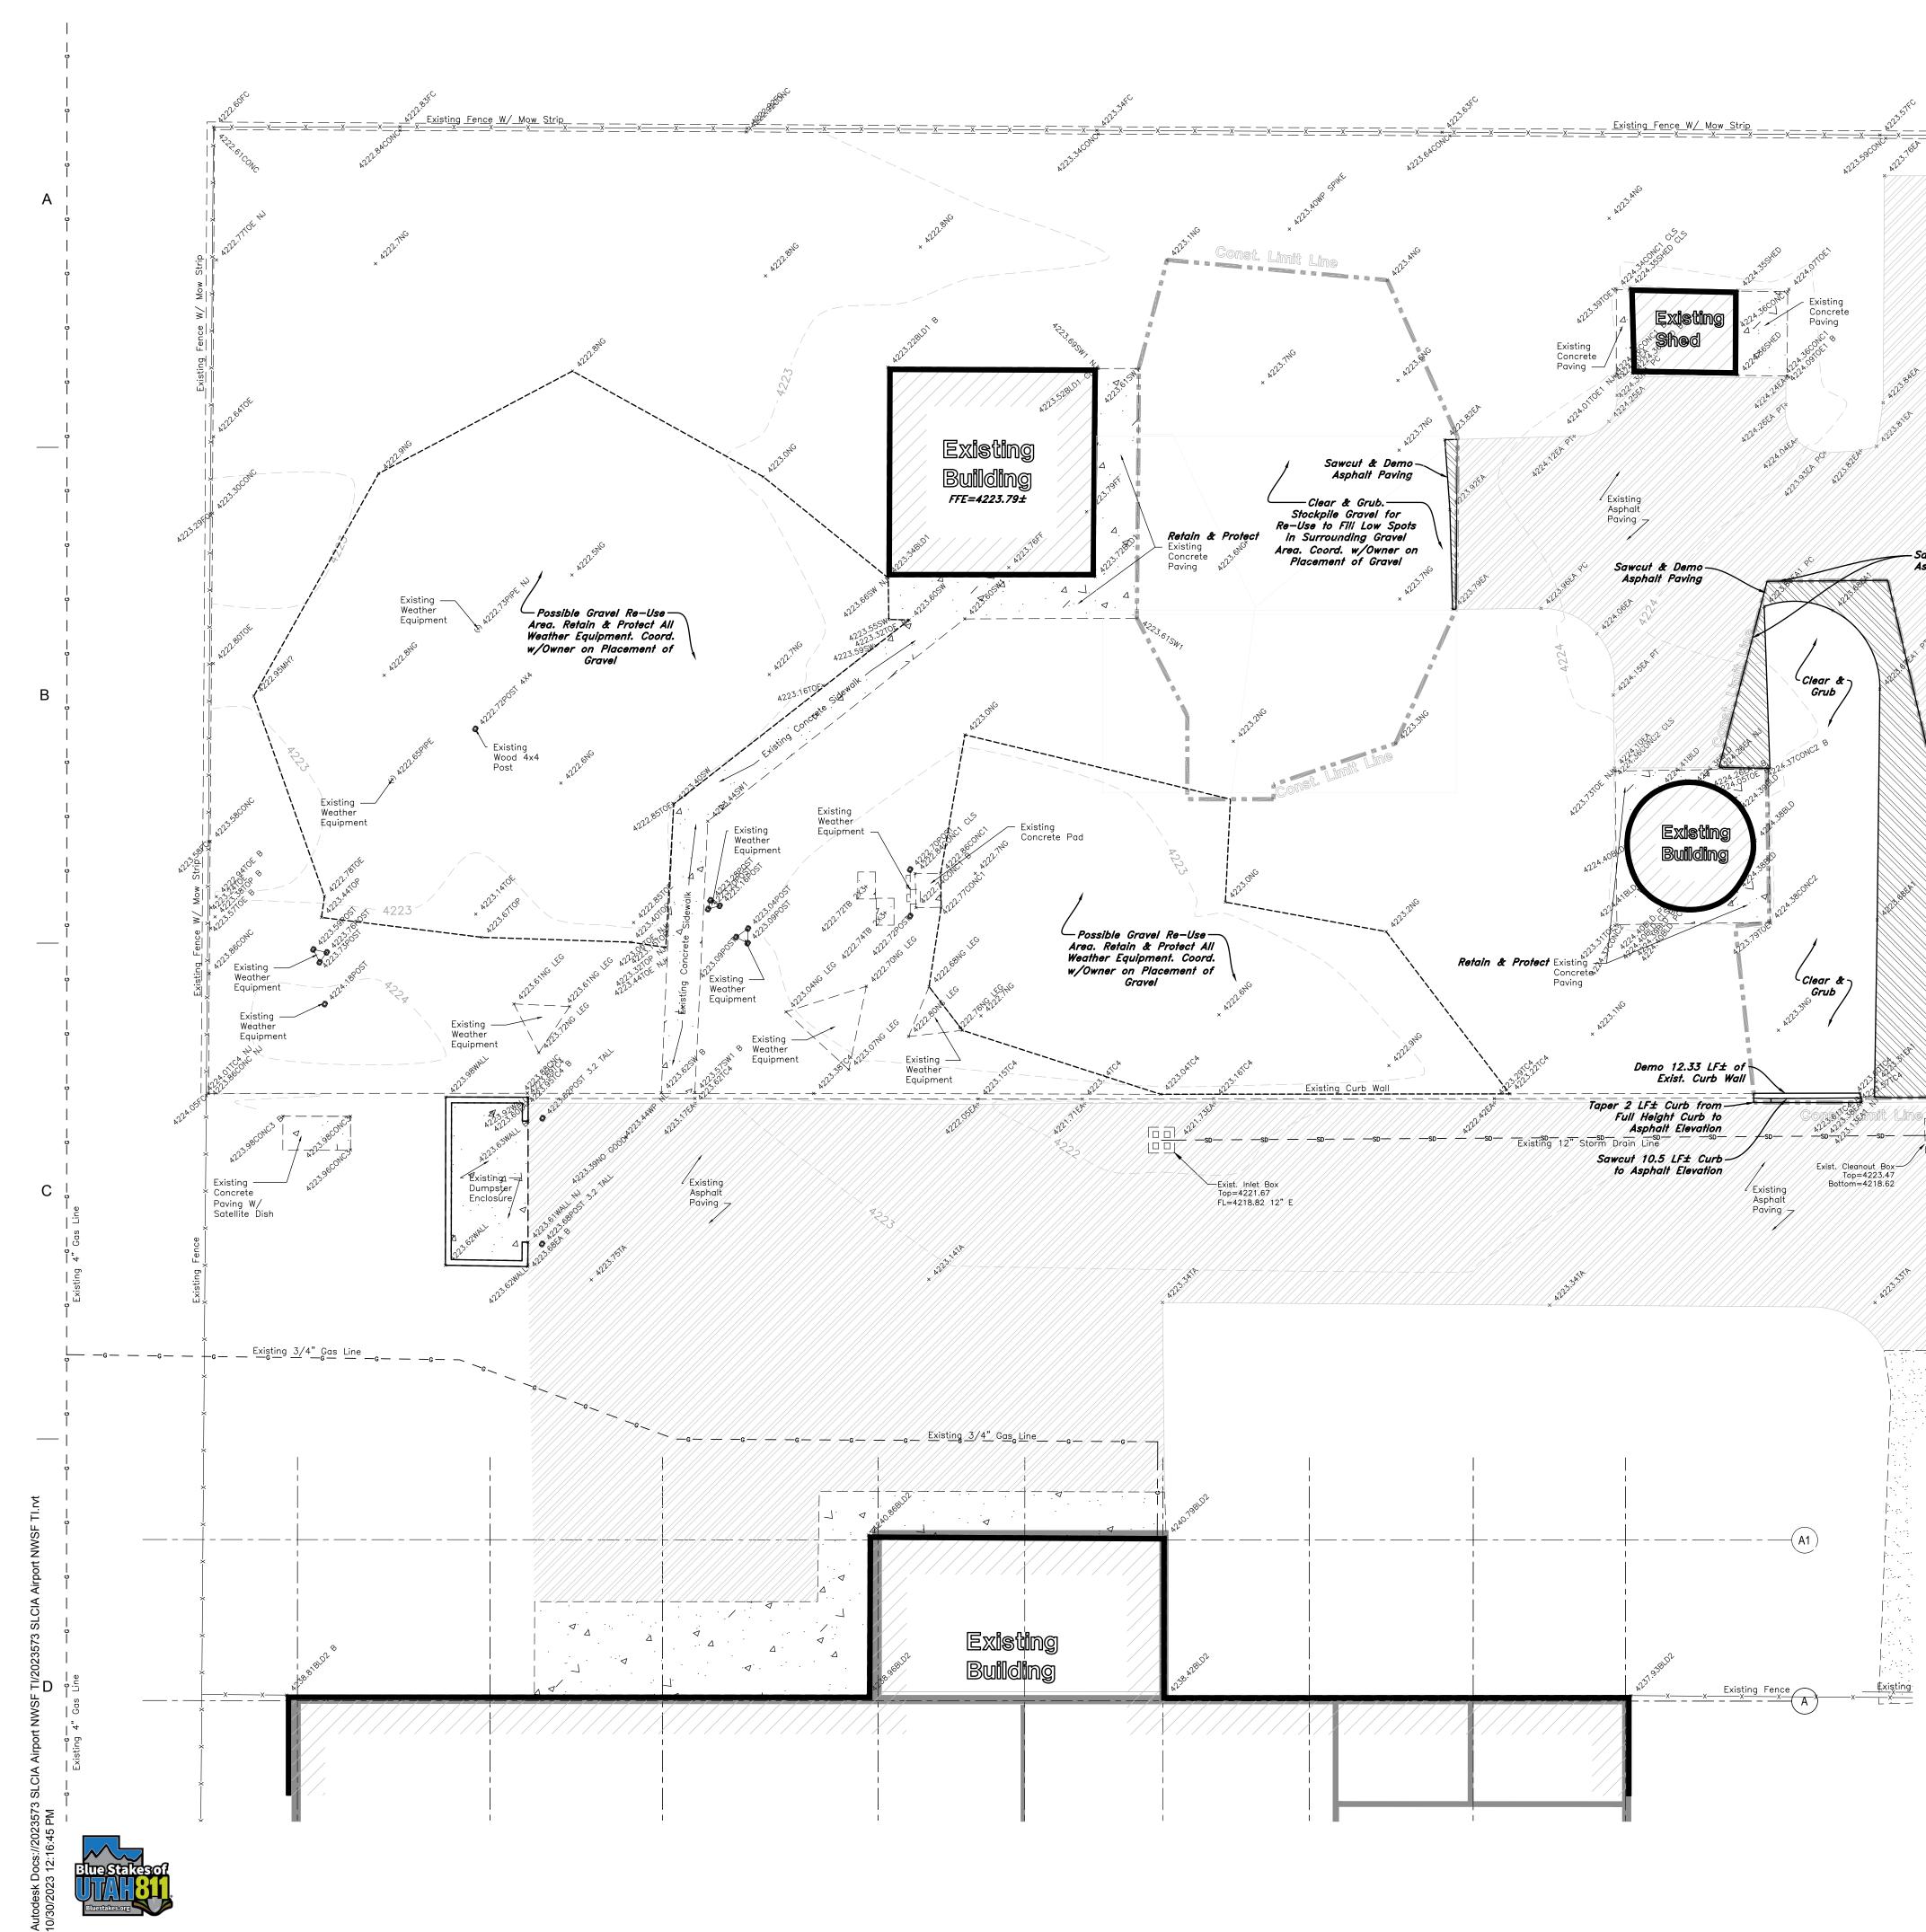

A/ /	CONSTRUCTION	το	CONFORM	то	CITY	STANDARDS		SPECIFICATIONS	IN	RIGHT	OF	WAY
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CAUTION NOTICE TO CONTRACTOR The contractor is specifically cautioned that the location and/or elevation of existing utilities as shown on these plans are based on records of the various utility companies and, where possible, measurements taken in the field. The information is not to be relied on as being exact or complete. The contractor must call the appropriate utility company at least 48 hours before any excavation to request exact field location of utilities. It shall be the responsibility of the contractor to relocate all existing utilities which conflict with the propose improvements shown on the plans.


- required for utility line removal. 11. Install traffic warning devices as needed in accordance with local standards. 12. Contractor shall obtain all permits necessary for demolition from City, County, State or Federal Agencies as required.
- an approved site for such material. Burning onsite is not permitted. 10. Contractor shall verify with city any street removal, curb cuts, and any restoration
- ways.

- Stockpiles shall be graded to maintain slopes not greater than 3 horizontal to 1 vertical. Provide erosion control as needed to prevent sediment transport to adjacent drainage

- 9. Contractor shall be responsible for disposal of all waste material. Disposal shall be at

- responsible for protection of in place and relocated utilities during construction.

- clearing operations from the site and dispose of in a legal manner. 7. The location and/or elevation of existing utilities as shown on these plans is based on records of the various utility companies and, where possible, measurements taken in the field. The information is not to be relied upon as being exact or complete. Contractor shall contact authorities having jurisdiction for field locations. Contractor shall be
- the demolition limits. 6. Remove debris, rubbish, and other materials resulting from the demolition and site
- retained and protected unless otherwise shown on the demolition plans. 4. Clear and grub trees, shrubs, and vegetation within construction limits, disposal to be off-site except where noted otherwise. 5. DO NOT interrupt any services or disrupt the operation of any businesses shown outside
- demolition limits or by note. 2. Refer to site improvement plans for more details on limits of removal. 3. All curbs, gutters, walks, slabs, walls, fences, flatwork, asphalt, waterlines and meters, gas lines, sewer lines, light poles, buried cables, storm drain piping and structures to be
- GENERAL DEMOLITION NOTES: 1. Demolition and site clearing for this contract are to include all areas shown within

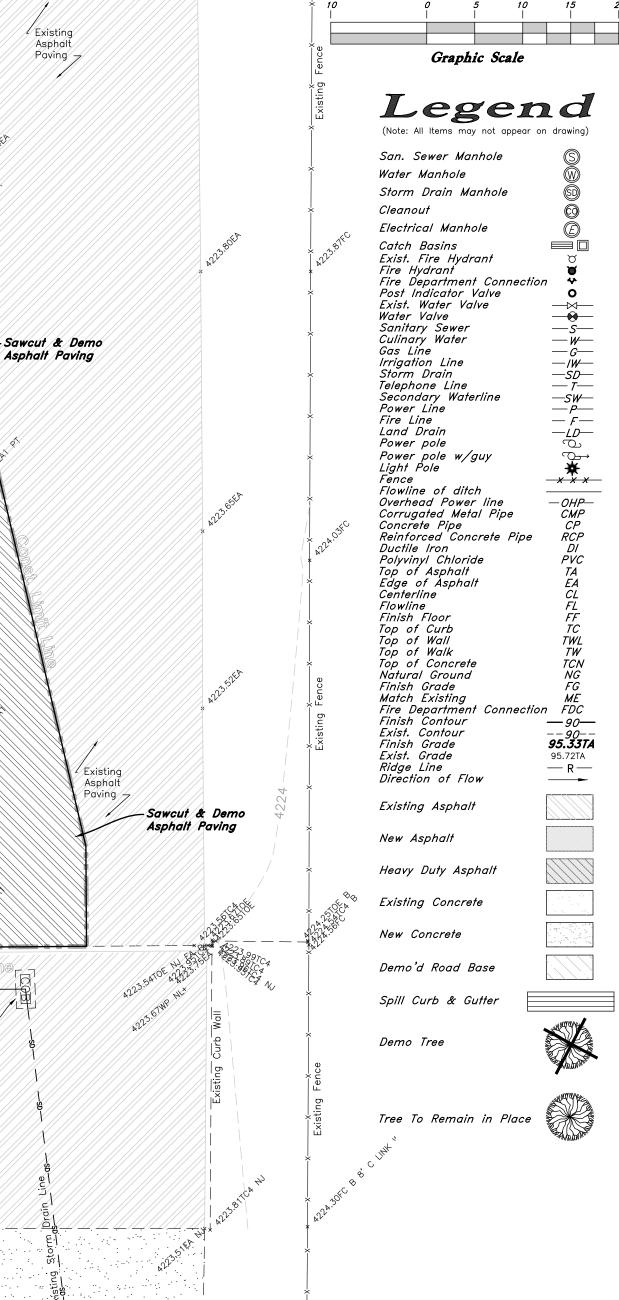

Scale: 1" = 10'

### GREAT BASIN 0 ENGINEERING 5746 SOUTH 1475 EAST - SUITE 200 Ogden, Utah 84403 Main (801)394-4515 S.L.C (801)521-0222 FAX 801-392-7544 WWW.GREATBASINENGINEERING.COM

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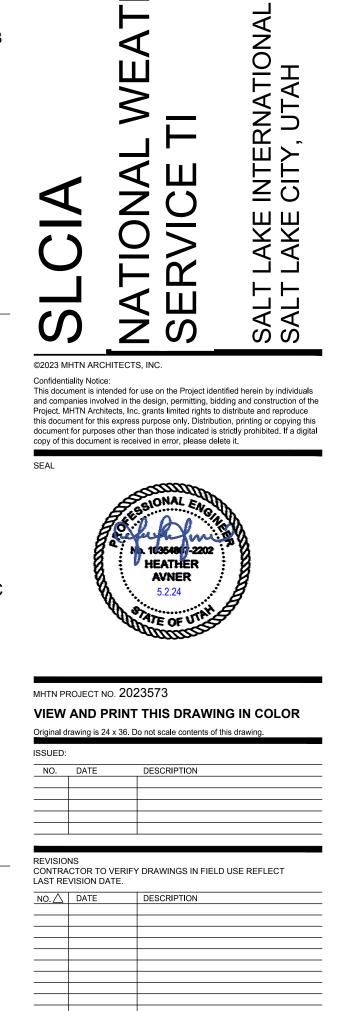
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Suite 250

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Salt Lake City, Utah 84101 Telephone (801) 595-6700




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May 02, 2024


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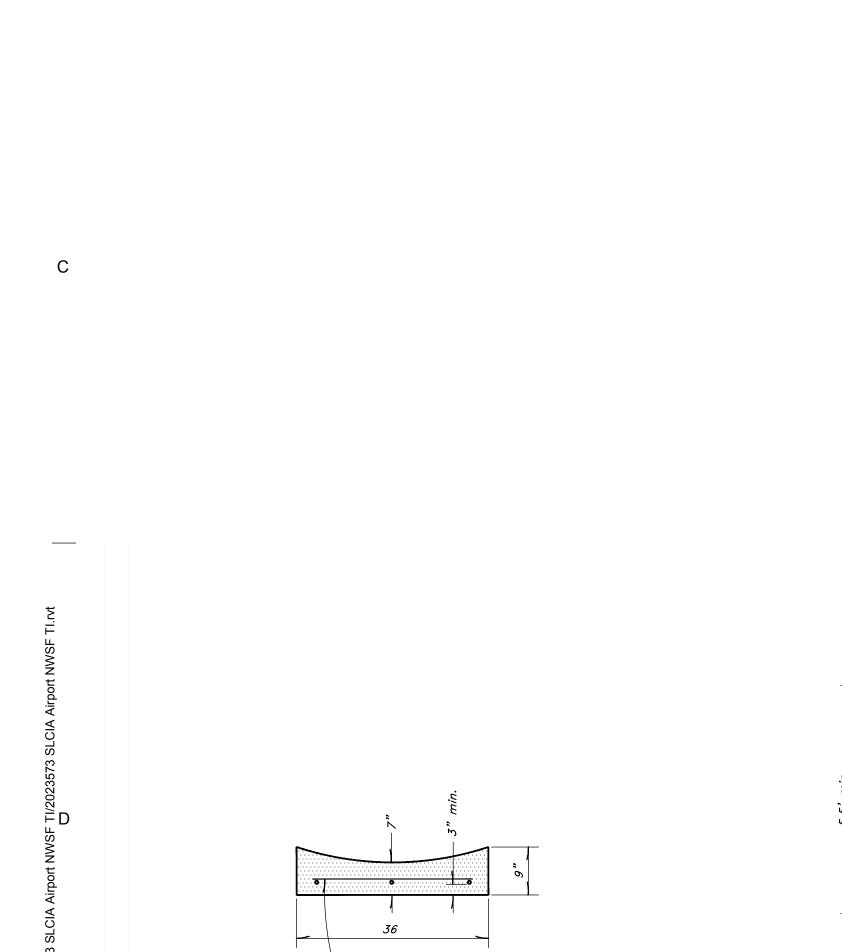
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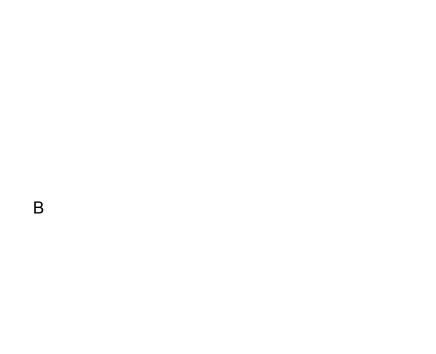
Construction Documents - Bid Set




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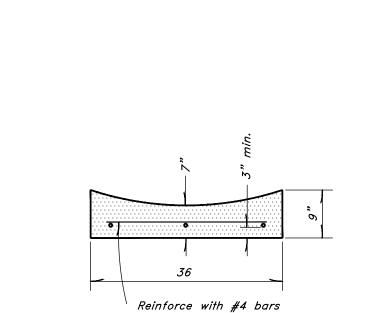


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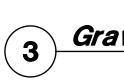


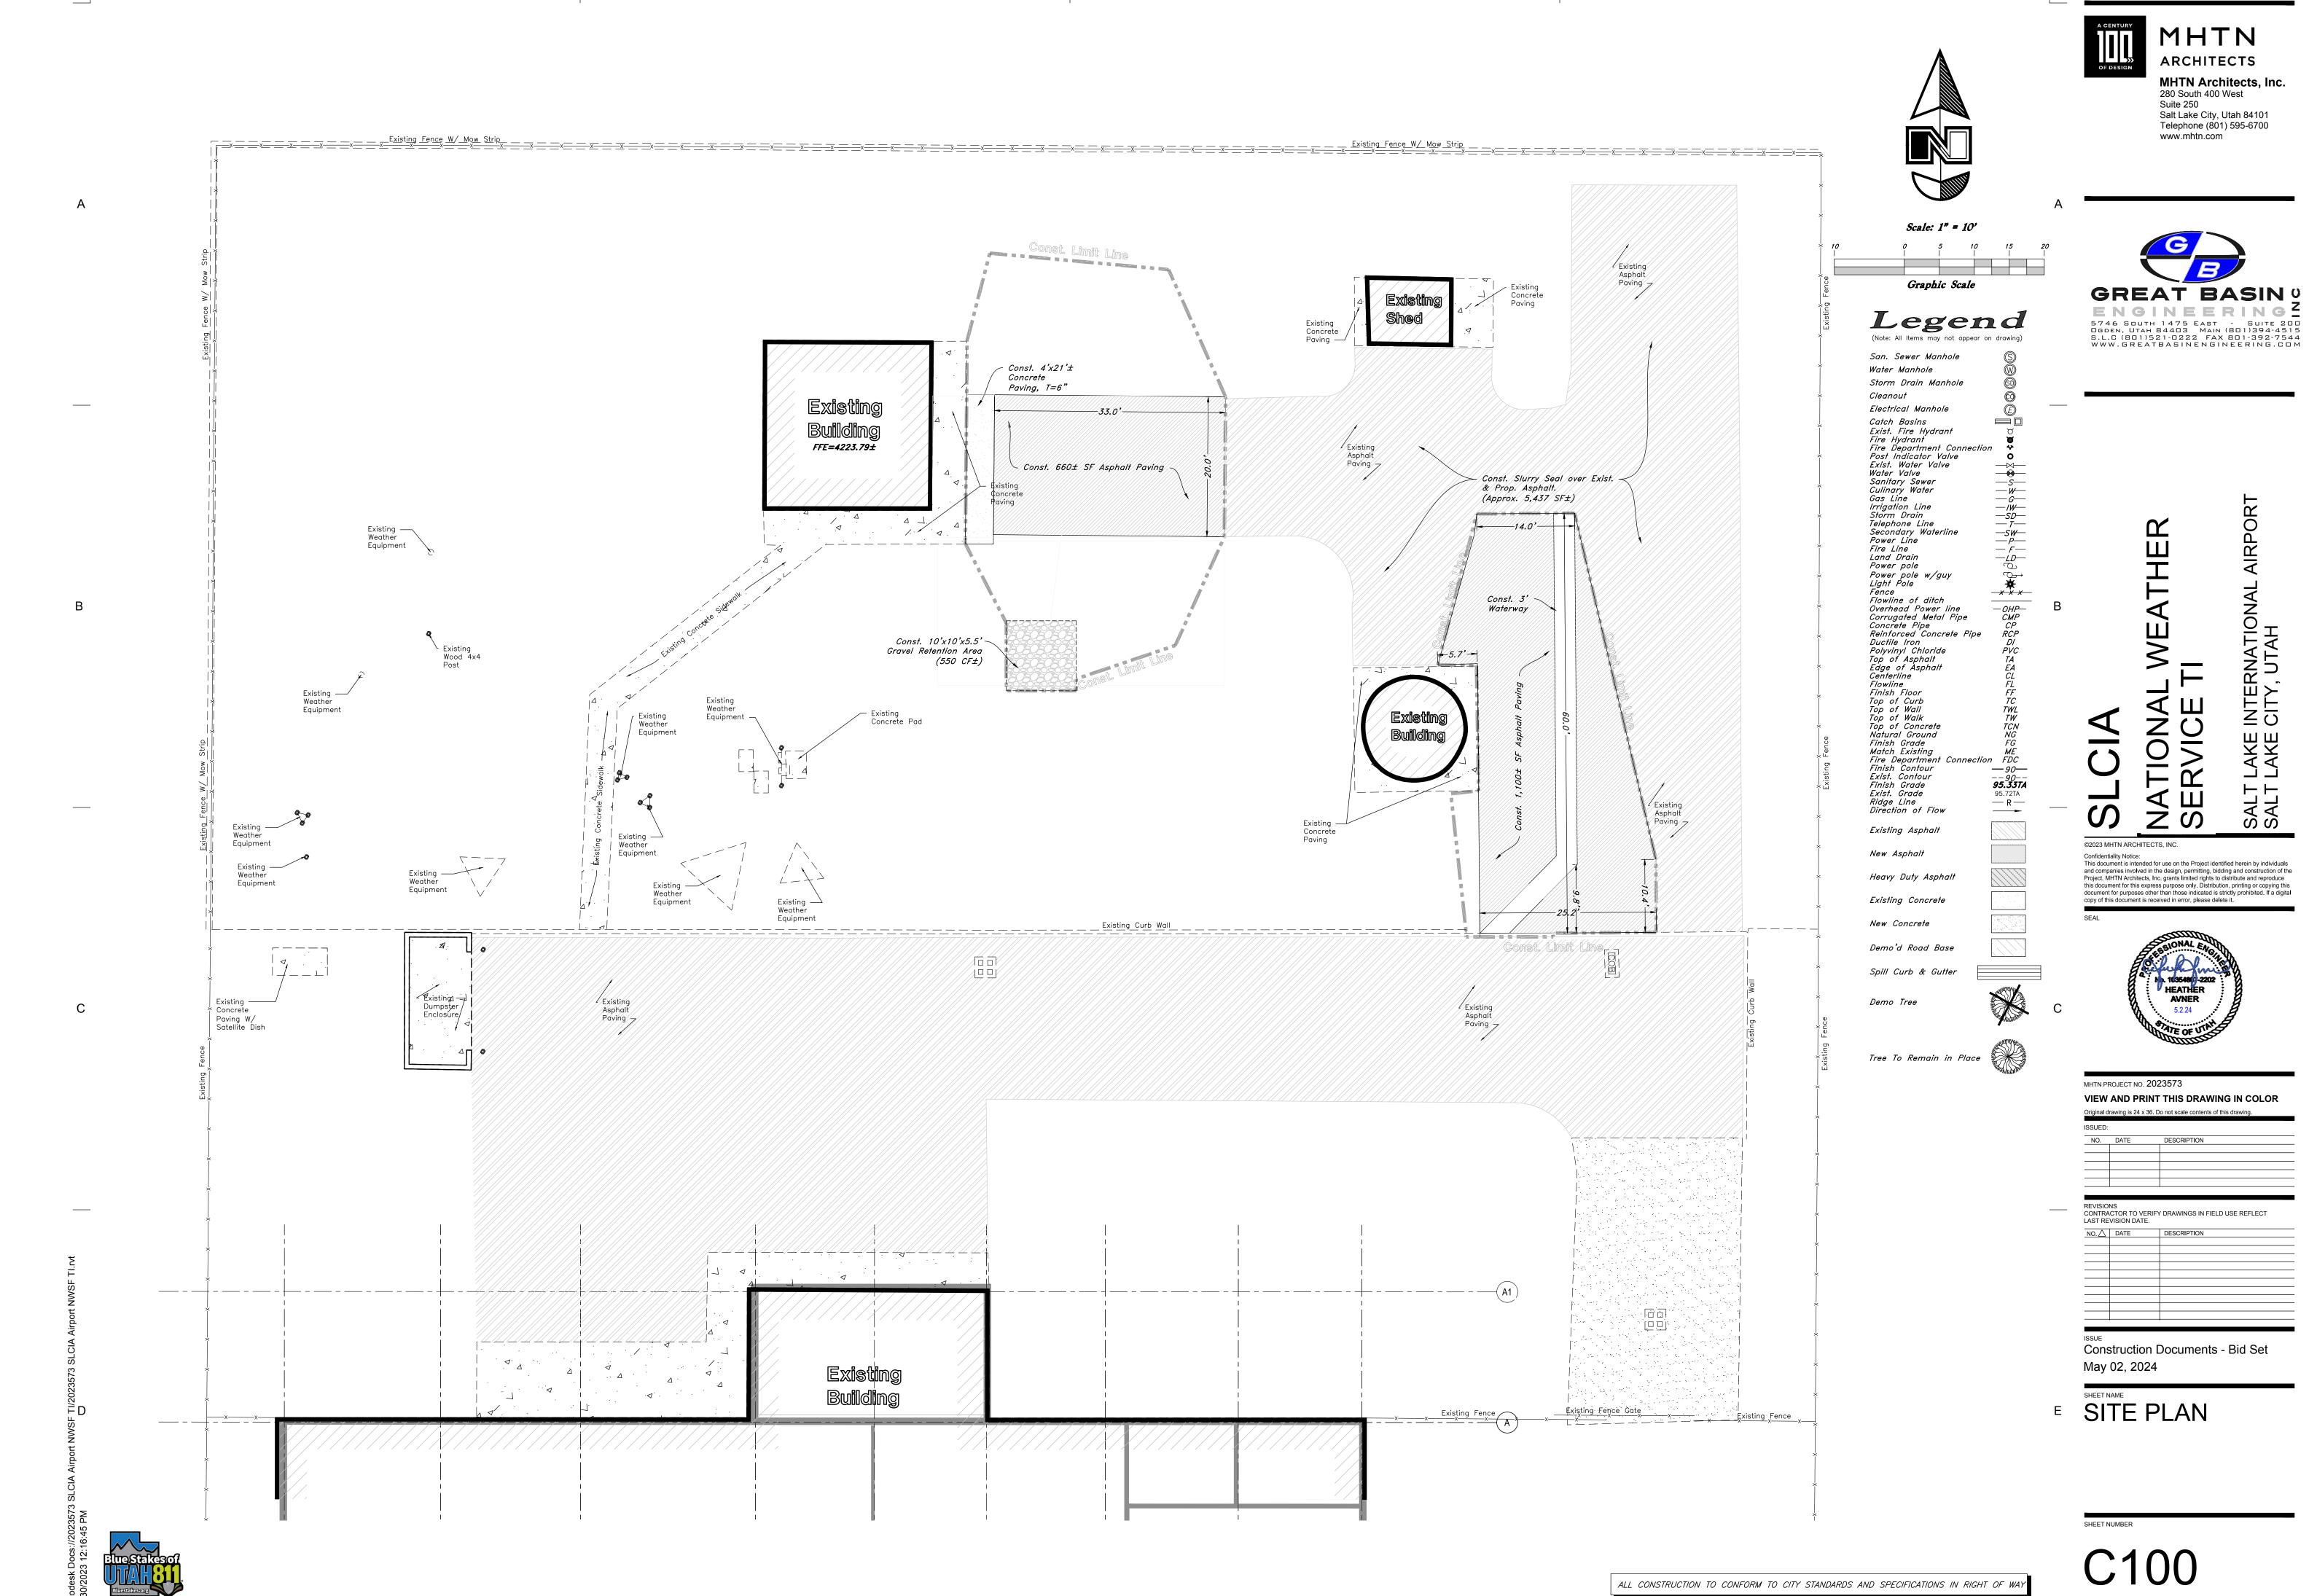Typical Waterway Detail NOT TO SCALE

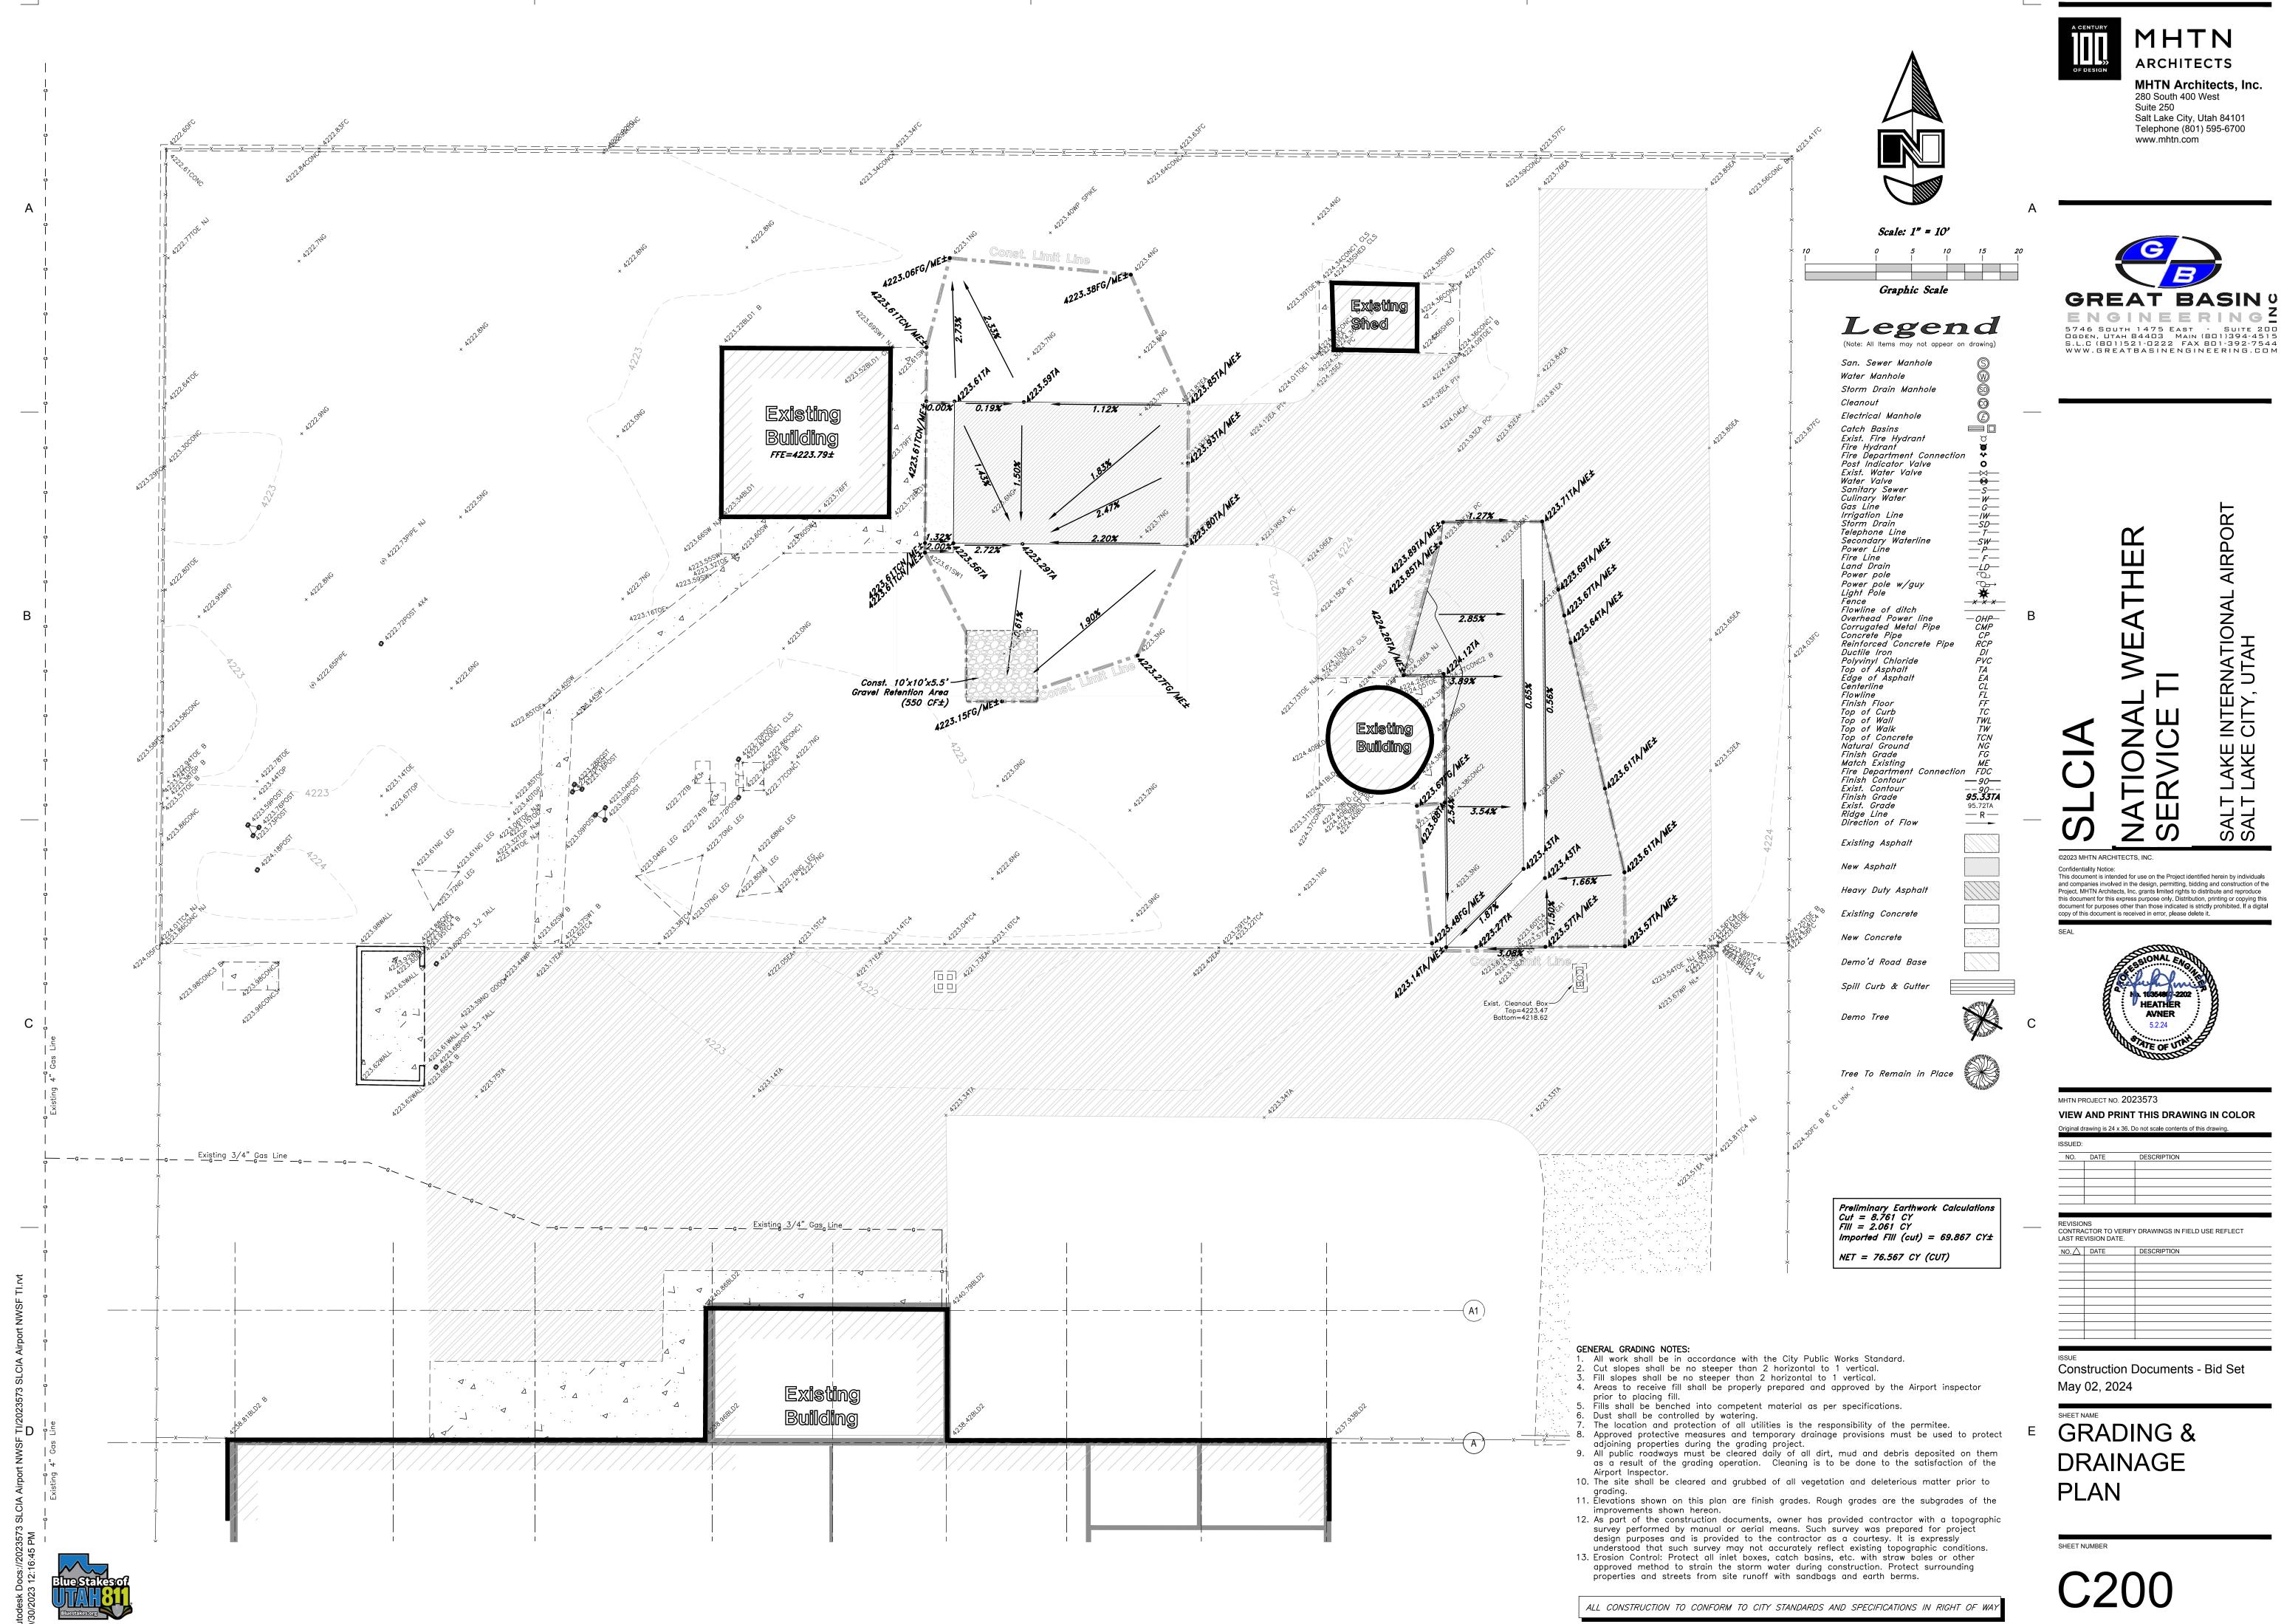@ 12" o.c. bothways
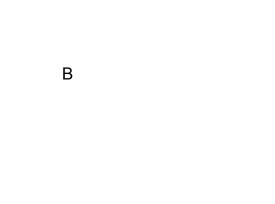
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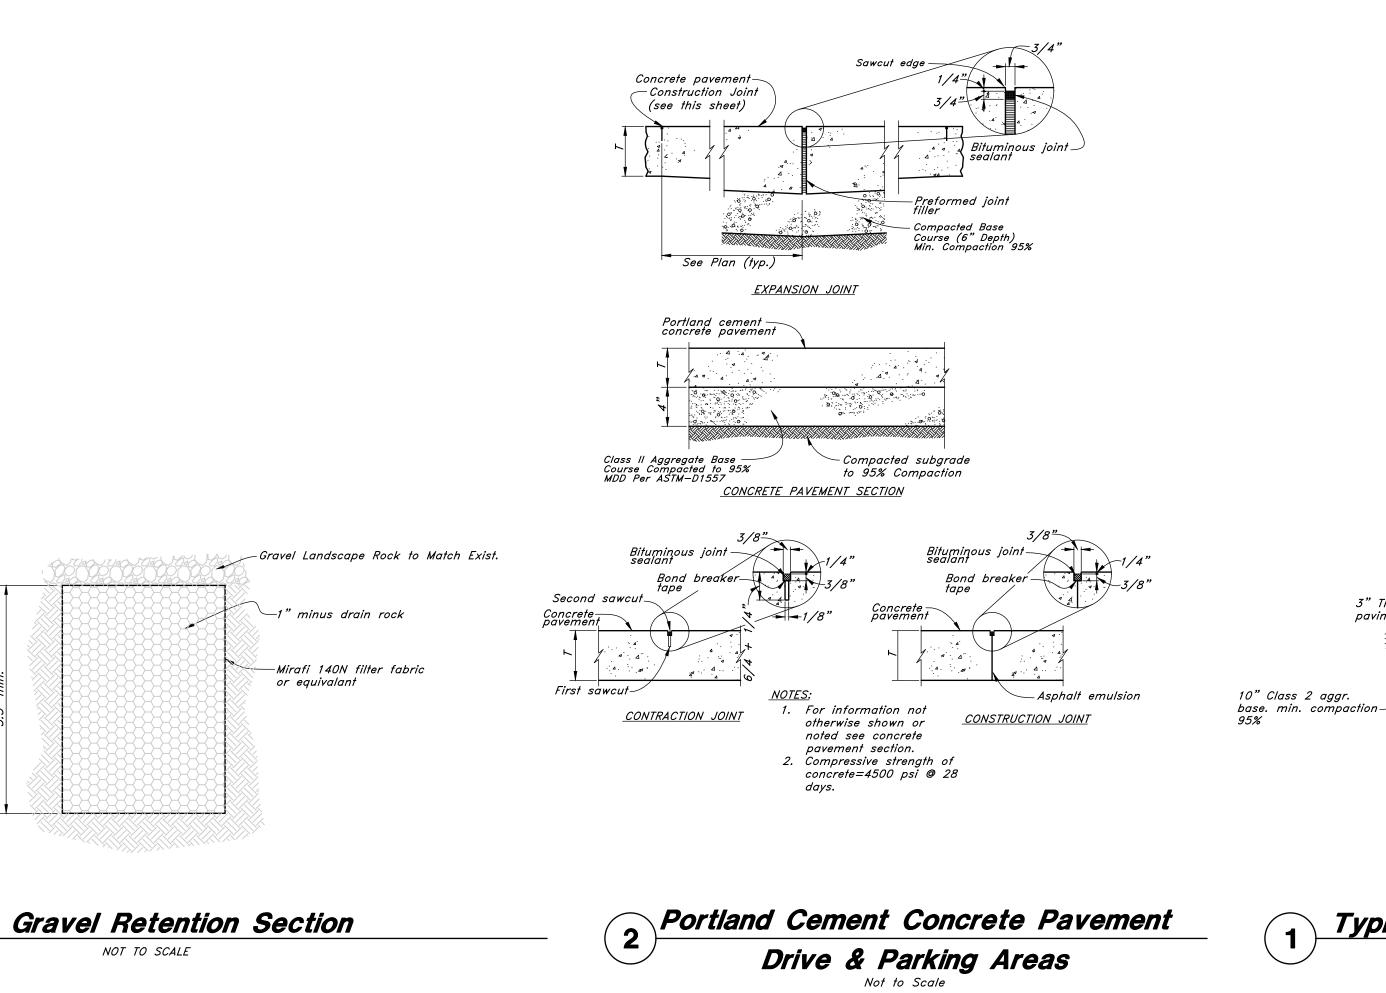
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3" Thick Bituminous –

Prepared subgrade.
 min. compaction 96%

Typical Bituminous Pavement Section


Heavy Duty Drives


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paving





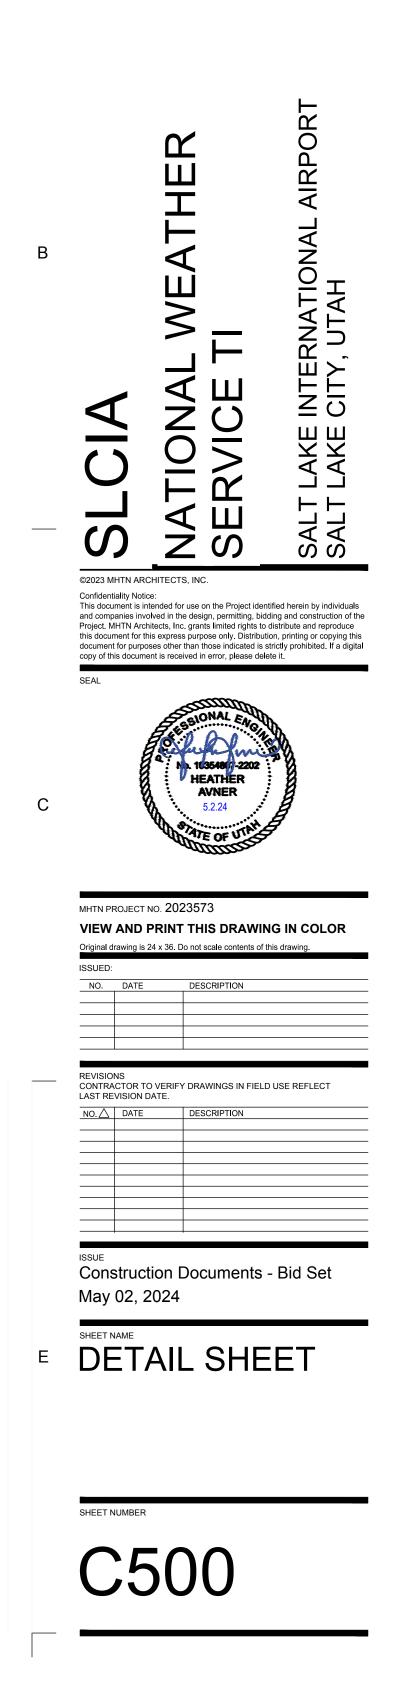

### CONSTRUCTION PHASING

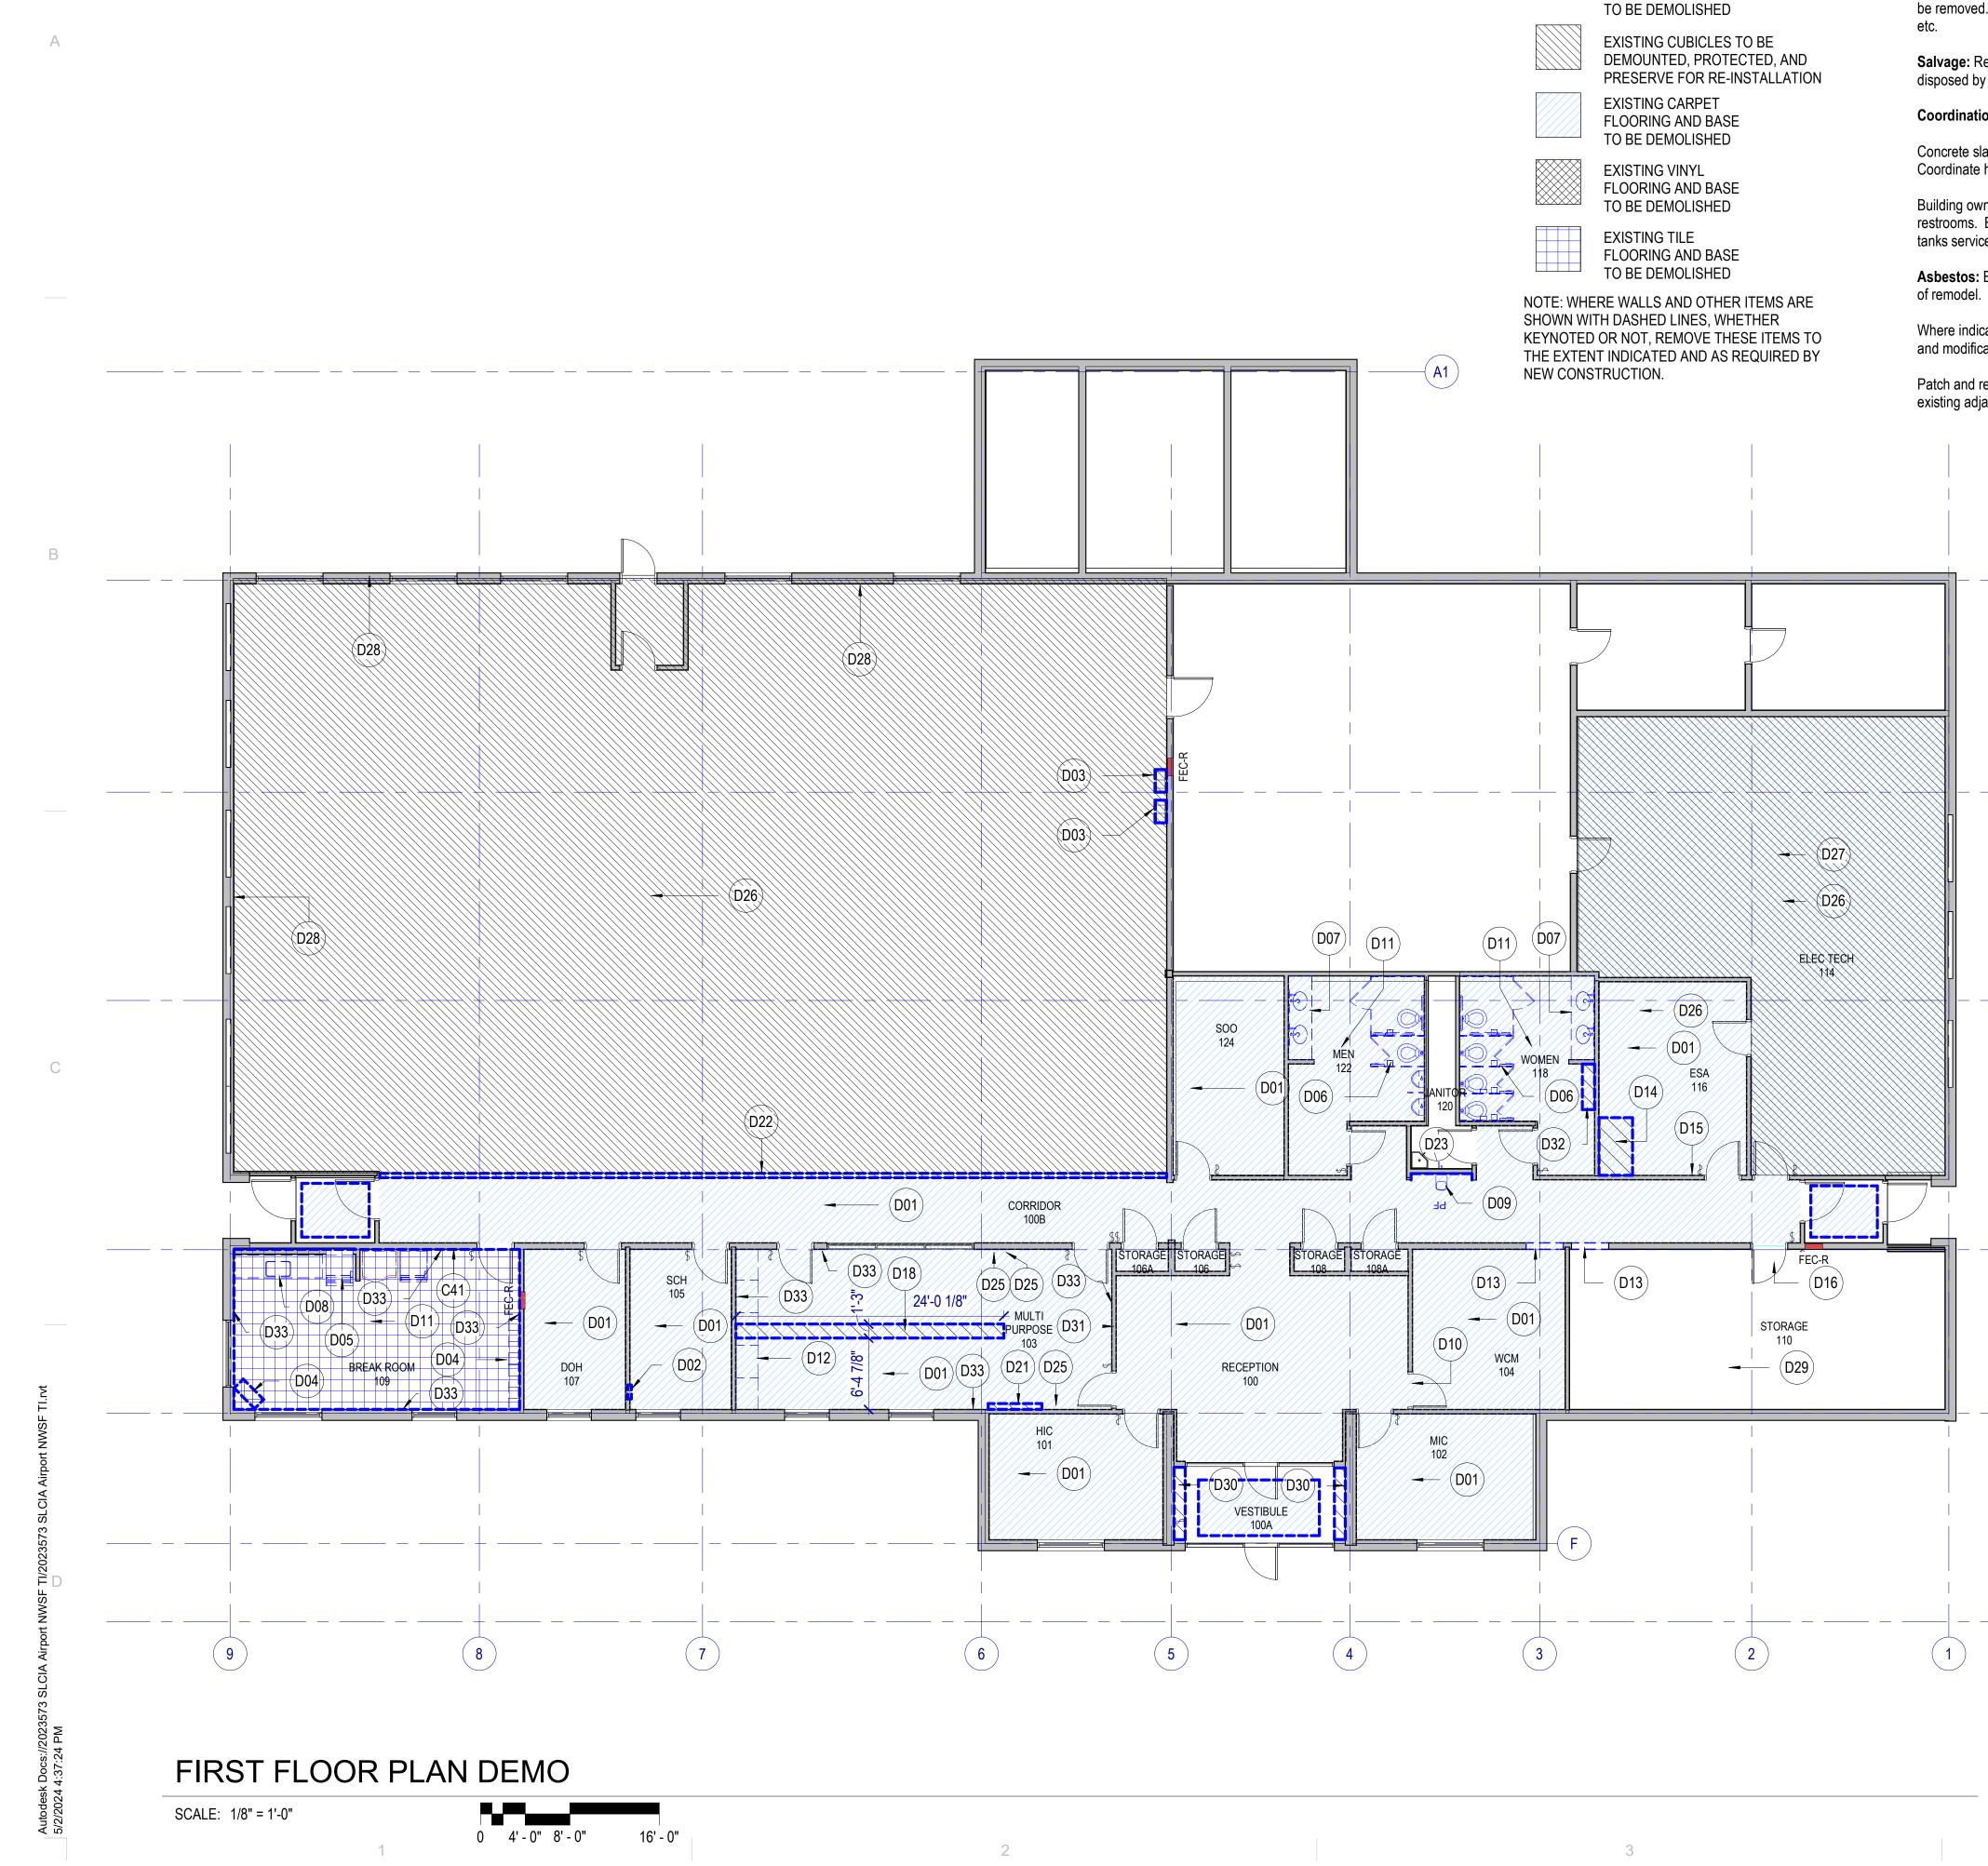1. Contractor to coordinate with the tenant regarding phasing of spaces to be demolished.

2. Contractor to delay taking possession 3. Contractor to delay demolition and construction of breakroom until at least one restroom


and drinking fountain are complete to maintain accessibility to culinary water. 4. Contractor to coordinate furniture relocation with tenant to ensure that there is continuous access to a sufficient number of desks as determined by tenant.

### LEGEND - DEMOLITION

AREA OF NO WORK

EXISTING TO REMAIN

REMOVE DOOR & FRAME **EXAMPLE :** WALLS & OTHER ITEMS

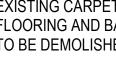

Protect in-place, existing mechanical, plumbing and electrical systems above ceilings that are not shown to be removed. This includes, but is not limited to: network cabling, coax cabling, conduits, piping, ductwork,

### **DEMOLITION GENERAL NOTES**

Existing Conditions: Verify that existing equipment that is to remain, to be salvaged or to be re-installed, is in working condition. Provide written documentation to the Owner for any items that not in working condition before beginning work in the area.

Protection: Protect existing construction to remain from damage during demolition and new construction work. Repair any damage resulting from this work.

Salvage: Review with owner all existing ceiling elements to be salvaged and returned to owner or disposed by contractor.

**Coordination:** Coordinate extent of ceiling to be removed with the architectural ceiling plan(s).

Concrete slab cutting, trenching, and wall tile removal in restrooms to be performed after business hours. Coordinate hours with the Owner.

Building owner to provide a portable restroom trailer for 3 months with three single occupant restrooms. Building Owner to provide power connection to building. Trailer to include water and sewer tanks serviced by provider. Trailer does not need skirting.

Asbestos: Building owner to test and remediate as needed any asbestos containing materials prior to start

Where indicated to be removed, salvage undamaged acoustical ceiling panels for use in repair, patching and modifications of existing ceilings. Use only in ceilings where panels match.

Patch and repair existing construction to remain where affected by and adjacent to demolition Work. match existing adjacent finishes.

	<u>KEYNOT</u>	ES	В
A	C41	REMOVE EXISTING TELEPHONE AND / OR CONNECTION PLATE, TERMINATE WIRING AND INSTALL BLANK COVER.	
	D01	REMOVE EXISTING CARPET AND BASE (GRAPHICALLY SHADED AREAS). REFER TO GENERAL NOTES REGARDING TESTING.	G
	D02	REMOVE EXISTING HEATER AND ELECTRICAL. PATCH ANI REPAIR WALL.	D
	D03	REMOVE EXISTING HUMIDIFIERS, PLUMBING, AND ELECTRICAL (NOT IN CONTRACT)	
$\frown$	D04	REMOVE EXISTING LOCKERS	
——————————————————————————————————————	D05	RELOCATE EXISTING REFRIGERATOR AND VENDING MACHINE, SEE NEW CONSTRUCTION DRAWINGS	
	D06	REMOVE EXISTING TOILET STALLS.	
	D07	REMOVE EXISTING SINKS AND COUNTERTOP.	
	D08	REMOVE EXISTING COUNTERTOP, SINK, AND CABINETRY	
	D09	REMOVE EXISTING DRINKING FOUNTAIN, ELECTRICAL AN PLUMBING TO REMAIN.	D
	D10	REMOVE & SALVAGE EXISTING DOOR AND RELOCATE, PATCH AND REPAIR AS NECESSARY, RELOCATE LIGHT SWITCH, SEE ELECTRICAL.	
— (C)	D11	REMOVE EXISTING FLOOR TILE AND BASE. REFER TO GENERAL NOTES REGARDING TESTING.	
	D12	REMOVE EXISTING MILLWORK AND SOFFIT, PATCH AND REPAIR EXISTING WALLS, CEILINGS, AND FLOOR AS REQUIRED.	С
	D13	DEMO WALL AREA FOR NEW DOOR, SEE NEW CONSTRUCTION DRAWINGS.	
	D14	DEMO EXISTING SLAB AS REQUIRED FOR NEW SHOWER AND PLUMBING. PERFORM AFTER GROUND PENETRATING RADAR SURVEY OR APPROVED EQUIVALENT. SEE NEW CONSTRUCTION DRAWINGS.	G
	D15	RELOCATE EXISTING THERMOSTAT.	
— D	D16	REMOVE EXISTING DOOR AND PORTION OF WALL AS CONSTRUCTION DRAWINGS INDICATE.	
	D18	TRENCH EXISTING SLAB FOR NEW DATA / POWER TO CENTER TABLE, PERFORM AFTER GROUND PENETRATING RADAR SURVEY OR APPROVED EQUIVALENT.	G
	D21	DEMO EXISTING MARKERBOARD CABINET, PATCH AND REPAIR WALL FOR PAINT	
$\frown$	D22	DEMO EXISTING CARPET TRANSITION. REFER TO GENER/ NOTES REGARDING TESTING.	AL
——( E )	D23	EXISTING JANITOR SINK TO REMAIN	
	D25	REMOVE EXISTING TELEPHONE AND / OR CONNECTION PLATE, TERMINATE WIRING AND INSTALL BLANK COVER.	
	D26	OFFICE CUBICLES TO BE DEMOUNTED PROTECTED AND PRESERVED FOR RE-INSTALLATION IN OFFICE AFTER CONSTRUCTION AND FINISHING.	
	D27	REMOVE EXISTING VINYL TILE FLOORING, ADHESIVE, AND WALL BASE (CROSSHATCHED AREA). AND PREPARE FLOOR AND PATCH AS NECESSARY FOR NEW SDT FLOORING. REFER TO GENERAL NOTES REGARDING TESTING.	D E
F1	D28	CARPET AT WALL TO BE REMOVED, WALL SURFACE TO B REPAIRED AND PATCHED, AND PAINTED. REFER TO GENERAL NOTES REGARDING TESTING.	E
	D29	DELIVER SURPLUS SHELVING TO OWNER.	
	D30	REMOVE EXISTING SHOWCASE DISPLAYS, PATCH AND REPAIR WALL FOR PAINT.	
NI	D31	REMOVE EXISTING TV, SAVE FOR RELOCATION	
N	D32	DEMO EXISTING STORAGE CABINET	
	D33	REMOVE EXISTING WALLCOVERING, PATCH AND PREPAR SURFACE FOR NEW PAINT	Έ
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### MHTN ARCHITECTS

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SET

MAY 02, 2024

SHEET NAME

PLAN

SHEET NUMBER

LAST REVISION DATE.

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MHTN PROJECT NO.2023573

NO. DATE DESCRIPTION

NO. DATE DESCRIPTION

01 Oct 27, 2023 SCHEMATIC DESIGN

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DEMOLITION

AD101

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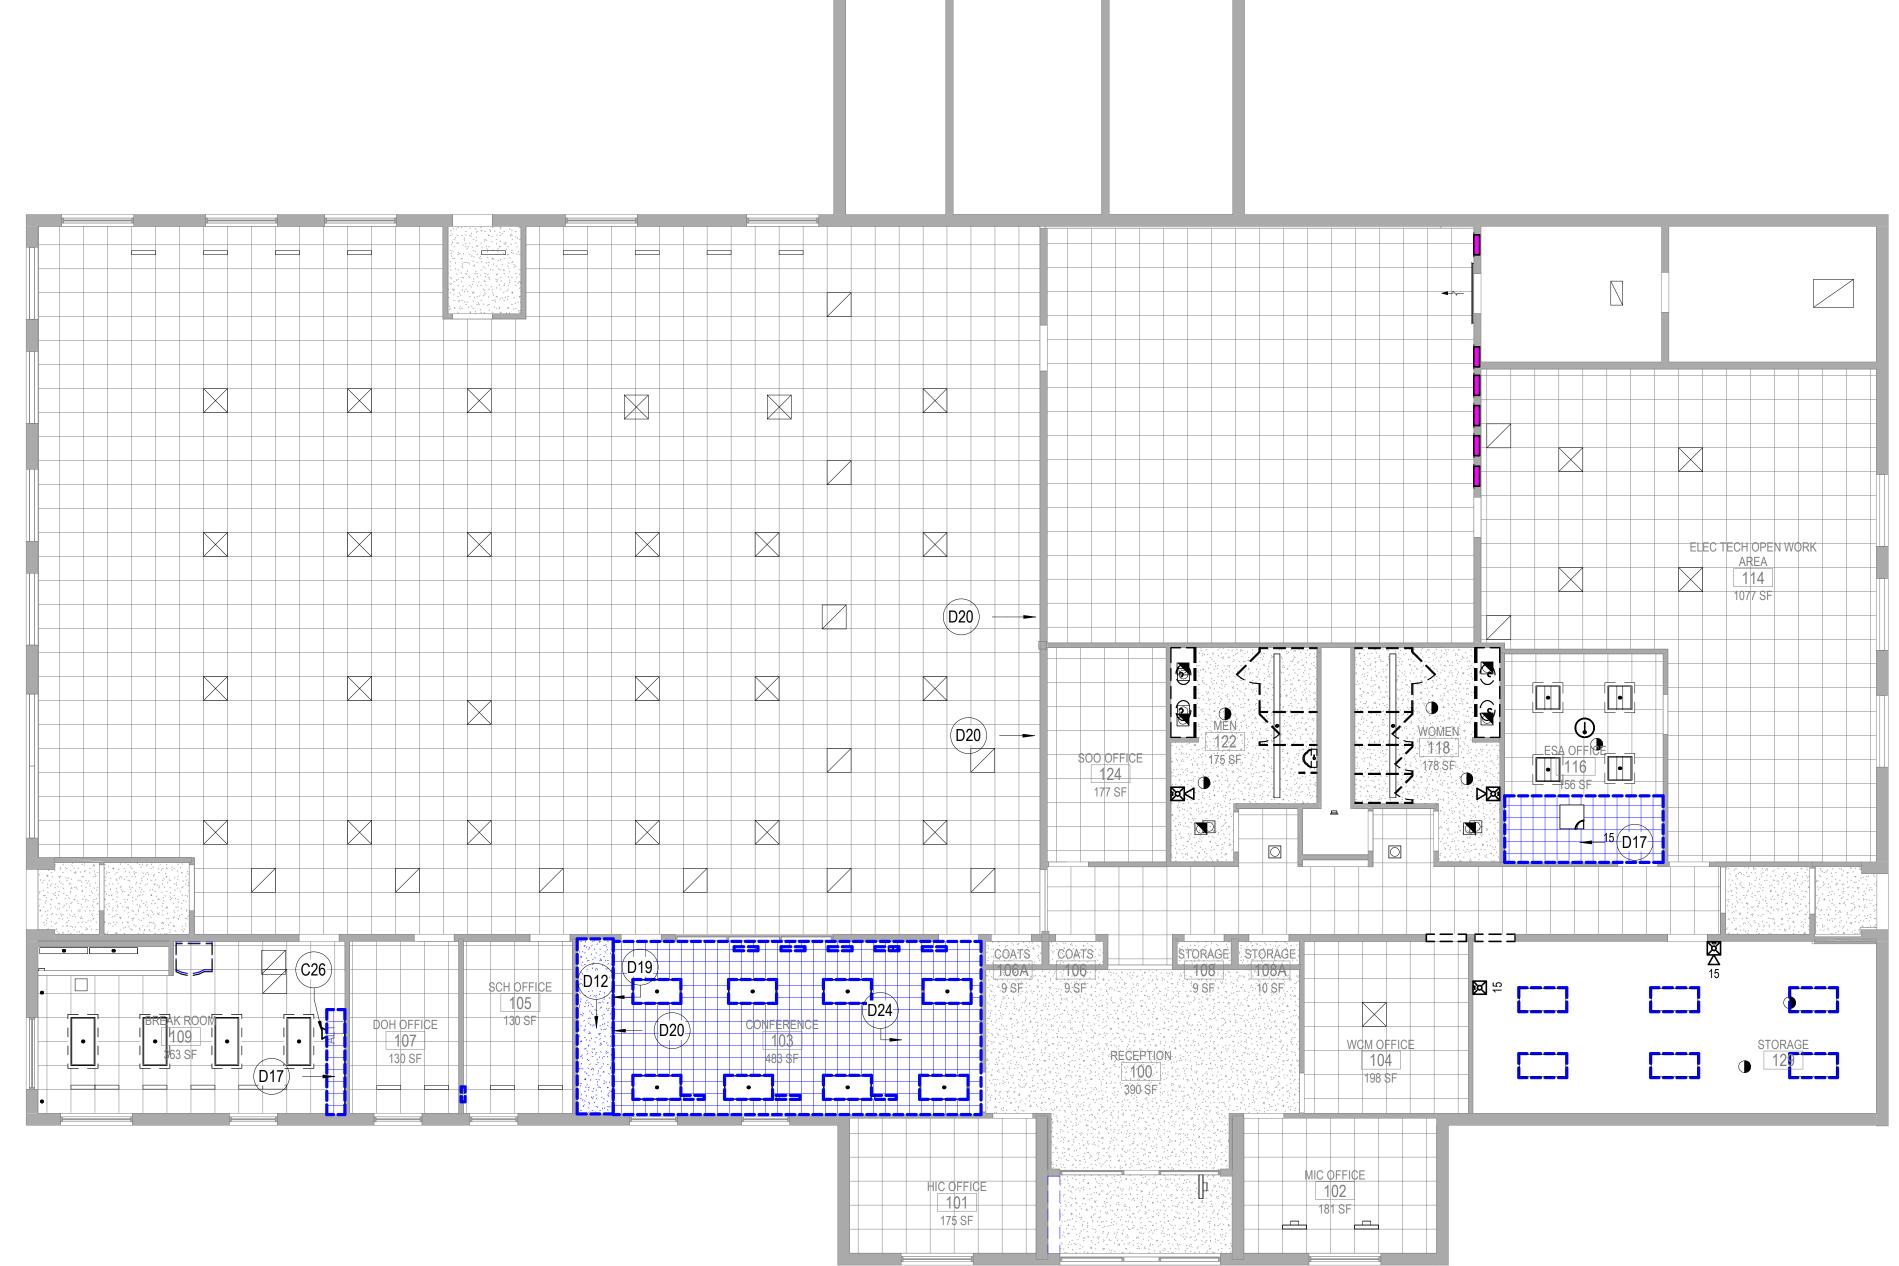
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### **LEGEND - DEMOLITION**

### AREA OF NO WORK

EXISTING TO REMAIN

**EXAMPLE :** WALLS & OTHER ITEMS TO BE DEMOLISHED



EXISTING GYPSUM CEILING TO BE DEMOLISHED



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EXISTING ACOUSTIC CEILING TILE AND GRID TO BE DEMOLISHED

NOTE: WHERE WALLS AND OTHER ITEMS ARE SHOWN WITH DASHED LINES, WHETHER KEYNOTED OR NOT, REMOVE THESE ITEMS TO THE EXTENT INDICATED AND AS REQUIRED BY NEW CONSTRUCTION.



Protection: Protect existing construction to remain from damage during demolition and new construction work. Repair any damage resulting from this work.

Protect in-place, existing mechanical, plumbing and electrical systems above ceilings that are not shown to be removed. This includes, but is not limited to: network cabling, coax cabling, conduits, piping, ductwork, etc.

Building owner to provide a portable restroom trailer for 3 months with three single occupant restrooms. Building Owner to provide power connection to building. Trailer to include water and sewer tanks serviced by provider. Trailer does not need skirting.

Patch and repair existing construction to remain where affected by and adjacent to demolition Work. match existing adjacent finishes.

2

### DEMOLITION GENERAL NOTES

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Concrete slab cutting, trenching, and wall tile removal in restrooms to be performed after business hours. Coordinate hours with the Owner.

Asbestos: Building owner to test and remediate as needed any asbestos containing materials prior to start of remodel.

Where indicated to be removed, salvage undamaged acoustical ceiling panels for use in repair, patching and modifications of existing ceilings. Use only in ceilings where panels match.

### **KEYNOTES**

C26	RELOCATE EXISTING FIRE BEACON
D12	REMOVE EXISTING MILLWORK AND SOFFIT, PATCH AND REPAIR EXISTING WALLS, CEILINGS, AND FLOOR AS REQUIRED.
D17	REMOVE & SALVAGE EXISTING ACOUSTIC SUSPENDED CEILING TILES AND REPAIR EXISTING SUSPENSION SYSTEM TO SUPPORT CEILING TO REMAIN. EXISTING LIGHTING TO REMAIN.
D19	REMOVE EXISTING GYPSUM SUSPENDED CEILING AND LIGHT FIXTURES. REFER TO GENERAL NOTES REGARDING TESTING.
D20	REMOVE & SALVAGE EXISTING SIGNAGE AND DELIVER TO OWNER, REPAIR AND PATCH IN PREPARATION FOR NEW PAINT / BASE
D24	REMOVE & SALVAGE EXISTING ACOUSTIC TILE CEILING, PROTECT TILES FROM DAMAGE AND DELIVER TO OWNER FOR ATTIC STOCK. REPAIR EXISTING SUSPENSION

SYSTEM TO SUPPORT CEILING TO REMAIN WHERE

APPLIES. EXISTING LIGHTING TO REMAIN.

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NO. DATE DESCRIPTION

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01 Oct 27, 2023 SCHEMATIC DESIGN

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REVISIONS

LAST REVISION DATE.


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MAY 02, 2024

SHEET NUMBER

SHEET NAME DEMOLITION RCP

**AD701** 

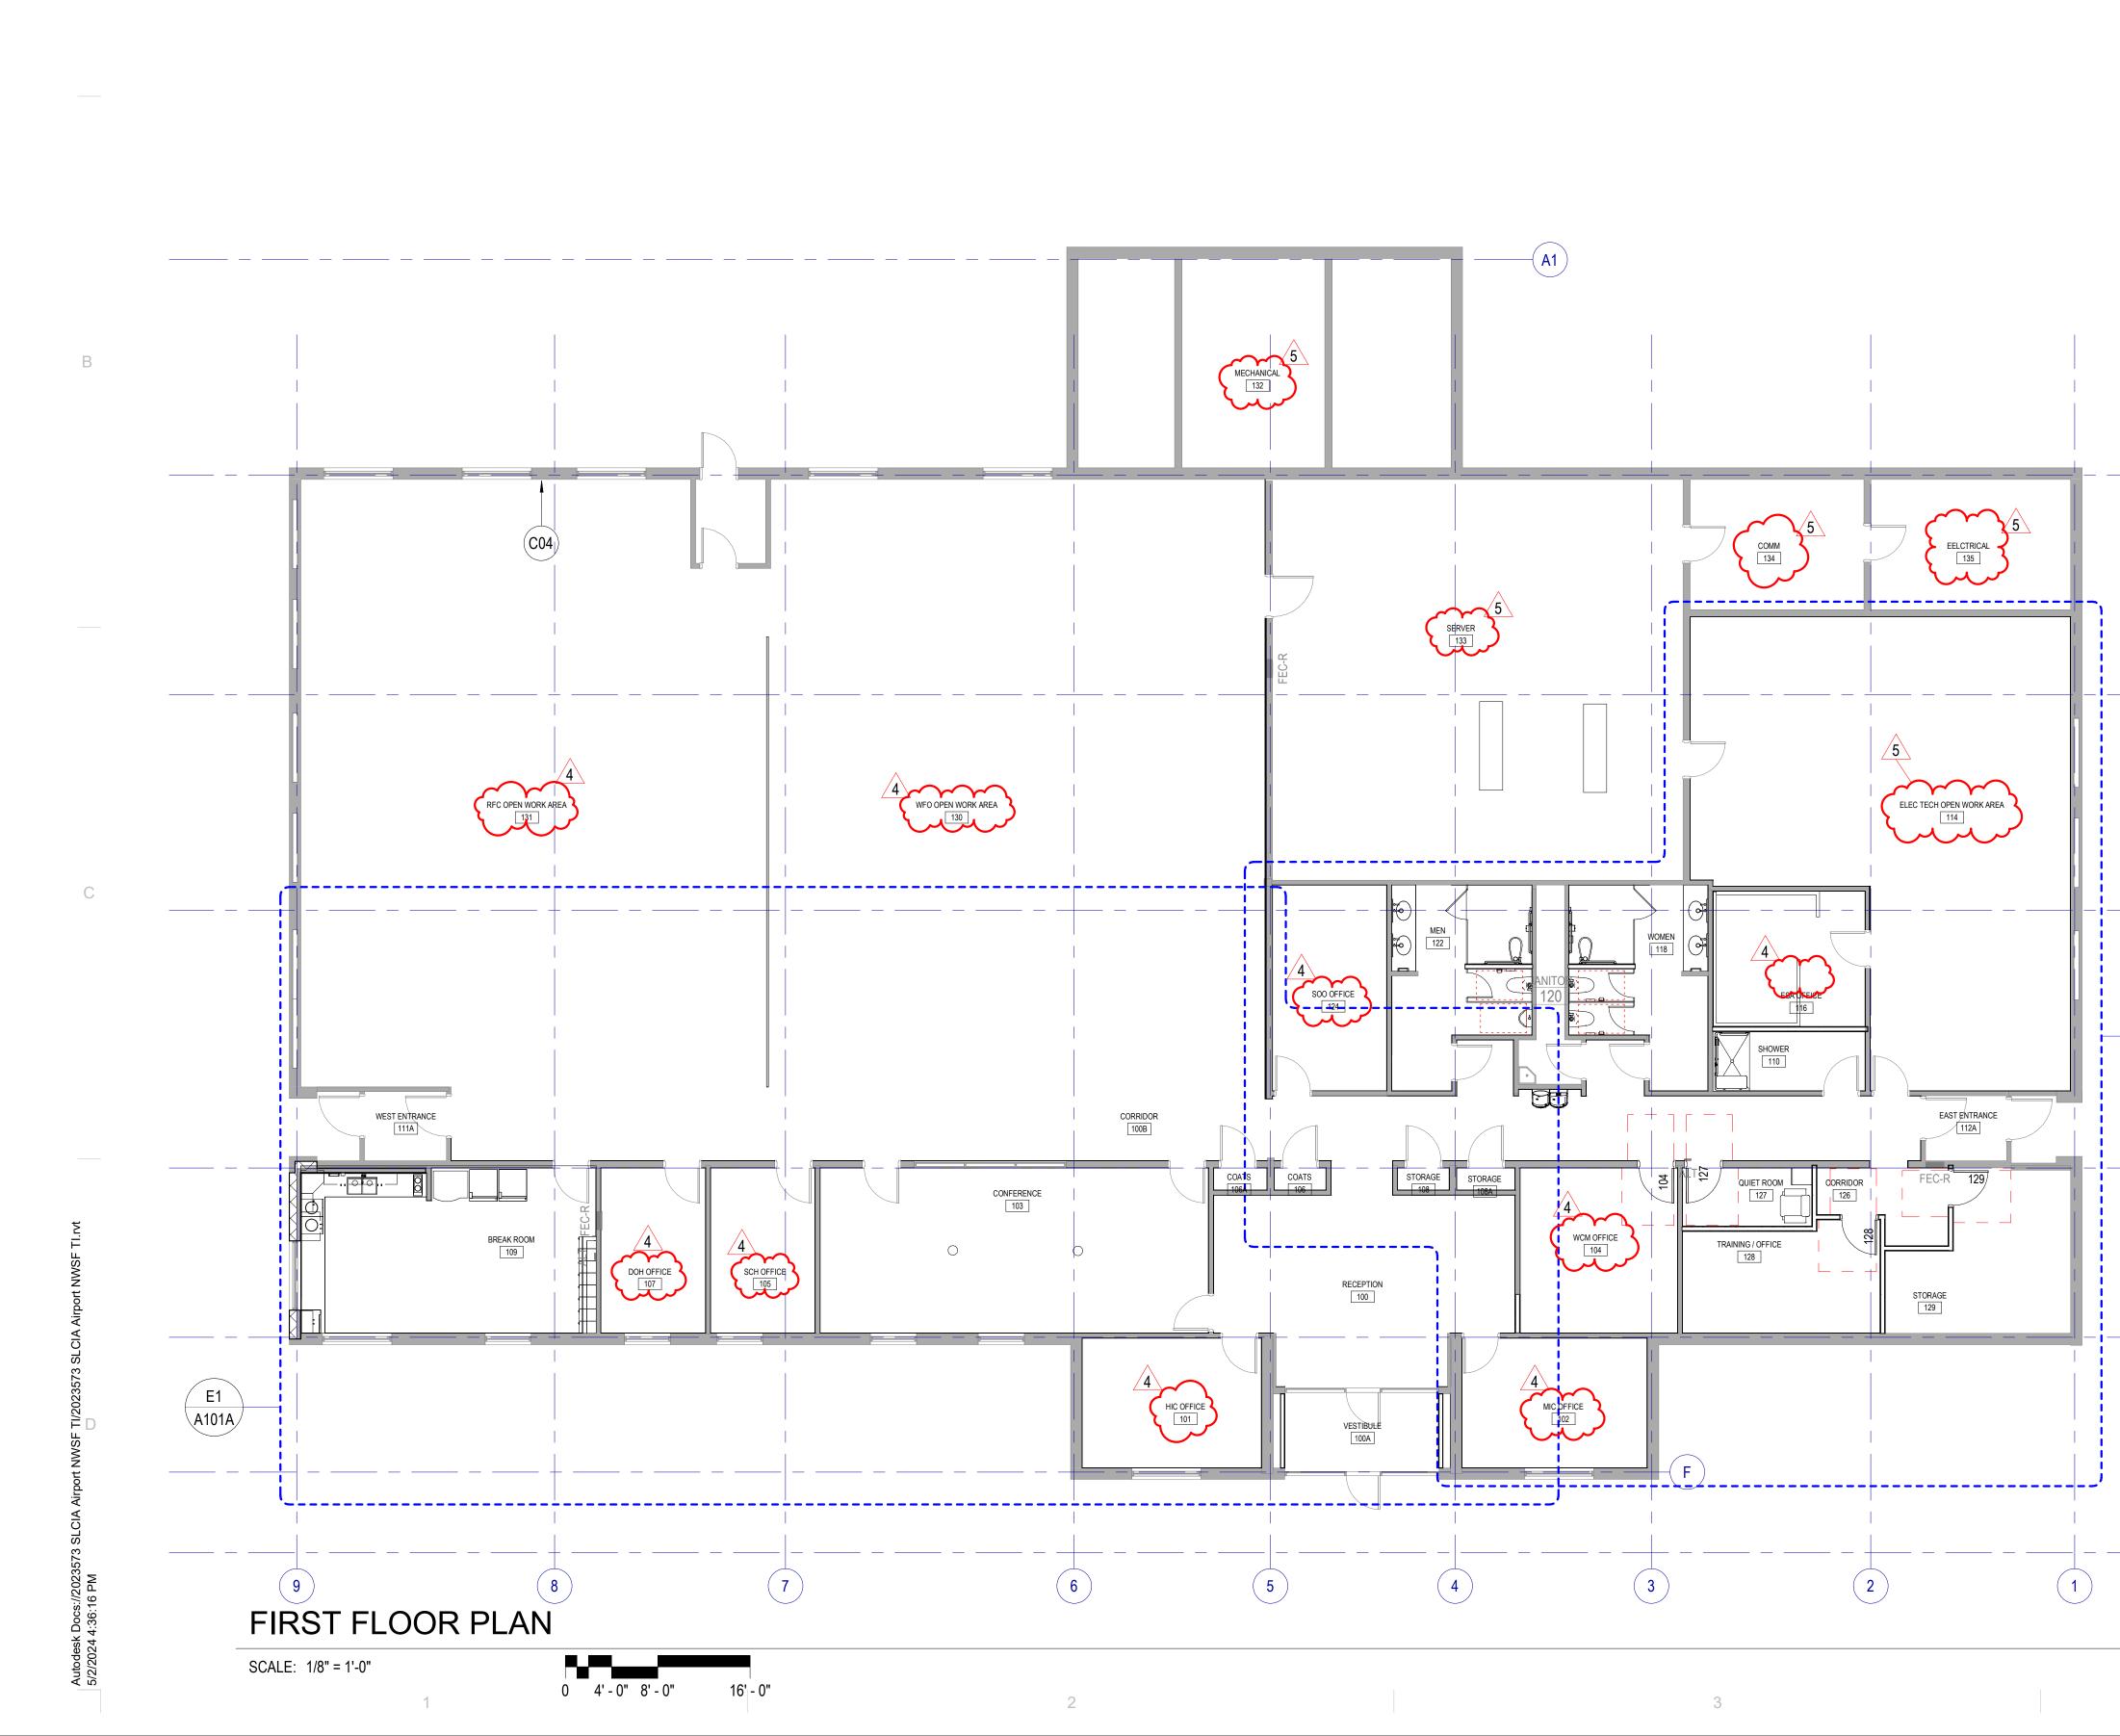

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RE: A651 Floor Finish plan for floor finishes Furniture may be shown for space planning; however, all furniture is not in contract.

### FLOOR PLAN GENERAL NOTES

References to sheets below are provided to aid in navigating the drawings.

RE: A101 for Interior Wall Types, walls are tagged on drawings A101A, and A101B.

Acoustical sealant to be used for all walls in Shower Room 110, Quite Room 127, and Office128.

Rated Construction: Provide as shown on the plans, the Life Safety Plans and elsewhere in the documents. Seal penetrations with systems applicable to the application and that have UL or other testing agency certifications.

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Keynotes: Not all keynotes apply to this sheet.

Door Schedule Abbreviations TME - To Match Existing

-(A)

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-( C )

E1

A101B

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-(F1)



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A101


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		INT		ALL
TAG		CONSTRUCT	ION	
MARK	DESCRIPTION	WIDTH	TERMINATION	LIMIT
S3A	5/8" GB + 3 5/8" MTL STUD + 5/8" GB	4 7/8"	TO DECK	
S3B	5/8" GB + 3 5/8" MTL STUD + 5/8" GB	4 7/8"	TO DECK	
S3BX	5/8" GB + 3 5/8" MTL STUD	4 1/4"	TO DECK	

А

	S3BX 5/8" GB + 3 5/8" MTL STUD	4 1/4" TO DECK	15'-6"		No	C13 C14 C15 C16	NEW CABINE IRY, COUNTERTOP, S SHELVING ADDED TO EXISTING CL NEW INFILL WALL TO MATCH EXIST PAINT AND FINISH TO MATCH. NEW CARPET AND BASE. CARPET I
	DOOR FRAME	AND FRAME SCHEDULE				C23 C24	ASHLAR. NEW POWER OUTLET OR RELOCAT AT HEIGHT TO MATCH EXISTING UN SEE ELECTRICAL NEW DATA LOCATION OR RELOCAT ELECTRICAL.
	# # TYPE HEIGHT TYPE MATERIAL	REMARKS	DOOR #			C29	CABINET DOORS TO OPEN FOR AC ACCESS
	104         F         3'-0"         7'-0"         1         TME         RELOCA           127         F         3'-0"         7'-0"         1         TME         NEW DO           128         F         3'-0"         7'-0"         1         TME         NEW DO	TED DOOR & FRAME, CLOSER, HARDWARE TME OR, CLOSER, HARDWARE TME W/ NEW VACANCY/OCCUPANCY OR, CLOSER, HARDWARE TME ND HARDWARE RELOCATED FROM CORRIDOR 100B	104 LOCK 127 128 129			C84	EXISTING BASE TO REMAIN
							A416 D1
	WEST ENTRANCE 111A 41 SF C84	(A412) D1		(A412) C1	CORRI [100 790	DOR B SF	C16
	$\begin{array}{c} PTD \\ SD \\ C13 \\ 10'-10 3/4'' \\ C29 \\ A1 \\ C29 \\ A2 \\ C29 \\ A2 \\ C29 \\ A1 \\ B2 \\ C13 \\ C1$	$\begin{array}{c} \\ \\ \\ \\ \\ \\ \\ \\ \\ \\ \\ \\ \\ \\ \\ \\ \\ \\ \\$	FFICE 17 SF	10 E3	A2 C24 C23 A1 A411 B1 CONFEE 10 483 A1 A411 B1 CONFEE 10 483 A1 A411 B1 CONFEE 10 483 A1	C24 C23 C23 SF	COATS 106A 9 SF
)							HIC OFFICE $A^2$ 101 175 SF A1 $A413$ A3 B1 C16 B1
	9	8		7		6	

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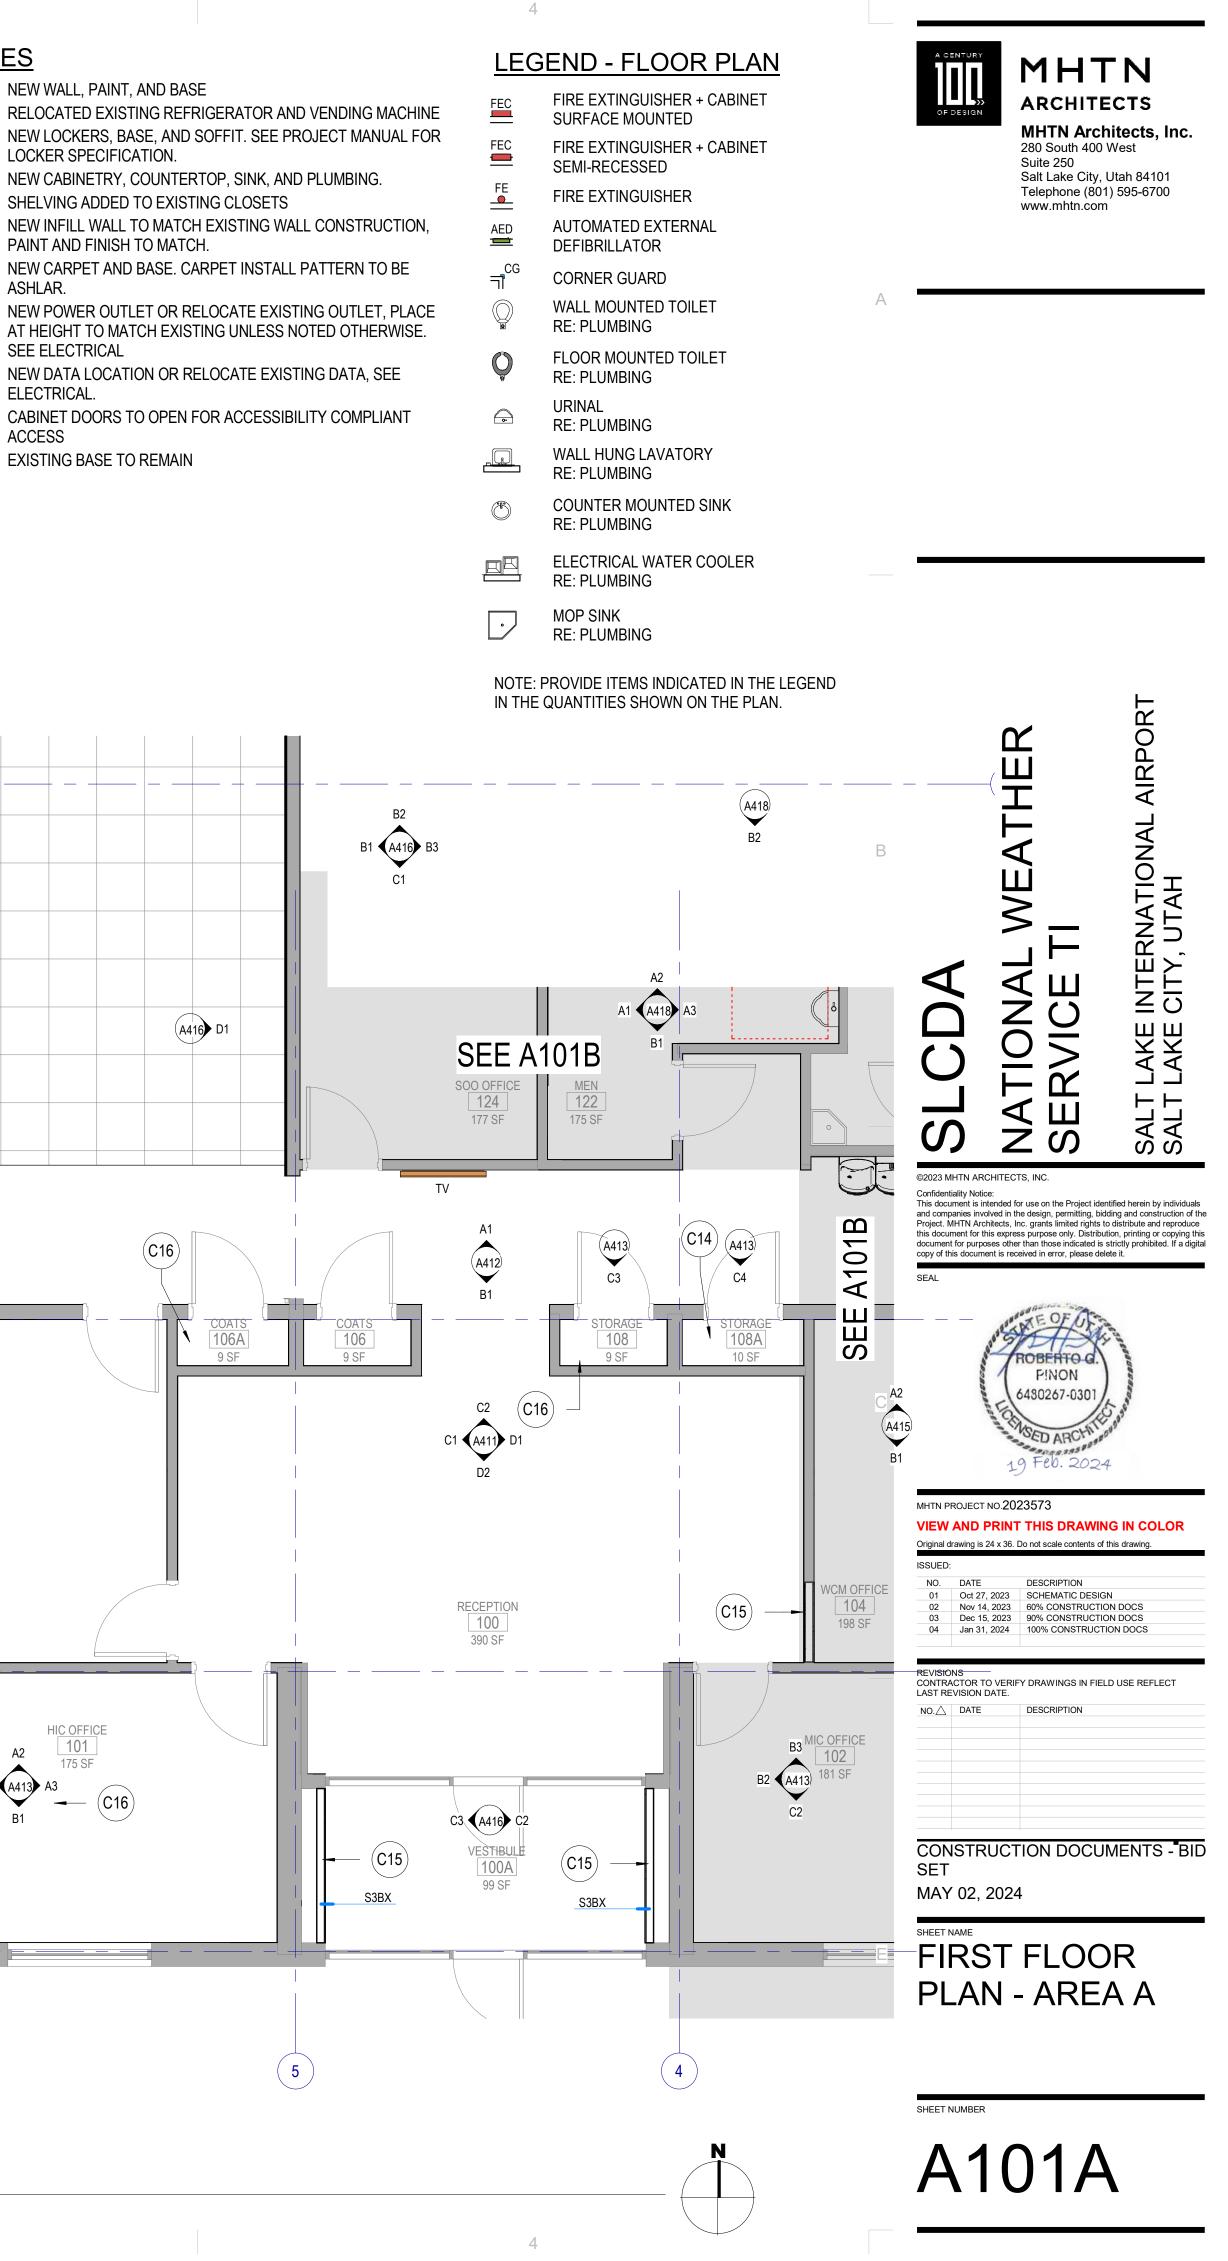



### TYPE SCHEDULE FIRE RESISTANCE ACOUSTICAL SOUND BATT IITING HEIGHT HEAD DETAIL BASE DETAIL FIRE RATING STANDARD STC 16'-6" Yes 40 16'-6" No 37 15'-6" No

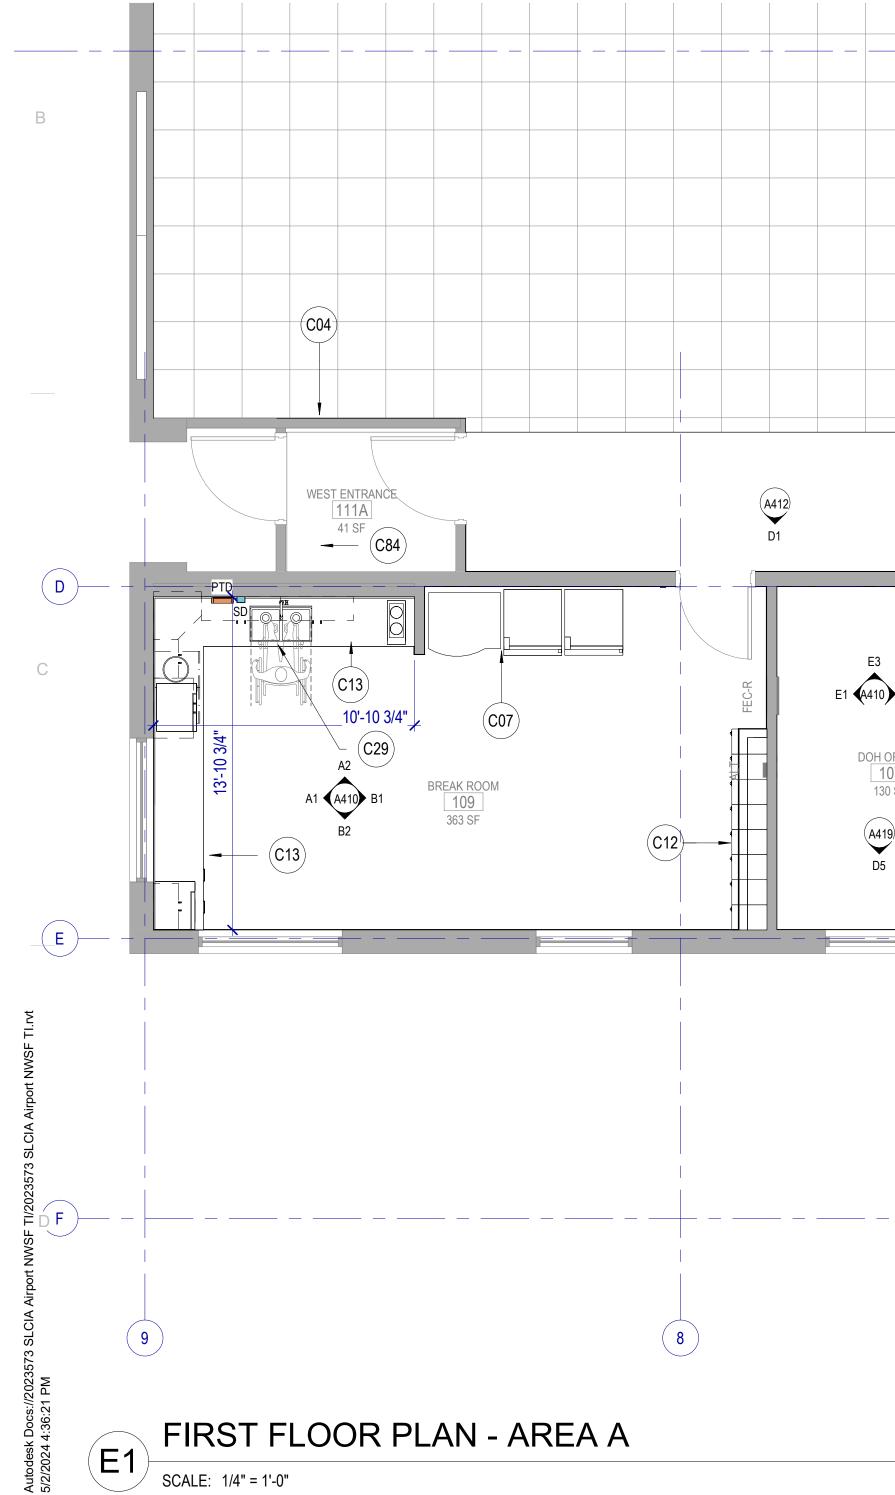2

<u>KEYNOTES</u>

C04 NEW WALL, PAINT, AND BASE C07 C12 LOCKER SPECIFICATION. NEW CABINETRY, COUNTERTOP, SINK, AND PLUMBING. C13



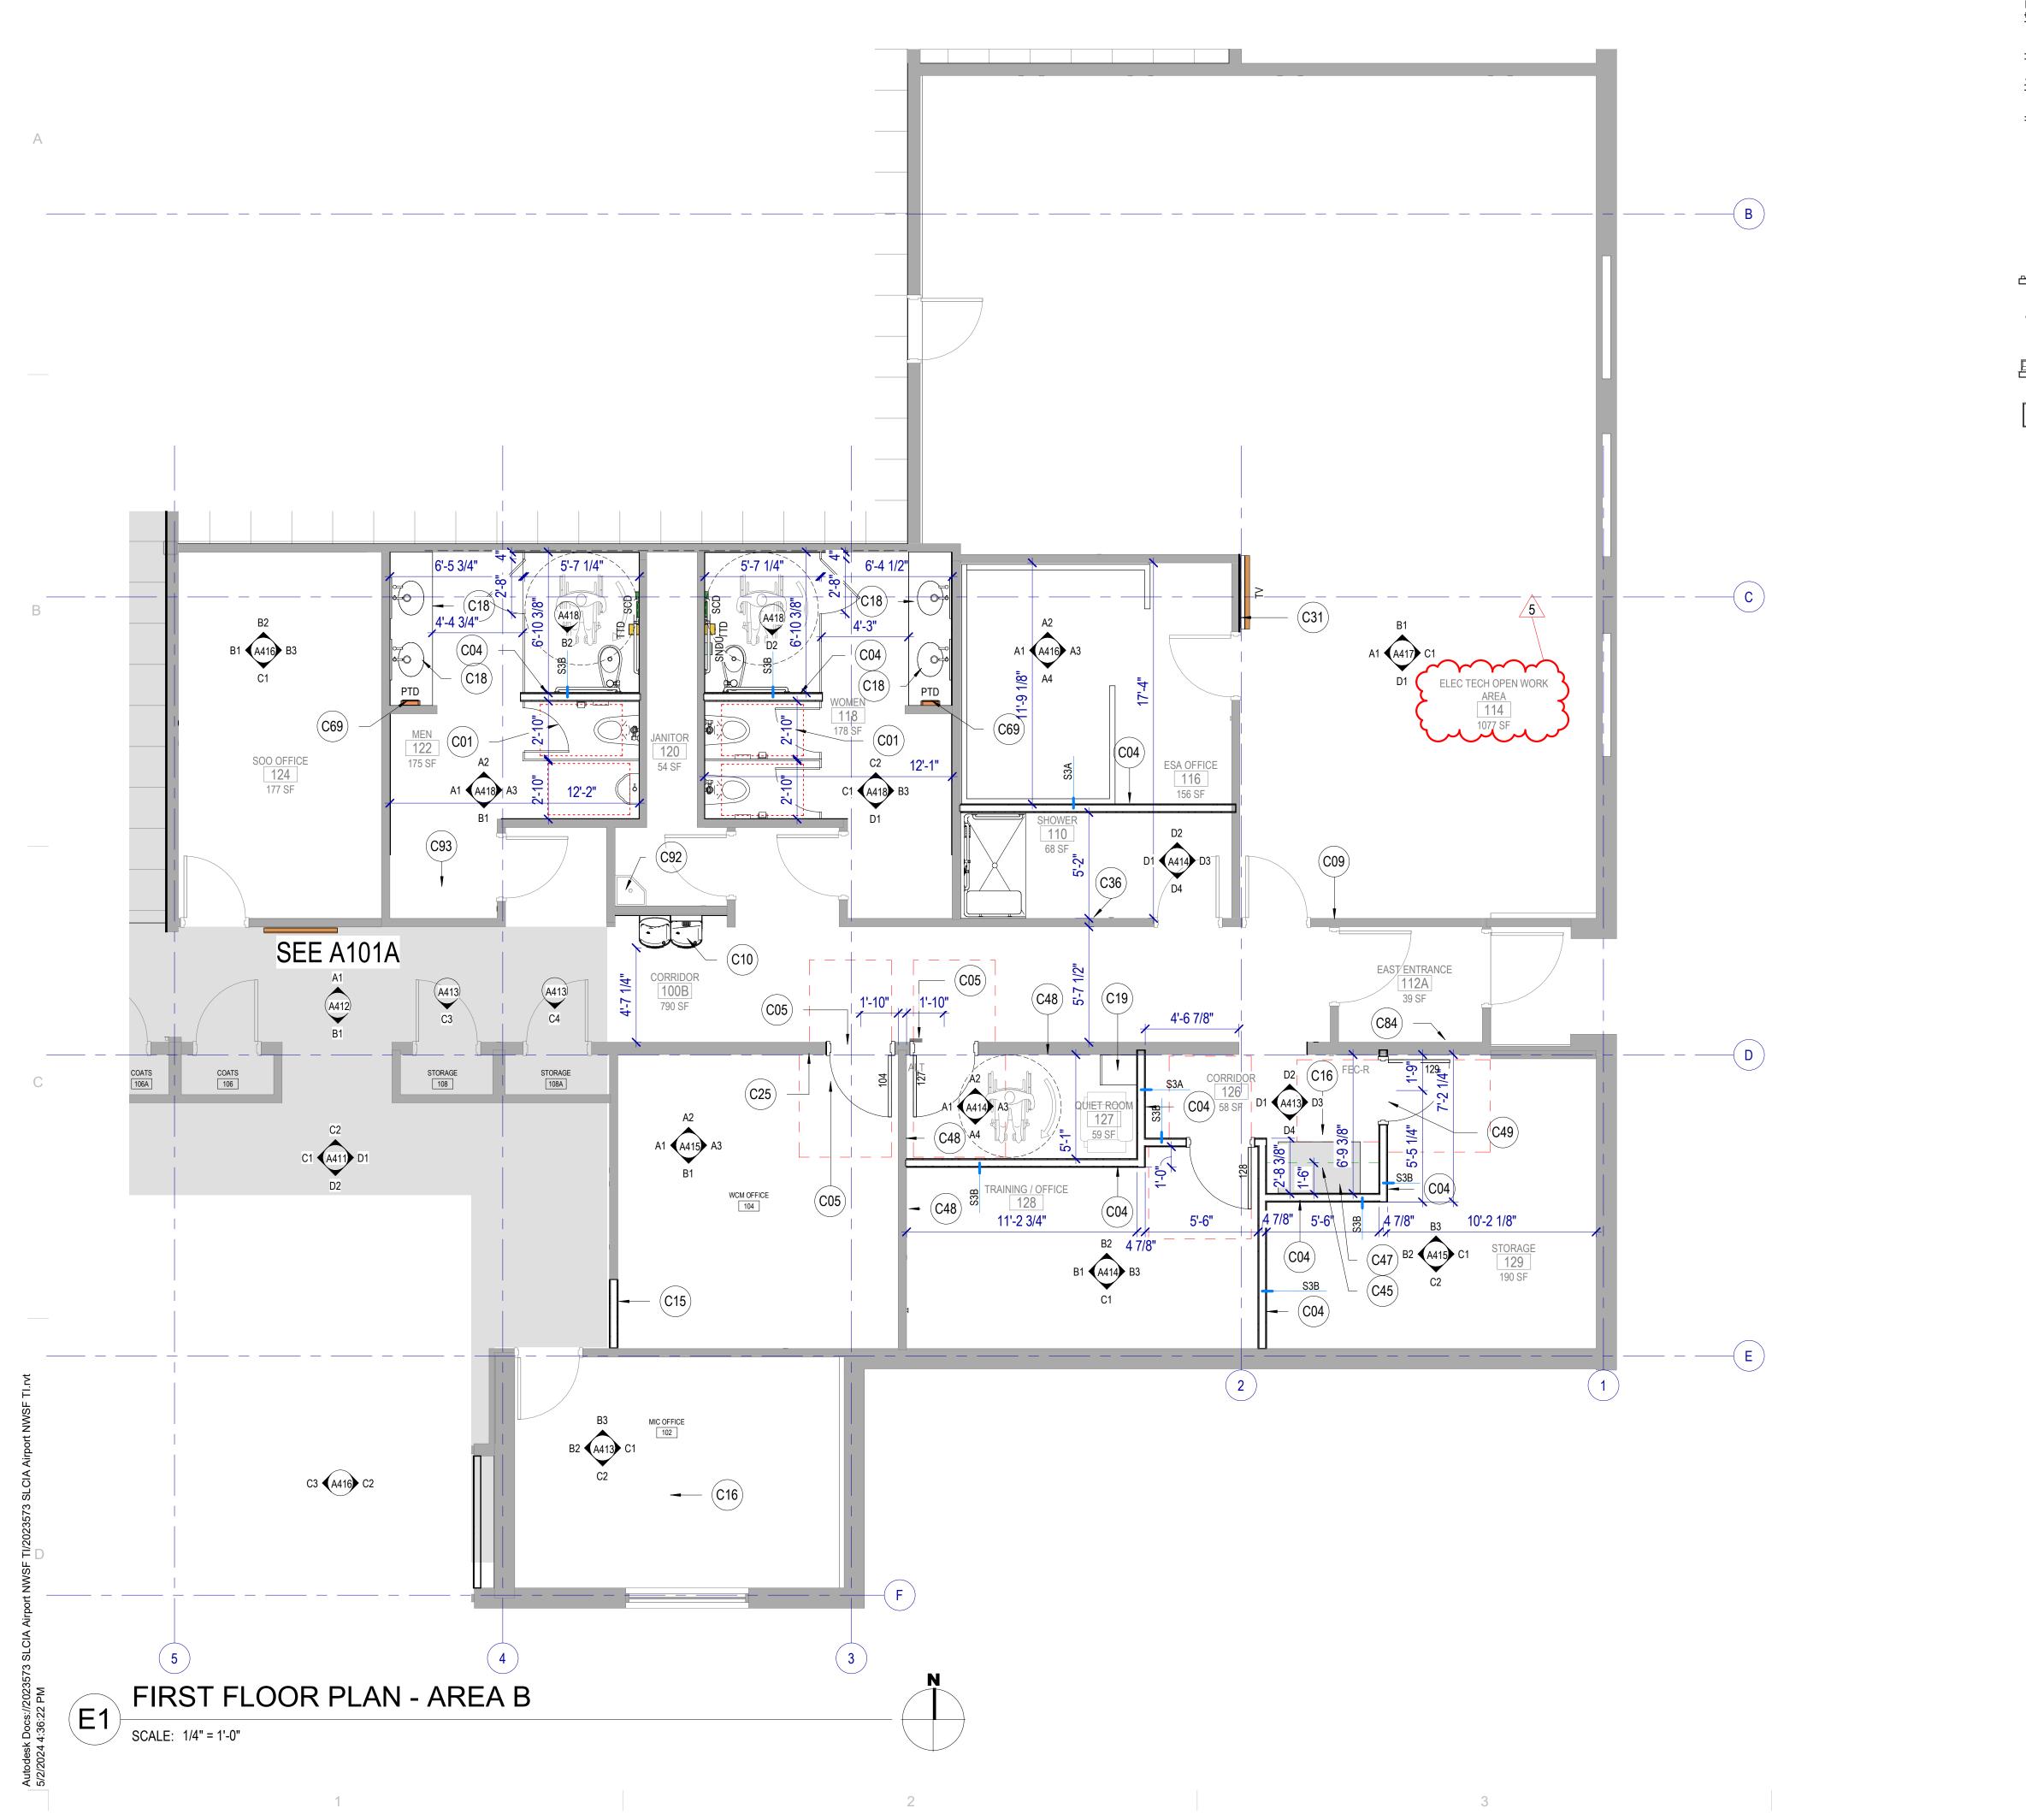

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LEGEND - FLOOR PLAN FIRE EXTINGUISHER + CABINET FEC SURFACE MOUNTED FEC FIRE EXTINGUISHER + CABINET SEMI-RECESSED FIRE EXTINGUISHER AUTOMATED EXTERNAL AED DEFIBRILLATOR CORNER GUARD WALL MOUNTED TOILET RE: PLUMBING FLOOR MOUNTED TOILET Q RE: PLUMBING URINAL **~** RE: PLUMBING WALL HUNG LAVATORY RE: PLUMBING COUNTER MOUNTED SINK RE: PLUMBING ELECTRICAL WATER COOLER RE: PLUMBING

4

MOP SINK • RE: PLUMBING

NOTE: PROVIDE ITEMS INDICATED IN THE LEGEND IN THE QUANTITIES SHOWN ON THE PLAN.

### KEYNOTES

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<u>KEYNOT</u>	<u>ES</u>
C01	NEW RESTROOM FIXTURES AND STALLS, FLOOR MOUNT OR WALL MOUNT TOILETS AS SHOWN ON
	DRAWINGS. FIXTURES TO BE ADA / B ABAAS COMPLIANT.
C04	NEW WALL, PAINT, AND BASE
C05	NEW DOOR AND FRAME TO MATCH EXISTING
C09	RELOCATED THERMOSTAT, TERMINATE WIRING AND REPLACE WITH BLANK COVER.
C10	NEW DRINKING FOUNTAINS WITH BOTTLE FILLER
C15	NEW INFILL WALL TO MATCH EXISTING WALL CONSTRUCTION, PAINT AND FINISH TO MATCH.
C16	NEW CARPET AND BASE. CARPET INSTALL PATTERN TO BE ASHLAR.
C18	NEW COUNTER, SINKS, FAUCETS, MIRRORS. FIXTURES TO BE ADA / ABAAS COMPLIANT.
C19	NEW LOW REFRIDGERATOR AND ELECTRICAL, FRIDGE NOT IN CONTRACT.
C25	NEW LIGHT SWITCH OR RELOCATE EXISTING SWITCH
C31	PATCH AND REPAIR GYPSUM BOARD, NEW PAINT
C36	NEW EPOXY PAINT AND BASE
C45	NEW SHELVING ABOVE EXISTING FURNITURE, ADJUSTABLE WITH BRACKETS, FULL CLOSET DEPTH.
C47	EXISTING FURNITURE TO BE RELOCATED TO THIS LOCATION.
C48	EXISTING WALL AT NEW CONSTRUCTION, ADD 5/8" GYPSUM BOARD ABOVE CEILING TILE TO DECK, TAPE AND MUD ABOVE ACOUSTIC CEILING
C49	EXISTING DOOR AND FRAME RELOCATED FROM CORRIDOR, PROTECT FROM DAMAGE AND REPAIR / REPAINT AS NECESSARY.
C69	PAPER TOWEL DISPENSER
C84	EXISTING BASE TO REMAIN
C92	EXISTING JANITOR SINK TO REMAIN.
C93	NEW EPOXY FLOORING AND BASE



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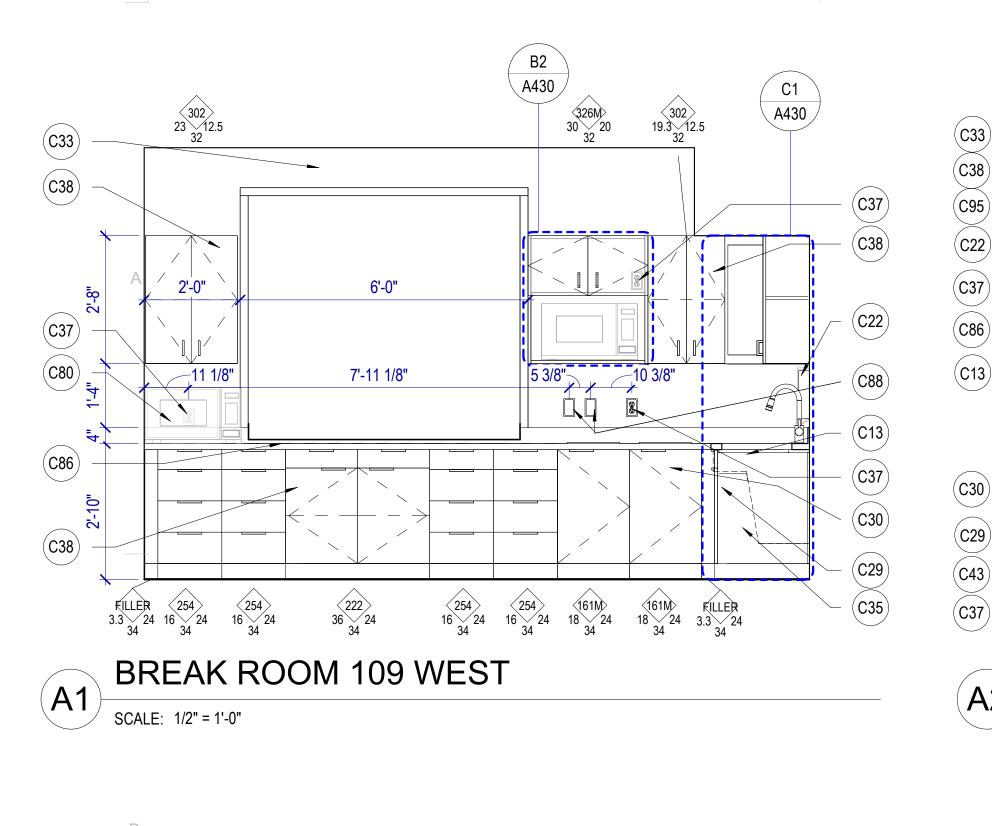
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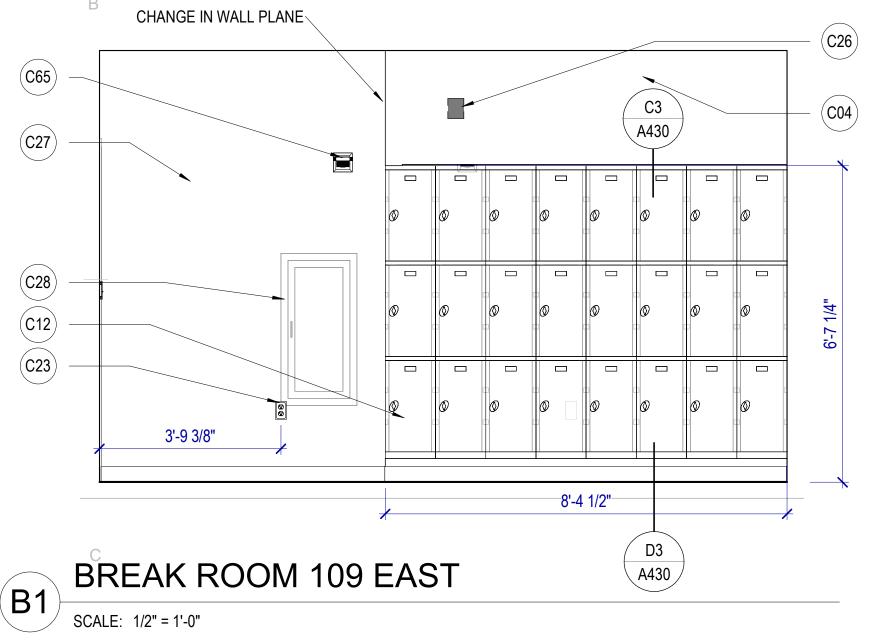
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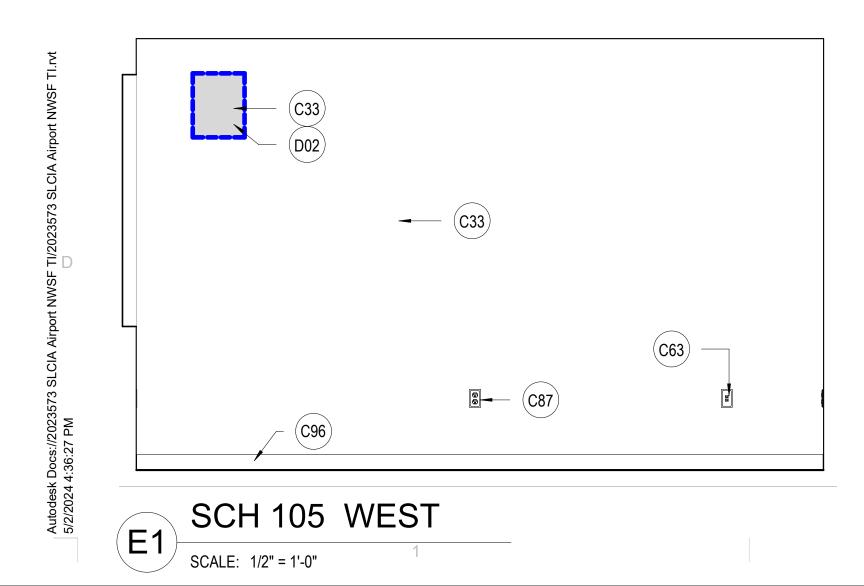
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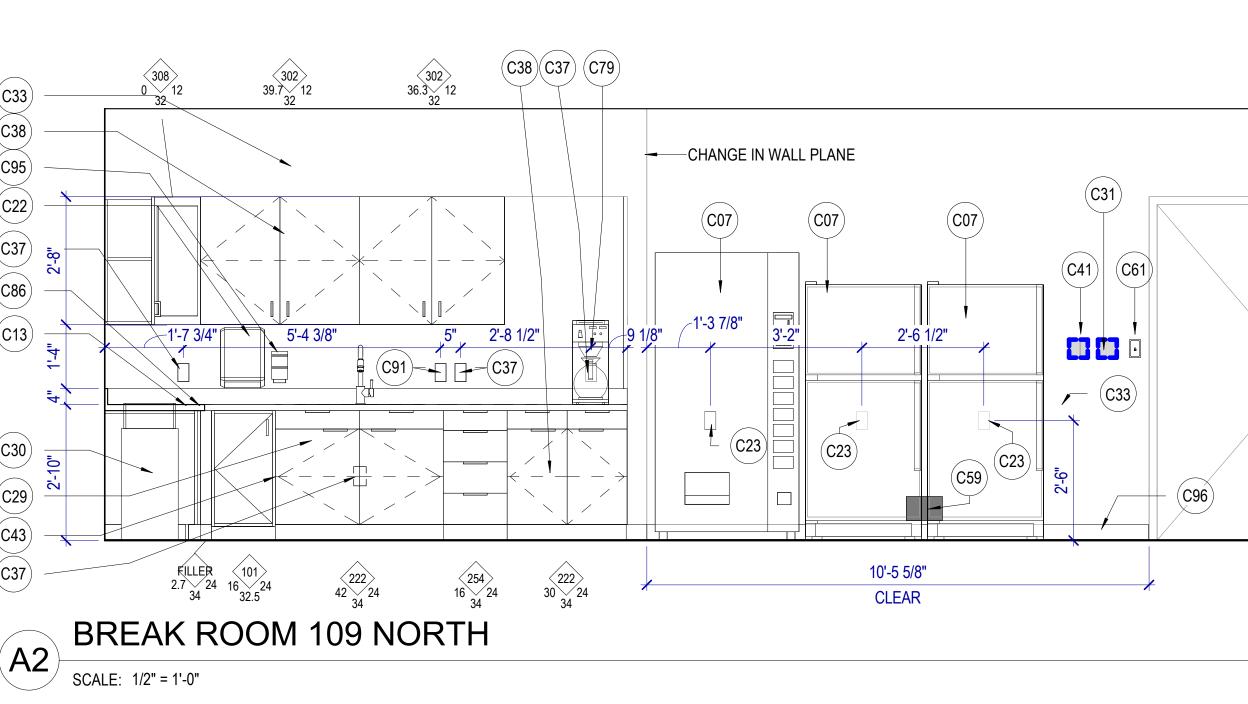
FIRST FLOOR PLAN - AREA B


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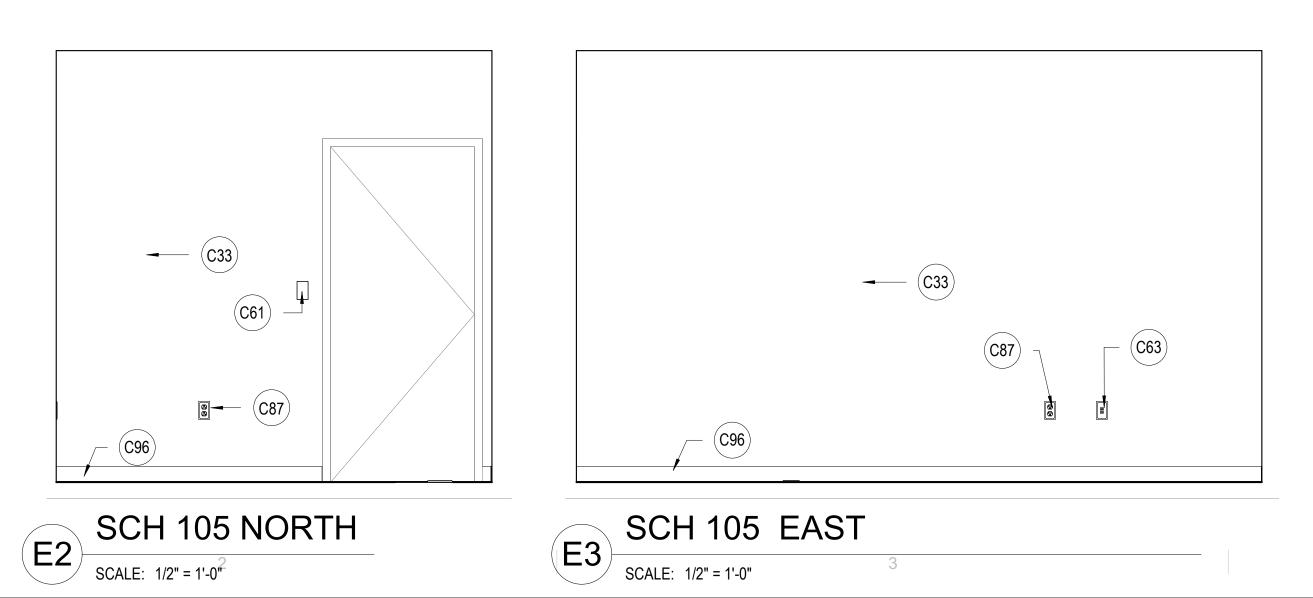








SCALE: 1/2" = 1'-0"

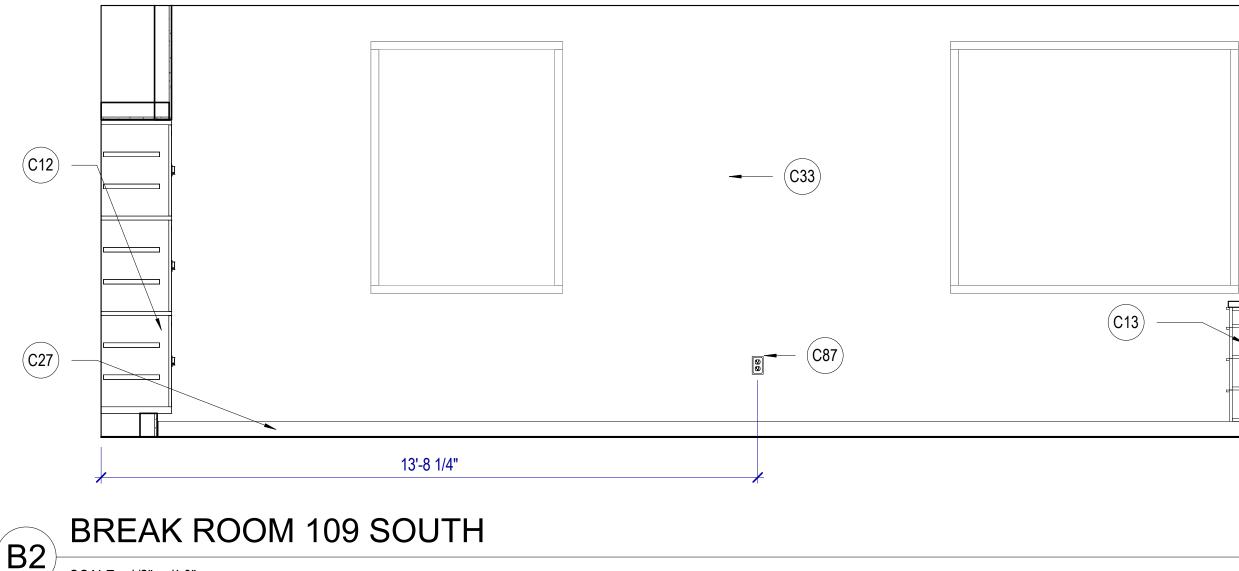

### INTERIOR ELEVATIONS GENERAL NOTES

RE: North American Architectural Woodwork Standards v3.0 (NAAWS), Cabinet Design Series for cabinet types.

RE: A101A for Interior Wall Types.

RE: A101A and A101B for the Finish Schedule.

Dimensions shown to walls or casework are to finished face of wall or cabinet, UNO.

Loose kitchen appliances (mircowaves, coffee maker, refrigerator, vending machines) are N.I.C.

Equipment indicated by dashed lines is a general representation and shown for coordination purposes only.

Mechanical, electrical, plumbing and telecom rough-in locations are shown for general coordination purposes only. Refer to mechanical, electrical, plumbing and telecom drawings.

All unused telephone jacks / data outlets to be removed, wires safed off, and blank plates installed or patch wall. Confirm wall patches locations with Owner.

Countertops: 25" deep with 4" high backsplash, UNO. Provide sidesplashes at walls, tall cabinets or similar transitions.

Blocking: Provide fire retardant plywood blocking in walls at cabinets, wallmounted accessories, equipment, display boards and similar items.

Finishes: Finishes are required on all exposed and semi-exposed surfaces, UNO. Wall elevations are not shown for walls where the Finish Schedule is deemed adequate to convey the intent.

Cabinet Locks: Provide locks on cabinet drawers and doors, keyed alike by room, UNO.

Casework Finishes: Provide laminate finishes on all exposed and semi-exposed surfaces as required by the specifications. Provide laminate finishes on concealed surfaces if required by the specifications. Refer to NAAWS Section 10.4.4 for

	nitions of exposed, semi-exposed and concealed surfaces.
<u>KE</u>	YNOTES
C04	NEW WALL, PAINT, AND BASE


- WALL, FAINT, AND DAGE C07 RELOCATED EXISTING REFRIGERATOR AND VENDING MACHINE
- C12 NEW LOCKERS, BASE, AND SOFFIT. SEE PROJECT MANUAL FOR LOCKER SPECIFICATION.
- C13 NEW CABINETRY, COUNTERTOP, SINK, AND PLUMBING. C22 EXISTING PAPER TOWEL DESPENSOR TO REMAIN, REPOSITION ADJACENT TO SINK. C23 NEW POWER OUTLET OR RELOCATE EXISTING OUTLET, PLACE AT HEIGHT TO MATCH EXISTING UNLESS NOTED OTHERWISE. SEE ELECTRICAL C26 RELOCATE EXISTING FIRE BEACON
- C27 NEW PAINT AND BASE
- C28 EXISTING FIRE CABINET TO REMAIN

C29 CABINET DOORS TO OPEN FOR ACCESSIBILITY COMPLIANT ACCESS C30 NEW CABINET RECYCLE AND WASTE RECEPTICALS

- C31 PATCH AND REPAIR GYPSUM BOARD, NEW PAINT
- C33 NEW PAINT

C13

- C35 ACCESSIBILITY OBSTRUCTION FREE ZONE
- C37 NEW GFCI OUTLET OR RELOCATED GFCI
- C38 NEW CABINETRY
- C41 REMOVE EXISTING TELEPHONE AND / OR CONNECTION PLATE, TERMINATE WIRING AND INSTALL BLANK COVER.
- C43 DOUBLE DOOR CABINET HOUSING FOR SINK DISPOSAL AND PLUMBING AS REQUIRED TO MAINTAIN ACCESSIBILITY AT SINK
- C59 NEW WATER SUPPLY FLUSH BOX WITH DOUBLE VALVE.
- C61 EXISTING LIGHT SWITCH, LOCATION APPROXIMATE
- C63 EXISTING DATA TO REMAIN, LOCATION APPROXIMATE
- C65 NEW FIRE BEACON, SEE ELECTRICAL
- C79 COFFEE MAKER NOT IN CONTRACT
- C80 MICROWAVE NOT IN CONTRACT
- C86 NEW COUNTERTOP WITH ROUNDED EDGES, AND BACKSPLASH. CAULK NO.
- BACKSPLASH AT WALL.
- C87 EXISTING POWER OUTLET TO REMAIN
- C88 NEW BLANK FACE GFCI
- C91 NEW SWITCH FOR GARBAGE DISPOSAL
- C95 MANUAL SOAP DISPENSER
- C96 NEW BASE

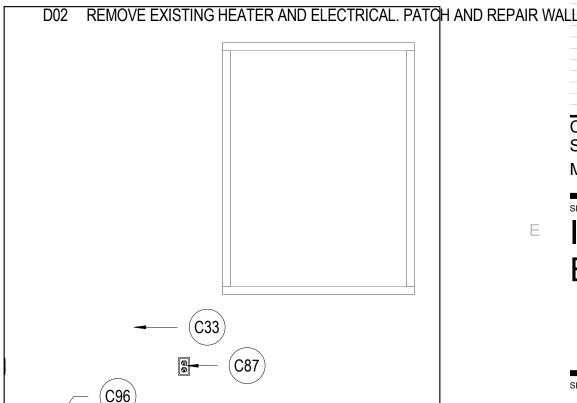



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6480267-0301

19 Feb. 2024

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DESCRIPTION Oct 27, 2023 SCHEMATIC DESIGN

4 Jan 31, 2024 100% CONSTRUCTION DOCS

CONTRACTOR TO VERIFY DRAWINGS IN FIELD USE REFLEC

Nov 14, 2023 60% CONSTRUCTION DOCS Dec 15, 2023 90% CONSTRUCTION DOCS

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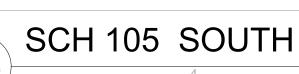
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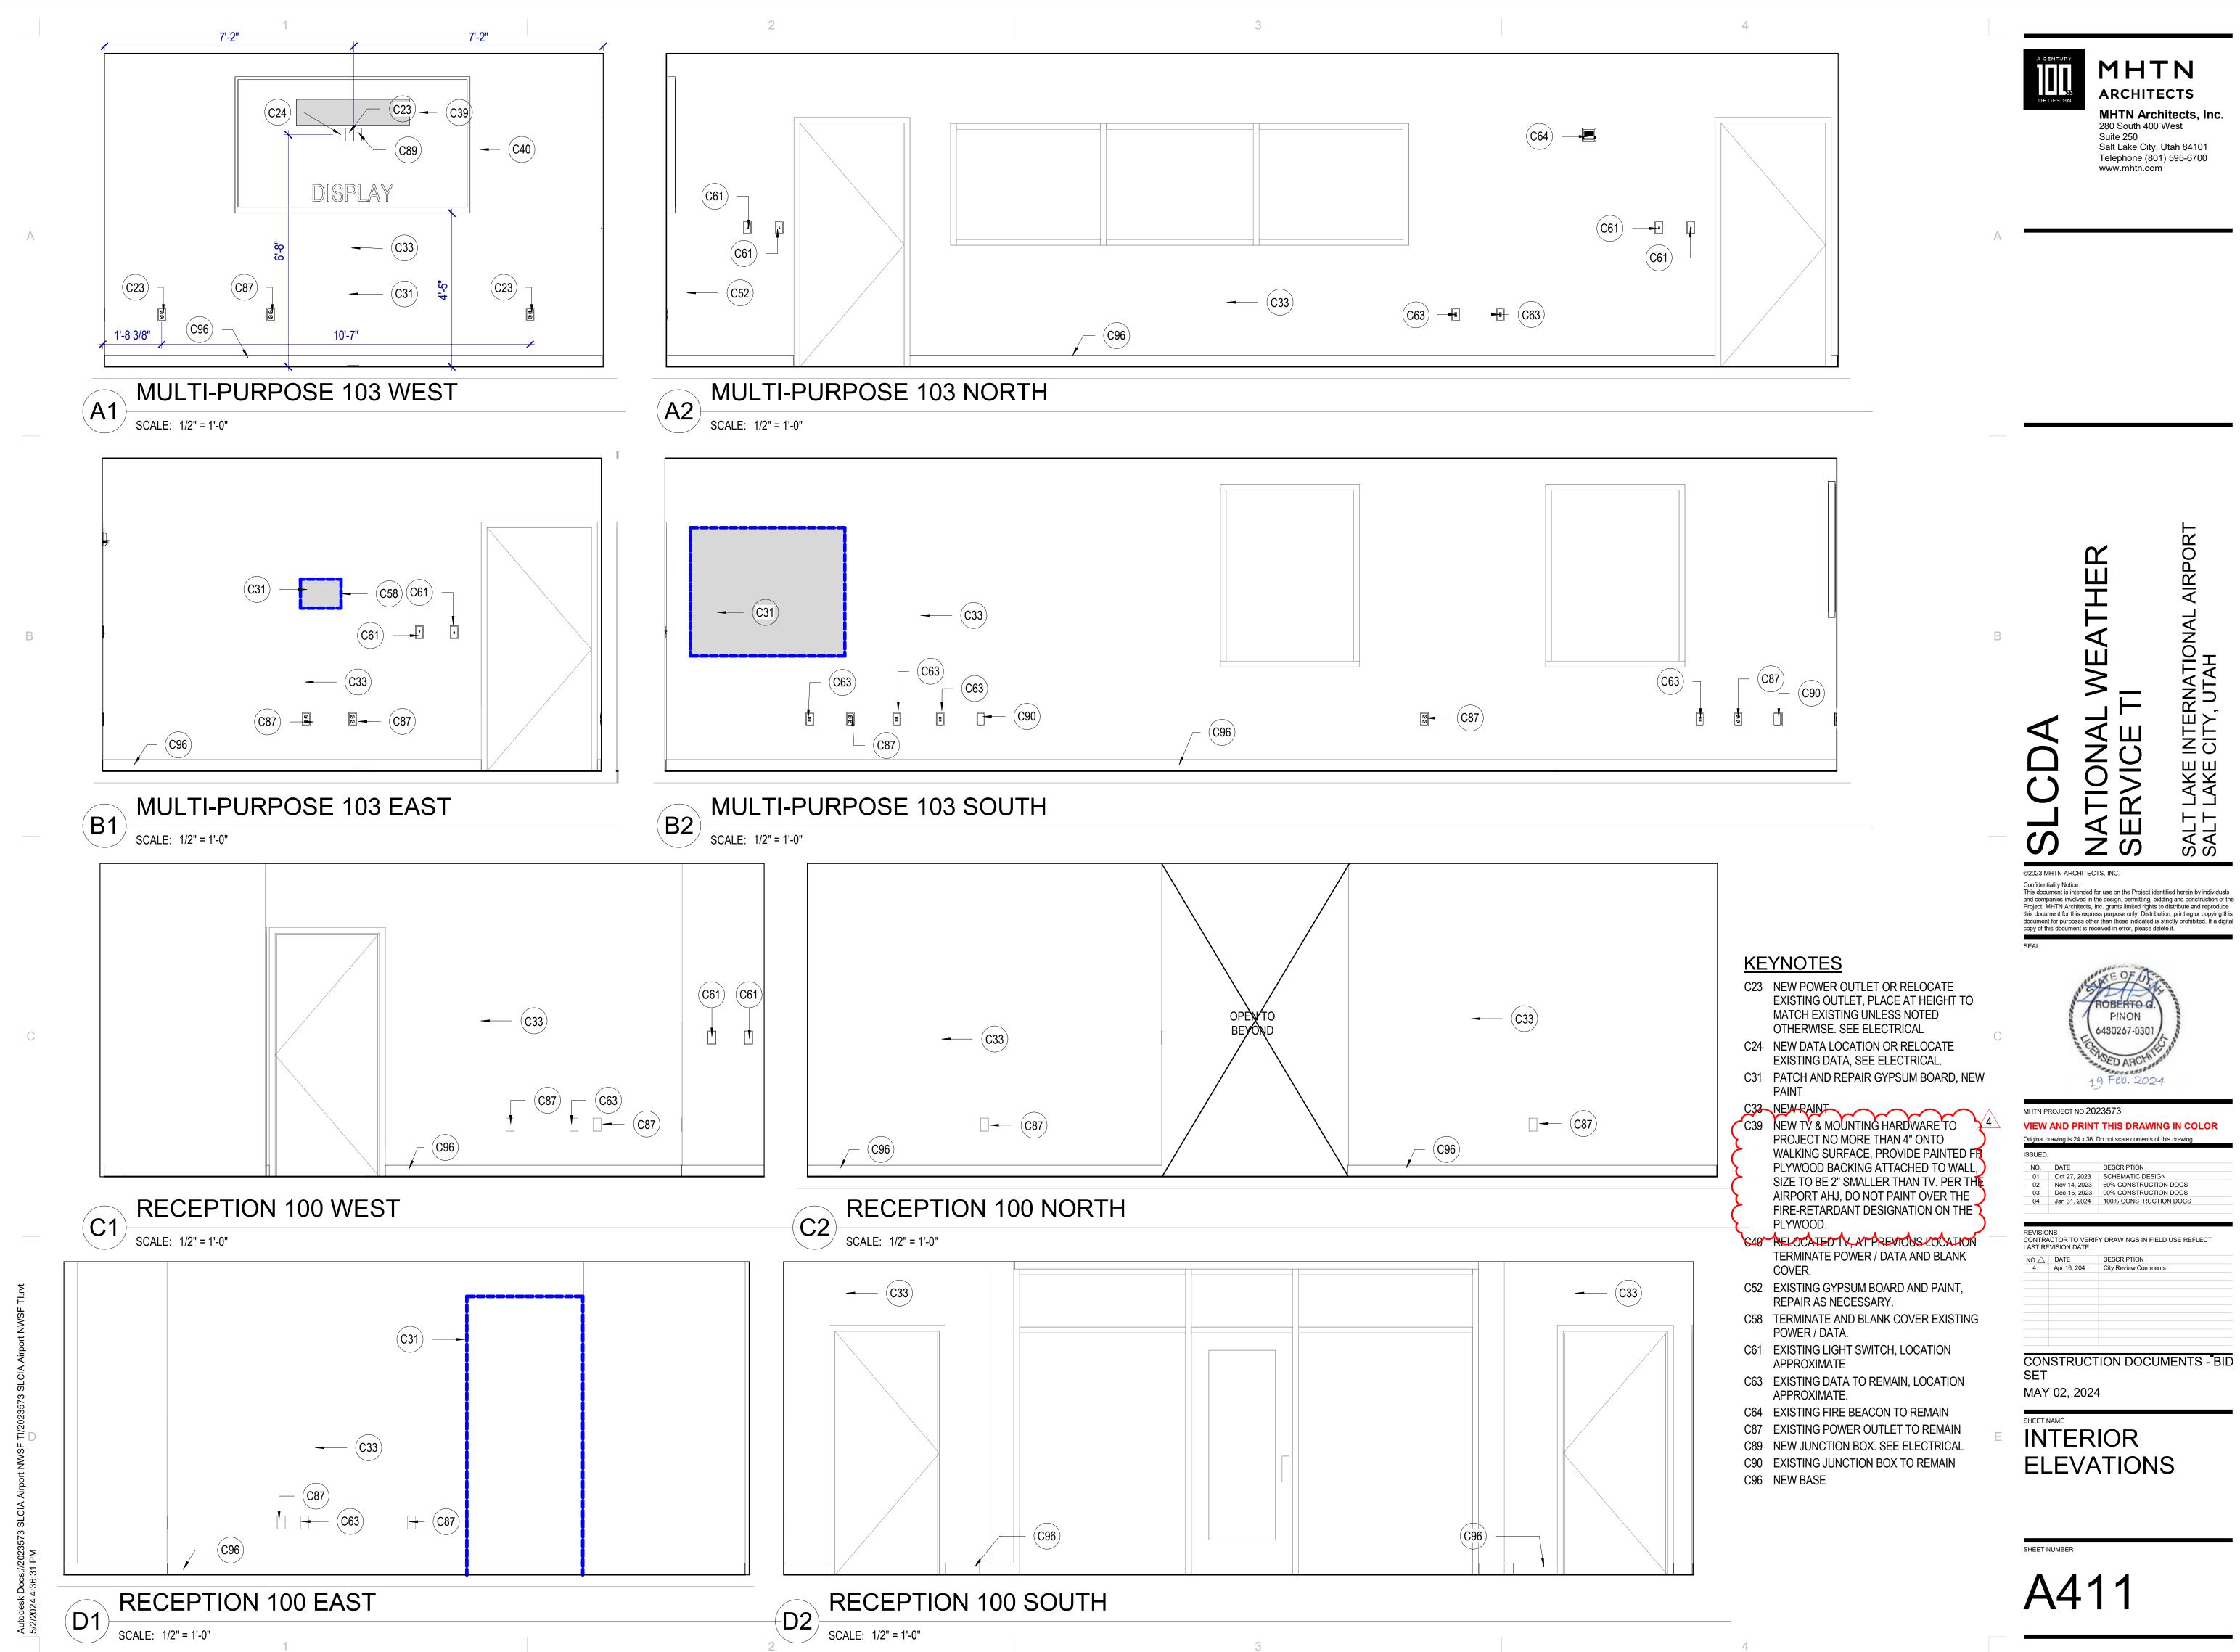



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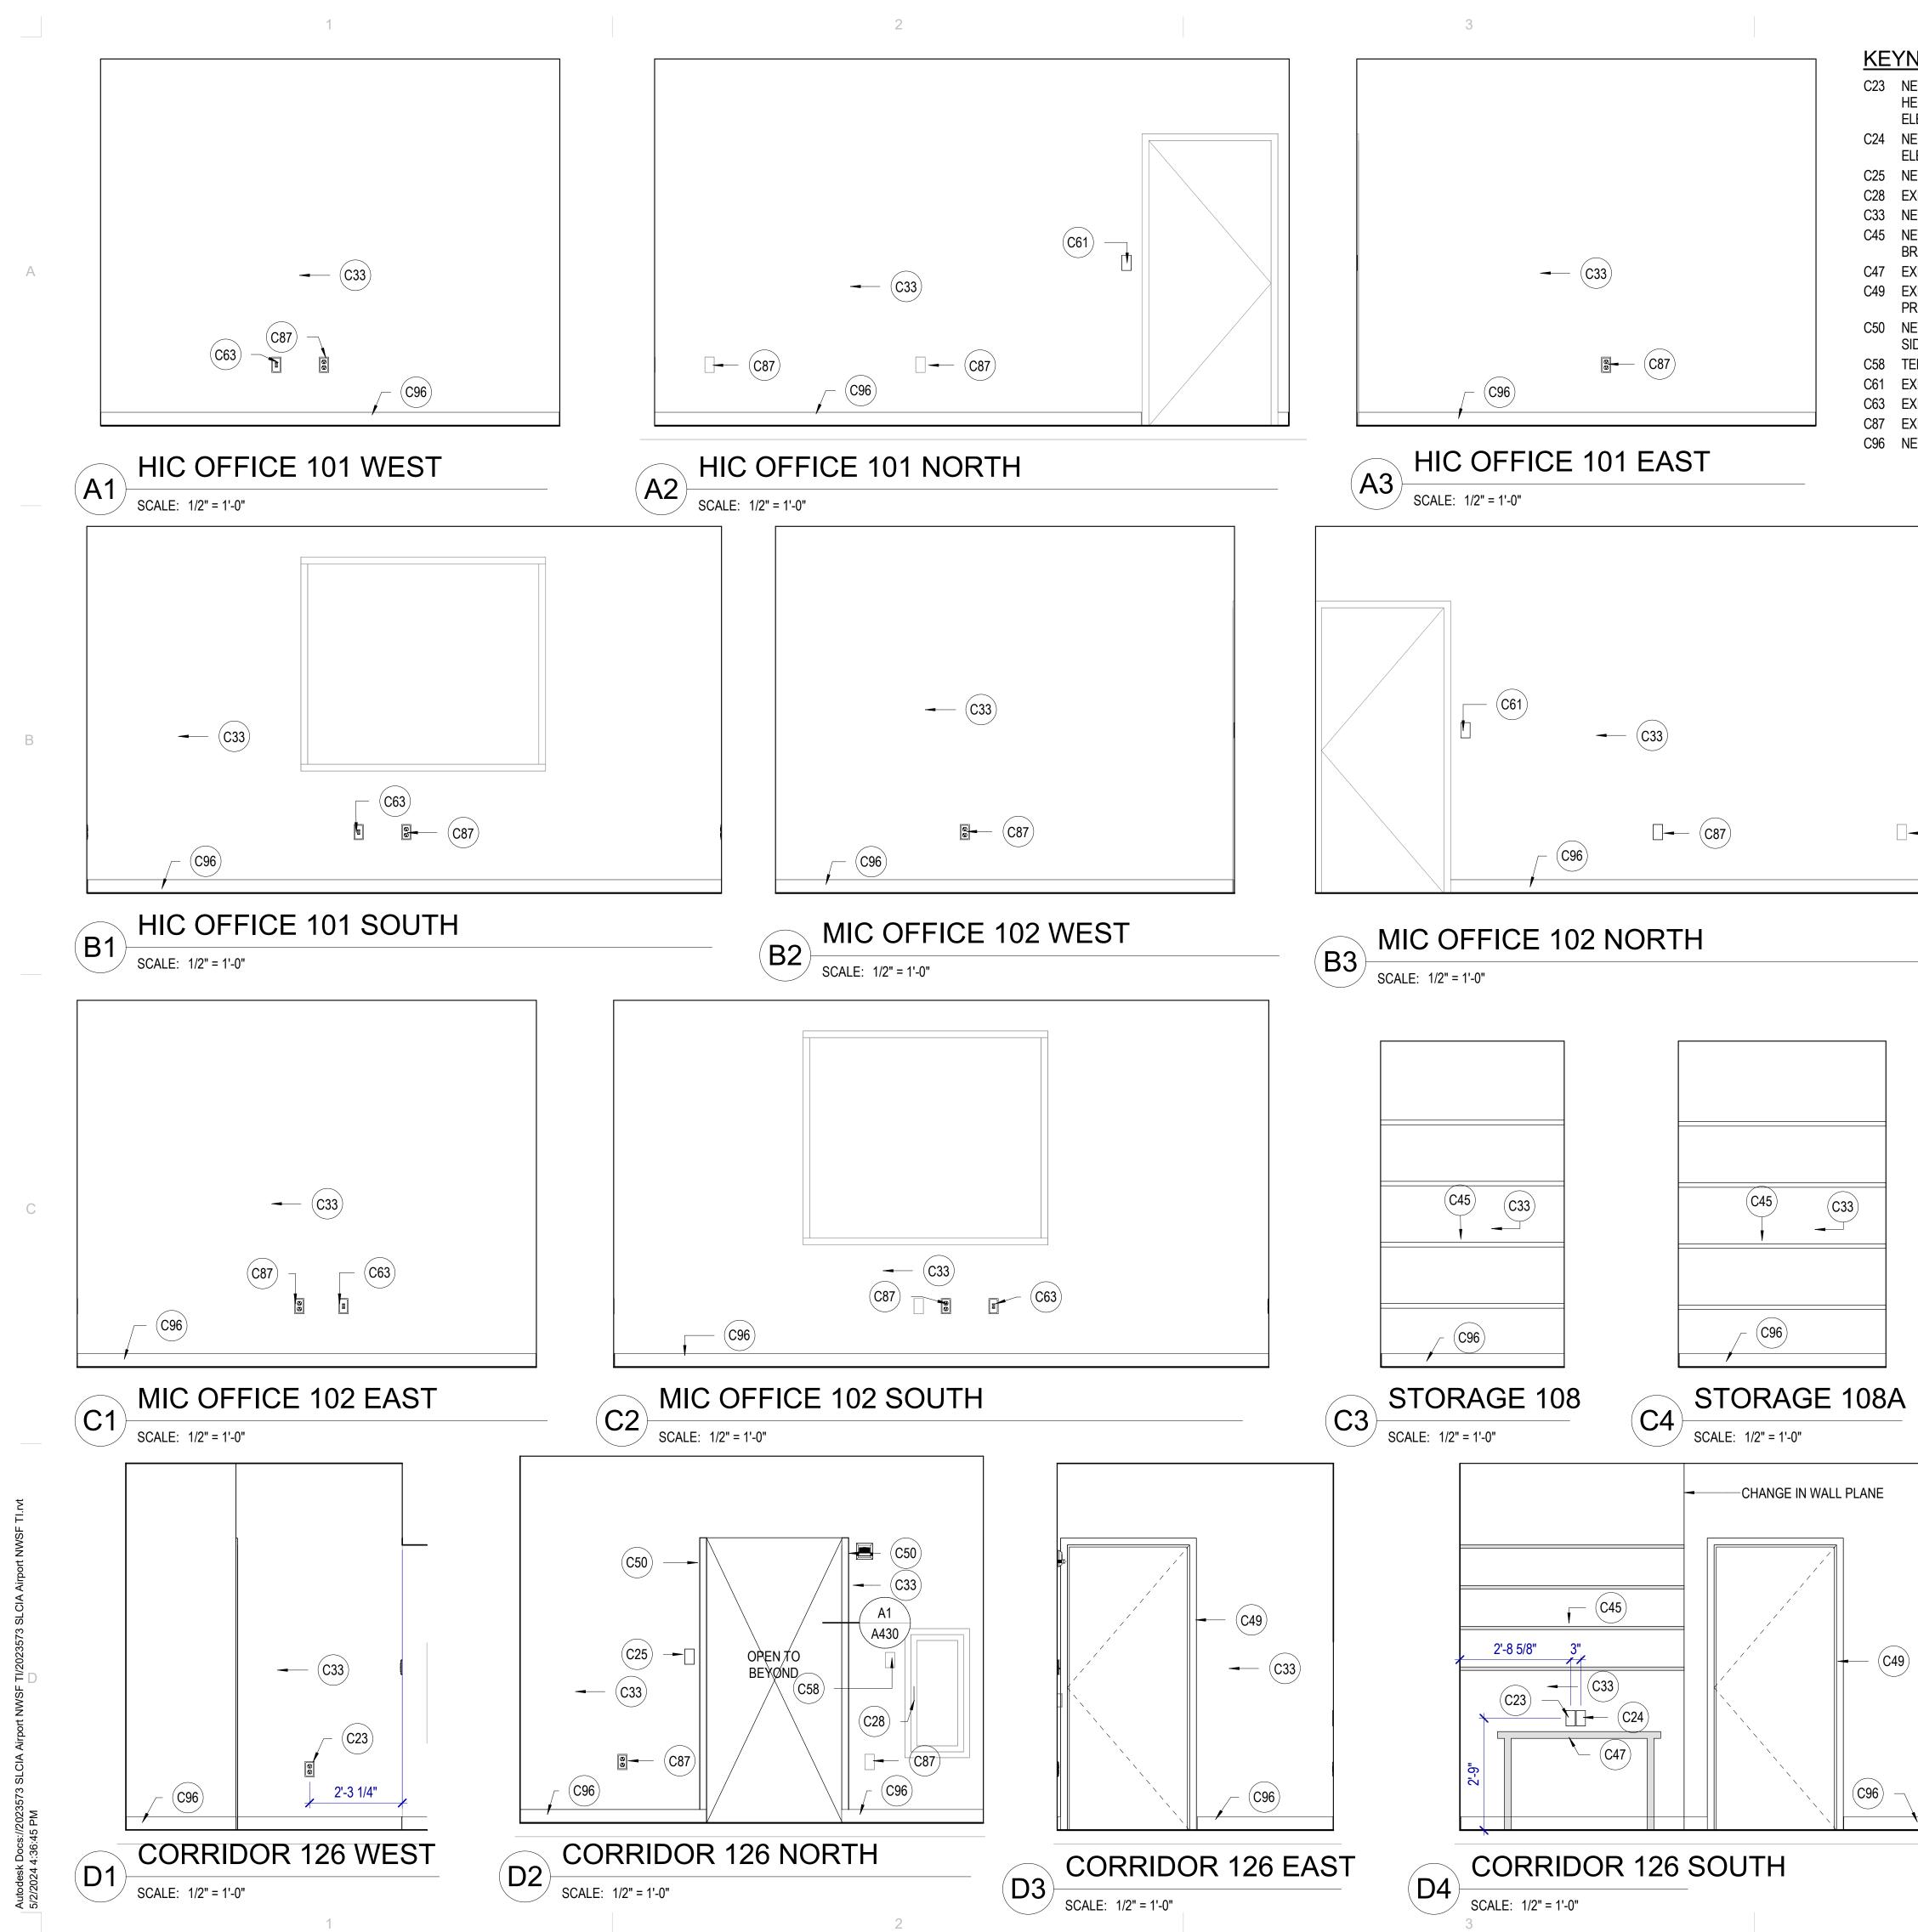




SCALE: 1/2" = 1'-0"





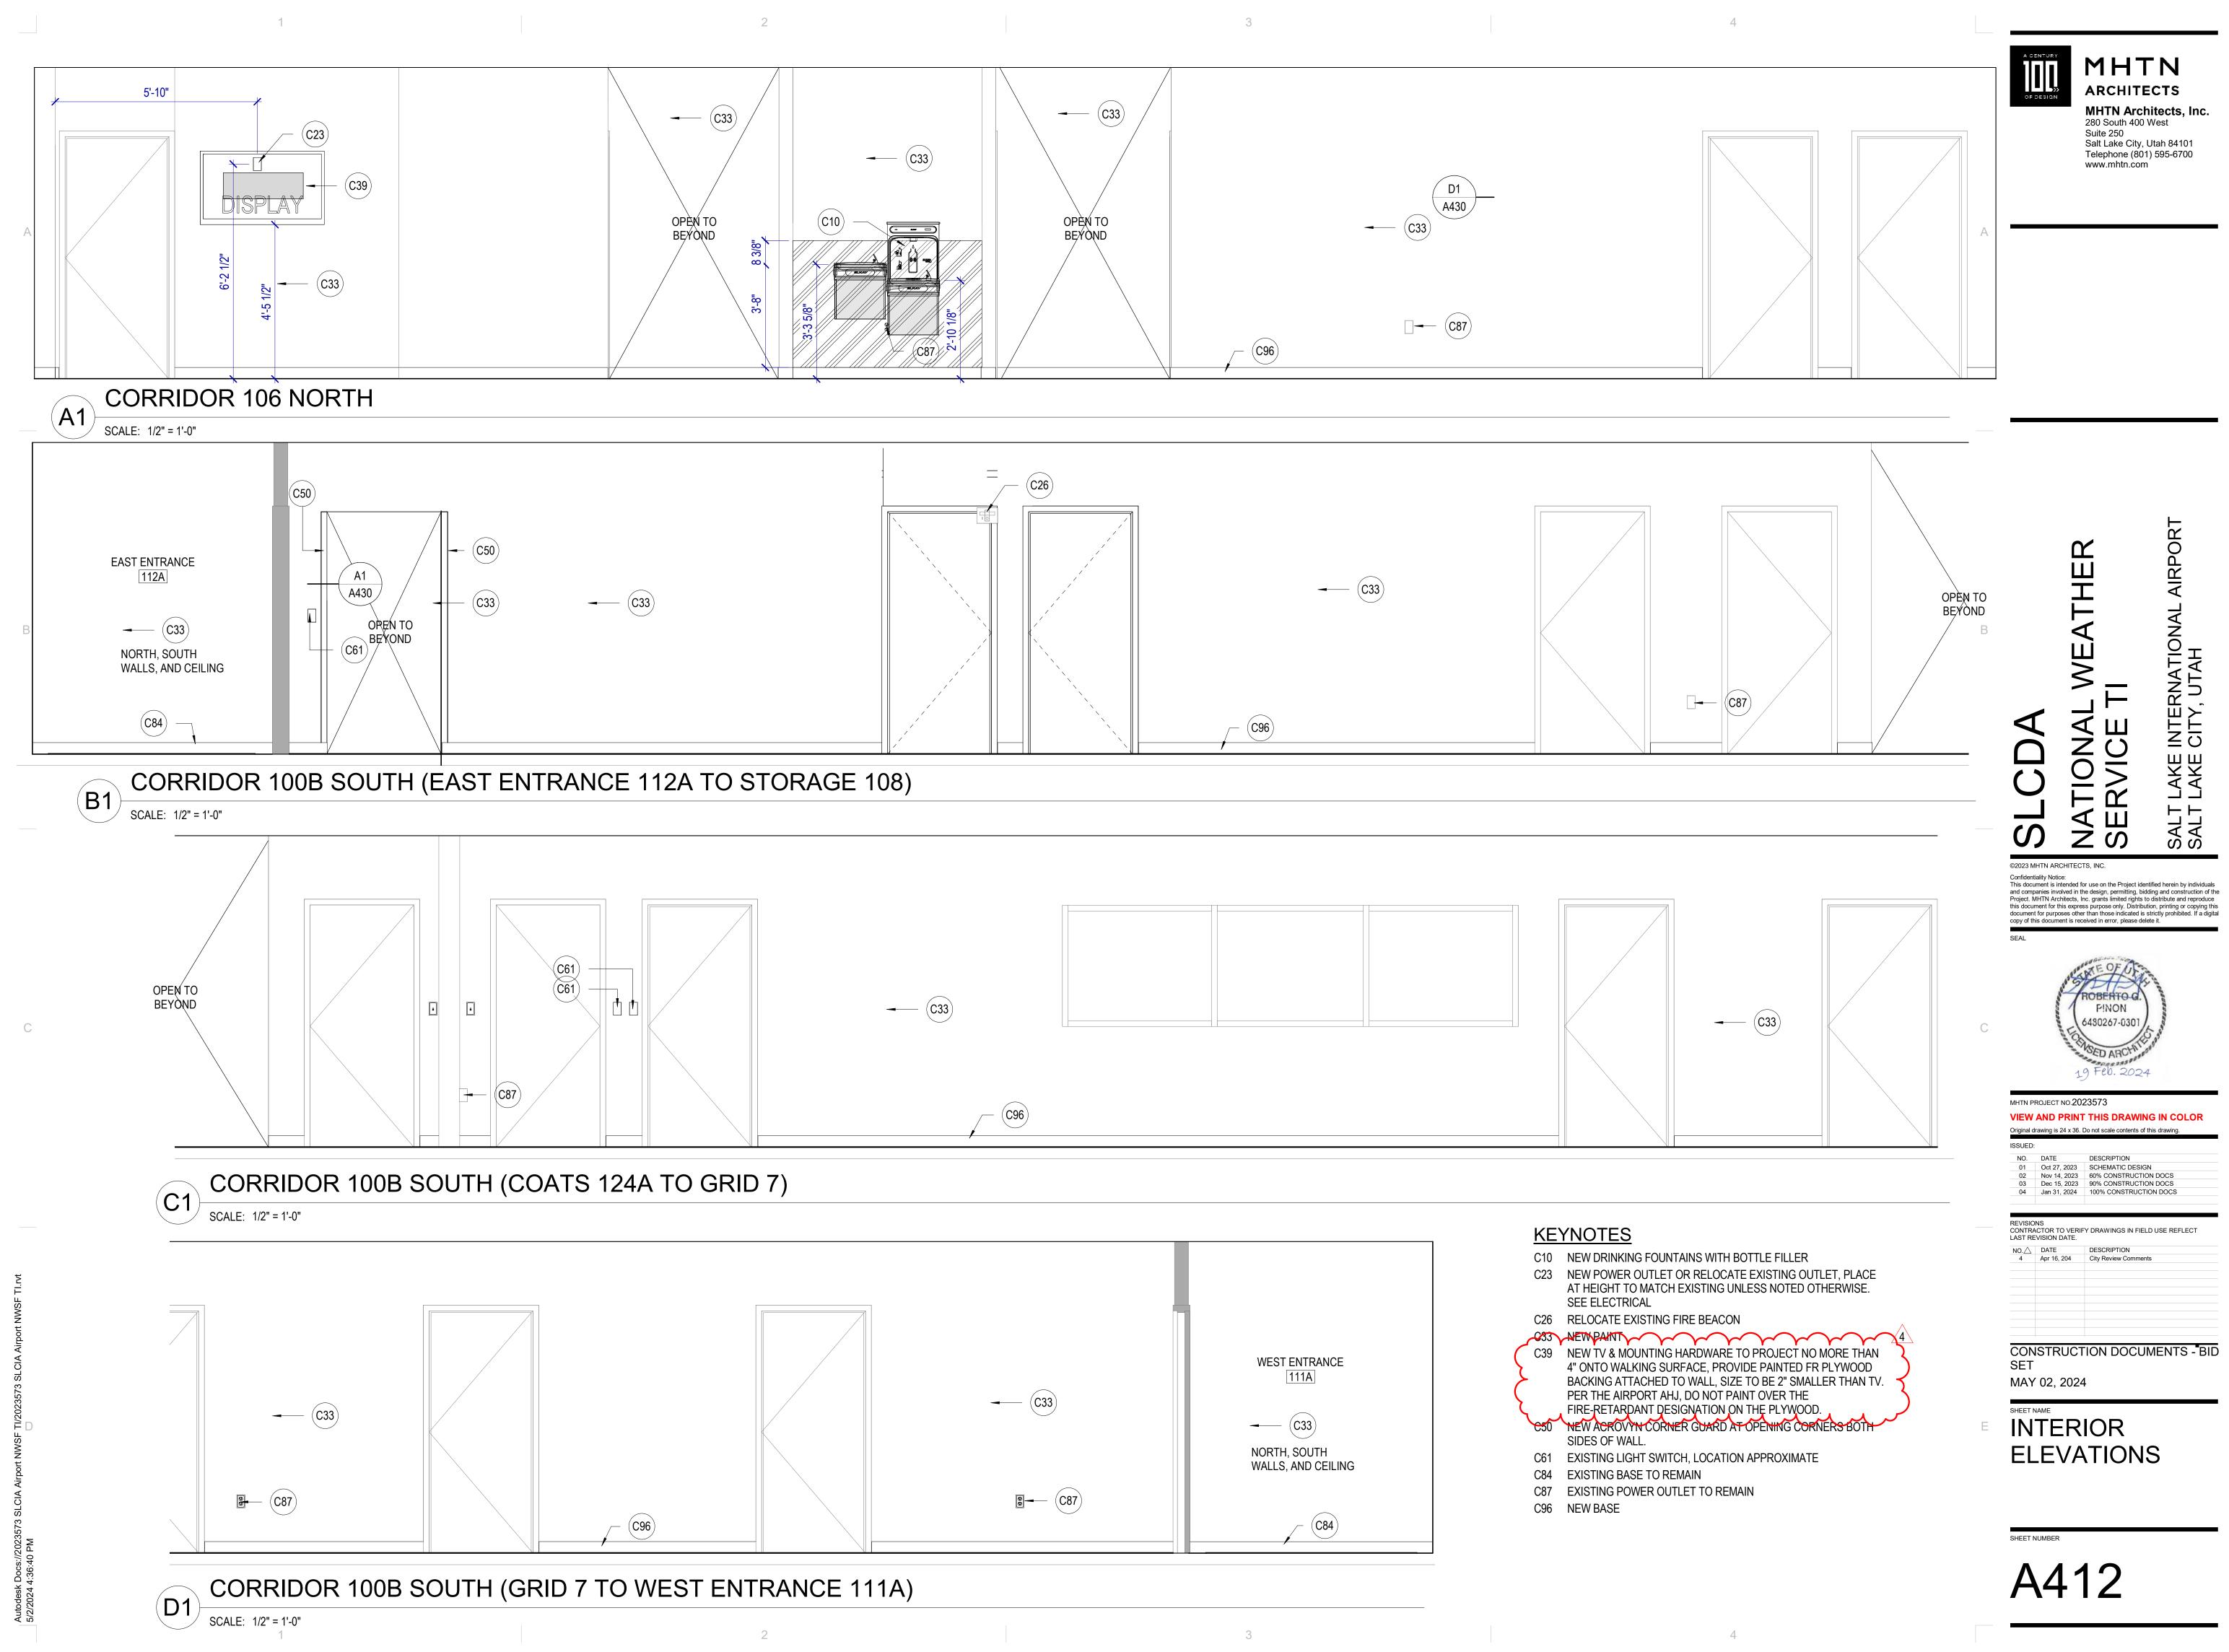

### <u>KEYNOTE</u>S


- C23 NEW POWER OUTLET OR RELOCATE EXISTING OUTLET, PLACE AT HEIGHT TO MATCH EXISTING UNLESS NOTED OTHERWISE. SEE ELECTRICAL
- C24 NEW DATA LOCATION OR RELOCATE EXISTING DATA, SEE ELECTRICAL.
- C25 NEW LIGHT SWITCH OR RELOCATE EXISTING SWITCH
- C28 EXISTING FIRE CABINET TO REMAIN
- C33 NEW PAINT
- C45 NEW SHELVING ABOVE EXISTING FURNITURE, ADJUSTABLE WITH BRACKETS, FULL CLOSET DEPTH.
- C47 EXISTING FURNITURE TO BE RELOCATED TO THIS LOCATION. C49 EXISTING DOOR AND FRAME RELOCATED FROM CORRIDOR, PROTECT FROM DAMAGE AND REPAIR / REPAINT AS NECESSARY.
- C50 NEW ACROVYN CORNER GUARD AT OPENING CORNERS BOTH SIDES OF WALL. C58 TERMINATE AND BLANK COVER EXISTING POWER / DATA.
- C61 EXISTING LIGHT SWITCH, LOCATION APPROXIMATE
- C63 EXISTING DATA TO REMAIN, LOCATION APPROXIMATE.
- C87 EXISTING POWER OUTLET TO REMAIN
- C96 NEW BASE




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A413



- C03 NEW ROLL-IN SHOWER ENCLOSURE AND PLUMBING, TO BE ADA / ABAAS C19 NEW LOW REFRIDGERATOR AND ELECTRICAL, FRIDGE NOT IN C23 NEW POWER OUTLET OR RELOCATE EXISTING OUTLET, PLACE AT HEIGHT TO MATCH EXISTING UNLESS NOTED OTHERWISE. SEE C24 NEW DATA LOCATION OR RELOCATE EXISTING DATA, SEE ELECTRICAL C25 NEW LIGHT SWITCH OR RELOCATE EXISTING SWITCH
- NEW ACCENT PAINT AND BASE, SEE FINISH SCHEDULE.
- TERMINATE AND BLANK COVER EXISTING POWER / DATA.
- NEW LIGHTS SWITCH, HEIGHT TO MATCH EXISTING, SEE ELECTRICAL

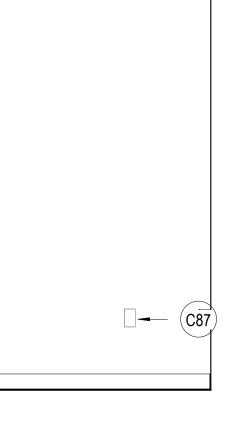

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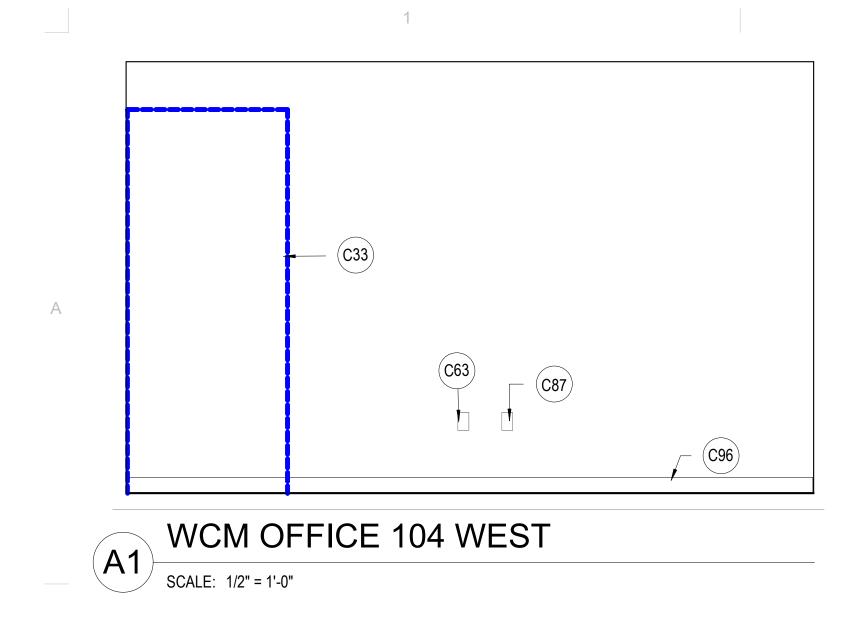
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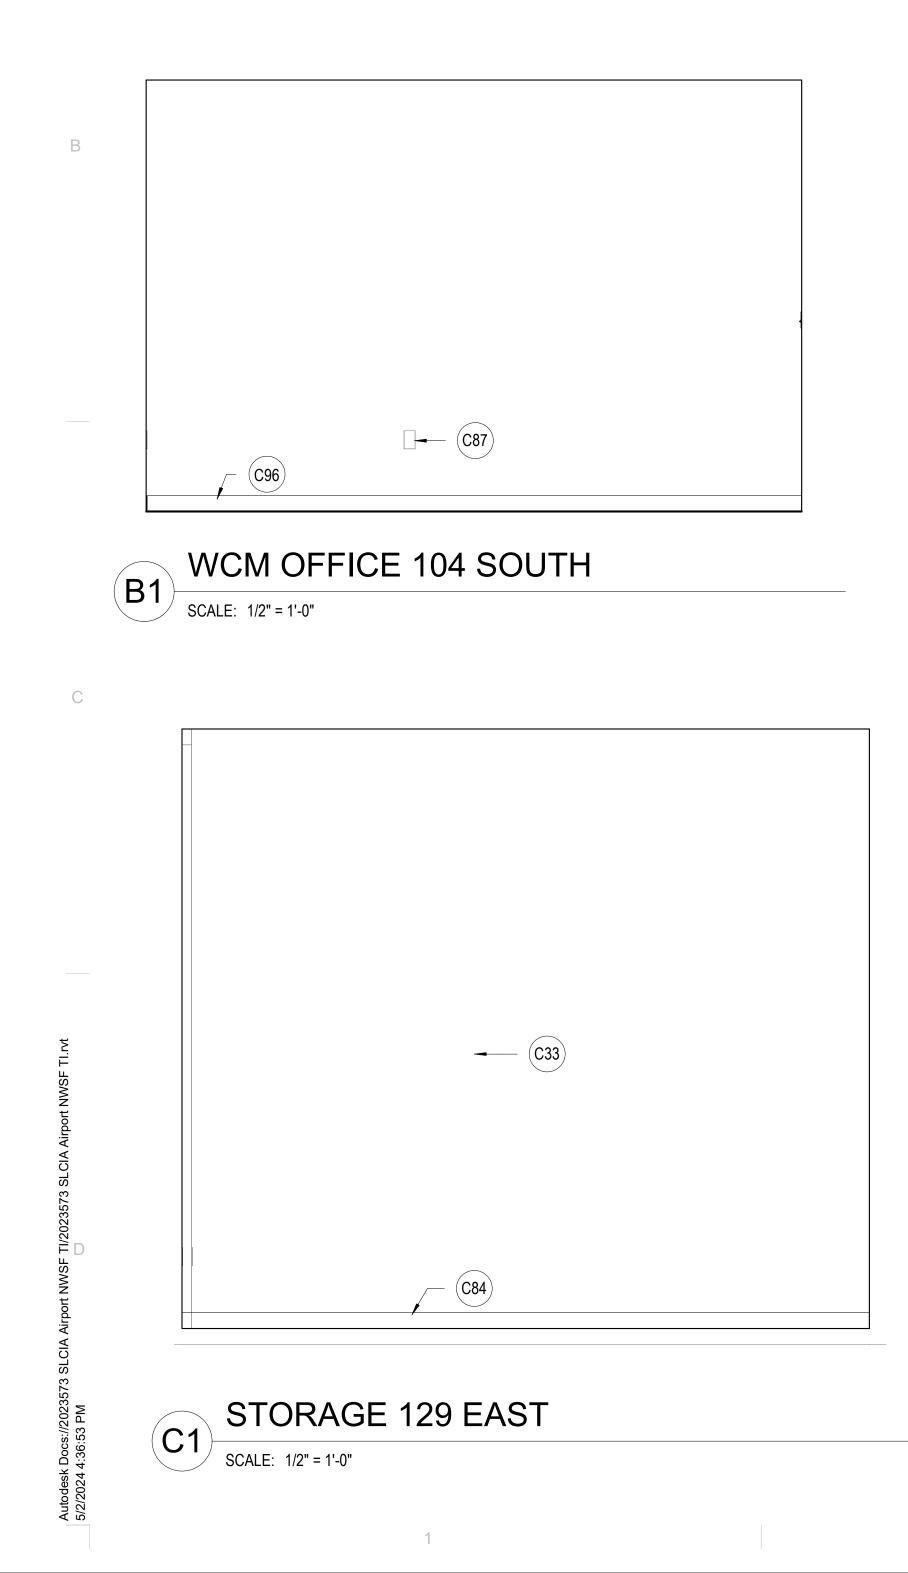
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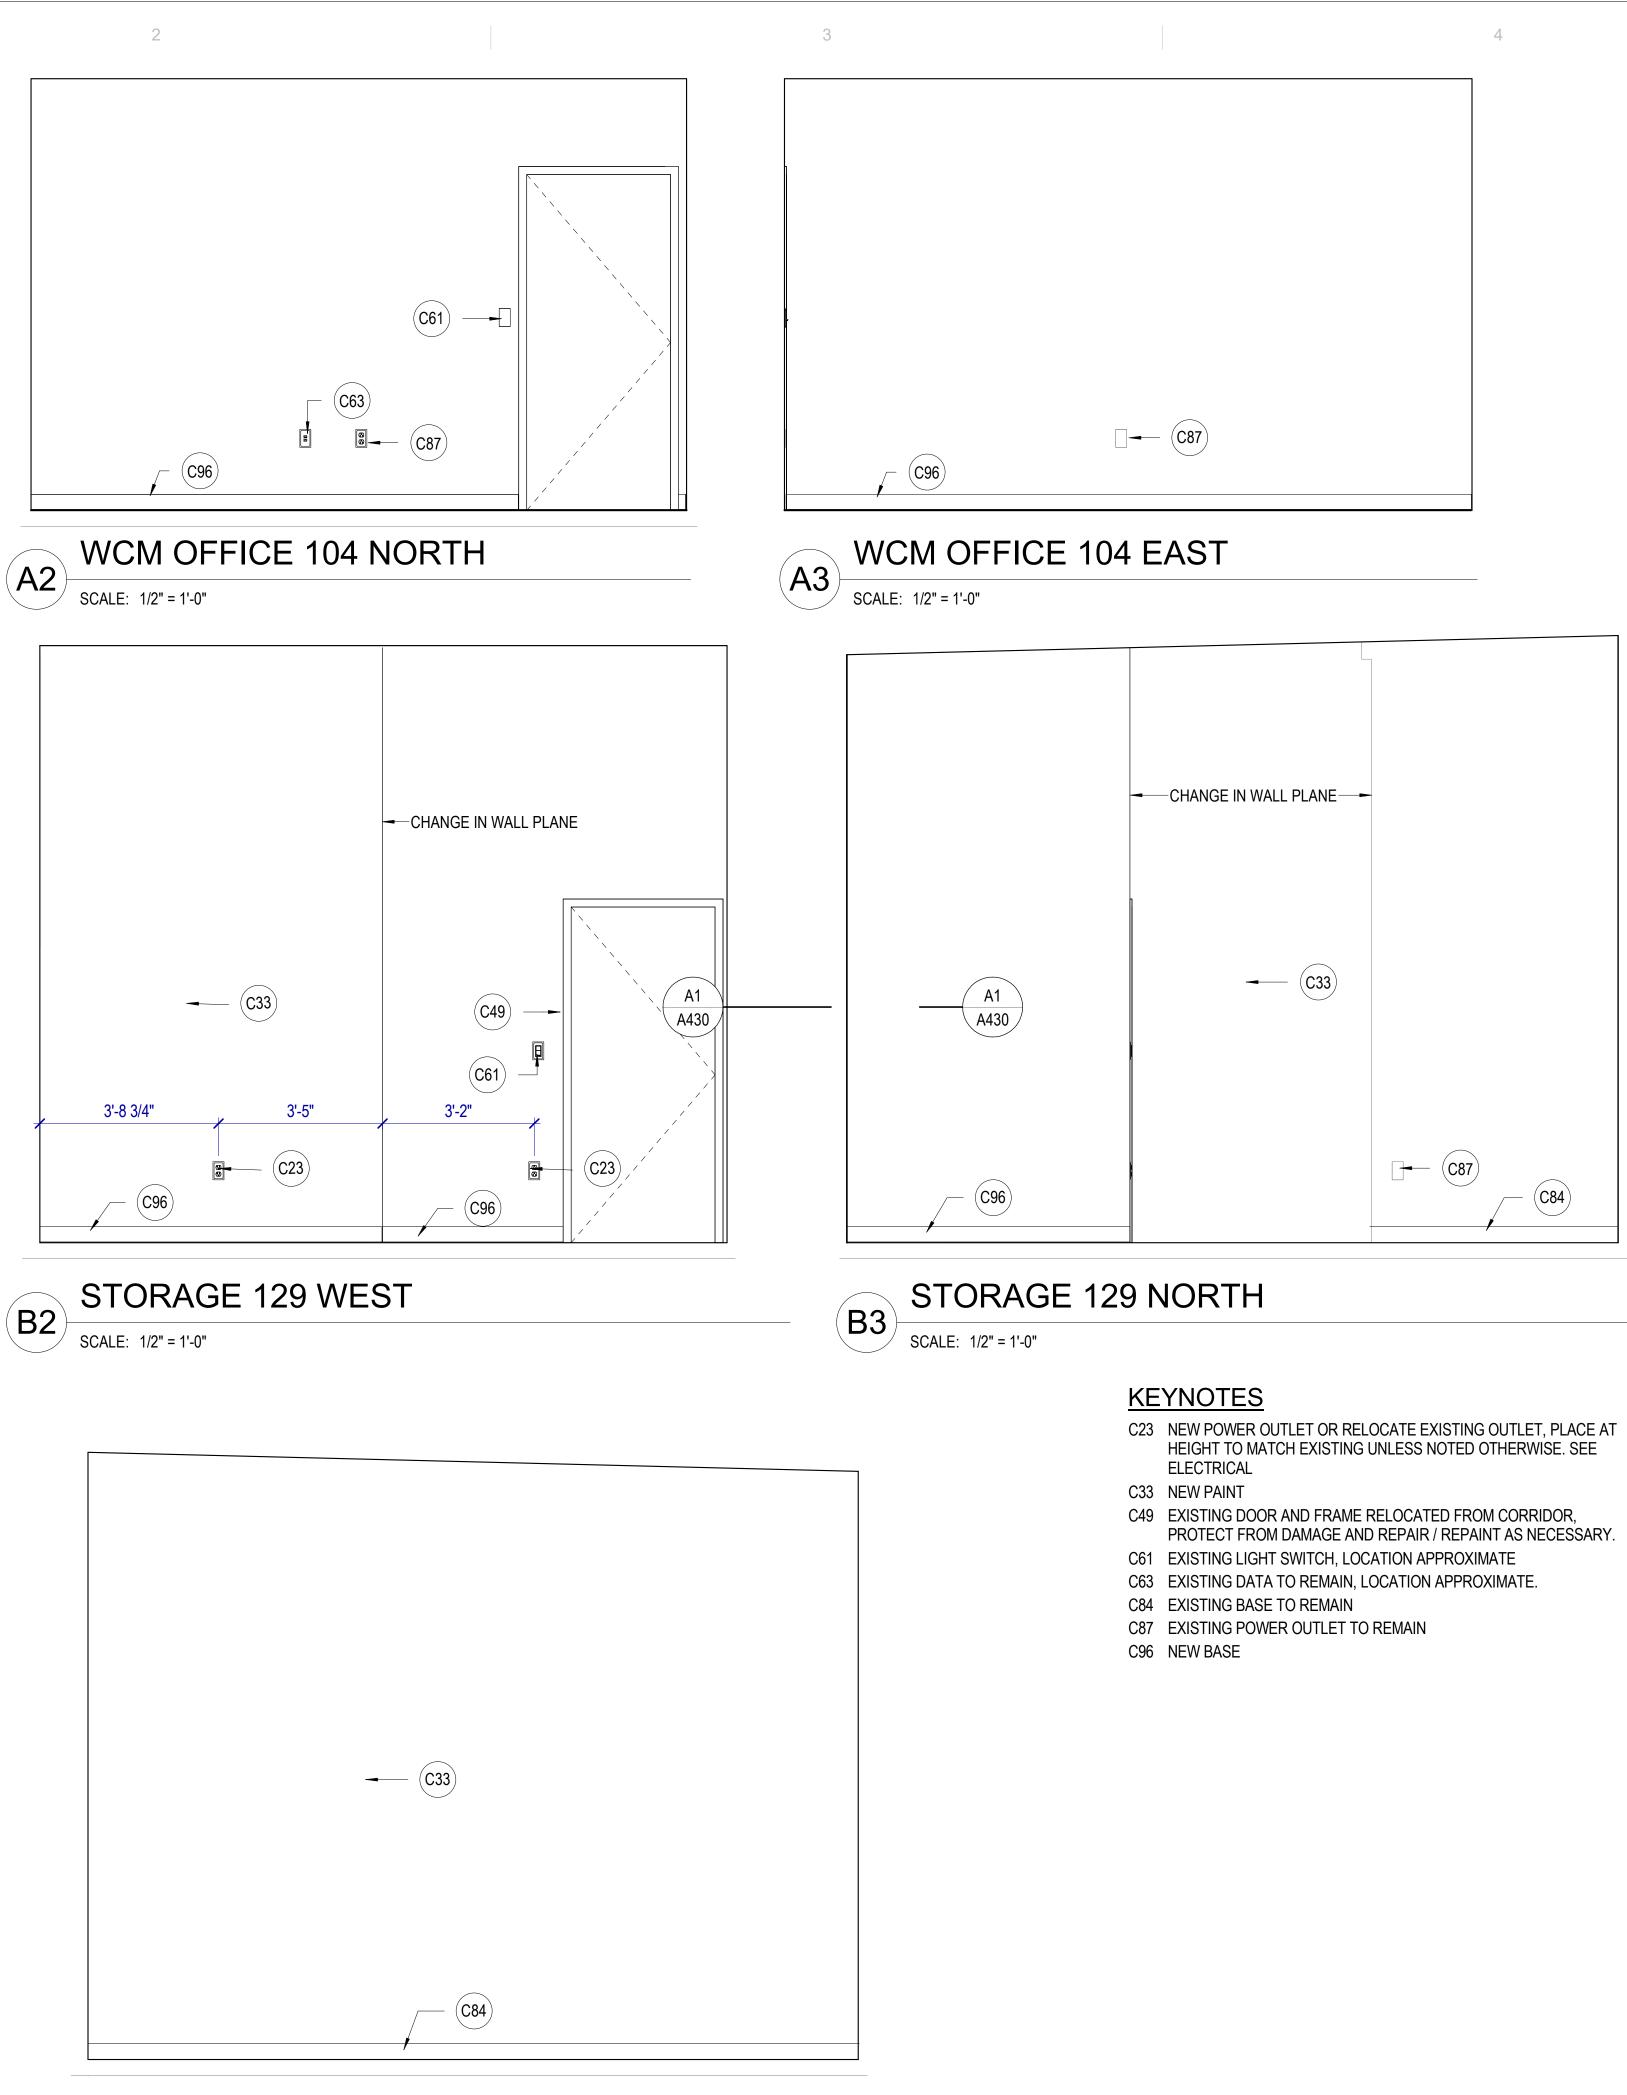
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- SHEET NAME INTERIOR ELEVATIONS
- A414

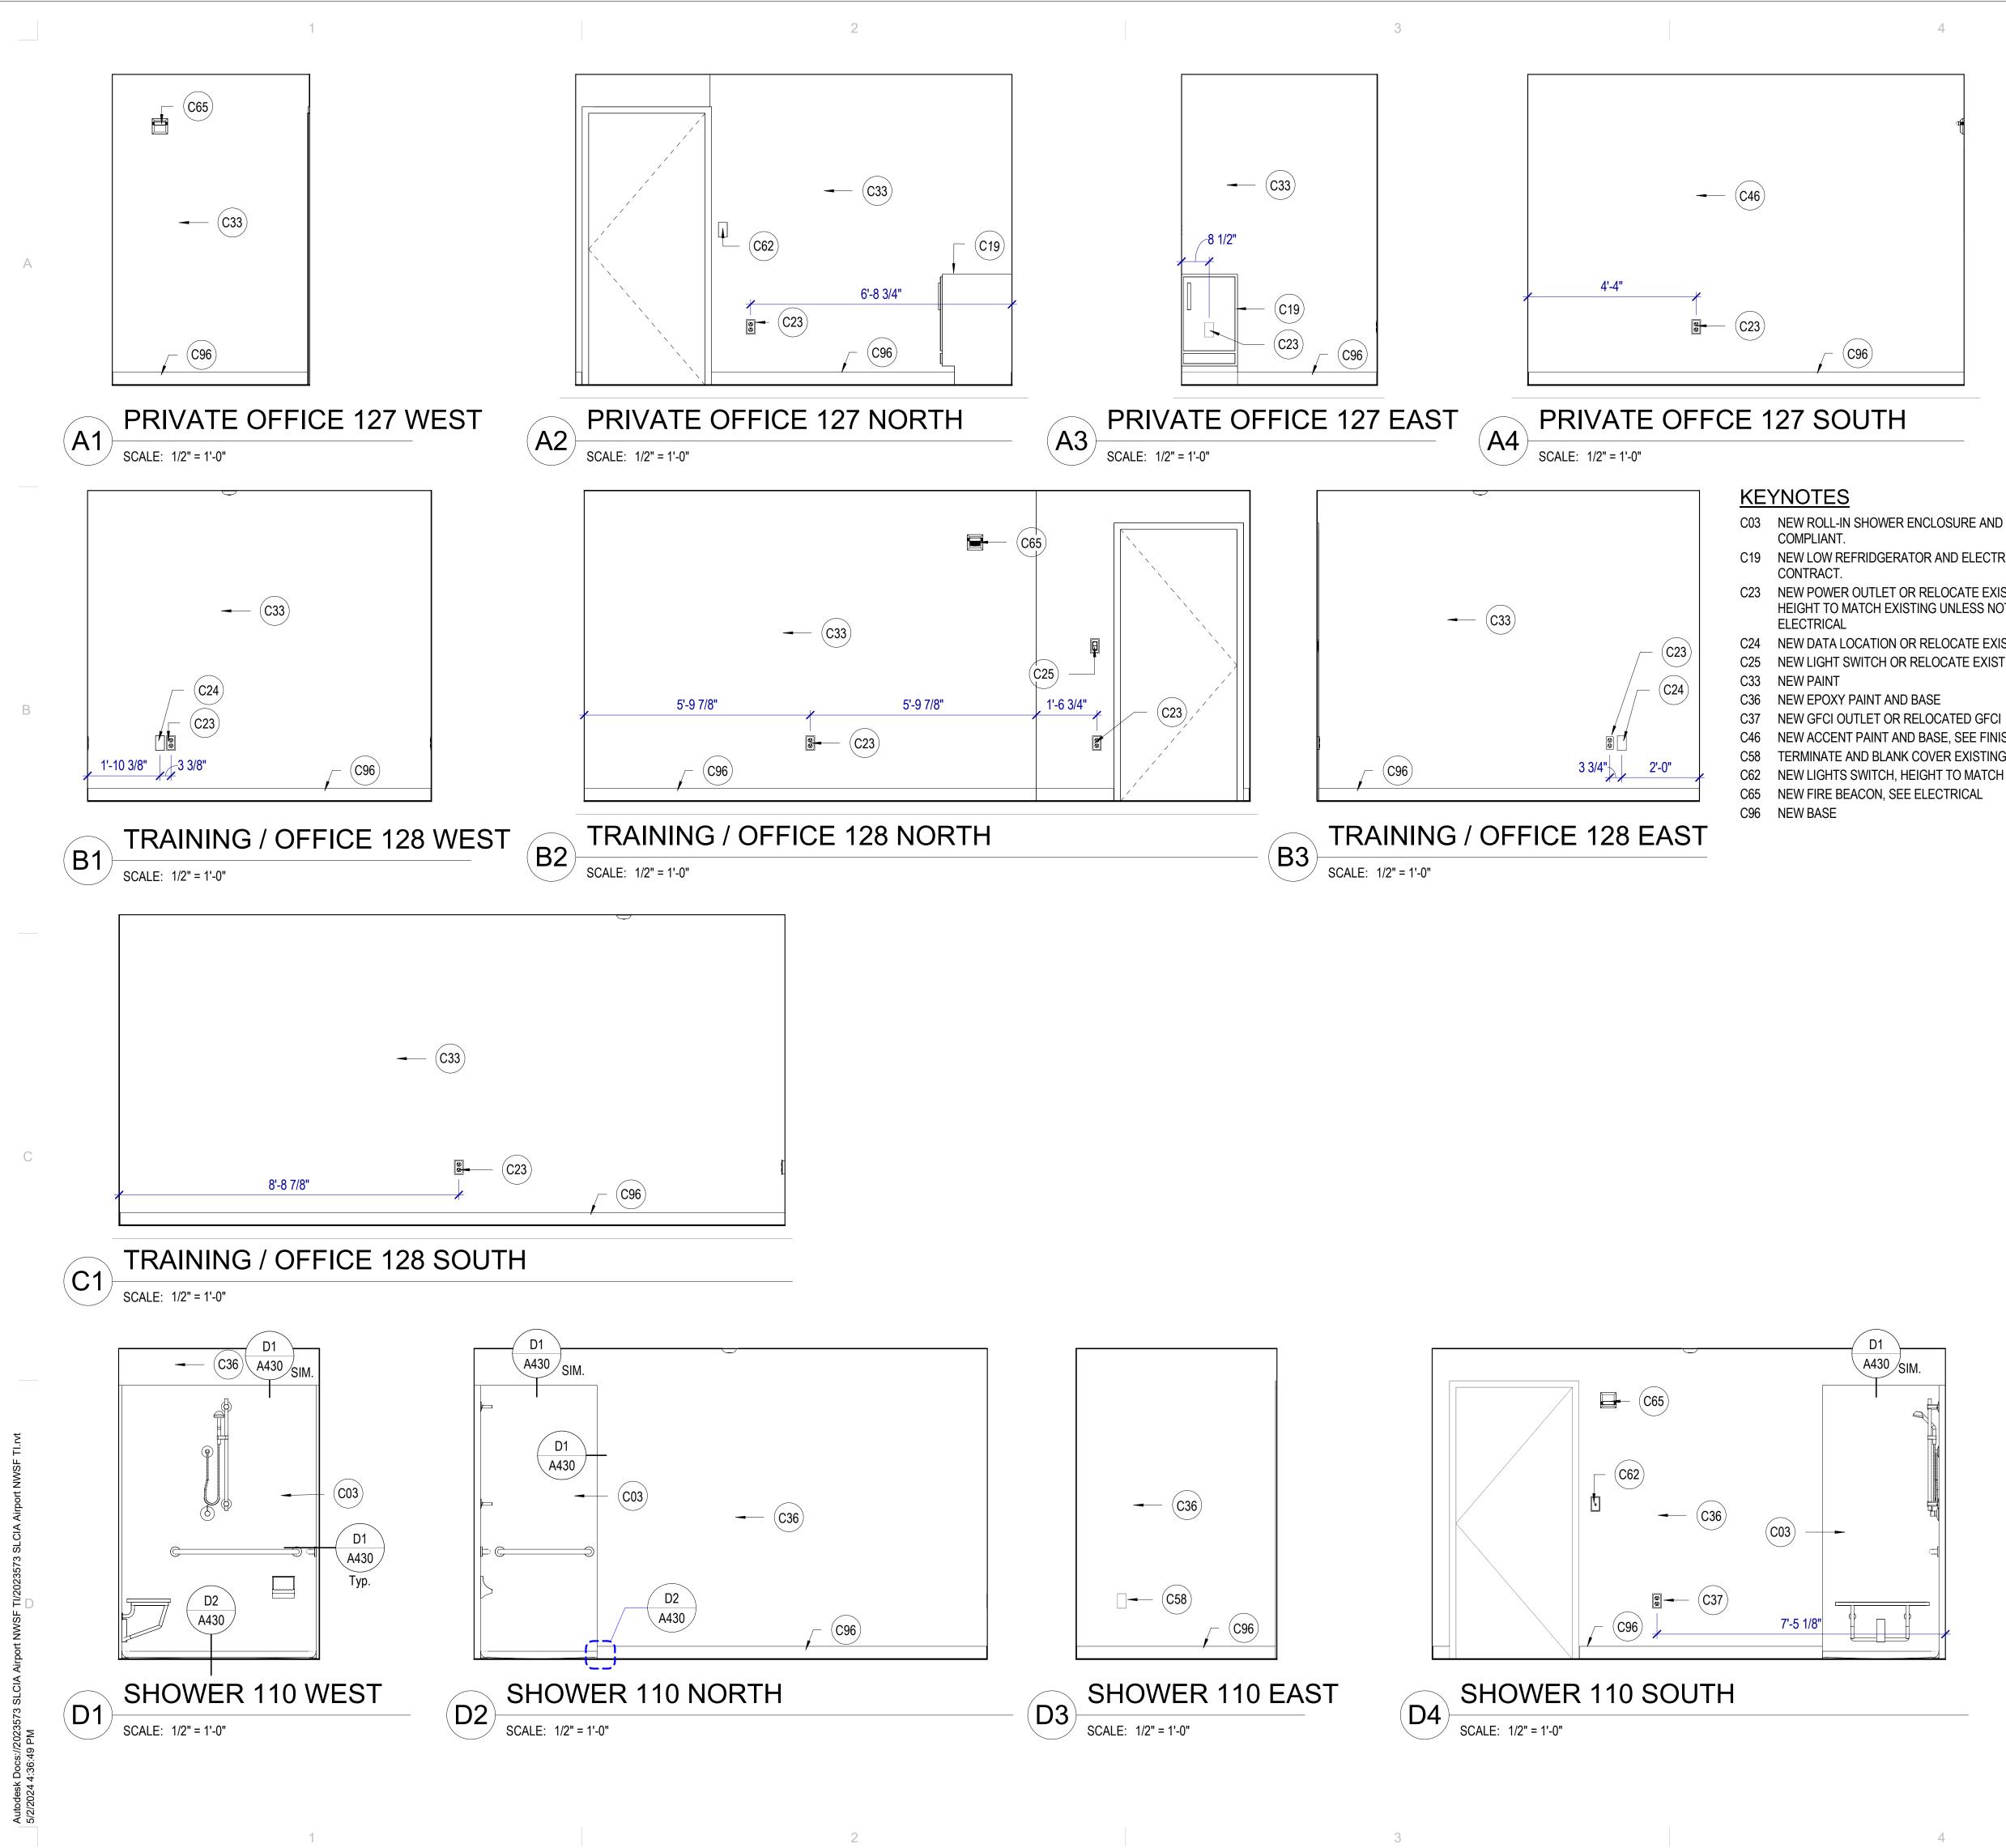SHEET NUMBER








### STORAGE 129 SOUTH C2 SCALE: 1/2" = 1'-0"


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### <u>KEYNOTES</u>

C23 NEW POWER OUTLET OR RELOCATE EXISTING OUTLET, PLACE AT HEIGHT TO MATCH EXISTING UNLESS NOTED OTHERWISE. SEE ELECTRICAL

4

C24 NEW DATA LOCATION OR RELOCATE EXISTING DATA, SEE ELECTRICAL. C39 NEW TV & MOUNTING HARDWARE TO PROJECT NO MORE THAN 4" ONTO

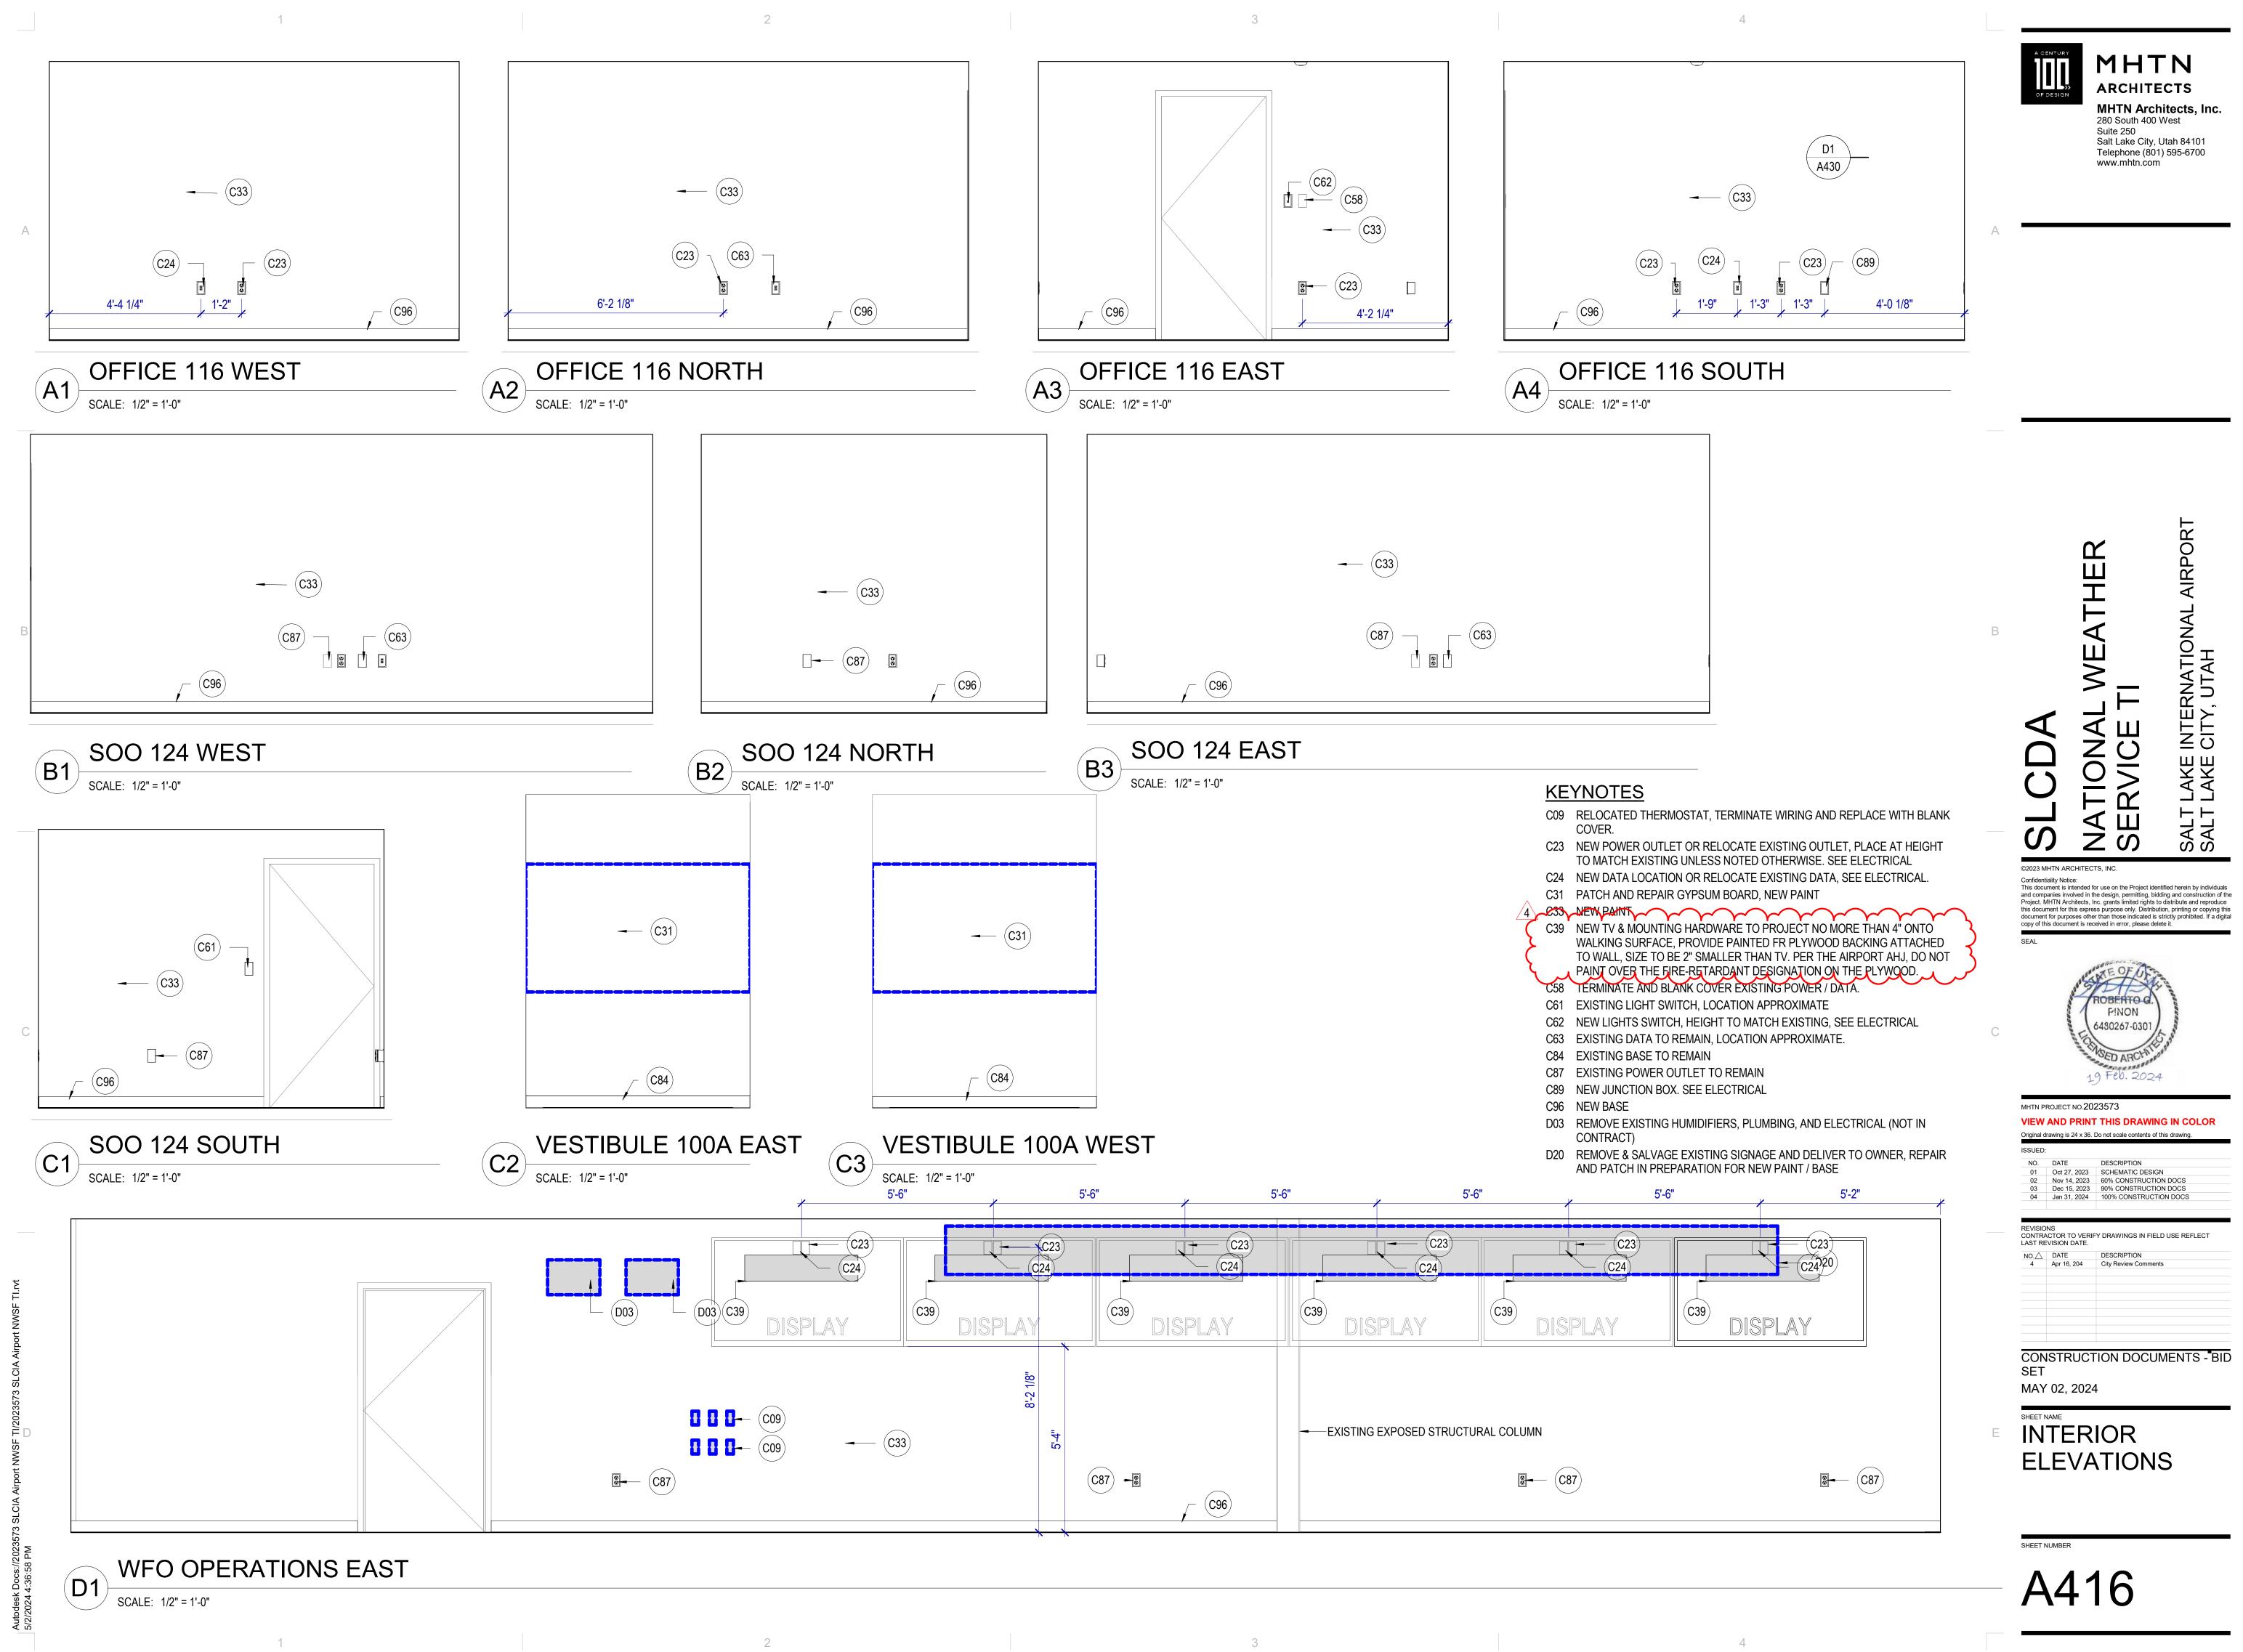- WALKING SURFACE, PROVIDE PAINTED FR PLYWOOD BACKING ATTACHED TO WALL, SIZE TO BE 2" SMALLER THAN TV. PER THE AIRPORT AHJ, DO NOT PAINT OVER THE FIRE-RETARDANT DESIGNATION ON THE
- PLYWOOD. 61 EXISTING LIGHT SWITCH, LOGATION APPROXIMATE
- C63 EXISTING DATA TO REMAIN, LOCATION APPROXIMATE.

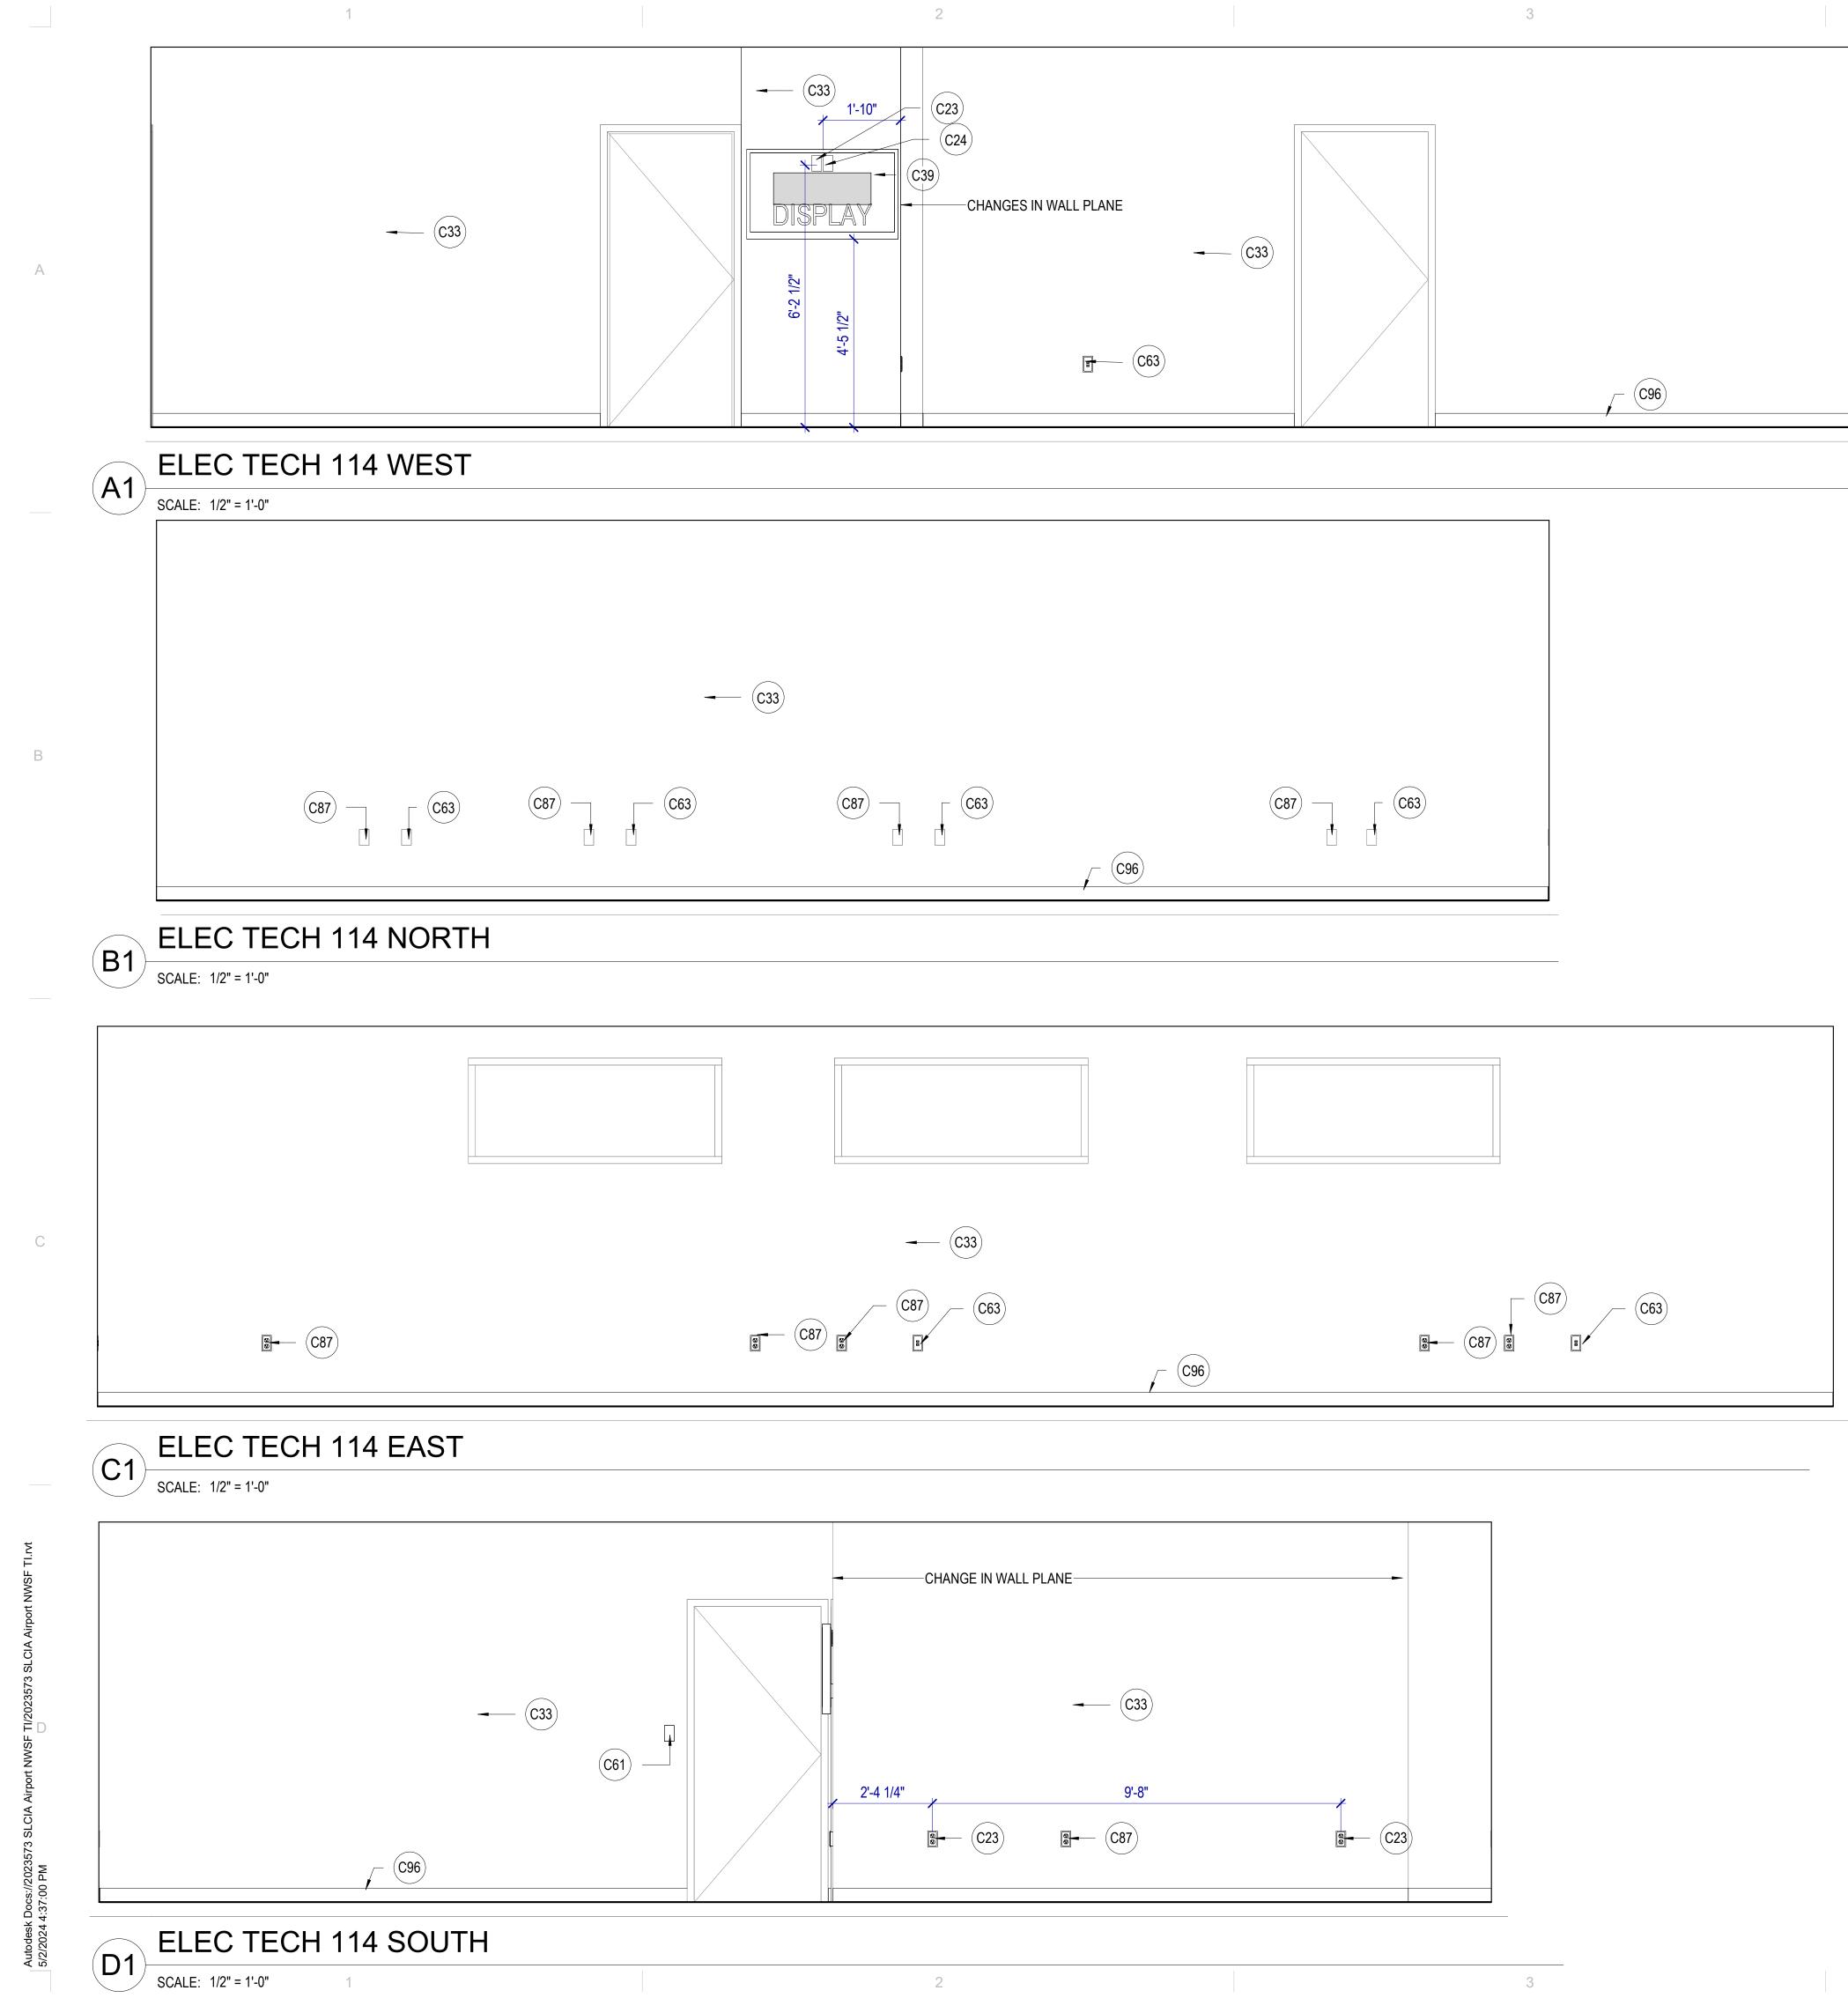
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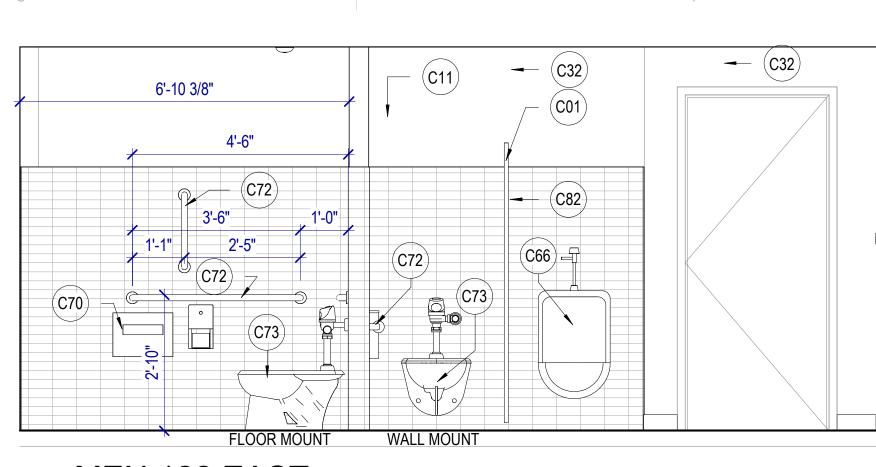
- C87 EXISTING POWER OUTLET TO REMAIN
- C96 NEW BASE




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MEN 122 EAST (A3) SCALE: 1/2" = 1'-0"



WHERE FEASIBLE AND APPROPRIATE EXISTING RESTROOM ACCESSORIES MAY BE RE-USED, EXCEPT PLUMBING FIXTURES OR ACCESSORIES REQUIRING UPDATE WITH SENSORS.

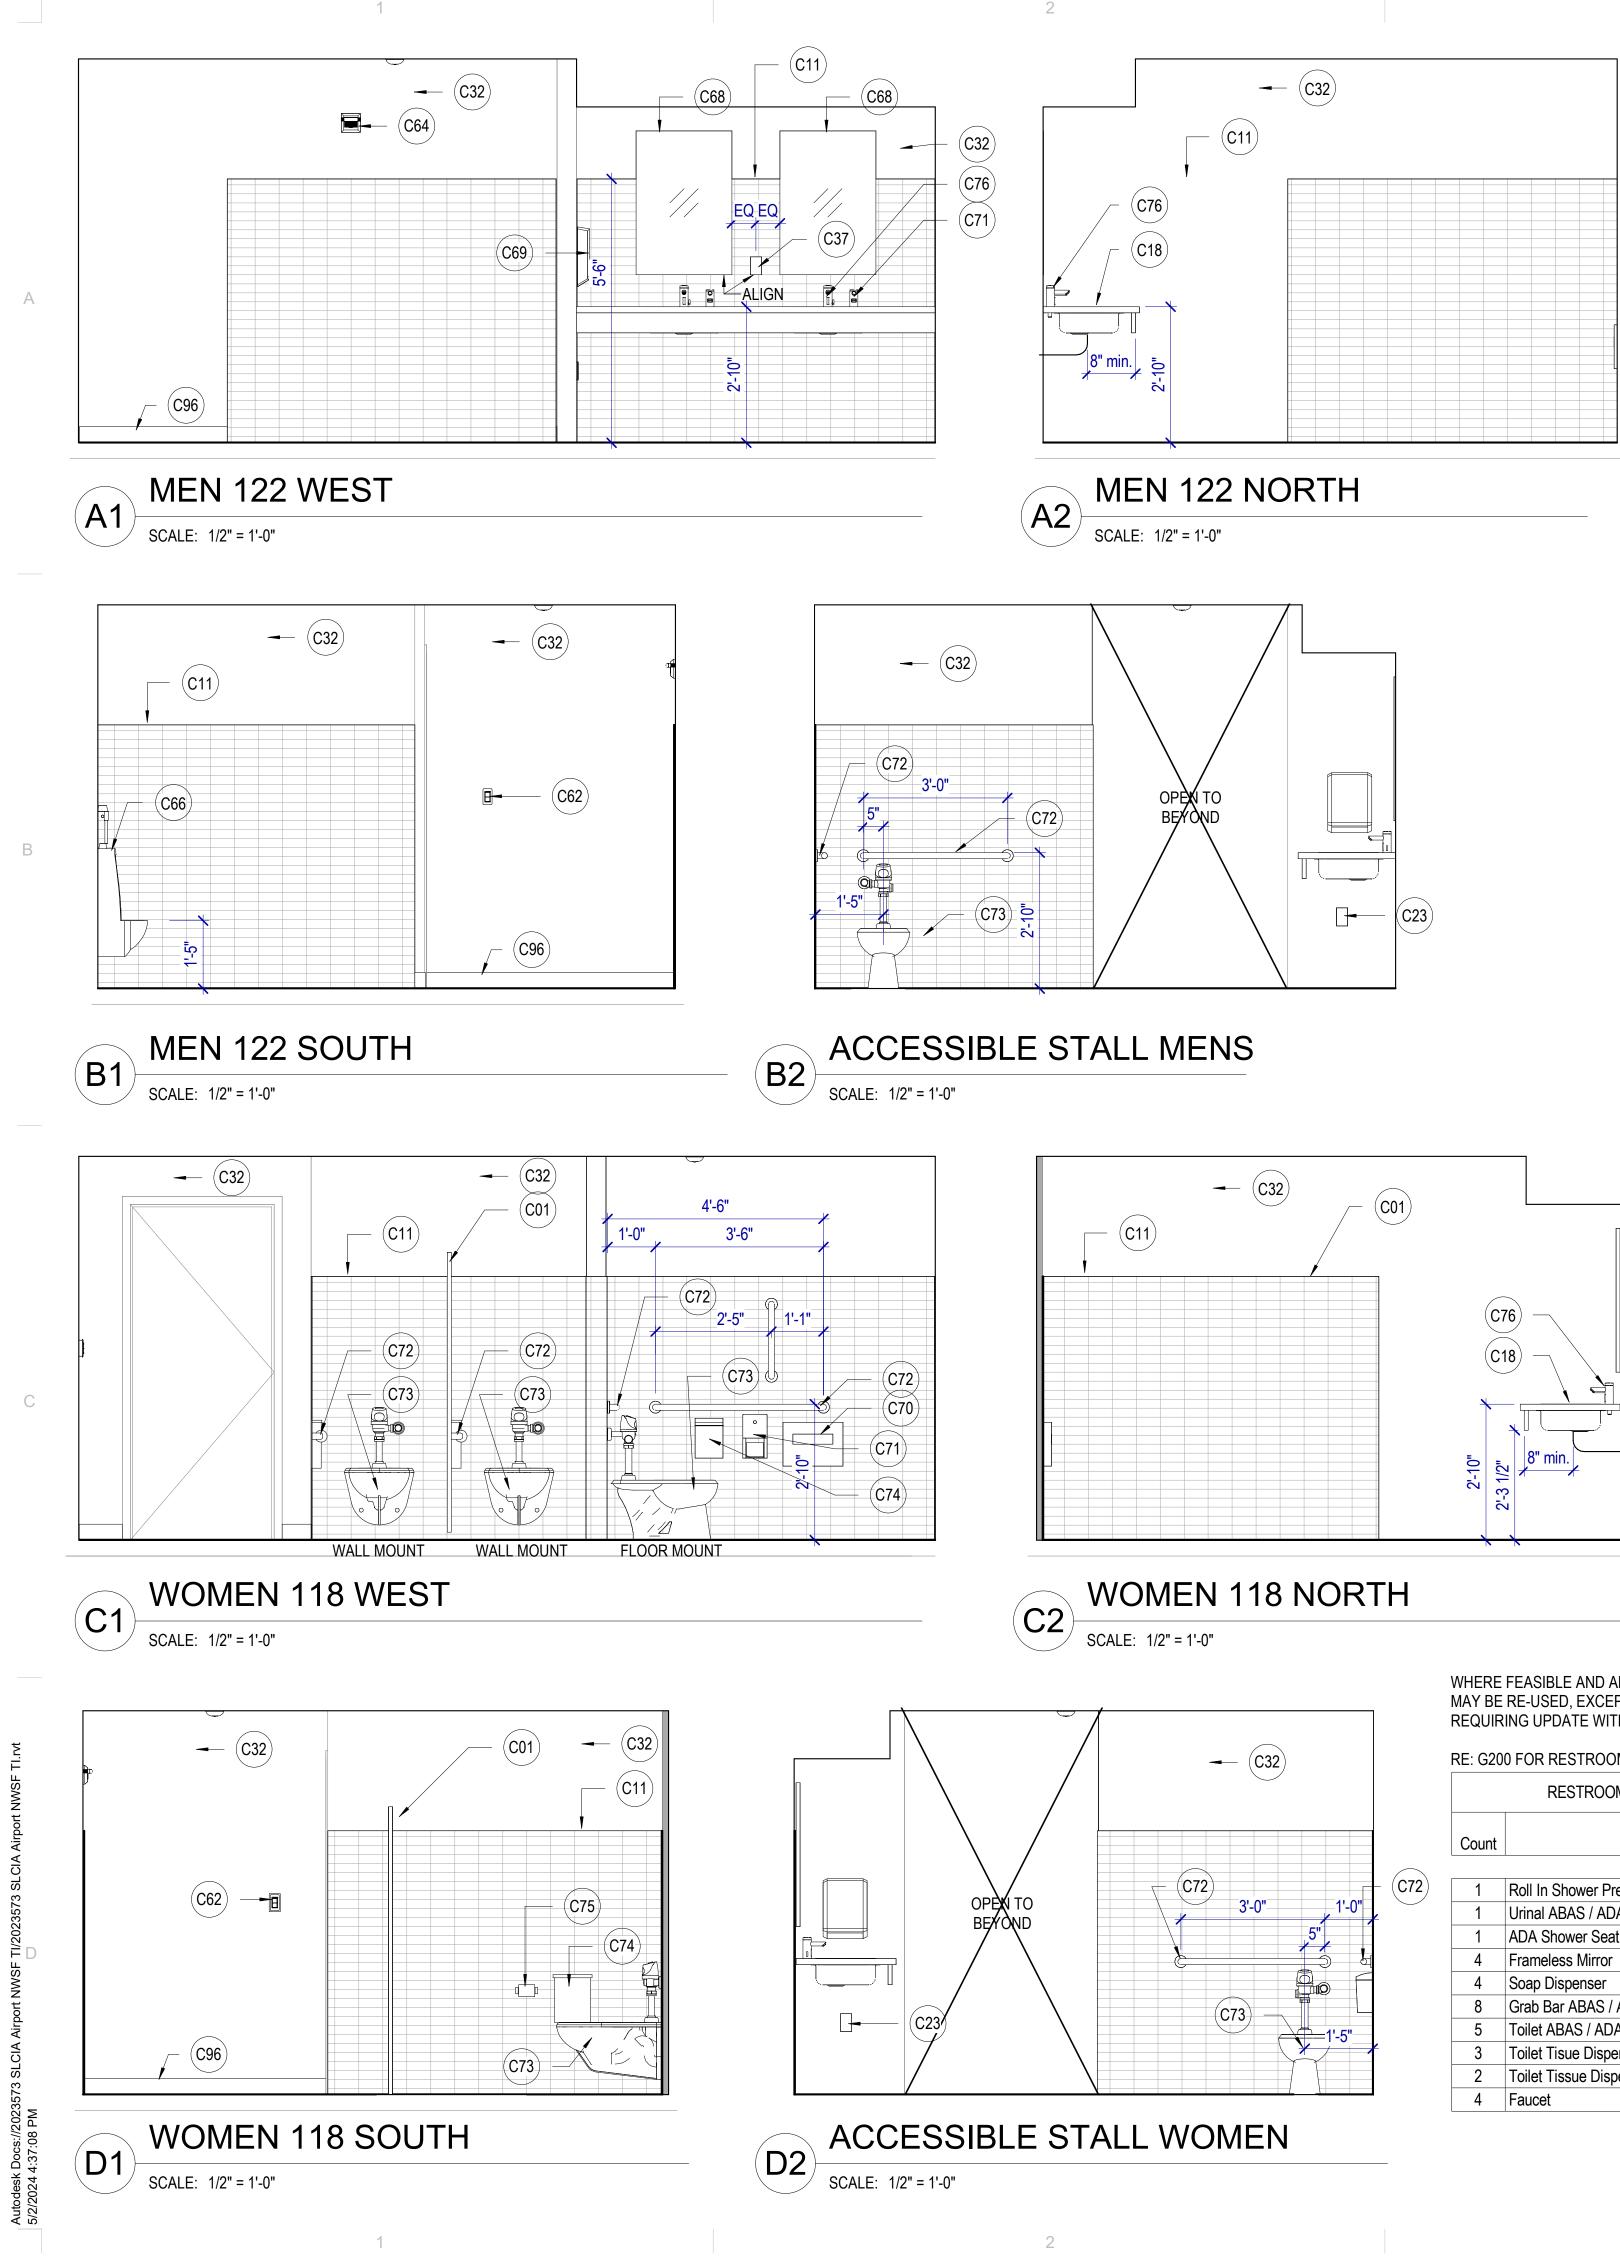RE: G200 FOR RESTROOM FIXTURE MOUNTING HEIGHTS AND CLEARANCES.

	RESTROOM & SHOWER ACCESSORY SCHEDUL	E
Count	Comments	Accessory Keynote
1	Roll In Shower Prefabricated ABAS / ADA Compliant	C03
1	Urinal ABAS / ADA Compliant	C66
1	ADA Shower Seat	C67
4	Frameless Mirror	C68
4	Soap Dispenser	C71
8	Grab Bar ABAS / ADA Compliant	C72
5	Toilet ABAS / ADA Compliant	C73
3	Toilet Tisue Dispenser with Napkin Disposal	C74
2	Toilet Tissue Dispenser	C75
4	Faucet	C78
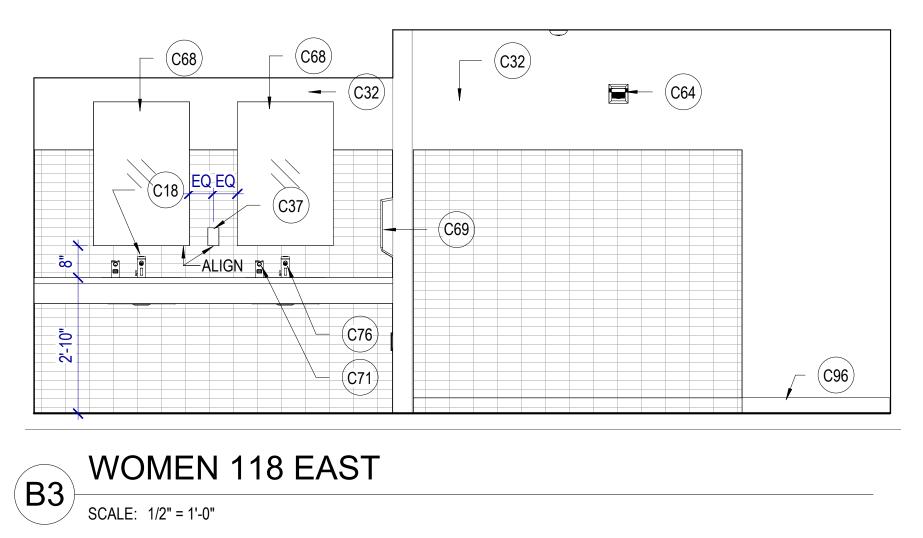
<u>RESTROOM</u> Frameless mirror

### **KEYNOTES**

- C01 NEW RESTROOM FIXTURES AND STALLS, FLOOR MOUNT OR WALL MOUNT TOILETS AS SHOWN ON DRAWINGS. FIXTURES TO BE ADA / ABAAS COMPLIANT
- C11 NEW TILE AND BASE C18 NEW COUNTER, SINKS, FAUCETS, MIRRORS, FIXTURES TO BE ADA / ABAAS COMPLIANT.
- C23 NEW POWER OUTLET OR RELOCATE EXISTING OUTLET, PLACE AT HEIGHT TO MATCH EXISTING UNLESS NOTED OTHERWISE. SEE ELECTRICAL
- C32 NEW EPOXY PAINT
- C37 NEW GFCI OUTLET OR RELOCATED GFCI
- C62 NEW LIGHTS SWITCH, HEIGHT TO MATCH EXISTING, SEE ELECTRICAL
- C64 EXISTING FIRE BEACON TO REMAIN
- C66 NEW URINAL ADA / ABAS COMPLIANT WITH SENSOR
- C68 FRAMELESS MIRROR
- C69 PAPER TOWEL DISPENSER
- C70 SEAT COVER DISPENSER
- C71 SOAP DISPENSOR WITH SENSOR
- C72 GRAB BAR ADA / ABAS COMPLIANT
- C73 WATER CLOSET ADA / ABAS COMPLIANT WITH SENSOR
- C74 SANITARY NAPKIN DISPOSAL
- C75 TOILET TISSUE DISPENSER
- C76 FAUCET WITH SENSOR
- C82 NEW TOILET STALL PARTITION
- C96 NEW BASE

### RESTROOM, SHOWER, AND BREAKROOM ACCESSORIES

Product: Manufacturer: Bobrick B-39747 Toilet tissue dispenser; Surface mount Product: Manufacturer: Bobrick B-2892 Toilet seat cover dispenser; Recessed Product: Manufacturer: Bobrick B-3013 Sanitary napkin disposal; Surface mount Product: Manufacturer: Bobrick B-270 Soap dispenser; Surface mount Product: Proline Curve 1000 Coat hook w/ door bumper Product: Bobrick B-212 Product: Bobrick – B165 – 2436 Stainless steel grab bar w/ satin finish Product: Bobrick B-6086-18" Stainless steel grab bar w/ satin finish

Product: Bobrick B-6086-36"

Stainless steel grab bar w/ satin finish Product: Bobrick B-6086-42"

BREAK ROOM Automatic paper towel dispenser/Waste receptacle; Recessed Automatic paper towel dispenser; Surface mount Product: Bobick B-72974 Soap dispenser; Surface mount Product: Proline Curve 1000 SHOWER ROOM Stainless steel two-wall grab bar w/ satin finish Product: Bobrick B-6861 Folding ADA shower seat; wall mount with floor supports Product: Bobrick B-918116R Dressing area folding seat with legs; ADA compliant Product: ASI 10-8209 60" shower curtain rod Product: Product:Bobrick B-207 x 60 Robe Hook Product: Bobrick B-211

Soap dispenser; Surface mount Product: Proline Curve 1000

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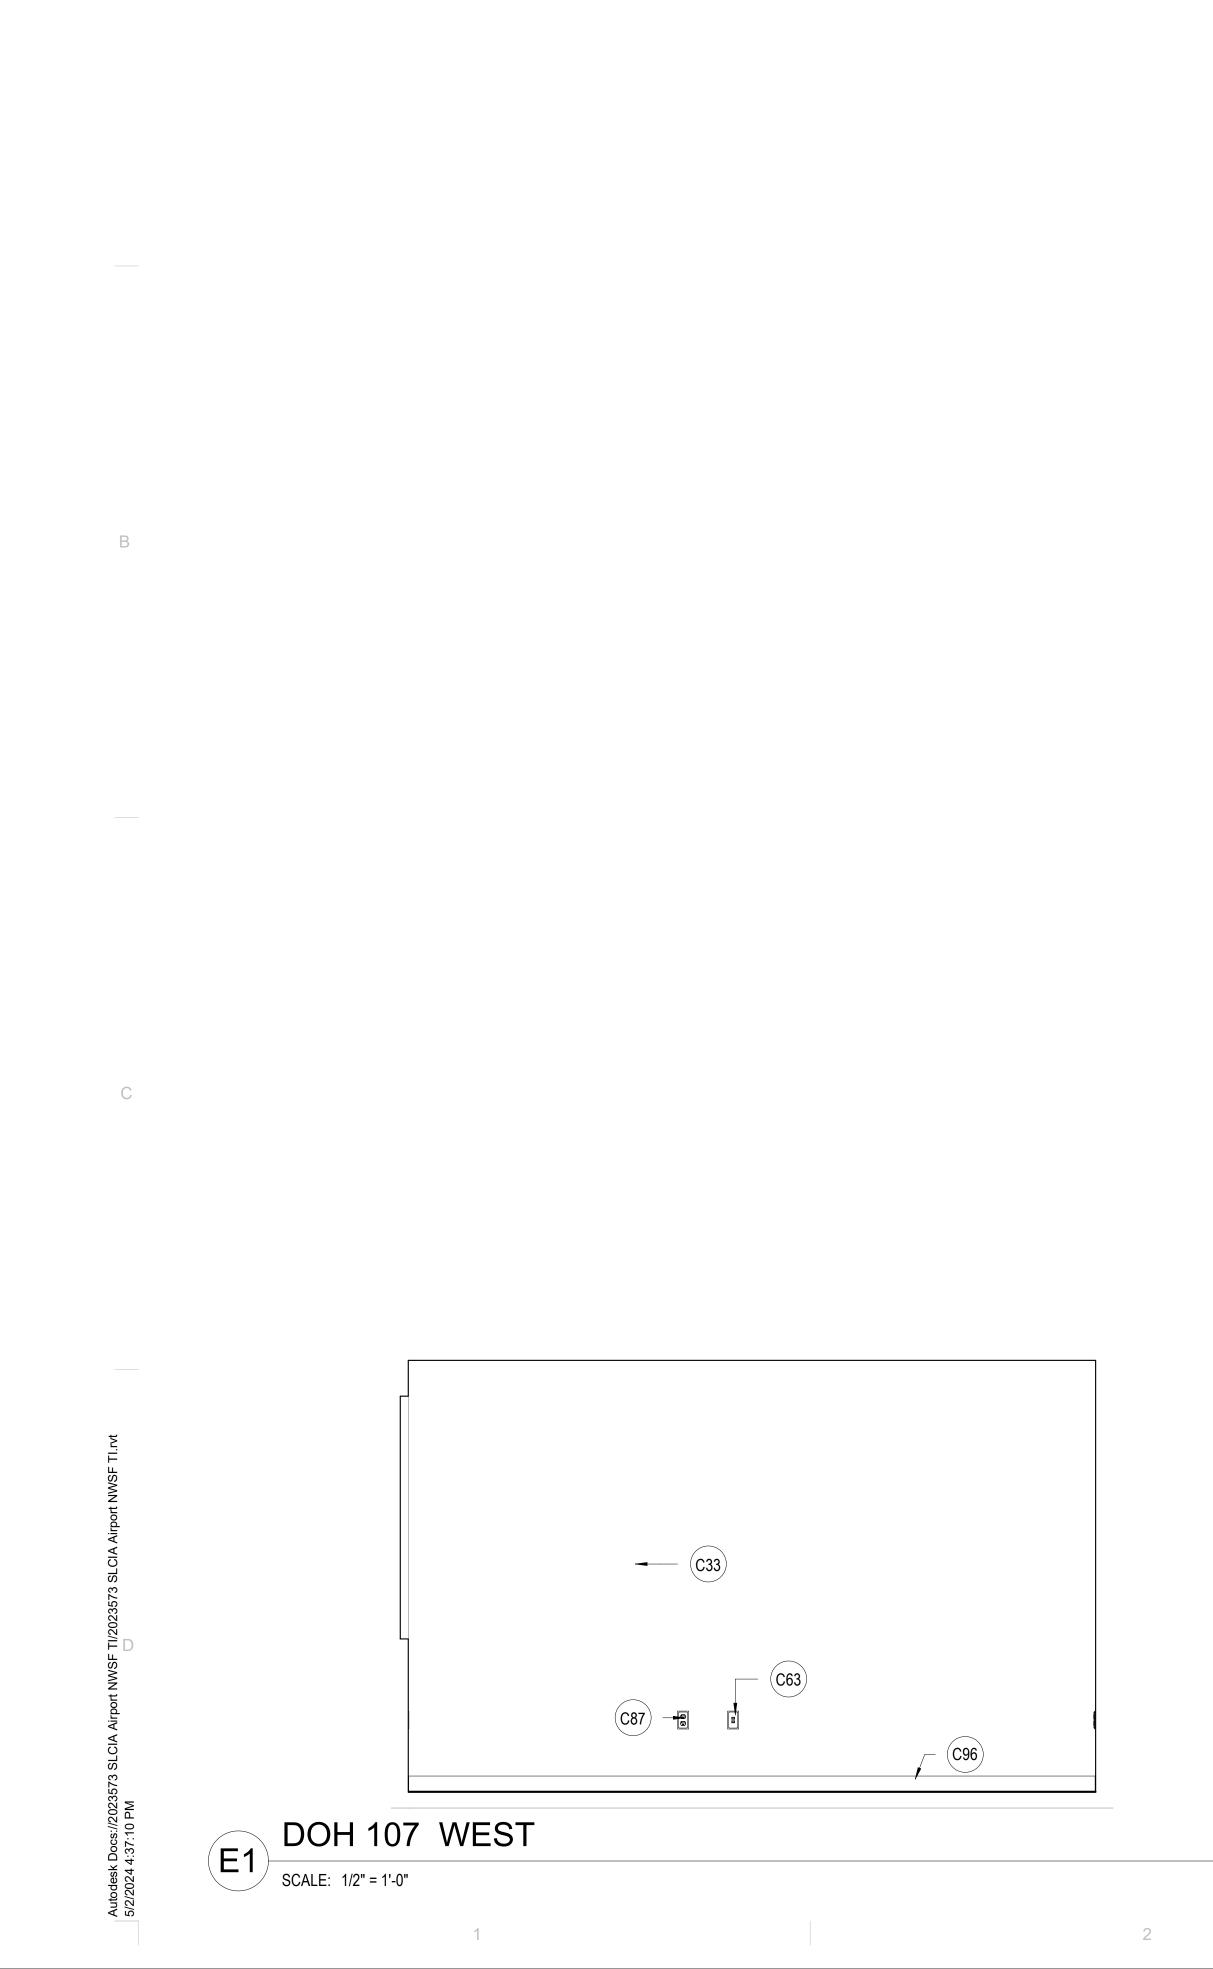
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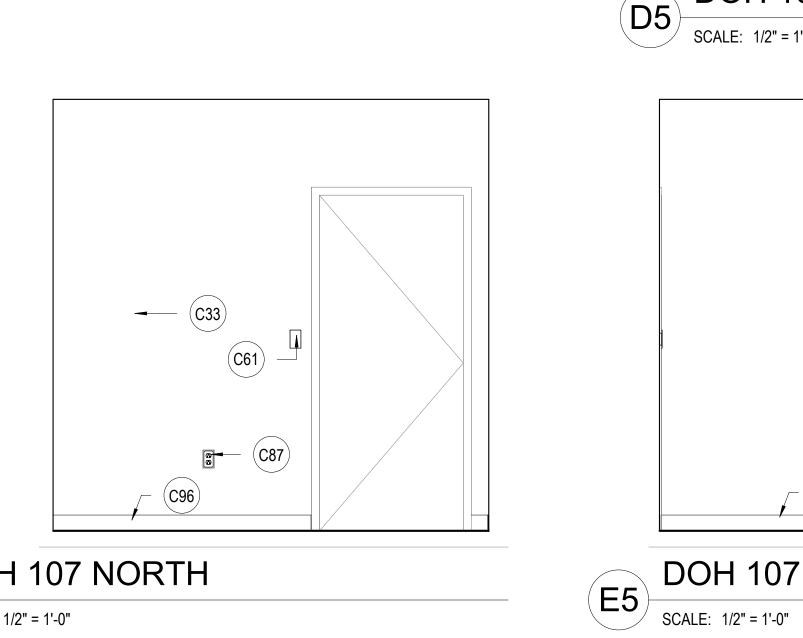
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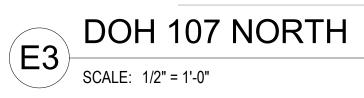
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### <u>KEYNOTES</u>


- C33 NEW PAINT
- C61 EXISTING LIGHT SWITCH, LOCATION APPROXIMATE
- C63 EXISTING DATA TO REMAIN, LOCATION APPROXIMATE.

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- C87 EXISTING POWER OUTLET TO REMAIN
- C96 NEW BASE




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### D5 DOH 107 SOUTH SCALE: 1/2" = 1'-0"

---- C33 **C87 C96** DOH 107 EAST
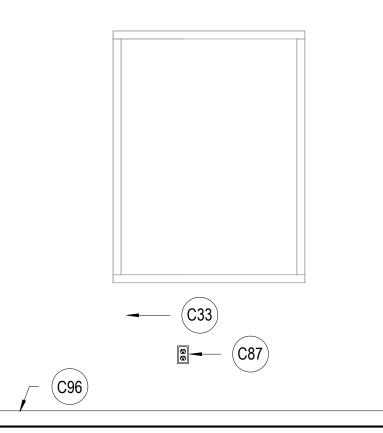
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C13

C33

C38

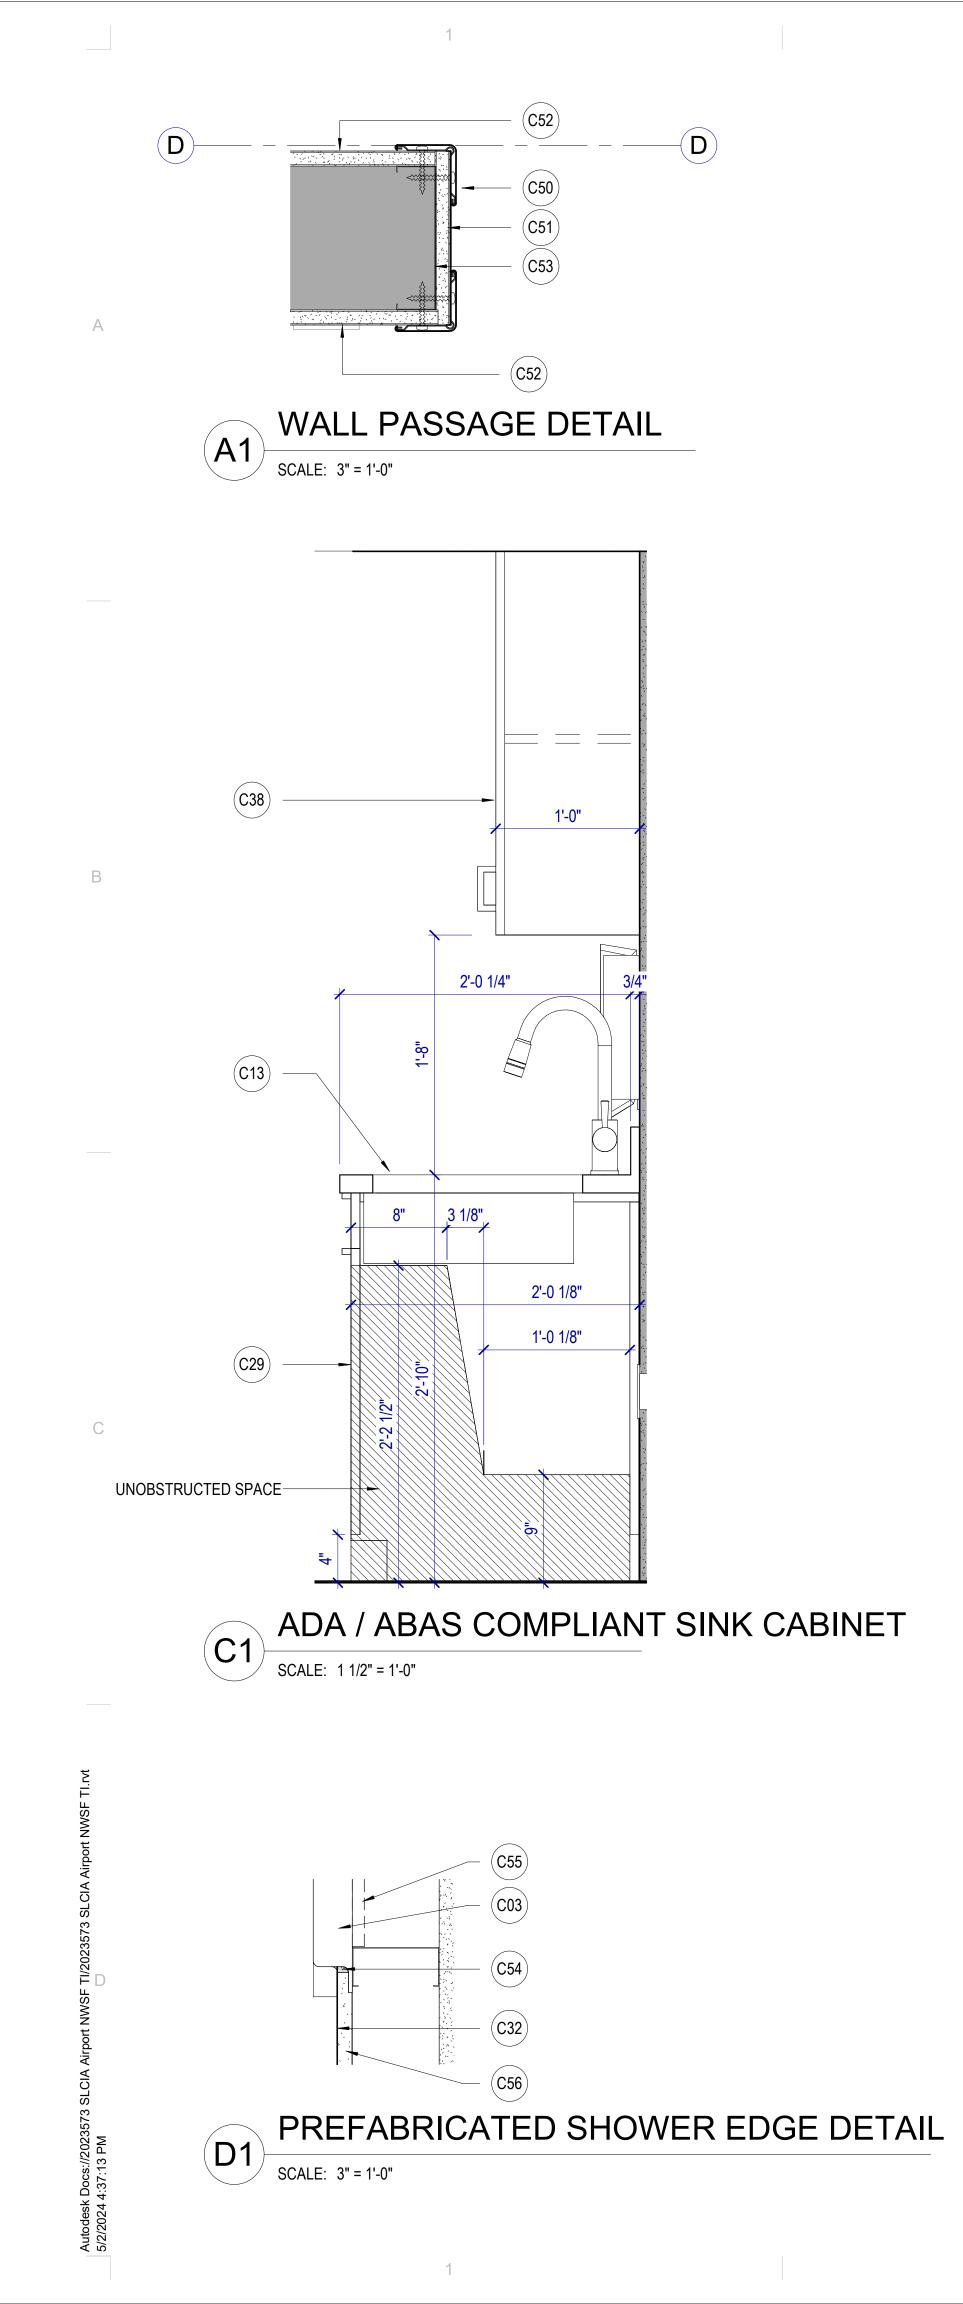C50

C51

C52


C53

C54

C55

- NEW ROLL-IN SHOWER ENCLOSURE AND PLUMBING, TO BE ADA / ABAAS COMPLIANT. C03 C12
  - NEW LOCKERS, BASE, AND SOFFIT. SEE PROJECT MANUAL FOR LOCKER SPECIFICATION.
  - NEW CABINETRY, COUNTERTOP, SINK, AND PLUMBING.
- C27 NEW PAINT AND BASE
- C29 CABINET DOORS TO OPEN FOR ACCESSIBILITY COMPLIANT ACCESS C32
  - NEW EPOXY PAINT
  - NEW PAINT NEW CABINETRY
  - NEW ACROVYN CORNER GUARD AT OPENING CORNERS BOTH SIDES OF WALL.
  - NEW 5/8" GYPSUM BOARD AND FINISH
  - EXISTING GYPSUM BOARD AND PAINT, REPAIR AS NECESSARY.
  - NEW COLD FORMED METAL STUDS AS NECESSARY.
  - NEW PAINTABLE WET RATED CAULKING
  - NEW FIRE RETARDANT BLOCKING AS REQUIRED.
  - NEW MOISTURE RESISTANT GYPSUM BOARD PANELS.
- C56 D14 DEMO EXISTING SLAB AS REQUIRED FOR NEW SHOWER AND PLUMBING. PERFORM AFTER GROUND


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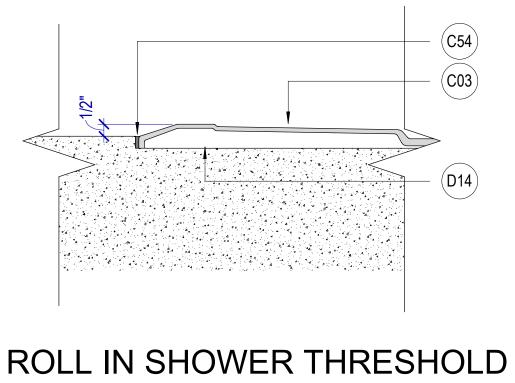


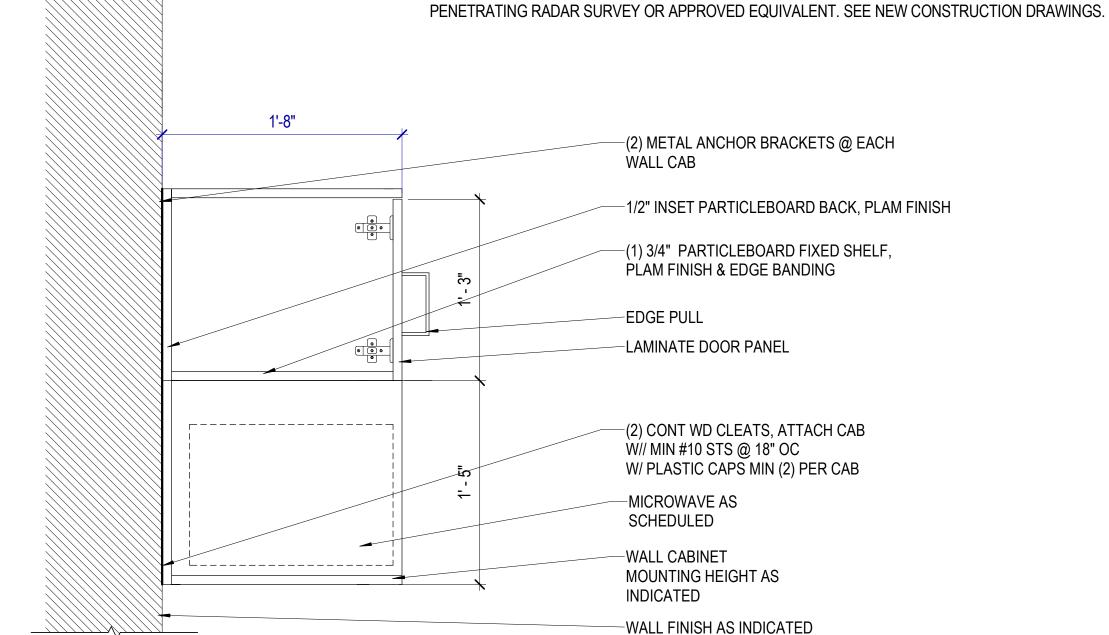

### MILLWORK MICROWAVE DETAIL


SCALE: 1 1/2" = 1'-0"



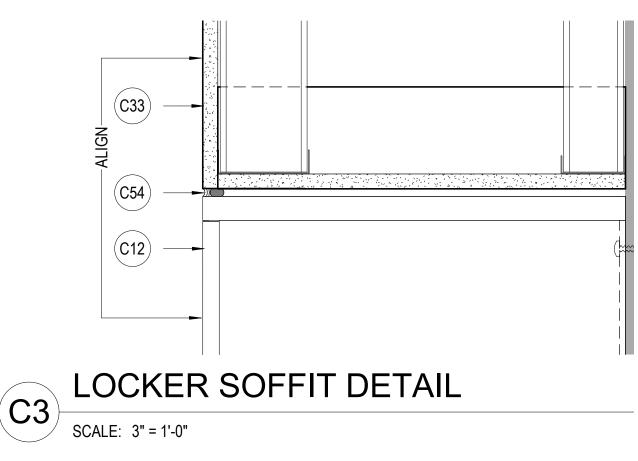

D2 SCALE: 3" = 1'-0"

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### **CASEWORK GENERAL NOTES**

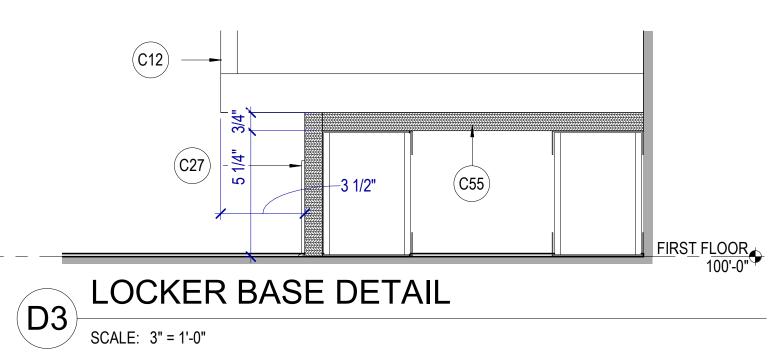Verify in Field (VIF): Field verify all dimensions and conditions before fabrication.

**Upper Cabinet Clearance:** 12" minimum clear inside dimension, UNO.

Electrical and Data Coordination: Coordinate electrical and data device locations with millwork.

Locks: Provide locks on cabinet drawers and doors, keyed alike by room, UNO.

Grommets: Locate as directed by Owner after installation.

### Cabinet Design Series

- Provide cabinets with integral finished ends and scribes at wall to wall installations not exceeding 1-1/2 inches in width.
- Where cabinets meet walls or other cabinets, provide filler panels, of sufficient width, but • not exceeding 1-1/2 inches, to allow doors with pulls to swing a minimum of 90 degrees and to prevent drawers from hitting adjacent door or drawer pulls. • Hardware and accessories shall be as provided for in these standards.

### CDS are subdivided as follows:

Base Cabinets w/o Drawers	100 Series
Base Cabinets w/ Drawers	200 Series
Wall Hung Cabinets	300 Series
Tall Storage Cabinets	400 Series
Tall Wardrobe Cabinets	500 Series
Library Cabinets	600 Series
Moveable Cabinets	700 Series

### General Notes

- 100 or 200 Series cabinets may be converted into moveable cabinets by prefixing a "7" to • the number. (Example: 7-102-36"x 30"x 18" [7-102-914 mm x 762 mm x 457 mm]).
- Moveable cabinets shall be equipped with adequate approved casters for the intended • load capacity
- CDS #'s 728, 729, 735, 736, 737, 738, and 739 require metal angle reinforced corners. • Carts and rolling tall storage cabinets with doors, lacking any horizontal and/or vertical •
- stabilizing dividers, require a diaphragm bottom; specifically CDS #'s 702, 712, 716, 722, 743,744, 746, 747, 750, and 751. Wardrobe cabinets (500 Series) with doors require a framed mirror on one door, and •
- cabinets # 533 and 534 require a paper roller/cutter and slide out tilting paper shelves.
- Cart storage cabinets are required to have hardwood side guides, specifically CDS #'s 160, 161, and 162.
- Ceramics drying cabinets are required to have galvanized metal frame shelves with wire • mesh, specifically CDS #'s 198 199, and 459.
- File drawers require full extension slides and a file hanging system, specifically CDS #'s 223, 224, 230, 231, 240, 242, 253, 255, 531, 532, and 533. •
- Wardrobe cabinets are required to have a shelf, pole, and framed mirror (without pin tray) when closed with hinged doors, specifically CDS #'s 501, 511, 512, 522, 530, 531, 532, and 552.
- Wardrobe cabinets are required to have a roll paper dispenser/cutter, specifically CDS #'s • 533 and 534.

A430



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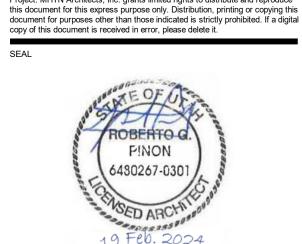
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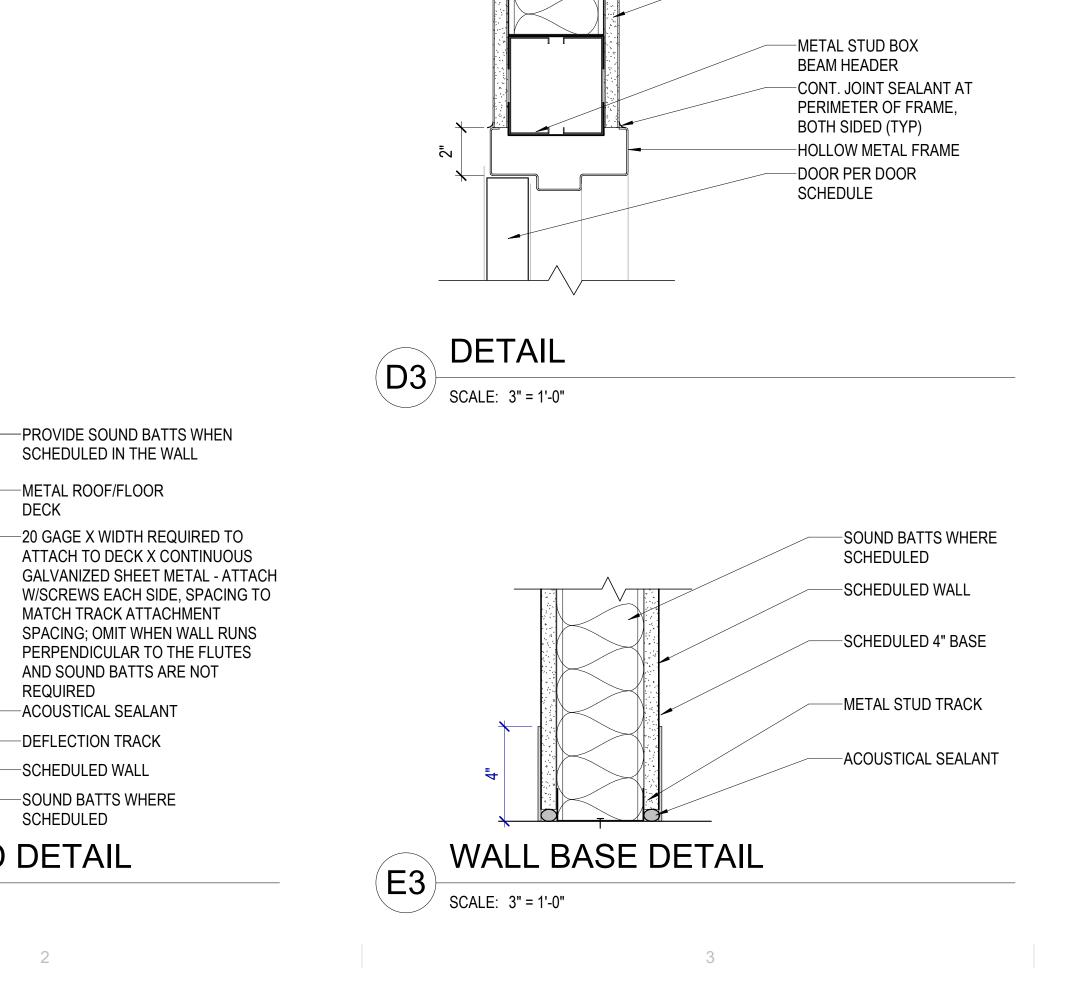
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1



-SOUND ATTENUATION

-SCHEDULED FINISH

—5/8" GYPSUM WALL BOARD, BOTH SIDES

BLANKET

3

	INTERIOR WALL TYPE SCHEDULE									
TAG		CONSTRUCT	ION				FIRE RES	ISTANCE	ACOUS	<b>FICAL</b>
MARK	DESCRIPTION	WIDTH	TERMINATION	LIMITING HEIGHT	HEAD DETAIL	BASE DETAIL	FIRE RATING	STANDARD	SOUND BATT	STC
S3A	5/8" GB + 3 5/8" MTL STUD + 5/8" GB	4 7/8"	TO DECK	16'-6"					Yes	40
S3B	5/8" GB + 3 5/8" MTL STUD + 5/8" GB	4 7/8"	TO DECK	16'-6"					No	37
S3BX	5/8" GB + 3 5/8" MTL STUD	4 1/4"	TO DECK	15'-6"					No	

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### DOOR SCHEDULE GENERAL NOTES

RE: Division 8 Section "Door Hardware" for hardware sets.

Door Leaves: At each door, provide the number of leaves shown on the plans. Where two leaves are shown, provide equal leaves, UNO.

**Frame Depth**: Coordinate hollow metal frame depth with wall thickness, wrapping stud framed walls. Provide depths as scheduled for masonry walls, UNO.


Abbreviations: Door and Frame Schedule Remarks abbreviations:

ADA	ADA Actuator
CR	Card Reader
DE	Delayed Egress

- EL Electric Latch
- ES Electric Strike MO Motor Operation
- MHO Magnetic Hold Open


		DOOR		FR	AME		
DOOR #	ТҮРЕ	WIDTH	HEIGHT	ТҮРЕ	MATERIAL	REMARKS	DOOR #
104	F	3'-0"	7'-0"	1	TME	RELOCATED DOOR & FRAME, CLOSER, HARDWARE TME	104
105	UU	3'-0"	7'-0"	1			105
	F	3'-0"	7'-0"	1	TME	NEW DOOR, CLOSER, HARDWARE TME W/ NEW VACANCY/OCCUPANCY LOCK	127
127	_	3'-0"	7'-0"	1	TME	NEW DOOR, CLOSER, HARDWARE TME	128
127 128	F						

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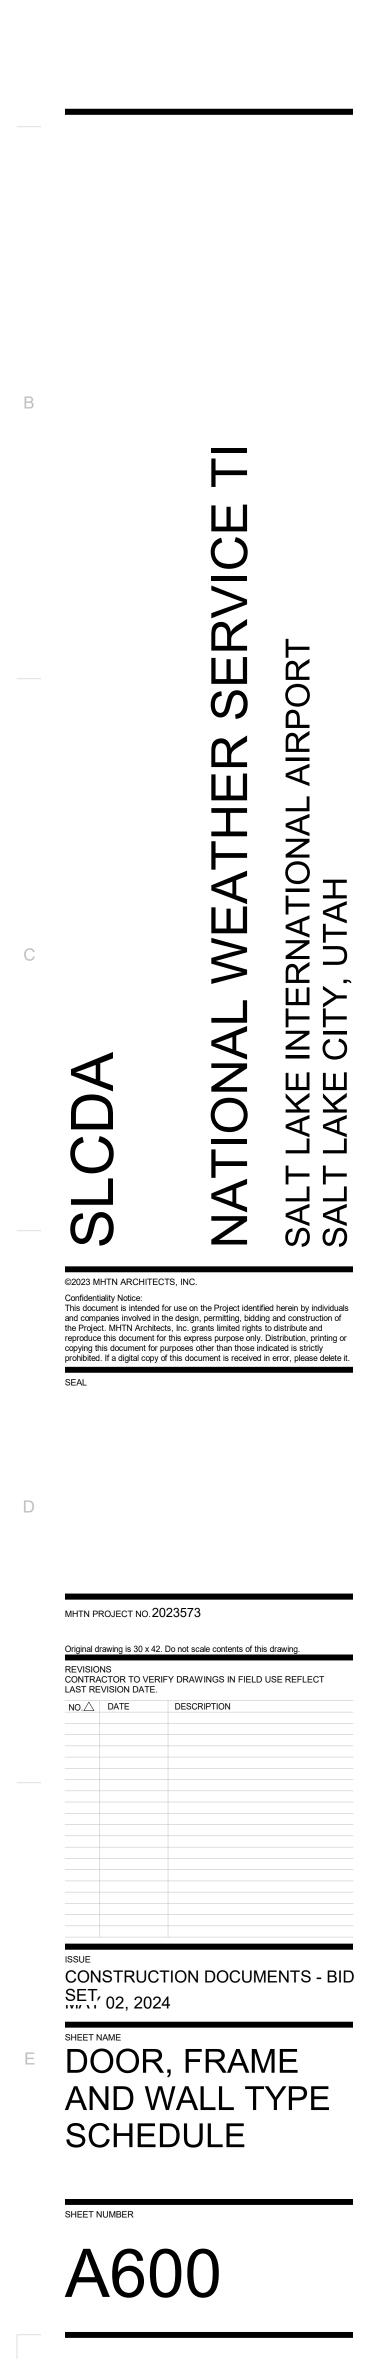
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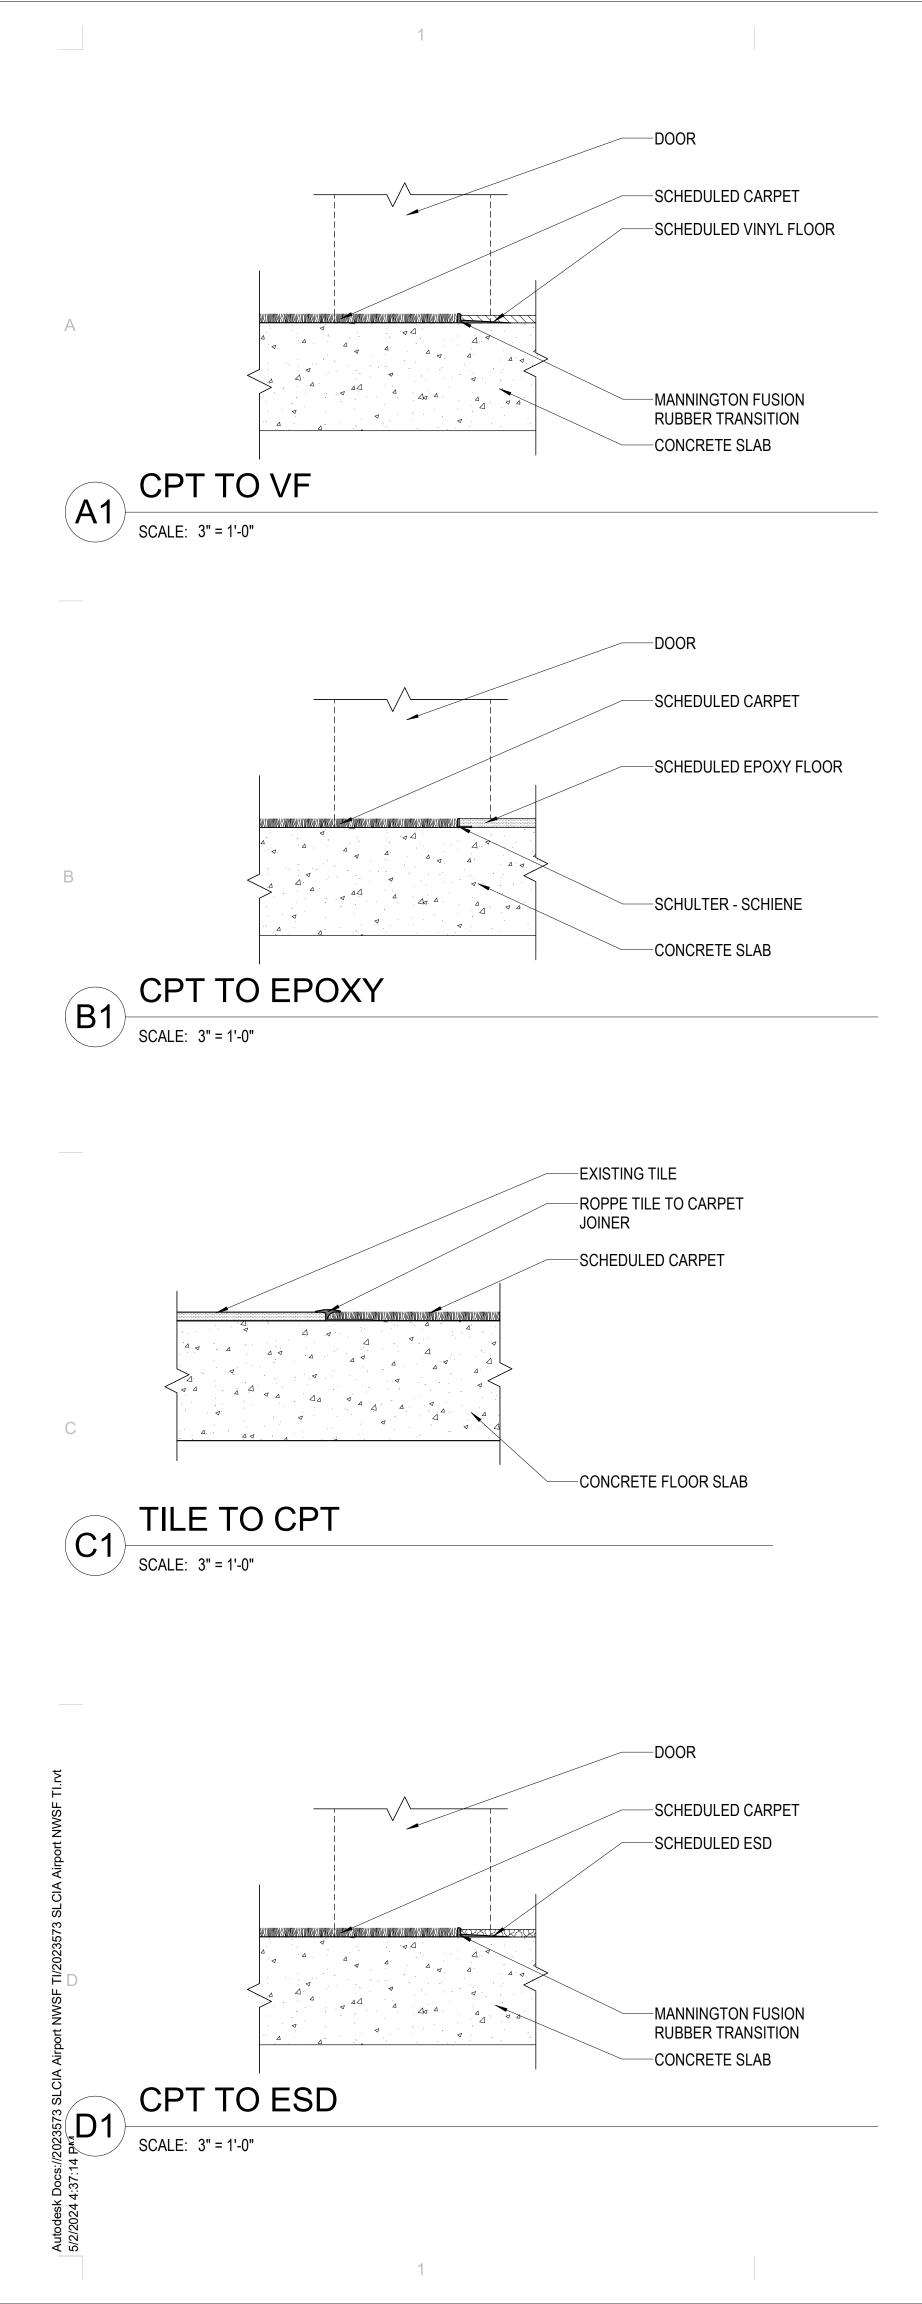


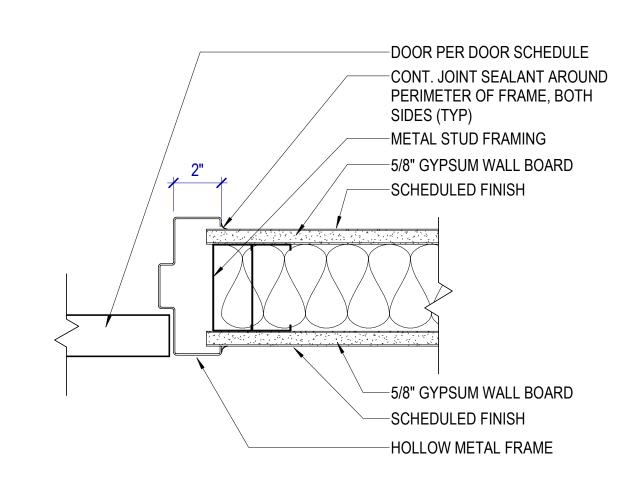




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### A610

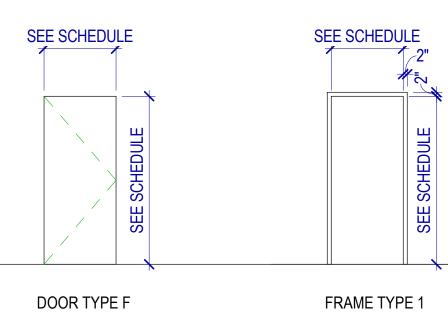SHEET NUMBER

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### SHEET NAME DOOR DETAILS
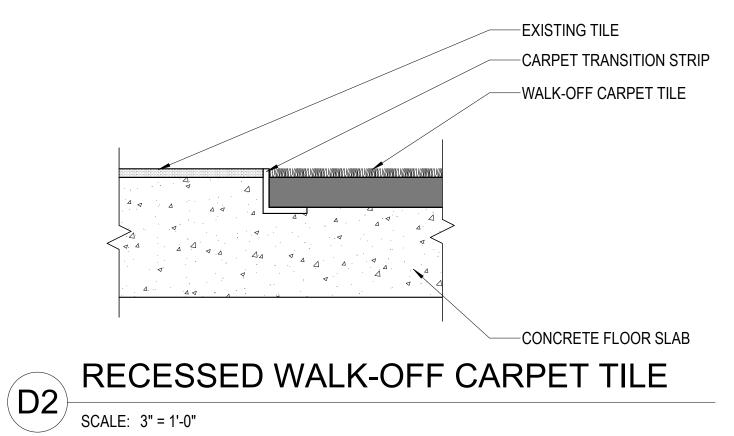
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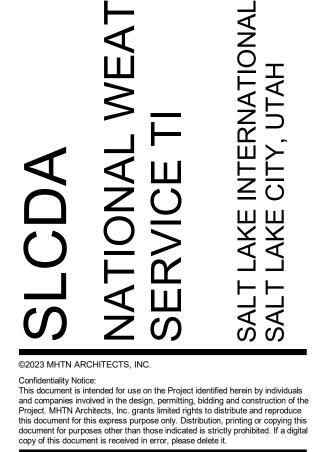
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### FINISH SCHEDULE LEGEND

### FLOOR FINISHES

**EF - EPOXY FLOORING** MANUFACTURER: DUDICK STYLE: STERI-QUARTZ T COLOR: SQT106

VF1 - LINOLEUM TILE FLOORING MANUFACTURER: MANNINGTON STYLE: ABSTRACT COLOR: STUCCO FLAX SIZE:CUSTOM INSTALLATION:ASPEKT LARGE

VF2 - LINOLEUM TILE FLOORING MANUFACTURER: MANNINGTON STYLE: ABSTRACT COLOR: STUCCO INDIGO SIZE:CUSTOM INSTALLATION:ASPEKT LARGE

VF3 - LINOLEUM TILE FLOORING MANUFACTURER: MANNINGTON STYLE: STONE COLOR: BASILICA SHALE SIZE:CUSTOM INSTALLATION:ASPEKT LARGE

CPT1 - GENERAL CARPET TILE MANUFACTURER: MANNINGTON STYLE: RPM RMX COLOR: SWING SIZE: 12"X36" INSTALLATION: VERTICAL ASHLAR

CPT2 - ACCENT CARPET TILE MANUFACTURER: MANNINGTON STYLE: RPM RMX COLOR: BLUEGRASS SIZE: 12"X36" INSTALLATION: VERTICAL ASHLAR

CPT3 - WALK-OFF MANUFACTURER: MILLIKEN STYLE: OBEX TILE CUT/STIPPLE STC 119 COLOR: DARK GREY SIZE: 19.7"X19.7" INSTALLATION: GRID

ESD - ELECTROSTATIC CONDUCTIVE TILE MANUFACTURER: ROPPE STYLE: ESD COLOR: STRATUS BLUE/ 753 SIZE: 36" X 36" INSTALLATION: GRID

### TRANSITION STRIP

### (TO BE VERIFIED BY FLOORING CONTRACTOR) T1 - TRANSITION STRIP

1

MANUFACTURER: SCHLUTER STYLE: SCHIENE COLOR: ANODIZED ALUMINUM

T2 - TRANSITION STRIP MANUFACTURER: MANNINGTON STYLE: FUSION RUBBER TRANSITION COLOR:

T3 - TRANSITION STRIP MANUFACTURER: ROPPE STYLE: TILE TO CARPET JOINER COLOR:

### **BASES**

**RB - RUBBER BASE** MANUFACTURER: ROPPE COLOR: HEIGHT: 4"

### WALL FINISHES

PT1 - GENERAL WALL:WATERBASED LATEX PAINT MANUFACTUERER: BENJAMIN MOORE COLOR: GLACIER WHITE OC-37 FINISH: EG-SHELL

PT2 - WATERBASED LATEX PAINT MANUFACTUERER: BENJAMIN MOORE COLOR: VAN DEUSEN BLUE/HC-156 FINISH: EG-SHELL

**PT3 - WATERBASED LATEX PAINT** MANUFACTUERER: SHERWIN WILLIAMS COLOR: HALCYON GREEN/ SW6213 FINISH: EG-SHELL

PT4 - WATERBASED LATEX PAINT MANUFACTUERER: BEHR COLOR: MATCH EXISTING FINISH: EG-SHELL

PT5 - GENERAL CEILING:WATERBASED LATEX PAINT MANUFACTUERER: BENJAMIN MOORE COLOR: GLACIER WHITE OC-37 FINISH: FLAT

EPT - EPOXY, WATERBASED MANUFACTUERER: BENJAMIN MOORE COLOR: GLACIER WHITE OC-37 FINISH: EG-SHELL

WT1 - CERAMIC WALL TILE MANUFACTURER: DALTILE PRODUCT: MULTITUDE STYLE: FLAT / MU18 COLOR: URBAN GREY SIZE: 12" x 24" GROUT COLOR: MAPEI, 5002 PEWTER

WT2 - CERAMIC WALL TILE MANUFACTURER: DALTILE PRODUCT: MULTITUDE STYLE: RECTANGLE WAVE MU19 COLOR: NOSTALGIC BLUE SIZE: 12" x 24" GROUT COLOR: MAPEI, 5002 PEWTER

WT3 - WALL TILE TRIM MANUFACTURER: SCHLUTER PRODUCT: JOLLY COLOR: SATIN ANODIZED

WP - WALL PROTECTION MANUFACTURER: PRODUCT: COLOR:

### <u>CEILINGS</u>

ACP1 - 12" X 12" ACOUSTICAL CEILING TILE MANUFACTUERER: ARMSTRONG PRODUCT: CORTEGA ANGLED TEGULAR COLOR: WHITE

GB1 - PAINTED GYPSUM BOARD, BENJAMIN MOOR GLACIER WHITE OC-37

GB2 - EPOXY PAINTED GYPSUM BOARD, BENJAMIN MOOR GLACIER WHITE OC-37

### **CABINET**

PL1 - PLASTIC LAMINATE MANUFACTURER: WILSONART COLOR: GREY ELM 8201 FINISH: 12

PL2 - PLASTIC LAMINATE MANUFACTURER: WILSONART COLOR: CLASSIC LINEN 4943 FINISH: 38

FEN - FENOLIC MANUFACTURER: ASI COLOR: PASTEL GREY #3074 FINISH: #3074

COUNTER TOP QZ - QUARTZ COUNTERTOP MANUFACTURER: CAMBRIA COLOR: PORTRUSH

SS - SOLID SURFACE MANUFACTURER: CORIAN COLOR: JUNIPER

### <u>MISC</u>

DOOR FRAME DF - PAINTED FINISH, MATCH EXISTING

### DOORS

D1 - MATCH EXISTING WOOD, STAIN AND FINISH

						ROOM FINISHE	ES					
Area	Name	Number	CEILING FINISH	EAST WALL FINISH	NORTH WALL FINISH	WEST WALL FINISH	SOUTH WALL FINISH	COUNTER TOP FINISH	BASE FINISH	CABINET FINISH	FLOOR FINISH	NOTES
390 SF	RECEPTION	100	PT5	PT1	PT1	PT1	PT1		RB		CPT1/CPT2	
99 SF	VESTIBULE	100A		PT1	PT1	PT1	PT1		EXISTING TO REMAIN		CPT3	EXISTING FLOOR TILE TO REMAIN
790 SF	CORRIDOR	100B	EXISTING TO REMAIN	PT1/PT2	PT1/PT2/WP	PT1/PT2	PT1		RB		CPT1	
175 SF	HIC OFFICE	101	EXISTING TO REMAIN	PT1	PT1	PT1	PT1		RB		CPT1	
181 SF	MIC OFFICE	102	EXISTING TO REMAIN	PT1	PT1	PT1	PT1		RB		CPT1	
483 SF	CONFERENCE	103	ACP1	PT2	PT1	PT1	PT1		RB		CPT1/CPT2	
198 SF	WCM OFFICE	104	EXISTING TO REMAIN	PT4	PT1	PT1	PT4		RB		CPT1	TOUCH-UP EXITSING PAINT WHERE NEEDED
130 SF	SCH OFFICE	105	EXISTING TO REMAIN	PT1	PT1	PT1	PT1		RB		CPT1	
9 SF	COATS	106	PT5	PT1	PT1	PT1	PT1		RB		CPT1	
9 SF	COATS	106A	PT5	PT1	PT1	PT1	PT1		RB		CPT1	
130 SF	DOH OFFICE	107	EXISTING TO REMAIN	PT1	PT1	PT1	PT1		RB		CPT1	
9 SF	STORAGE	108	PT5	PT1	PT1	PT1	PT1		RB		CPT1	
10 SF	STORAGE	108A	PT5	PT1	PT1	PT1	PT1		RB		CPT1	
363 SF	BREAK ROOM	109	EXISTING TO REMAIN	PT1	PT1	PT1	PT1	SS	RB	PL1	VF1-VF3	VINYL FLOOR PATTERN
68 SF	SHOWER	110	EPT	EPT	EPT	EPT	EPT		RB		EF	
41 SF	WEST ENTRANCE	111A	PT5	EXISTING TO REMAIN	PT1	EXISTING TO REMAIN	PT1		EXISTING TO REMAIN		CPT3	EXISTING FLOOR TILE TO REMAIN
39 SF	EAST ENTRANCE	112A	PT5	EXISTING TO REMAIN	PT1	EXISTING TO REMAIN	PT1		EXISTING TO REMAIN		CPT3	EXISTING FLOOR TILE TO REMAIN
1077 SF	ELEC TECH OPEN WORK AREA	114	EXISTING TO REMAIN	PT1	PT1	PT1/PT2	PT1/PT2		RB		ESD	
156 SF	ESA OFFICE	116	EXISTING TO REMAIN	PT1	PT1	PT1	PT1		RB		CPT1	
178 SF	WOMEN	118	EPT	EPT/WT1/WT2	EPT/WT1	EPT/WT1	EPT/WT1	QZ	RB		EF	
54 SF	JANITOR	120	EXISTING TO REMAIN		EXISTING TO REMAIN		EXISTING TO REMAIN					
175 SF	MEN	122	EPT	EPT/WT1	EPT/WT1	WPT/WT1/WT2	EPT/WT1	QZ	RB		EF	
177 SF	SOO OFFICE	124	EXISTING TO REMAIN	PT1	PT1	PT1	PT1		RB		CPT1	
58 SF	CORRIDOR	126	ACP1	PT1	PT1	PT1	PT1		RB		CPT1	
59 SF	QUIET ROOM	127	ACP1	PT3	PT1	PT1	PT3		RB		CPT1	
157 SF	TRAINING / OFFICE	128	ACP1	PT1	PT1/PT2	PT1/PT2	PT1		RB		CPT1	
190 SF	STORAGE	129	OPEN TO STRUCTURE	PT1	PT1	PT1	PT1		RB WEST WALLS		EXISTING TO REMAIN	RUBBER RUBBER BASE ON NEW WALLS ONLY
2273 SF	WFO OPEN WORK AREA	130	EXISTING TO REMAIN	PT2	PT1	N/A	N/A		RB		EXISTING TO REMAIN	
2125 SF	RFC OPEN WORK AREA	131	EXISTING TO REMAIN	N/A	PT1	PT1	PT1		RB		EXISTING TO REMAIN	

### FINISH SCHEDULE GENERAL NOTES

RE: A610 for typical floor finish transition details

RE: A651 for Floor Pattern Plans

### Finishes

Provide finishes as indicated in the finish schedule. Refer to interior elevations, where drawn, for clarification, dimensions and additional information. The absence of an interior elevation does not override the requirement to provide the finish indicated in the schedule.

Where a finish is partly hidden by an object, extend that finish behind the object.

Where multiple finishes are scheduled, refer to interior elevations and floor pattern plans for transition locations.

Floor: Extend floor finishes into knee spaces at cabinets, under counters and under all other objects, which in a floor plan view may obscure the extent of the floor finish.

Base: Where base is scheduled for a room, provide base at all walls whether shown in elevation, including alcoves and offsets. At gypsum board walls, if no base is scheduled or shown in interior elevations, provide 4" rubber base.

**Walls**: Extend wall finishes behind cabinets, behind mirrors, and into other areas that may be hidden in elevation views.

**Ceilings**: Paint areas above suspended ceilings that are visible from below. Color: black.

**Doors, Windows and Frames**: Unless specified to be pre-finished at the factory, provide paint finish on hollow metal doors and hollow metal door and window frames. Color as indicated, or if not indicated, then as selected by the Architect. Provide specified stain finish at wood doors.

Unfinished and Primed Metal Surfaces: Paint all unfinished and primed metal surfaces that are visible with the specified system(s). Color by Architect.

Standing and Running Trim: Provide specified stain finish at wood trim.

Floor Finish Transitions at Doors: Locate floor finish material transitions that occur at doors under the center of the door, UNO.

Floor Drains: Coordinate location of floor drains with Plumbing drawings.

Typical Colors, UNO: Walls: PT1 Doors: MATCH EXISTING Frames: MATCH EXISTING

**Seaming Diagrams:** Provide diagrams for broadloom carpet and sheet flooring.

Wall Covering Seams: Apply wall covering to minimize seams, to provide equal panels and locate seams no closer than 1'-0" from corners.

4



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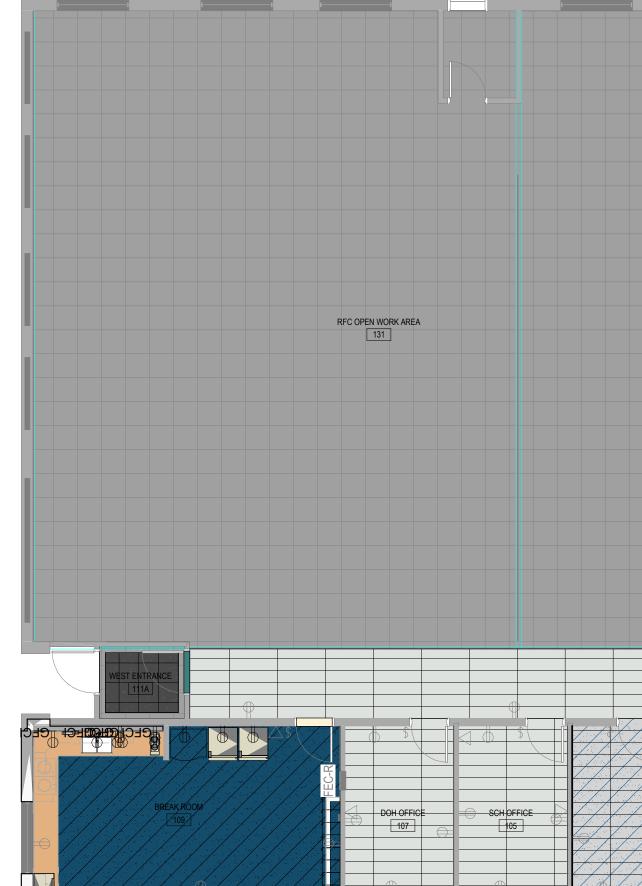
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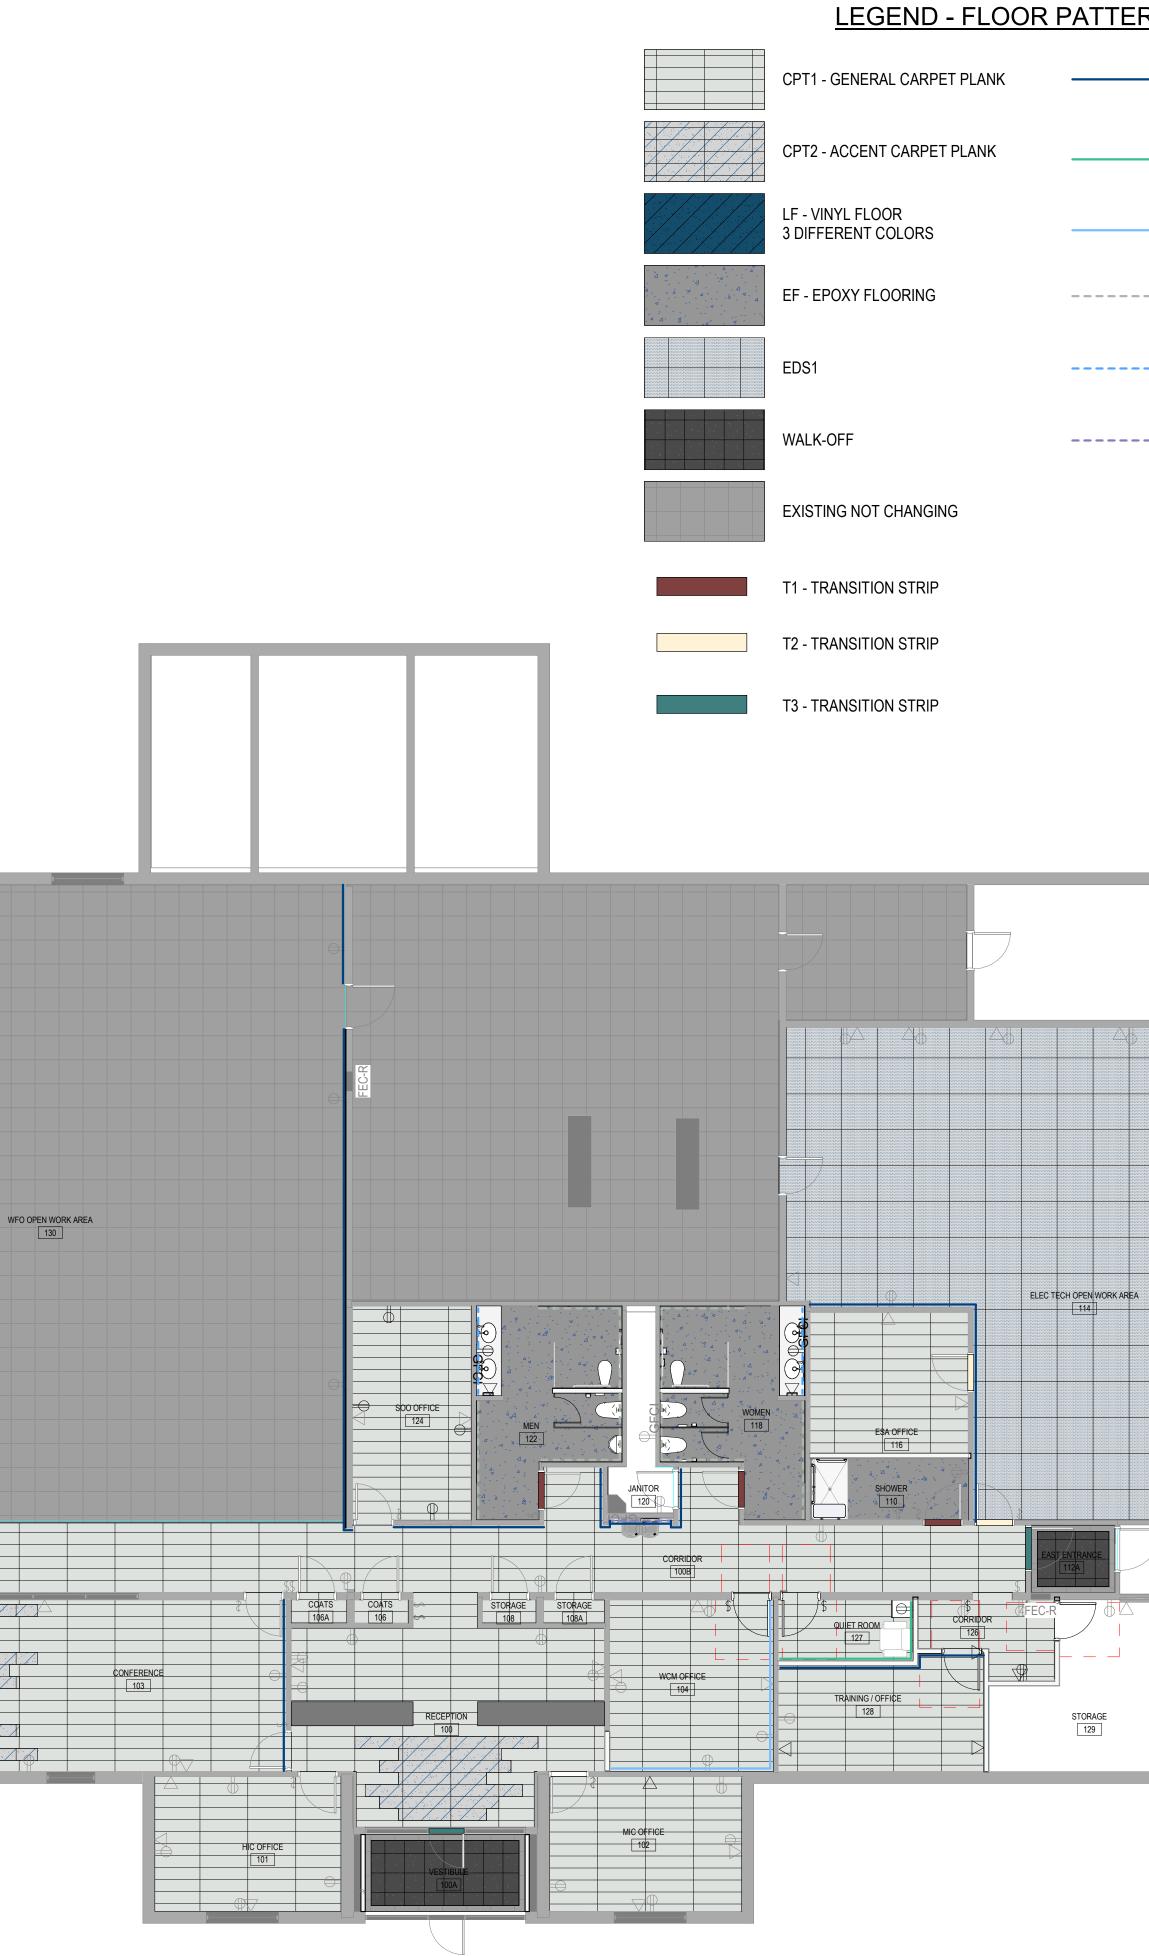
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0 4' - 0" 8' - 0" 16' - 0"



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### LEGEND - FLOOR PATTERN



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PT2 - NEW ACCENT PAINT

PT3 - NEW ACCENT PAINT QUIET ROOM ONLY

EXISTING ACCENT PAINT

---- WT1 - WALL TILE

----- WT2 - WALL TILE

----- WP - WALL PROTECTION

RE: A640 for the Finish Schedule.

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RE: A640 For Carpet Installation.

RE: A610 for typical floor finish transition details

RE: Structural drawings for recessed slabs.


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the room, UNO.

2,500 SF.

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### REFLECTED CEILING PLAN GENERAL NOTES

Ceiling Height: 9'-0" UNO. Where floor height varies in a room, ceiling height is shown at the entry to

Ceiling Grid/Panel Alignment: The design intent of the Reflected Ceiling Plans is center ceiling grids or acoustical panels between walls in both directions, or to center grids in one direction, panels in the other. If the grid does not comply with the design intent, then coordinate with Architect to adjust the ceiling layout prior to installation.

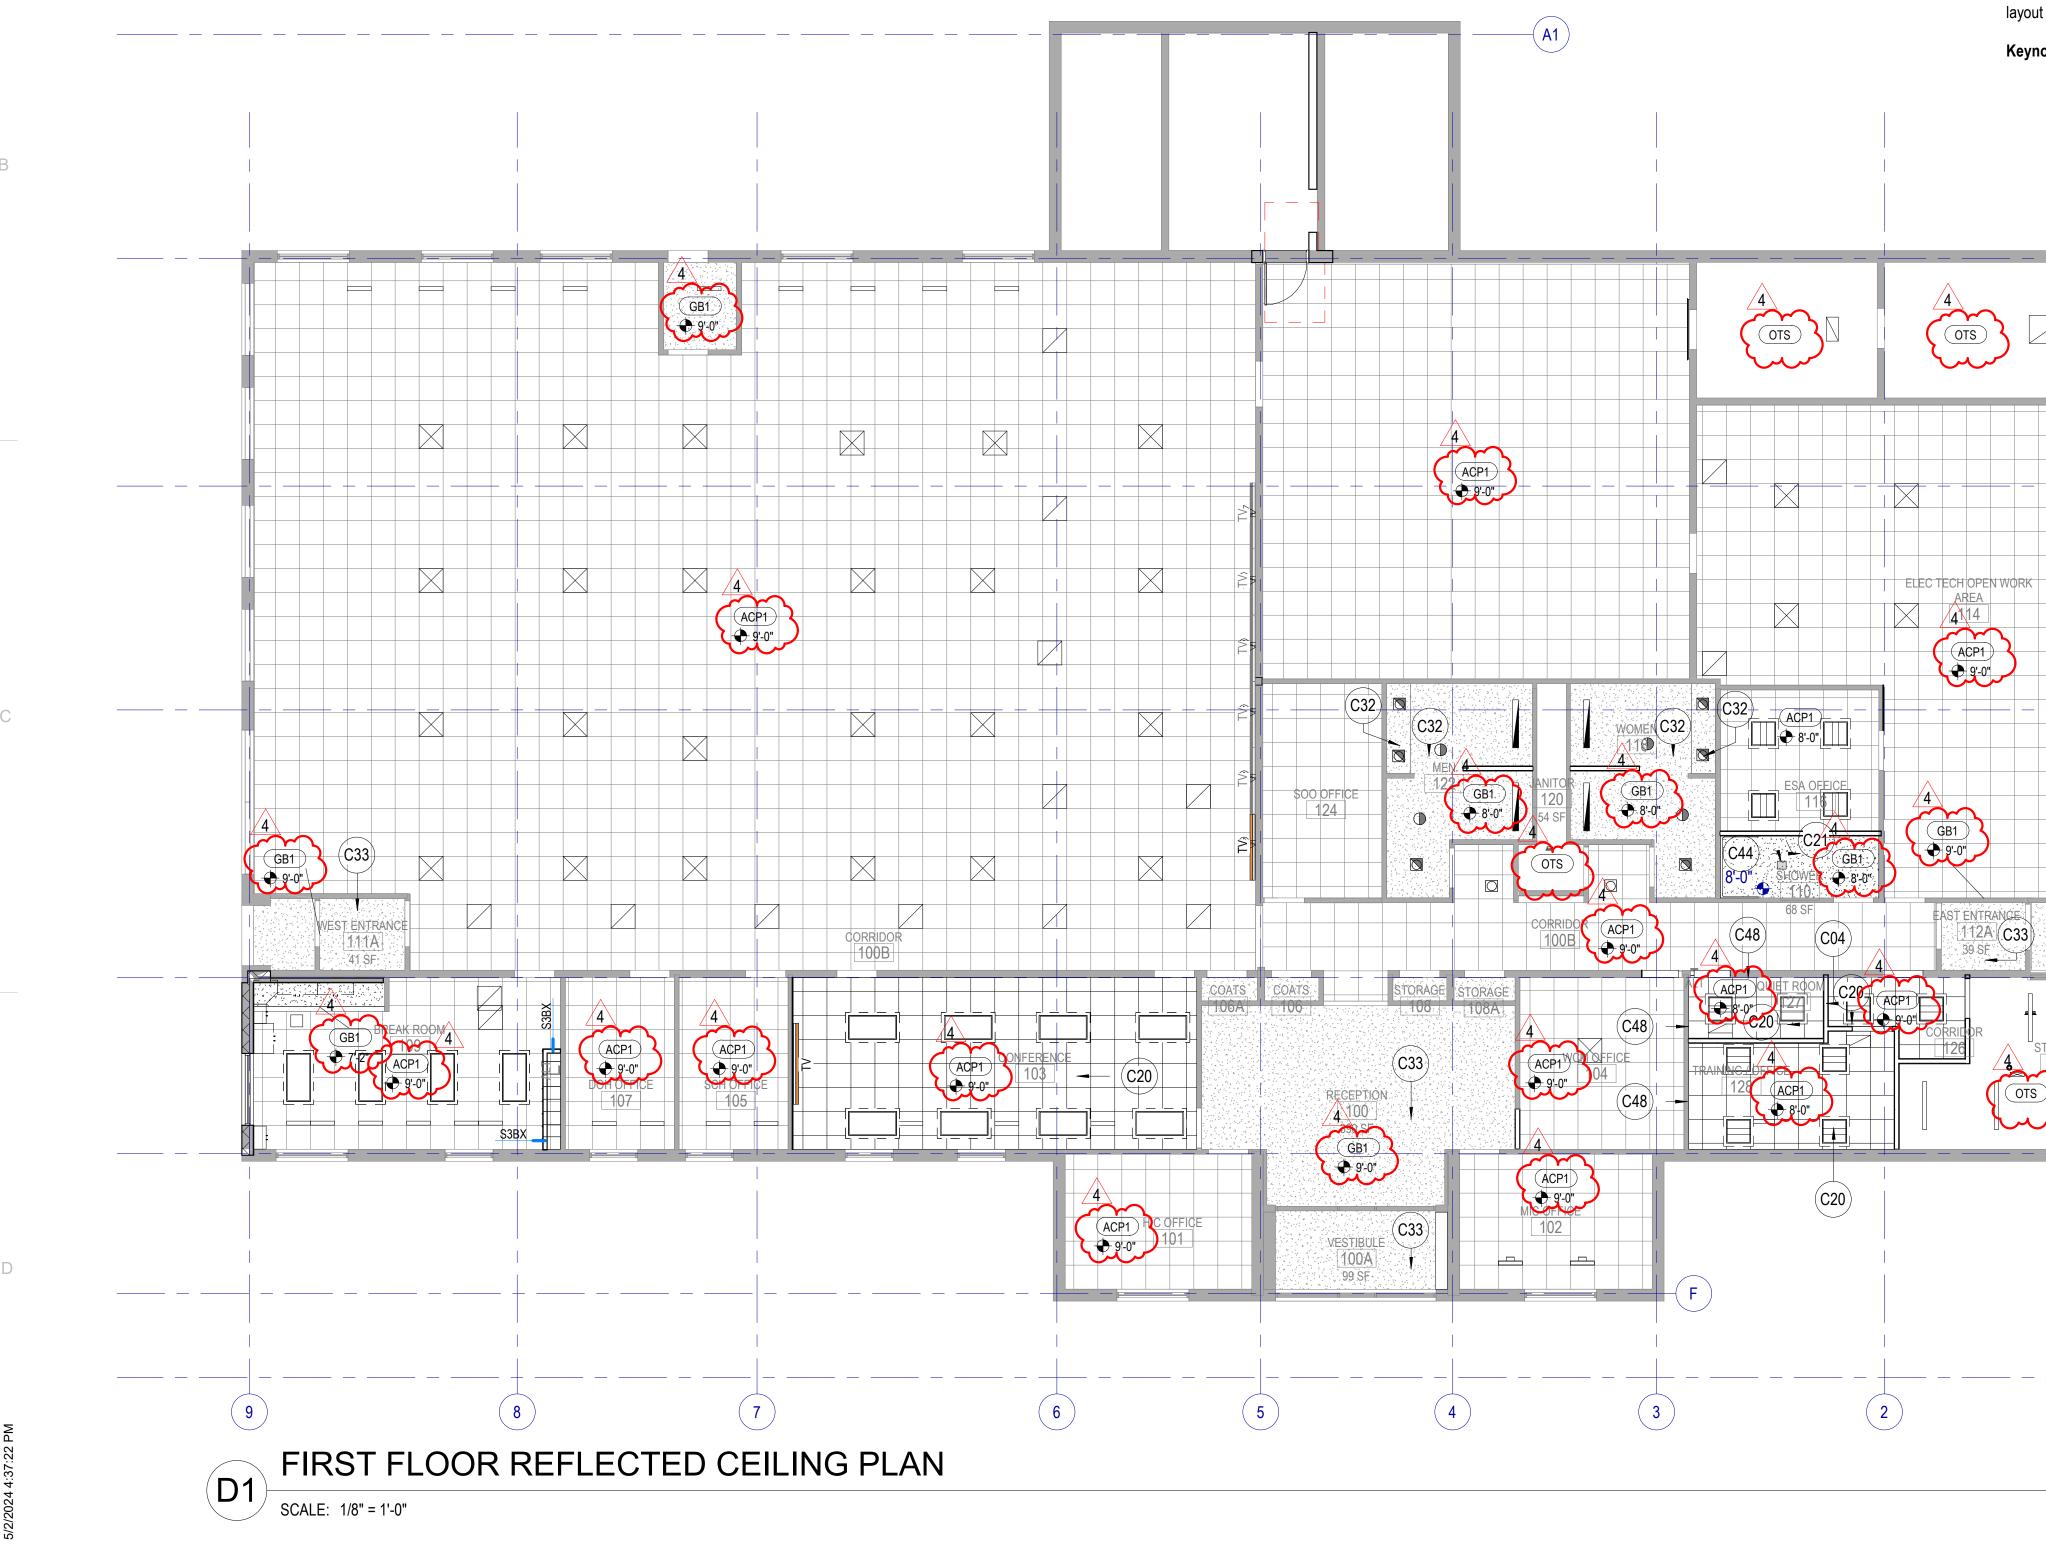Seismic Design Category: D: Heavy-duty suspension system required / Refer to Structural / Refer to Specifications.

Seismic Bracing: Rigid bracing required at ceilings over 1,000 SF and at all ceilings with fire sprinklers and other penetrations.

Seismic Control Joints: Provide seismic control joints in suspended acoustical ceilings greater than

Control Joints: Provide control joints in gypsum board ceilings at 30'-0" max spacing. Coordinate locations with Architect to align joints with other elements in the ceilings or on the walls.

Exposed Elements: Paint exposed structure, pipe, conduit and HVAC duct at open ceilings and at open areas around ceiling clouds. Color: As selected by Architect.

Walls to Deck: Extend all walls to deck, including all components of the wall assembly, UNO.

Fire Sprinklers: Center sprinkler heads in acoustical panels; run in straight lines in orthogonal, rectangular spaces.

Electrical, Mechanical and other Devices: Center in acoustical panels. Coordinate feature lighting layout with Architect prior to rough-in.

Keynotes: Not all keynotes apply to this sheet.

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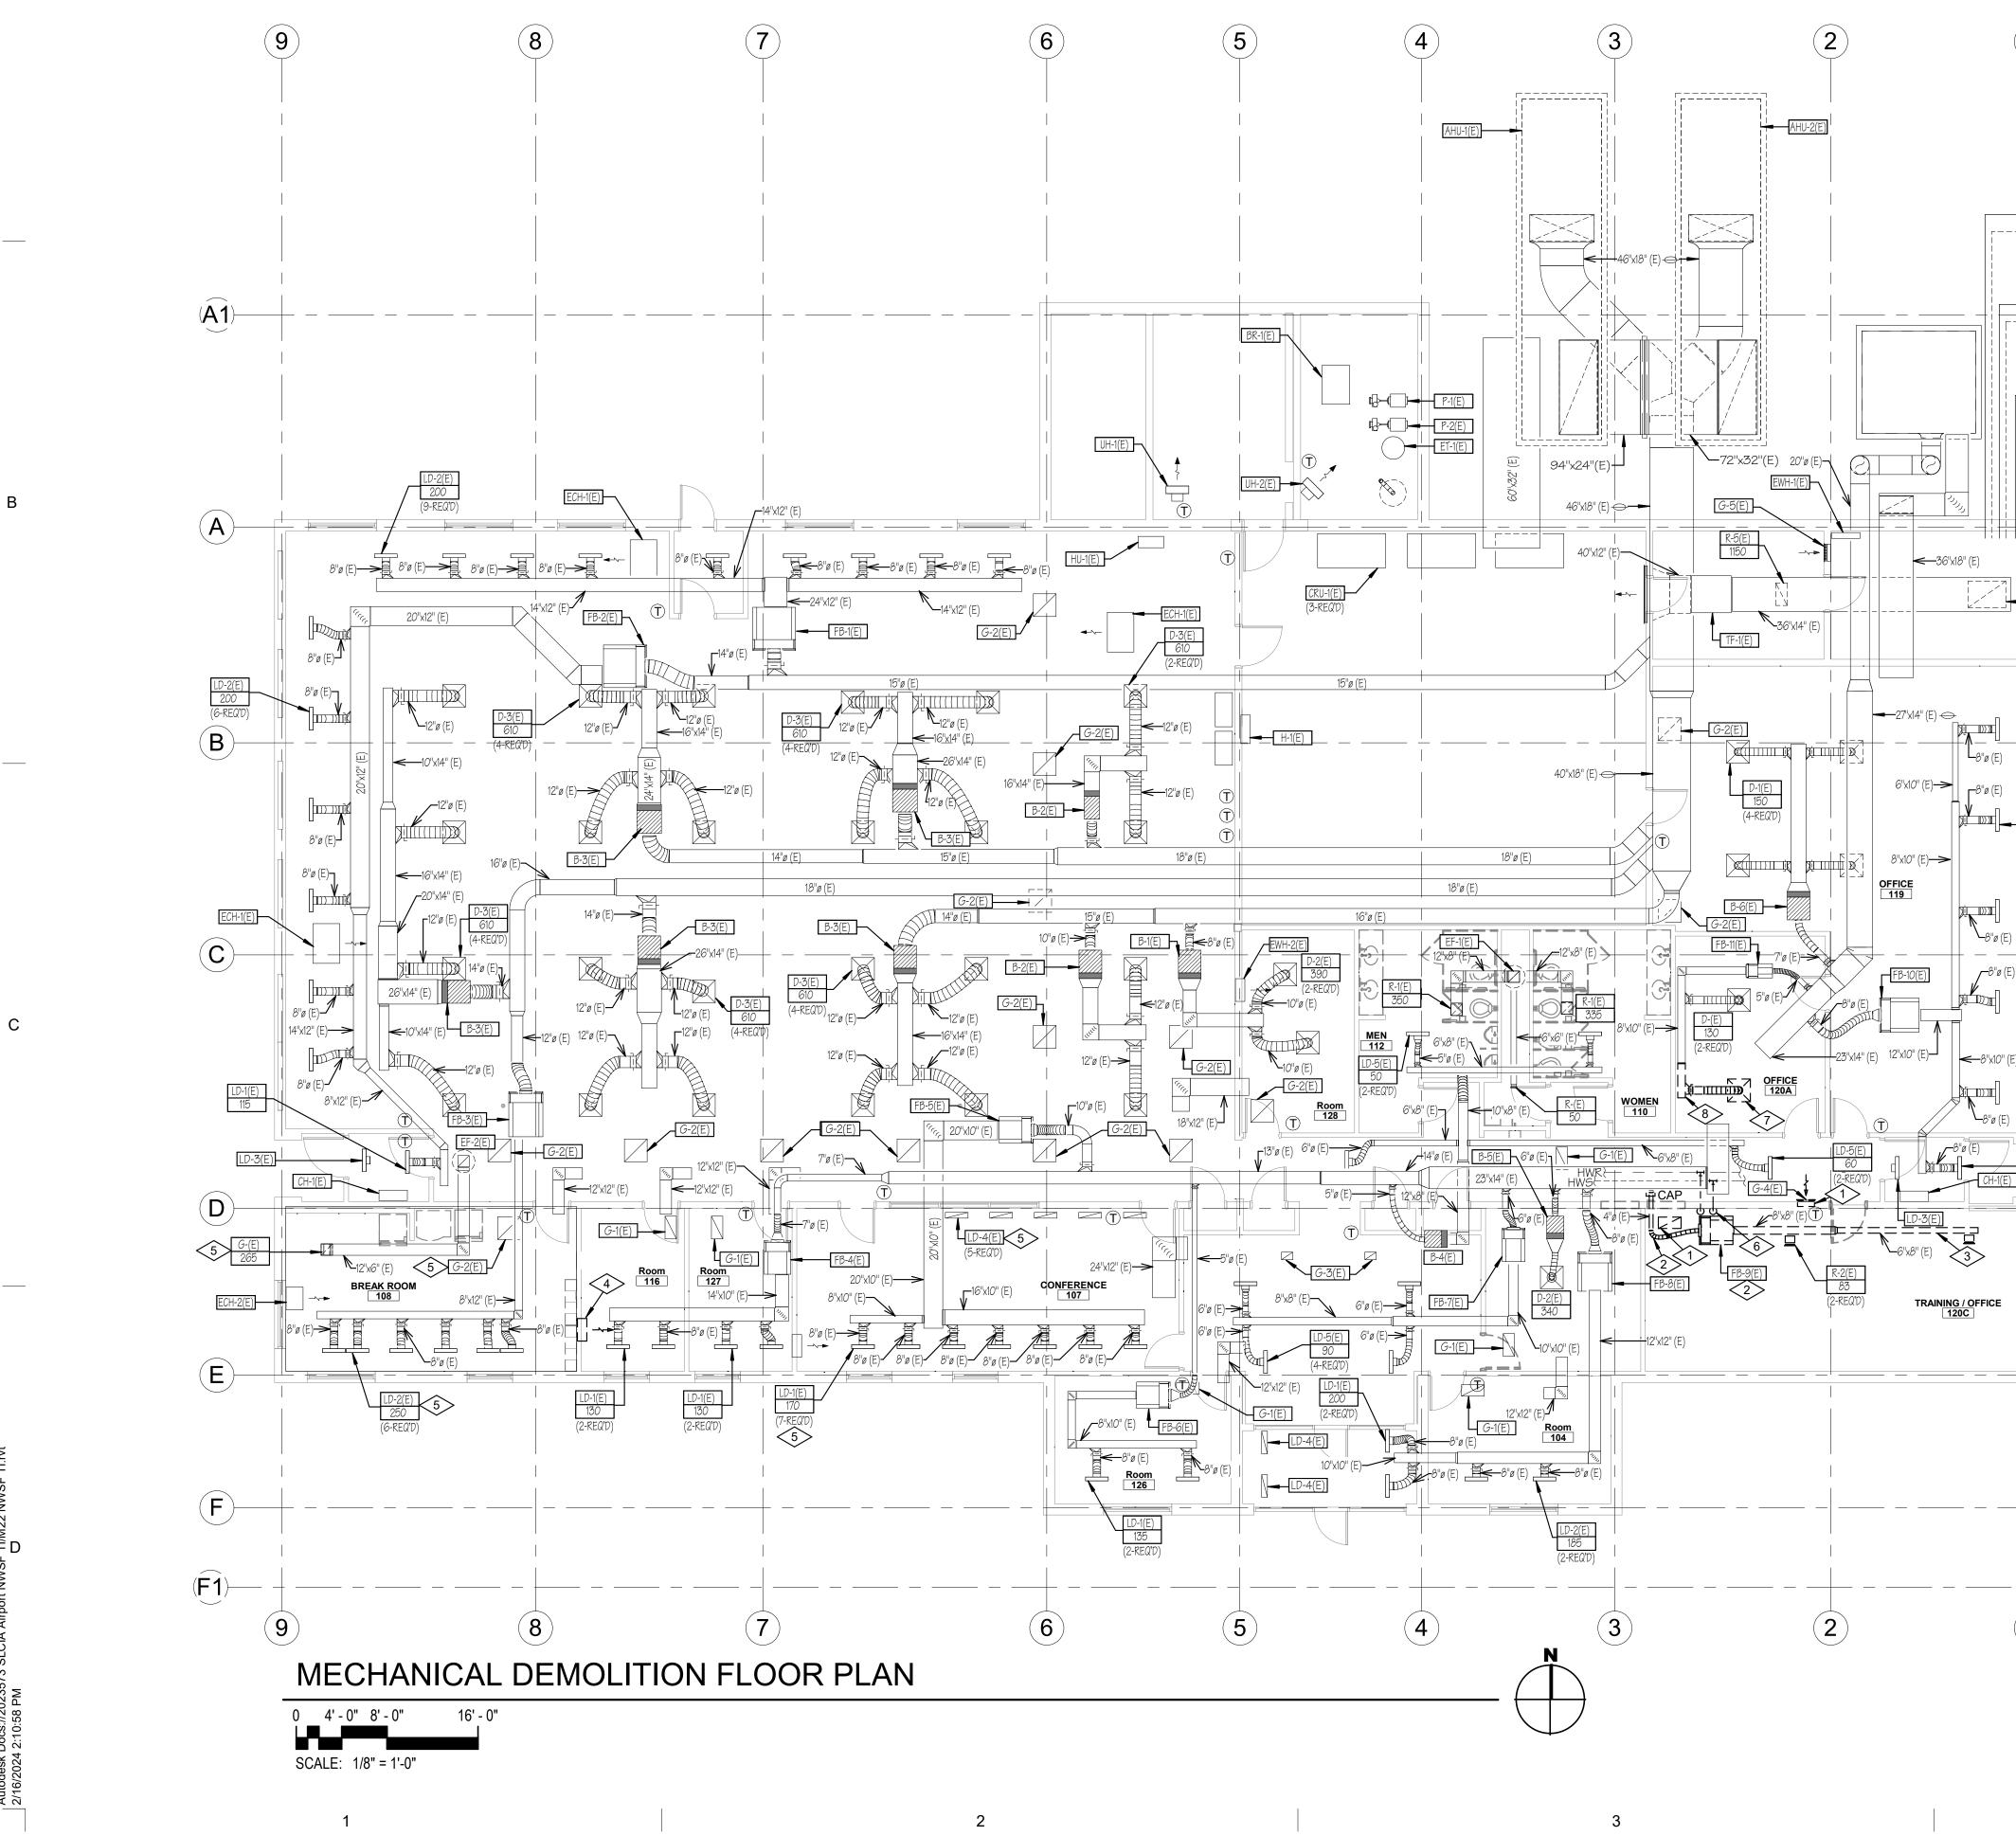
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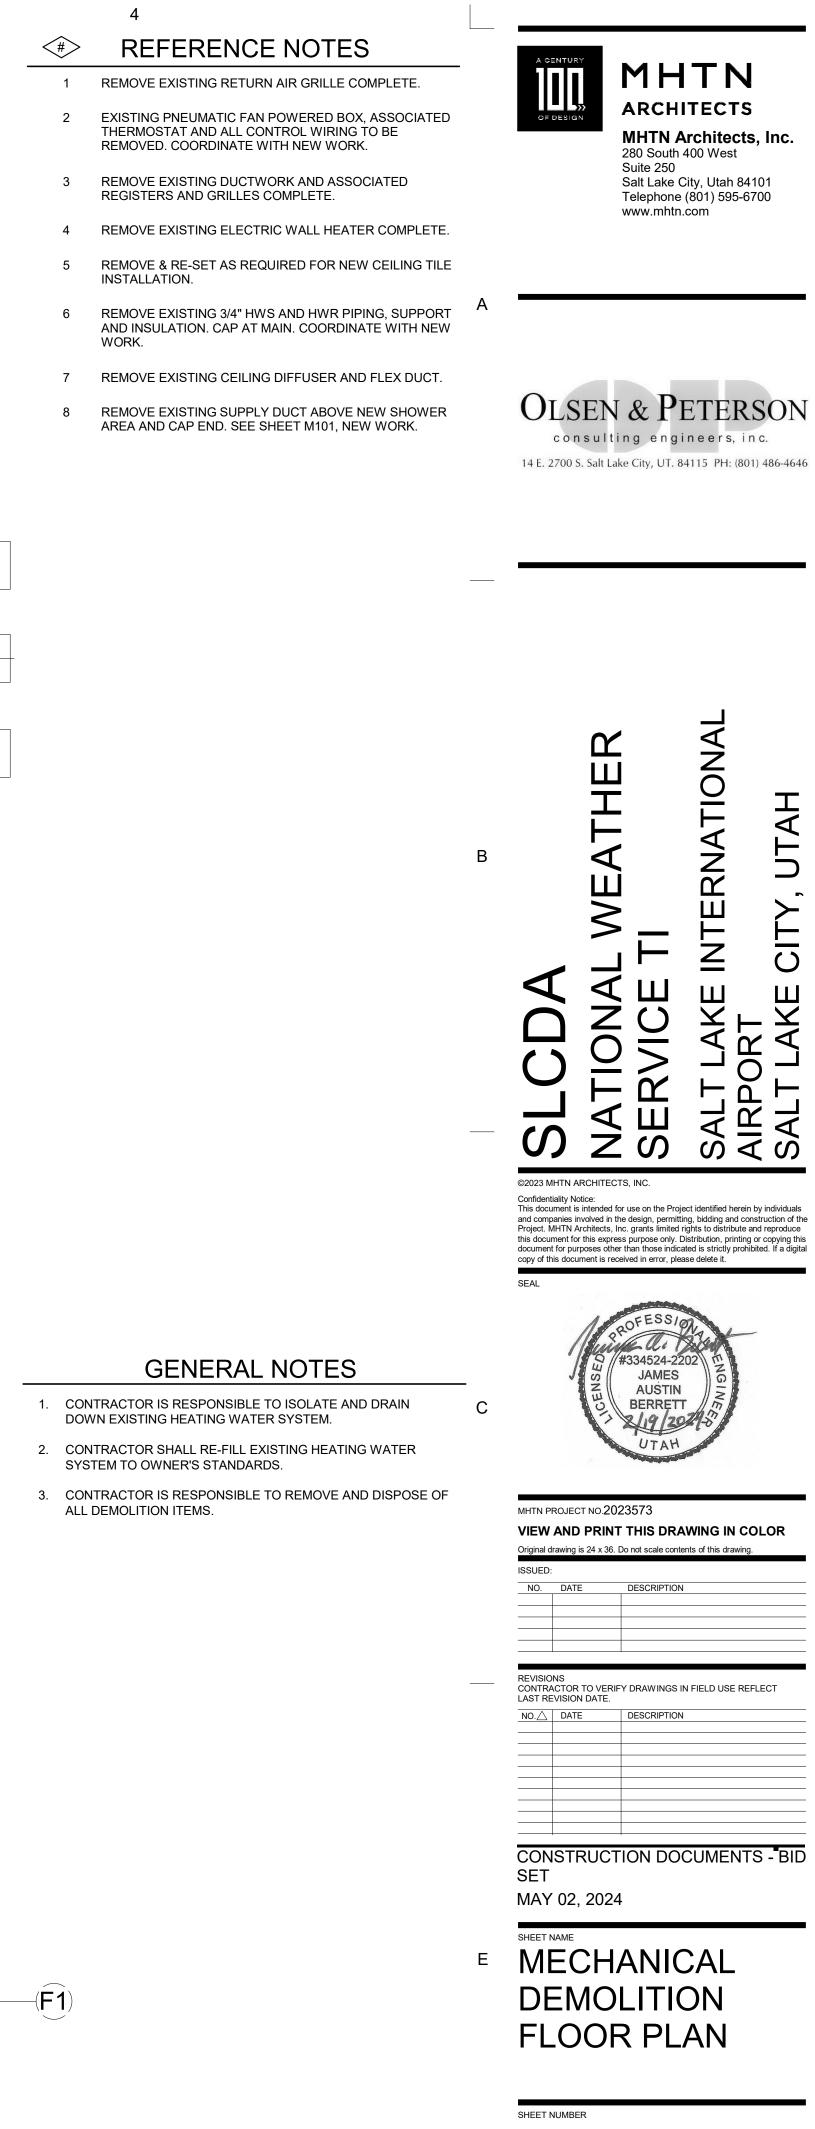
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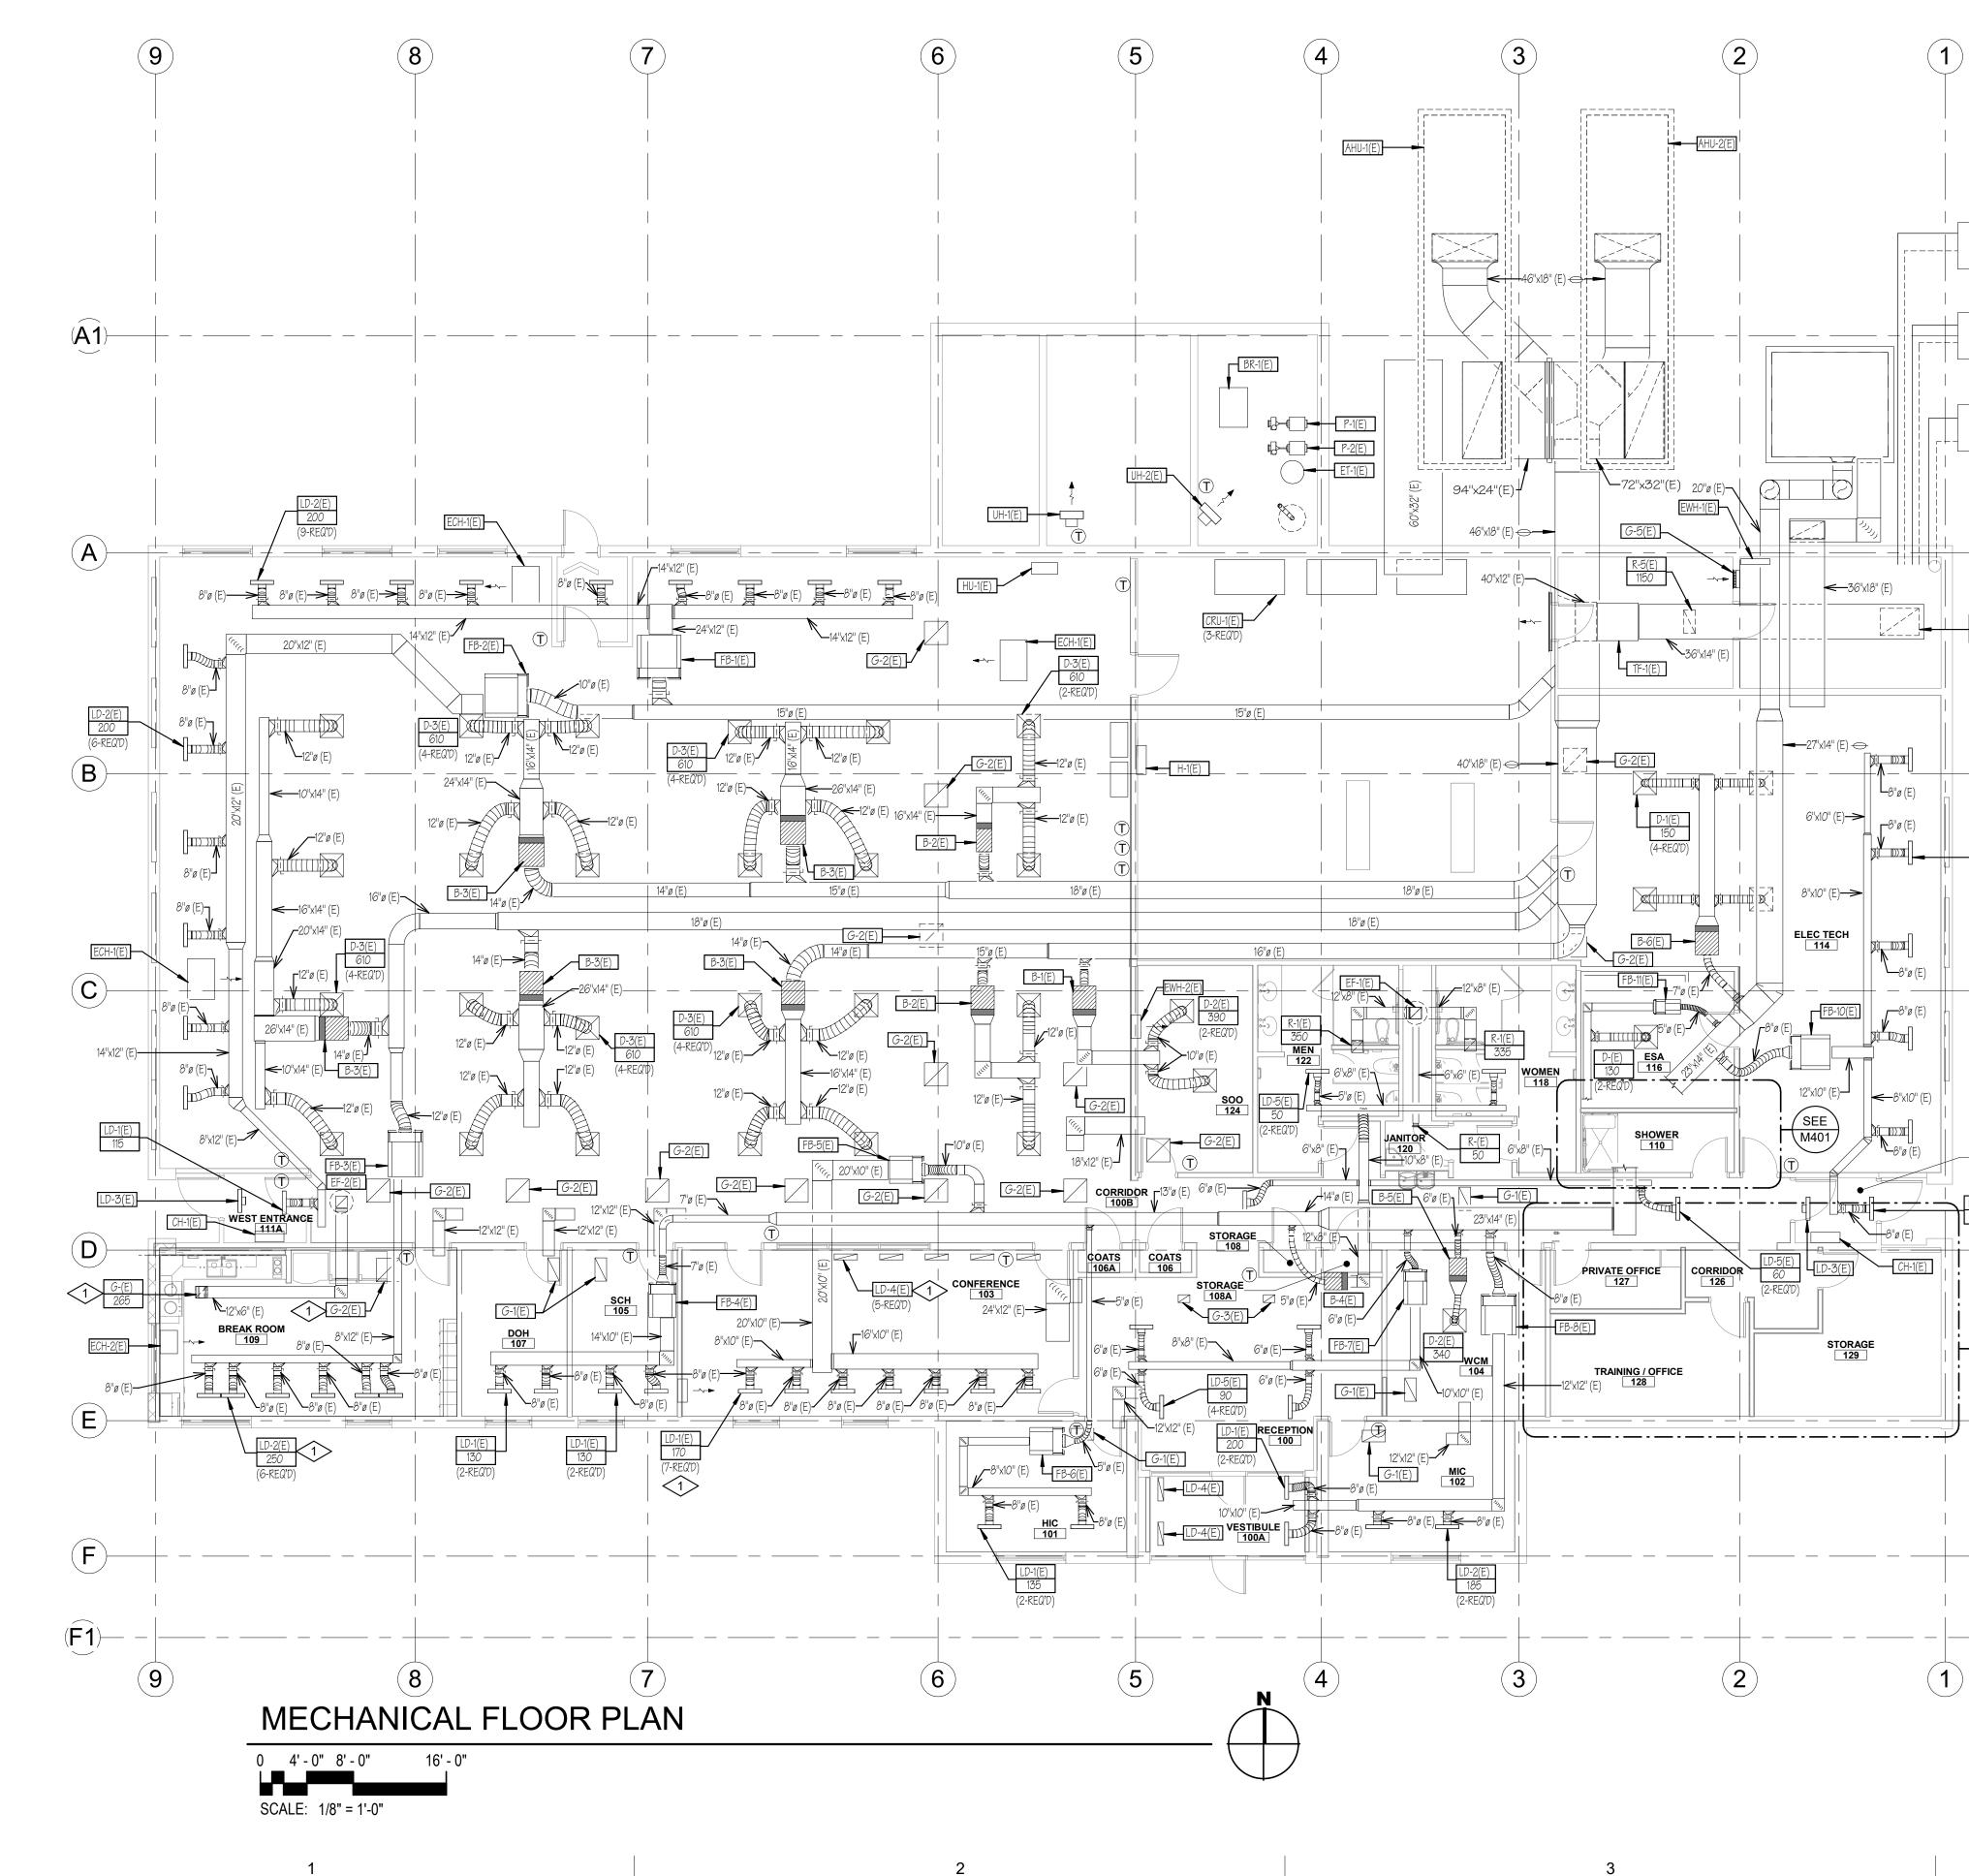
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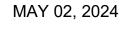
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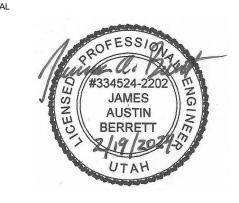


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**OLSEN & PETERSON** 

consulting engineers, inc.

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**REFERENCE NOTES** 

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REMOVE & RE-SET AS REQUIRED FOR NEW CEILING TILE INSTALLATION.

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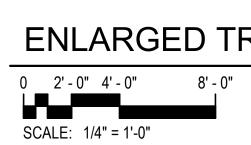
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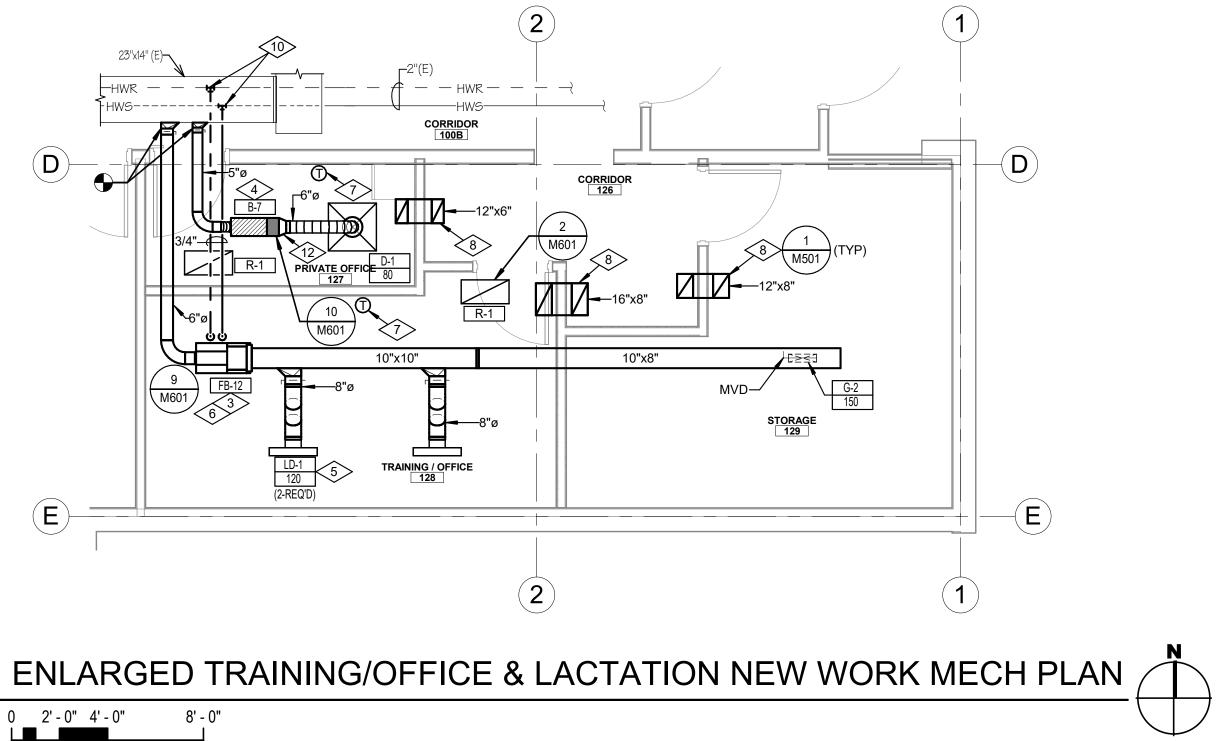
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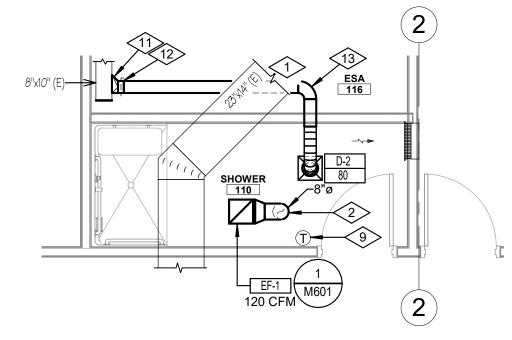



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### **REFERENCE NOTES** <\#>

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- 1 EXISTING DUCTWORK TO REMAIN.
- NEW EXHAUST FAN; ROUTE EXHAUST UP THROUGH ROOF TO RAINPROOF CAP. SEE DETAIL 8/M601. 2
- PROVIDE NEW FAN POWERED BOX AND ASSOCIATED DUCTWORK AND CONTROLS. 3
- PROVIDE NEW VAV BOX AND ASSOCIATED DUCTWORK 4 AND CONTROLS.
- PROVIDE NEW LINEAR SLOT DIFFUSER. COORDINATE WITH OTHER PROJECT FOR CONNECTIONS SIZES. 5
- PROVIDE NEW HWS & HWR PIPING AS REQUIRED. PROVIDE NEW HW VALVE. 6
- NEW DIGITAL HEATING/COOLING THERMOSTAT. 7
- TRANSFER AIR DUCT; PROVIDE OPENINGS AT EACH END ON TOP FOR SOUND ATTENUATION. 8
- 9 EXISTING THERMOSTAT TO REMAIN.
- CONNECT NEW HWS AND HWR PIPING TO EXISTING AT APPROXIMATELY THIS LOCATION. REPAIR PIPE 10 INSULATION AT TIE-IN.
- 11 CONNECT TO EXISTING SUPPLY DUCT.

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- 12 HET FITTING WITH MANUAL BALANCING DAMPER.
- 13 DUCT TO RUN ABOVE CEILING. COORDINATE WITH EXISTING CONDITION.



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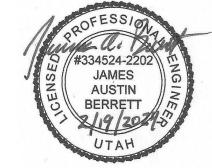
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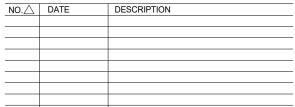
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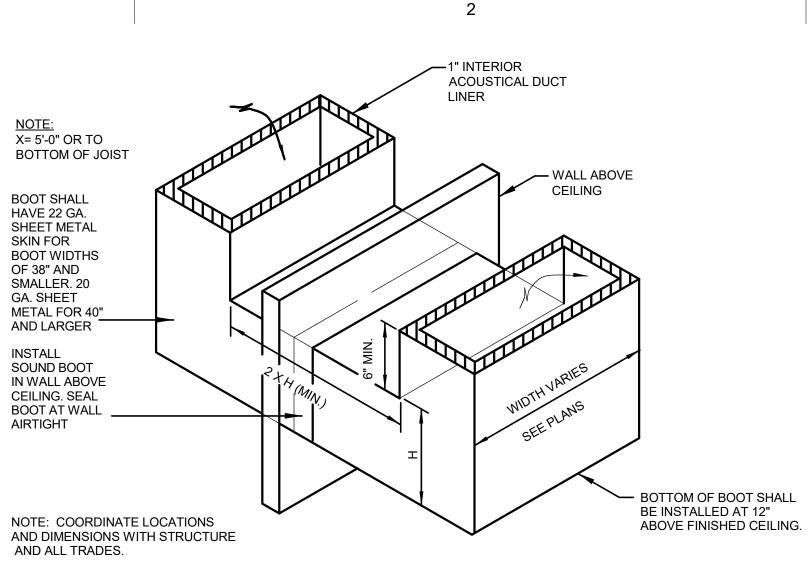
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### **RETURN AIR SOUND BOOT DETAIL**

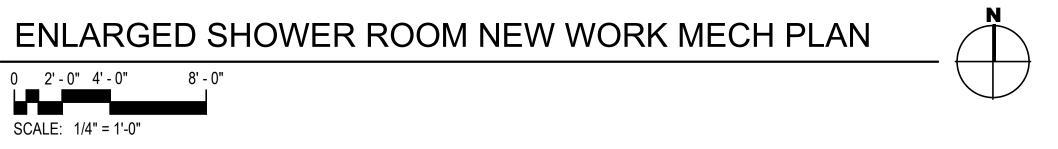M501

	TANT OWERED VAN REHEAT DOX SCHEDOLE												
			% (4)			% (5)		F	RE-HEAT	COIL	(2)	(6)	(1)(2)(3)
SYMBOL	COOLING CFM	HEATING CFM	MIN. CFM	INLET SIZE	A.P.D.	HEAT. CFM	MBH	GPM	ROWS	W.P.D.	COIL SIZE	MOTOR	MAKE & MODEL
FB-12	390	220	30	6" DIA.	.33"	60	10.7	1.1	2	.06 FT.	14" x 12 1/2"	1/8 H.P. 1.1 AMPS 277/1/60	PRICE FDV5-2006

NOTES:


FOR RIGHT OR LEFT HAND COIL CONNECTIONS. COORDINATE WITH INSTALLING CONTRACTOR.

(2) CAPACITIES BASED ON 55 DEG.F. ENTERING AIR TEMP., 180 DEG.F. ENTERING WATER TEMP WITH 20 DEG.F. WATER TEMP. DROP. & WATER SOLUTION (3) COORDINATE CONTROL MOUNTING WITH ATC CONTRACTOR.

(4) MINIMUM CFM SHALL BE SET FOR 30 PERCENT OF THE TOTAL CFM FOR EACH VAV BOX.

(5) MAXIMUM HEATING CFM SHALL BE SET FOR 60 PERCENT OF THE TOTAL CFM FOR EACH VAV BOX.

(6) MOTORS TO BE 277/1/60.

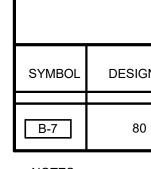

NOTES:

EXHAUST FAN SCHEDULE										
SYMBOL	TYPE	C.F.M	S.P.	R.P.M.	MOTOR	DRIVE	WEIGHT LBS.	MAKE & MODEL		
EF-1	CEILING	160	.25"	740	127 WATTS 120/1/60	DIRECT		TWIN CITY T200 (1)		

NOTES:

(1) CEILING MOUNTED EXHAUST FANS TO BE COMPLETE WITH SIGHT TIGHT BAR-TYPE CEILING GRILLE, BACKDRAFT DAMPERS AND FLEXIBLE CONNECTION ON DISCHARGE DUCT.

REGISTER & GRILLE SCHEDULE							
SYMBOL	SIZE	LOCATION	TYPE	MAKE & MODEL (1)			
G-1	12" x 12"	CEILING	EXHAUST	PRICE 535			
G-2	14" X 4"	DUCT	SUPPLY	PRICE 510			
R-1	24" x 12"	CEILING	RETURN	PRICE 535			

NOTES:

SHALL COORDINATE WITH REFLECTED CEILING PLANS TO DETERMINE PROPER FRAMES.

(1) COLOR AND FINISH TO MATCH CEILING GRID, COORDINATE WITH ARCHITECT. SUPPLIER OF REGISTERS AND GRILLES (2) ALL REGISTERS TO BE C/W OPPOSED BLADE VOLUME CONTROL DAMPER.

(3) COORDINATE EXACT LOCATION WITH ARCHITECT PRIOR TO INSTALLATION.

LINEAR DIFFUSER SCHEDULE							
SYMBOL	SLOT WIDTH	# OF SLOTS	DIFFUSER LENGTH	PATTERN	CEILING	(1)(2)(3)(4) MAKE & MODEL	
LD-1 CFM	3/4"	2	24"	2-WAY	LAY IN	PRICE SDS75	

NOTES:

(1) COLOR & FINISH TO MATCH CEILING OR CEILING GRID. COORDINATE WITH ARCHITECT.

(2) INTERIOR DEFLECTOR OF DIFFUSER SHALL BE FLAT BLACK. (3) MAXIMUM NC OF 35 AT DESIGN CFM.

(4) ALL LINEAR DIFFUSERS MUST BE SUPPORTED FROM OVERHEAD CONSTRUCTION INDEPENDENT OF CEILING WITH A MINIMUM OF (2) 12-GAUGE WIRES.

DIFFUSER SCHEDULE								
SYMBOL	TYPE	DIFFUSER SIZE	NECK SIZE	LOCATION	AIR PATTERN	MAKE & MODEL		
D-1 CFM	SUPPLY AIR	24"x24"	6"Ø	CEILING	4-WAY	(1)(2) PRICE SCD		
D-2 CFM	SUPPLY AIR	12"x12"	6"Ø	CEILING	4-WAY	(1)(2) PRICE ASCD		

NOTES:

(1) DIFFUSERS SHALL HAVE BRIGHT-WHITE FINISH.

(2) COORDINATE WITH ARCHITECTURAL CEILING PLAN FOR CEILING TYPE.


### FAN POWFRED VAV REHEAT BOX SCHEDULE

(1) VAV AND COIL CONTROL SHALL BE ACCESSED FROM SAME SIDE OF BOX. SEE PLAN


VAV BOX SCHEDULE							
GN CFM	% (2) MIN. CFM	INLET SIZE	A.P.D.	% (3) HEAT. CFM	(1) MAKE & MODEL		
)	30	5" DIA.	.33"	60	PRICE SDV		


(1) COORDINATE CONTROL MOUNTING WITH ATC CONTRACTOR.


(2) MINIMUM CFM SHALL BE SET FOR 30 PERCENT OF THE TOTAL CFM FOR EACH VAV BOX. (3) MAXIMUM HEATING CFM SHALL BE SET FOR 60 PERCENT OF THE TOTAL CFM FOR EACH VAV BOX.

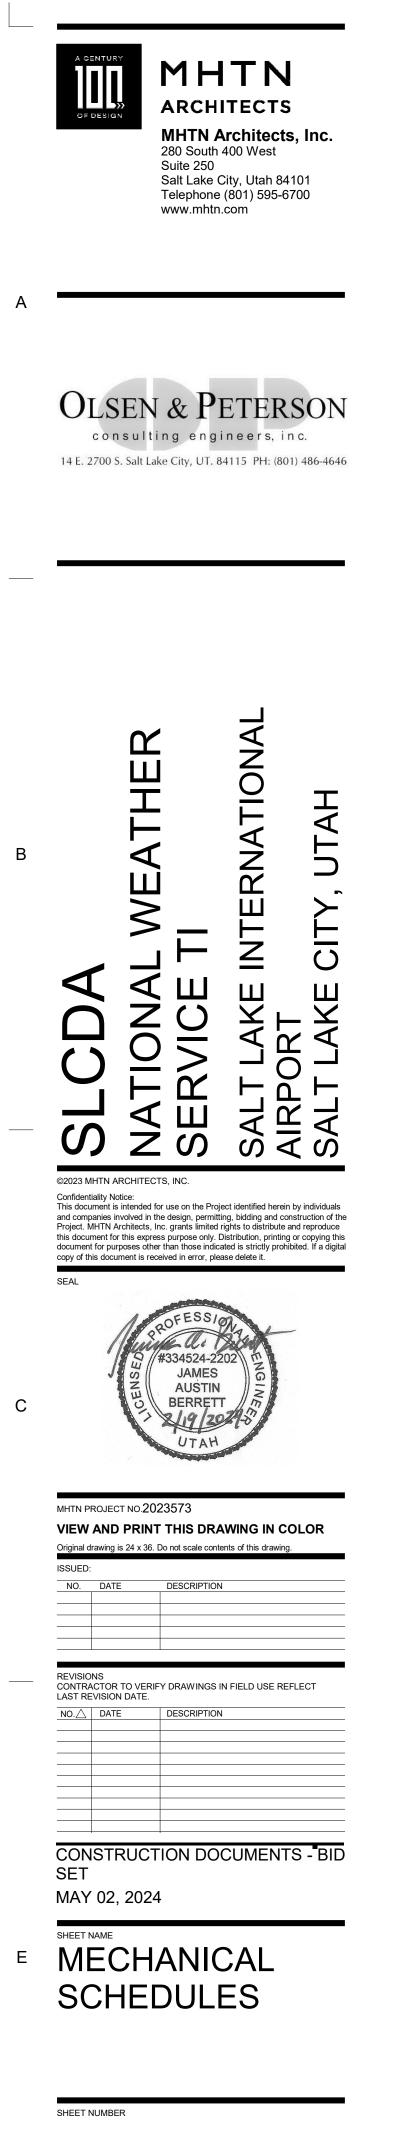



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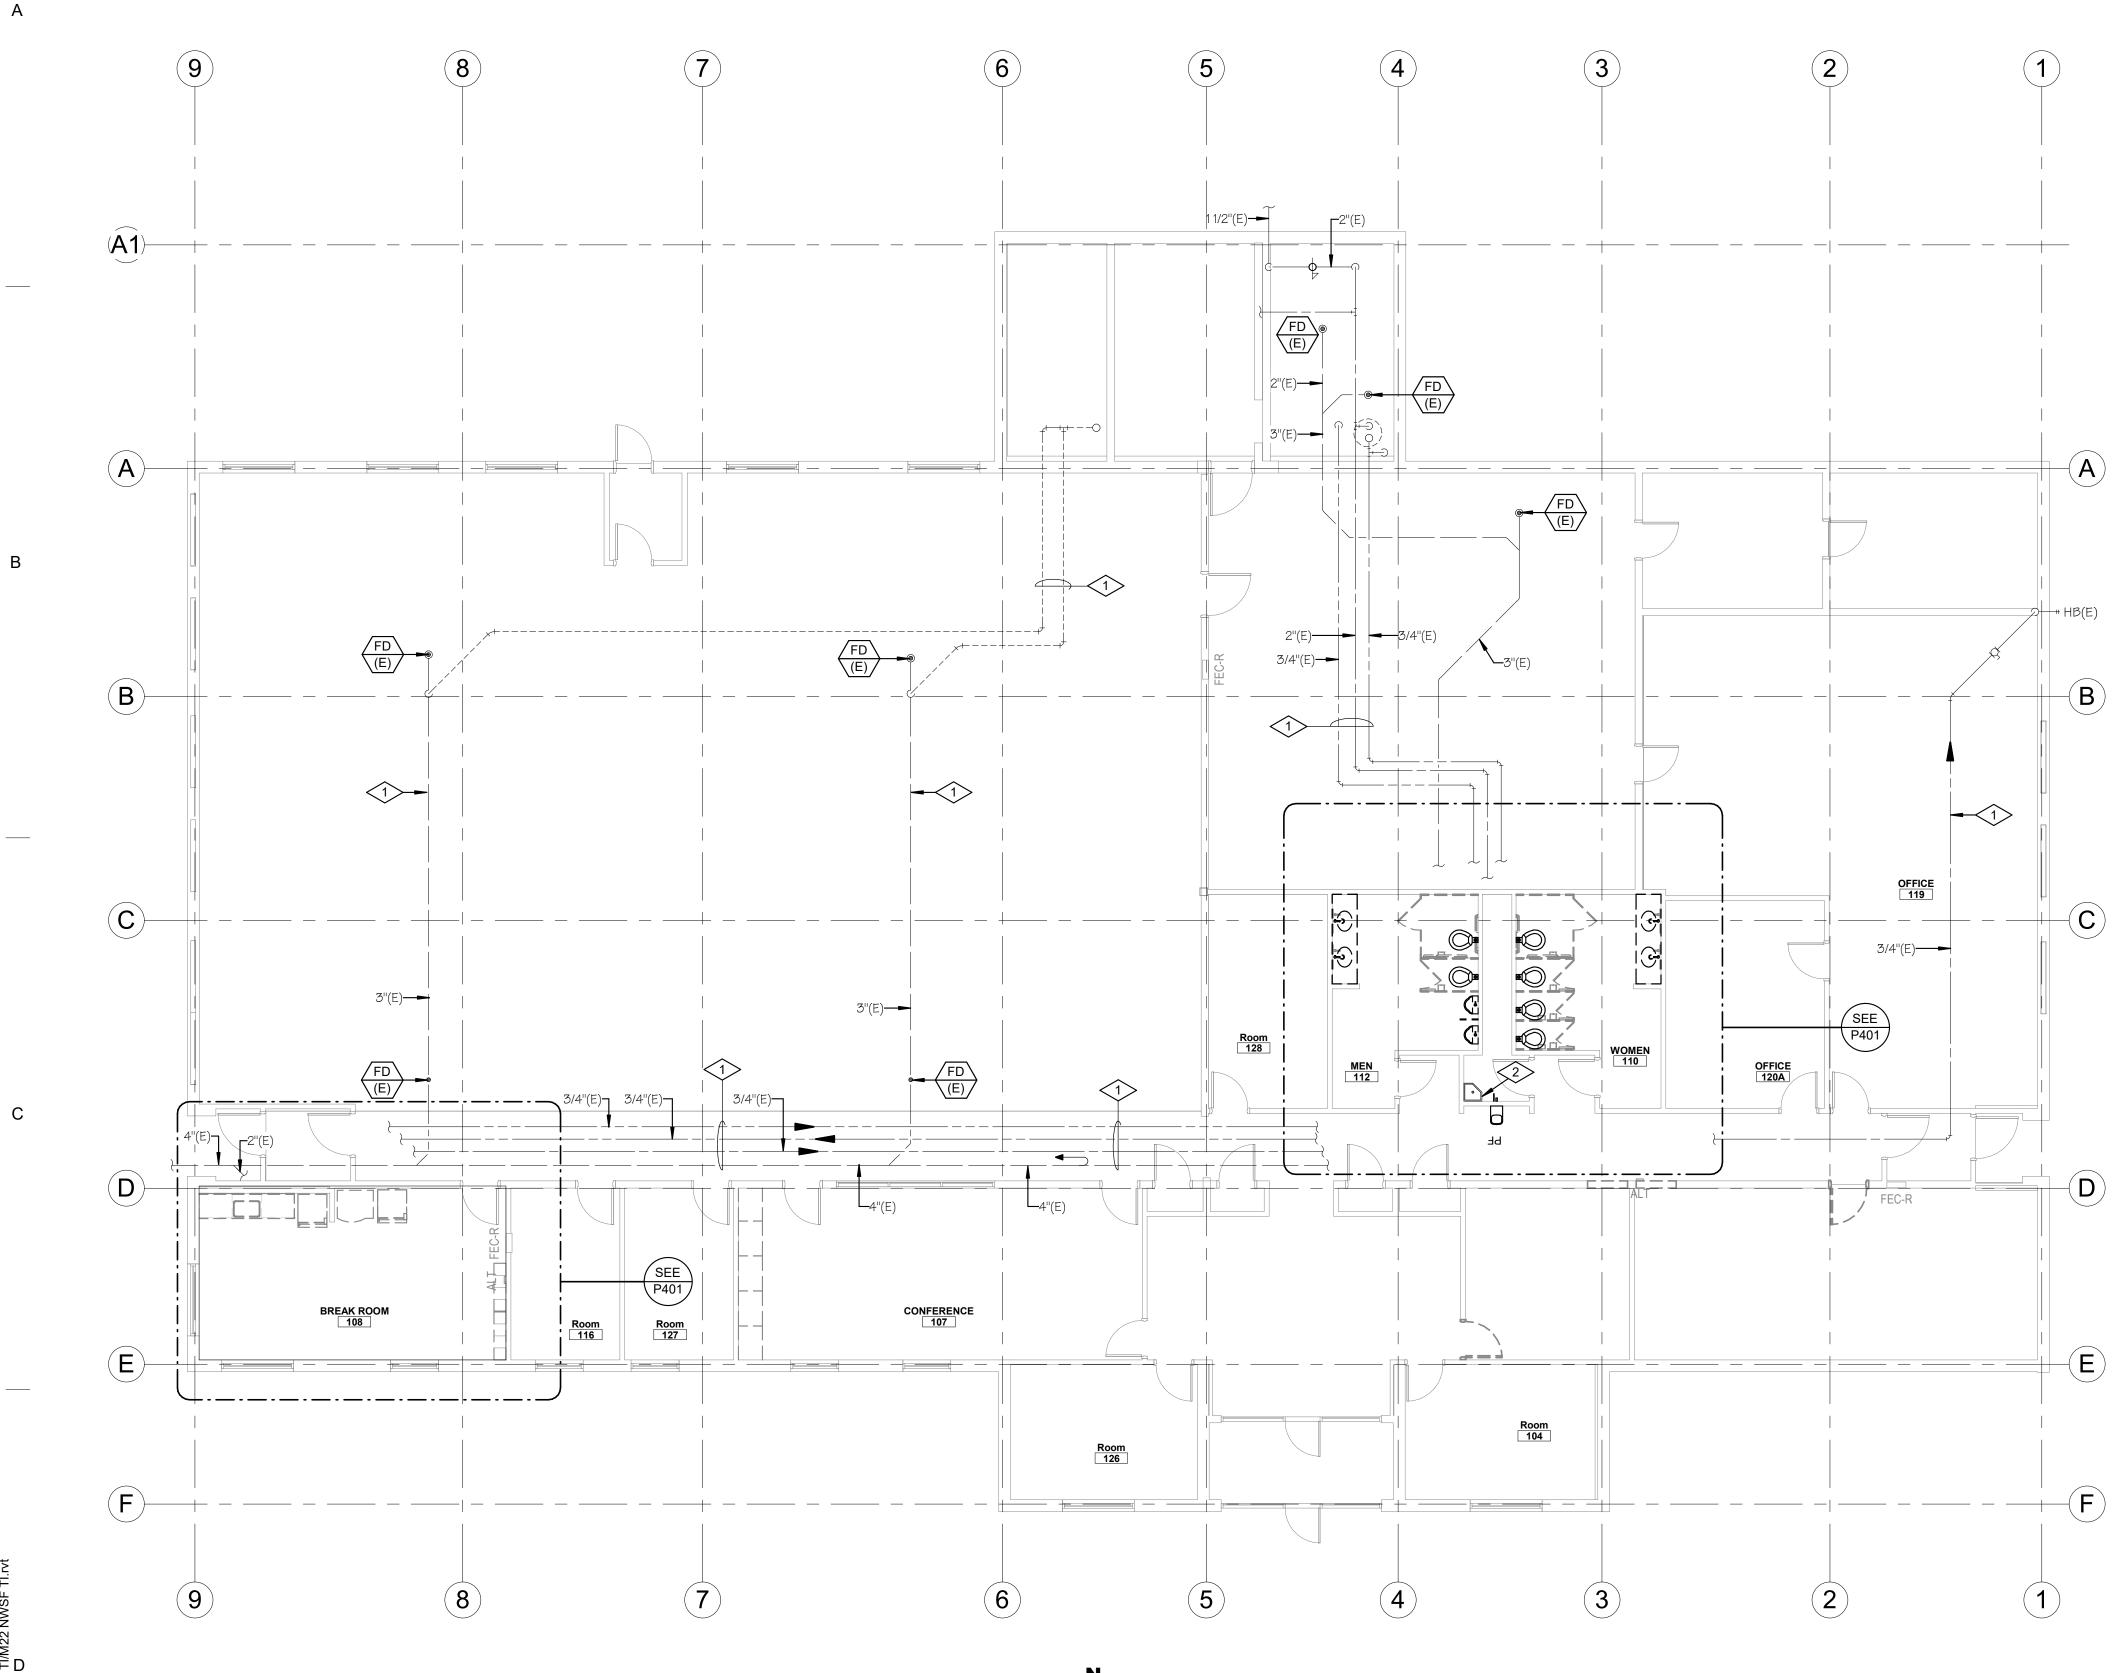


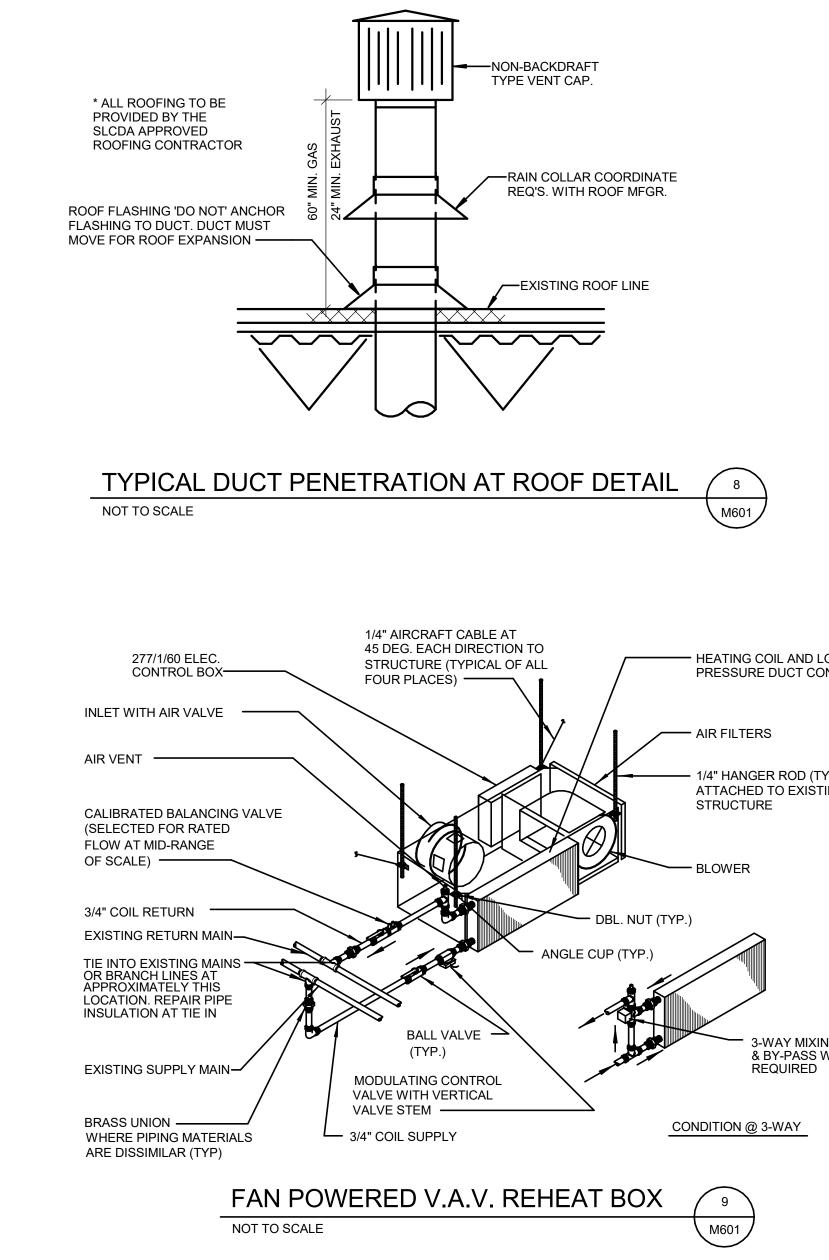

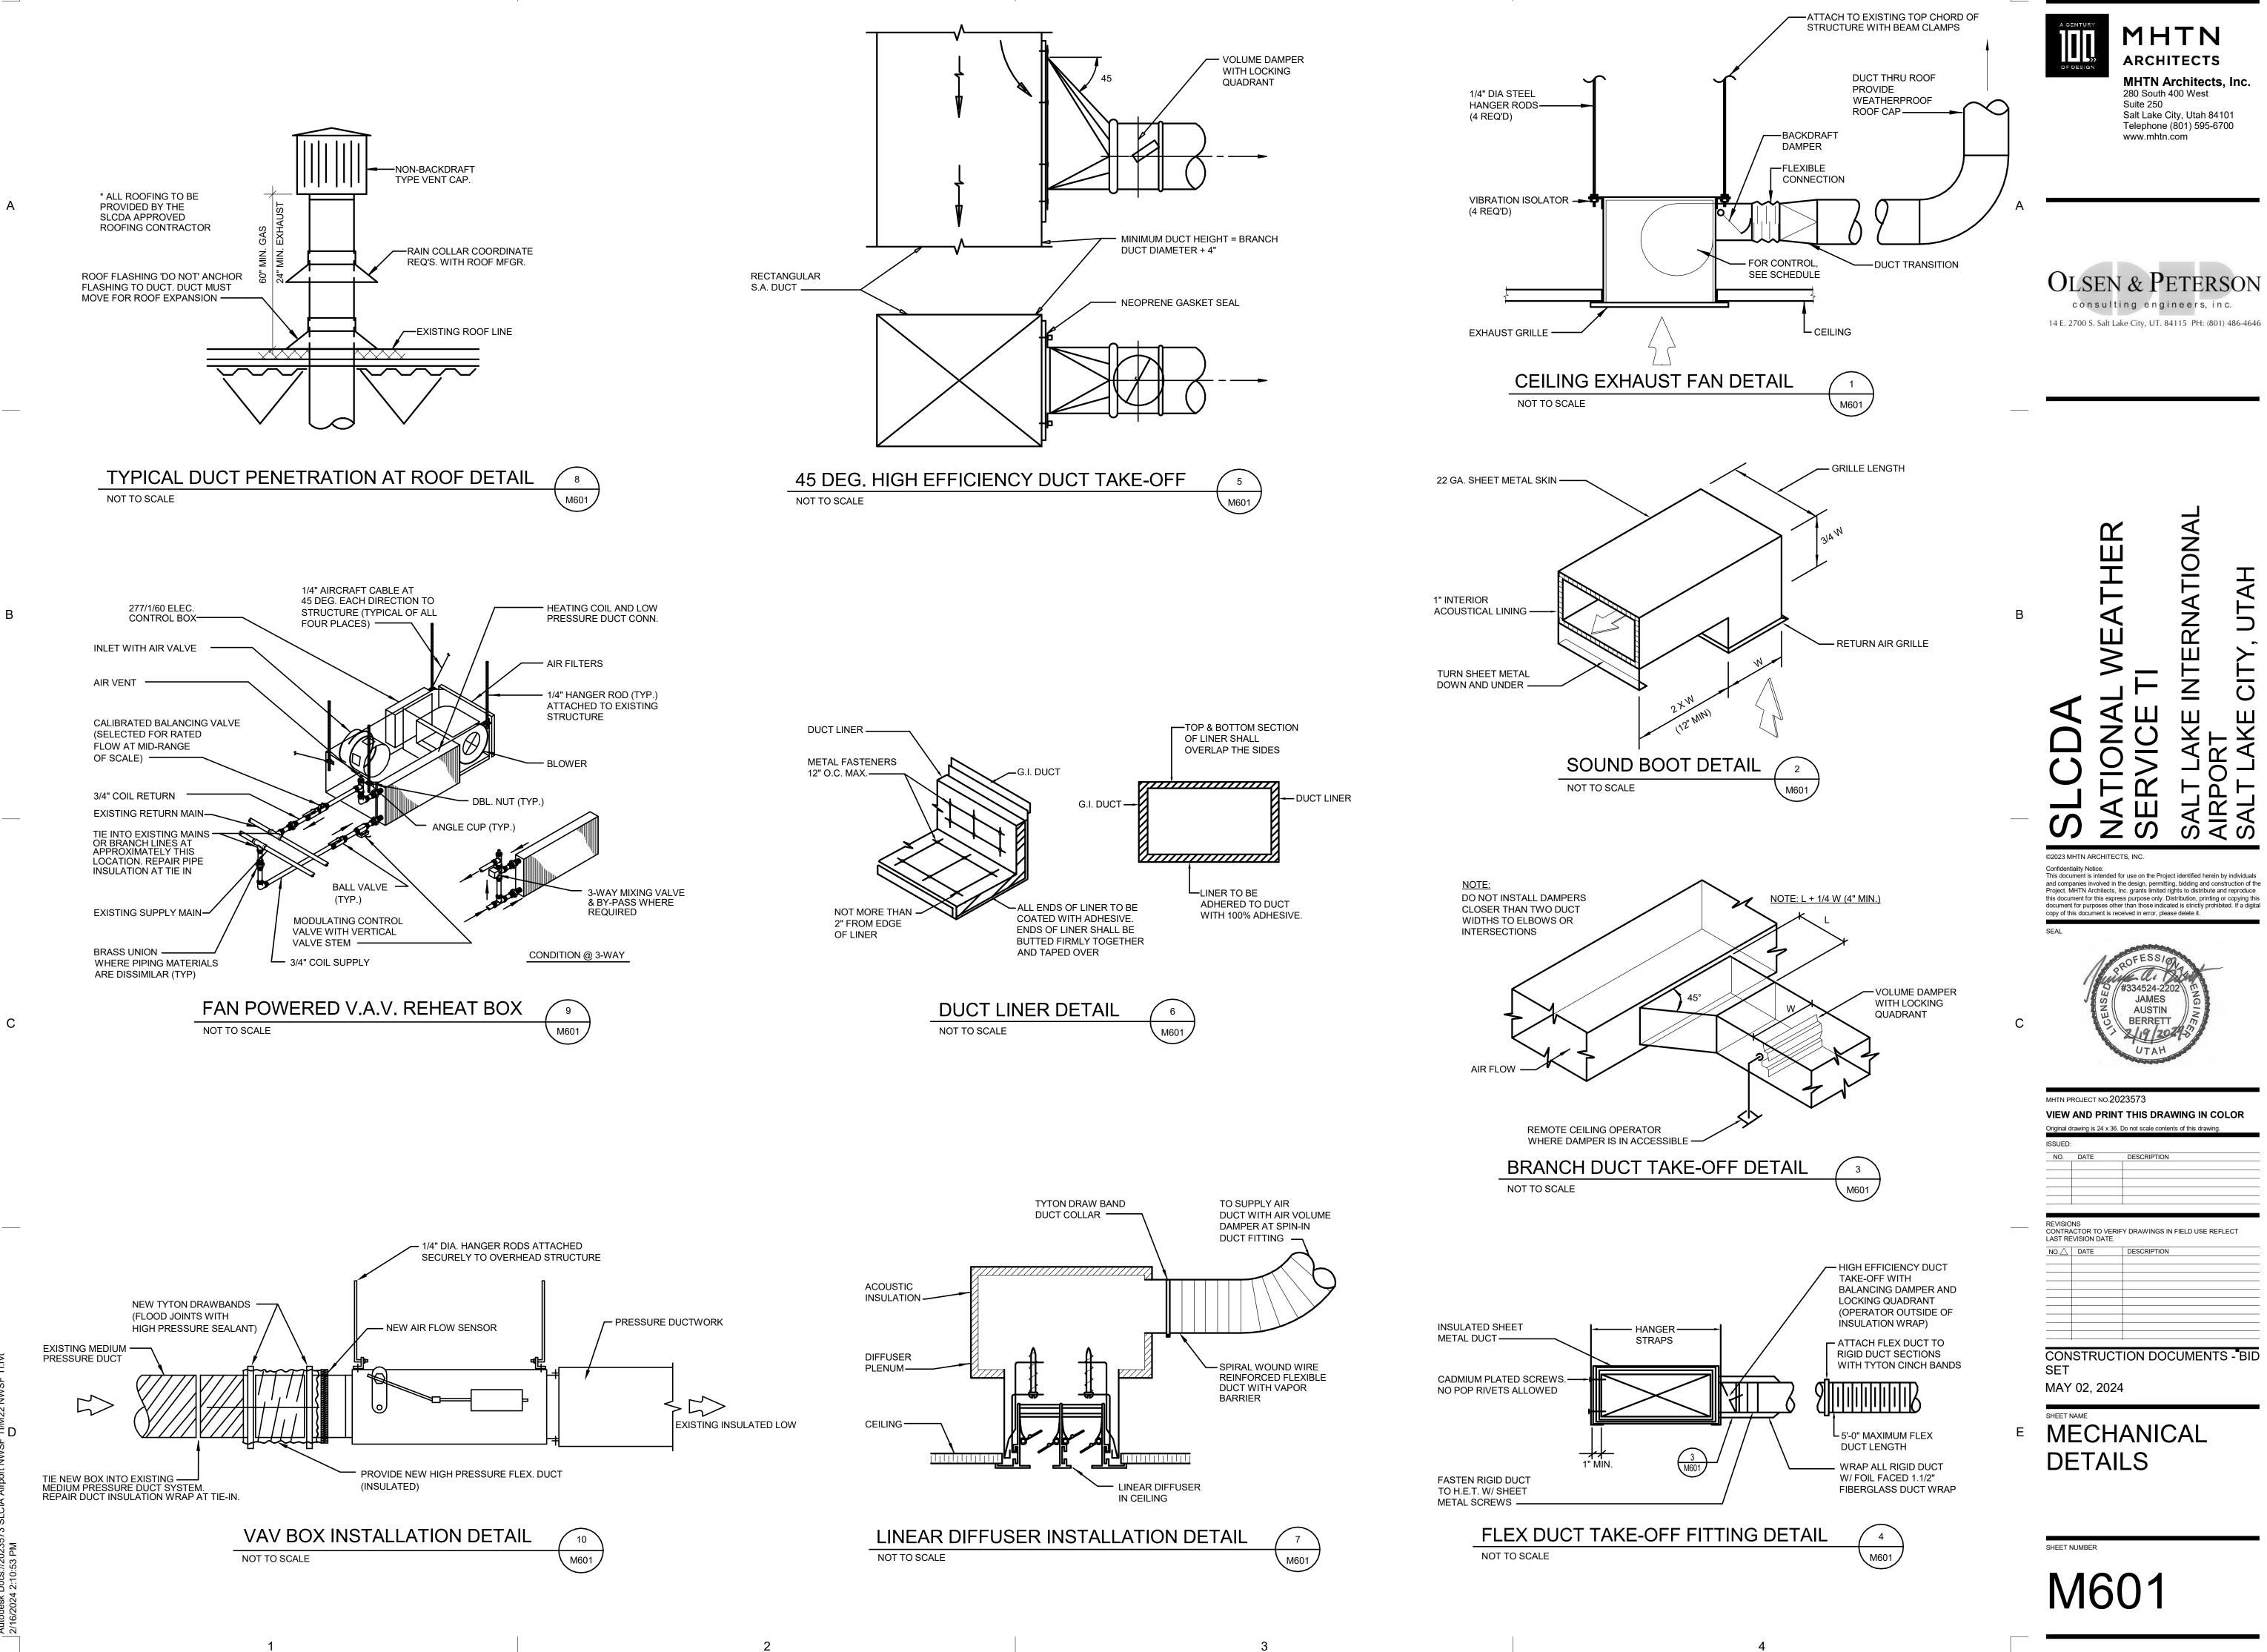

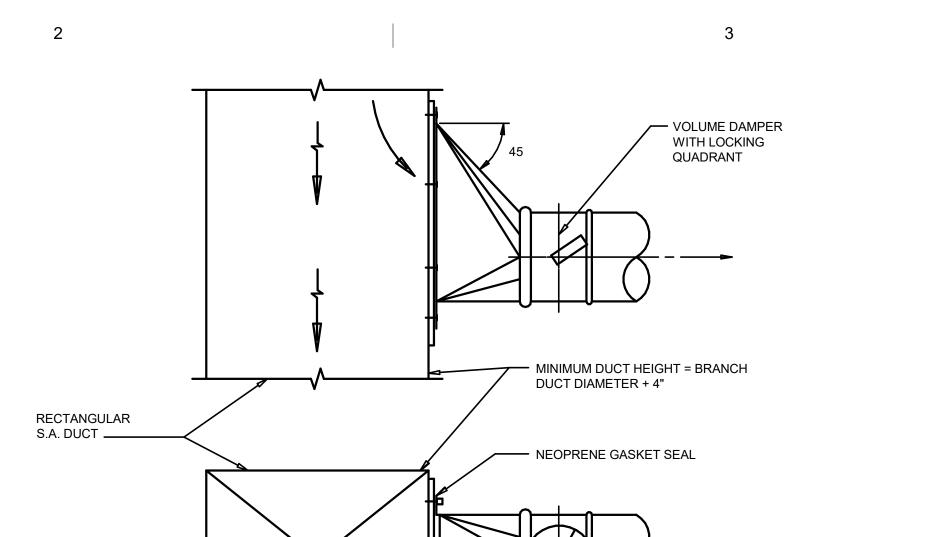

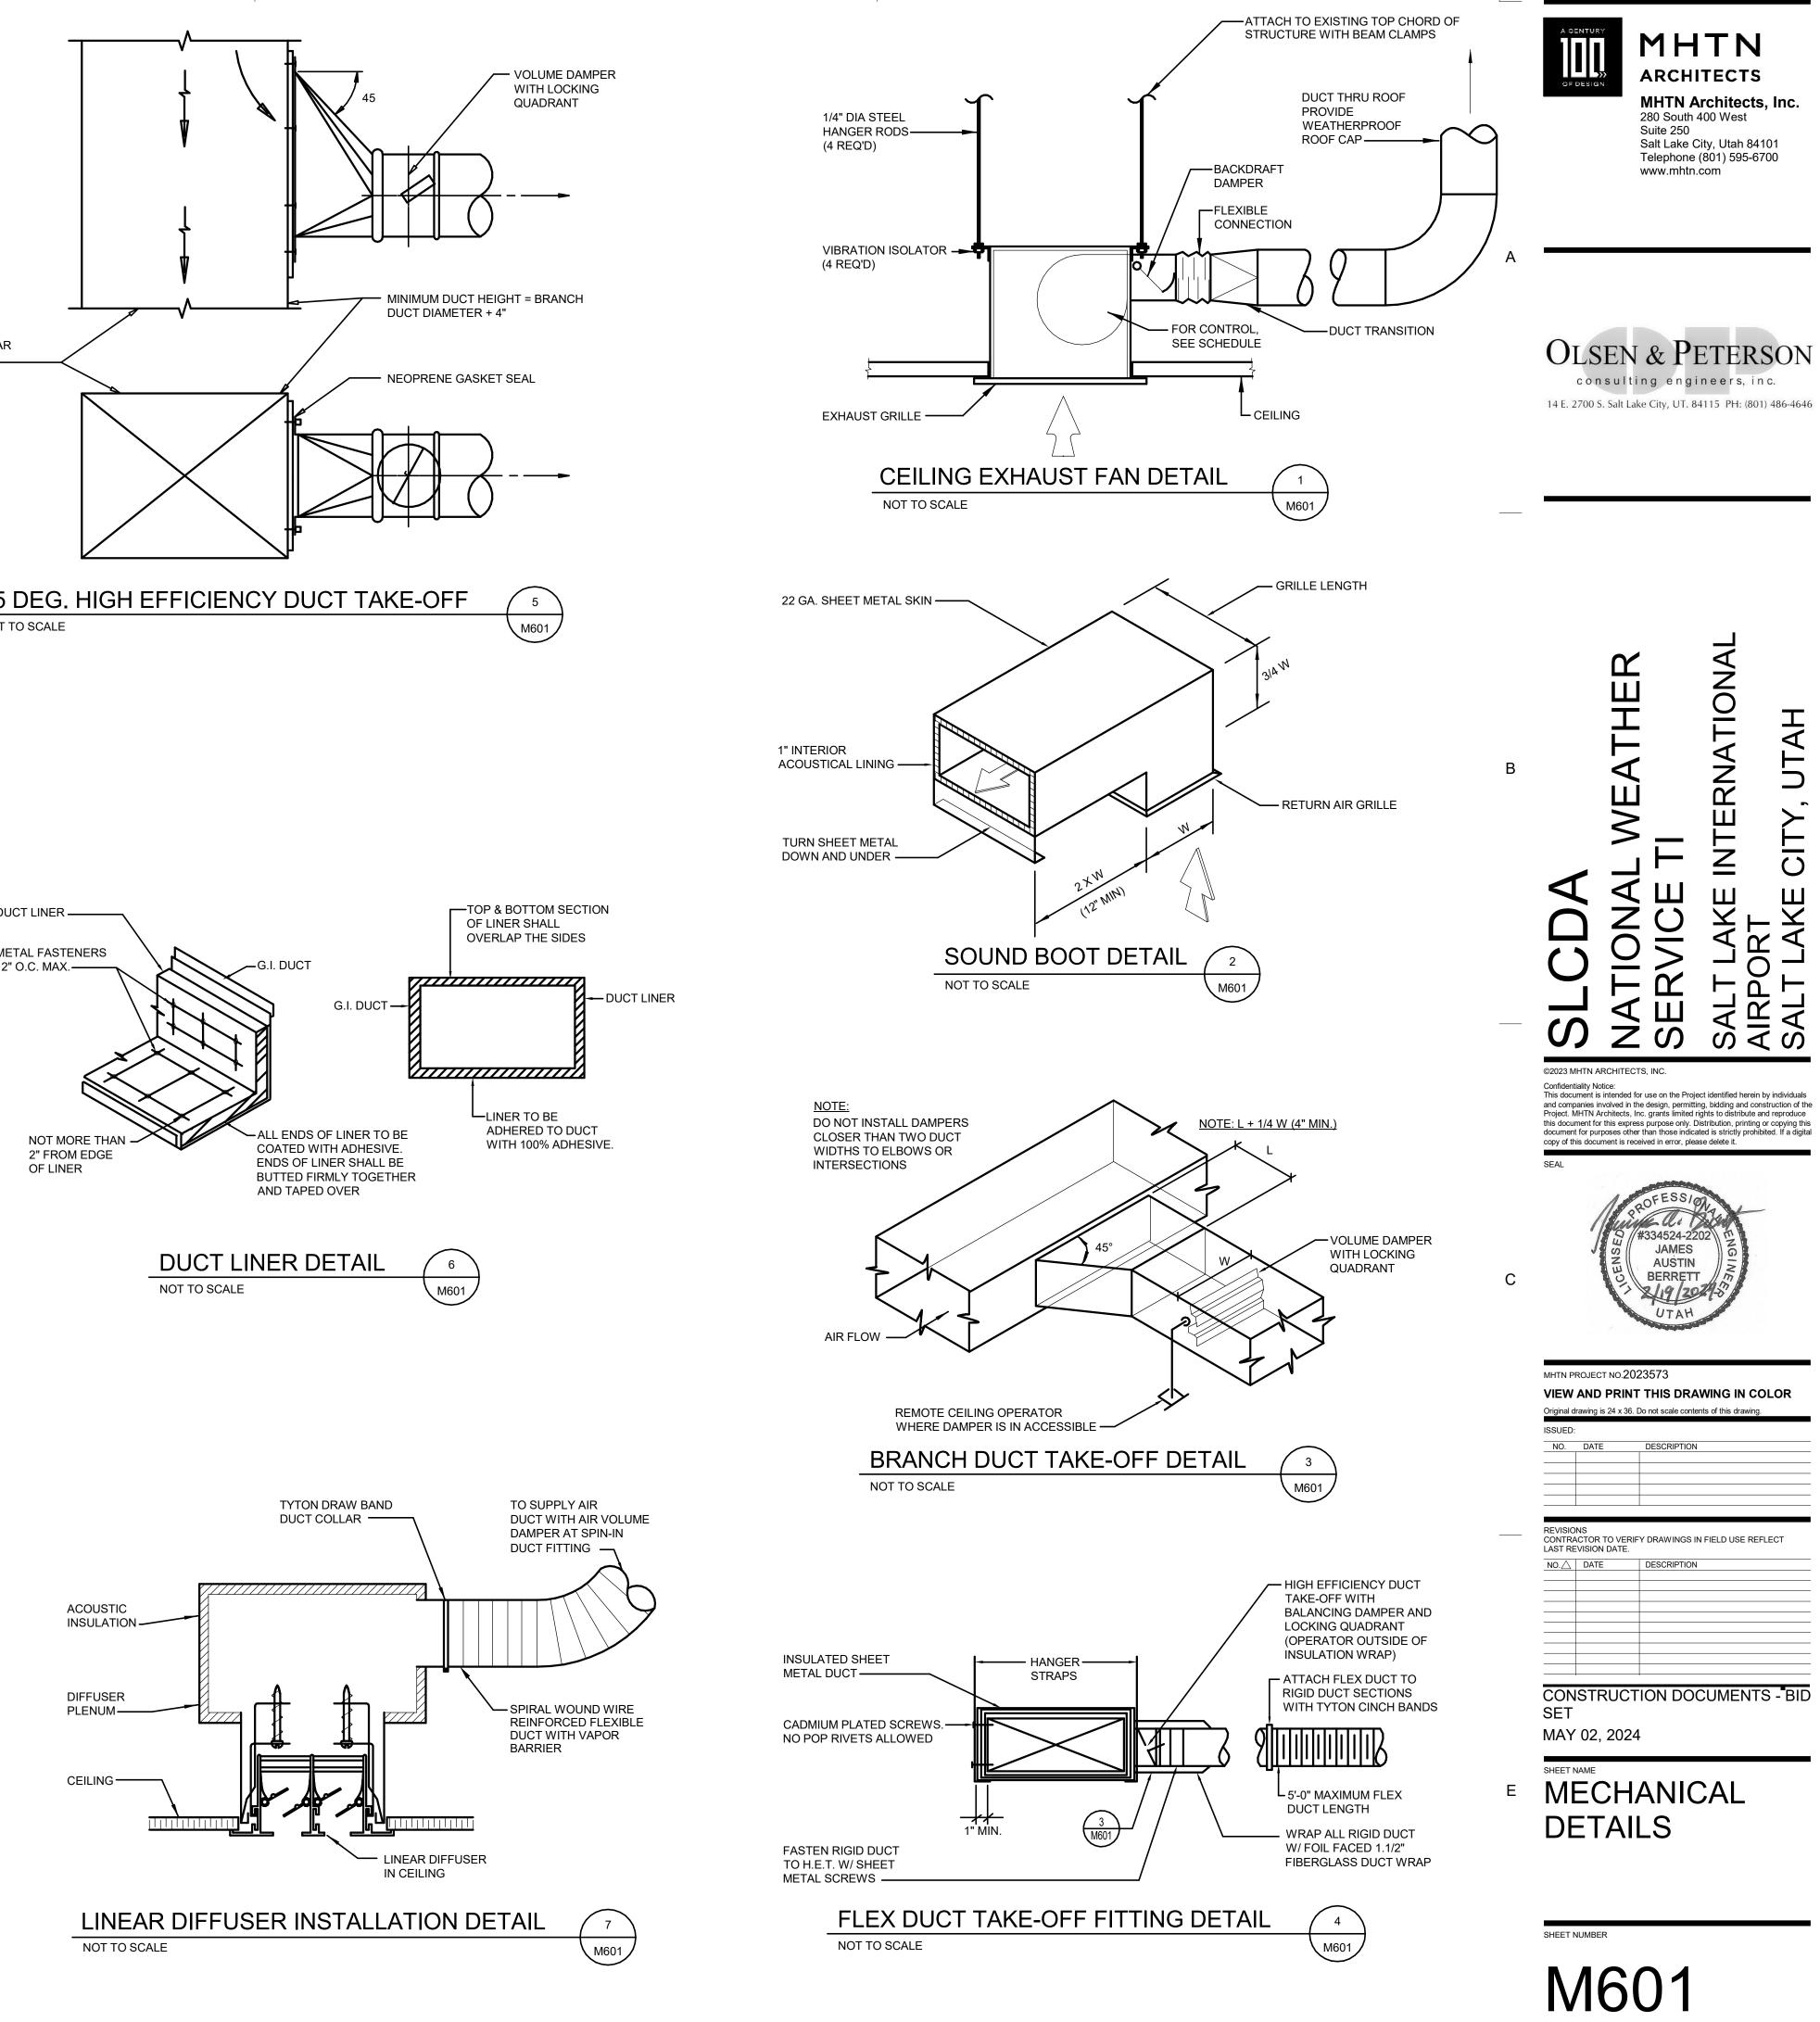

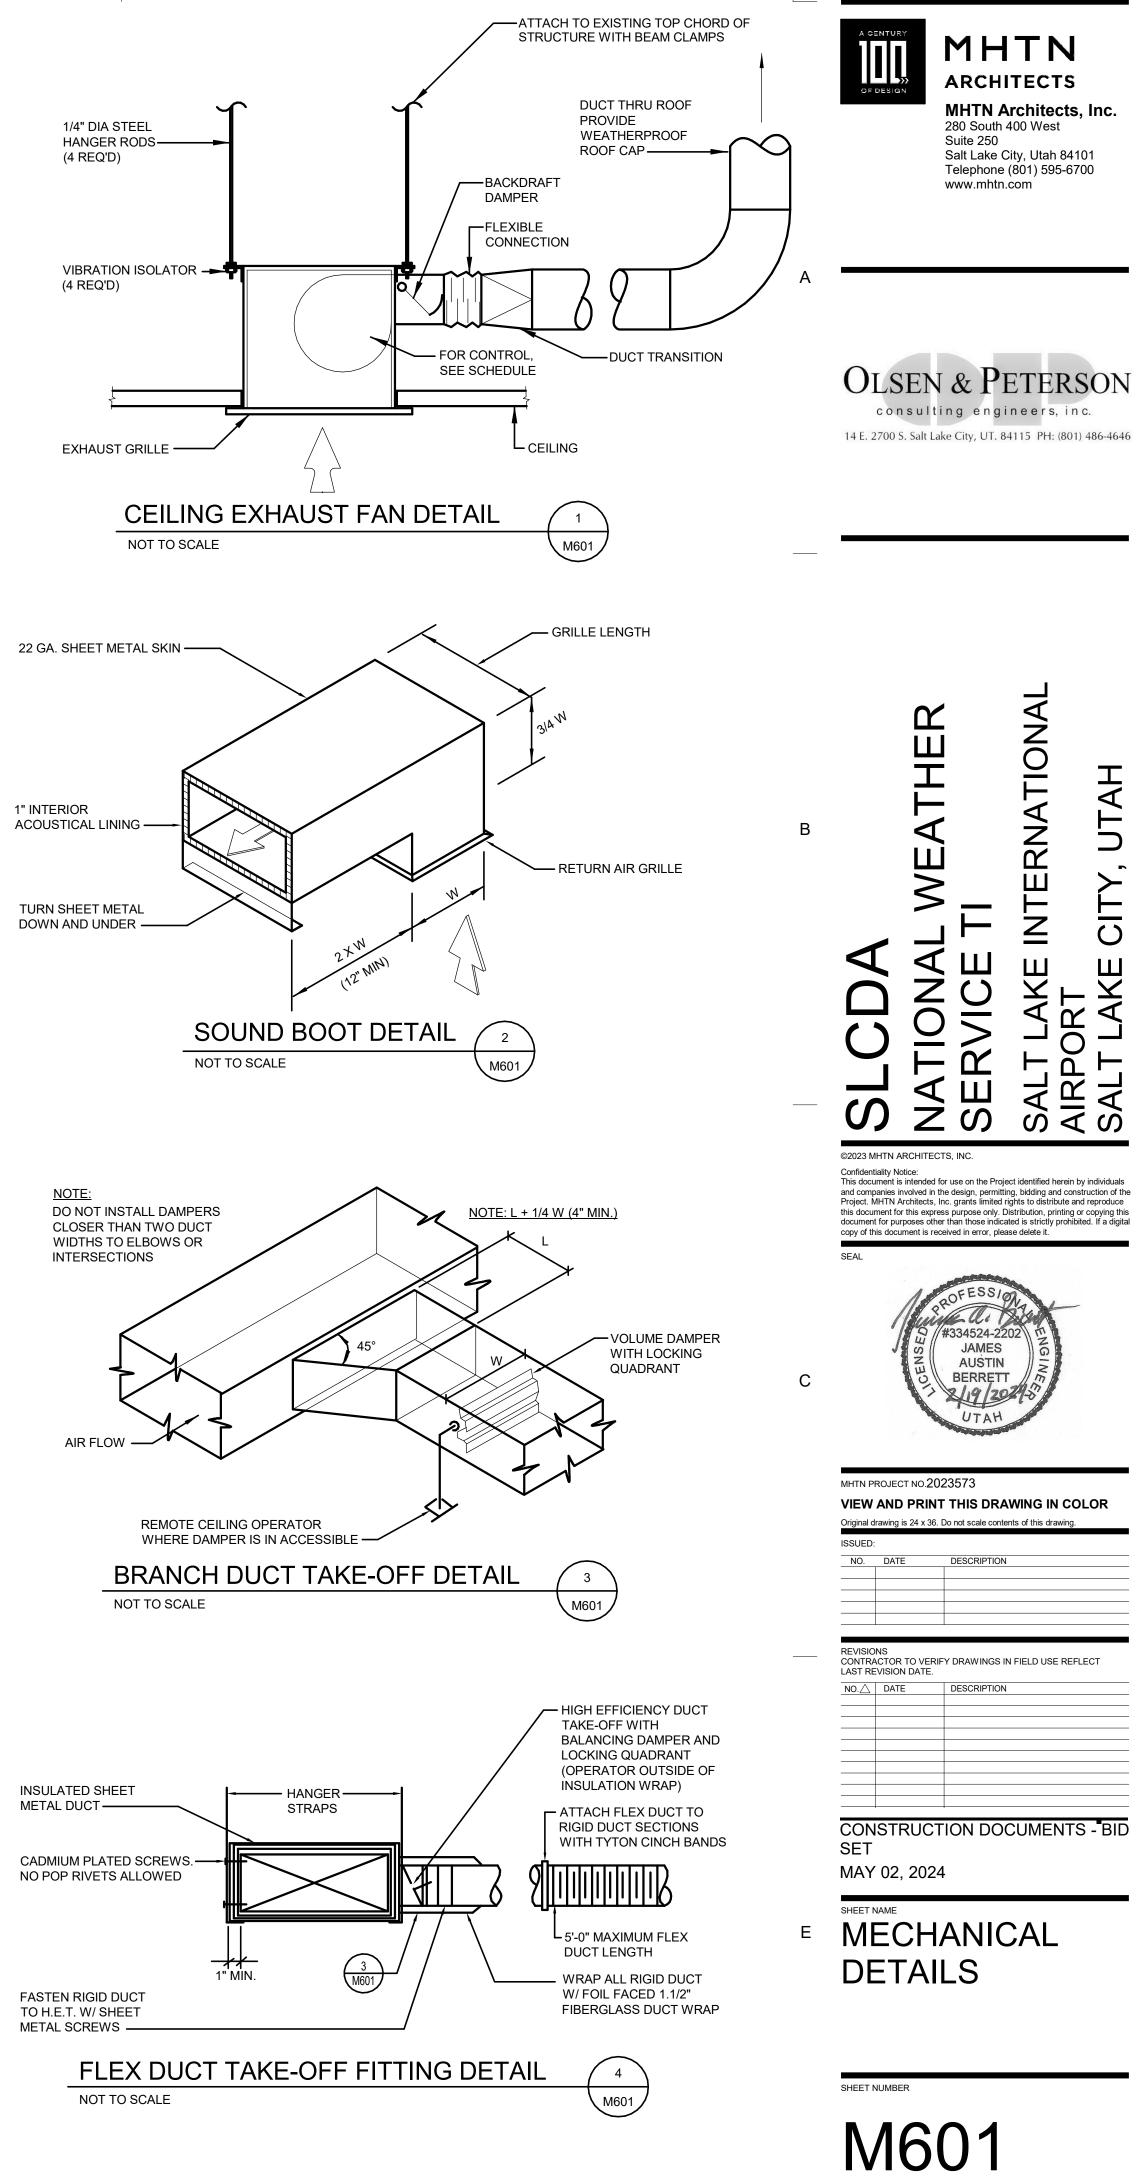

PLUMBING DEMOLITION FLOOR PLAN

0 4' - 0" 8' - 0" SCALE: 1/8" = 1'-0" 16' - 0"

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PD101

### E PLUMBING DEMOLITION FLOOR PLAN

MAY 02, 2024


SHEET NUMBER

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ISSUED: NO. DATE DESCRIPTION

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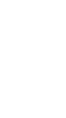
ARCHITECTS

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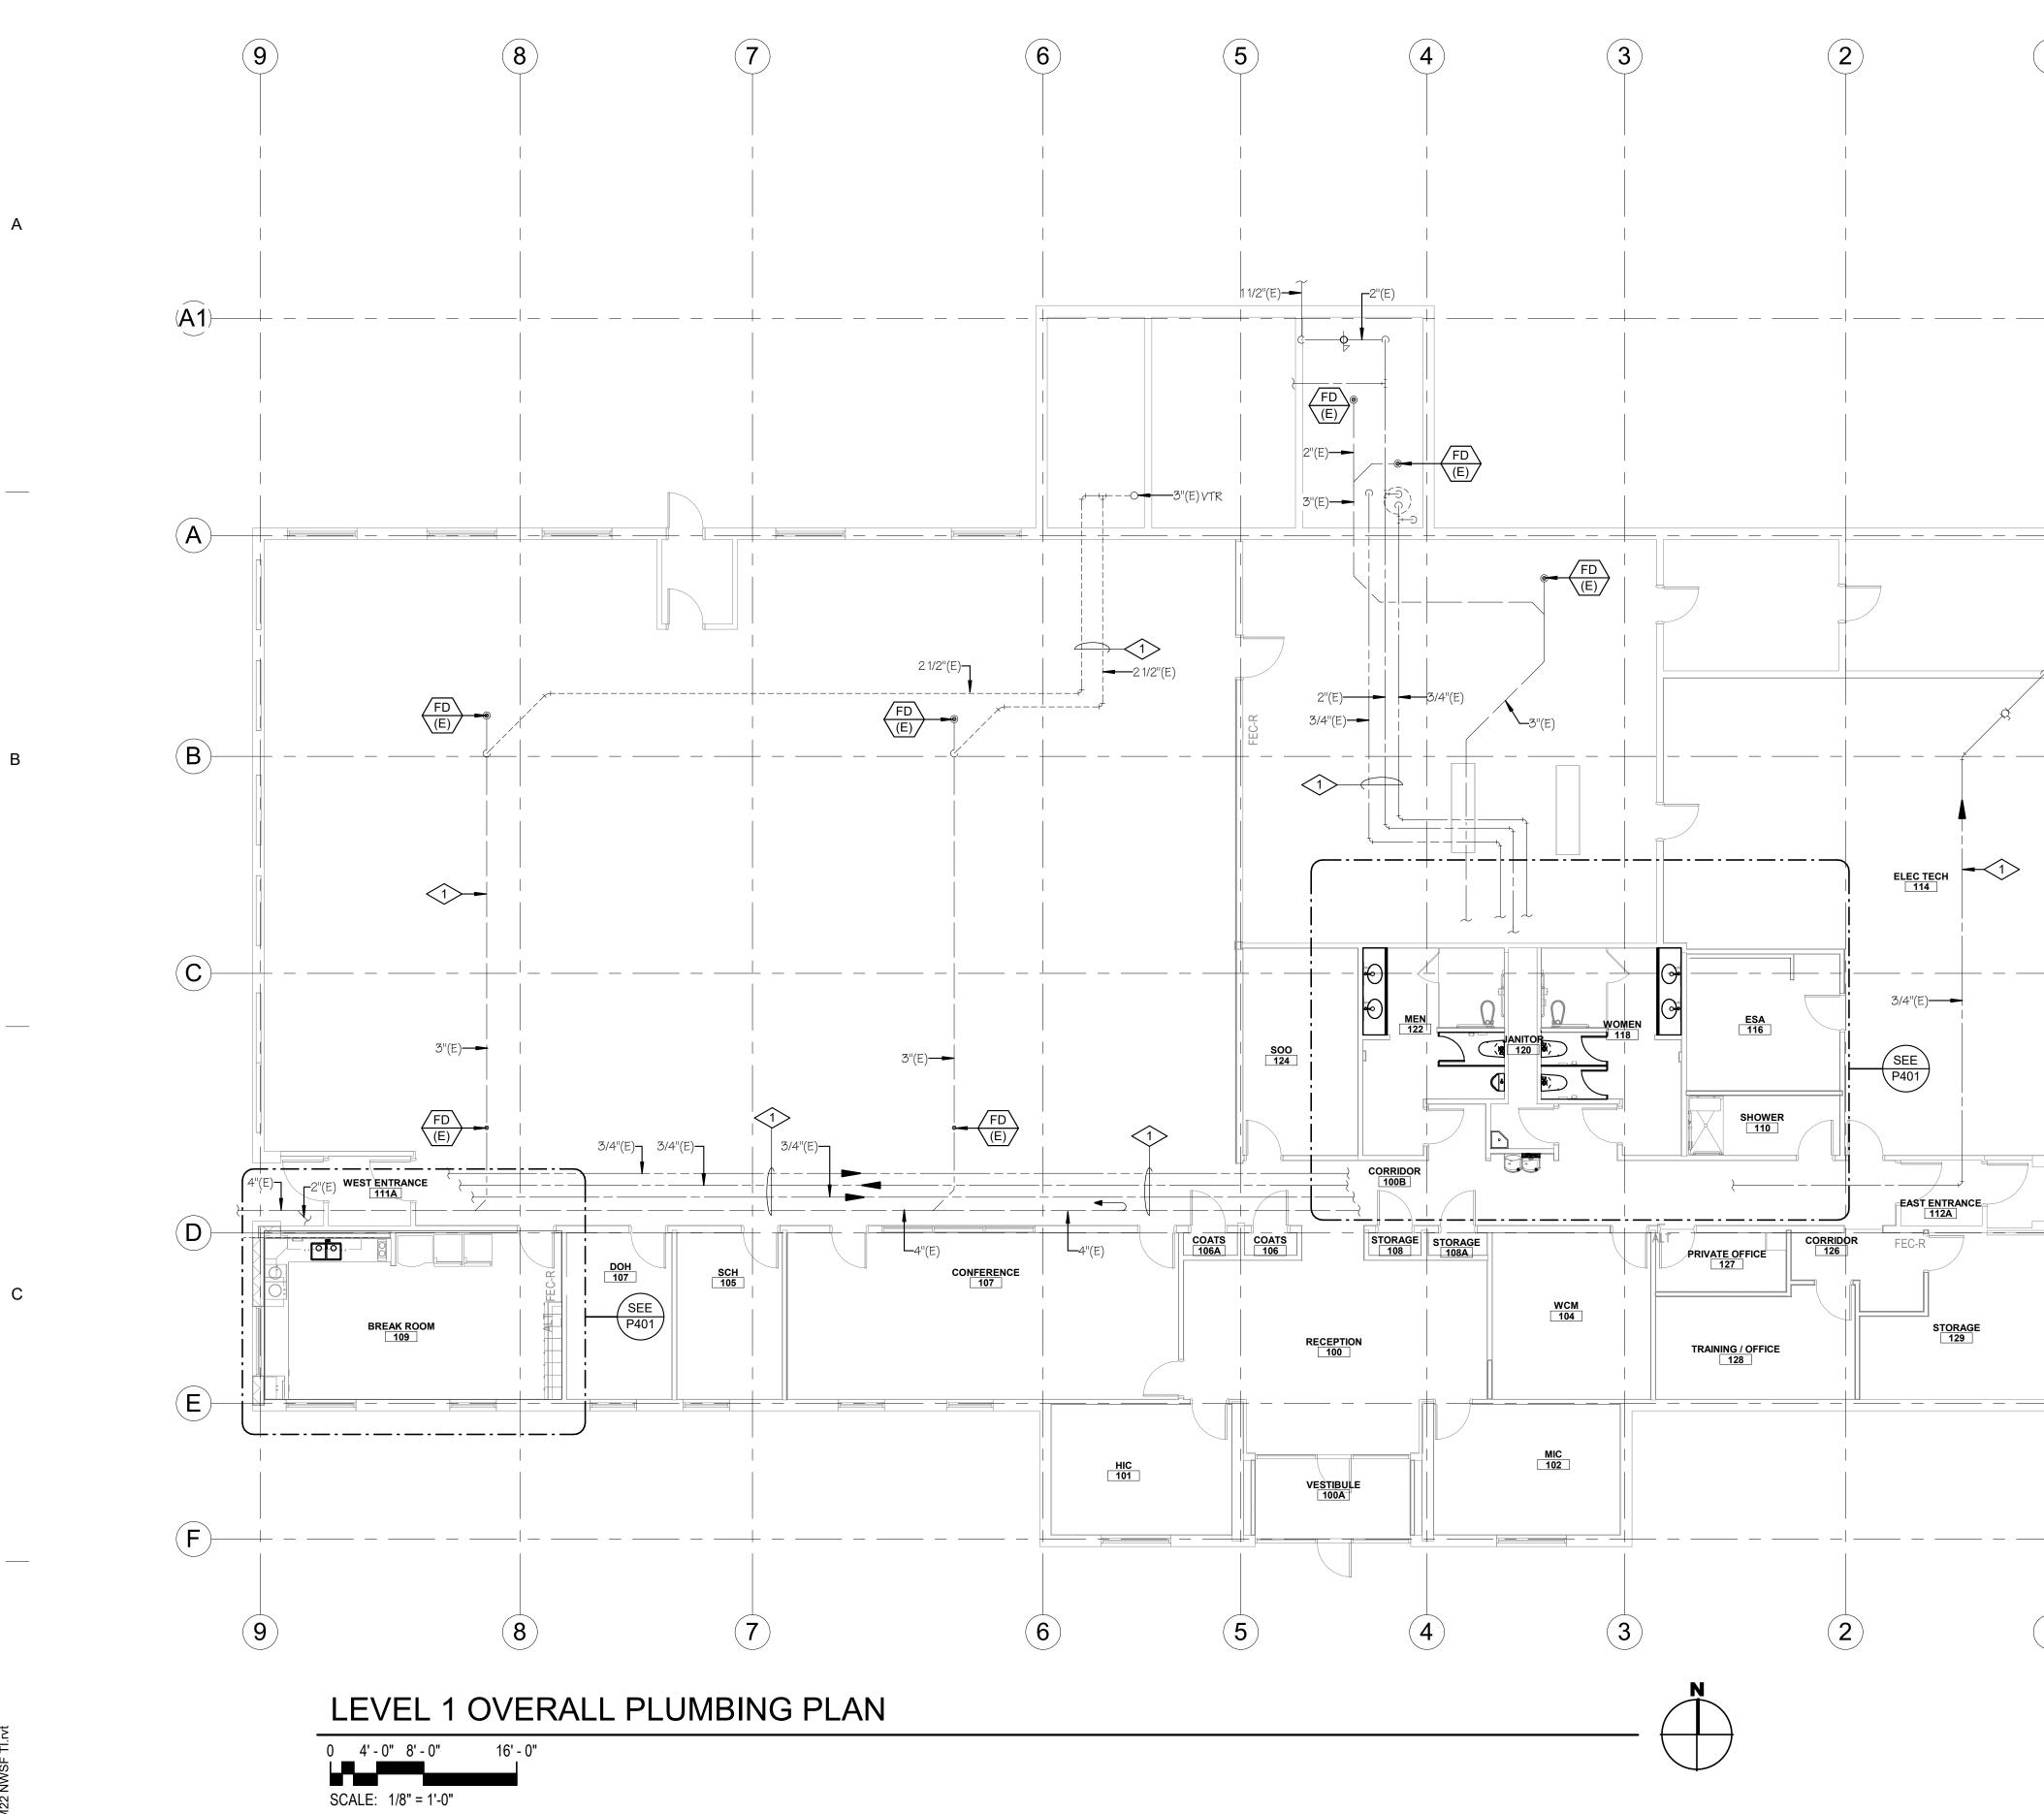


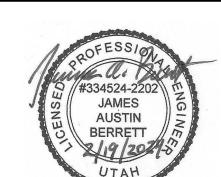

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# P101

SHEET NUMBER

# E PLUMBING FLOOR PLAN

MAY 02, 2024

CONSTRUCTION DOCUMENTS - BID SET

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**REFERENCE NOTES** 

<\#> 1 EXISTING PLUMBING TO REMAIN.

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(1)

 $(\mathbf{A})$ 

B

 $(\mathbf{C})$ 

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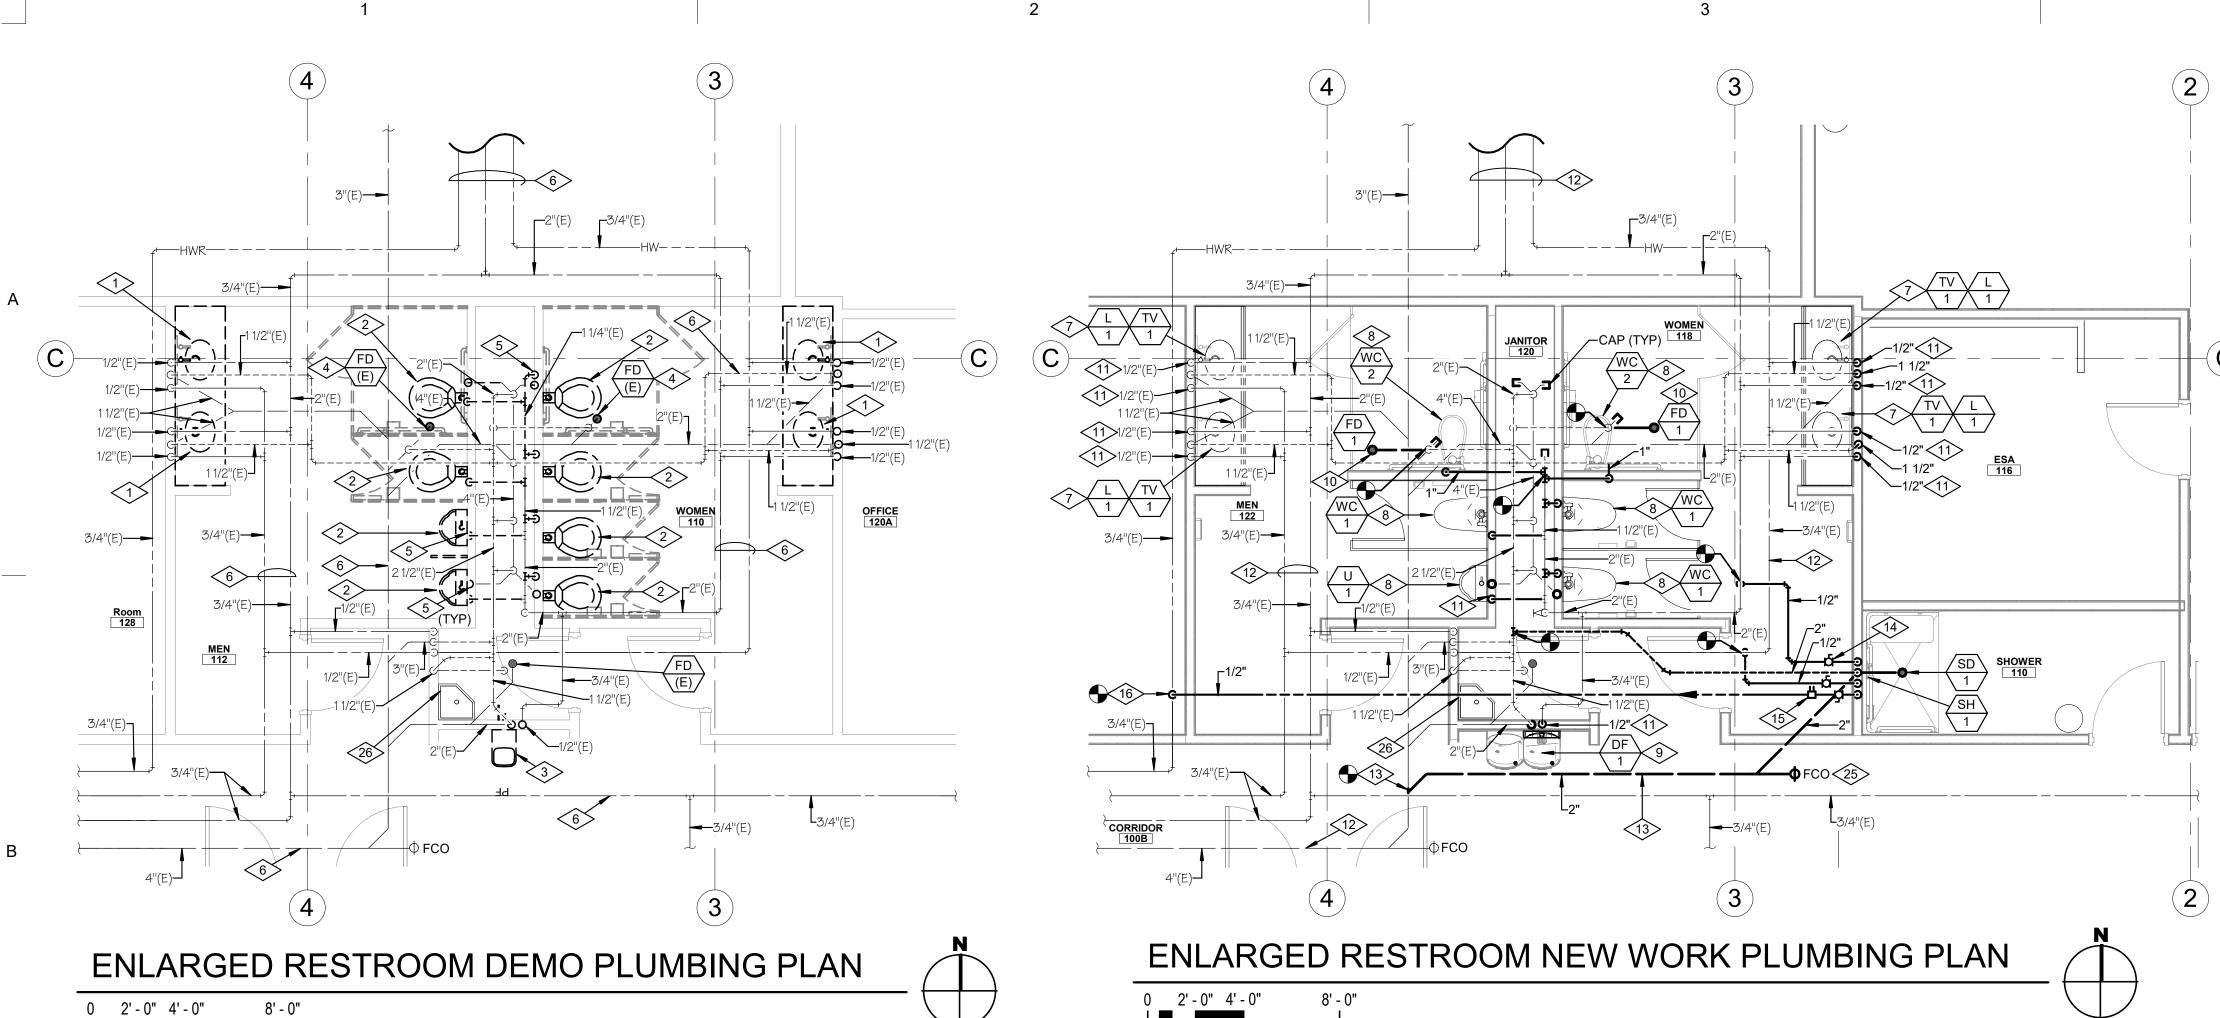
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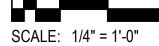
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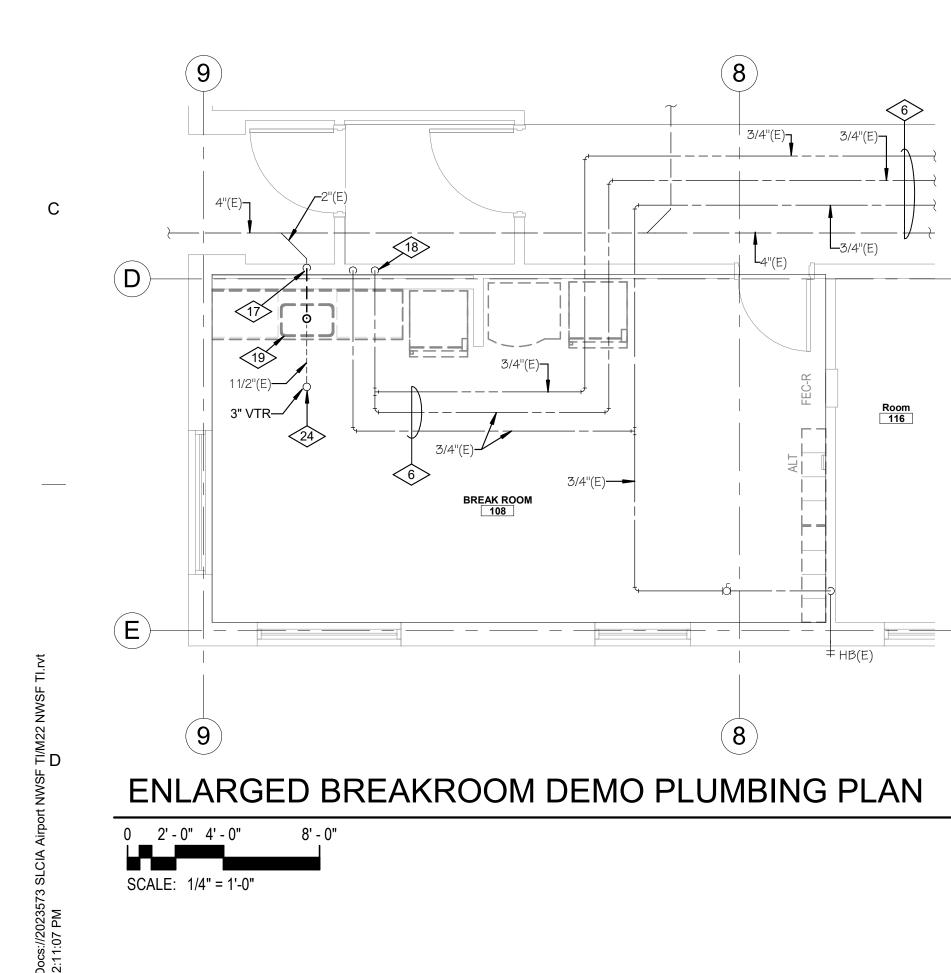
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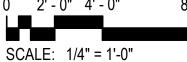
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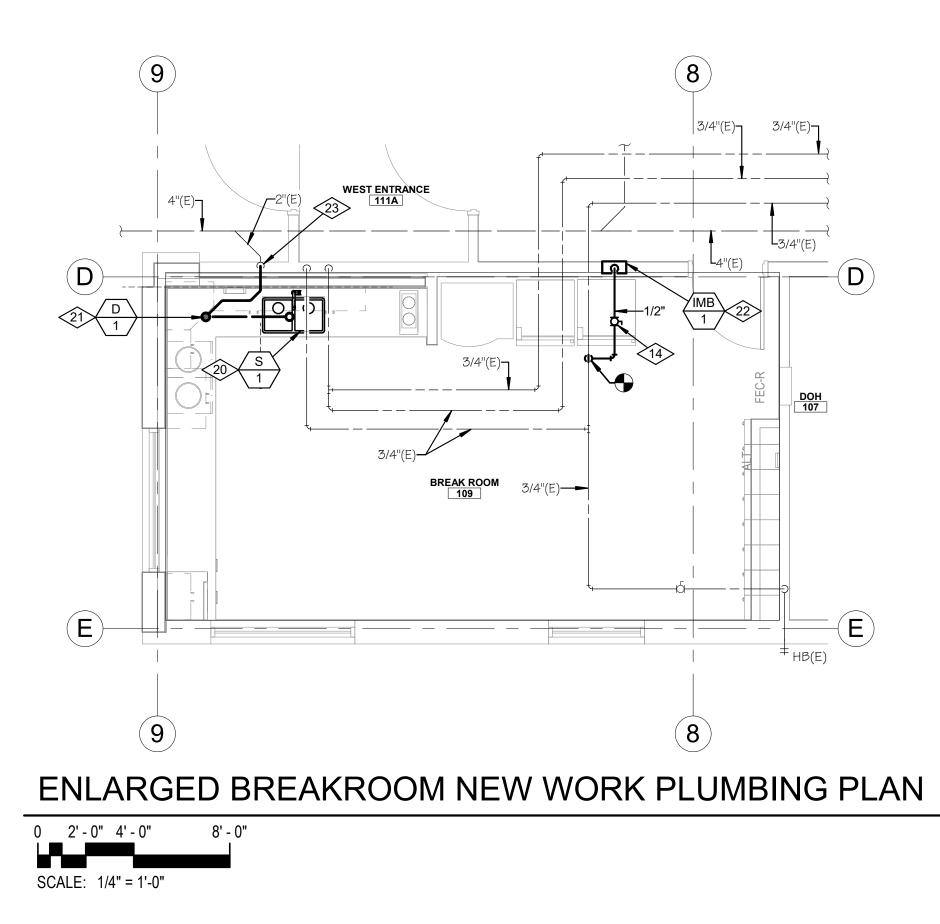
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 $(\mathsf{D})$ 

(E)

## **REFERENCE NOTES**

<#>

- REMOVE EXISTING SINK COMPLETE. REMOVE WATER LINES BACK TO WALL AND COORDINATE WITH NEW WORK FOR CONNECTION OF EXISTING TO NEW.
- REMOVE ALL EXISTING PLUMBING FIXTURES AS HIGHLIGHTED ON PLAN. REMOVE EXISTING WATER, WASTE AND VENT CONNECTIONS; CAP EXISTING LINES THAT ARE NOT RE-USED, AND COORDINATE WITH NEW WORK FOR EXTENT OF DEMOLITION FOR CONNECTION TO NEW.
- REMOVE EXISTING WATER FOUNTAIN; REMOVE EXISTING WATER AND WASTE CONNECTIONS; COORDINATE WITH NEW WORK FOR EXTENT OF DEMOLITION FOR CONNECTION TO NEW.
- REMOVE FLOOR DRAINS DOWN TO TRAP; CAP EXISTING 4 WASTE LINE BELOW FLOOR. COORDINATE WITH NEW WORK FOR EXTENT OF DEMOLITION FOR CONNECTION TO NEW.
- REMOVE EXISTING WATER LINES AND DROPS WHERE SHOWN; COORDINATE CONNECTION OF NEW TO EXISTING; TYPICAL ALL WATER CLOSETS AND URINALS.
- 6 EXISTING WATER LINES, VENT LINES AND WASTE LINES TO REMAIN.
- 7 NEW SINK, UNDER COUNTER MOUNT. CONNECT NEW WATER LINES BACK TO WALL AND RECONNECT TO EXISTING. PROVIDE NEW 1/4 STOPS.
- PROVIDE NEW WATER CLOSETS AND URINALS. CONNECT NEW WATER, WASTE AND VENT CONNECTIONS TO EXISTING; CONTRACTOR TO SAW CUT WHERE REQUIRED TO INSTALL NEW WASTE LINES BELOW SLAB FOR FLOOR MOUNT WATER CLOSETS. PROVIDE NEW 2" VENT RISER FROM EACH NEW FIXTURE AND TIE INTO EXISTING IN CHASE.
- PROVIDE NEW DUAL WATER FOUNTAIN WITH BOTTLE FILLER; TIE NEW WATER, WASTE AND VENT CONNECTIONS TO EXISTING.
- PROVIDE NEW FLOOR DRAINS WHERE SHOWN; 2" WASTE 10 LINE TO BE ROUTED BACK TO EXISTING. COORDINATE NEW WORK WITH ARCHITECTURAL PLANS FOR FLOOR SLOPING TO FLOOR DRAIN. CONTRACTOR TO PROVIDE SAW CUTS FOR INSTALLATION OF NEW FLOOR DRAINS TO EXISTING WASTE LINE.
- 11 PROVIDE NEW WATER LINES AND DROPS WHERE SHOWN; 1" CW DROPS TO EACH WATER CLOSET AND URINAL
- 12 EXISTING WATER LINES, VENT LINES AND WASTE LINES TO REMAIN.
- 13 TIE IN NEW 2" WASTE LINE FROM NEW SHOWER DRAIN TO EXISTING WASTE LINE IN THIS APPROXIMATE LOCATION. CONTRACTOR TO FIELD VERIFY EXACT LOCATION FOR TIE IN, AND PROVIDE SAW CUT WITH BACK FILL AND NEW CONCRETE TO MATCH EXISTING.
- 14 LINE SIZE BALL VALVES; PROVIDE ACCESS PANEL IN ACCESSIBLE LOCATION NEW VALVES FOR ADJUSTMENT.
- 15 PROVIDE CIRCUIT SETTER; SET VALVE AT 0.25 GPM.
- 16 TIE IN NEW 1/2" HWR LINE AT THIS APPROXIMATE LOCATION.
- 17 REMOVE WASTE LINE UNDER COUNTER BACK TO SINK SIDE OF WALL; COORDINATE WITH NEW WORK FOR **RE-CONNECTION.**
- 18 REMOVE WATER LINES TO SINK UNDER CABINET BACK TO CABINET PENETRATION AT INSIDE OF CABINET; COORDINATE WITH NEW WORK FOR RE-CONNECTION.
- 19 REMOVE EXISTING SINK AND DISPOSER COMPLETE. COORDINATE WITH ARCHITECTURAL DEMOLITION PLANS.
- 20 RE-CONNECT NEW SINK TO EXISTING CW AND HW LINES BELOW SINK CABINET; COORDINATE WITH ARCHITECTURAL PLANS FOR CABINET STYLE. PROVIDE NEW 1/4 STOPS.
- 21 DISPOSAL BELOW CABINET IN CORNER; PIPE NEW WASTE LINES TO/FROM THE NEW SINK TO DISPOSAL AND SLOPE BACK TO EXISTING WASTE LINE CONNECTION BELOW CABINET. COORDINATE CLEARANCES AND REQUIREMENTS FOR PIPING PRIOR TO COMMENCEMENT OF WORK. DISPOSER TO BE LOCATED TO THE WEST WALL TO ALLOW INSTALLATION OF ADA SKIRT AT SINK. ACCESS WILL BE PROVIDED IN THE MILLWORK.
- ICE MAKER BOX IN WALL TO SERVE (2) REFRIGERATORS. 22 PROVIDE 1/4" COPPER PIPING TO BOTH REFRIGERATORS. MOUNT AT 48" A.F.F. PLUMBING CONTRACTOR TO PROVIDE 3/8" BRAIDED WATER CONNECTION LINES FROM IMB-1 TO EXISTING REFRIGERATORS. FIELD COORDINATE REQUIREMENTS.
- 23 PROVIDE NEW 2" WASTE LINE CONNECTION AND 1-1/2" VENT TO EXISTING; COORDINATE WITH DEMOLITION PRIOR TO COMMENCEMENT OF WORK.
- 24 EXISTING 1-1/2" VENT TO 3" VTR TO REMAIN.
- 25 PROVIDE NEW 2" FLOOR CLEANOUT. COORDINATE WITH EXISTING CONDITIONS. FLOOR CLEANOUT MUST BE VISIBLE ABOVE FLOOR FINISH.
- 26 EXISTING SERVICE SINK AND RELATING PIPING TO REMAIN.

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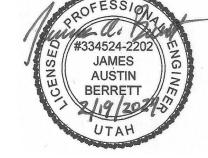
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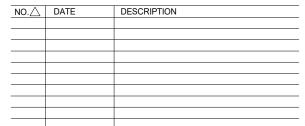
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NO.	DATE	DESCRIPTION	

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CONSTRUCTION DOCUMENTS - BID SET

MAY 02, 2024

## SHEET NAME ENLARGED PLUBMING PLAN

SHEET NUMBER

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INSULATION SHIELD. SIZE SHIELD — TO PREVENT COMPRESSION OF INSULATION. VAPOR SEAL ALL SEAMS, JOINTS, AND TERMINALS

NOT TO SCALE

WHEN USED ON LOW TEMPERATURE PIPE




	PLUMBING FIXTURE SCHEDULE												
SYMBOL	FIXTURE	WASTE	VENT	C.W.	H.W.	TEMP. W.	NOTES (1)(2)						
$\left< \frac{WC}{1} \right>$	WATER CLOSET	4"	2"	1"			(2) WALL MOUNTED - SENSOR FLUSH VALVE						
$\frac{WC}{2}$	WATER CLOSET	4"	2"	1"			FLOOR MOUNTED - SENSOR FLUSH VALVE <sup>(2)</sup> (ADA)						
$\left\langle \begin{array}{c} U\\ 1 \end{array} \right\rangle$	URINAL	3"	2"	1"			(2) WALL MOUNTED - SENSOR FLUSH						
$\begin{pmatrix} L \\ 1 \end{pmatrix}$	LAVATORY	1-1/2"	1-1/2"	1/2"	1/2"	1/2"	UNDERCOUNTER MOUNTED W/ SENSOR (2) FAUCET - (ADA) W/ ASSE TV-1						
$\left\langle \frac{S}{1} \right\rangle$	SINK	1-1/2"	1-1/2"	1/2"	1/2"		DBL COMP. SS WITH STANDARD FAUCET						
$\left\langle \begin{array}{c} D\\ 1 \end{array} \right\rangle$	DISPOSER	1-1/2"	1-1/2"	1/2"			SINK S-1 L.H. SIDE 3/4 H.P. 120/1/60						
DF 1	DRINKING FOUNTAIN	1-1/2"	1-1/2"	1/2"			WALL MOUNTED - BI-LEVEL WITH BOTTLE FILLER ON LOW SIDE 120/1/60						
SH 1	SHOWER			1/2"	1/2"		(ADA)						
SD 1	SHOWER DRAIN	2"	1-1/2"		-		W/DEEP SEAL TRAP AND ASSE TRAP GUARD						
$\left( \frac{\text{IMB}}{1} \right)$	ICE MAKER BOX	-	-	1/2"	-		SERVES (2) REFRIGERATORS						
$\overline{1}$	TEMPERING VALVE			1/2"	1/2"	1/2"	SINGLE LAV. ASSE 1070 MOUNT UNDER LAVATORY						
$\left\langle \begin{array}{c} FD \\ 1 \end{array} \right\rangle$	FLOOR DRAIN	2"	1-1/2"				W/DEEP SEAL TRAP AND ASSE TRAP GUARD						

4

NOTES:

(1) CONTRACTOR SHALL VERIFY EXACT LOCATION OF ALL PLUMBING FIXTURES AND DRAINS WITH ARCHITECTURAL DRAWINGS PRIOR TO ROUGH-IN OR INSTALLATION.

(2) 120 VOLT SENSOR

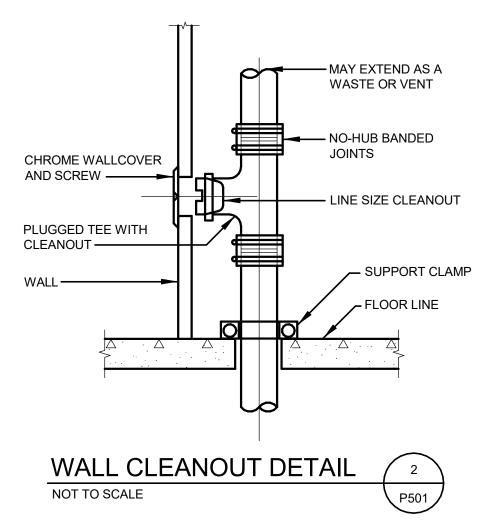

RIGID CALCIUM SILICATE BLOCK INSULATION. EXTEND 6" BEYOND SHIELD

PIPE SUPPORT DETAIL

HANGER ROD

NOTE:

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P501


DETAIL APPLIES TO ALL DOMESTIC COLD WATER,

- PIPE INSULATION (SEE SPECIFICATIONS)

CHILLED WATER, AND ROOF DRAIN PIPING.

BRANCH WATER LINE SCHEDULE										
FIXTURE	FIXTURE UNITS	TOTAL C 1/2"	UANTITY OF 3/4"	FIXTURES S 1"	ERVED BY A 1 1/4"	GIVEN PIPE 1-1/2"	SIZE 2"			
WATER CLOSET	10			1	2	3	8			
URINAL	5		1	2	3	6	20			
LAVATORY	2	1	3	5	7	15	50			
SINK	2	1	3	5	7	15	50			
KITCHEN SINK	2	1	3	5	7	15	50			
DRINKING FOUNTAIN	1	2	6	10	15	30				
TOTAL FIXTURE UNITS SERVED BY PIPE SIZE	÷	2	6	10	15	30	100			

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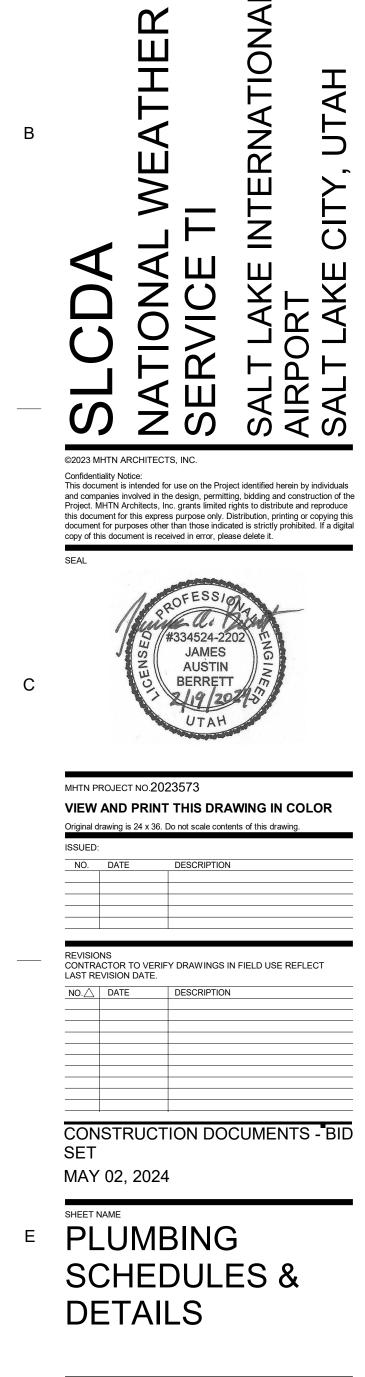
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SHEET NUMBER

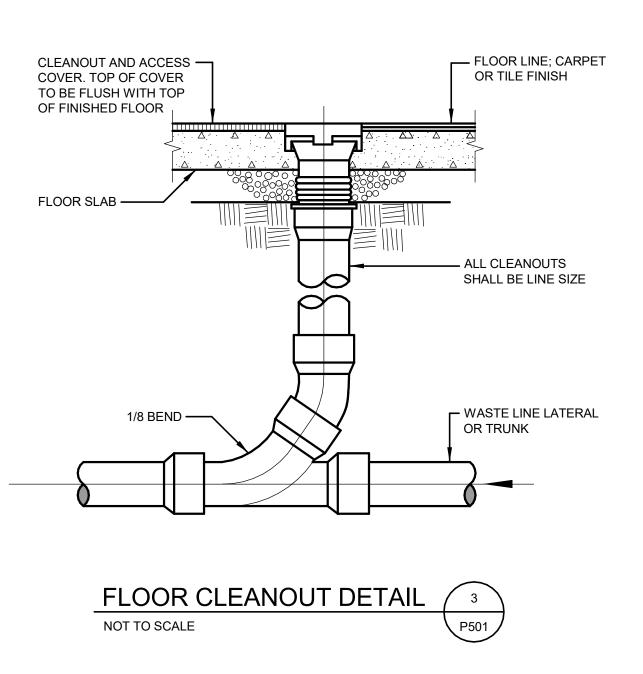P501



	EQUIPMEN
SYMBOL	DESCRIPTION
\$ <sub>T</sub>	MANUAL STARTER WITH THERMAL OVERLOAD(S
<u>ф</u> Г	ELECTRIC MOTOR
  	FUSED DISCONNECT SWITCH
Ē	CIRCUIT BREAKER AND ENCLOSURE
	MAGNETIC STARTER
	COMBINATION MAGNETIC STARTER / FUSED DIS
	COMBINATION MAGNETIC STARTER / NON-FUSE
⊠ <sup>⊥</sup>	COMBINATION MAGNETIC STARTER / MOTOR CIP PROTECTOR (MCP)
	LIGHTING AND APPLIANCE PANELBOARD (SURF)
	POWER DISTRIBUTION PANELBOARD
	SWITCHBOARD
<b>T-#</b>	DRY TYPE TRANSFORMER
	FL
SYMBOL	DESCRIPTION
■ <sup>B#</sup>	FLOOR BOX - REFER TO SUBSCRIPT AND FLOOR FOR MORE INFORMATION
Ρ	PROVIDE 4" SQUARE DEEP OUTLET BOX AND EL FURNITURE WIRING REQUIREMENTS AND OUTLE ROUGH-IN. WHIP FROM OUTLET BOX TO SYSTEM
С	PROVIDE BOX WITH GROMMETTED COVER PLAT PLACEMENT OF OUTLET BOXES IN WALLS AND C EXTEND CONDUIT WITH NYLON PULL ROPE TO A TERMINATE CONDUIT IN CEILING SPACE WITH A NYLON BUSHING.
⊙ <sup>P#</sup>	POKE THROUGH - REFER TO SUBSCRIPT AND FL
$\bigcirc$	MULTI-SERVICE POKE-THRU WITH FURNITURE F (POWER, COMMUNICATIONS AND A/V)
P	"TOMBSTONE" (LEGRANDE 525) OUTLET BOX WI (POWER ONLY)
Ĉ	"TOMBSTONE" (LEGRANDE 525) OUTLET BOX WI (COMMUNICATIONS ONLY)
	LIC
SYMBOL	DESCRIPTION
\$	SINGLE-POLE TOGGLE SWITCH
\$ <sup>a</sup>	SINGLE-POLE TOGGLE SWITCH
\$2	DOUBLE-POLE TOGGLE SWITCH
\$3	THREE-WAY TOGGLE SWITCH
$L^{\#}_{LV}$	LOW VOLTAGE SWITCH
€ a #	OCCUPANCY SENSOR
∕ <b>⊅</b> ª #	DIGITAL DAYLIGHT SENSOR
	L
	IXTURE SYMBOLS ARE GENERAL IN NATURE AND
	TO THE LIGHT FIXTURE SCHEDULE FOR SPECIFIC
2. ARROV	/S INDICATE AIMING DIRECTION.
SYMBOL	DESCRIPTION
•	LIGHT FIXTURES
•	
•	
	RECESSED DOWN LIGHT
	EGRESS LIGHT FIXTURE
XXXX	LIGHT FIXTURE CALLOUT (LETTER DENOTES FIX
	TELEP
SYMBOL	DESCRIPTION
	DATA OUTLET
	WIRELESS ACCESS POINT
•	L

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NT AND CONTI	ROL SYMBOLS		ELECTRICAL SYMBOL SCHEDULE GENERAL NOTES					
	MOUNTING	REMARKS	1 MOUNT					
5)	AT EQUIPMENT		<ol> <li>MOUNT ALL OUTLETS, DEVICES, AND EQUIPMENT AT HEIGHTS INDICATED BELOW, UNLESS NOTED OTHERWISE ON THE DRAWINGS. UNLESS NOTED OTHERWISE, HEIGHTS ARE GIVEN FROM FINISHED FLOOR TO CENTER OF OUTLET BOX.</li> </ol>					
			2. WHERE OUTLETS, DEVICES, AND EQUIPMENT ARE NOTED BY SUBSCRIPTS, REFER TO ABBREVIATION SCHEDULE FOR DEFINED REQUIREMENTS.					
	+60" +60"		4	3. WHERE OUTLETS, DEVICES AND EQUIPMENT ARE NOTED BY THE SUBSCRIPT 'A', MOUNT AT 4" ABOVE COUNTER. IF COUNTER HAS A				
	+60"		BACK S	PLASH, MOUNT AT 4" ABOVE BACK SPLASH. REFER TO ARCHITECTURA				
	+60"		4. NOT ALL ELECTRICAL SYMBOLS MAY BE USED.					
SCONNECT	+60"							
D DISCONNECT	+60"		5. ALL DE	VICE MOUNTING HEIGHTS SHOWN ARE IN GENERAL UNLESS OTHERWIS		IN THE FLOOR PLANS.		
RCUIT	+60"			GENERAL SYMB	OLS			
			SYMBOL	DESCRIPTION		REMARKS		
ACE-MOUNTED)	TOP AT +72" TOP AT +72"	20"W X 6"D 20"W X 6"D	(XX)	KEYED NOTE				
	WALL	THESE SYMBOLS ARE GENERAL IN						
	FLOOR       FLOOR		1 E-1	DETAIL REFERENCE	LETTER-NUMBER IND DETAIL IS SHOWN; WI DETAIL IS GENERAL II	TES DETAIL NUMBER; BOTTOM ICATES DRAWING SHEET WHERE HERE NOT SPECIFICALLY REFERENCED, N NATURE AND SHALL APPLY WHERE		
		IS INDICATED IN SEMI-QUOTES (I.E. 'L2A', 'MDP')		ELEVATION REFERENCE		TES ELEVATION NUMBER; BOTTOM		
	PAD MOUNT		2 E-2		LETTER-NUMBER IND	ICATES WHERE ELEVATION IS SHOWN.		
_OOR BOX DE	.OOR BOX DEVICES			SECTION REFERENCE	TOP NUMBER INDICA	TES ELEVATION NUMBER; BOTTOM		
		3 E-2			ICATES WHERE ELEVATION IS SHOWN.			
R BOX SCHEDULE								
ET BOX LOCATIONS	WITH SYSTEM FURNITUR	NITURE. COORDINATE SYSTEM E SUPPLIER/INSTALLER PRIOR TO	100	ARCHITECTURAL ROOM NUMBER				
MS FURNITURE TO B	BE PROVIDED BY SYSTEM	FURNITURE INSTALLER.		EQUIPMENT NAME / NUMBER		VIATES EQUIPMENT NAME OR TYPE; DICATES EQUIPMENT NUMBER. REFER DUILE		
COLUMNS WITH SYS		PER NEC. COORDINATE ER/INSTALLER PRIOR TO ROUGH-IN. ECOM RISER DIAGRAM FOR CONDUIT SIZING		REVISION NUMBER		ANGES EITHER ISSUED BY ADDENDUM		
			$\underline{\land}$			JCTION AND TO DENOTE RECORD		
LOOR BOX SCHEDUL	LE FOR MORE INFORMATI	ON.						
EED CONNECTIONS	Э.	MOUNTING		REVISION CLOUD	AFFECTED BY THE RE	EAS, DEVICES, EQUIPMENT DETAILS, ETC. EVISION.		
		FLOOR						
TH FURNITURE FEED CONNECTIONS. FLOOR			BREAKLINE	USED TO BREAK DRA	WINGS.			
TH FURNITURE FEEI	D CONNECTIONS.	FLOOR						
<b>.</b>			LCD-###					
GHTING CONT	TROLS			BRANCH CIRCUITING	SYMBOLS			
	MOUNTING	REMARKS	SYMBOL	DESCRIPTION		REMARKS		
	+48"			BRANCH CIRCUIT HOME RUN TO PANEL	ARROWS:			
	+48"	SUBSCRIPT KEYS SWITCH TO FIXTURES			REQUIRED.	S INDICATES NUMBER OF CIRCUITS		
		CONTROLLED.		BRANCH CIRCUITING (U.N.O.) CONTINUATION				
	+48"		]	CONDUIT STUB-IN	CAP AND MARK			
	+48"							
	+48"	REFER TO LOW VOLTAGE SWITCH SCHEDULE FOR MORE INFORMATION						
		"#" SPECIFIES TYPE	J	JUNCTION BOX	MOUNT AS NOTED. S	UBSCRIPT 'F' INDICATES TO PROVIDE A ANK COVERPLATE.		
	CEILING	"a" LOWER CASE SPECIFIES ZONE "#" SPECIFIES TYPE	0	BRANCH CIRCUITING (U.N.O.) TURNED UP OR TOWARDS OBSERVER.				
	CEILING	"a" LOWER CASE LETTER SPECIFIES ZONE "#" SPECIFIES THE FOOTCANDLE SETTING		BRANCH CIRCUITING (U.N.O.) TURNED DOWN OR AWAY FROM OBSERVER.				
IGHTING SYM	BOLS	THE SENSOR SHALL BE SET TO		2 CIRCUIT, BRANCH CIRCUIT HOME RUN TO PANEL		S INDICATES NUMBER OF CIRCUITS		
D MAY BE SHOWN OI	THE DRAWINGS IN VARIOUS SIZES AND SHAPES.			3 CIRCUIT, 4 WIRE BRANCH CIRCUIT HOME RUN TO PANEL	REQUIRED.			
CATION INFORMATIC	JN.				NUMBER OF ARROWS REQUIRED.	S INDICATES NUMBER OF CIRCUITS		
	MOUNTING	REMARKS		ELECTRONIC SYSTEM GEN	ERAL SYMBOLS	1		
	AS SPECIFIED		SYMBOL	DESCRIPTION	MOUNTING	REMARKS		
	OR DETAILED		PANEL NAME	ELECTRONIC SYSTEM PANELBOARD (SURFACE MOUNT)	TOP AT 72"	ELECTRONIC SYSTEMS MAY INCLUDE BUT ARE NOT SPECIFICALLY LIMITED TO, TELEPHONE, DATA, TELEVISION,		
	AS SPECIFIED		PANEL NAME	ELECTRONIC SYSTEM PANELBOARD (FLUSH MOUNT)	TOP AT 72"	LIGHTING CONTROL, CLOCKS, FIRE ALARM, ACCESS CONTROL, SECURITY, CCTV, SOUND SYSTEM, NURSE CALL,		
	OR DETAILED	THIS IS AN <u>EXAMPLE</u> OF AN EGRESS				OR INTERCOM.		
	AS SPECIFIED OR DETAILED	LIGHT FIXTURE. EGRESS LIGHT FIXTURES		ELECTRONIC SYSTEM TERMINAL BOARD	TOP AT 72"			
(TURE TYPE)		ARE HALF-SHADED DIAGONALLY		FIRE ALARM SYM	BOLS			
,								
PHONE / DATA	SYMBOLS		SYMBOL	DESCRIPTION	MOUNTING	REMARKS		
				HEAT DETECTOR	CEILING			
	MOUNTING	REMARKS	X ©	SMOKE DETECTOR				
	+18"			FIRE ALARM AUDIO/VISUAL HORN/STROBE				
	CEILING			CEILING MOUNTED FIRE ALARM AUDIO/VISUAL HORN/STROBE	1			
			FACP	FIRE ALARM CONTROL PANEL				
				WIRING DEVICE SY	MBOLS	•		
			SYMBOL	DESCRIPTION	MOUNTING	REMARKS		
			⊕	DUPLEX RECEPTACLE FOURPLEX RECEPTACLE	+18" +18"			
			71.15			-		

_		ABBREVIAT	ION SO	CHEDULE
		NOTE: NOT ALL ABBR	EVIATIO	NS MAY BE USED.
	A A ACC	ABOVE COUNTER AMP OR AMPS ACCESS CONTROL	LSI LSIG	LONG-TIME, SHORT-TIME INSTANTANEOUS LONG-TIME, SHORT-TIME INSTANTANEOUS GROUND FAULT
	ADJ	ADJACENT	LTG	LIGHTING
	AFF	ABOVE FINISHED FLOOR	MBJ	MAIN BONDING JUMPER
	AHJ	AUTHORITY HAVING JURISDICTION	MCA	MINIMUM CIRCUIT AMPS
	AL	ALUMINUM	MCB	MAIN CIRCUIT BREAKER
	ATS	AUTOMATIC TRANSFER SWITCH	MLO	MAIN LUGS ONLY
	AUX	AUXILIARY	MV	MEDIUM VOLTAGE
	AWG	AMERICAN WIRE GAUGE	MW	MICROWAVE
	BAS BLDG	BUILDING AUTOMATION SYSTEM	NC NEC	NORMALLY CLOSED NATIONAL ELECTRIC CODE
	C	CONDUIT	NIC	NOT IN CONTRACT
	CB	CIRCUIT BREAKER	NL	NIGHT LIGHT
	CKT	CIRCUIT	NO	NORMALLY OPEN
	CLG	CEILING	OC	ON CENTER(S)
	CO	CONVENIENCE OUTLETS	OCP	OVER CURRENT PROTECTION
	COMM	COMMUNICATIONS	OCPD	OVER CURRENT PROTECTION DEVICE
	CU	COPPER	PA	PUBLIC ADDRESS
	DAS	DISTRIBUTED ANTENNA SYSTEM	PH	PHASE
	(E)	EXISTING	PV	PHOTOVOLTAIC
NCED, ERE	EA EG EGC	EACH EQUIPMENT GROUND EQUIPMENT GROUNDING CONDUCTOR	PWR QTY R	POWER QUANTITY REMOVE
М	ELEC	ELECTRICAL	REF	REFRIGERATOR
	EM	EMERGENCY	REQ	REQUIREMENTS
	EMT	ELECTRIC METALLIC TUBING	RGC	RIGID GALVANIZED METALLIC CONDUIT
OWN.	ENT	ELECTRIC NONMETALLIC TUBING	RMC	RIGID METAL CONDUIT
	EQUIP	EQUIPMENT	RMP	ROCKY MOUNTAIN POWER
	EWC	ELECTRIC WATER COOLER	RNC	RIGID NONMETALLIC CONDUIT
	EXP	EXPLOSION PROOF	RR	REMOVE AND RELOCATE
	FA	FIRE ALARM	S	SURFACE MOUNTED
M OWN.	FACP FLA FMC	FIRE ALARM CONTROL PANEL FULL LOAD AMPS FLEXIBLE METAL CONDUIT	SBJ SCP SFL	SYSTEM BONDING JUMPER SECURITY CONTROL PANEL SUB-FEED LUGS
	FO	FIBER OPTIC	SPD	SURGE PROTECTIVE DEVICE
	FOB	FREIGHT ON BOARD	SS	SURGE SUPPRESSION
	FTL	FEED-THROUGH LUGS	SSBJ	SUPPLY SIDE BONDING JUMPER
	GEC	GROUNDING ELECTRODE CONDUCTOR	TGB	TELECOMMUNICATION GROUNDING BUS BAR
	GND	GROUND CONDUCTOR	TMGB	TELECOMMUNICATION MAIN GROUNDING
PE; EFER	H HOA HP	HOSPITAL GRADE HAND-OFF-AUTO HORSE POWER	TR TTB TYP	BUS BAR TAMPER RESISTANT TELEPHONE TERMINAL BOARD
NDUM	HZ IBT ID	HORIZONTALLY MOUNTED INTERSYSTEM BONDING TERMINATION BAR INTRUSION DETECTION	UF UG	TYPICAL UNDER FLOOR UNDERGROUND
	IG	ISOLATED GROUND	UNO	UNLESS NOTED OTHERWISE
	IMC	INTERMEDIATE METAL CONDUIT	USB	UNIVERSAL SERIAL BUS
	INS	INSULATED	VSS	VIDEO SURVEILLANCE SYSTEM
ILS, ETC.	ISO	ISOLATED	W/	WITH
	KCMIL	KILO CIRCULAR MIL	WO/	WITHOUT
	KVA	KILO VOLT AMPERES	WP	WEATHER PROOF
	KW	KILOWATTS	WR	WEATHER RESISTANT
	LFNC	LIQUID-TIGHT NONMETAL CONDUIT	XFMR	TRANSFORMER
	LS	LONG-TIME, SHORT-TIME SHEE		DEX
	EG001	_		
	-1			

DEMOLITON PLAN

DETAILS

DETAILS

76-125

126-190 191-300

301-480

NOTES:

RISER DIAGRAMS

SCHEDULES

FLOOR PLAN - LIGHTING

SCHEDULES, DETAILS, AND WIRING DIAGRAMS

FLOOR PLAN - POWER AND SYSTEMS

 UP SIZING CHART FOR 20AMP, SIN

 PHASE BRANCH CIRCUITS

 120 VOLTS, 12A MAX LOAD, 3% VD

 LENGTH (FT)
 CONDUCTOR SIZE
 CONDUIT SIZE

 0-75
 (3)#12
 3/4"

(3)#10

(3)#8

(3)#6

(3)#4

PROVIDE BRANCH CIRCUIT CONDUCTORS IN SIZES SUCH THAT

VOLTAGE DROP FOR BRANCH CIRCUIT CONDUCTORS IN SIZES SUCH THAT VOLTAGE DROP FOR BRANCH CIRCUITS DO NOT EXCEED 3 PERCENT AT THE FARTHEST OUTLET. INCREASE CONDUCTOR SIZES (AND CONDUITS WHERE TO COMPLY WITH NEC CONDUIT FILL REQUIREMENTS) AS NECESSARY TO ACCOMMODATE THIS REQUIREMENT.

1-1/2"

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VOLTAGE DROP UPSIZING CHART FOR 20AMP, SINGLE

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MHTN ARCHITECTS OF DESIGN MHTN Architects, Inc. 280 South 400 West Suite 250 Salt Lake City, Utah 84101 Telephone (801) 595-6700 www.mhtn.com 240 E. MORRIS AVE. SUITE 200 SALT LAKE CITY, UT 84115 P (801) 534-1130 F (801) 534-1080 www.envisioneng.com Ο AIRP **M 'IONAL** \_ ΞŪ AKE AKE  $\square$  $\mathbf{C}$ SAI SAI  $\mathcal{O}$ NZ ©2023 MHTN ARCHITECTS, INC Confidentiality Notice: This document is intended for use on the Project identified herein by individuals and companies involved in the design, permitting, bidding and construction of the Project. MHTN Architects, Inc. grants limited rights to distribute and reproduce this document for this express purpose only. Distribution, printing or copying this document for purposes other than those indicated is strictly prohibited. If a digital copy of this document is received in error, please delete it. SEAL ONAL 9808039-2202 ALEKSANDAR RANKOVĮC 02/19/2024 MHTN PROJECT NO.2023573 Original drawing is 24 x 36. Do not scale contents of this drawing. ISSUED: NO. DATE DESCRIPTION \_\_\_\_\_ REVISIONS CONTRACTOR TO VERIFY DRAWINGS IN FIELD USE REFLECT LAST REVISION DATE. NO. DATE DESCRIPTION \_\_\_\_\_ \_\_\_\_\_ \_\_\_\_\_ ------GONSTRUCTION DOCUMENTS - BID SET MAY 02, 2024

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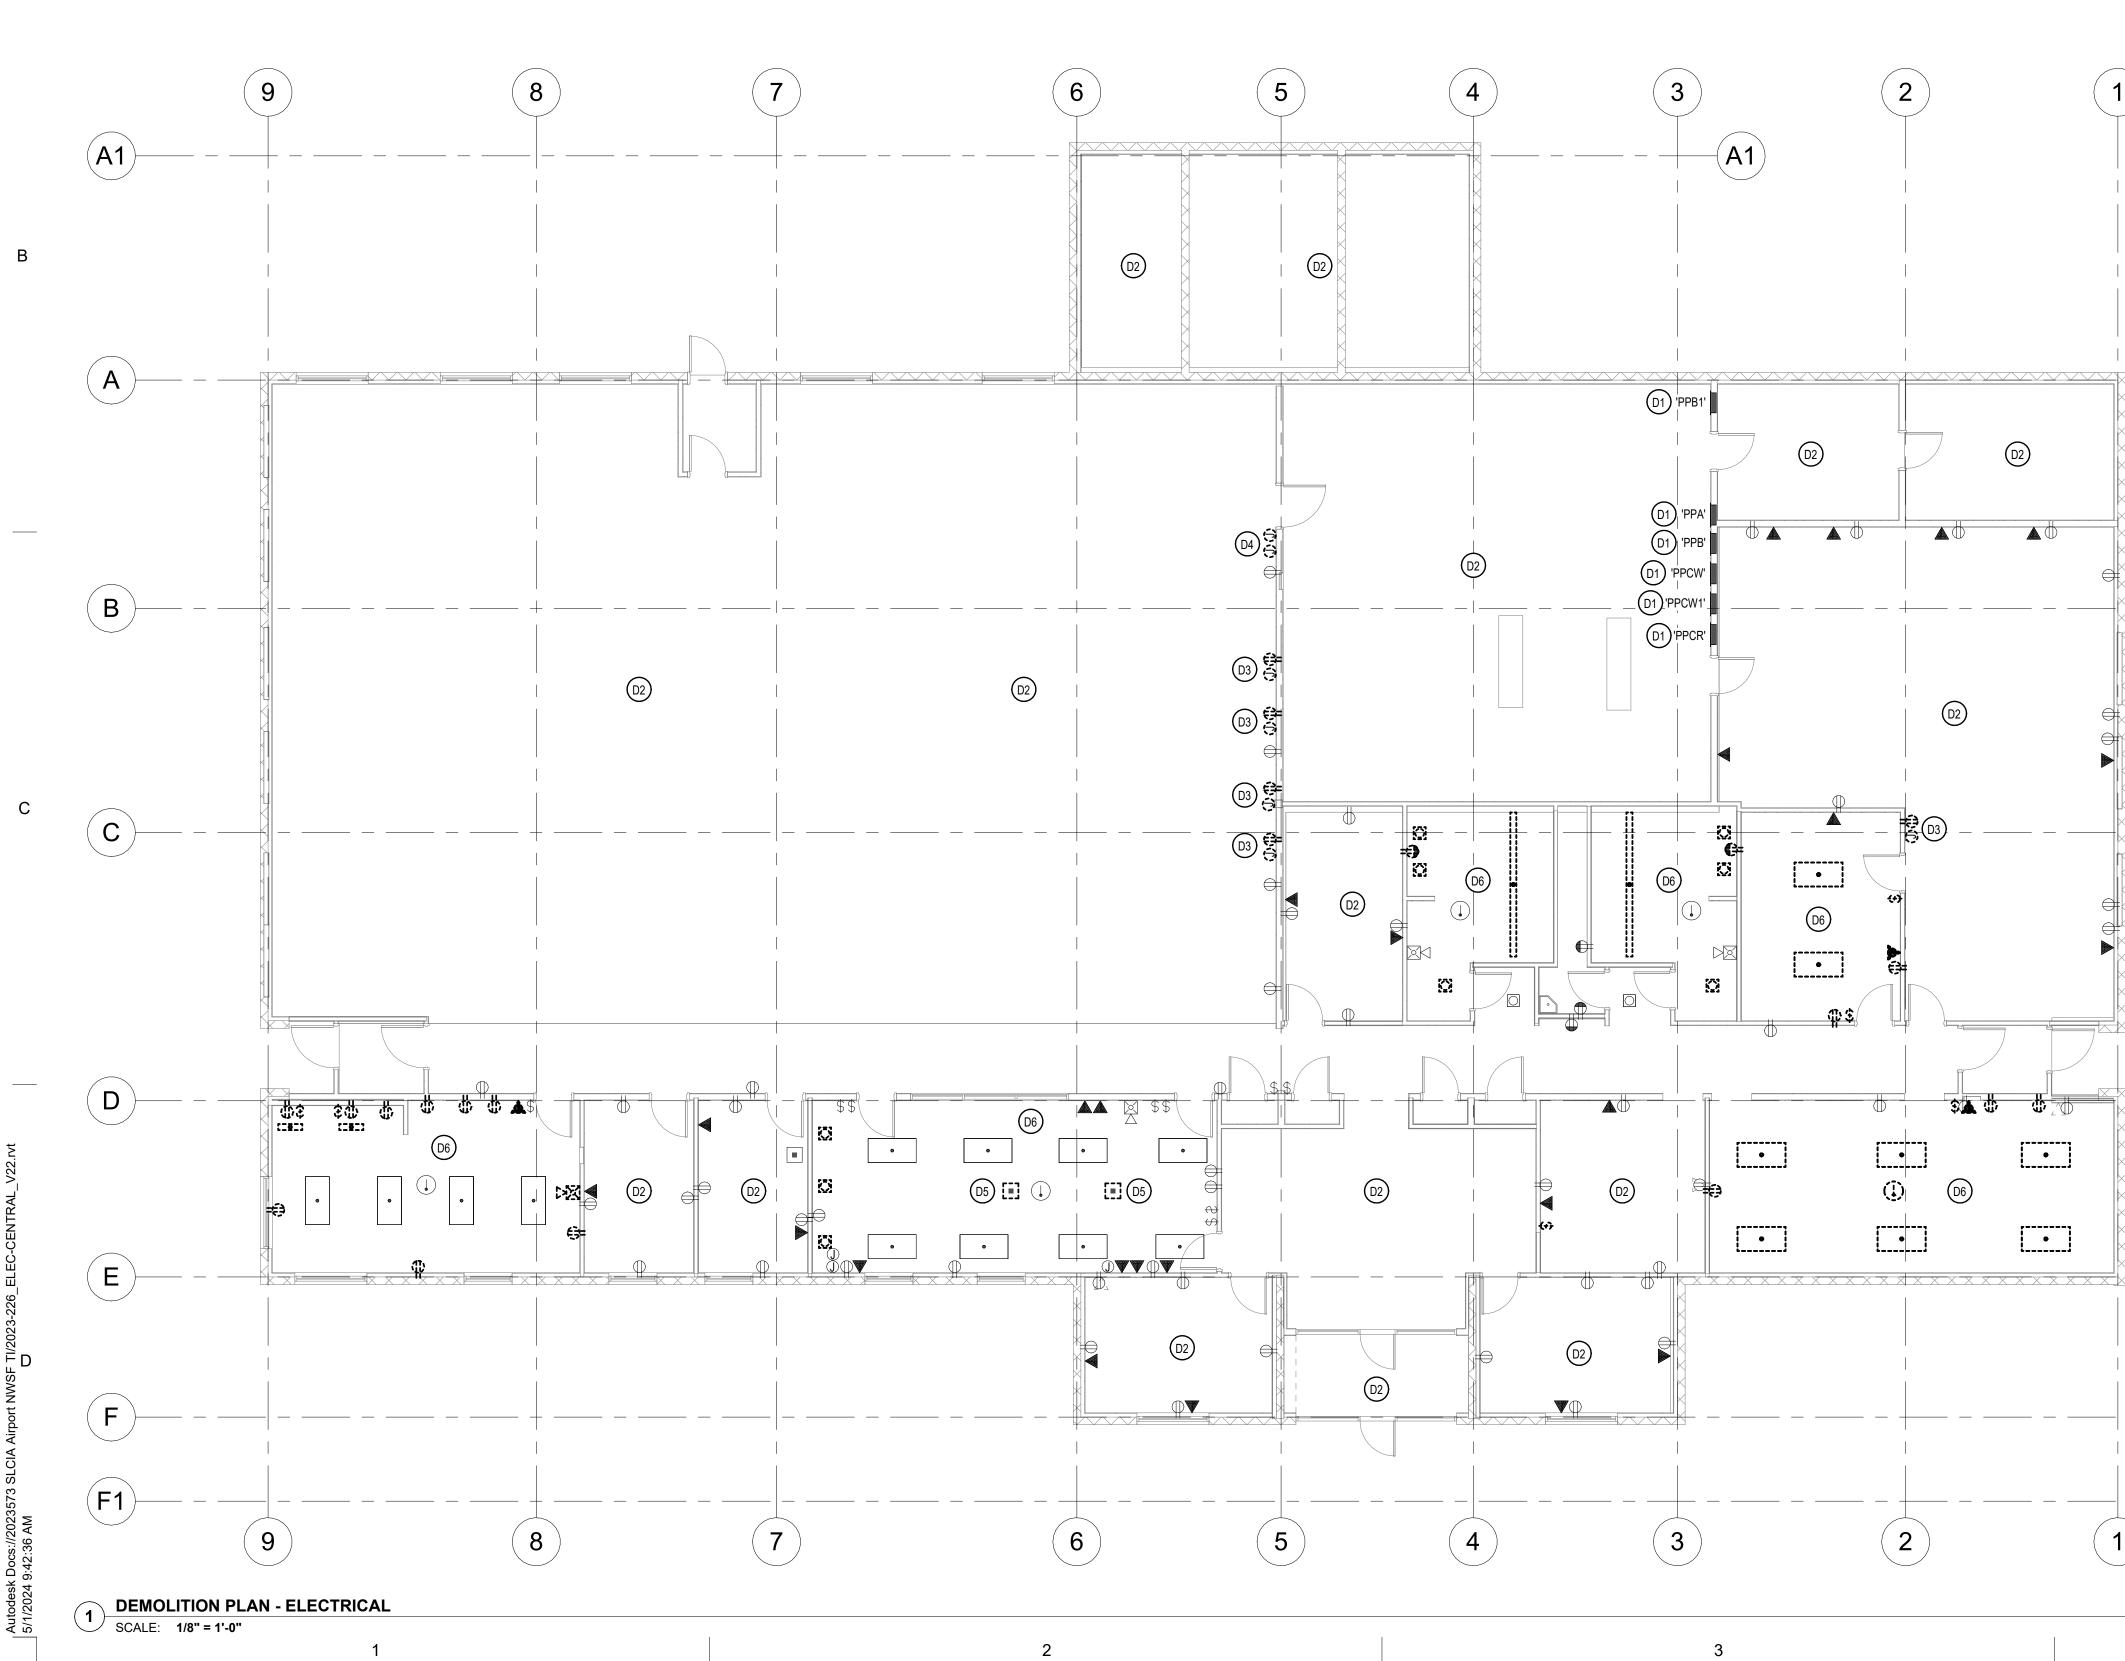
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E GENERAL NOTES AND SYMBOLS LISTS

EG001

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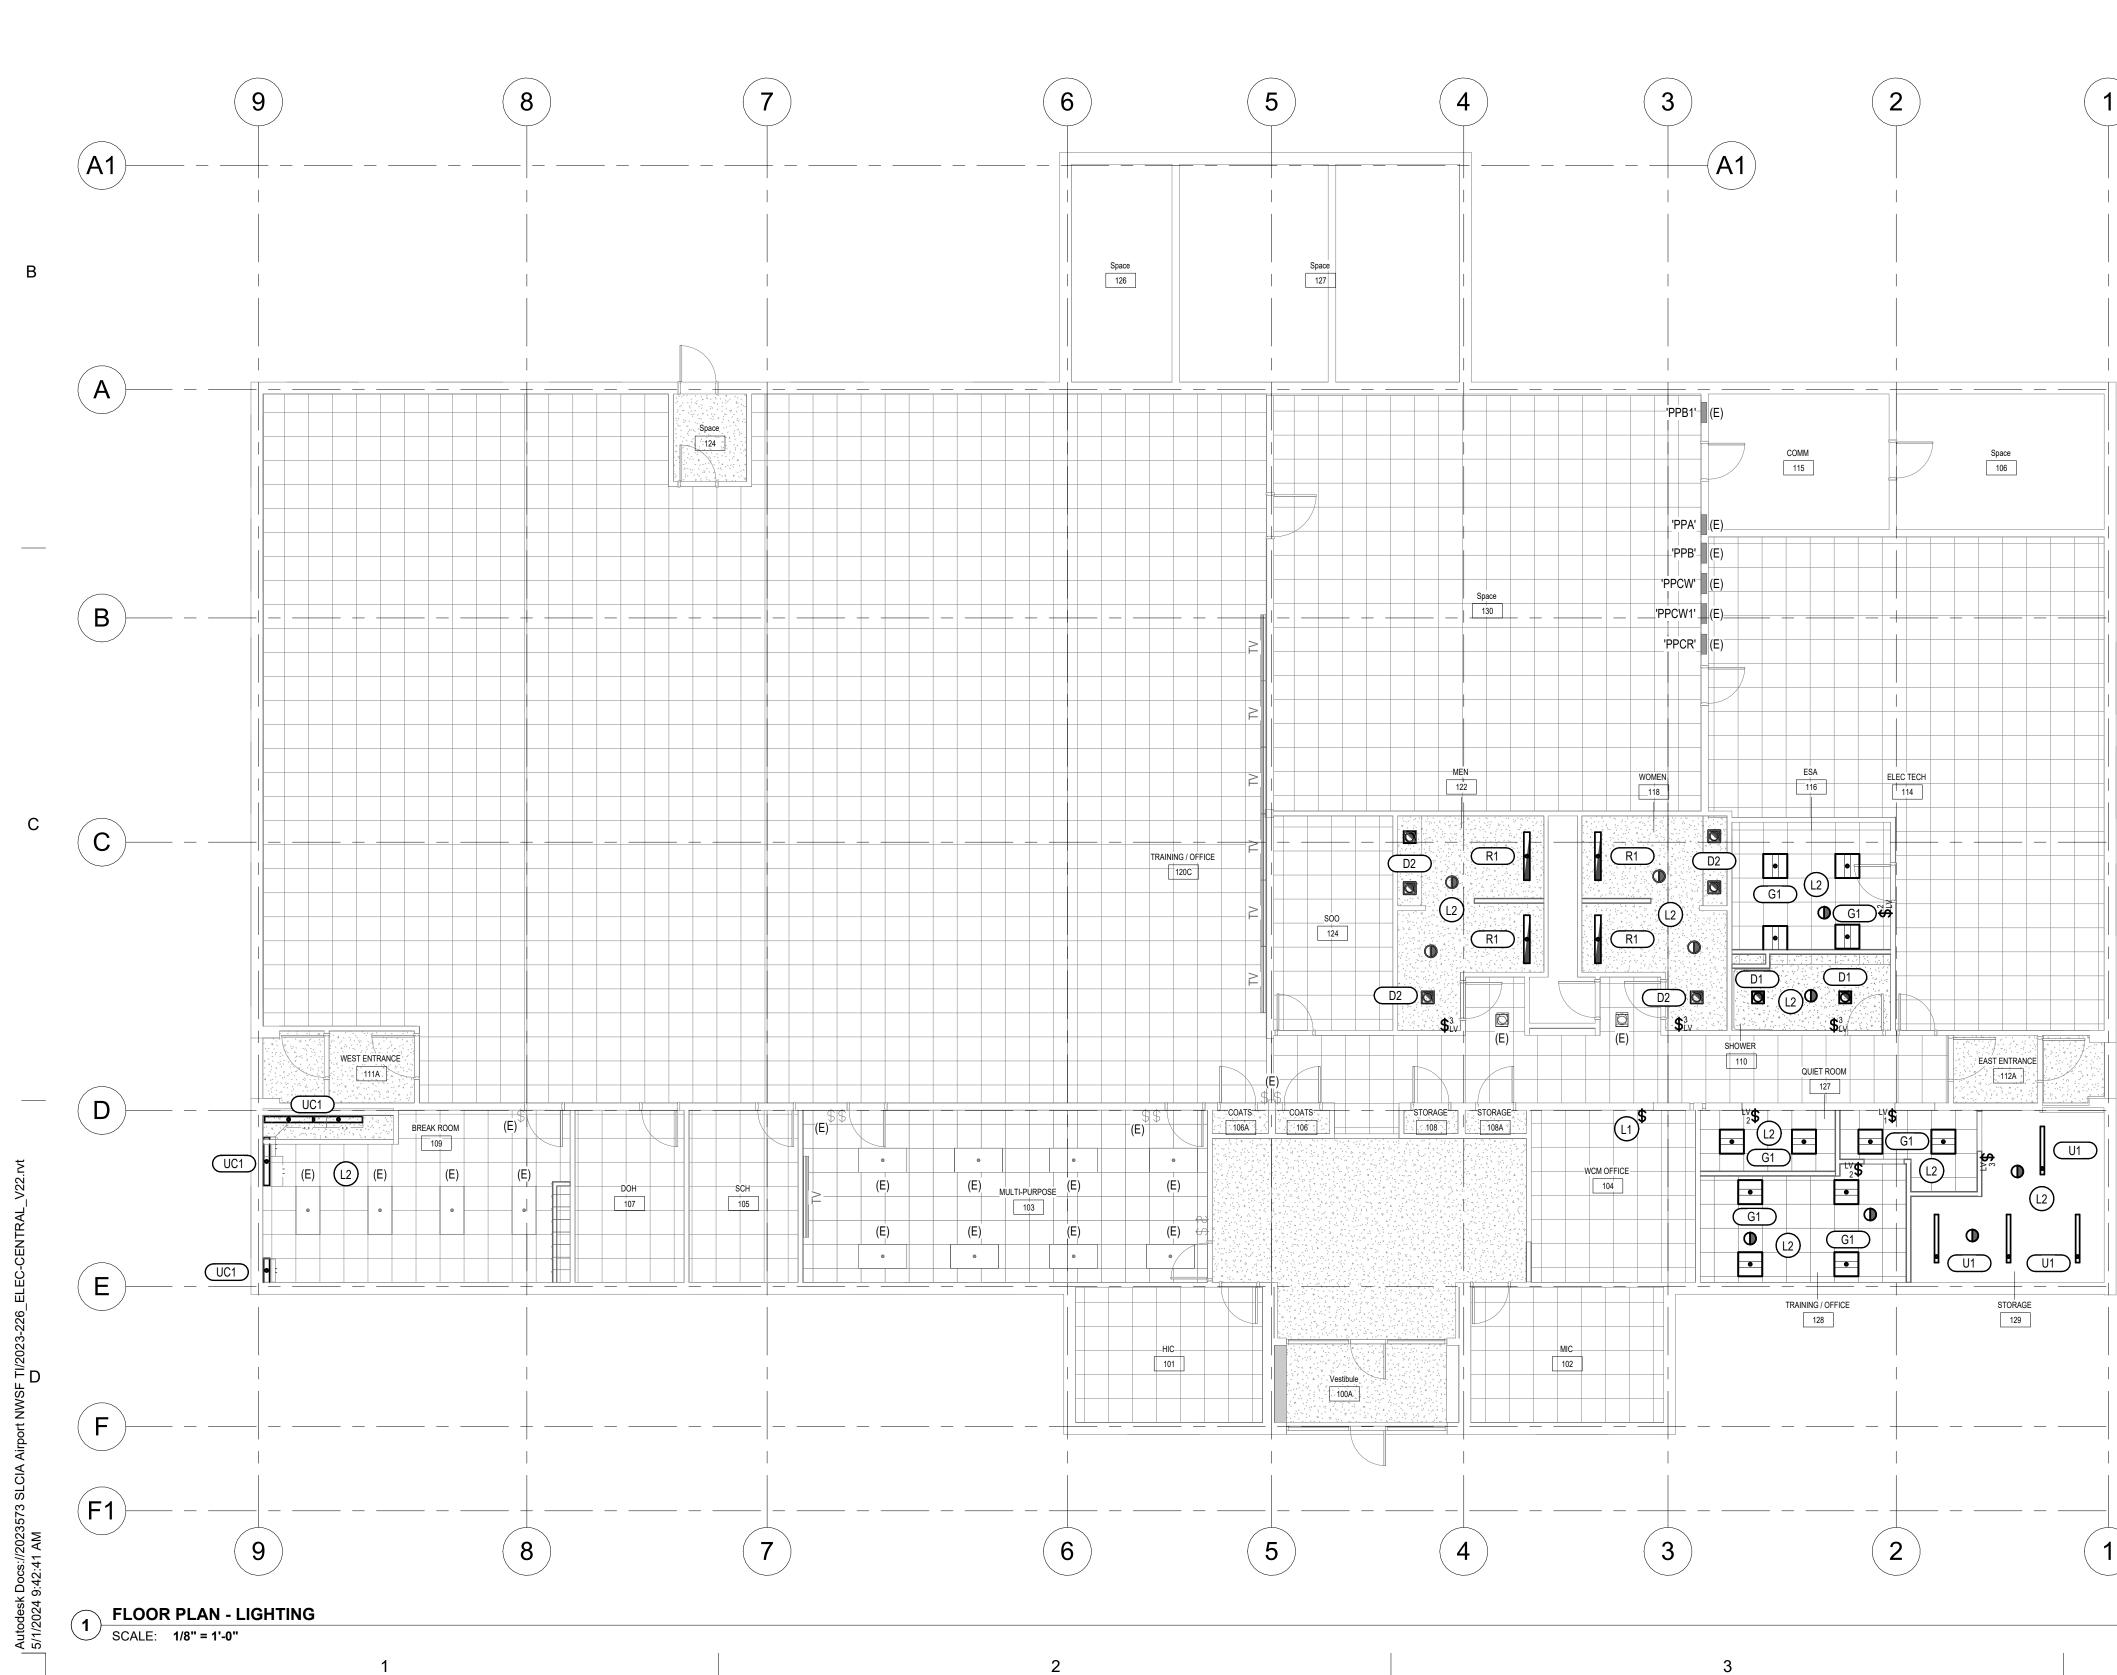
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KEYE	DNOTES (#)	
D1	PROTECT AND MAINTAIN	
D2	ALL ELECTRICAL EQUIPMENT INCLUDING LIGHT FIXTURE FIRE ALARM DEVICES, SECURITY DEVICES IN THE SPACE SHOWN OR NOT SHALL BE PROTECTED AND MAINTAINE	E WHETHER
D3	DEMOLISH POWER AND HDMI JUNCTION BOXES FOR EX DEMOLISH CONDUIT AND CONDUCTORS UP TO THE NEA BOX. REMOVE HDMI CABLING BACK TO SOURCE.	
D4	DEMOLISH POWER TO EXISTING HUMIDIFIERS. DEMOLIS CONDUCTORS BACK TO SOURCE.	H CONDUIT ANI
D5	DEMOLISH EXISTING FLOOR BOX AND ALL ASSOCIATED CONDUCTORS UP TO THE NEAREST JUNCTION BOX. DEI EXISTING CABLING. SAWCUT EXISTING CONCRETE SLAE REFER TO ARCHITECTURAL PLANS FOR MORE INFORMA	MOLISH ALL AS REQUIRED
D6	ALL EXISTING CIRCUITS IN THIS SPACE SHALL BE RE-US NEW FLOOR PLANS. CONDUIT AND CONDUCTORS SHALL ONLY UP TO THE NEAREST ACCESSIBLE JUNCTION BOX	BÉ DEMOLISH

(1

		4		
	GENERA	L DEMOLITION NOTES:		
S,	ITEMS ARE 1 DESC INCLU	SS SPECIFICALLY NOTED OTHERWISE, REMOVE ALL ELECTRICAL S SHOWN IN DARK AND DASHED LINES. LIGHT AND SOLID ITEMS TO REMAIN. DEMOLITION ITEMS ARE SHOWN TO GIVE A BASIC RIPTION OF THE EXTENT OF DEMOLITION WORK, BUT MAY NOT BE JSIVE. PROVIDE DEMOLITION WORK IN ACCORDANCE WITH THE OWING REQUIREMENTS:		ARCHITECTS MHTN Architects, Inc. 280 South 400 West Suite 250 Salt Lake City, Utah 84101 Telephone (801) 595-6700
ION	A.	DISCONNECT AND REMOVE ANY/ALL FIXTURES, DEVICES, EQUIPMENT, ETC. REQUIRED FOR PROPER COMPLETION OF THE WORK WHETHER SHOWN OR NOT.		www.mhtn.com
ND	В.	RELOCATE, REWIRE, AND/OR RECONNECT ANY/ALL FIXTURES, DEVICES, EQUIPMENT, ETC. THAT FOR ANY REASON OBSTRUCTS CONSTRUCTION.	A	
D,	C.	LEAVE ALL EXISTING FIXTURES, DEVICES, EQUIPMENT, ETC. IN PORTIONS OF THE BUILDING NOT BEING REMODELED, IN WORKING CONDITION. RESTORE ALL INTERRUPTED BRANCH CIRCUITS, FEEDERS, ETC.		
) HED	D.	REMOVE AND DISPOSE OF ALL RACEWAYS, CONDUCTORS, BOXES, DEVICES, EQUIPMENT, ETC. THAT ARE NOT TO BE REUSED. TERMINATE AT ACCESSIBLE JUNCTION BOX BY PROVIDING PROPER KNOCK-OUT CLOSURE, TAPE CONDUCTORS, LABEL AS "SPARE" WITH CIRCUIT NO., ZONE NO, OR OTHER CHARACTERISTIC IDENTIFYING SOURCE.		240 E. MORRIS AVE. SUITE 200 SALT LAKE CITY, UT 84115 P (801) 534-1130 F (801) 534-1080 www.envisioneng.com
	E.	EXISTING RACEWAYS MAY BE REUSED, IF IN PLACE, WHERE POSSIBLE, AND WHERE IN COMPLIANCE WITH THE SPECIFICATIONS AND THE INTENT OF THE CONTRACT DOCUMENTS. UPGRADE AND OR PROVIDE NEW CONDUIT SUPPORTS WHERE NECESSARY FOR ALL RACEWAYS BEING REUSED. ENSURE INTEGRITY OF EXISTING RACEWAYS BEFORE REUSE.		——––––––––––––––––––––––––––––––––––––
	F.	CONCEAL ALL RACEWAY AND WIRING IN EXISTING WALLS, CEILINGS, FLOORS, ETC. THE USE OF WIREMOLD IS PERMITTED ONLY WHERE SPECIFICALLY NOTED ON DRAWING.		K A
	G.	DO NOT PENETRATE STRUCTURAL ELEMENTS OF FLOORS, WALLS, CEILINGS, ROOFS, ETC.		
	Н.	COORDINATE WITH OWNER WHAT EQUIPMENT SHOULD BE DISPOSED OF AND WHAT EQUIPMENT IS TO BE RETURNED TO OWNER.		
	I.	FIRE ALARM SYSTEM MUST REMAIN OPERATIONAL DURING ALL PHASES OF CONSTRUCTION.		
			C	<section-header></section-header>
				REVISIONS       CONTRACTOR TO VERIFY DRAWINGS IN FIELD USE REFLECT       LAST REVISION DATE.       NO.▲     DATE       DESCRIPTION
	E			GONSTRUCTION DOCUMENTS - BID SET MAY 02, 2024
	F		E	DEMOLITON PLAN
	- <b>F1</b>			
/		_		ED101



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## LIGHTING GENERAL NOTES:

- REFER TO LIGHTING DETAILS SHEETS FOR TYPICAL CONTROL WIRING DIAGRAMS. PROVIDE COMPLETE SYSTEM WITH ALL REQUIRED CONDUIT, WIRING, SWITCHES, SENSORS, POWER PACK, ETC.
- LOCATE POWER PACKS AND ROOM CONTROLLERS ABOVE ACCESSIBLE CEILING NEAR ROOM ENTRANCES.
- CONFIRM ALL LOCATIONS OF LIGHT FIXTURES WITH ARCHITECT PRIOR TO INSTALLATION.
- PROVIDE UNSWITCHED HOT FOR ALL EMERGENCY LIGHTS AND BATTERY PACKS.

# KEYED NOTES (#)

- PROVIDE NEW SWITCH TO CONTROL EXISTING LIGHT FIXTURES. EXTEND CONDUITS AND CONDUCTORS AS REQUIRED.
- TIE ALL NEW LIGHT FIXTURES IN THIS SPACE TO NEAREST AVAILABLE EXISTING LIGHTING CIRCUIT.



# MHTN ARCHITECTS

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ALEKSANDAR RANKOVIC

02/19/2024

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SALT LAKE CITY, UT 84115

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MHTN PROJECT NO.2023573

ISSUED:

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SET

MAY 02, 2024

SHEET NUMBER

E FLOOR PLAN -LIGHTING

EL101

NO. DATE

LAST REVISION DATE.

NO. DATE DESCRIPTION

Original drawing is 24 x 36. Do not scale contents of this drawing

DESCRIPTION

REVISIONS CONTRACTOR TO VERIFY DRAWINGS IN FIELD USE REFLECT

GONSTRUCTION DOCUMENTS - BID

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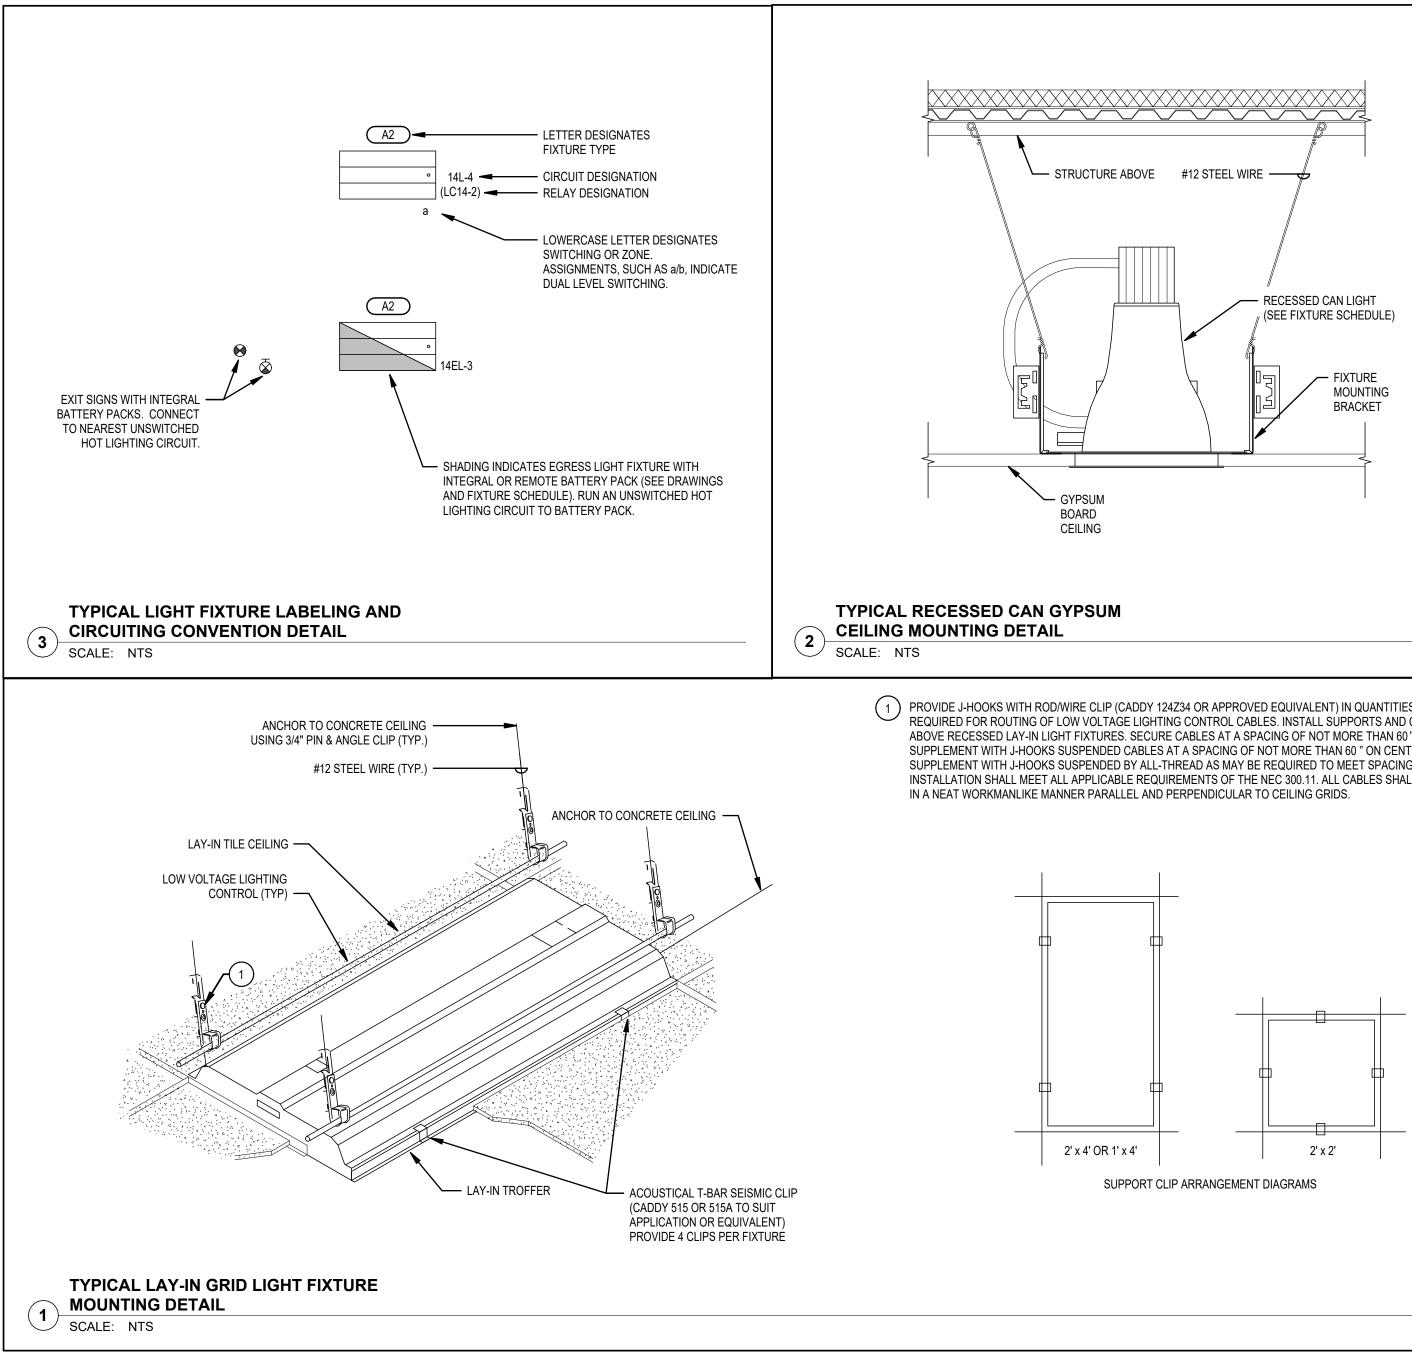
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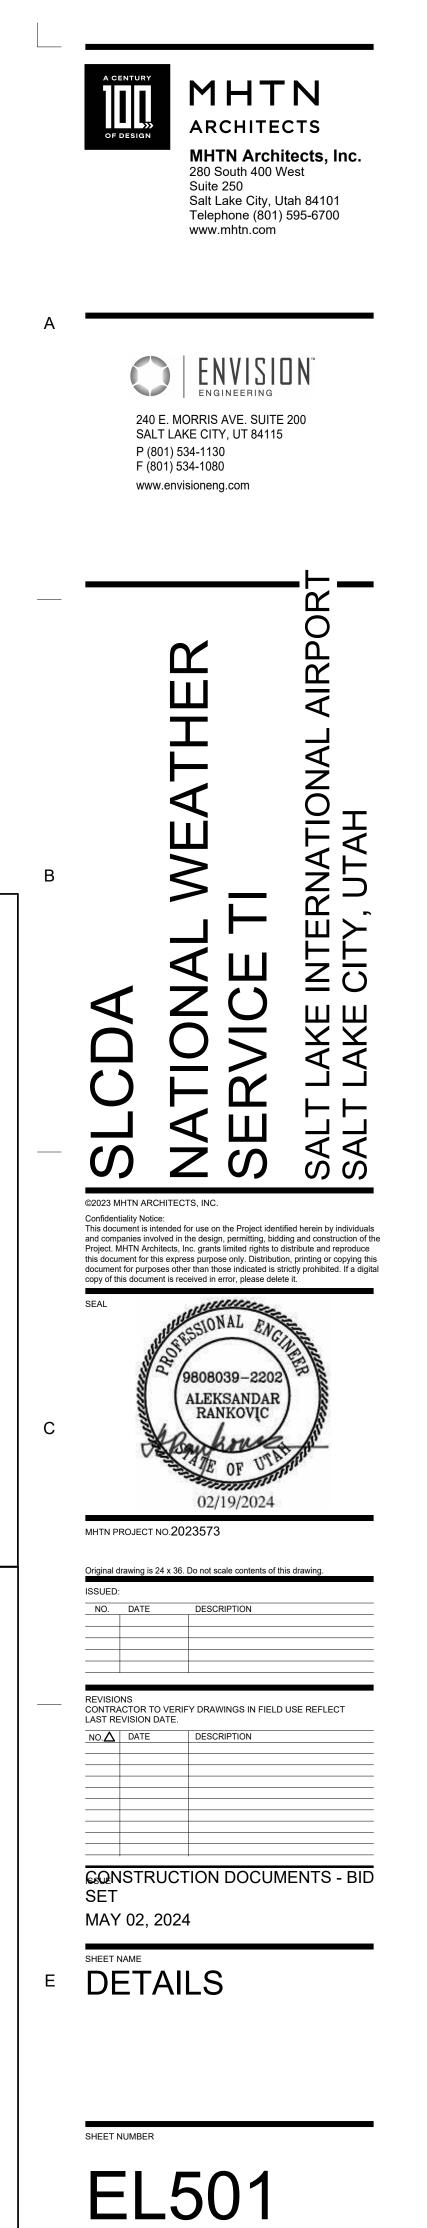
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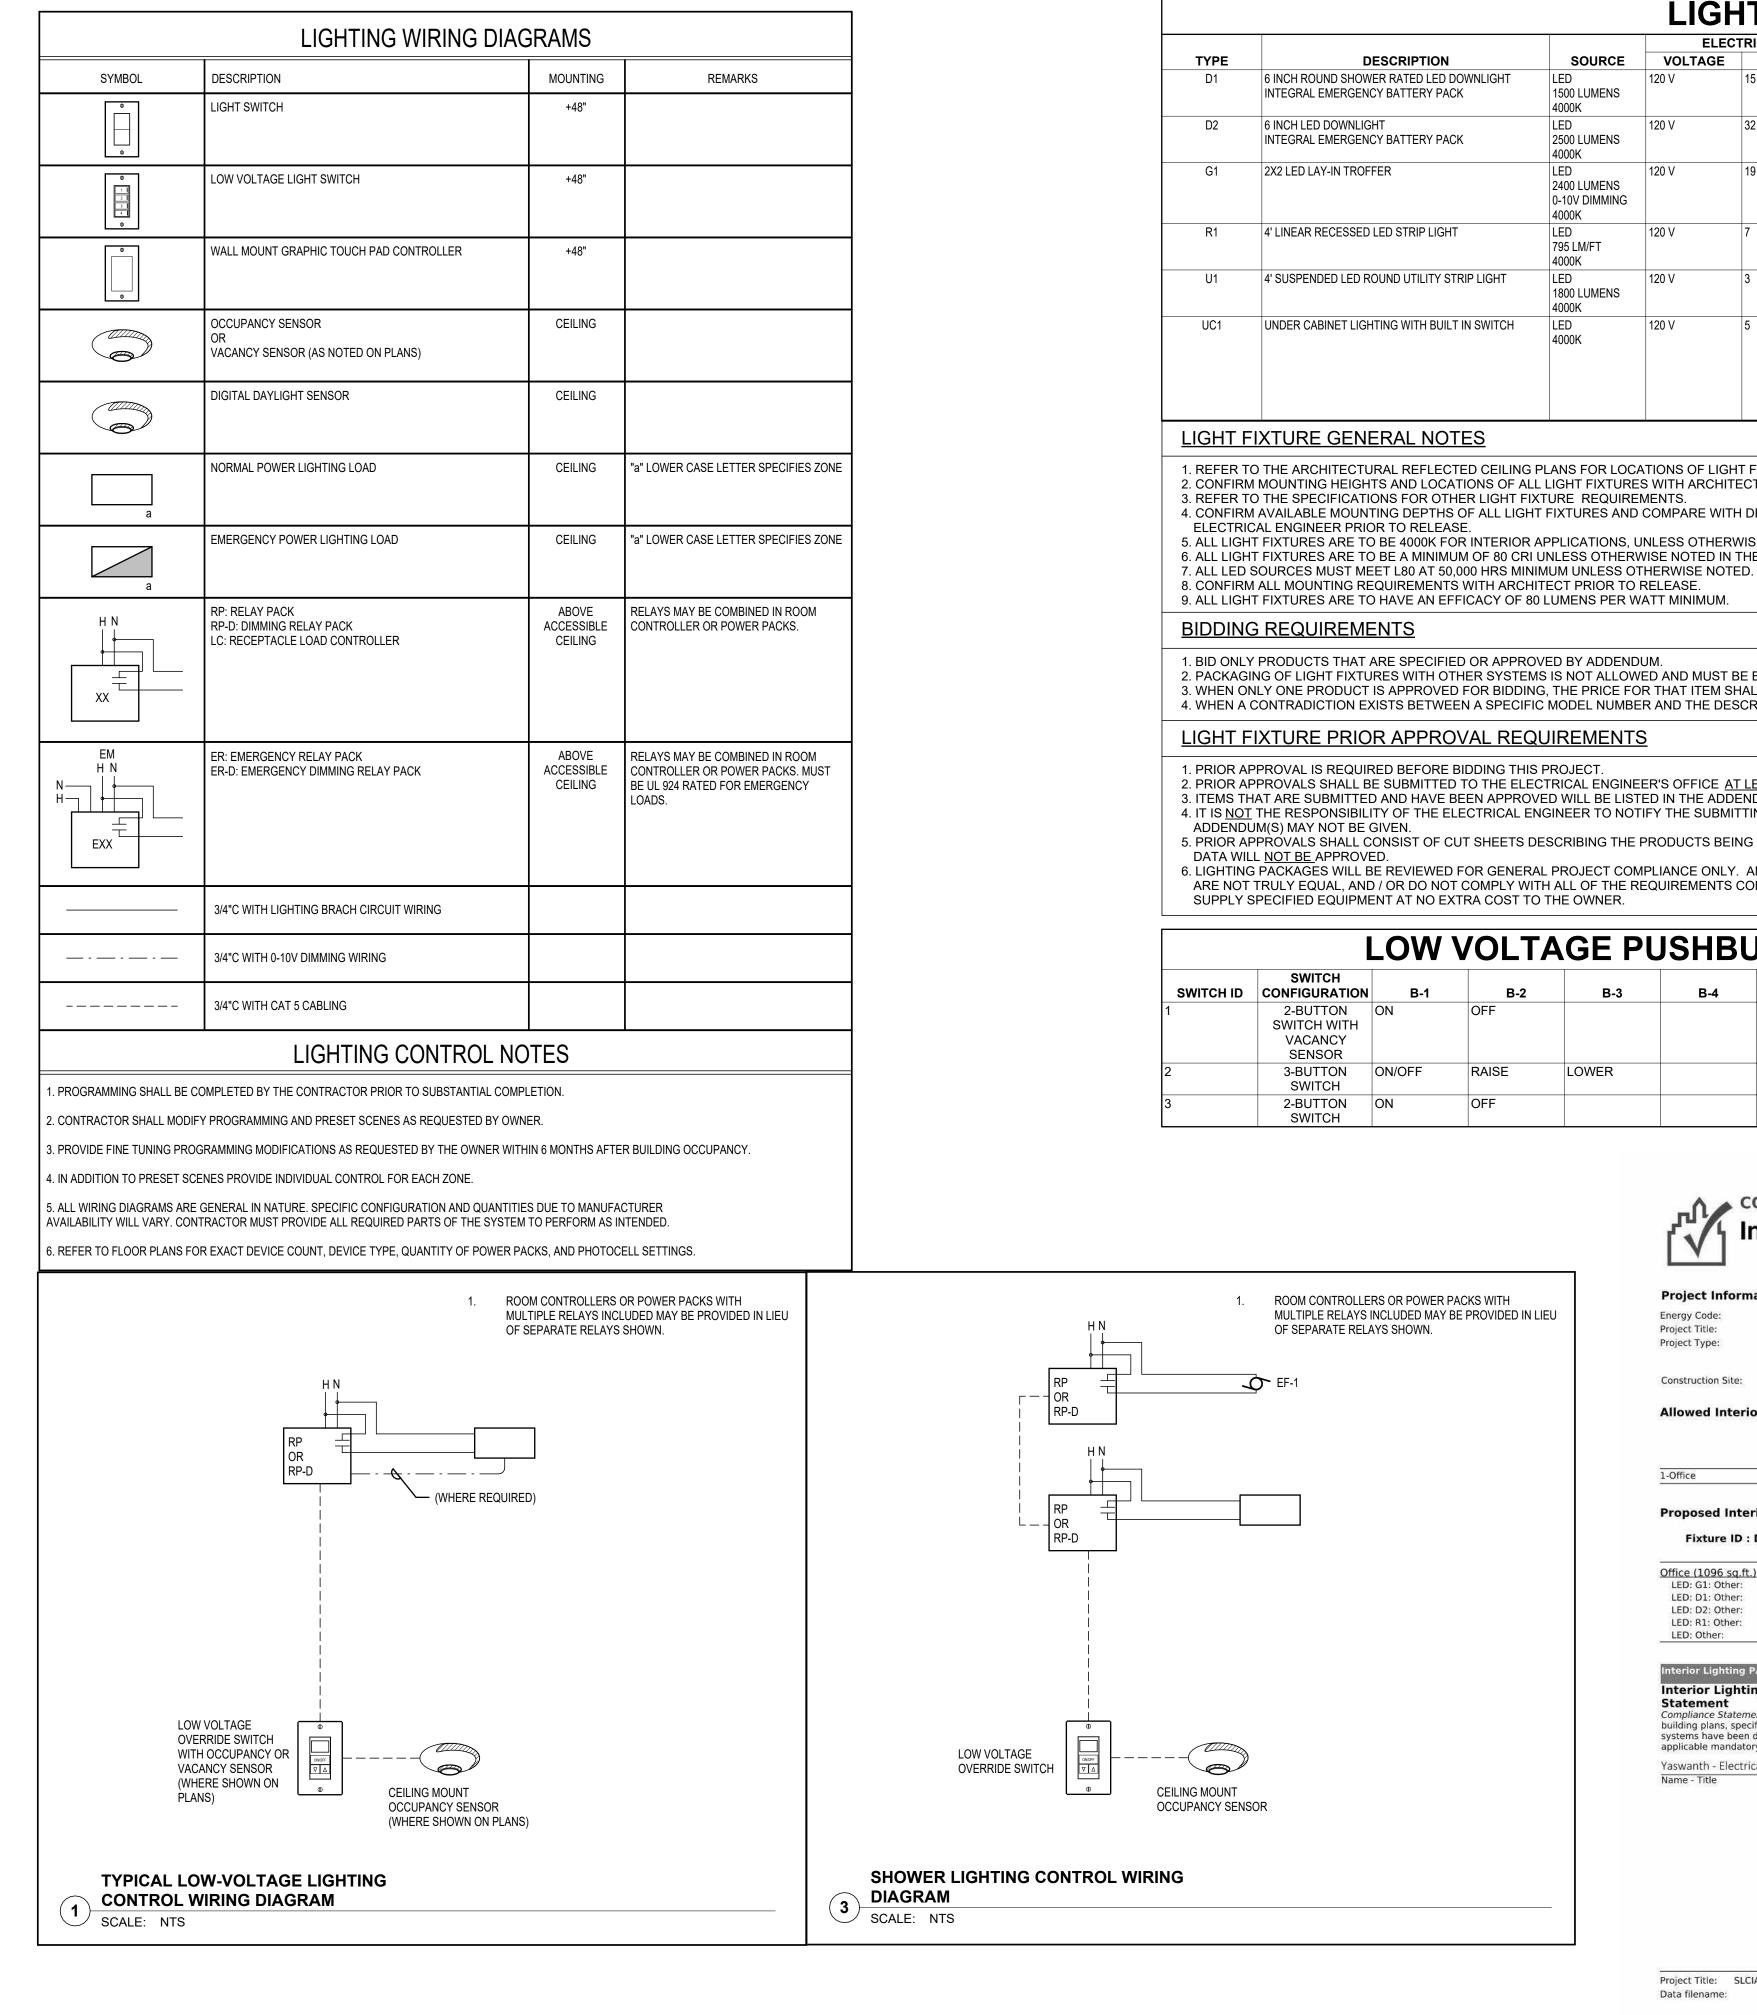


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(1) PROVIDE J-HOOKS WITH ROD/WIRE CLIP (CADDY 124Z34 OR APPROVED EQUIVALENT) IN QUANTITIES AS MAY BE REQUIRED FOR ROUTING OF LOW VOLTAGE LIGHTING CONTROL CABLES. INSTALL SUPPORTS AND CLIPS 12 " ABOVE RECESSED LAY-IN LIGHT FIXTURES. SECURE CABLES AT A SPACING OF NOT MORE THAN 60" ON CENTERS. SUPPLEMENT WITH J-HOOKS SUSPENDED CABLES AT A SPACING OF NOT MORE THAN 60 " ON CENTERS. SUPPLEMENT WITH J-HOOKS SUSPENDED BY ALL-THREAD AS MAY BE REQUIRED TO MEET SPACING CRITERIA. INSTALLATION SHALL MEET ALL APPLICABLE REQUIREMENTS OF THE NEC 300.11. ALL CABLES SHALL BE ROUTED IN A NEAT WORKMANLIKE MANNER PARALLEL AND PERPENDICULAR TO CEILING GRIDS.



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IFIES ZONE		
IFIES ZONE		
DOOL		
ROOM (S.		
ROOM		
KS. MUST INCY		

			ELECTRICAL		APPROVED	CATALOG INFORMATION	
TYPE	DESCRIPTION	SOURCE	VOLTAGE	LOAD	MANUFACTURERS	<b>CATALOG NUMBER / SERIES</b>	COMMENTS / NOTES
D1	6 INCH ROUND SHOWER RATED LED DOWNLIGHT INTEGRAL EMERGENCY BATTERY PACK	LED 1500 LUMENS 4000K	120 V	15	COOPER (OR APPROVED EQUAL)	HC6 15 D010 REM7 61PS MD W	
D2	6 INCH LED DOWNLIGHT INTEGRAL EMERGENCY BATTERY PACK	LED 2500 LUMENS 4000K	120 V	32	COOPER (OR APPROVED EQUAL)	HC6 25 D010 REM7 61 MD C	
G1	2X2 LED LAY-IN TROFFER	LED 2400 LUMENS 0-10V DIMMING 4000K	120 V	19	COOPER (OR APPROVED EQUAL)	22CZ2 24 UNV L840 (*EL7W)	* - PROVIDE WITH INTEGRAL EMERGENCY BATTERY PACK WHER SHOWN ON PLANS
R1	4' LINEAR RECESSED LED STRIP LIGHT	LED 795 LM/FT 4000K	120 V	7	COOPER (OR APPROVED EQUAL)	S123DR S 775D 8 40 GYP 4FO 1 U F	
U1	4' SUSPENDED LED ROUND UTILITY STRIP LIGHT	LED 1800 LUMENS 4000K	120 V	3	COOPER (OR APPROVED EQUAL)	4SNLED LD5 18SL LW UNV L840 CD1	
UC1	UNDER CABINET LIGHTING WITH BUILT IN SWITCH	LED 4000K	120 V	5	COOPER (OR APPROVED EQUAL)	HU30M SCTD - *	- REFER TO FLOOR PLANS FOR LENGTHS * ARCHITECT TO SELECT STANDARD FINISH PROVIDE ALL CONNECTIONS AND ACCESSORIES FOR A COMPLETE SYSTEM

1. REFER TO THE ARCHITECTURAL REFLECTED CEILING PLANS FOR LOCATIONS OF LIGHT FIXTURES. BRING ALL DISCREPANCIES OF LOCATIONS AND QUANTITIES TO THE ATTENTION OF THE ARCHITECT PRIOR TO BIDDING. 2. CONFIRM MOUNTING HEIGHTS AND LOCATIONS OF ALL LIGHT FIXTURES WITH ARCHITECTURAL ELEVATIONS AND / OR ARCHITECT. 3. REFER TO THE SPECIFICATIONS FOR OTHER LIGHT FIXTURE REQUIREMENTS.

- 4. CONFIRM AVAILABLE MOUNTING DEPTHS OF ALL LIGHT FIXTURES AND COMPARE WITH DEPTHS SHOWN ON SHOP DRAWINGS. BRING ALL POTENTIAL CONFLICT AREAS TO THE ATTENTION OF THE ARCHITECT AND
- 5. ALL LIGHT FIXTURES ARE TO BE 4000K FOR INTERIOR APPLICATIONS, UNLESS OTHERWISE NOTED IN THE FIXTURE DESCRIPTION. 6. ALL LIGHT FIXTURES ARE TO BE A MINIMUM OF 80 CRI UNLESS OTHERWISE NOTED IN THE FIXTURE DESCRIPTION.
- 8. CONFIRM ALL MOUNTING REQUIREMENTS WITH ARCHITECT PRIOR TO RELEASE.
- 9. ALL LIGHT FIXTURES ARE TO HAVE AN EFFICACY OF 80 LUMENS PER WATT MINIMUM.

- 1. BID ONLY PRODUCTS THAT ARE SPECIFIED OR APPROVED BY ADDENDUM.
- 2. PACKAGING OF LIGHT FIXTURES WITH OTHER SYSTEMS IS NOT ALLOWED AND MUST BE BID SEPARATELY. I.E. LIGHT FIXTURES AND ALL LIGHTING CONTROLS.
- 3. WHEN ONLY ONE PRODUCT IS APPROVED FOR BIDDING, THE PRICE FOR THAT ITEM SHALL BE BROKEN OUT SEPARATELY WHEN SUBMITTING PRICING TO VARIOUS DISTRIBUTORS AND / OR CONTRACTOR. 4. WHEN A CONTRADICTION EXISTS BETWEEN A SPECIFIC MODEL NUMBER AND THE DESCRIPTION, THE DESCRIPTION SHALL GOVERN.

- 2. PRIOR APPROVALS SHALL BE SUBMITTED TO THE ELECTRICAL ENGINEER'S OFFICE AT LEAST (8) WORKING DAYS BEFORE BID TIME. PRIOR APPROVALS RECEIVED AFTER THIS TIME PERIOD SHALL BE REJECTED. 3. ITEMS THAT ARE SUBMITTED AND HAVE BEEN APPROVED WILL BE LISTED IN THE ADDENDUM(S). VERBAL APPROVALS WILL NOT BE GIVEN ON ANY ITEM.

- 6. LIGHTING PACKAGES WILL BE REVIEWED FOR GENERAL PROJECT COMPLIANCE ONLY. AN IN-DEPTH REVIEW OF ANY ALTERNATE FIXTURES WILL BE DONE DURING THE SUBMITTAL REVIEW PROCESS. ANY FIXTURES THAT ARE NOT TRULY EQUAL, AND / OR DO NOT COMPLY WITH ALL OF THE REQUIREMENTS CONTAINED IN THE CONTRACT DOCUMENTS, WILL NOT BE APPROVED. IF EQUIMENT IS DISAPPROVED FOR BIDDING, CONTRACTOR SHALL

	LOW VOLTAGE PUSHBUTTON SCHEDULE											
SWITCH ID	SWITCH CONFIGURATION		B-2	В-3	B-4	B-5	B-6	B-7	В-8	PROGRAMMING NOTES:		
	2-BUTTON SWITCH WITH VACANCY SENSOR	ON	OFF									
	3-BUTTON SWITCH	ON/OFF	RAISE	LOWER								
	2-BUTTON SWITCH	ON	OFF									


Project Information	
Energy Code:	2021 IECC
Project Title:	SLCIA NWS TI
Project Type:	Alteration
Construction Site:	Owner/Agent:
Allowed Interior Lightin	ng Power
Ar	A ea Category
1-Office	
LED: D2: Other: LED: B1: Other:	
LED: D2: Other: LED: R1: Other: LED: Other:	
LED: R1: Other:	
LED: R1: Other: LED: Other: Interior Lighting PASSES Interior Lighting Comp Statement Compliance Statement: The pro- building plans, specifications, ar systems have been designed to applicable mandatory requirement	posed interior lighting alteration pro- nd other calculations submitted with meet the 2021 IECC requirements i ents listed in the Inspection Checklis
LED: R1: Other: LED: Other: Interior Lighting PASSES Interior Lighting Comp Statement Compliance Statement: The pro building plans, specifications, and systems have been designed to	posed interior lighting alteration pr nd other calculations submitted with meet the 2021 IECC requirements i ents listed in the Inspection Checklis

Project Title: SLCIA NWS TI Data filename:

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4. IT IS NOT THE RESPONSIBILITY OF THE ELECTRICAL ENGINEER TO NOTIFY THE SUBMITTING PARTY OF ERRORS IN THE SUBMITTAL. NOTIFICATION OF ERRORS BY THE ELECTRICAL ENGINEER PRIOR TO ISSUANCE OF THE 5. PRIOR APPROVALS SHALL CONSIST OF CUT SHEETS DESCRIBING THE PRODUCTS BEING SUBMITTED AS EQUIVALENTS. ALL SPECIFICATION INFORMATION SHALL BE CLEARLY MARKED. PRODUCTS WITHOUT PHOTOMETRIC

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Report date: 01/30/24 Page 2 of 8

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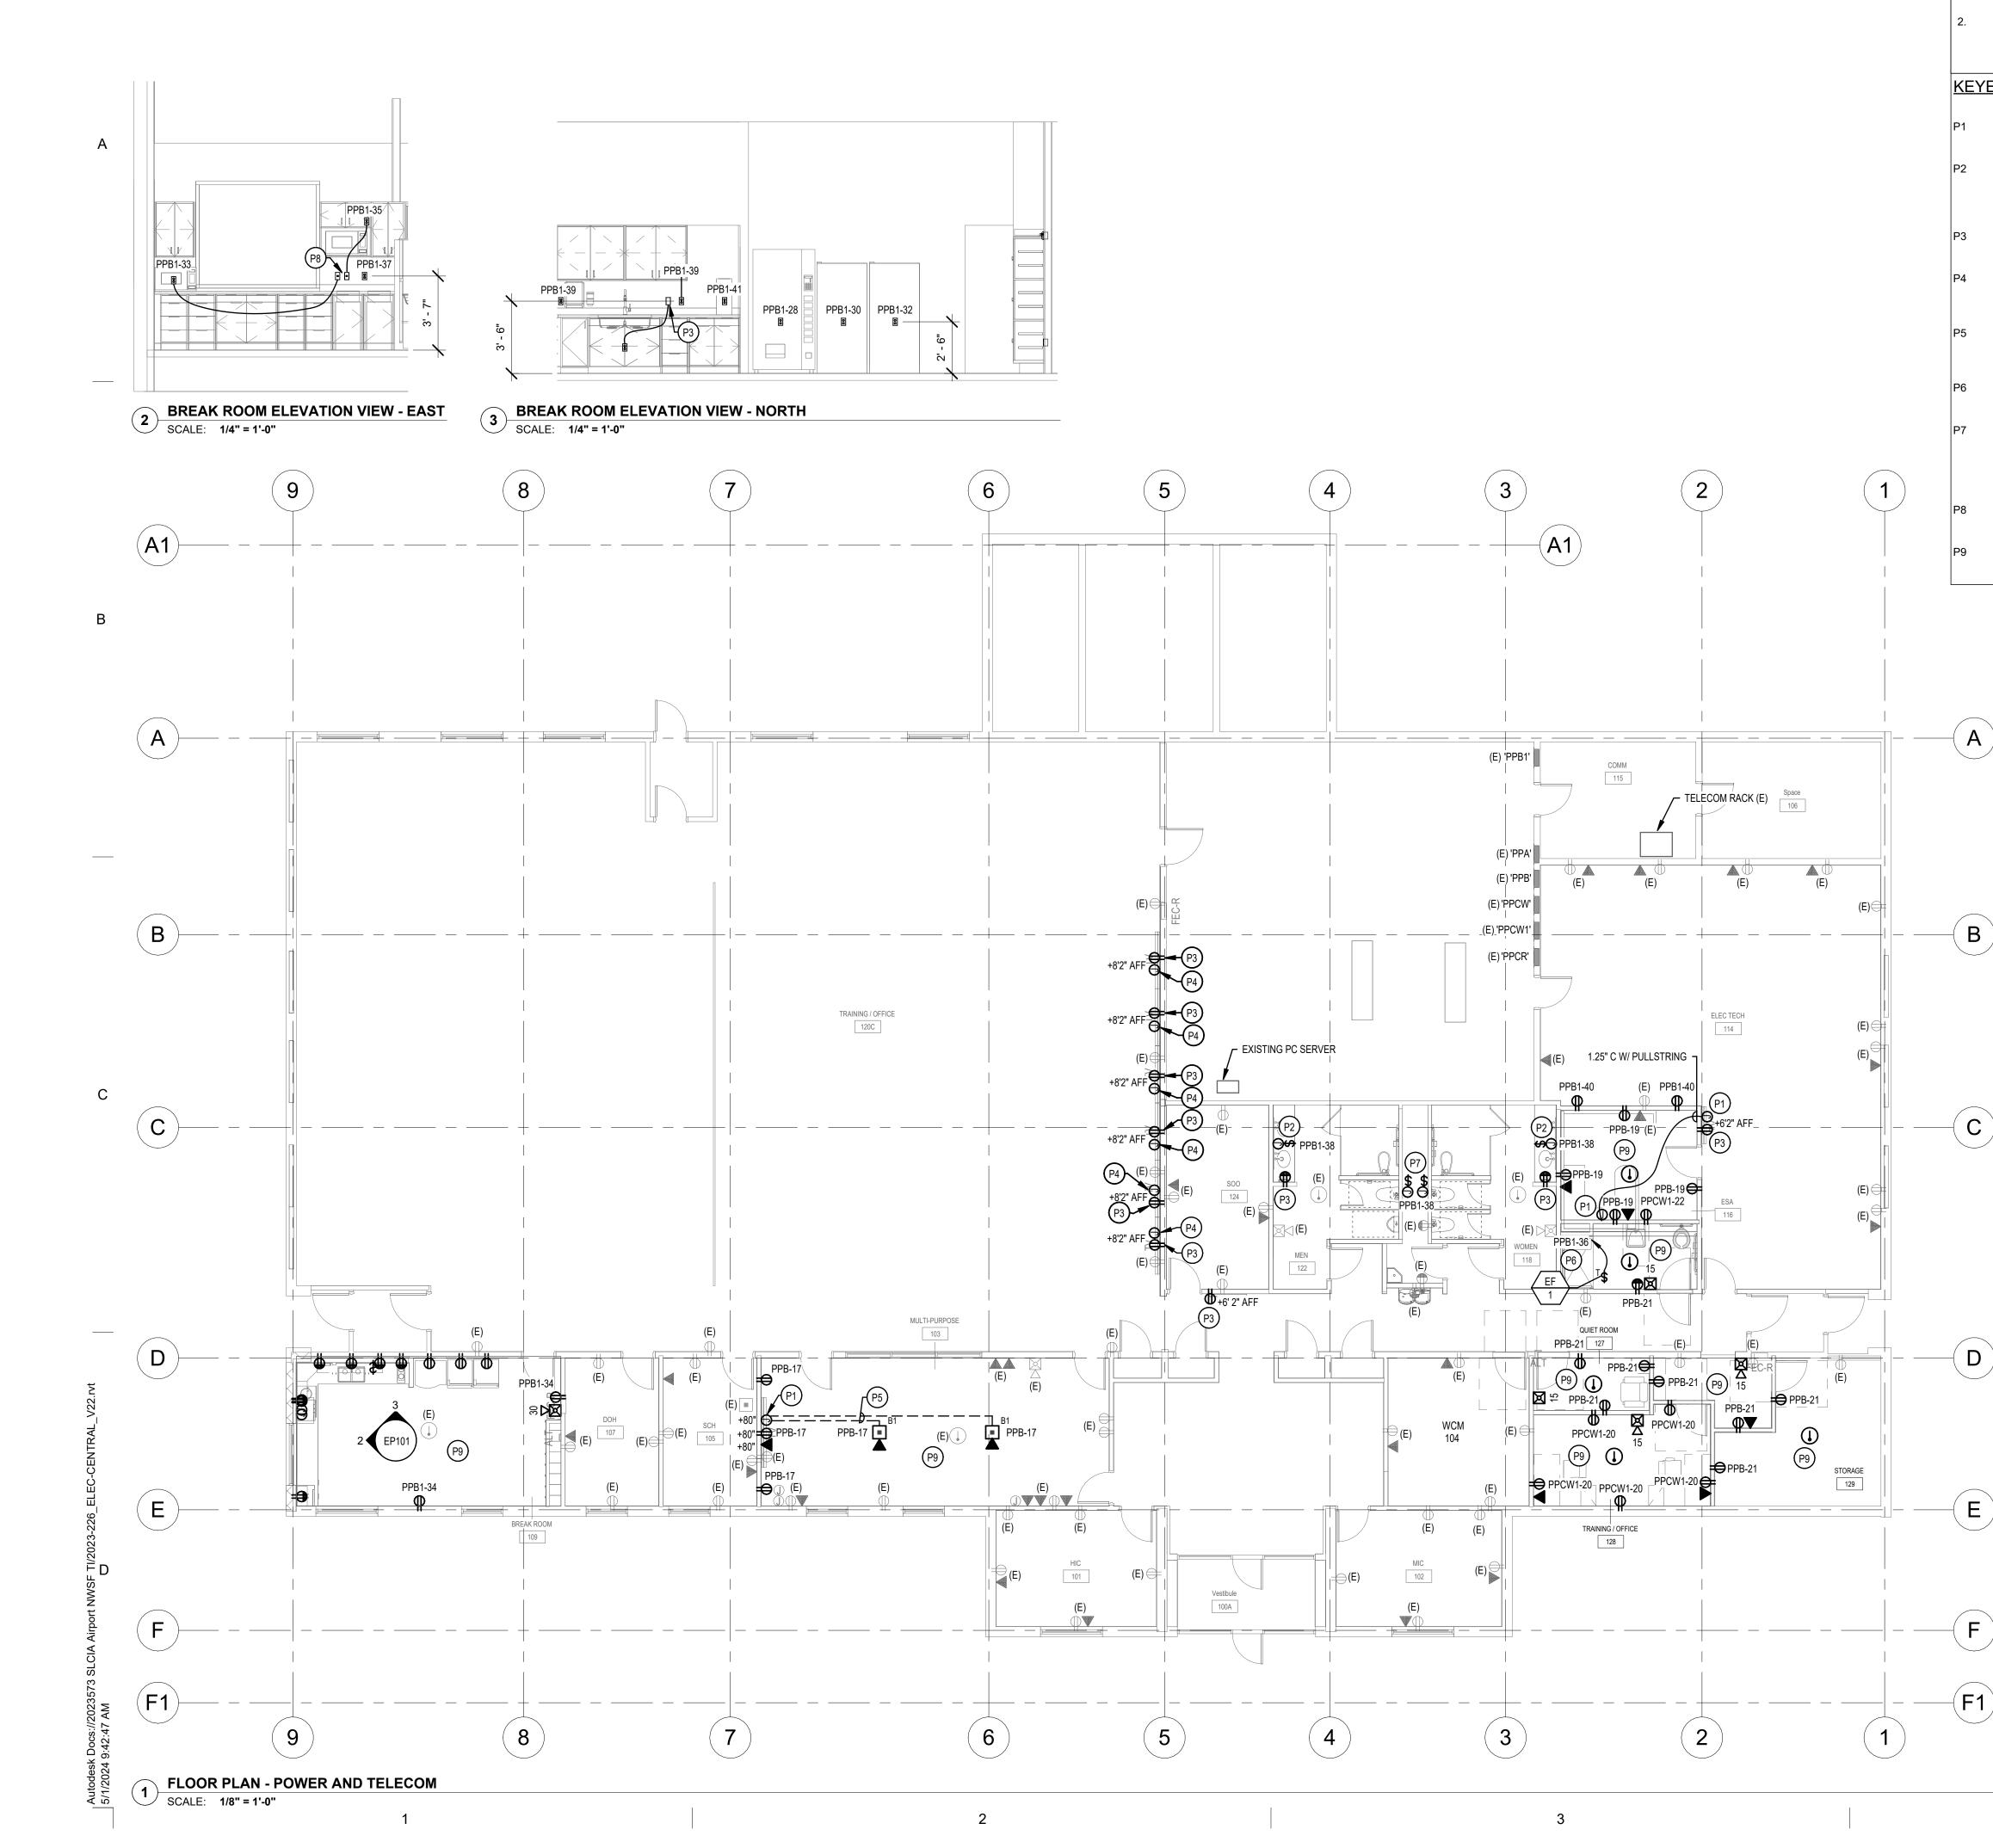
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SHEET NUMBER

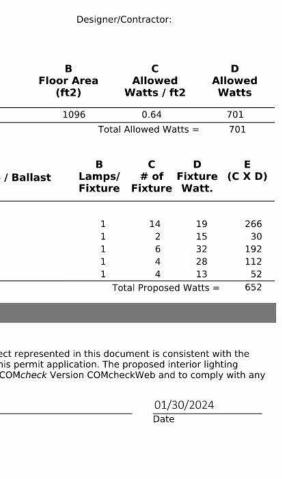WIRING

EL601

DIAGRAMS



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POV	VER GENERAL NOTES:
1.	ALL 120V, 20AMP OUTLETS THAT ARE WITHIN 6' OF ANY SINK SHALL BE GFCI.
2.	THE DIVISION 26 CONTRACTOR SHALL DETERMINE THE EXACT ROUTING OF ALL CONDUITS IN THE FIELD. THIS PLAN REPRESENTS A SCHEMATIC REPRESENTATION OF DEVICE LOCATIONS AND CONDUIT RUNS.
KEYE	D NOTES (#)
P1	PROVIDE JUNCTION BOX WITH SINGLE MUD RING AND COVER PLATE WIT 2" RUBBER GROMMET. SIZE BOX PER NEC.
P2	PROVIDE JUNCTION BOX AND TOGGLE SWITCH (EQUIVALENT TO HUBBEI HBL1221L, 20A, 1-POLE, 120V) FOR AUTO SINK FAUCET. PROVIDE JUNCTIO BOX TO SINK LOCATION. PLUMBING CONTRACTOR SHALL PROVIDE TRANSFORMER AND LOW VOLTAGE WIRING.
P3	TIE TO EXISTING CIRCUIT. EXTEND CONDUIT AND CONDUCTORS AS REQUIRED.
P4	PROVIDE JUNCTION BOX WITH SINGLE MUD RING AND COVER PLATE WIT 2" RUBBER GROMMET EXTEND 1" CONDUIT WITH PULLSTRING FROM JUNCTION BOX TO EXISTING TELECOM RACK.
P5	EXTEND 1.25" CONDUIT WITH PULLSTRING FROM FLOOR BOX TO WALL MOUNTED JUNCTION BOX FOR TV CABLING. SAWCUT EXISTING SLAB AS REQUIRED, REFER TO ARCHITECTURAL PLANS FOR MORE INFORMATION
P6	EXHAUST FAN SHALL BE CONTROLLED WITH THE LIGHTS IN THIS SPACE. RUN BRANCH CIRCUIT CONDUCTORS THROUGH LIGHTING CONTROLS.
P7	PROVIDE JUNCTION BOX AND TOGGLE SWITCH (EQUIVALENT TO HUBBEI HBL1221L, 20A, 1-POLE, 120V) FOR AUTO URINALS AND WATER CLOSETS PROVIDE JUNCTION BOX IN THE LOCATION SHOWN. PLUMBING CONTRACTOR SHALL PROVIDE TRANSFORMER AND LOW VOLTAGE WIRING.
P8	PROVIDE BLANK FACE GFCI FOR PROTECTING MICROWAVE RECEPTACLI PROVIDE LABEL "MW GFCI".
P9	RE-USE EXISTING CONDUIT AND CONDUCTORS WHEREVER POSSIBLE IN THE SPACE. EXTEND NEW CONDUIT AND BRANCH CIRCUIT WIRING AS REQUIRED.

4

MHTN ARCHITECTS OF DESIG MHTN Architects, Inc. 280 South 400 West Suite 250 Salt Lake City, Utah 84101 Telephone (801) 595-6700 www.mhtn.com 240 E. MORRIS AVE. SUITE 200 SALT LAKE CITY, UT 84115

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ALEKSANDAR RANKOVIC

02/19/2024

MHTN PROJECT NO.2023573

ISSUED:

SET

MAY 02, 2024

NO. DATE

Original drawing is 24 x 36. Do not scale contents of this draw

DESCRIPTION

REVISIONS CONTRACTOR TO VERIFY DRAWINGS IN FIELD USE REFLECT LAST REVISION DATE.

**GONSTRUCTION DOCUMENTS - BID** 

NO. DATE DESCRIPTION


( **A** )

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E FLOOR PLAN -POWER AND SYSTEMS






# Autodesk Docs://2023573 SLCIA Airport NWSF TI/2023-226\_ELEC-CENTRAL\_V22.1 5/1/2024 9:42:49 AM
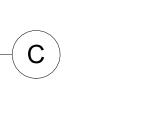
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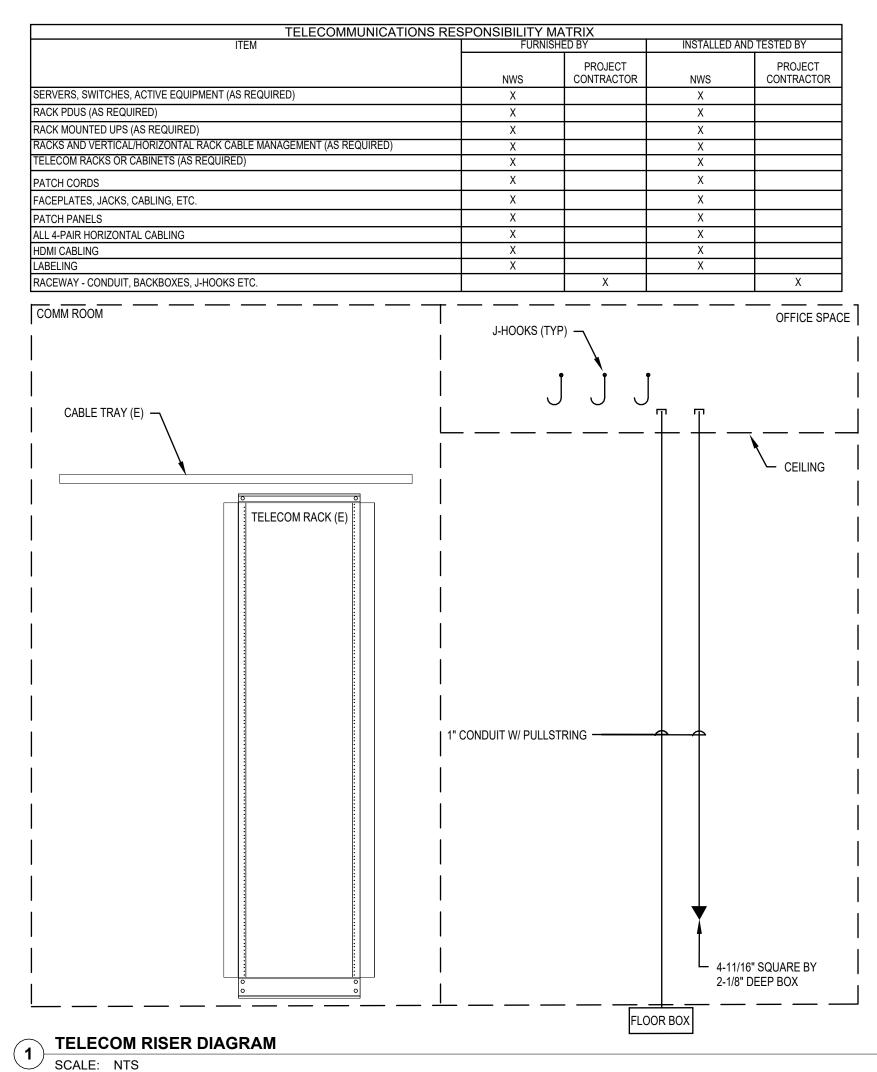
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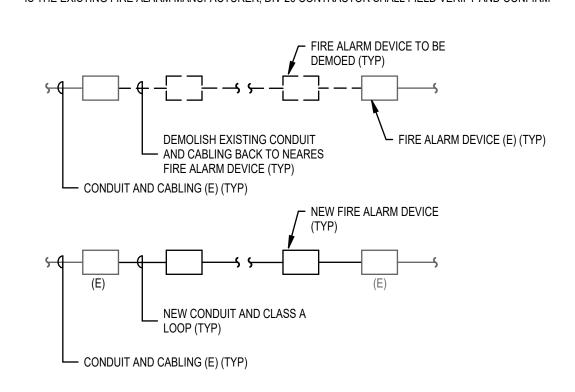
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FIRE ALARM RISER DIAGRAM 2

SCALE: NTS



TO PROVIDE THE INTENT OF FIRE ALARM SYSTEM TO BE PROVIDED. ALL NEW FIRE ALARM DEVICES SHALL MATCH THE EXISTING FIRE ALARM SYSTEM MANUFACTURER.SIMPLEX 6. IS THE EXISTING FIRE ALARM MANUFACTURER, DIV 26 CONTRACTOR SHALL FIELD VERIFY AND CONFIRM

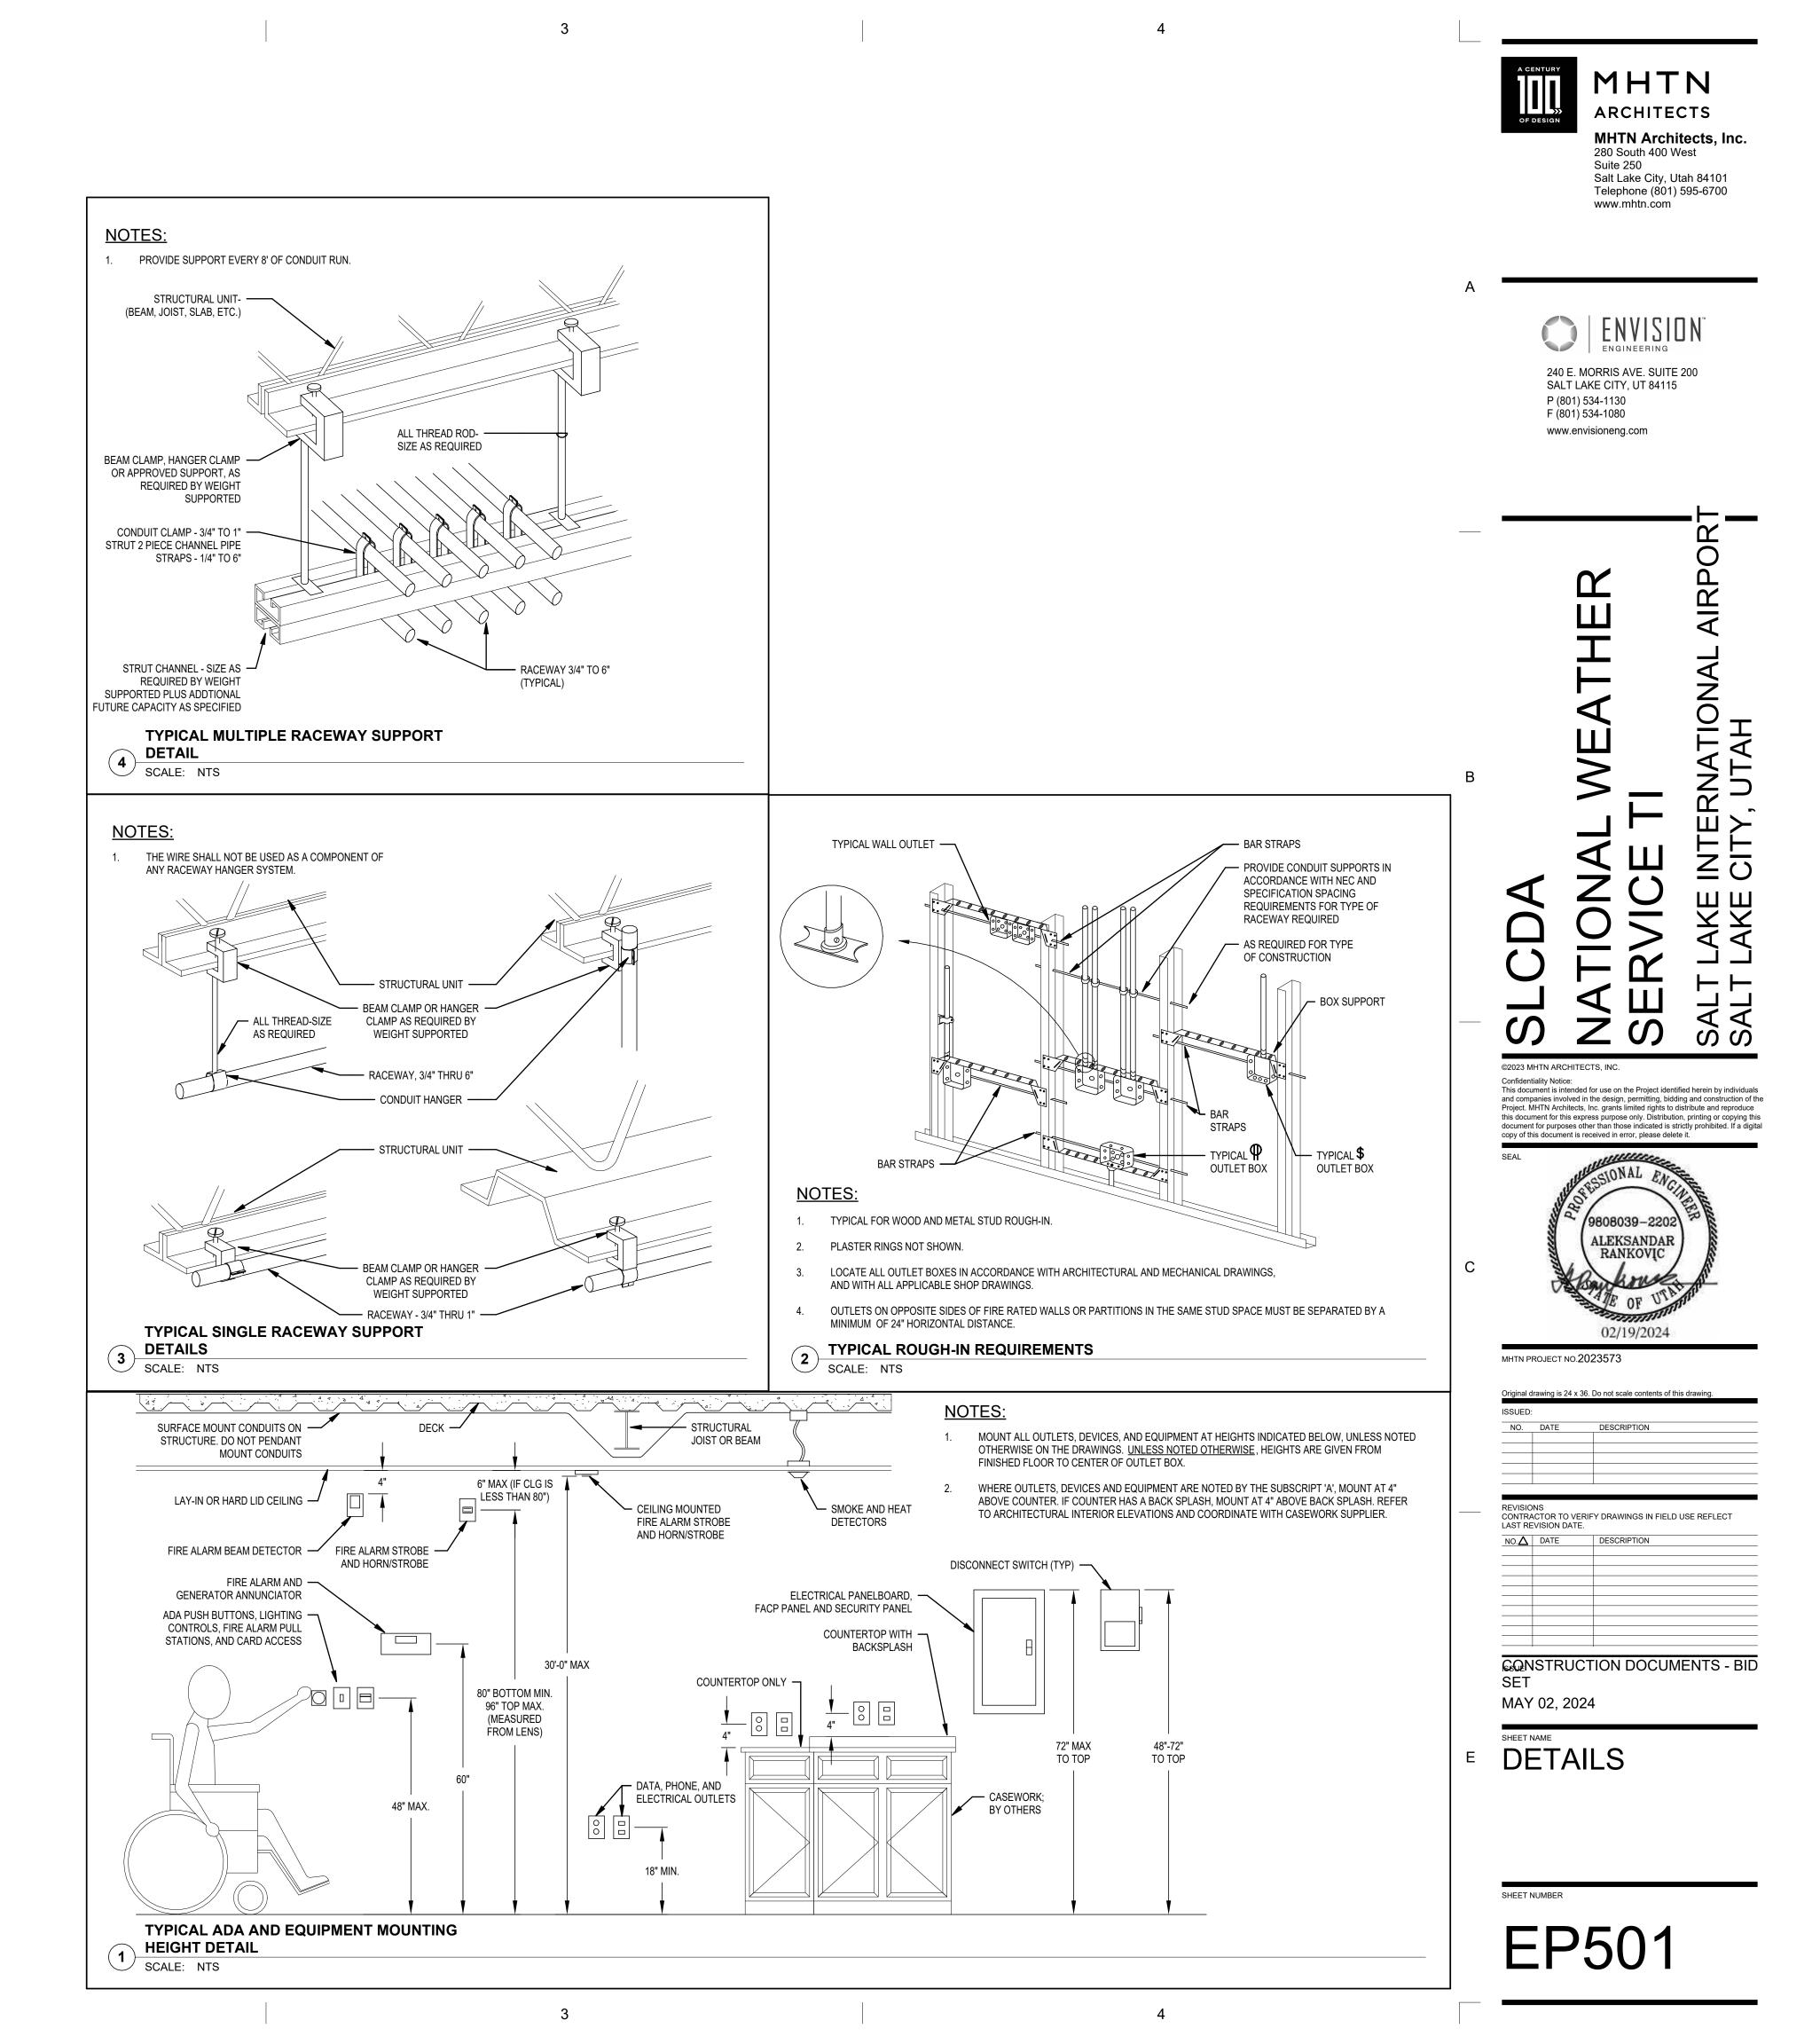- 12" WHERE RUN VERTICALLY AND 48" WHERE RUN HORIZONTALLY. ALL FIRE ALARM DEVICE LOCATIONS, RISER DIAGRAM ETC. ARE SCHEMATIC IN NATURE AND ARE SHOWN 5.
- MANF. CUT SHEETS, CALCULATIONS, AND DRAWINGS. WHEN UTILIZING CLASS A CIRCUITS, SEPERATE OUTGOING AND RETURN CONDUCTORS BY A MINIMUM OF 4.

3

- PROVIDE UPDATED FIRE ALARM MAPS OF THE BUIDING SHOWING ALL FIRE ALARM DEVICES. SUBMIT TO LOCAL AUTHORITY HAVING JURISDICTION, A MINIUM OF TWO SETS OF PLANS, COMPLETE WITH
- **GENERAL NOTES:** WIRING SHALL BE CONTINOUS FROM ONE DEVICE TO ANOTHER, SPLICING IS NOT ALLOWED.

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EP60 <sup>2</sup>	1
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DIAGRAMS

### LOCATIONS ONLY. REFER TO CONDUIT SIZING SCHEDULE FOR ADDITIONAL INFORMATION. FLEXIBLE METALLIC AND FLEXIBLE NONMETALLIC CONDUIT ARE PROHIBITED. PATHWAYS SUPPORT PATHWAYS MUST HAVE ADEQUATE SUPPORT TO WITHSTAND PULLING THE CABLES.

- COMPONENT OF THE SUSPENDED CEILING.

4

- PATHWAYS SHOULD BE INSTALLED AT LEAST 3" OF CLEAR VERTICAL SPACE ABOVE THE CEILING TILES AND T-BARS TO ENSURE ACCESSIBILITY, AND SHOULD AT NO POINT REST OR BE SUPPORTED BY ANY

- PROVIDE CADDY CAT HP OR EQUIVALENT J-HOOKS WITH MIN SPACING OF 5' OFF CENTER.

- CONDUIT SEGMENTS SHALL NOT EXCEED 100' WITHOUT A PULL POINT. CONDUIT RUNS SHOULD BE LIMITED TO LESS THAN 150' ALL CONDUITS SHALL BE EQUIPPED WITH A PULL CORD THAT HAS A MINIMUM RATING OF 200LBS. CONDUIT SHALL BE SIZED PER ANSI/TIA/EIA 569-B, WITH A MINIMUM SIZE OF 1". SEE CONDUIT SIZING SCHEDULE FOR EXACT SIZES REQUIRED. ALL HORIZONTAL CABLING CONDUIT RUNS SHALL BE SINGLE CONTINUOUS RUNS FROM THE VOICE/DATA

OUTLET TO THE NEAREST ACCESSIBLE CEILING SPACE. JUNCTION BOXES ARE ALLOWED IN ACCESSIBLE

- REFER TO DRAWINGS AND SPECIFICATIONS FOR ALL OUTLET/DEVICE INSTALLATION REQUIREMENTS AND LOCATIONS. ACCEPTABLE CONDUIT RUNS MUST NOT HAVE A BEND OVER 90 DEGREES OR AN AGGREGATE OF BENDS IN EXCESS OF 180 DEGREES BETWEEN PULL POINTS.
- ALL PENETRATIONS THROUGH FIRE RATED WALL SHALL BE PROVIDED WITH FIRE RATED PATHWAYS, PUTTY PADS AND FIRE CAULKING SUCH THAT THE WALL RAITING IS MAINTAINED. SEE SPECIFICATIONS FOR ADDITIONAL REQUIREMENTS.
- <u>GENERAL</u> CONDUITS THAT ENTER A TELECOM ROOM SHOULD TERMINATE NEAR THE CORNERS TO ALLOW FOR PROPER RACKING. ALL PATHWAYS MUST NOT EXCEED 295' FROM THE TELECOM RACK TO THE DATA OUTLET.
- <u>COORDIANTION</u> CONTRACTOR SHALL CONDUCT A PRE-CONSTRUCTION MEETING WITH OWNER'S REPRESENTATIVES AND ELECTRICAL ENGINEER PRIOR TO BEGINNING ANY WORK OR PURCHASING ANY EQUIPMENT.

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TELECOMMUNICATIONS GENERAL NOTES AND GUIDELINES:



RANKOVIC

02/19/2024

Original drawing is 24 x 36. Do not scale contents of this drawing.

DESCRIPTION

REVISIONS CONTRACTOR TO VERIFY DRAWINGS IN FIELD USE REFLECT

**GONSTRUCTION DOCUMENTS - BID** 

MHTN PROJECT NO.2023573

ISSUED:

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SET

MAY 02, 2024

RISER

SHEET NAME

SHEET NUMBER

NO. DATE

LAST REVISION DATE.

NO. DATE DESCRIPTION

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					PA	NE	LBC	DAR	DS	CHE	EDU	LE					
	PANEL NA		PP	CW							CATION: S	Space	130			F	EED F
	MOUNTING: RECESSED	)			VC	DLTAGE: 1	120/208 \	Nye		MA	IN TYPE:						
	ENCLOSURE: NEMA 1					PHASE: 3	-				RATING:					NEUTR	
	DOOR TYPE:					WIRES: 4					RATING:					ISOLATE	D GRO
				Min.	A.I.C.	RATING: 2	22,000			BUS MA	TERIAL:				-		
							BF	RANCH I	BREAK	<b>ERS</b>							
KEYED NOTE	CIRCUIT DESCRIPTION	AMP	POLE	Load Type		A	<b>\</b>		В		C	СКТ #		POLE	АМР	CIRC	CUIT D
	EXISTING LOAD	20 A	3		1	0 VA	0 VA					2		3	30 A	EXISTING	G LOAD
					3			0 VA	0 VA			4					
					5					0 VA	0 VA	6					
	EXISTING LOAD	30 A	3		7	0 VA	0 VA					8		3	20 A	EXISTING	G LOAD
					9			0 VA	0 VA			10					
					11					0 VA	0 VA	12					
	EXISTING LOAD	20 A	3		13	0 VA	0 VA					14		1	20 A	EXISTING	g load
					15			0 VA	0 VA			16		1	20 A	EXISTING	g load
					17					0 VA	0 VA	18		1	20 A	EXISTING	G LOAE
	EXISTING LOAD	30 A	3		19	0 VA	900 VA					20	R	1	20 A	R:TRAINI	NG 128
					21			0 VA	180 VA	<b>\</b>		22	R	1	20 A	R: ESA 1	16
					23					0 VA	0 VA	24		1	20 A	-SPARE-	
	TOTAL CONNECT				• •		VA	180	D VA	0	VA						
	TOTAL CONNECTED CU	RRENT F	PER PH	ASE (	AMPS)	8.	A	2	2 A	0	А						
TYPE	LOAD CLASSIFICATION			CC	ONNEC	TED LOAI	D DE	MAND FA	CTOR	ESTIMAT	ED DEMAN	1D				PANEL	TOTAL
Р	Panel				0	VA		0.00%		0	VA						
R	Receptacle				108	80 VA		100.00%	6	108	30 VA			Тс	tal Co	nn. Load:	1080 \
L	Lighting				0	VA		0.00%		0	VA		25%	OF LA	RGEST	MOTOR:	
С	Continuous				0	VA		0.00%		0	VA			Tot	al Est.	Demand:	1080 \
E	Equipment				0	VA		0.00%		0	VA			Tota	Conn	. Current:	3 A
м	Motor				0	VA		0.00%		0	VA		Tota	Est. D	emano	d Current:	3 A
К	Kitchen				0	VA		0.00%		0	VA						
0	Other				0	VA		0.00%		0	VA						

					PA	NE	LBC	)AR	DS	CHE	EDU	LE					
	PANEL NA	ME:	PP	<b>B1</b> (E	EXISTING	G SQUARE D	) PANELBAC	DRD)		LO	CATION:	Space	130		,	FEED FROM:	
	MOUNTING: RECESSED	)			VC	OLTAGE:	120/208 W	Vye		MA	IN TYPE:					SPD:	
	ENCLOSURE: NEMA 1					PHASE:	3			BUS	RATING:					NEUTRAL RATING:	
	DOOR TYPE:					WIRES:	4			MCB	RATING:					ISOLATED GROUND:	
				Min.	A.I.C.	RATING:	22,000			BUS MA	TERIAL:						
							BR	ANCH E	BREAKE	ERS							
KEYED				Load	СКТ							СКТ	Load				KEYED
NOTE	CIRCUIT DESCRIPTION	AMP	POLE	Туре	#		4	E	3		0	#			AMP	CIRCUIT DESCRIPTION	NOTE
	EXISTING LOAD	20 A	1		1	0 VA	0 VA					2		1	20 A	EXISTING LOAD	
	EXISTING LOAD	20 A	1		3			0 VA	0 VA			4		1	20 A	EXISTING LOAD	
	EXISTING LOAD	20 A	1		5					0 VA	0 VA	6		1	20 A	EXISTING LOAD	
	EXISTING LOAD	20 A	1		7	0 VA	0 VA					8		1	20 A	EXISTING LOAD	
	EXISTING LOAD	20 A	1		9			0 VA	0 VA			10		1	20 A	EXISTING LOAD	
	EXISTING LOAD	20 A	1		11					0 VA	0 VA	12		1	20 A	EXISTING LOAD	
	EXISTING LOAD	20 A	1		13	0 VA	0 VA					14		1	20 A	EXISTING LOAD	
	EXISTING LOAD	20 A	1		15			0 VA	0 VA			16		1	20 A	EXISTING LOAD	
	EXISTING LOAD	20 A	1		17					0 VA	0 VA	18		1	20 A	EXISTING LOAD	
	EXISTING LOAD	20 A	1		19	0 VA	0 VA					20		1	20 A	EXISTING LOAD	
	EXISTING LOAD	20 A	1		21			0 VA	0 VA			22		1	20 A	EXISTING LOAD	
	EXISTING LOAD	20 A	1		23					0 VA	0 VA	24		1	20 A	EXISTING LOAD	
	-SPARE-EXISTING LOAD	20 A	1		25	0 VA	0 VA					26		1	20 A	EXISTING LOAD	
	EXISTING LOAD	20 A	1		27			0 VA	1200 VA			28	K	1	20 A	K:VENDING MACHINE	1,2
	EXISTING LOAD	20 A	1		29					0 VA	1200 VA	30	K	1	20 A	K:FRIDGE	1
	-SPACE ONLY-		1		31		1200 VA					32	K	1	20 A	K:FRDIGE	1
1	K:MW	20 A	1	K	33			1500 VA	360 VA			34	R	1	20 A	R:BREAK ROOM 109	1
1	K: BREAK ROOM 109	20 A	1	K	35					1500 VA	1176 VA	36	М	1	20 A	EF-1	1
1	K: BREAK ROOM 109	20 A	1	K	37	1500 VA	200 VA					38	E	1	20 A	E:AUTOMATIC FAUCETS	1
1	K: BREAK ROOM 109	20 A	1		39			1680 VA	360 VA			40	R	1	20 A	R:ELEC TECH 114	1
1	K: BREAK ROOM 109	20 A	1		41					1500 VA		42		1		-SPACE ONLY-	
	TOTAL CONNECT	ED LOA	D PER	PHAS	E (VA)	290	0 VA	510	O VA	537	6 VA						
	TOTAL CONNECTED CU	RRENT P	ER PH	IASE (	AMPS)	24	I A	45	δA	48	3 A						
							-					-					

TYPE	LOAD CLASSIFICATION	CONNECTED LOAD	DEMAND FACTOR	ESTIMATED DEMAND	PANEL	TOTALS
Р	Panel	0 VA	0.00%	0 VA		
R	Receptacle	900 VA	100.00%	900 VA	Total Conn. Load:	13376 VA
L	Lighting	0 VA	0.00%	0 VA	25% OF LARGEST MOTOR:	
С	Continuous	0 VA	0.00%	0 VA	Total Est. Demand:	9785 VA
E	Equipment	200 VA	100.00%	200 VA	Total Conn. Current:	37 A
М	Motor	1176 VA	125.00%	1470 VA	Total Est. Demand Current:	27 A
К	Kitchen	11100 VA	65.00%	7215 VA		
0	Other	0 VA	0.00%	0 VA		

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	UNIT NA	ME		ELECT	RICAL INPUT			FEEDER	IRE	STAF	RTER / DISC			CTION AT UNIT	-		
		No.	DESCRIPTION		PE VOLTS PH			QTY SIZE	EQPT G		SIZE	SIZE	POLES	SIZE POLES			REMARKS
						1 9.8 A	1 3/4"	2 12	12	1A	1HP	NA N	NA	1HP 1	NEMA 1		
	1. MA 2. MA FOI 3. CO 4. CO 5. CO 6. REI 7. CO 8. CO 9. NO 10. FUS <b>GENE</b> 1. CO SUI 2. ALL 3. ELE 4. ELE	NUAL STA NUAL STA R ATC CO MBINATIC MBINATIC DUCED V( MBINATIC DUCED V( MBINATIC DUCED V( MBINATIC DUCED V( MBINATIC DUCED V( MBINATIC MBI	ISCONNECT/CONNECTION ARTER WITH THERMAL OVERLOAD ARTER WITH THERMAL OVERLOAD ARTER WITH THERMAL OVERLOAD INTROL. IN MAGNETIC STARTER / FUSED DISON MAGNETIC STARTER / MOTOR CONNECT STARTER / MOTOR CONNECT STARTER / FUSED DISONNECT SWITCH ON TWO-SPEED STARTER / MOTOR DISCONNECT SWITCH ONNECT SWITCH ONNECT SWITCH ISCONTRACTOR SHALL BE COPPER. CONTRACTOR SHALL REVIEW MED CONTRACTOR SHALL REVIEW OTH SES IN ACCORDANCE WITH MANUF	PROTECTION & I SCONNECT IRCUIT PROTEC MOTOR CIRCUIT DISCONNECT CIRCUIT PROTE ORDINATE AND S CHANICAL DRAW	LOW VOLTAGE TOR (MCP) PROTECTOR (N CTOR (MCP) SIZE FEEDER, S VINGS FOR ANY MITTALS FOR A	MCP) TARTER, DI ADDITIONA NY EQUIPM	NTACTOR 12 13 14 15 16 17 18 19 SCONNECT AND	S PRIOR TO B	NECTION CEPTACLE RPOSE OU DISCONN ITCH TARTER ATOR SW RLY-BREA OL WIRIN LAY.	E OUTLET JTLET JECT /ITCH AKER RELJ IG BETWE	AY EN ACCORDAN	3. FURNIS UNDER C. FURNIS DIVISIO D. FURNIS E. FURNIS	Shed & Divisio Shed Ui DN 26 Shed, In Shed By	INSTALLED UNE ON 26 NDER ANOTHEF NSTALLED & CO Y OWNER, INST/		ON REQUIRIN	ONNECTED UNDE ON 26
<b>E</b> ce 130 <b>FEED FROM</b> :					DEVICE						OR BOX						
SPD: NEUTRAL RATING: ISOLATED GROUND:				B1	4-GANG	(1) 3/4" C FOF (1) 1" C FOR (1) 1.25" C FC	DATA DR AV CONDUIT STUBBED <sup>-</sup>	DUPLEX	G2 DATA		G4 G8 ARE	G6	LEGR	NUFACTURER RAND (OR ROVED EQUAL)	CAT. # (OR APPROV EFB45S	ED EQUAL)	COMMENT ARCHITECT TO SELE FINISH
KT Load # Type POLE AMP CIRCUIT DESCRIPT		KEYED NOTE						1			1						
2 3 30 A EXISTING LOAD	-																
3 20 A EXISTING LOAD																	
) 2																	
2 4 1 20 A EXISTING LOAD																	
6 1 20 A EXISTING LOAD																	
8          1         20 A         EXISTING LOAD           0         R         1         20 A         R:TRAINING 128		3															
20         R         1         20 A         R. INAIMING 128           22         R         1         20 A         R: ESA 116		3															
24 1 20 A -SPARE-																	
PANEL TOTALS																	
Total Conn. Load: 1080 VA			PANELBOARD SCHEDULE	EYED NOTE:													
25% OF LARGEST MOTOR: Total Est. Demand: 1080 VA			1. PROVIDE NEW BREAK					G PANELBOAF	RD.								
Total Conn. Current: 3 A			2. PROVIDE CLASS A GR 3. UTILIZE EXISTING BRE		TERRUPTER TY	PE CIRCUIT	BREAKER.										
Total Est. Demand Current: 3 A																	
Total Est. Demand Current: 3 A			3. UTILIZE EXISTING BRE	IANER													
		I															

EXISTING LOAD

EXISTING LOAD

EXISTING LOAD

								-		-			_
					<b>P</b> A	NE	LBC	DAR	<u>D S</u>	CHE	<u>EDU</u>	<u>ILE</u>	•
	PANEL NA	ME:	: PP	<b>B</b> (EX	ISTING	SQUARE D P	PANELBAOF	RD)		LO	CATION:	Space	13
	<b>MOUNTING:</b> RECESSED	5			V	OLTAGE:	120/208 V	Vye		MA	IN TYPE:		
	ENCLOSURE: NEMA 1					PHASE:	3	•		BUS	RATING:		
	DOOR TYPE:					WIRES:	4			MCB	RATING:		
				Min.	A.I.C.	RATING:	22,000			BUS MA	TERIAL:		
							BR	ANCH B	REAK	ERS			
KEYED NOTE		AMP	POLE	Load Type	СКТ #		4	E	3		C	CKT #	L T
	EXISTING LOAD	20 A	1		1	0 VA	0 VA					2	
	EXISTING LOAD	20 A	1		3			0 VA	0 VA			4	
	EXISTING LOAD	20 A	1		5					0 VA	0 VA	6	
	EXISTING LOAD	20 A	1		7	0 VA	0 VA					8	
	EXISTING LOAD	20 A	1		9			0 VA	0 VA			10	
	EXISTING LOAD	20 A	1		11					0 VA	0 VA	12	
	EXISTING LOAD	20 A	1		13	0 VA	0 VA					14	
	EXISTING LOAD	20 A	1		15			0 VA	0 VA			16	
3	R:MULTI-PURPOSE 103	20 A	1	R	17					900 VA	0 VA	18	
3	R:ESA 116	20 A	1	R	19	720 VA	0 VA					20	
3	R:110,127	20 A	1	R	21			2460 VA	0 VA			22	
	EXISTING LOAD	20 A	1		23					0 VA	0 VA	24	
	EXISTING LOAD	20 A	1		25	0 VA	0 VA					26	
	EXISTING LOAD	20 A	1		27			0 VA	0 VA			28	
	EXISTING LOAD	20 A	1		29					0 VA	0 VA	30	
	EXISTING LOAD	20 A	1		31	0 VA	0 VA					32	
	EXISTING LOAD	20 A	1		33			0 VA	0 VA			34	
	EXISTING LOAD	20 A	1		35					0 VA	0 VA	36	
		00.4			07	0.144	0.1/4					00	1

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TOTAL CONNECTED LOAD PER PHASE (VA) 720 VA TOTAL CONNECTED CURRENT PER PHASE (AMPS) 6 A

TYPE	LOAD CLASSIFICATION	CONNECTED LOAD	DEMAND FACTOR	ESTIMATED DEMAND	
Р	Panel	0 VA	0.00%	0 VA	
R	Receptacle	2880 VA	100.00%	2880 VA	
L	Lighting	0 VA	0.00%	0 VA	
С	Continuous	0 VA	0.00%	0 VA	
E	Equipment	0 VA	0.00%	0 VA	
м	Motor	0 VA	0.00%	0 VA	
ĸ	Kitchen	1200 VA	100.00%	1200 VA	
0	Other	0 VA	0.00%	0 VA	

20 A 1 -- 37 0 VA 0 VA

20 A 1 -- 39

20 A 1 -- 41

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	5	-		
		FI	-	
		NEUTRA		
		-	-	
-1				
		CIRC		KEYED NOTE
1				NOTE
1				
1				
1	20 A	EXISTING	G LOAD	
1	20 A	EXISTING	S LOAD	
1	20 A	EXISTING	S LOAD	
1	20 A	EXISTING	G LOAD	
1	20 A	EXISTING		
1 1		EXISTING		
-	20 A		LOAD	
1 1 1	20 A 20 A 20 A	EXISTING EXISTING EXISTING	G LOAD G LOAD G LOAD	
1 1 1 1	20 A 20 A 20 A 20 A	EXISTING EXISTING EXISTING EXISTING	G LOAD G LOAD G LOAD G LOAD	
1 1 1 1 1 1	20 A 20 A 20 A 20 A 20 A	EXISTING EXISTING EXISTING EXISTING EXISTING	G LOAD G LOAD G LOAD G LOAD G LOAD	
1 1 1 1 1 1 1 1 1	20 A 20 A 20 A 20 A 20 A 20 A	EXISTING EXISTING EXISTING EXISTING EXISTING EXISTING	G LOAD G LOAD G LOAD G LOAD G LOAD G LOAD	
1 1 1 1 1 1 1 1 1 1	20 A 20 A 20 A 20 A 20 A 20 A 20 A	EXISTING EXISTING EXISTING EXISTING EXISTING EXISTING	S LOAD S LOAD S LOAD S LOAD S LOAD S LOAD S LOAD S LOAD	
1 1 1 1 1 1 1 1 1 1 1	20 A 20 A 20 A 20 A 20 A 20 A 20 A 20 A	EXISTING EXISTING EXISTING EXISTING EXISTING EXISTING EXISTING	G LOAD G LOAD G LOAD G LOAD G LOAD G LOAD G LOAD G LOAD G LOAD	
1 1 1 1 1 1 1 1 1 1 1 1	20 A 20 A 20 A 20 A 20 A 20 A 20 A 20 A	EXISTING EXISTING EXISTING EXISTING EXISTING EXISTING EXISTING EXISTING	S LOAD S LOAD S LOAD S LOAD S LOAD S LOAD S LOAD S LOAD S LOAD S LOAD	
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1 1 1 1 1 1 1 1 1 1 1 1	20 A 20 A 20 A 20 A 20 A 20 A 20 A 20 A	EXISTING EXISTING EXISTING EXISTING EXISTING EXISTING EXISTING EXISTING	G LOAD G LOAD	
	1 1 1 1 1 1 1 1	d         POLE         AMP           1         20 A           1         20 A	d eDescription0POLEAMP120 AEXISTING120 AEXISTING	ePOLEAMPCIRCUIT DESCRIPTION120 AEXISTING LOAD120 AEXISTING LOAD

0 VA 0 VA 42

900 VA

8 A

0 VA 0 VA

2460 VA

21 A

38

40

25% OF LARGEST MOTOR:

Total Est. Demand: 4080 VA Total Conn. Current: 11 A Total Est. Demand Current: 11 A

