


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VICINITY MAP:

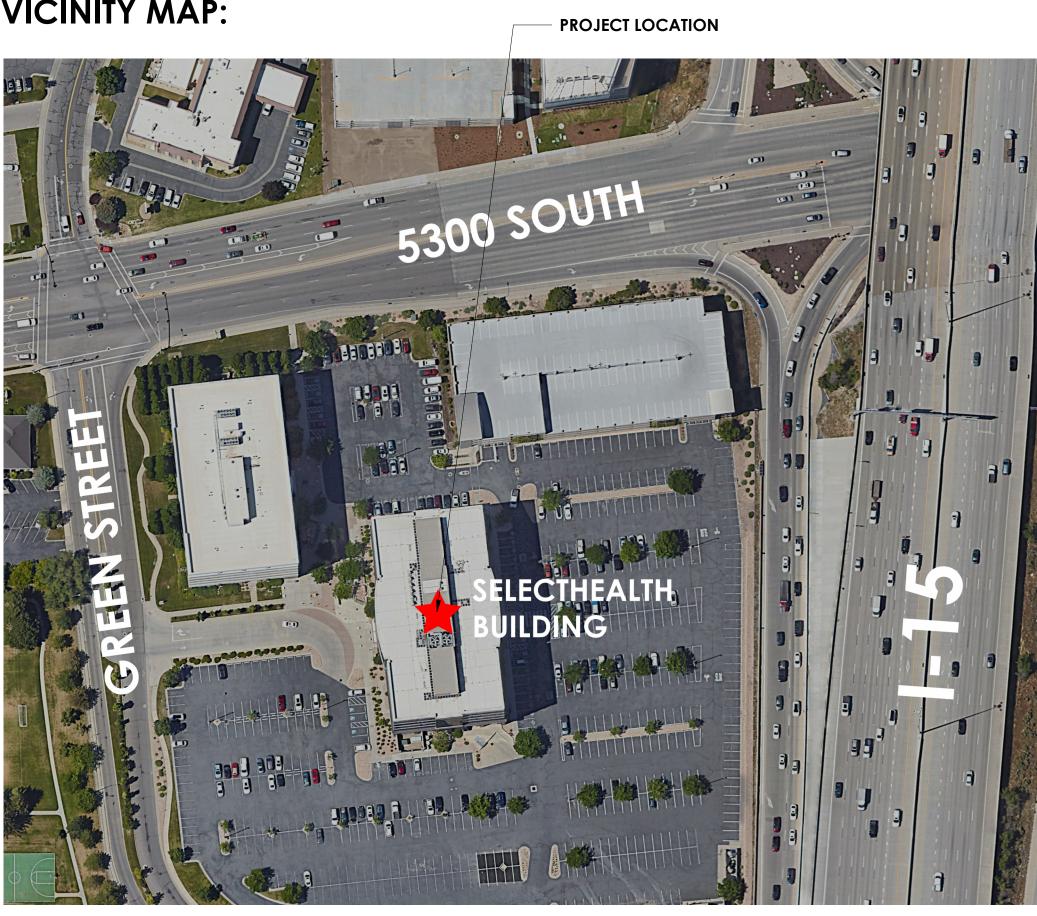

# SELECTHEALTH BUILDING TENANT IMPROVEMENT **BID SET**

**OWNER** | SELECT HEALTH

ARCHITECT

**MECHANICAL/PLUMBING** | SPECTRUM ENGINEERS

# 5381 S GREEN STREET MURRAY, UT 84123



ARCHITECT / CONSULTANT



PROJECT DESCRIPTION

## SELECTHEALTH BUILDING **TENANT IMPROVEMENT**

5381 S GREEN STREET **MURRAY, UT 84123** 

SHEET NAME:

## **COVER SHEET**

REVISIONS MARK DATE DESCRIPTION

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ISSUE DATE: ISSUE TYPE: DRAWN BY: CHECKED BY: PROJECT#:

08/17/2023 BID SET J. HALBERT R. OLSON 2023-15



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	TA601	AUDIO VISUAL SYSTEMS RISER DIAGRAMS
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# **GENERAL NOTES:**

- THE GENERAL CONTRACTOR SHALL HEREAFTER BE REFERRED TO AS "GENERAL CONTRACTOR" OR "GC". THE OWNER MAY HEREAFTER BE REFERRED TO AS "OWNER".
- THE GENERAL CONTRACTOR IS RESPONSIBLE FOR ALL WORK REGARDLESS OF THE LOCATION OF THE INFORMATION IN THE DOCUMENTS. THE GENERAL CONTRACTOR SHALL UTILIZE THE COMPLETE & ENTIRE CONSTRUCTION DRAWINGS AND WRITTEN SPECIFICATIONS FOR ALL REQUIRED INFORMATION TO PROVIDE COMPLETE CONSTRUCTION OF THIS PROJECT AND IS RESPONSIBLE TO COORDINATE ALL DRAWINGS AND SPECIFICATIONS WITH ALL SUBCONTRACTORS REGARDLESS OF LOCATION IN CONTRACT DOCUMENTS. ITEMS LISTED IN DRAWINGS MAY NOT BE INCLUDED IN SPECIFICATIONS. ITEMS LISTED IN SPECIFICATIONS MAY NOT BE INCLUDED IN DRAWINGS.
- 3 UNLESS OTHERWISE INDICATED IN THE CONSTRUCTION DOCUMENTS AS BEING NOT IN CONTRACT (N.I.C.) OR EXISTING, ALL ITEMS, MATERIALS AND INSTALLATION OF SAME ARE PART OF THE CONTRACT AS DEFINED BY THE ENTIRE CONSTRUCTION DOCUMENTS AND SPECIFICATIONS. THE GC SHALL PROVIDE AND INSTALL ALL ACCESSORIES, COMPONENTS AND ASSEMBLIES REQUIRED FOR THE WORK DEPICTED OR SPECIFIED.
- 4 THE GENERAL CONTRACTOR SHALL FIELD VERIFY ALL CONDITIONS AND DIMENSIONS PRIOR TO BEGINNING ANY WORK AND SHALL BE RESPONSIBLE FOR ALL WORK AND MATERIALS INCLUDING THOSE FURNISHED BY SUBCONTRACTORS. THE GC SHALL ACCEPT PREMISES AS FOUND. OWNER WILL MAINTAIN THE EXISTING CONDITION OF THE SITE AND EXISTING STRUCTURES AT THE TIME OF BIDDING.
- DISCREPANCIES BETWEEN PORTIONS OF THE CONTRACT DOCUMENTS ARE NOT INTENDED. THE GENERAL CONTRACTOR IS TO CLARIFY WITH THE ARCHITECT ANY SUCH DISCREPANCIES DURING BIDDING AND PRIOR TO COMMENCING WORK.
- DIMENSIONS TAKE PRECEDENCE OVER DRAWINGS: DO NOT SCALE DRAWINGS TO DETERMINE ANY LOCATIONS. THE ARCHITECT SHALL BE NOTIFIED OF ANY DISCREPANCY PRIOR TO CONTINUING WITH WORK. CHANGES IN THE WORK TO BE DOCUMENTED IN WRITING AND APPROVED IN WRITING PRIOR TO BEING STARTED -(IMPLEMENTED)
- 7 ALL PLAN DIMENSIONS ARE FROM GRIDLINE OR FACE OF STUD OR FACE OF BLOCK UNLESS OTHERWISE INDICATED. SEE SECTION ON "DIMENSIONING" THIS SHEET.
- 8 THE CONTRACTOR SHALL REPORT TO THE ARCHITECT ALL CONDITIONS REQUIRING COORDINATION/ CHANGES WITH THE CONTRACT DOCUMENTS. COORDINATION / APPROVAL SHALL TAKE PLACE BEFORE THE WORK BEGINS. ALL CHANGES TO THE CONTRACT COST SHALL BE APPROVED THROUGH A CHANGE ORDER.
- 9 DETAILED DRAWINGS AND LARGER SCALE DRAWINGS TAKE PRECEDENCE OVER SMALL SCALE DRAWINGS.
- 10 THE ARCHITECT WILL REVIEW SHOP DRAWINGS AND SAMPLES FOR CONFORMANCE WITH DESIGN CONCEPT OF THE PROJECT. THE ARCHITECT'S REVIEW OF A SEPARATE ITEM SHALL NOT INDICATE APPROVAL OF AN ASSEMBLY IN WHICH THE ITEM FUNCTIONS. THE ARCHITECT WILL NOT REVIEW SHOP DRAWINGS UNTIL THE GC HAS REVIEWED AND STAMPED THE SHOP DRAWING/SUBMITTAL. THE GC IS RESPONSIBLE FOR FIELD VERIFYING ALL DIMENSIONS SHOWN ON THE SHOP DRAWINGS. THE ARCHITECT'S REVIEW OF THE SHOP DRAWINGS SHALL NOT OVERRIDE THE CONDITIONS DESCRIBED IN THE CONTRACT DOCUMENTS UNLESS SPECIFICALLY NOTED OTHERWISE BY THE ARCHITECT. WORK SHALL NOT PROCEED WITHOUT RETURNED REVIEWED SUBMITTALS.
- 11 FOR CONSTRUCTION DETAILS NOT SHOWN, USE THE MANUFACTURER'S STANDARD DETAILS OR APPROVED SHOP DRAWINGS / DATA SHEETS IN ACCORDANCE WITH THE PROJECT SPECIFICATIONS.
- 12 FOR GRADING, TRENCHING ETC., CONTACT THE ARCHITECT FOR INSTRUCTIONS PRIOR TO THE CONTINUATION OF WORK SHOULD ANY UNUSUAL CONDITIONS BECOME APPARENT DURING GRADING OR FOUNDATION CONSTRUCTION. EXISTING ELEVATIONS AND LOCATIONS TO BE JOINED SHALL BE VERIFIED BY THE GENERAL CONTRACTOR BEFORE CONSTRUCTION.
- 13 ALL WORK, MATERIALS AND METHODS SHALL BE IN CONFORMANCE WITH THE CODES, ORDINANCES AND REGULATIONS OF ALL GOVERNMENTAL AGENCIES HAVING JURISDICTION AT THE PROJECT LOCATION. THE GENERAL CONTRACTOR MUST COMPLY WITH THE CONTRACTOR REGISTRATION REQUIREMENTS OF ALL GOVERNING AUTHORITIES.
- 14 ALL PROJECT CONSTRUCTION SHALL CONFORM WITH ANSI A-117.1-2009, AND THE AMERICANS WITH DISABILITIES ACT (ADA).
- 15 THE GENERAL CONTRACTOR SHALL NOTIFY ALL APPLICABLE LOCAL GOVERNING AUTHORITIES AND UTILITIES PRIOR TO COVERING UP ANY WORK REQUIRING INSPECTION.
- 16 THE GENERAL CONTRACTOR SHALL MAINTAIN ALL REQUIRED EXITS AND FIRE LANES IN WORKING ORDER.
- 17 A GENERAL BUILDING PERMIT IS REQUIRED. ALL PERMITS OR CONNECTION FEES SHALL BE SECURED BY THE GENERAL CONTRACTOR AND REIMBURSED THROUGH THE OWNER.
- 18 THE GENERAL CONTRACTOR SHALL PROVIDE AND INSTALL FIRE EXTINGUISHERS WHERE SHOWN ON PLAN.
- 19 MINIMUM FLAME SPREAD CLASSIFICATION OF INTERIOR FINISH SHALL CONFORM TO THE BUILDING CODE AND LOCAL GOVERNING BUILDING CODES/ORDINANCES. SEE CODE SUMMARY, SHEET G001.
- 20 THE GENERAL CONTRACTOR SHALL PROVIDE AND IS SOLELY RESPONSIBLE AND LIABLE FOR PUBLIC AND EMPLOYEE PROTECTION AS NECESSARY AND AS REQUIRED BY THE CODES, INCLUDING EXTERIOR AND INTERIOR PEDESTRIAN TRAFFIC BARRIERS. ALL WORK SHALL CONFORM TO THE ORDINANCES AND REGULATIONS OF GOVERNMENTAL AGENCIES HAVING JURISDICTION AT THE PROJECT.
- 21 THE GENERAL CONTRACTOR SHALL PROVIDE TEMPORARY BARRICADES FOR DUST AND NOISE CONTROL, AND ALL REQUIRED ENVIRONMENTAL PROTECTION WHERE WORK JOINS EXISTING CONDITIONS.
- 22 ALL DEBRIS SHALL BE REMOVED FROM PREMISES AND ALL AREAS SHALL BE LEFT IN A CLEAN (BROOM) CONDITION DAILY.
- 23 IT SHALL BE THE RESPONSIBILITY OF THE GENERAL CONTRACTOR TO COORDINATE AND OR CALL BLUE STAKES TO LOCATE ALL EXISTING UTILITIES, WHETHER SHOWN HEREIN OR NOT, AND WHEN IDENTIFIED TO PROTECT THEM FROM DAMAGE. THE GENERAL CONTRACTOR SHALL BEAR ALL EXPENSE OF REPAIR OR REPLACEMENT OF IDENTIFIED UTILITIES OR OTHER PROPERTY DAMAGED BY OPERATIONS IN CONJUNCTION WITH THE EXECUTION OF THE WORK.
- 24 APPROVED PLANS SHALL BE KEPT IN A PLAN BOX AND SHALL NOT BE USED BY WORKMEN. ALL CONSTRUCTION SETS SHALL REFLECT THE SAME INFORMATION. THE GENERAL CONTRACTOR SHALL ALSO MAINTAIN, IN GOOD CONDITION, ONE COMPLETE SET OF PLANS WITH ALL REVISIONS, ADDENDA AND CHANGE ORDERS, ON THE PREMISES AT ALL TIMES. THESE ARE TO BE KEPT UNDER THE CARE OF THE JOB SUPERINTENDENT.
- 25 THE GENERAL CONTRACTOR IS TO PROVIDE BLOCKING AS REQUIRED FOR MOUNTING OF WALL MOUNTED SHELVES, CABINETS, HC GRAB BARS AND PARTITION BRACES AND ALL OTHER ITEMS IDENTIFIED ON THE EQUIPMENT OR ACCESSORY SCHEDULE. BLOCKING SHALL BE FIRE TREATED WHERE REQUIRED BY THE BUILDING CODE.
- 26 THE GENERAL CONTRACTOR IS RESPONSIBLE FOR RECEIVING, UNLOADING, UNCRATING, INSTALLATION AND HOOK-UP OF ALL OWNER FURNISHED ITEMS UNLESS NOTED OTHERWISE ON THE DRAWINGS.

## **GENERAL NOTES:**

- 27 THE GENERAL CONTRACTOR IS TO ASSURE THAT NO REBAR OR REINFORCEMENT IS PRESENT PRIOR TO CORE DRILLING OR PLACING BOLTS OR ANY OTHER ITEM WHICH COULD DISTURB THE STRUCTURAL SLAB OR FOUNDATION WALLS.
- 28 PROVIDE GALVANIC PROTECTION BETWEEN DISSIMILAR MATERIALS WHERE REQUIRED.
- 29 PROVIDE METAL TRIM OR CASING AT ALL EDGES OF PLASTER AND DRYWALL SURFACES WHERE IT TERMINATES OR MEETS ANY OTHER MATERIAL, UNLESS NOTED OTHERWISE.
- 30 PROVIDE METAL CORNER TRIM AT ALL OUTSIDE CORNERS OF PLASTER AND DRYWALL SURFACES.
- 31 ALL PENETRATIONS THROUGH ANY SURFACE SHALL BE THOROUGHLY SEALED WITH APPROPRIATE SEALANT MATERIAL.
- 32 UNLESS OTHERWISE NOTED, ALL EXTERIOR AND INTERIOR METAL, TRIM, TREILLAGE, RAILINGS, MOLDINGS, FRAMES, CASTING ETC., SHALL BE PAINTED.
- 33 FOR PLUMBING, FIRE SPRINKLER AND ELECTRICAL SYSTEMS, PROVIDE APPROVED ASSEMBLIES WITH SELF CLOSING DEVICES FOR ANY PENETRATIONS IN RATED CONSTRUCTION.
- 34 THE GC SHALL VERIFY LOCATIONS OF ALL CEILING& WALL ACCESS PANELS WITH MECHANICAL, FIRE SPRINKLER AND PLUMBING PLANS. ACCESS PANELS SHALL BE FURNISHED AND INSTALLED WITH A FIRE RATING EQUAL TO THE WALL OR CEILING ASSEMBLY INTO WHICH THEY ARE TO BE INSTALLED. FINISH AND LOCATION SHALL BE APPROVED BY THE ARCHITECT.
- 35 THE GC SHALL VERIFY DIMENSIONS OF ALL EQUIPMENT PADS & BASES WITH EQUIPMENT MANUFACTURERS & SHALL VERIFY ALL SIZES AND LOCATIONS OF DUCT OPENINGS ON ROOF AND INTERIOR SHAFTS.

# **ADDITIONAL BID ALTERNATES**

#### ALL LEVELS

- 1. NEW PAINT THROUGHOUT (REFER TO FINISH LEGEND FOR 'P1' SPECIFICATION). LEVEL 01
- 1. DEMO EXISTING ACOUSTIC CEILING PANELS IN NORTH CORRIDOR, EMPLOYEE CORRIDOR AND SOUTH CORRIDOR. PROVIDE NEW ACP;
- REFER TO SHEETS AD004, AD006, AD008, A111, A114 & A117. 2. DEMO EXISTING FLOORING IN NORTH CORRIDOR, EMPLOYEE CORRIDOR AND SOUTH CORRIDOR; PROVIDE NEW FLOORING AND BASE; REFER TO
- SHEETS AD003, AD005, AD007, A110, A113 AND A116. 3. DEMO EXISTING WALL TILE IN NORTH CORRIDOR, EMPLOYEE CORRIDOR AND SOUTH CORRIDOR; REFER KEYNOTE ON SHEETS AD003, AD005, AD007. 4. LOBBY THORUGHOUT: REFACE ALL EXISTING WOOD VENEER AND PLASTIC
- LAMINATE WITH SURFACE APPLIED ARCHITECTURAL FILM (REFER TO FINISH LEGEND FOR 'W1' SPECIFICATION). 5. TWO ENCLOSED OFFICES ADJACENT TO LOBBY SOUTH: REFACE OPEN
- WORKSTATION FURNITURE PLASTIC LAMINATE WITH SURFACE APPLIED ARCHITECTURAL FILM (REFER TO FINISH LEGEND FOR 'W1' SPECIFICATION).

#### LEVEL 04 **EMPLOYEE BREAKROOM:**

1a: REFACE EXISTING CASEWORK PLASTIC LAMINATE FACES WITH NEW PLASTIC LAMINATE (REFER TO FINISH LEGEND FOR 'CW1' SPECIFICATION). 1b: DEMO EXISTING PLASTIC LAMINATE COUNTERTOPS AND PROVIDE NEW SOLID SURFACE COUNTERTOPS (REFER TO FINISH LEGEND FOR 'CW3' SPECIFICATION).

## **NOTES TO BIDDERS:**

FURNITURE AND MOST EQUIPMENT ARE FOR REFERENCE ONLY AND WILL BE OWNER PROVIDED. CONTRACTOR TO COORDINATE ANY AND ALL CONCERNS FOR POWER, PLUMBING, ELECTRICAL COORDINATION WITH EXISTING OWNER-PROVIDED FURNITURE.

CONTRACTOR, SUBCONTRATOR, VENDOR OR ANY OTHER PERSON PARTICIPATING IN BIDDING THIS PROJECT SHALL BE RESPONSIBLE FOR INFORMATION CONTAINED IN ANY AND ALL SHEETS OF DRAWINGS AND SPECIFICATIONS.

## **SCOPE OF WORK:**

NEW TENANT IMPROVEMENT WITHIN THE EXISTING SELECTHEALTH BUILDING ON THE 1ST, 2ND, 3RD, 4TH AND 6TH FLOORS. CONSTRUCTION SCOPE IS LOBBY, ELEVATOR LOBBY, CORRIDORS, STORAGE ROOMS, MAIL & SCANNING ROOMS, TRAINING ROOMS AND BREAK ROOMS OF TYPICAL CONSTRUCTION AND AVERAGE FINISH LEVELS.

EXISTING SPACE WILL NEED TO BE FIELD VERIFIED, MEASURED, AND MODIFIED TO COMPLETE PROJECT, INCLUDING PLUMBING AND MECHANICAL PENETRATIONS AND NEW FINISHES ON EXISTING WALLS. CONTRACTOR IS TO ENSURE ENTIRE SPACE IS OF NEW QUALITY AND FINISH LEVEL, ALL EXISTING EXPOSED SURFACES TO RECEIVE PAINT OR NEW FINISHES, SEE FINISH PLANS.

ajc architects

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ARCHITECT / CONSULTANT



PROJECT DESCRIPTION

## SELECTHEALTH BUILDING **TENANT IMPROVEMENT**

#### 5381 S GREEN STREET **MURRAY, UT 84123**

SHEET NAME:

## INDEX AND GENERAL NOTES

REVISIONS MARK DATE DESCRIPTION

ISSUE DATE: 08/17/2023 ISSUE TYPE: BID SET DRAWN BY: J. HALBERT CHECKED BY: R. OLSON PROJECT#: 2023-15



#### SECTION 007000 – CONDITIONS OF THE CONTRACT

#### 1.1 General Conditions: Stipulated Sum (Single-Prime Contract)

1.2 Supplementary Conditions: A. Insurance Requirements:

- 1. The Tenant shall provide Builder's Risk Insurance during Construction and Property and Liability Insurance for completed improvements.
- 2. The Tenant's General Contractor must demonstrate a Certificate of Insurance licensed in the State of Utah showing full coverage of the contractor for Comprehensive Automobile Liability and Commercial General Liability.

END OF SECTION 007000

#### SECTION 011000 - SUMMAR 1.1 Scope of Work of Project: Interior Tenant Improvement within an existing building as indicated

- in the Contract Documents.
- A. Use of Site: Limited to work in areas indicated. Coordinate with Building Owner for Contractor Staging Areas, Contractor Delivery Entrances and Contractor Parking Areas. B. Tenant's Occupancy Requirements: Occupancy of completed areas of construction.
- C. For FF&E (Fixtures, Furniture and Equipment) see information that is provided by The Design Agency

END OF SECTION 011000

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#### SECTION 012500 - SUBSTITUTION PROCEDURES

1.1 ACTION SUBMITTALS A. Substitution Request Form: CSI Form 13.1A.

- B. Documentation:
- 1. Justification.
- 2. Coordination information. 3. Detailed comparison.
- 4. Product Data.
- 5. Samples.
- 6. Certificates and qualification data.
- 7. List of similar installations. 8. Material test reports.
- 9. Research reports.
- 10. Detailed comparison of Contractor's construction schedule.
- 11. Cost information.
- 12. Contractor's certification. 13. Contractor's waiver of rights to additional payment or time.
- C. Architect's Action: If necessary, Architect will request additional information within seven days of receipt of a request for substitution. Architect will notify Contractor of acceptance or rejection within 15 days of receipt, or seven days of receipt of additional information.
- 1.2 SUBSTITUTIONS A. Substitutions for Cause: Not later than 15 days prior to time required for preparation and review of submittals.
- B. Substitutions for Convenience: Will be considered if received within 30 days after commencement of the Work.

END OF SECTION 012500

#### SECTION 012600 - CONTRACT MODIFICATION PROCEDURES

- SUMMARY
- A. Minor Changes in the Work: Use AIA Document G710 B. Quotation Form: Use CSI Form 13.6D and Form 13.6C.
- C. Contractor-Initiated Work Changes Proposals: Submit to Architect.
- D. Work Changes Proposal Request Form Form acceptable to Architect and Owner.
- E. Change Orders: Architect shall issue on AIA Document G701.
- F. Construction Change Directives: Use AIA Document G714.

#### END OF SECTION 012600

#### SECTION 012900 - PAYMENT PROCEDURES Summary

- A. Schedule of Values:
- 1. Provide multiple line items for principal subcontract amounts in excess of five percent of the Contract Sum.
- 2. Include separate line items under Contractor and principal subcontracts for Project closeout requirements in an amount totaling five percent of the Contract Sum and
- subcontract amoun B. Applications for Payment:
- Payment Application Times: Indicated in the Agreement.
- Payment Application Forms: AIA Document G702 and AIA Document G703.
- 3. Waiver of Mechanic's Lien: Submitted from [entities lawfully entitled to file a lien for work covered by payment including subcontractors, sub-subcontractors, and suppliers for construction period covered by previous application.

#### END OF SECTION 012900

#### SECTION 013100 - PROJECT MANAGEMENT AND COORDINATION

- 1.1 REQUESTS FOR INFORMATION (RFIS) A. RFI Forms: Use AIA Document G716.
- B. Architect's Action: Allow seven working days for Architect's response for each RFI.
- C. RFI Log: Maintain a tabular log of RFIs. Submit log weekly. Use CSI Log Form 13.2B.
- 1.2 PROJECT MEETINGS A. Schedule and conduct meetings.
- B. Preconstruction conference.

Substantial Completion.

- 1. Preinstallation Conferences: Before each construction activity that requires
- coordination. C. Project Closeout Conference: No later than 30 days prior to the scheduled date of
- D. Progress Meetings: At weekly, coordinated with preparation of payment requests. E. Coordination Meetings: At biweekly intervals, in addition to specific meetings held for other purposes.
- END OF SECTION 013100

#### SECTION 013200 - CONSTRUCTION PROGRESS DOCUMENTATION

- 1.1 INFORMATIONAL SUBMITTALS A. Format for Submittals: PDF electronic file.
- B. Contractor's construction schedule.
- C. Special Reports: Submit at time of unusual event.
- D. Updating: At monthly intervals, issued one week before progress meeting. END OF SECTION 013200

#### SECTION 013300 - SUBMITTAL PROCEDURES

- 1.1 PROCEDURES
- A. Electronic copies of digital data files of the Contract Drawings will be provided by Architect for Contractor's use, if asked. B. Processing Time:
- 1. Initial Review: 15 days.
- 2. Resubmittal Review: 15 days.
- 3. Sequential Review: 21 days.
- 4. Concurrent Consultant Review: 15 days.
- C. Transmittal Form: AIA Document G810. D. Submittal Procedures:
- 1. Post as PDF files directly to Architect's FTP site.
- a. Action Submittals.
- b. Informational Submittals.
- c. Certificates and Certifications Submittals: Provide a digital signature on electronically submitted certificates and certifications where indicated.
- d. Delegated-Design Services Certification: In addition to other required submittals, submit digitally signed PDF electronic file, signed and sealed by the responsible design professional. E. Contractor's Review:
- Submittals: Marked with approval stamp before submitting to Architect.
- 2. Action Submittals: Stamped with an action stamp and returned.
- 3. Informational Submittals: Reviewed but not returned, or rejected if they do not comply with requirements
- 4. Incomplete submittals will be returned without review.
- 5. Submittals Not Required: May not be reviewed and may be discarded.

END OF SECTION 013300

#### SECTION 013516 - ALTERATION PROJECT PROCEDURES 1.1 QUALITY ASSURANCE

- A. Specialist qualifications.
- B. Alteration work program for whole Project.
- C. Fire-prevention plan 1.2 STORAGE AND HANDLING OF SALVAGED MATERIALS
- A. Storage Space:
- 1. On-site by Owner, includes security. 1.3 PROTECTION

#### A. Protection:

. Barricades, barriers, and temporary directional signage for public and fire egress. Temporary protective covers over walkways.

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- 3. Surface protection along haul routes.
- 4. Sound-control treatment. 5. Utility Services: maintain existing services and provide temporary services during
- interruptions.
- 6. Test drains before start of work.
- . Protect existing roofing. B. Fire Protection:
- 1. General: NFPA 241. Perform duties titled "Owner's Responsibility for Fire Protection." Provide fire extinguishers, fire blankets, and rag buckets. 2. Heat-Generating Equipment: Open-flame equipment is not permitted.

1. Demonstrate the proposed range of aesthetic effects and workmanship.

1. Owner Responsibilities: Where indicated as Owner's responsibility, Owner will engage a

2. Contractor Responsibilities: Tests and inspections not explicitly assigned to Owner are

a. Retesting/Reinspecting: Regardless of whether original tests or inspections were

Contractor's responsibility, provide quality-control services, including retesting and

reinspecting, for construction that replaced Work that failed to comply with the

2. Maintain mockups as a standard for judging the completed Work.

B. Sanitary Facilities: Provide temporary toilets, wash facilities, and drinking water.

D. Provide isolation of work areas in occupied facilities with noise and dust controls.

E. Provide ventilation and humidity control as required for the performance of the work.

1. Manufacturer/Source: Product by manufacturer or from source named that complies

requirements. Comparable products [will] [will not] be considered[ unless otherwise

4. Basis-of-Design Product: Either the specified product or a comparable product by one

5. Visual Matching Specification: Product that matches Architect's sample. Architect's

6. Visual Selection Specification: Product (and manufacturer) that complies with other

specified requirements. Architect will select color, gloss, pattern, density, or texture

from manufacturer's product line that includes both standard and premium items.

a. Product does not require revisions to the Contract Documents, is consistent with

the Contract Documents and will produce the indicated results, and is

b. Comparison of proposed product with those named in the Specifications.

4. Existing Utility Services and Mechanical/Electrical Systems: Minimize interruption to

5. Cutting: In general, use hand or small power tools. Cut holes and slots neatly to

6. Patching: Patch with durable seams that are as invisible as practicable. Restore

minimum size required. Temporarily cover openings when not in use.

. Clean Project site and work areas daily. Dispose of materials lawfully.

. Start equipment and operating components to confirm proper operation.

1. Provide final protection and maintain conditions that ensure Work is without damage.

A. Recycling nonhazardous demolition and construction waste, to greatest extent practical.

B. Train workers, subcontractors, and suppliers on proper waste management procedures.

A. Prepare and submit Contractor's list of incomplete items (punch list) prepared on

C. Warranties, maintenance service agreements, and similar documents submitted.

D. Releases, occupancy permits, and operating certificates submitted.

L. Changeover information for use, operation, and maintenance submitted.

M. Owner's personnel instructed in operation, adjustment, and maintenance of equipment

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A. Existing Conditions: Existence and location of site improvements, utilities, and other

construction affecting the Work must be investigated and verified.

Review of the Contract Documents and field conditions.

2. Products: One of the products listed that complies with requirements. Comparable

3. Manufacturers: Product by one of the manufacturers listed that complies with

C. Provide temporary heating and cooling required by construction activities.

qualified testing agency to perform these services.

- 3. Trained Fire Watch:
- a. Final Fire-Safety Inspection: 30 minutes after conclusion of work. b. Maintain fire-watch personnel until 60 minutes after conclusion of daily work.
- END OF SECTION 013516

#### SECTION 014000 - QUALITY REQUIREMENTS

1.1 QUALITY ASSURANCE

C. QUALITY CONTROL

END OF SECTION 014000

A. Fire Extinguishers.

END OF SECTION 015000

1.2 TEMPORARY UTILITY INSTALLATION

1.1 GENERAL

A. Preconstruction testing. B. Mockups: For each form of construction and finish required, using materials indicated for

Contractor's responsibility

Contract Documents.

SECTION 015000 - TEMPORARY FACILITIES AND CONTROLS

A. Water Service: Connect to existing service.

G. Telephone Service: Provide temporary telephone service.

of the other named manufacturers.

products will be considered unless otherwise indicated.

compatible with other portions of the Work.

c. Product provides specified warranty.

F. Lighting: Provide temporary lighting.

SECTION 016000 - PRODUCT REQUIREMENTS

1.1 PRODUCT SELECTION PROCEDURES

A. Product Selection Procedures:

with requirements.

decision will be final.

1. Conditions for Consideration:

B. COMPARABLE PRODUCTS

END OF SECTION 016000

1.1 EXECUTION

SECTION 017300 - EXECUTION

B. CUTTING AND PATCHING

occupied areas.

exposed finishes.

D. STARTING AND ADJUSTING

2. Keep installed work clean.

3. Remove debris from concealed spaces.

2. Adjust equipment for proper operation.

SECTION 017419 - CONSTRUCTION WASTE MANAGEMENT AND DISPOSAL

B. Disposing of nonhazardous demolition and construction waste.

A. Types and quantities of demolition and construction waste.

B. Owner advised of pending insurance changeover.

F. Tools, spare parts, and extra materials delivered.

K. Owner advised of heat and utility changeover.

E. PROTECTION OF INSTALLED CONSTRUCTION

C. PROGRESS CLEANING

END OF SECTION 017300

END OF SECTION 017419

1.2 WASTE MANAGEMENT PLAN

1.1 SUBSTANTIAL COMPLETION

CSI Form 14.1A.

and systems.

SECTION 017700 - CLOSEOUT PROCEDURES

E. Project Record Documents submitted.

G. Final changeover of locks performed.

I. Test/adjust/balance records submitted.

H. Startup testing completed.

J. Temporary facilities removed.

N. Final cleaning performed. O. Touchup performed.

11 SUMMARY

. Provide temporary support.

2. Protect in-place construction.

3. Protect adjacent occupied areas.

indicated].

the completed Work.

#### 1.2 FINAL COMPLETION

- A. Preliminary Procedures: Before requesting final inspection, complete the following: B. Final Application for Payment submitted. C. List of incomplete items (punch list) endorsed by Architect as completed or otherwise
- resolved for acceptance.
- D. Evidence of continuing insurance coverage submitted. E. Final pest-control inspection report and warranty submitted.
- 1.3 SUBMITTAL OF PROJECT WARRANTIES
- A. Partial Occupancy: Submit warranties within 15 days of completion of designated portions of the Work that are occupied or used by Owner. B. Organize warranty documents based on Project Manual and bind in heavy-duty, three-
- ring, vinyl-covered, loose-leaf binders.
- C. Scan warranties and bonds into a single indexed electronic PDF file.
- D. O and M Manuals. 1.4 FINAL CLEANING
- A. Cleaning Agents: Comply with Green Seal's GS-37 and California Code of Regulations maximum allowable VOC levels.
- B. Clean each surface or unit to condition expected in an average commercial building cleaning and maintenance program. C. Replace disposable air filters and clean permanent air filters.
- D. Clean ducts, blowers, and coils if units were operated without filters during construction. E. Clean HVAC system in compliance with NADCA Standard 1992-01.
- 1.5 REPAIR OF THE WORK A. Repair or remove and replace defective construction. Where damaged or worn items cannot be repaired or restored, provide replacements. Restore damaged construction and permanent facilities used during construction to specified condition. END OF SECTION 017700

#### SECTION 017839 - PROJECT RECORD DOCUMENTS

- 1.1 RECORD DOCUMENTS A. Record Drawings:
  - 1. Initial Submittal: PDF electronic files.
- 2. Final Submittal: PDF electronic file. B. Record Specifications: Annotated PDF electronic files.
- C. Record Product Data: Annotated PDF electronic files and directories.
- D. Miscellaneous Record Submittals: Annotated PDF electronic files and directories. E. Record Digital Data Files: Corrected digital data files of the Contract Drawings, as follows:
- 1. Format: Annotated PDF electronic file with comment function enabled END OF SECTION 017839

#### SECTION 055000 - METAL FABRICATIONS

- 1.1 SUBMITTALS A. Product Data for each material listed.
- B. Shop Drawings for fabricated items.
- 1.2 PRODUCTS
- A. Materials: Steel shapes, and bars, Slotted channel framing. B. Miscellaneous Framing and Supports: Primed using zinc-rich primer. C. Anchor bolts, slotted-channel inserts.
- END OF SECTION 055000

#### SECTION 061053 - MISCELLANEOUS ROUGH CARPENTRY 1.1 SUBMITTALS

- A. Product Data for each material listed.
- 1.2 MATERIALS
- A. Wood Products, General: 1. Maximum Moisture Content of Lumber: 15 percent for 2-inch nominal thickness or less, 19 percent for more than 2-inch nominal thickness.
- B. Miscellaneous Nailers and Blocking:
- 1. Dimension Lumber: Standard, Stud, or No. 3, grade any species. C. Fasteners: Hot-dip galvanized or stainless steel where exposed to weather, in ground
- contact, in contact with treated wood, or in area of high relative humidity. END OF SECTION 061053

#### SECTION 061600 - SHEATHING

- 1.1 SUBMITTALS A. Product Data for each material listed.
- 1.4 MATERIALS
- A. Wood Product 1. Ply-wood – Either Doc PS 1 or Doc PS 2 unless otherwise noted. Thickness not less than 1.2 inch. Sheathing tape as recommended by manufacturer.
- B. Miscellaneous Nailers and Blocking: C. Screws: ASTM C 954 Length as recommended by screw manufacturer.
- END OF SECTION 061600

#### SECTION 064116 - PLASTIC-LAMINATE-CLAD ARCHITECTURAL CABINETS

- 1.1 SUMMARY A. Section Includes:
- 1. Plastic-laminate-clad architectural cabinets.
- 2. Cabinet hardware and accessories.
- 1.2 QUALITY ASSURANCE A. Mockups for typical plastic-laminate cabinets.
- 1.3 PLASTIC-LAMINATE-CLAD CABINETS
- A. Architectural Woodwork Standards Grade: Custom.
- B. Type of Construction: Frameless. C. Door and Drawer-Front Style: Flush overlay.
- D. Laminate Cladding for Exposed Surfaces:
- 1. Plastic-Laminate Grade: VGS. E. Materials for Semiexposed Surfaces: High-pressure decorative laminate, ISO 4586-3. 1.4 materials
- A. Cabinet Hardware:
  - . Hinges: Frameless, concealed.
  - 2. Pulls: Back mounted. 3. Adjustable shelf supports.
  - 4. Exposed Hardware Finishes: As selected by Owner and Architect from Manufacturer's standard.

END OF SECTION 064116

#### SECTION 079200 - JOINT SEALANTS 1.1 SUBMITTALS

- A. Product Data
- 1.2 PRECONSTRUCTION TESTING
- A. Low-emitting sealants by Manufacturers. 1.3 JOINT SEALANTS
- A. Nonstaining silicone joint sealants.
- B. Urethane joint sealants. C. Immersible joint sealants.
- D. Silyl-terminated polyether joint sealants.
- E. Mildew-resistant joint sealants.
- F. Polysulfide joint sealants. G. Butyl joint sealants.
- H. Latex joint sealants.
- I. Joint-sealant backing. 1.4 FIELD QUALITY CONTROL
- A. Field-adhesion testing.
- END OF SECTION 079200

#### SECTION 081113 - HOLLOW METAL DOORS AND FRAMES AND LITES 1.1 SUBMITTALS

- A. Product Data.
- B. Shop Drawings indicating installation Details.
- 1.2 INTERIOR STANDARD STEEL DOORS AND FRAMES A. Heavy-Duty Doors and Frames: ANSI/SDI A250.8, Level 2.
- 1. Face: Uncoated steel sheet, minimum thickness of 0.042 inch. 2. Edge Construction: Model 2, Seamless.
- 3. Core: Manufacturer's standard. 4. Frames: Full profile welded; steel sheet, minimum thickness of 0.053 inch.
- 1.3 INSTALLATION

3

A. Metal-Stud Partitions: Frames filled with insulation END OF SECTION 081113

#### SECTION 081416 - FLUSH WOOD DOORS 1.1 QUALITY ASSURANCE

- A. Manufacturer and Vendor: FSC certified for chain of custody.
- 1.2 DOOR CONSTRUCTION, GENERAL A. Quality Standard: ANSI/WDMA I.S.1-A.
- 1.3 FLUSH WOOD VENEER-FACED DOORS FOR TRANSPARENT FINISH
- A. Interior Solid-Core Doors:
- 1. Performance Grade: ANSI/WDMA I.S. 1A Heavy Duty. 2. ANSI/WDMA I.S. 1A Grade: Custom.
- 3. Species: Match existing doors.
- 4. Cut: Plain sliced (flat sliced).
- 5. Match between Veneer Leaves: Pleasing match 6. Assembly of Veneer Leaves on Door Faces: Center-balance match.
- 7. Special Matching:
- a. Pair and set match.
- b. Room Match: Door faces of compatible color and grain within each c. Blueprint matching.
- 8. Core: Either glued wood stave or structural composite lumber.
- 9. Construction: Five or seven plies, bonded. 1.4 LIGHT FRAMES
- A. Light-Opening Frames:
- 1. Metal for fire doors. 1.5 PRIMING/FINISHING
- A. Factory Finishing: Doors indicated to receive transparent finish. B. Transparent Factory Finishes:
  - 1. ANSI/WDMA I.S. 1A Grade: Custom. 2. Finish: catalyzed polyurethane.
- END OF SECTION 081416

#### SECTION 087100 - DOOR HARDWARE

- 1.2 WARRANTY A. Materials and Workmanship: Three years.
- 1.3 MAINTENANCE SERVICE A. Full-Maintenance Service: 12 months.

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	r: FSC certified for chain of custody	<i>ų</i> .	SECTION 088813 - FIRE-RATED GLAZING 1.1 WARRANTY A. Laminated Glass: Not less than five years.	
<ol> <li>ANSI/WDMA I.S. 1A Gr</li> <li>Species: Match existin</li> <li>Cut: Plain sliced (flat)</li> </ol>	/DMA I.S.1-A. DOORS FOR TRANSPARENT FINISH ANSI/WDMA I.S. 1A Heavy Duty. rade: Custom. ng doors. sliced).		<ul> <li>B. Double Glazing Units with Clear Intumescent Interlayer: Not less than five years.</li> <li>1.2 MATERIALS <ul> <li>A. Silicone Glazing Sealants: Neutral curing, Class 50.</li> <li>B. Glazing Tapes: Back-bedding-mastic type.</li> <li>C. Fire-Resistance-Rated Framing and Doors: Fire-resistance-rated glazing with 60-, 90-, and 120-minute ratings requires framing and doors from glass supplier, tested as an assembly complying with ASTM E119 or UL 263.</li> </ul> </li> <li>END OF SECTION 088813</li> </ul>	703 east 1700 south salt lake city, ut 84105 ajcarchitects.com
<ol> <li>Assembly of Veneer Le</li> <li>Special Matching:         <ul> <li>a. Pair and set matching:</li> <li>b. Room Match: Do</li> <li>c. Blueprint matching:</li> </ul> </li> </ol>	or faces of compatible color and § g. bod stave or structural composite Iu	grain within each room.	<ul> <li>SECTION 092216 - NON-STRUCTURAL METAL FRAMING</li> <li>1.1 QUALITY ASSURANCE <ul> <li>A. Code-compliance certification of studs and tracks.</li> </ul> </li> <li>1.2 MATERIALS <ul> <li>A. Steel Framing: <ul> <li>Steel studs and tracks. Minimum 20 gauge, To be verified with wall height.</li> <li>Embossed, high-strength steel studs and tracks.</li> <li>3. Slip-Type Head Joints:</li> </ul> </li> </ul></li></ul>	
<ul> <li>A. Light-Opening Frames: <ol> <li>Metal for fire doors.</li> </ol> </li> <li>1.5 PRIMING/FINISHING <ol> <li>Factory Finishing: Doors in</li> <li>Transparent Factory Finish</li> <li>ANSI/WDMA I.S. 1A Gr</li> <li>Finish: catalyzed poly</li> </ol> </li> </ul>	rade: Custom.	sh.	<ul> <li>a. Single long-leg track.</li> <li>b. Double tracks.</li> <li>c. Deflection track.</li> <li>4. Firestop track.</li> <li>5. Hat-shaped, rigid furring channels.</li> <li>6. Resilient furring channels.</li> <li>7. Cold-rolled furring channels.</li> </ul>	
END OF SECTION 081416 SECTION 087100 - DOOR HARDWA 1.1 SUBMITTALS A. Product Data.	<u>\RE</u>		8. Z-shaped furring. END OF SECTION 092216 SECTION 092900 - GYPSUM BOARD 1.1 MATERIALS	ARCHITECT / CONSULTANT
<ul> <li>B. Shop Drawings indicating</li> <li>C. Maintenance Data: Subr</li> <li>1.2 WARRANTY</li> <li>A. Materials and Workmansh</li> <li>1.3 MAINTENANCE SERVICE</li> <li>A. Full-Maintenance Service:</li> <li>1.4 KEYING</li> <li>A. Hardware supplier, will ins</li> </ul>		ruction cores. Construction	<ul> <li>A. Manufacturers: Subject to compliance with requirements, provide products by one of the following: <ol> <li>CertainTeed Gypsum.</li> <li>Georgia-Pacific Gypsum LLC.</li> <li>National Gypsum Company.</li> <li>USG Corporation.</li> </ol> </li> <li>B. Gypsum Board, Type X: ASTM C1396/C1396M. <ol> <li>Thickness: 5/8 inch.</li> <li>Long dges: Tapered and featured (rounded or beveled) for prefilling.</li> </ol> </li> </ul>	
<ul> <li>B. Keying Schedule: Arrange Architect, Owner and har and locking hardware, ar with project requirements Architect.</li> <li>1.5 FIELD QUALITY CONTROL</li> <li>A. Independent Architecture B. Occupancy Adjustment: A</li> </ul>	of or a keying meeting, and program dware supplier, and other involved e functionally correct and keying of Furnish 3 typed copies of keying of al Hardware Consultant: Owner er After six months.	mming meeting with d parties to ensure locksets and programming complies and programming schedule to	<ul> <li>1.2 TRIM ACCESSORIES <ul> <li>A. Interior Trim: ASTM C 1047.</li> <li>1. Material: Galvanized or aluminum-coated steel sheet or rolled zinc.</li> <li>2. Shapes, select from the following where indicated: <ul> <li>a. Cornerbead.</li> <li>b. LC-Bead: J-shaped; exposed long flange receives joint compound.</li> <li>c. U-Bead: J-shaped; exposed short flange does not receive joint compound.</li> </ul> </li> <li>1.3 JOINT TREATMENT MATERIALS</li> </ul></li></ul>	NOT FOR CONSTRUCTION
1.6 DOOR HARDWARE SCHEDULE:Manufacturer ListCodeNameMKMcKinneyRORockwoodRUCorbin RusswinYAYaleNONortonRFRixsonPEPemkoSUSecuritron			<ul> <li>A. General: Comply with ASTM C 475/C 475M.</li> <li>B. Joint Tape: <ol> <li>Interior Gypsum Board: Paper.</li> <li>Glass-Mat Gypsum Sheathing Board: 10-by-10 glass mesh.</li> </ol> </li> <li>C. Joint Compound for Interior Gypsum Board: For each coat use formulation that is compatible with other compounds applied on previous or for successive coats.</li> <li>Prefilling: At open joints, rounded or beveled panel edges, and damaged surface areas, use all purpose, sandable taping compound.</li> <li>Embedding and First Coat: For embedding tape and first coat on joints, fasteners, and trim flanges, use all purpose, sandable taping compound.</li> <li>Use setting-type compound for installing paper-faced metal trim accessories.</li> <li>Fill Coat: For second coat, use drying-type, all-purpose, sandable topping</li> </ul>	PROJECT DESCRIPTION SELECTHEALTH BUILDING TENANT IMPROVEMENT
<u>Set: 1.0</u> Doors: [E]001, [E]002	T ( 1 0 70 /		compound. 4. Finish Coat: For third coat, use drying-type, all-purpose, sandable topping compound. D. Auxiliary Materials: 1. Provide auxiliary materials that comply with referenced installation standards and	5381 S GREEN STREET
<ul> <li>6 Hinge</li> <li>1 Self/Auto Flush Bolt</li> <li>1 Dust Proof Strike</li> <li>1 Access Control Cyl Lock</li> <li>1 SFIC Core</li> <li>1 Coordinator</li> <li>2 Surface Closer</li> <li>2 Kick Plate</li> <li>2 Electromagnetic Holder</li> <li>1 Gasketing</li> <li>1 Astragal</li> <li>1 Frame Harness</li> <li>1 Door Harness</li> <li>2 Electric Payner Transfer</li> </ul>	T4A3786 2845/2945 (as required) 570 US26D RO CL33603 x SN200 NZD BIPS CLS6 Match existing 2600 (brackets as required) 8501 K1050 10'' 99XM (per details) S44BL S771C QC-C1500P (as required) QC-C_P (as required) EL-CEPT	US26D MK US32D RO 626 RU <i>5</i> US28 RO 689 NO US32D RO 689 RF <i>5</i> PE PE MK <i>5</i> MK <i>5</i> 630 SU <i>5</i>	<ul> <li>manufacturer's written instructions.</li> <li>2. Steel Drill Screws: ASTM C1002 unless otherwise indicated. <ul> <li>a. Use screws complying with ASTM C954 for fastening panels to steel members from 0.033 to 0.112 inch thick.</li> <li>b. For fastening cementitious backer units, use screws of type and size recommended by panel manufacturer.</li> <li>3. Thermal Insulation: As specified in Section 072100 "Thermal Insulation."</li> </ul> </li> <li>END OF SECTION 092900</li> <li>SECTION 093013 - CERAMIC TILING <ul> <li>1.1 SUBMITTALS</li> <li>A. Product Data for all materials.</li> <li>B. Low VOC materials.</li> <li>C. Maintenance Data: Submit with Project Closeout Documents.</li> </ul> </li> </ul>	MURRAY, UT 84123
existing doors requires a fi provided on these existing frames. <u>Set: 2.0</u>	in this set is for design purpose only eld survey. It is very possible that lis g doors. It is always recommended	y. Specifying hardware for ted hardware cannot be	<ol> <li>1.2 QUALITY ASSURANCE         <ul> <li>A. Mockup for each type of floor tile installation.</li> </ul> </li> <li>1.3 TILE PRODUCTS         <ul> <li>A. Refer to Interior Finish Legend on Drawing Sheet A620.</li> </ul> </li> <li>1.4 ACCESSORY MATERIALS         <ul> <li>A. Thresholds: Granite.</li> <li>B. Tile Backing Panels: Glass-mat, water-resistant backing board at wet walls.</li> <li>C. Waterproof Membrane: Fabric-reinforced, modified-bituminous sheet or Fabric-reinforced,</li> </ul> </li> </ol>	SPECIFICATIONS
<ul> <li>Doors: [E]003, [E]004, [E]005, [E</li> <li>6 Hinge</li> <li>1 Self/Auto Flush Bolt</li> <li>1 Dust Proof Strike</li> <li>1 Storeroom Lock</li> <li>1 SFIC Core</li> <li>1 Coordinator</li> <li>2 Surface Closer</li> <li>2 Kick Plate</li> <li>2 Stop</li> </ul>	TA2714 2845/2945 (as required) 570 CLX3357 NZD C6S Match existing 1700 8501 K1050 10'' 406/409/441H (as required)	US26D MK US32D RO US26D RO 626 RU Black RO 689 NO US32D RO US32D RO	<ul> <li>fluid-applied membrane.</li> <li>D. Crack Isolation Membrane: Fabric-reinforced, modified-bituminous sheet or Fabric-reinforced, fluid-applied membrane.</li> <li>E. Metal edge strips.</li> <li>1.5 INTERIOR TILE INSTALLATION SCHEDULE <ul> <li>A. Interior Floors on Concrete:</li> <li>1. TCNA F122: Thinset mortar bed on waterproof membrane. epoxy, Standard grout.</li> <li>2. TCNA F125A: Thinset mortar on crack isolation membrane. Sand-portland cement, Standard grout.</li> </ul> </li> <li>END OF SECTION 093013</li> </ul>	REVISIONS MARK DATE DESCRIPTION
existing doors requires a fi	S44BL S771C in this set is for design purpose only eld survey. It is very possible that lis g doors. It is always recommended	ted hardware cannot be	SECTION 095113 - ACOUSTICAL PANEL CEILINGS 1.1 PERFORMANCE REQUIREMENTS A. Engineering design of seismic restraints by Contractor. B. Flame-Spread Index: Class B. C. Smoke-Developed Index: 450. 1.2 PRODUCTS	
frames. <u>Set: 3.0</u> Doors: [N] 102, [N] 103, [N] 104,	[N]105, [N]106		<ul> <li>A. Acoustical Panels:</li> <li>1. Basis-Of-Design Product: Armstrong; Optima PB</li> <li>a. Type XII: Glass-fiber base with other overlay.</li> <li>b. Pattern: E (lightly textured).</li> </ul>	
<ul> <li>3 Hinge</li> <li>1 Classroom Lock</li> <li>1 SFIC Core</li> <li>1 Surface Closer</li> <li>1 Kick Plate</li> <li>1 Stop</li> <li>1 Gasketing \$44BL</li> </ul> Set: 4.0 Doors: [N] 100	T4A3786 CLX3355 NZD C6S Match existing 8501 K1050 10'' 406/409/441H (as required)	US26D MK 626 RU 689 NO US32D RO US32D RO PE	<ul> <li>c. LR: 0.88.</li> <li>d. NRC: 0.95.</li> <li>e. AC: 190.</li> <li>f. Thickness: 7/8 inch.</li> <li>g. Modular Size: 24 by 24 inches.</li> <li>B. Metal Suspension System: <ol> <li>High-humidity finish.</li> <li>Wide-Face, Capped, Double-Web Steel: Heavy duty.</li> <li>Hold-down clips.</li> <li>Impact clips.</li> <li>Seismic perimeter stabilizer bars, struts, and clips.</li> </ol> </li> </ul>	
<ul> <li>3 Hinge</li> <li>1 Passage Latch</li> <li>1 Surface Closer</li> <li>1 Kick Plate</li> <li>1 Stop</li> <li>1 Gasketing</li> </ul>	TA2714 CLX3310 NZD 8501 K1050 10'' 406/409/441H (as required) S44BL	US26D MK 626 RU 689 NO US32D RO US32D RO PE	<ul> <li>C. Metal Edge Moldings and Trim: Roll-formed sheet metal.</li> <li>1.2 ERECTION TOLERANCES <ul> <li>A. Main and Cross Runners: Level to within 1/8 inch in 12 feet.</li> <li>B. Moldings and Trim: Level to within.</li> </ul> </li> <li>1.3 FIELD QUALITY CONTROL <ul> <li>A. Special Inspection: Contractor-engaged special inspector for seismic design.</li> <li>B. Testing Agency: Contractor engaged</li> </ul> </li> <li>END OF SECTION 095113</li> </ul>	ISSUE DATE: 08/17/2023 ISSUE TYPE: BID SET DRAWN BY: M. TRAVIS CHECKED BY: R. OLSON PROJECT#: 2023-15



#### SECTION 096263 - STAINLESS STEEL WALL BASE

- 1.1 products A. Stainless steel base to match existing.
- 1.2 MATERIALS A. Type 304 Stainless Steel Wall Base
- B. Preformed Corner Units: Provide preformed inside and outside corner units. C. Adhesive: Manufacturer's standard polyurethane adhesive supplied in 10.5 oz or 29.0 oz tubes.
- 1.3 PREPARATION
- A. Surface Preparation: Surfaces to receive stainless steel wall base shall be cleaned to remove all dust, debris, and other contaminates that would interfere with adhesive bond. B. Place stainless steel base and accessory units in locations/rooms where material is to be installed and acclimate to building conditions as specified herein in Project/Site Conditions article for a minimum period of 24 hours prior to installation.

1.4 INSTALLATION

- A. Adhesive Installation: Install stainless steel wall base with adhesive in strict accordance with manufacturer's printed installation instructions. B. Install base accurately placed in proper location, level, and in proper alignment with
- adjoining work and applied finishes. a. Fit field connections accurately together to form hairline joints.
- C. Where necessary to provide secure attachment at corners, end terminations, or where higher abuse is anticipated, supplement adhesive installation with two (2) countersunk # 10 stainless steel screws (installer supplied) placed in pre-drilled and countersunk holes located within 1 inch of each exposed end or corner. Set screw heads flush in countersunk 1.4 PRODUCTS
- D. Field Fabricated Corners: Where preformed corners are not utilized, field fabricate corners by V-notching back of base to 1/2 depth maximum of thickness of material and bend to form tightly to corner substrate. END OF SECTION 096263

#### SECTION 096513 - RESILIENT BASE AND ACCESSORIES 1.1 PRODUCTS

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- A. Resilient Base: Thermoset rubber.
- 1. Style and Location:
- a. Cove: In areas with carpet.
- b. Cove: In areas with resilient flooring. c. Butt to: In areas indicated.
- 2. Minimum Thickness: 0.125 inch.
- 3. Height: As indicated on Drawings. See Sheet A620.
- 4. Outside Corners: Job formed or preformed.
- 5. Inside Corners: Job formed or preformed.
- B. Resilient Accessories: Rubber. 1. Carpet edge for glue-down applications.
- 2. Joiner for tile and carpet.
- 3. Transition strips.
- a. Basis-Of-Design Product: Shaw Contract 269VS, Color as selected by Architect. C. Installation Materials:
- 1. Trowelable leveling and patching compounds.
- 2. Adhesives.

#### 3. Metal edge strips. END OF SECTION 096513

SECTION 096519 - RESILIENT TILE FLOORING

- 1.1 PRODUCTS A. Luxury Vinyl Floor Plank: Monolithic vinyl tile.
- 1. Basis-Of-Design Product: ShawContract; Terrain II 12 Mil, Root. F6
- a. Class: Class III, Type B
- b. Surface: Smooth.
- c. Thickness: 0.098 inch.
- d. Wear Layer Thickness: 12 mil e. Size: 6 by 48 inches.
- f. Seamless-Installation Method: Glue-Down.
- B. Rubber Floor Tile: Homogeneous rubber tile, through mottled.
- 1. Basis-Of-Design Product: Tarkett; Minerality, Meta F5 a. Surface: Leather.
  - b. Thickness: 0.125 inch.
  - c. Size: 12 by 24 inches.
  - d. Seamless-Installation Method: Glue-Down.
- C. Installation Materials:
- 1. Trowelable leveling and patching compounds. 2. Adhesives.
- END OF SECTION 096519

#### SECTION 096813 - TILE CARPETING

1.1 WARRANTY A. Materials and Workmanship for Carpet Tile: 10 years.

- 1.2 PRODUCTS
- A. Basis-Of-Design Product: ShawContract F1:
- 1. Collection: All Access
- 2. Style: Path Tile 5T034
- 3. Color: Ebony 34500
- 4. Fiber: Ecosolution Q100<sup>™</sup> Nylon.
- 5. Pile Characteristic: Multi-Level Pattern Cut/Loop.
- 6. Density: 7448 oz/yd<sup>3</sup>.
- 7. Pile Thickness: 0.294 inches. 8. Total Weight: 30 oz./sq. yd.
- 9. Size: 24 by 24 inches.
- B. Basis-Of-Design Product: ShawContract F2:
- 1. Collection: Light Series
- 2. Style: Vibrant Tile 5T001, Equinox 01760 3. Color: Custom Color Formula; A:CF042, B:6025, C:5223D, D:6180, E:5500D, F:5657D
- 4. Fiber: Ecosolution Q100<sup>™</sup> Nylon.
- 5. Pile Characteristic: Multi-Level Pattern Cut/Loop.
- 6. Density: 6990 oz/yd<sup>3</sup>.
- 7. Pile Thickness: 0.240 inches.
- 8. Total Weight: 20 oz./sq. yd.
- 9. Size: 24 by 24 inches.
- 10. Backing: EcoLogix a. Size: 24 by 24 inches.
- b. Thickness: 0.185 inches
- END OF SECTION 096813

#### SECTION 099123 - INTERIOR PAINTING

- 1.1 SUBMITTALS
- A. Product Data. B. Low-emitting paints and coatings.
- C. Samples and paint Draw-Downs.
- 1.2 PAINT, GENERAL
- A. MPI-listed products.
- 1.3 INTERIOR PAINTING SCHEDULE, see Finish Legend.
- A. Hollow Metal Doors and Frames: 1. Light Industrial coating, semi-gloss.
- B. Gypsum Board Substrates:
- 1. Latex over latex sealer system, Satin finish walls, flat finish ceilings.
- END OF SECTION 099123
- SECTION 101423 PANEL SIGNAGE 1.1 SUBMITTALS
- A. Product Data.
- B. Samples.
- C. Low VOC adhesives. D. Maintenance Data: Submit with Project Closeout Documents.
- 1.2 SIGNS
- A. Panel Signs: Signs with exposed edges. 1. Solid-Sheet Sign: Acrylic sheet with surface-applied, raised graphics.
- 2. Text and Typeface: Accessible raised characters and Braille.
- 3. Mounting: Surface mounted with adhesive or two-face tape.

END OF SECTION 101423

#### SECTION 104413 - FIRE PROTECTION CABINETS 1.1 SUBMITTALS

A. Product Data. B. Shop Drawings including fabrication and installation Details. 1.2 PRODUCTS

2

- A. Fire-Protection Cabinets:
- 1. Type: Fire extinguisher.
- 2. Cabinet Construction: Nonrated. 3. Mounting: Semirecessed.
- 4. Door Style: Fully glazed panel with frame.
- 5. Door Glazing: Tempered float glass (clear).
- 6. Finish: a. Steel: Factory primed for field painting.
- END OF SECTION 104413

#### SECTION 104416 - FIRE EXTINGUISHERS

1.3 PERFORMANCE REQUIREMENTS

END OF SECTION 104416

A. Product Data.

C. Low VOC adhesives.

A. Stainless Steel, 2.5 inch legs.

1.1 SUSTAINABILITY REQUIREMENTS

A. Low-emitting adhesives.

B. Low-emitting composite wood.

1.2 SOLID SURFACE MATERIAL COUNTERTOPS

1.1 QUARTZ AGGLOMERATE COUNTERTOPS

A. Front: Straight, slightly eased edge.

B. Backsplash and End Splash: Eased edge.

A. Install on plywood subtops with adhesive.

A. Front: Straight, slightly eased edge.

B. Backsplash and End Splash: Eased edge.

C. Countertops: 1/2-inch-thick, solid surface material.

A. Install on particleboard subtops with adhesive.

SECTION 123661.19 - QUARTZ AGGLOMERATE COUNTERTOPS

C. Countertops: 3/4-inch-thick, quartz agglomerate.

2

B. Samples.

1.2 CORNER GUARD

END OF SECTION 102600

D. Integral sinks.

END OF SECTION 123661.16

1.3 INSTALLATION

1.2 INSTALLATION

END OF SECTION 123661.19

1.1 SUBMITTALS

1.2 WARRANTY

- 1.1 SUBMITTALS A. Product Data.
- B. Maintenance data: Submit with Project Closeout Documents.

A. Materials and Workmanship: Six years.

A. Portable Hand-Carried Fire Extinguishers:

SECTION 102600 - WALL AND DOOR PROTECTION

enameled-aluminum container.

SECTION 123661.16 - SOLID SURFACING COUNTERTOPS

3

4

A. Fire Extinguishers: Complying with NFPA 10 and U.L. listed and labeled.

1. Multipurpose Dry-Chemical Type in Aluminum Container: UL-rated 3-A:40-B:C, 5-Ib nominal capacity, with monoammonium phosphate-based dry chemical in

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ARCHITECT / CONSULTANT
NOT FOR CONSTRUCTION
PROJECT DESCRIPTION SELECTHEALTH BUILDING TENANT IMPROVEMENT
5381 S GREEN STREET MURRAY, UT 84123

Sheet NAME:

revisions

ISSUE DATE:

ISSUE TYPE:

DRAWN BY:

PROJECT#:

SHEET NUMBER:

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CHECKED BY: R. OLSON

08/17/2023

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2023-15

M. TRAVIS

**SPECIFICATIONS** 

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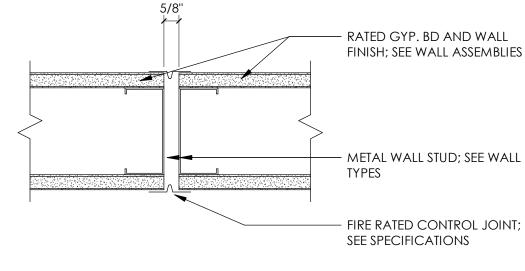
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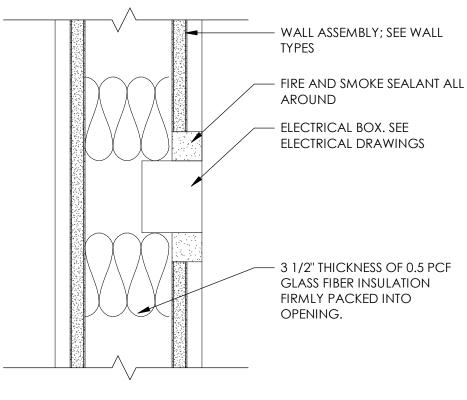
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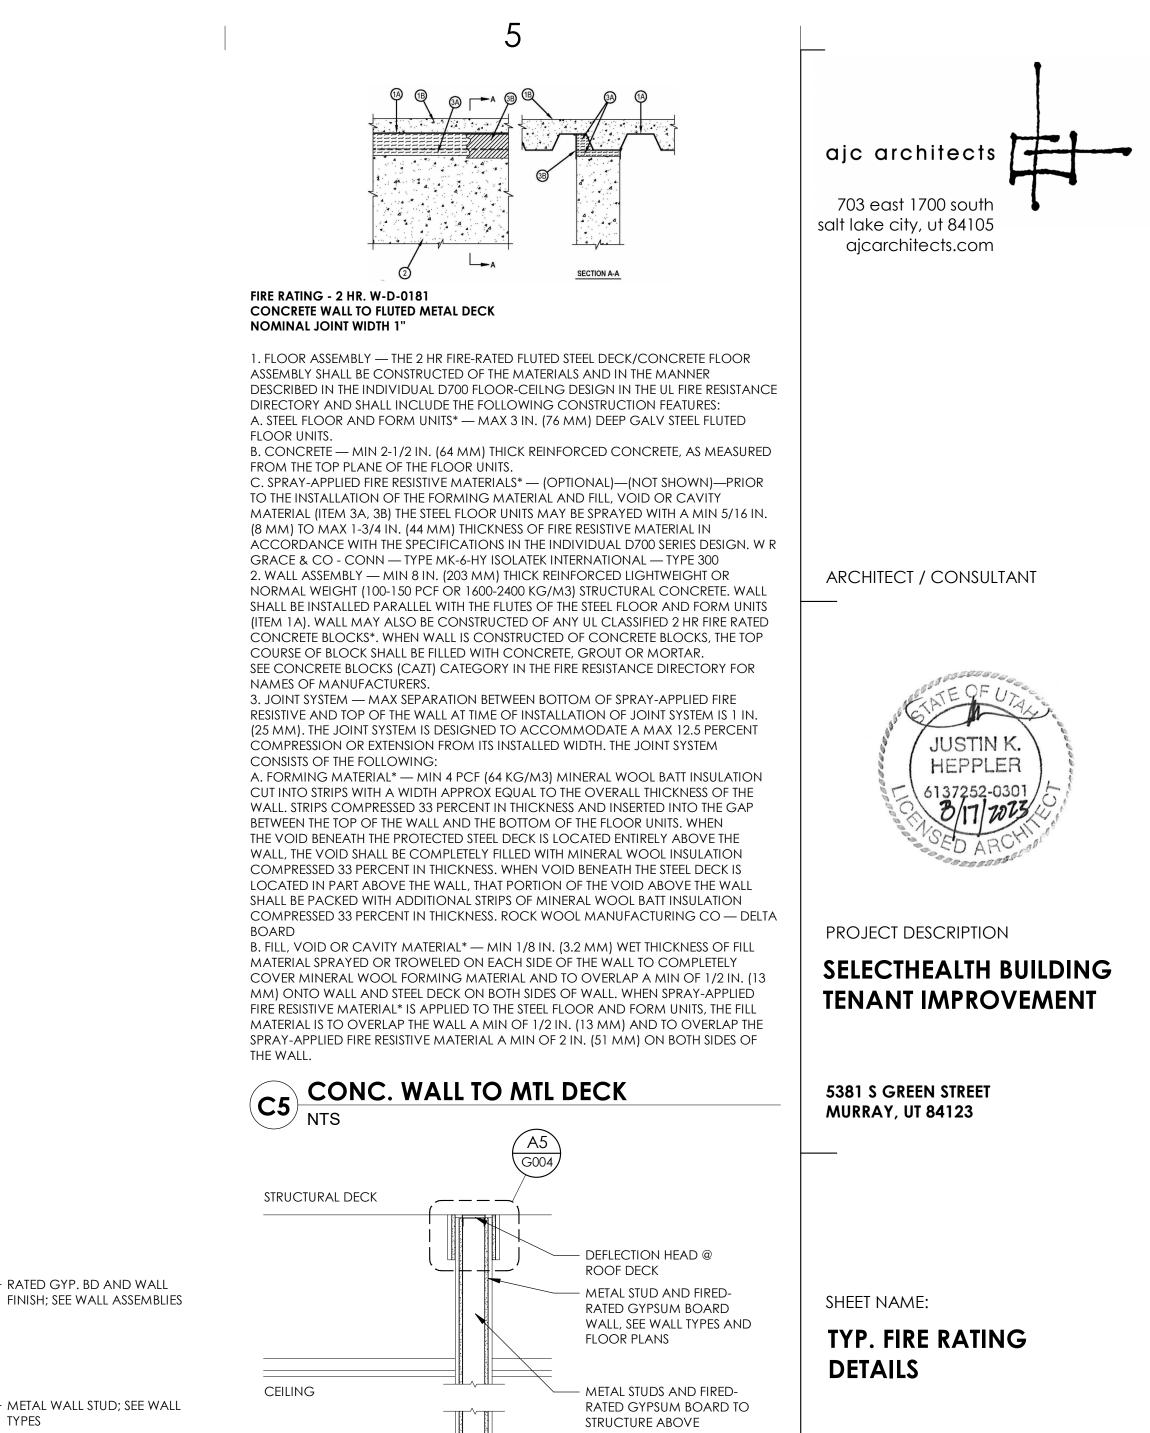




A4 TYPICAL FIRE-RATED WALL BOX 3" = 1'-0",

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18 GA METAL TRACK, SECURED TO SLAB WITH

0.177" DIAMETER X 1 1/2"


LONG POWDER DRIVEN FASTENERS AT 2'-0'' OC

FIRESTOPPING EACH SIDE

FIRE RATED CONTROL JOINT;



FLOOR

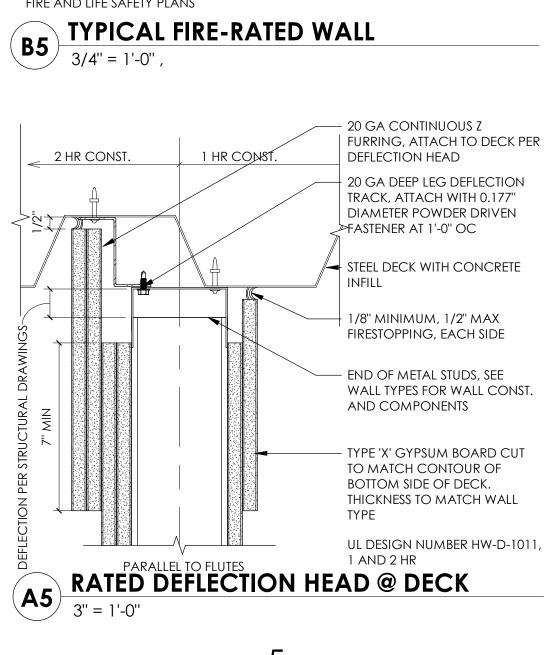

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08/17/2023

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2023-15

J. HALBERT

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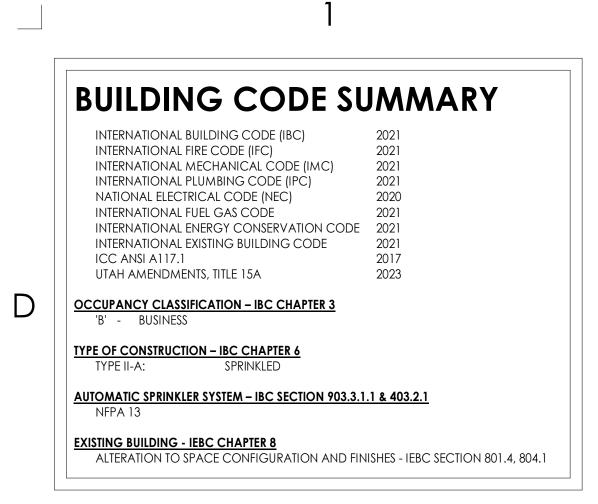
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MAIL ROOM SCANNING ROOM

# **GENERAL NOTES**


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## **CODE LEGEND**



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#### <sup>1</sup>/<sub>2</sub> HOUR RATED FIRE ASSEMBLY

FIRE EXTINGUISHER

FIRE DEPARTMENT CONNECTION

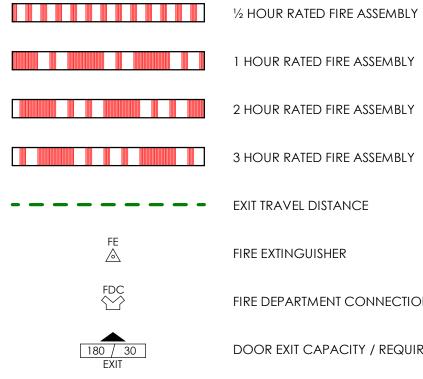DOOR EXIT CAPACITY / REQUIRED EXIT CAPACITY

FIRE RISER

## **UL NOTES**

REFERENCES:

. •

UL FIRE RESISTANCE DIRECTORY; CURRENT EDITION. NFPA 101 LIFE SAFETY CODE

ALL GOVERNING LOCAL AND REGIONAL BUILDING CODES

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## ajc architects

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ARCHITECT / CONSULTANT



PROJECT DESCRIPTION

## SELECTHEALTH BUILDING **TENANT IMPROVEMENT**

**5381 S GREEN STREET MURRAY, UT 84123** 


SHEET NAME:

FIRE SAFETY PLAN -LEVEL 01

REVISIONS MARK DATE DESCRIPTION

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# **GENERAL NOTES**


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## CODE LEGEND

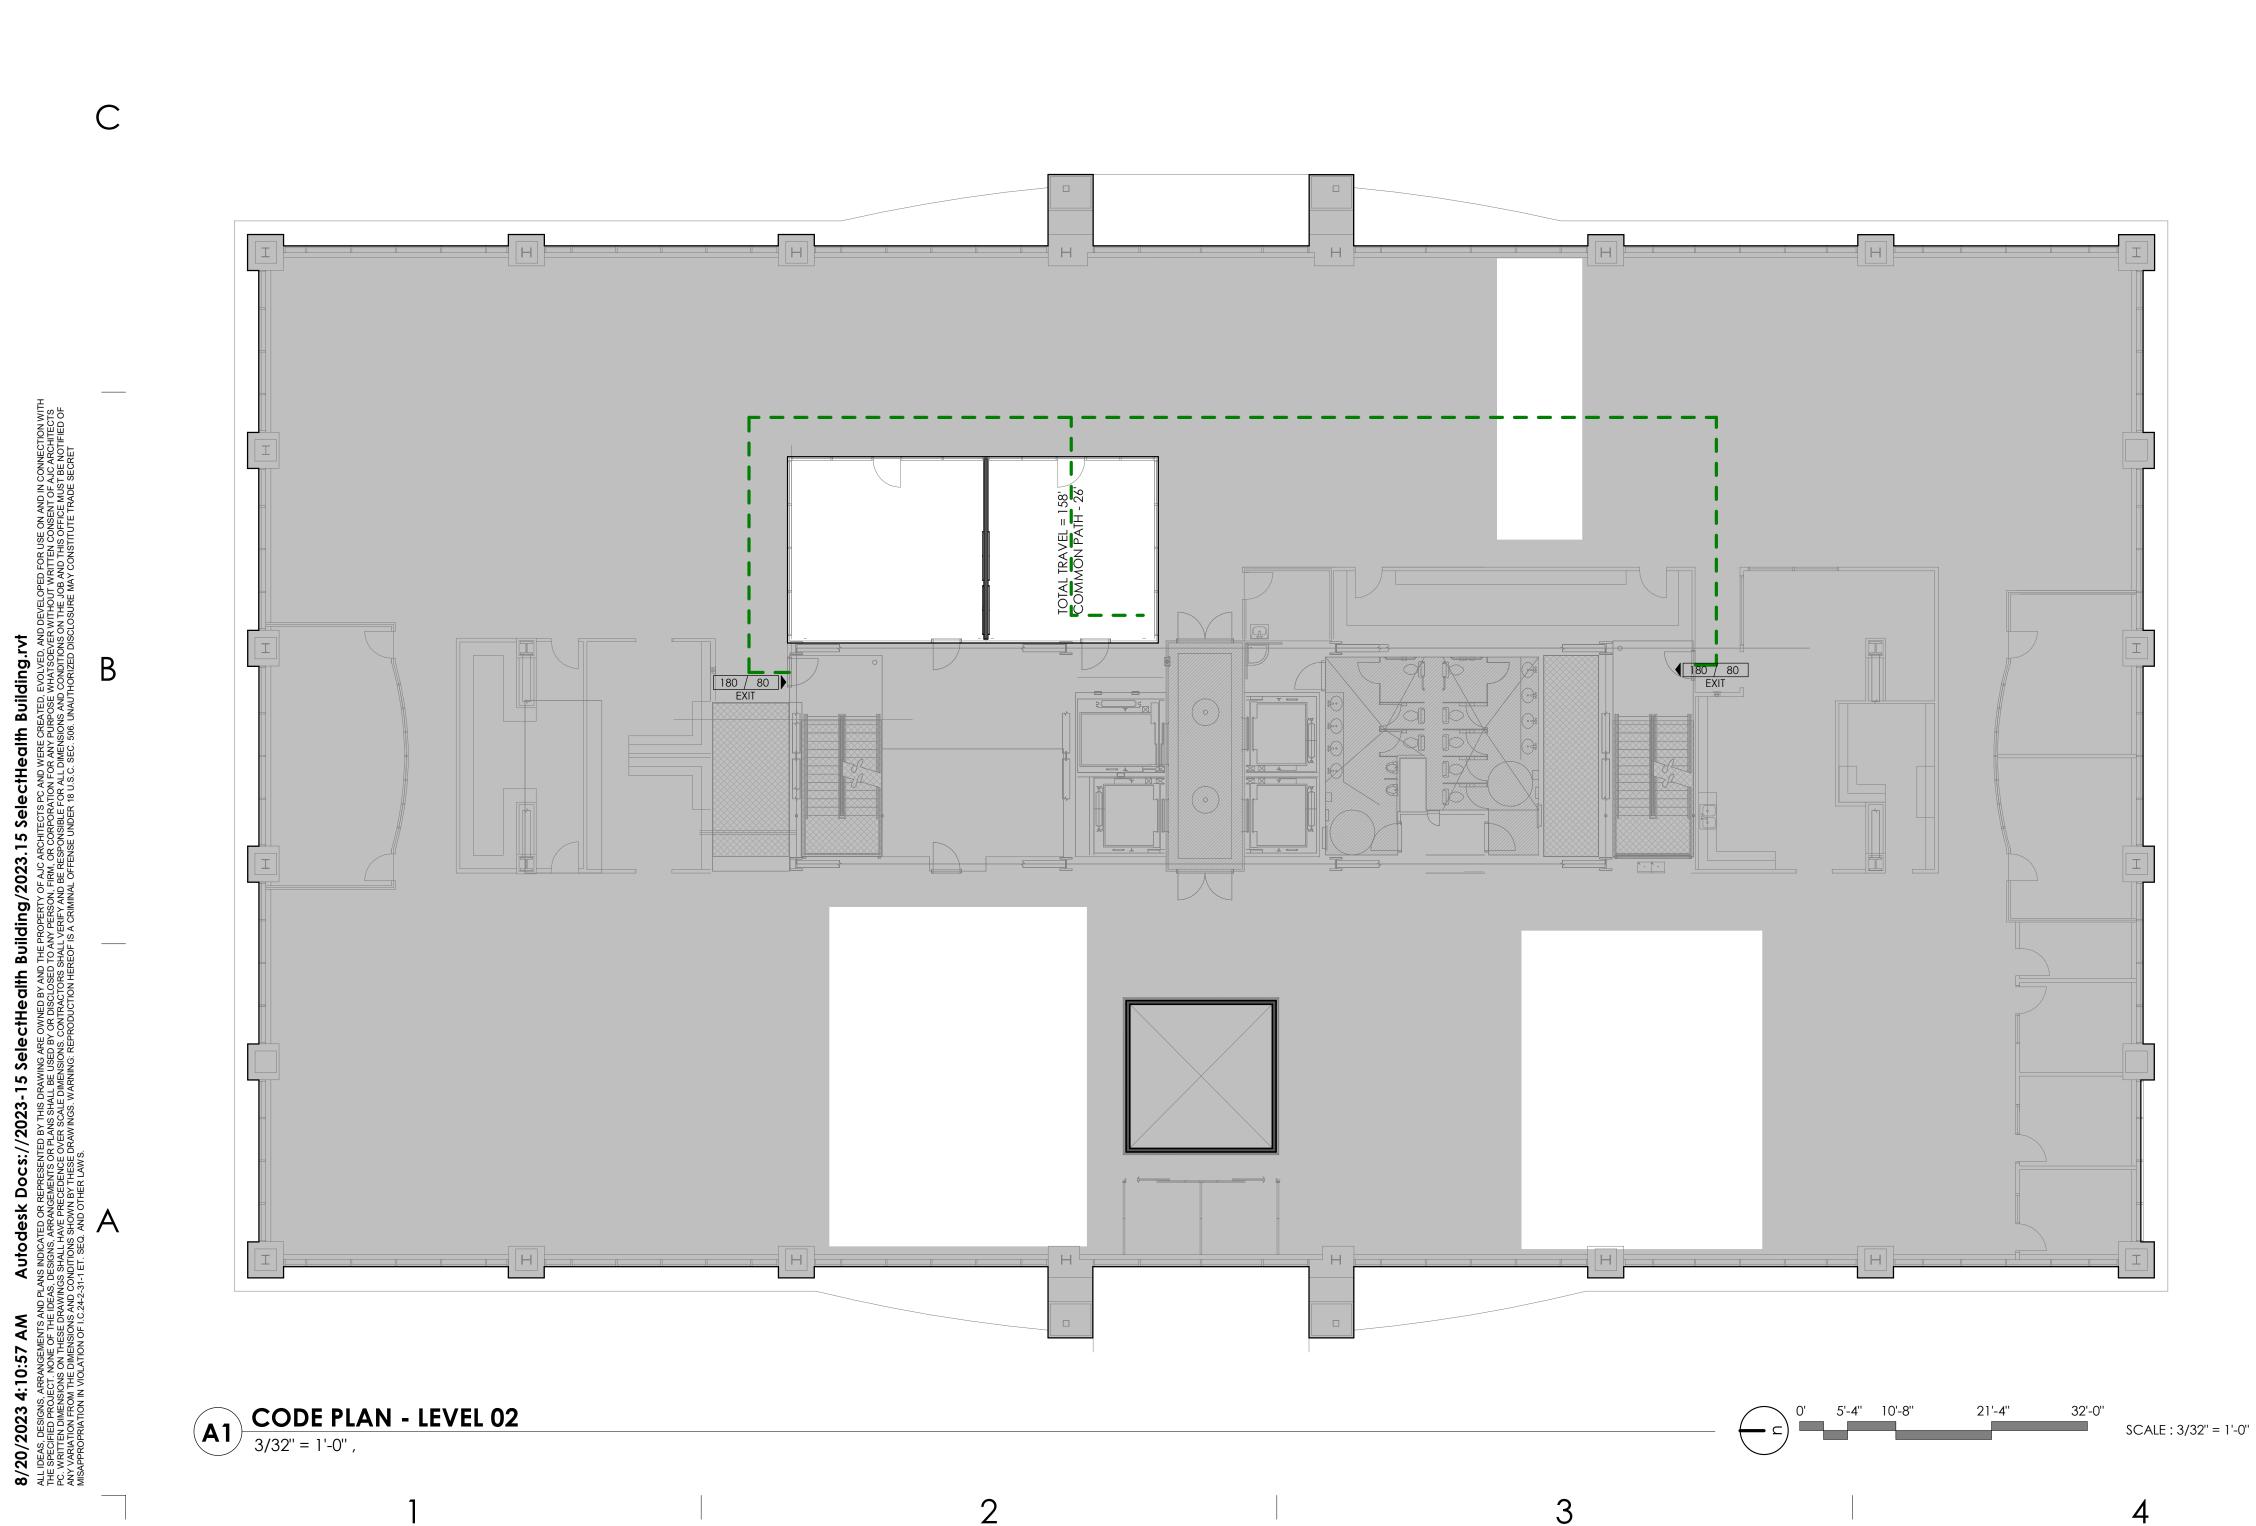

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1/2 HOUR RATED FIRE ASSEMBLY 1 HOUR RATED FIRE ASSEMBLY

2 HOUR RATED FIRE ASSEMBLY

3 HOUR RATED FIRE ASSEMBLY

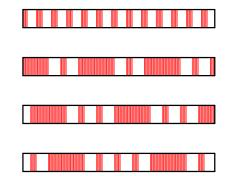exit travel distance

FIRE EXTINGUISHER

FIRE DEPARTMENT CONNECTION

DOOR EXIT CAPACITY / REQUIRED EXIT CAPACITY

FIRE RISER

## **UL NOTES**

**REFERENCES:** 

· UL FIRE RESISTANCE DIRECTORY; CURRENT EDITION.

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NFPA 101 LIFE SAFETY CODE •

ALL GOVERNING LOCAL AND REGIONAL BUILDING CODES •

FIRESTOP SYSTEM INSTALLATION MUST MEET REQUIREMENTS OF ASTM E1966 (UL 2079) TESTED ASSEMBLIES THAT PROVIDE A FIRE RATING EQUAL TO THAT OF THE SURROUNDING CONSTRUCTION.

## FIRE PROTECTION NOTES

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## ajc architects

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PROJECT DESCRIPTION

## SELECTHEALTH BUILDING **TENANT IMPROVEMENT**

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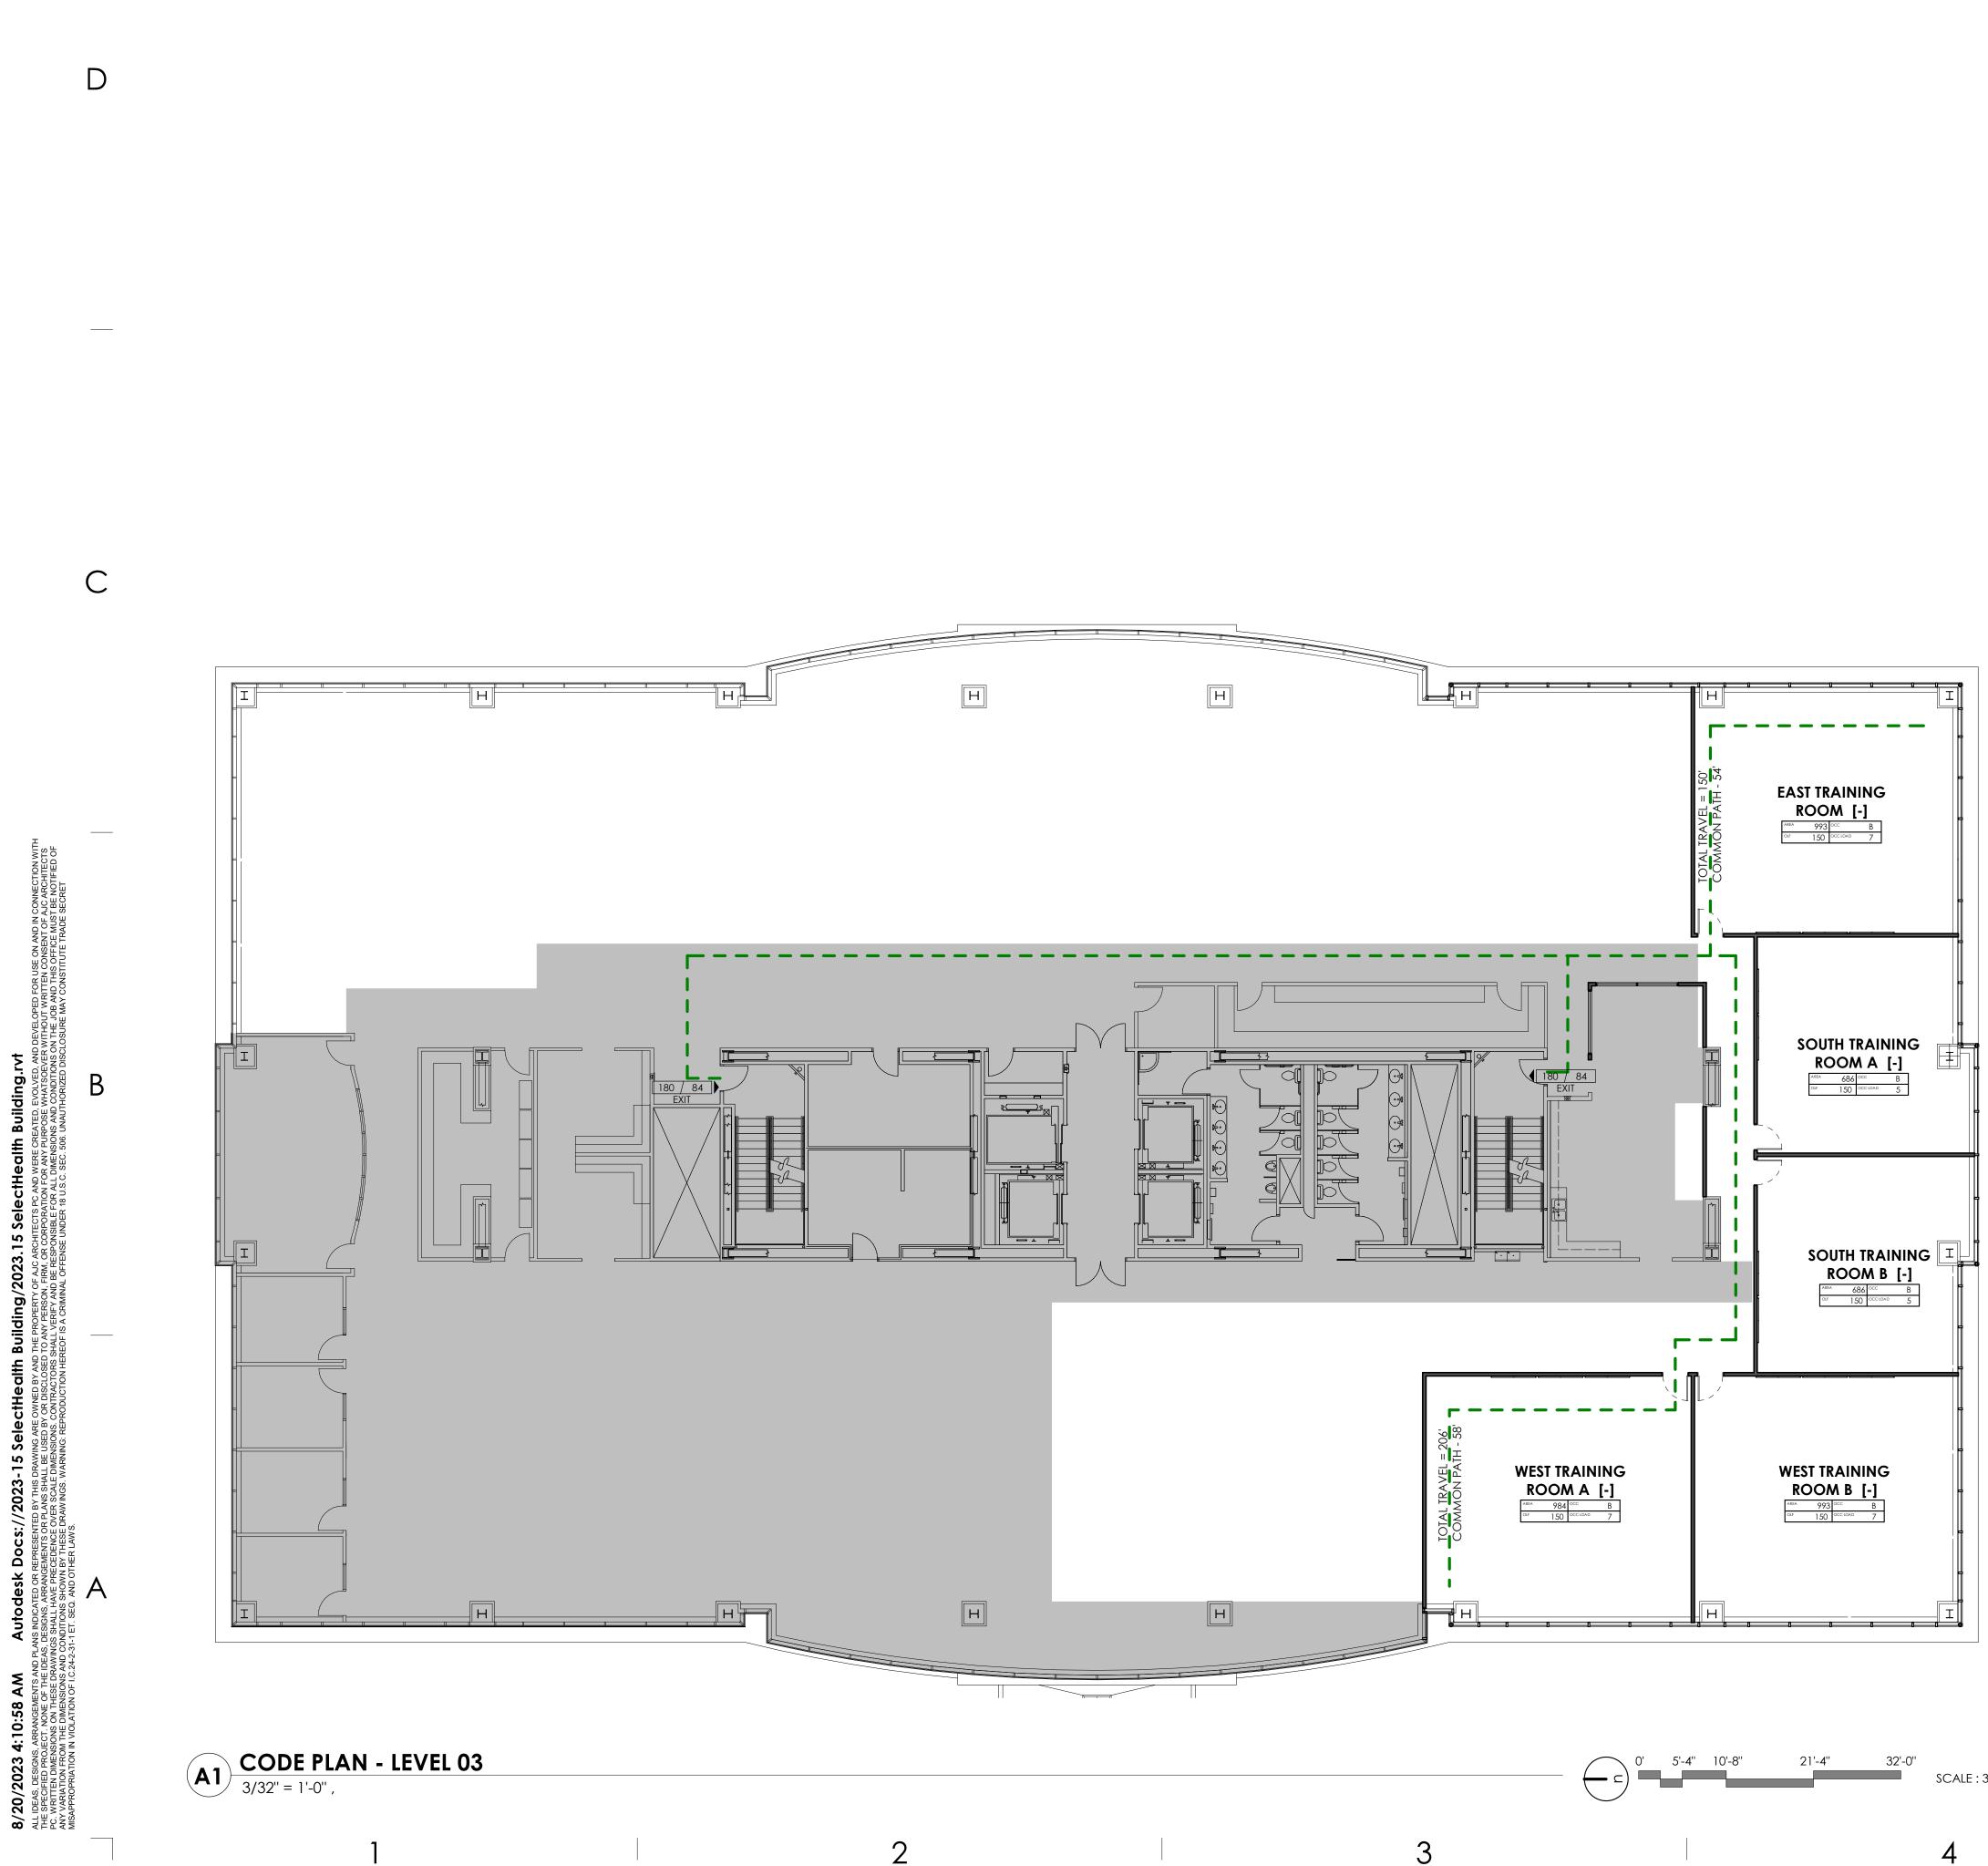
FIRE SAFETY PLAN -LEVEL 02

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# **GENERAL NOTES**


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# CODE LEGEND



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2 HOUR RATED FIRE ASSEMBLY

3 HOUR RATED FIRE ASSEMBLY

FIRE EXTINGUISHER

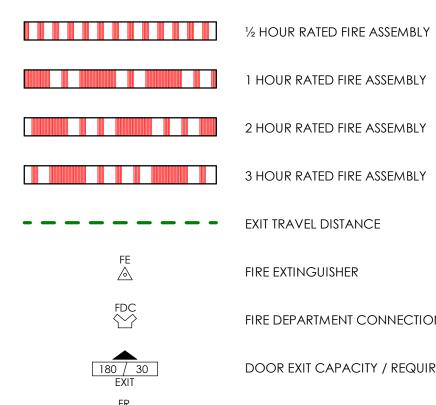FIRE DEPARTMENT CONNECTION

DOOR EXIT CAPACITY / REQUIRED EXIT CAPACITY

FIRE RISER

# **UL NOTES**

REFERENCES:

UL FIRE RESISTANCE DIRECTORY; CURRENT EDITION. NFPA 101 LIFE SAFETY CODE

ALL GOVERNING LOCAL AND REGIONAL BUILDING CODES •

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ARCHITECT / CONSULTANT



PROJECT DESCRIPTION

## SELECTHEALTH BUILDING **TENANT IMPROVEMENT**

**5381 S GREEN STREET** MURRAY, UT 84123

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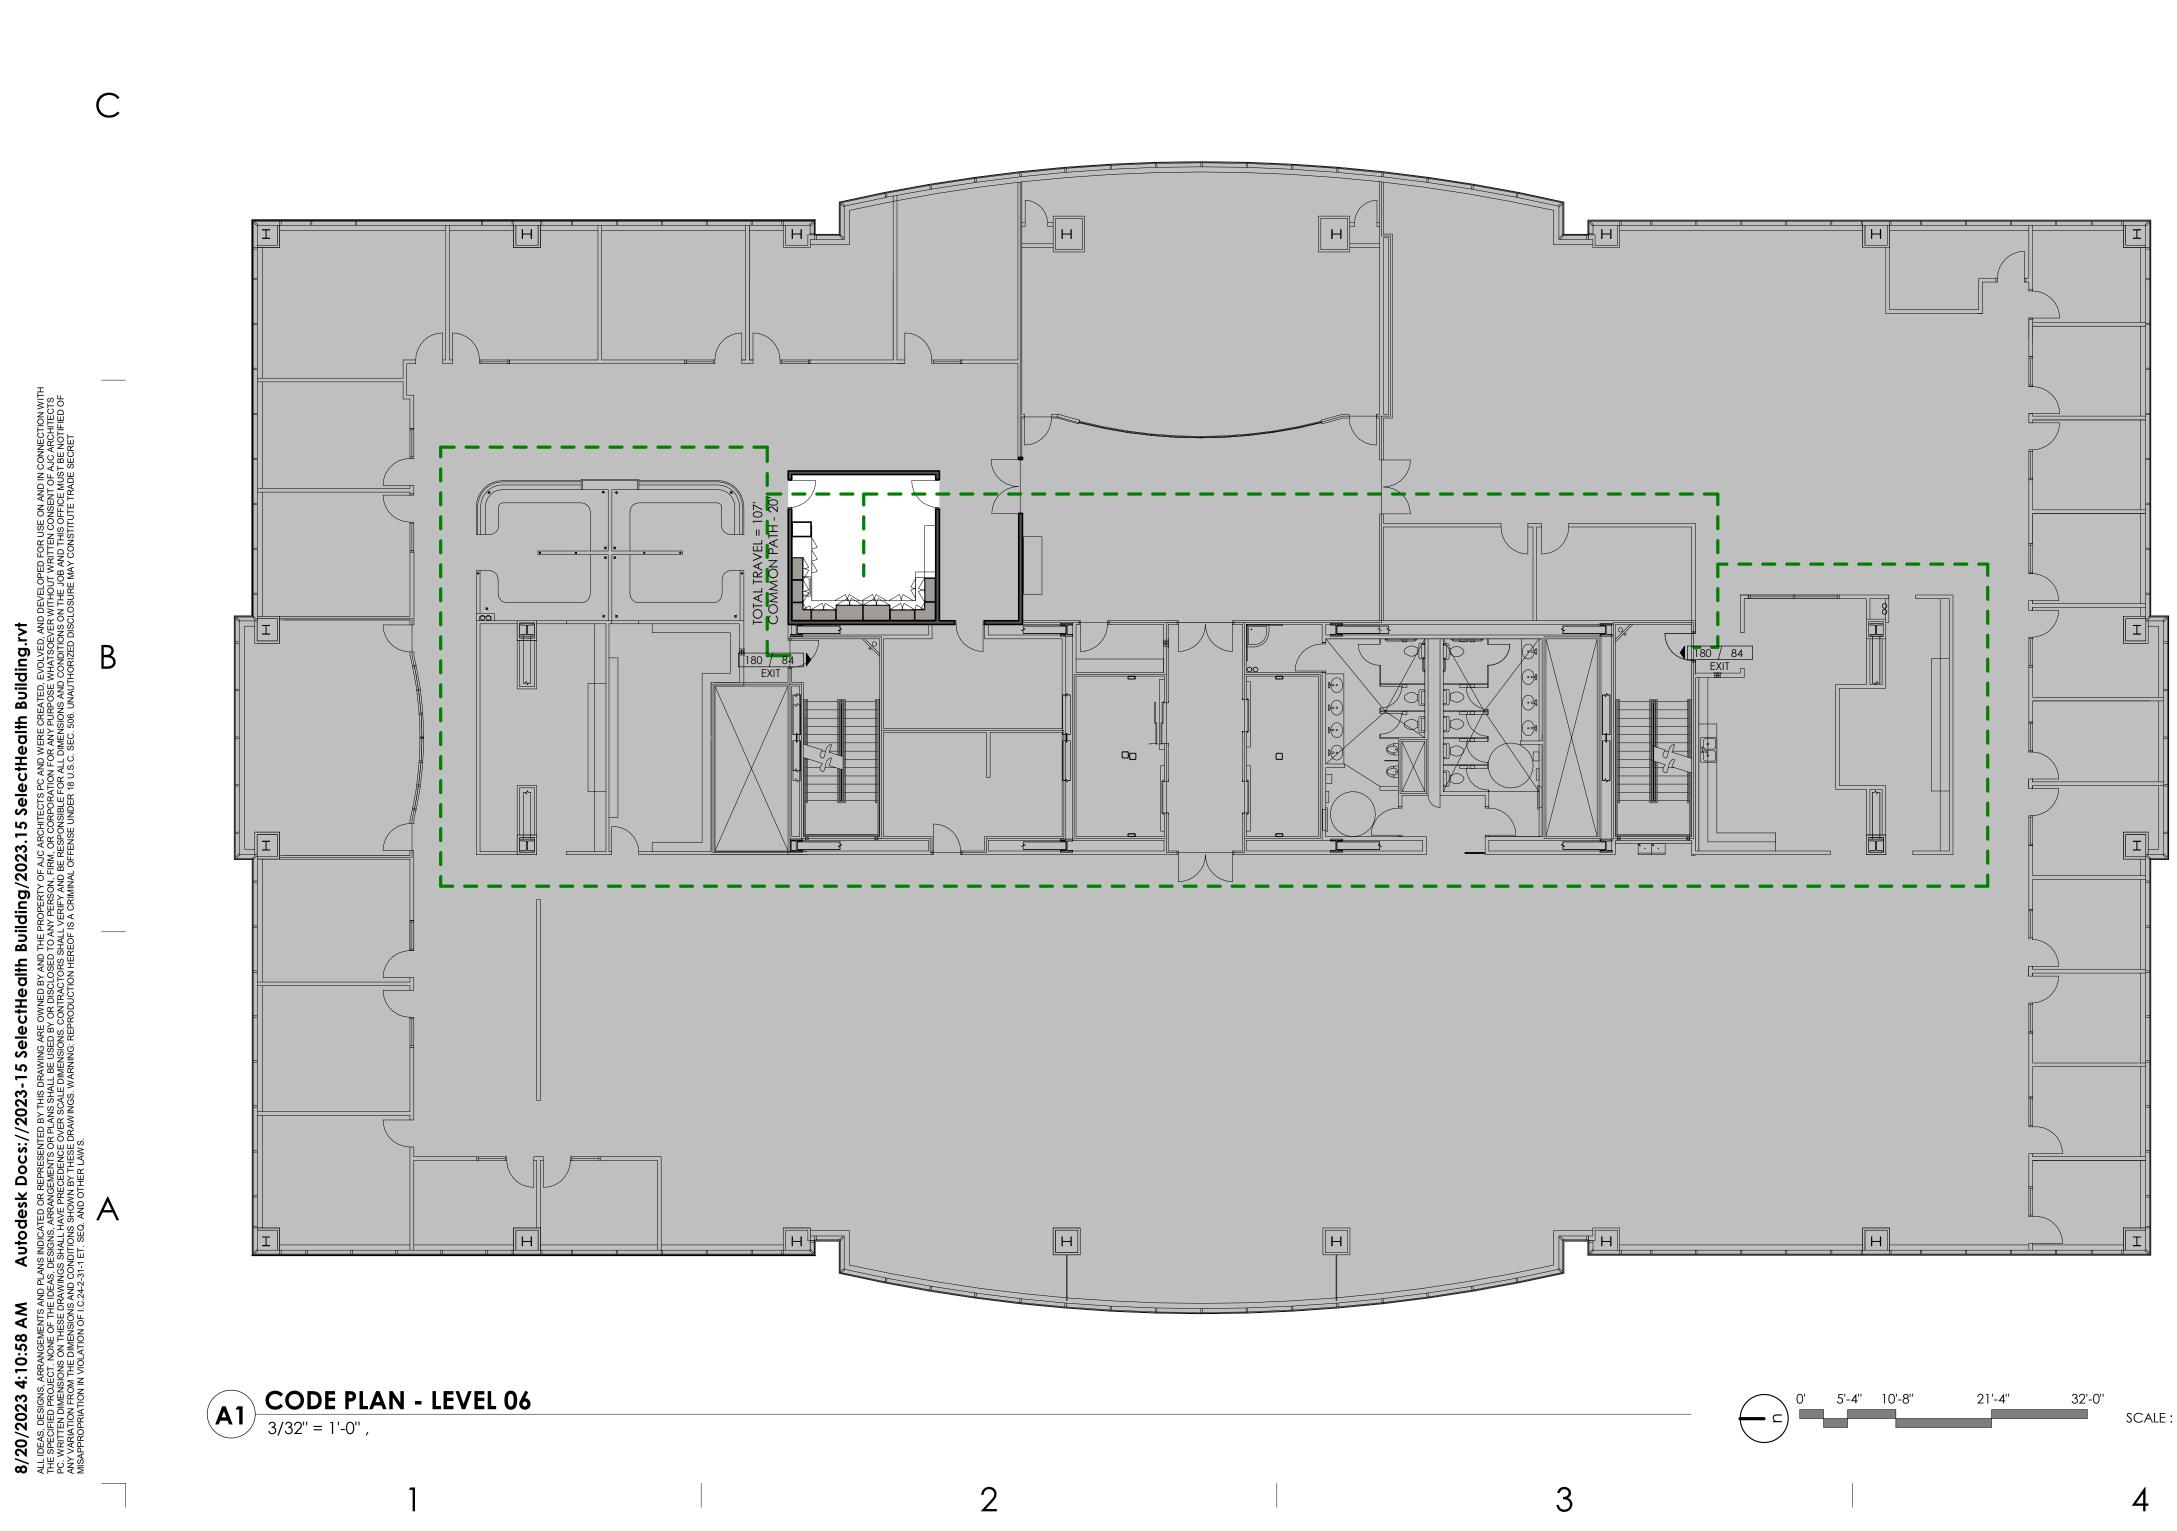
FIRE SAFETY PLAN -LEVEL 03

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SCALE : 3/32" = 1'-0"

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# **GENERAL NOTES**


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# CODE LEGEND



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2 HOUR RATED FIRE ASSEMBLY

FIRE EXTINGUISHER

FIRE DEPARTMENT CONNECTION

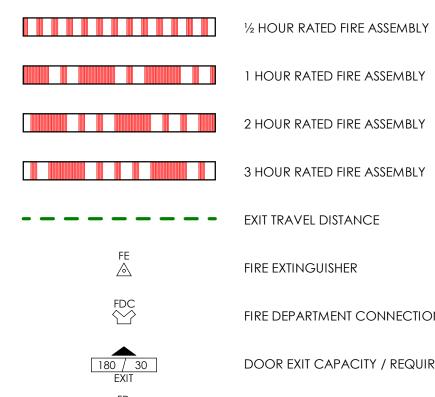DOOR EXIT CAPACITY / REQUIRED EXIT CAPACITY

FIRE RISER

# **UL NOTES**

REFERENCES:

UL FIRE RESISTANCE DIRECTORY; CURRENT EDITION. NFPA 101 LIFE SAFETY CODE

· ALL GOVERNING LOCAL AND REGIONAL BUILDING CODES

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AUTOMATIC FIRE SPRINKLER, FIRE SUPPRESSION AND FIRE ALARM SYSTEMS WHEN TAKEN OUT OF SERVICE ARE REQUIRED TO HAVE THE FIRE PREVENTION BUREAU NOTIFIED. THE DURATION OF TIME AND THE DATE MUST BE STATED TO INCLUDE THE DATE WHICH THE FIRE PROTECTION EQUIPMENT WILL BE PLACED IN SERVICE. AS REQUIRED IN IFC CHAPTER 33.

ALL DEFERRED (IBC 107.3.4.1) SUBMITTAL ITEM(S) NEED TO BE SUBMITTED WITHIN A TIMELY MANNER (30 CALENDAR DAYS OF THE ORIGINAL BUILDING PERMIT ISSUANCE DATE). THE FINAL INSPECTION APPROVAL (IBC 110.3.10) CANNOT BE ISSUED AND NO BUILDING OR STRUCTURE CAN BE USED OR OCCUPIED (IBC 111.1) UNTIL ALL THE DEFERRED SUBMITTED ITEMS ARE APPROVED BY THE BUILDING OFFICIAL.

FLOOR CARPET SHALL BE TESTED IN ACCORDANCE TO NATIONAL FIRE PROTECTION ASSOCIATION STANDARD 253 AND BE A CLASS I (0.45 WATTS/CM2) IN CORRIDORS, EXIT ENCLOSURES, EXIT PASSAGEWAYS AND CLASS II (0.22 WATTS/CM2) IN ALL ROOMS AND AREAS.

ACOUSTICAL CEILING PANELS SHALL BE LISTED AND TESTED AMERICAN SOCIETY OF TESTING MATERIALS (ASTM) E 84 AND HAVE A FLAME SPREAD OF 0-25 AND A SMOKE INDEX OF 0-450. IF THE CEILING TILE IS A COMPONENT PART OF A PLENUM SYSTEM THEN IT SHALL BE LISTED AND TESTED AMERICAN SOCIETY OF TESTING MATERIALS (ASTM) E 84 AND HAVE A FLAME SPREAD OF 0-25 AND A SMOKE INDEX OF 0-50.

FIRE ALARM SYSTEM SHALL BE INSTALLED WHEN THERE ARE EXTINGUISHING SYSTEMS IN THE BUILDING FOR OCCUPANT NOTIFICATION. FIRE ALARM SYSTEM HORN AND STROBE SHALL BE INSTALLED UNLESS WITHIN THE AREA APPLIANCES ARE INSTALLED AND THE AREA HAS THE REQUIRED DB RATING AS PRESCRIBED IN INTERNATIONAL FIRE CODE 907.5.2.1.1 & VISIBLE REQUIREMENTS IN SECTION 907.5.2.3

#### ajc architects

703 east 1700 south salt lake city, ut 84105 ajcarchitects.com

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PROJECT DESCRIPTION

## SELECTHEALTH BUILDING **TENANT IMPROVEMENT**

5381 S GREEN STREET MURRAY, UT 84123

Sheet Name:

FIRE SAFETY PLAN -LEVEL 06

revisions MARK DATE DESCRIPTION


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08/17/2023 BID SET M. TRAVIS 2023-15





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# GENERAL NOTES:

- REFER TO DOOR HARDWARE SPECIFICATIONS FOR DOOR HARDWARE ADA • REQUIREMENTS AND STANDARDS.
- REFER TO ELECTRICAL DRAWINGS FOR ELECTRICAL DEVICES ADA MOUNTING • HEIGHT REQUIREMENTS.
- REFER TO SITE PLAN FOR ACCESSIBLE ROUTE REQUIREMENTS AND DETAIL • REFERENCES. (NOT APPLICABLE TO ALL PROJECTS.)
- UNLESS NOTED AS "MIN." OR "MAX" DIMENSIONS SHOWN ARE ABSOLUTE. • DIMENSIONS SHOWN HERE SHALL GOVERN THE INSTALLATION OF ALL ACCESSIBLE FIXTURES AND ACCESSORIES, UNLESS MORE SPECIFIC DIMENSIONS ARE SHOWN ELSEWHERE IN THE CONTRACT DOCUMENTS THAT ARE WITHIN THE PERMISSIBLE LIMITS SHOWN HERE.
- MOUNTING HEIGHTS OF RESTROOM FIXTURES AND ACCESSORIES. PROVIDE • BACKING AT ALL WALL MOUNTED FIXTURES AND EQUIPMENT.
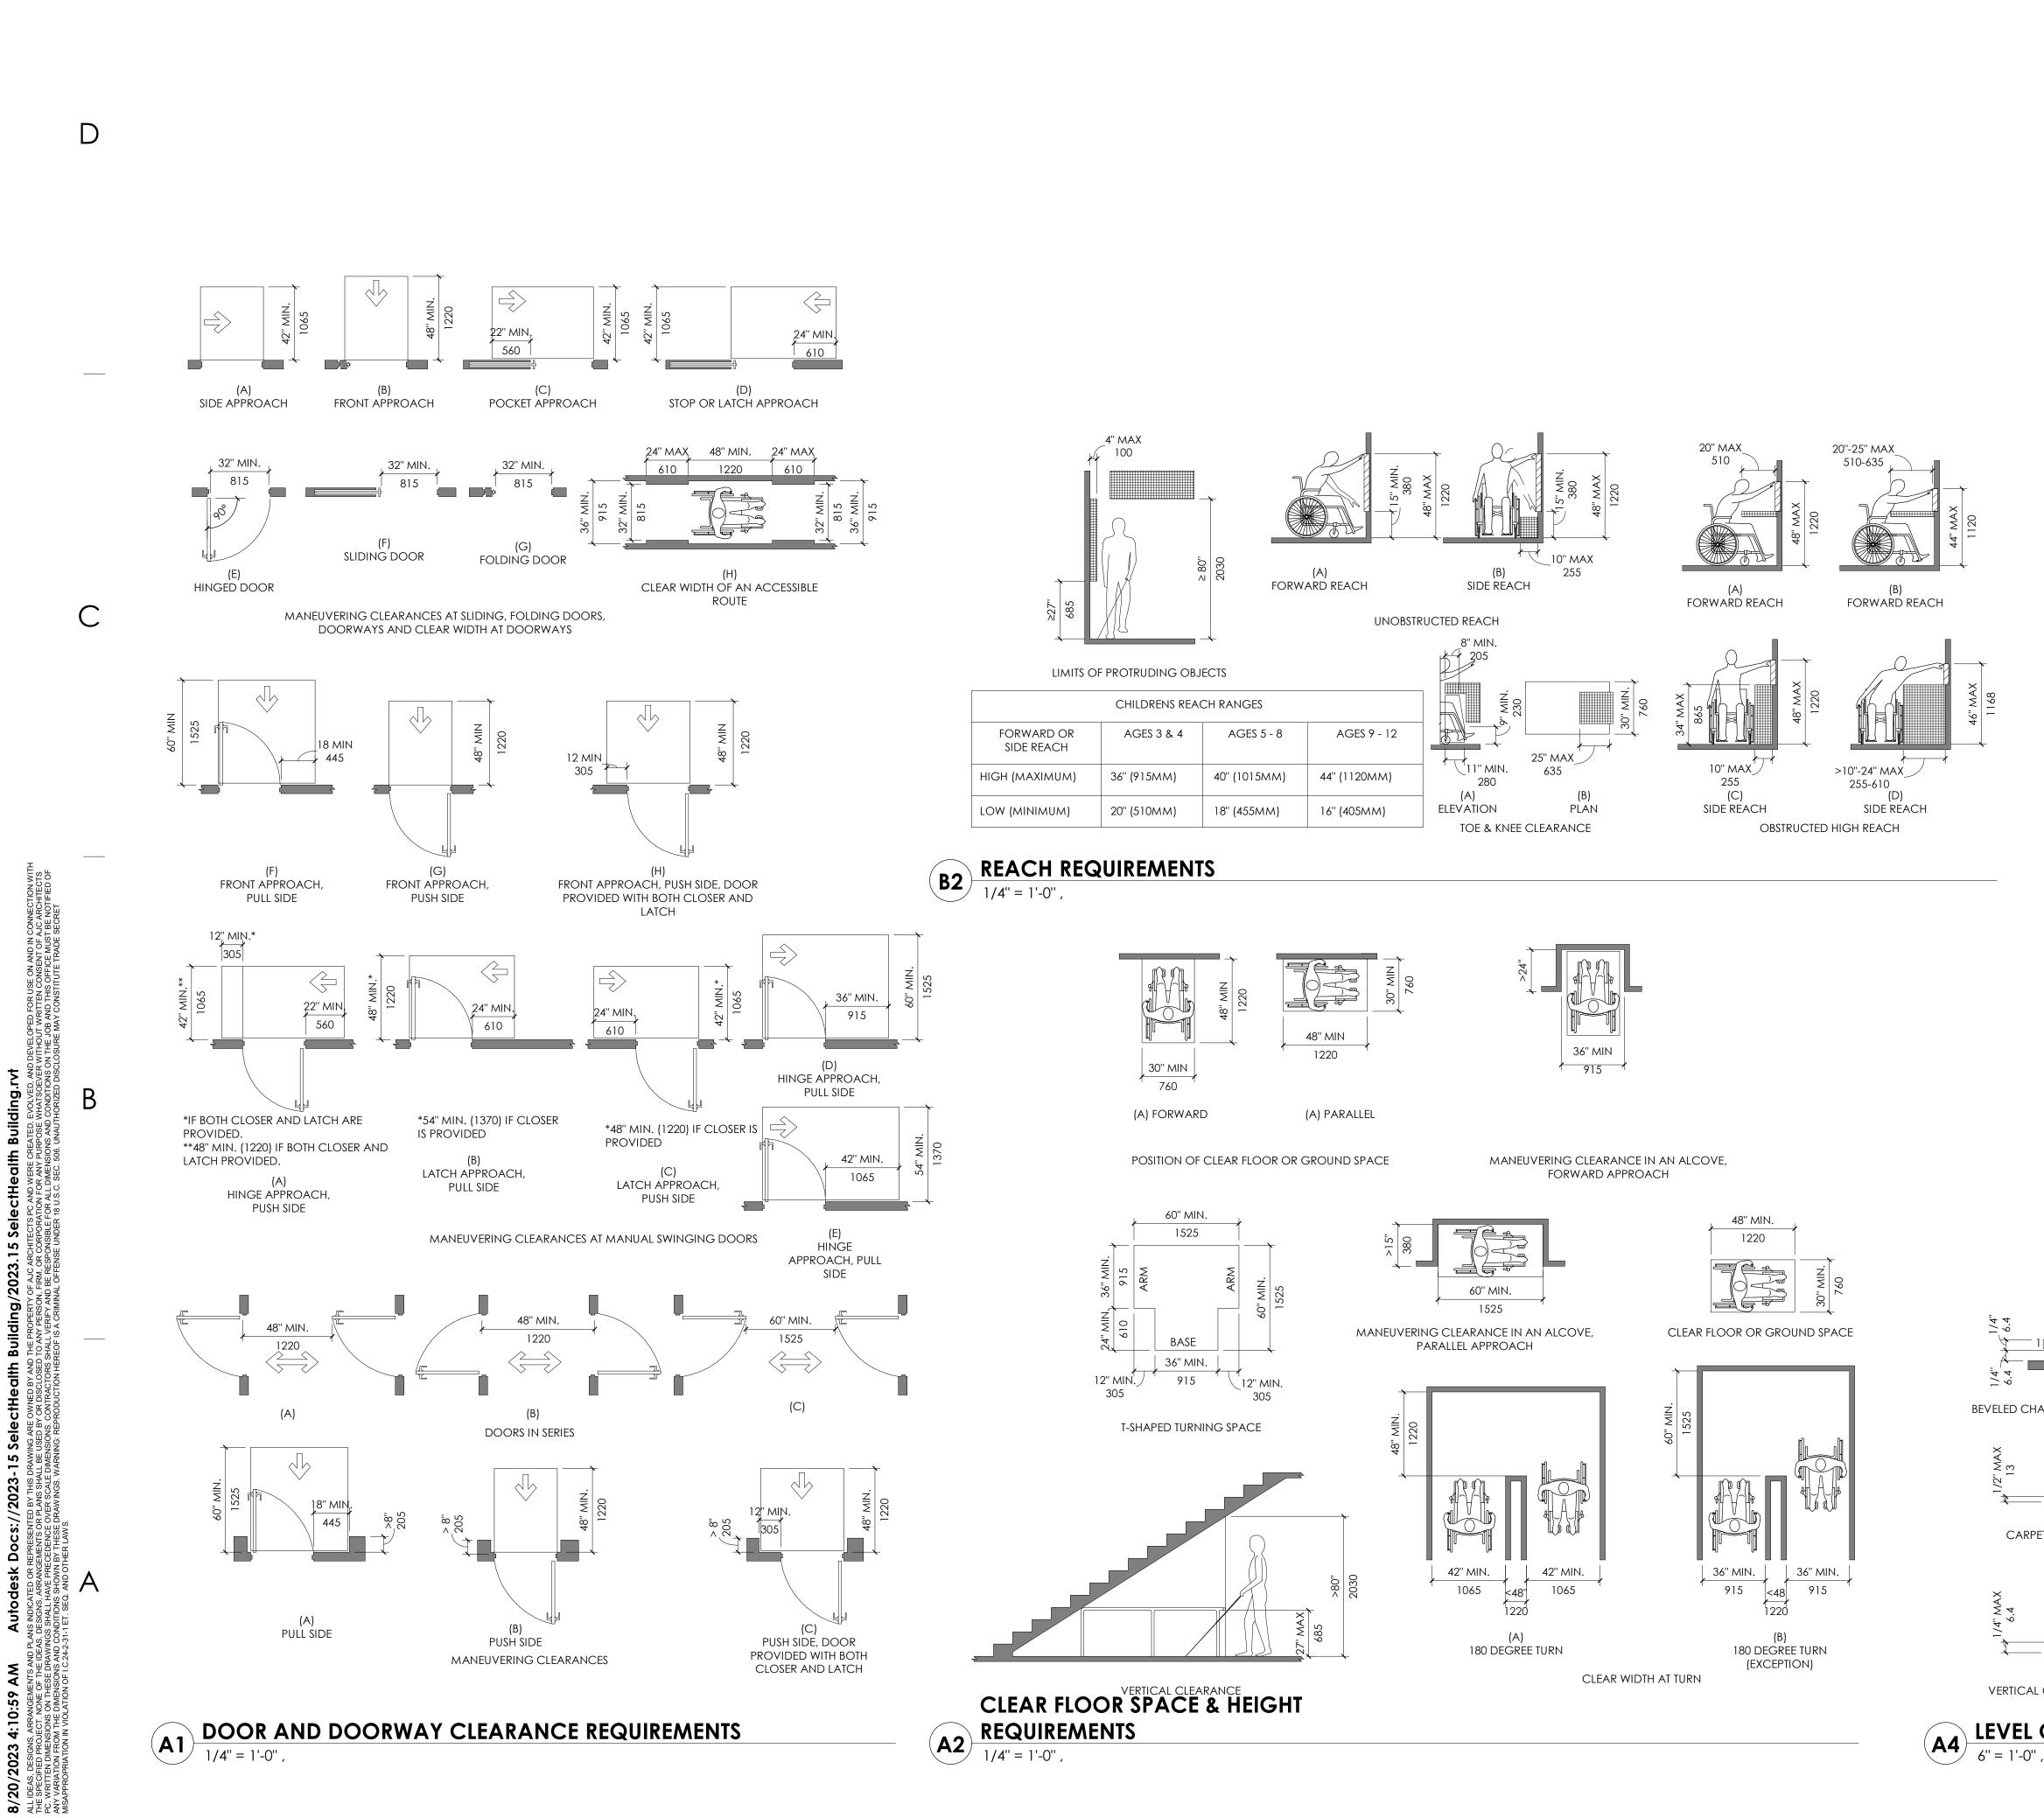
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#### SELECTHEALTH BUILDING **TENANT IMPROVEMENT**

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Sheet Name:

#### ADA REQUIREMENTS

REVISIONS

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BEVELED CHANGE IN LEVEL

≥ ຕ 1/2" + +

CARPET PILE HEIGHT

1/2+

VERTICAL CHANGE IN LEVEL

LEVEL CHANGE

ISSUE DATE: ISSUE TYPE: DRAWN BY: CHECKED BY: R. OLSON PROJECT#:

08/17/2023 **BID SET** J. HALBERT 2023-15



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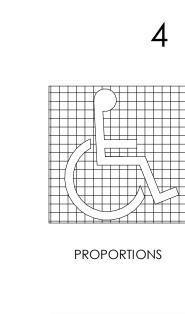
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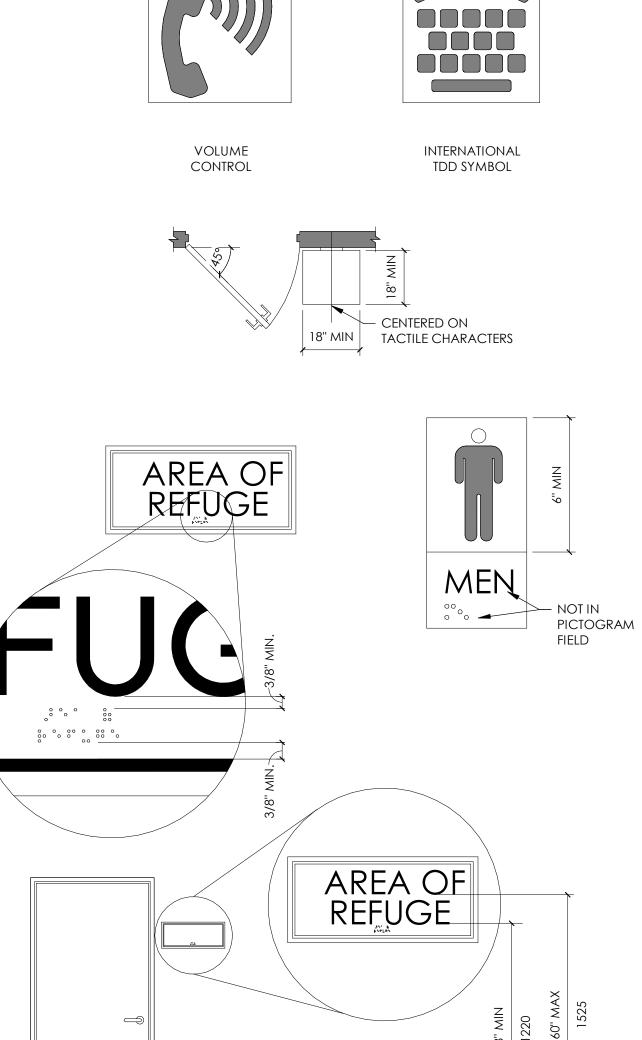
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DOOR SIGNAGE



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# GENERAL NOTES:

- REFER TO DOOR HARDWARE SPECIFICATIONS FOR DOOR HARDWARE ADA • REQUIREMENTS AND STANDARDS.
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- MOUNTING HEIGHTS OF RESTROOM FIXTURES AND ACCESSORIES. PROVIDE • BACKING AT ALL WALL MOUNTED FIXTURES AND EQUIPMENT.

## **LETTERS AND NUMBERS:**

1

4.

Letters and numbers on signs shall be raised 1/32" minimum and shall be sans-serif UPPERCASE CHARACTERS ACCOMPANIED BY GRADE 2 BRAILLE. (SEC. 1117B.5.6.1) RAISED CHARACTERS OR SYMBOLS SHALL BE A MINIMUM OF 5/8" HIGH. (SEC. 1117B5.6.2)

- PICTORIAL SYMBOL SIGNS (PICTOGRAMS) SHALL BE ACCOMPANIED BY THE EQUIVALENT VERBAL DESCRIPTION PLACED DIRECTLY BELOW THE PICTOGRAM. THE BORDER DIMENSION OF THE PICTOGRAM SHALL BE A MINIMUM OF 6" IN HEIGHT. (SEC. 1117B.5.6.3)
- Letters and numbers on signs shall have a width-to-height ratio of between 3:5 and 1:1 AND A STROKE WIDTH-TO-HEIGHT RATIO BETWEEN 1:5 AND 1:10. (SEC. 1117B.5.3) CHARACTERS AND SYMBOLS SHALL CONTRAST WITH THEIR BACKGROUND, EITHER LIGHT
- CHARACTERS ON A DARK BACKGROUND OR DARK CHARACTERS ON A LIGHT BACKGROUND. (SEC. 1117B.5.5) CHARACTERS AND NUMBERS ON SIGNS SHALL BE SIZED ACCORDING TO THE VIEWING DISTANCE
- 6. FROM WHICH THEY ARE TO BE READ. THE MINIMUM HEIGHT IS MEASURED USING AN UPPER CASE X. LOWER CASE CHARACTERS ARE PERMITTED. FOR SIGNS SUSPENDED OR PROJECTED ABOVE THE FINISH FLOOR IN COMPLIANCE WITH SECTION 1121B, THE MINIMUM CHARACTER HEIGHT SHALL BE 3". (SEC. 1117B.5.4)
- CONTRACTED GRADE 2 BRAILLE SHALL BE USED WHEREVER BRAILLE SYMBOLS ARE SPECIFICALLY 7. REQUIRED IN OTHER PORTIONS OF THESE REGULATIONS. DOTS SHALL BE 1/10" ON CENTERS IN EACH CELL WITH 2/10" SPACE BETWEEN CELLS. DOTS SHALL BE RAISED A MINIMUM OF 1/40" ABOVE THE BACKGROUND. (SEC. 1117B.5.2)

## **SIGN LOCATIONS:**

- ALL BUILDING ENTRANCES THAT ARE ACCESSIBLE TO AND USABLE BY PERSONS WITH DISABILITIES AND AT EVERY MAJOR JUNCTION ALONG OR LEADING TO AN ACCESSIBLE ROUTE OF TRAVEL SHALL BE IDENTIFIED WITH A SIGN DISPLAYING THE INTERNATIONAL SYMBOL OF ACCESSIBILITY AND WITH ADDITIONAL DIRECTIONAL SIGNS, AS REQUIRED, TO BE VISIBLE TO PERSONS ALONG APPROACHING PEDESTRIAN WAYS. (SEC. 1117B.5.7 & 1127B.3)
- WHEN PERMANENT IDENTIFICATION IS PROVIDED FOR ROOMS AND SPACES, RAISED LETTERS SHALL BE PROVIDED AND SHALL BE ACCOMPANIED BY BRAILLE IN CONFORMANCE WITH SECTION 1117B.5.6. SIGNS SHALL BE INSTALLED ON THE WALL ADJACENT TO THE LATCH OUTSIDE OF THE DOOR. WHERE THERE IS NO WALL SPACE ON THE LATCH SIDE, INCLUDING AT LEAF DOORS, SIGNS SHALL BE PLACE ON THE NEAREST ADJACENT WALL, PREFERABLY ON THE RIGHT. MOUNTING HEIGHT SHALL BE 60" ABOVE THE FINISH FLOOR TO THE CENTERLINE OF THE SIGN. MOUNTING LOCATION SHALL BE DETERMINED SO THAT THE PERSON MAY APPROACH WITHIN 3" OF THE SIGNAGE WITHOUT ENCOUNTERING PROTRUDING OBJECTS OR STANDING WITHIN THE SWING OF A DOOR. (SEC. 1117B.5.9)
- ADDITIONAL DIRECTIONAL SIGNS ALONG ACCESSIBLE PATH OF TRAVEL ARE REQUIRED. BUILDINGS REMODELED TO PROVIDE ACCESSIBLE SANITARY FACILITIES FOR PUBLIC USE SHALL HAVE INFORMATION POSTED IN THE LOBBY AS PART OF THE BUILDING DIRECTORY.

#### **INTERNATIONAL SYMBOL OF ACCESSIBILITY:** STANDARD USED TO IDENTIFY ACCESSIBLE FACILITIES.

WHITE FIGURE ON BLUE BACKGROUND, COLOR # 15090 ON FEDERAL STANDARD # 595A. WHEN ENFORCING AGENCY DETERMINES, IF APPROPRIATE, SPECIAL DESIGNS AND COLORS MAY BE APPROVED.

## **BRAILLE**:

4.

SEE 4/T-4 FOR MORE INFO.


- USE CONTRASTED GRADE 2 BRAILLE. DOTS TO BE 0.1 INCH ON CENTER IN EACH CELL.
- 0.2 INCH SPACE BETWEEN CELLS. DOTS RAISED MINIMUM 0.025 INCH ABOVE BACKGROUND.

#### ARCHITECT / CONSULTANT

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PROJECT DESCRIPTION

## SELECTHEALTH BUILDING **TENANT IMPROVEMENT**

#### **5381 S GREEN STREET** MURRAY, UT 84123

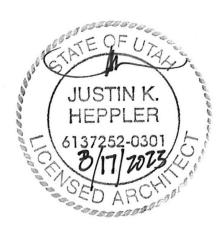Sheet Name:

#### **ADA REQUIREMENTS**

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ISSUE DATE: ISSUE TYPE: DRAWN BY: CHECKED BY: R. OLSON PROJECT#:

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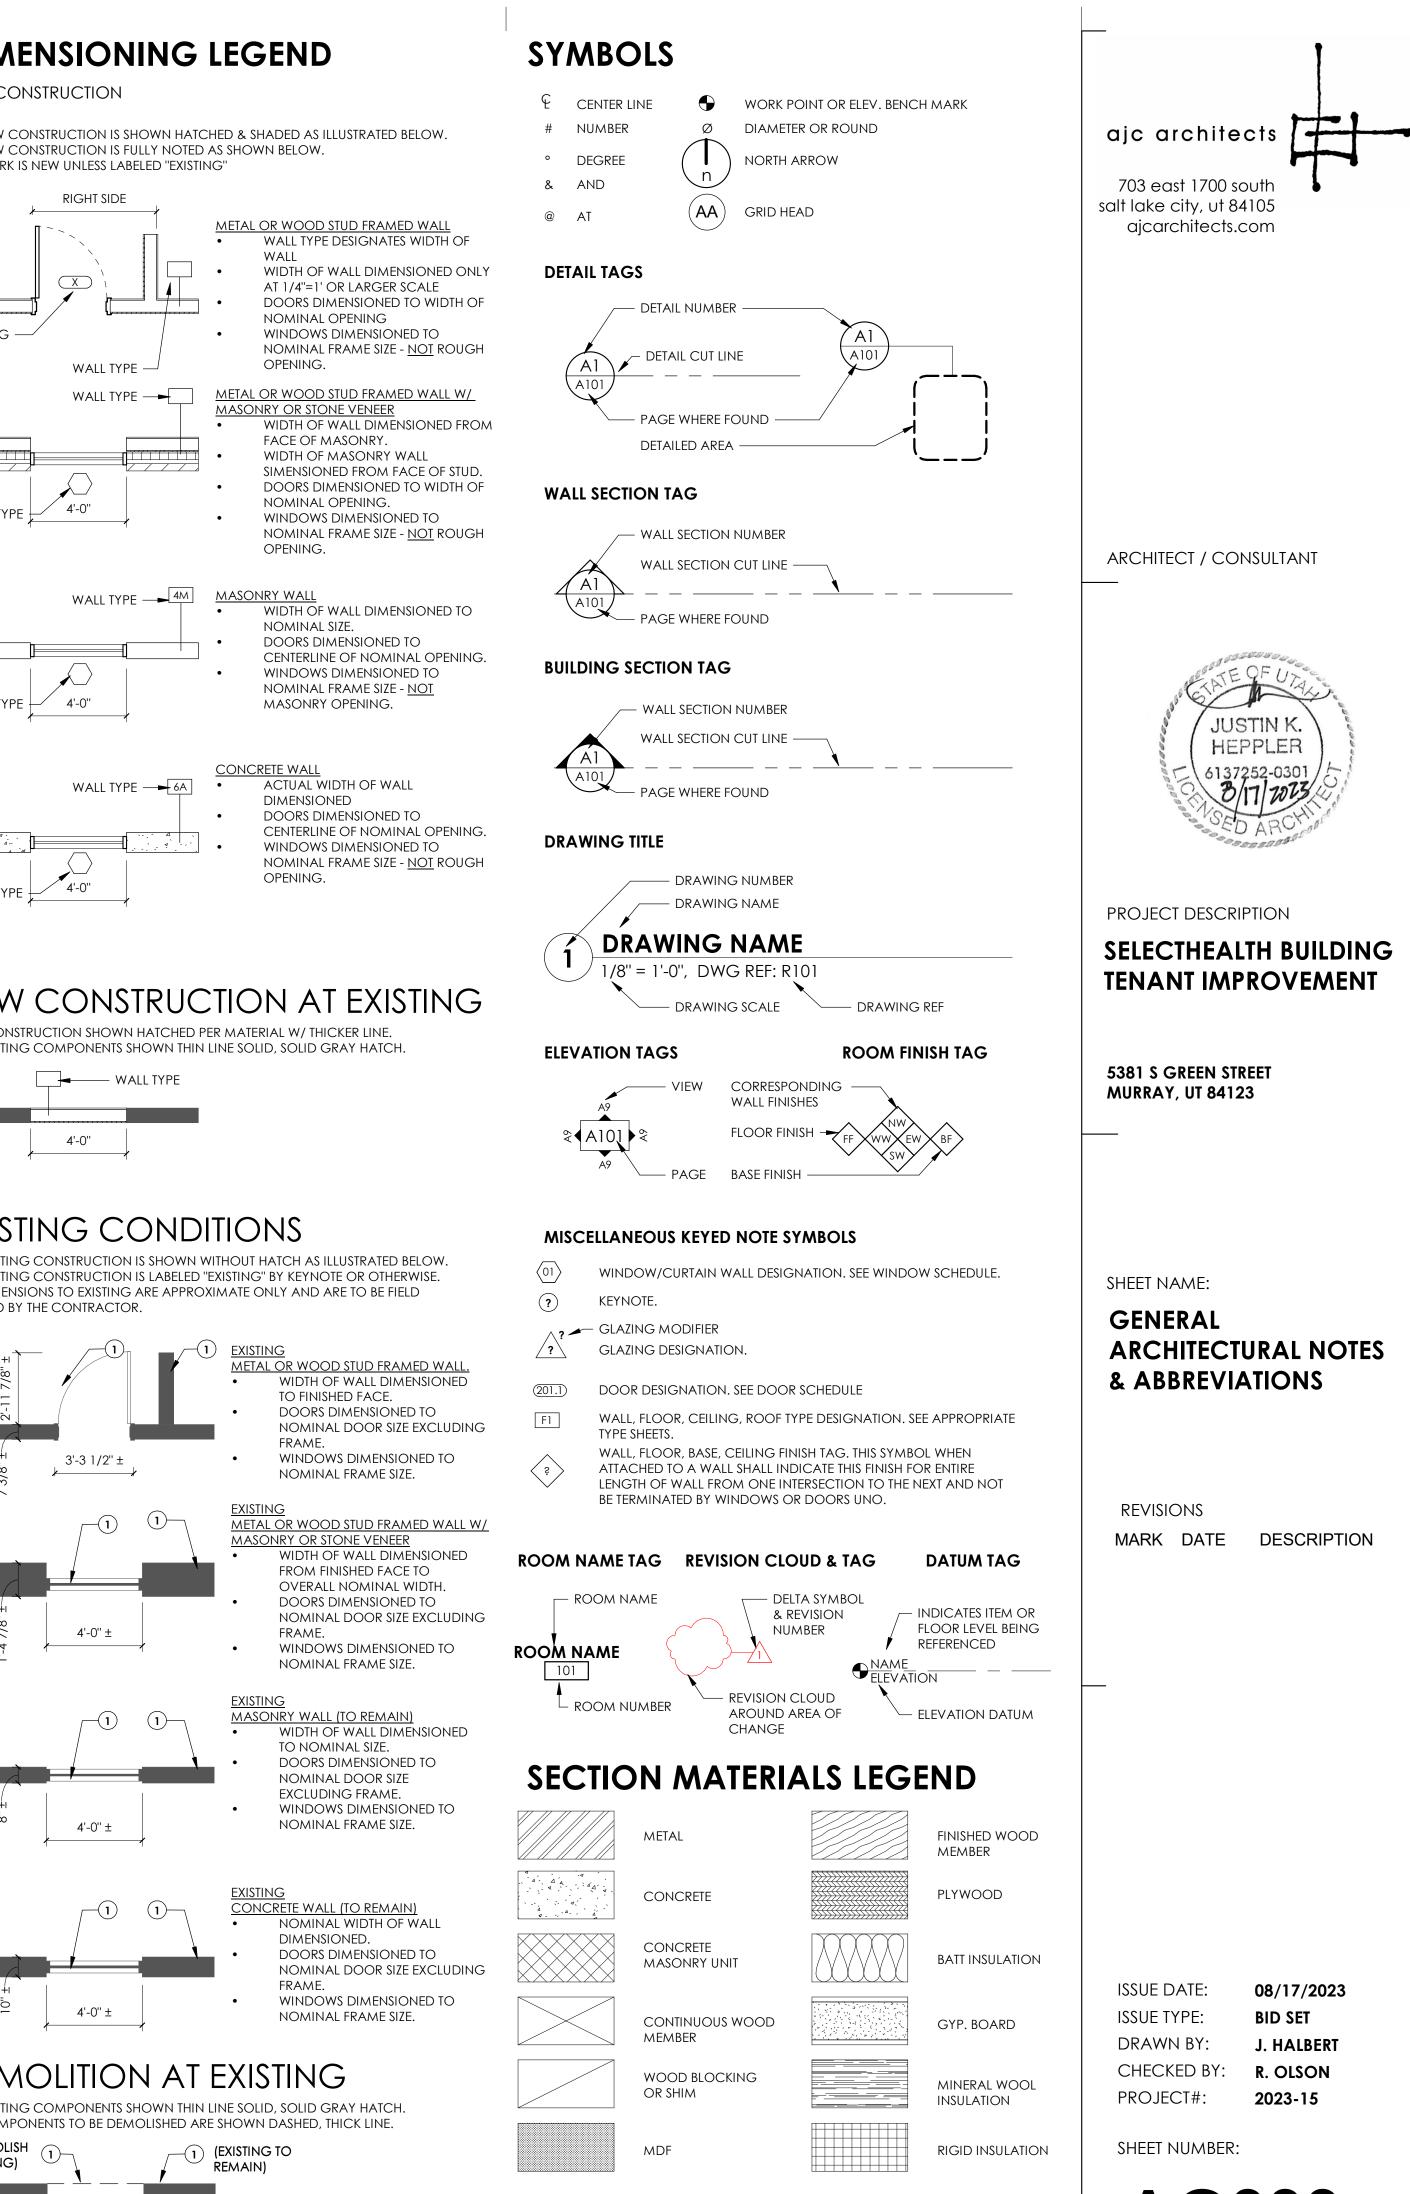
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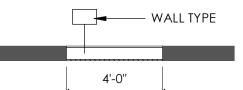
# **ABBREVIATIONS**

ABB A.F.F. AD ACOUS A/C ALUM AB APPR	ABBREVIATION (S) ABBREVIATION (S) ABOVE FINISHED FLOOR ACCESS DOOR ACOUSTICAL AIR CONDITIONING ALUMINUM ANCHOR BOLT APPROVED ASPHALT CONCRETE
BOT B.O. B.O.B.	BEAM BLOCK BOARD BOTTOM BOTTOM OF BOTTOM OF BEAM BUILDING
COL	CEILING CEILING HEIGHT CEMENT CENTER TO CENTER CERAMIC CLEAR CLOSET COLUMN COMPOSITION CONCRETE CONCRETE MASONRY UNIT CONNECTION CONTINUOUS COORDINATE CORRIDOR COUNTERSINK
DEL DEMO DET DIAG DIA DIM DIR DR DR DO DBL DF DN DS DWG DF	DELETE DEMOLITION DETAIL DIAGONAL DIAMETER DIMENSION DIRECTION DOOR DOOR OPENING DOUBLE DOUGLAS FIR DOWN DOWNSPOUT DRAWING DRINKING FOUNTAIN
EA EWC ELEC ELEV OR EL ELEV EQ EQUIP EXIST EJ EXT	EACH ELECTRIC WATER COOLER ELECTRICAL ELEVATION ELEVATOR EQUAL EQUIPMENT EXISTING EXPANSION JOINT EXTERIOR
EWC ELEC ELEV OR EL EQ EQUIP EXIST EJ EXT	ELECTRIC WATER COOLER ELECTRICAL ELEVATION ELEVATOR EQUAL EQUIPMENT EXISTING EXPANSION JOINT
EWC ELEC ELEV OR EL EQ EQUIP EXIST EJ EXT FOC FOS FOW FT FRP FIN FF FO FHC FLR FD FS FDN FH FS FDN FH FS FDN FH FS FSD GALV OR GV GA GC GL GC GR	ELECTRIC WATER COOLER ELECTRICAL ELEVATION ELEVATOR EQUAL EQUIPMENT EXISTING EXPANSION JOINT EXTERIOR FACE OF CONCRETE FACE OF STUD FACE OF WALL FEET FIBER REINFORCED PLASTIC FINISH FINISH FLOOR FINISH FLOOR FINISH FLOOR FINISHED OPENING FIRE HOSE CABINET FLOOR DRAIN FLOOR SINK FOUNDATION FULL HEIGHT FULL SIZE
EWC ELEC ELEV OR EL EQ EQUIP EXIST EJ EXT FOC FOS FOW FT FRP FIN FF FO FHC FLR FD FS FDN FH FS FDN FH FS FDN FH FS FSD GALV OR GV GA GC GL GC GR	ELECTRIC WATER COOLER ELECTRICAL ELEVATION ELEVATOR EQUAL EQUIPMENT EXISTING EXPANSION JOINT EXTERIOR FACE OF CONCRETE FACE OF WALL FET FIBER REINFORCED PLASTIC FINISH FLOOR FINISH FLOOR FINISHED OPENING FIRE HOSE CABINET FLOOR FLOOR DRAIN FLOOR SINK FOUNDATION FULL HEIGHT FULL SIZE FULL SIZE FULL SIZE DETAIL GALVANIZED GAUGE GENERAL CONTRACTOR GLASS GLASS FIBER REINFORCED CONCRETE GRADE
EWC ELEC ELEV OR EL EQ EQUIP EXIST EJ EXT FOC FOS FOW FT FRP FIN FF FO FLR FD FS FDN FH FS FSD GALV OR GV GA GC GL GC GL GFRC C HDWD H HP HM	ELECTRIC WATER COOLER ELECTRICAL ELEVATION EQUAL EQUIPMENT EXISTING EXPANSION JOINT EXTERIOR FACE OF CONCRETE FACE OF STUD FACE OF WALL FEET FIBER REINFORCED PLASTIC FINISH FLOOR FINISH FLOOR FINISH FLOOR FINISHED OPENING FIRE HOSE CABINET FLOOR DRAIN FLOOR SINK FOUNDATION FULL HEIGHT FULL SIZE FULL SIZE DETAIL GALVANIZED GAUGE GENERAL CONTRACTOR GLASS GLASS FIBER REINFORCED CONCRETE GRADE GYPSUM BOARD HARDWOOD HIGH HIGH POINT HOLLOW METAL


LTG	LIGHTING
MAINT	MAINTENANCE
MFG	MANUFACTURER
MO	MASONRY OPENING
MAT'L MAX	MATERIAL MAXIMUM
	MAXIMUM MECHANICAL
MB	MECHANICAL BOLT
MET	METAL
MEZZ	
MIN MISC	MINIMUM MISCELLANEOUS
MULL	MULLION
(N) NR	NEW NON-RATED
N.I.C.	NOT IN CONTRACT
N.T.S.	NOT TO SCALE
NO.	NUMBER
OFF	OFFICE
OC	ON CENTER
OPN'G	OPENING
OCC OPP	OPERATOR CONTROL CENTER OPPOSITE
OFF	OPPOSITE HAND
OD	OUTSIDE DIAMETER
OF	OVERFLOW
OFI OFCI	OWNER FURNISH ITEM OWNER FURNISHED
	CONTRACTOR INSTALLED
OFOI	OWNER FURNISHED OWNER
	INSTALLED
PR	PAIR
PLAS	PLASTIC
PL PLWD	PLATE PLYWOOD
	PORTLAND CEMENT
PREP	PREPARATION
PT	PRESSURE TREATED
PTDF	PRESSURE TREATED DOUGLAS
PROJ	PROJECTION
QT	QUARRY TILE
QI	QUARTIEL
REF	FREFERENCE
r or rad Redw'd	REDWOOD
REFL	REFLECTED
RCP	REFLECTED CEILING PLAN
	REINFORCE
req'd res	REQUIRED RESILIENT
RR	RESTROOM(S)
R	RISER
RD RTU	ROOF DRAIN ROOF TOP UNIT
RM	ROOM
R.O.	ROUGH OPENING
SECT	SECTION
SHT	SHEET
SIM	SIMILAR
SPECS SQ	SPECIFICATIONS SQUARE
SS	STAINLESS STEEL
	STANDARD
• · · ·	STATION STEEL
STG	STORAGE
STRUCT	STRUCTURAL
SUSP SYM	SUSPENDED SYMMETRICAL
	TELEPHONE TEMPERED
THK	THICK
T&G	TONGUE & GROOVE
	TOP BACK OF CURB
т.О. т.О.С.	TOP OF TOP OF CONCRETE OR CURB
	TOP OF FOOTING
	TOP OF STEEL TOP OF WALL
T.O.W. TDC	TRAFFIC DECK COVERING
T	TREAD
TYP	TYPICAL
UNO	UNLESS NOTED OTHERWISE
V.I.F.	VERIFY IN FIELD
VER	VERTICAL
WC	WATER CLOSET
WL WP	
WP W	WATERPROOFING WIDE
W/	WITH
WD	WOOD
WP WI	WORKING POINT WROUGHT IRON
	· · · · · · · · · · · · · · · · · · ·

NEW CONSTRUCTION






## **EXISTING CONDITIONS**

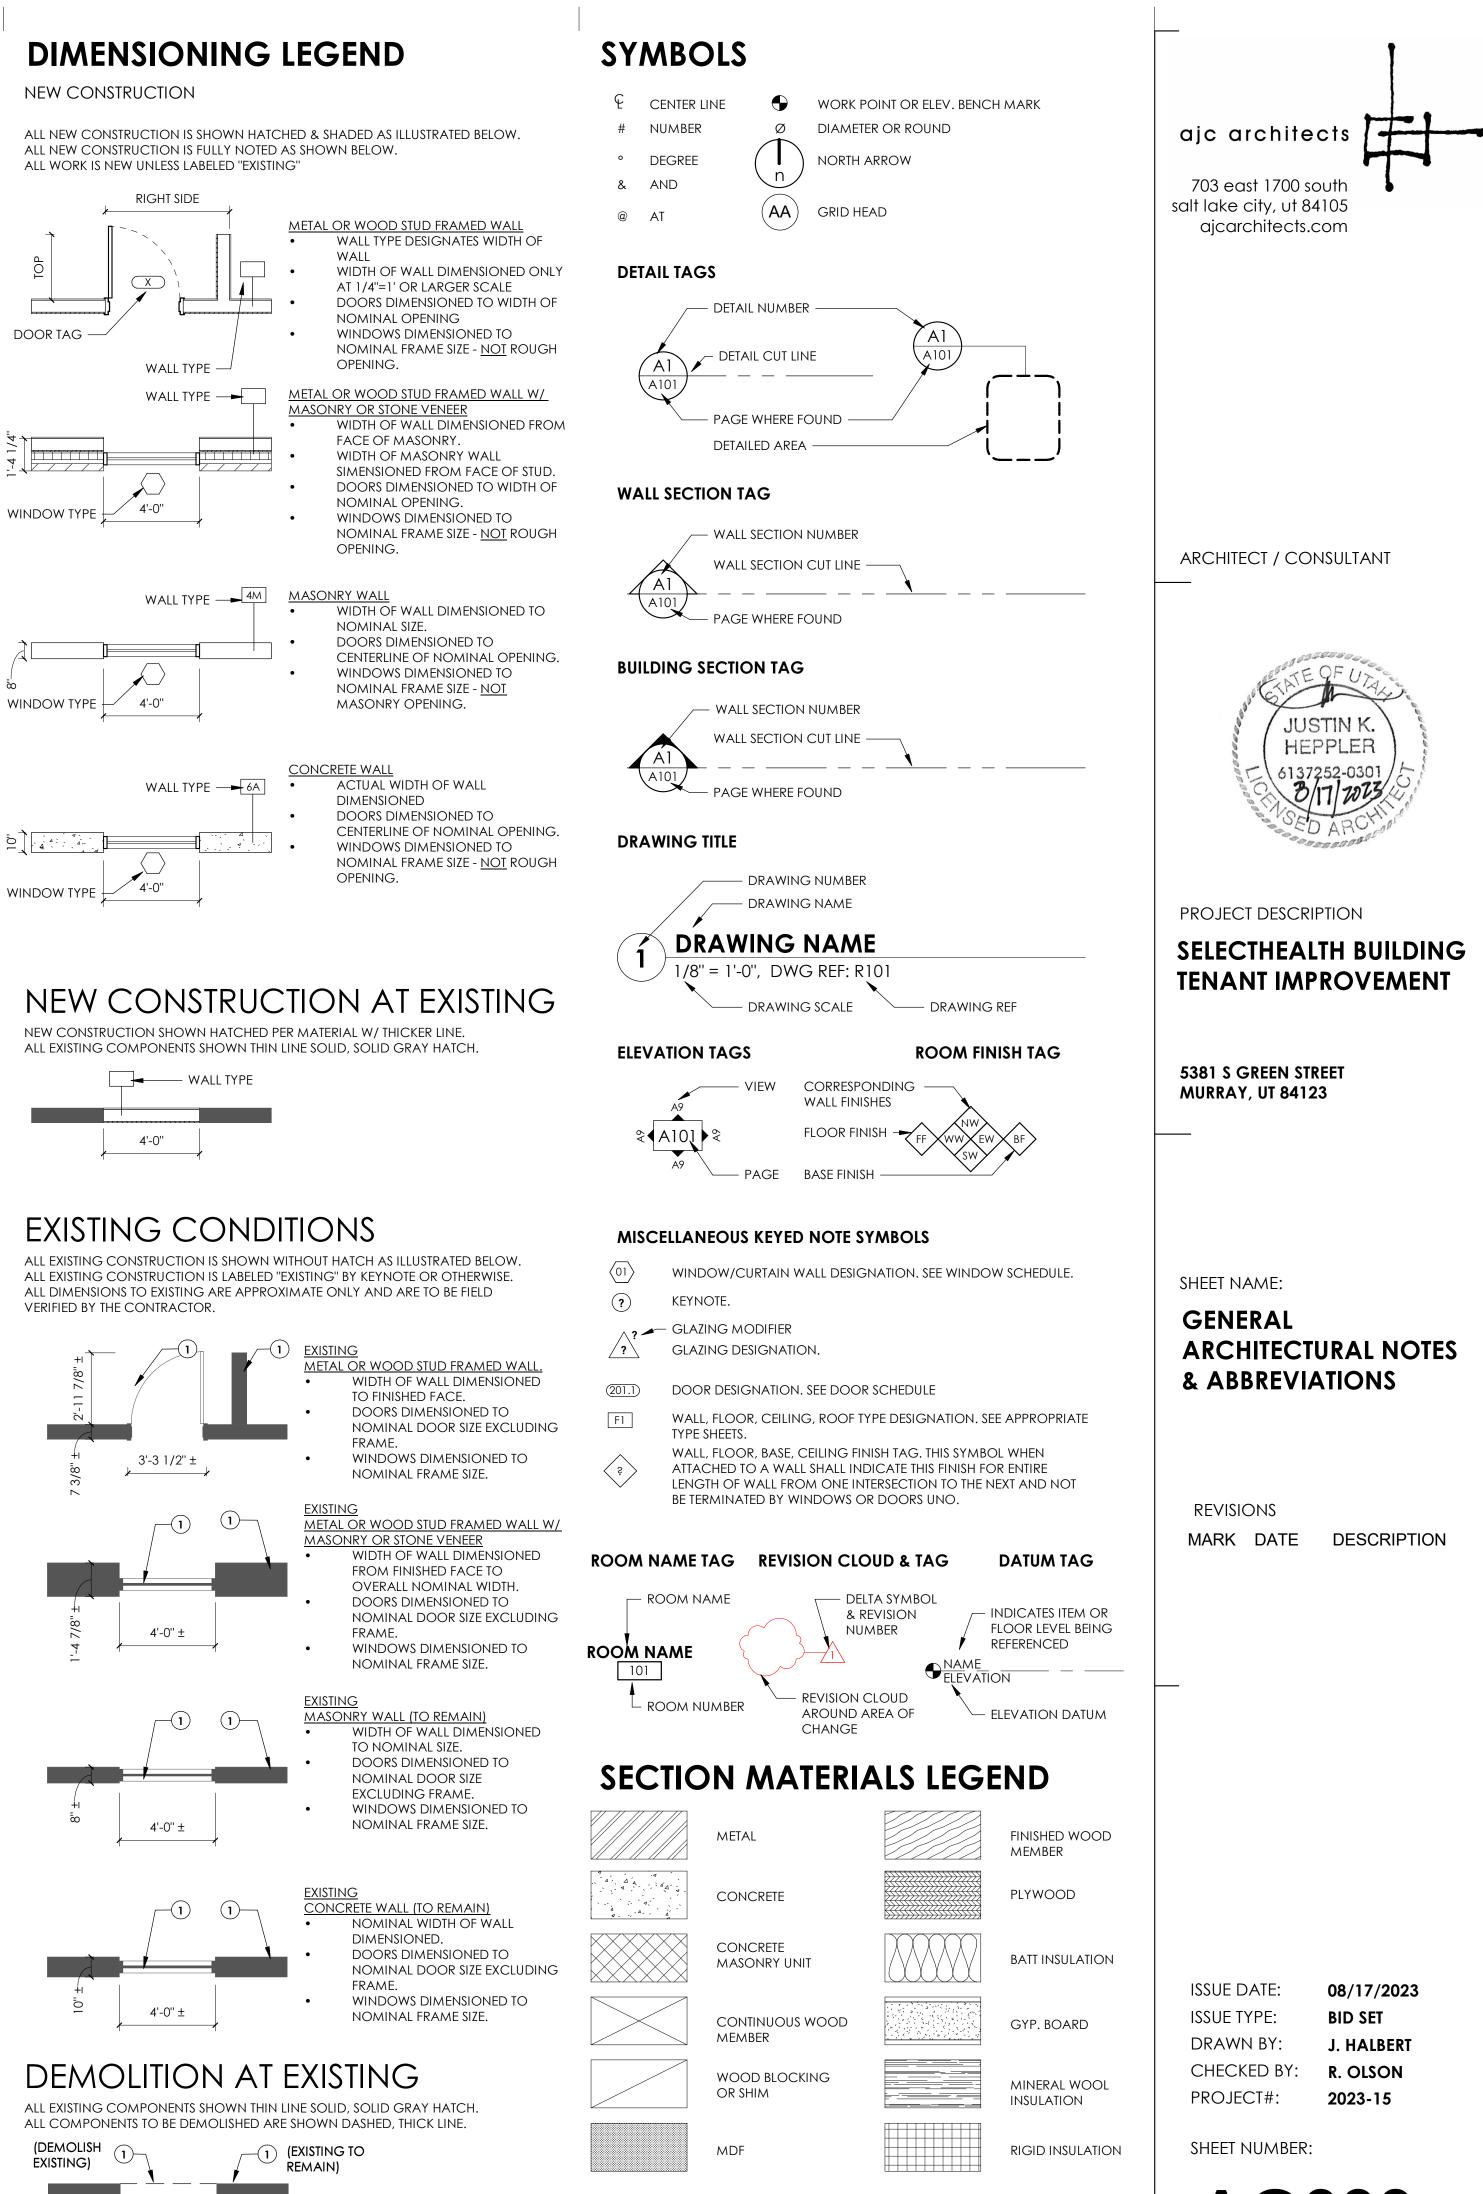

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# **GENERAL NOTES:**

SEE SHEET GOO1 FOR DRAWING INDEX.

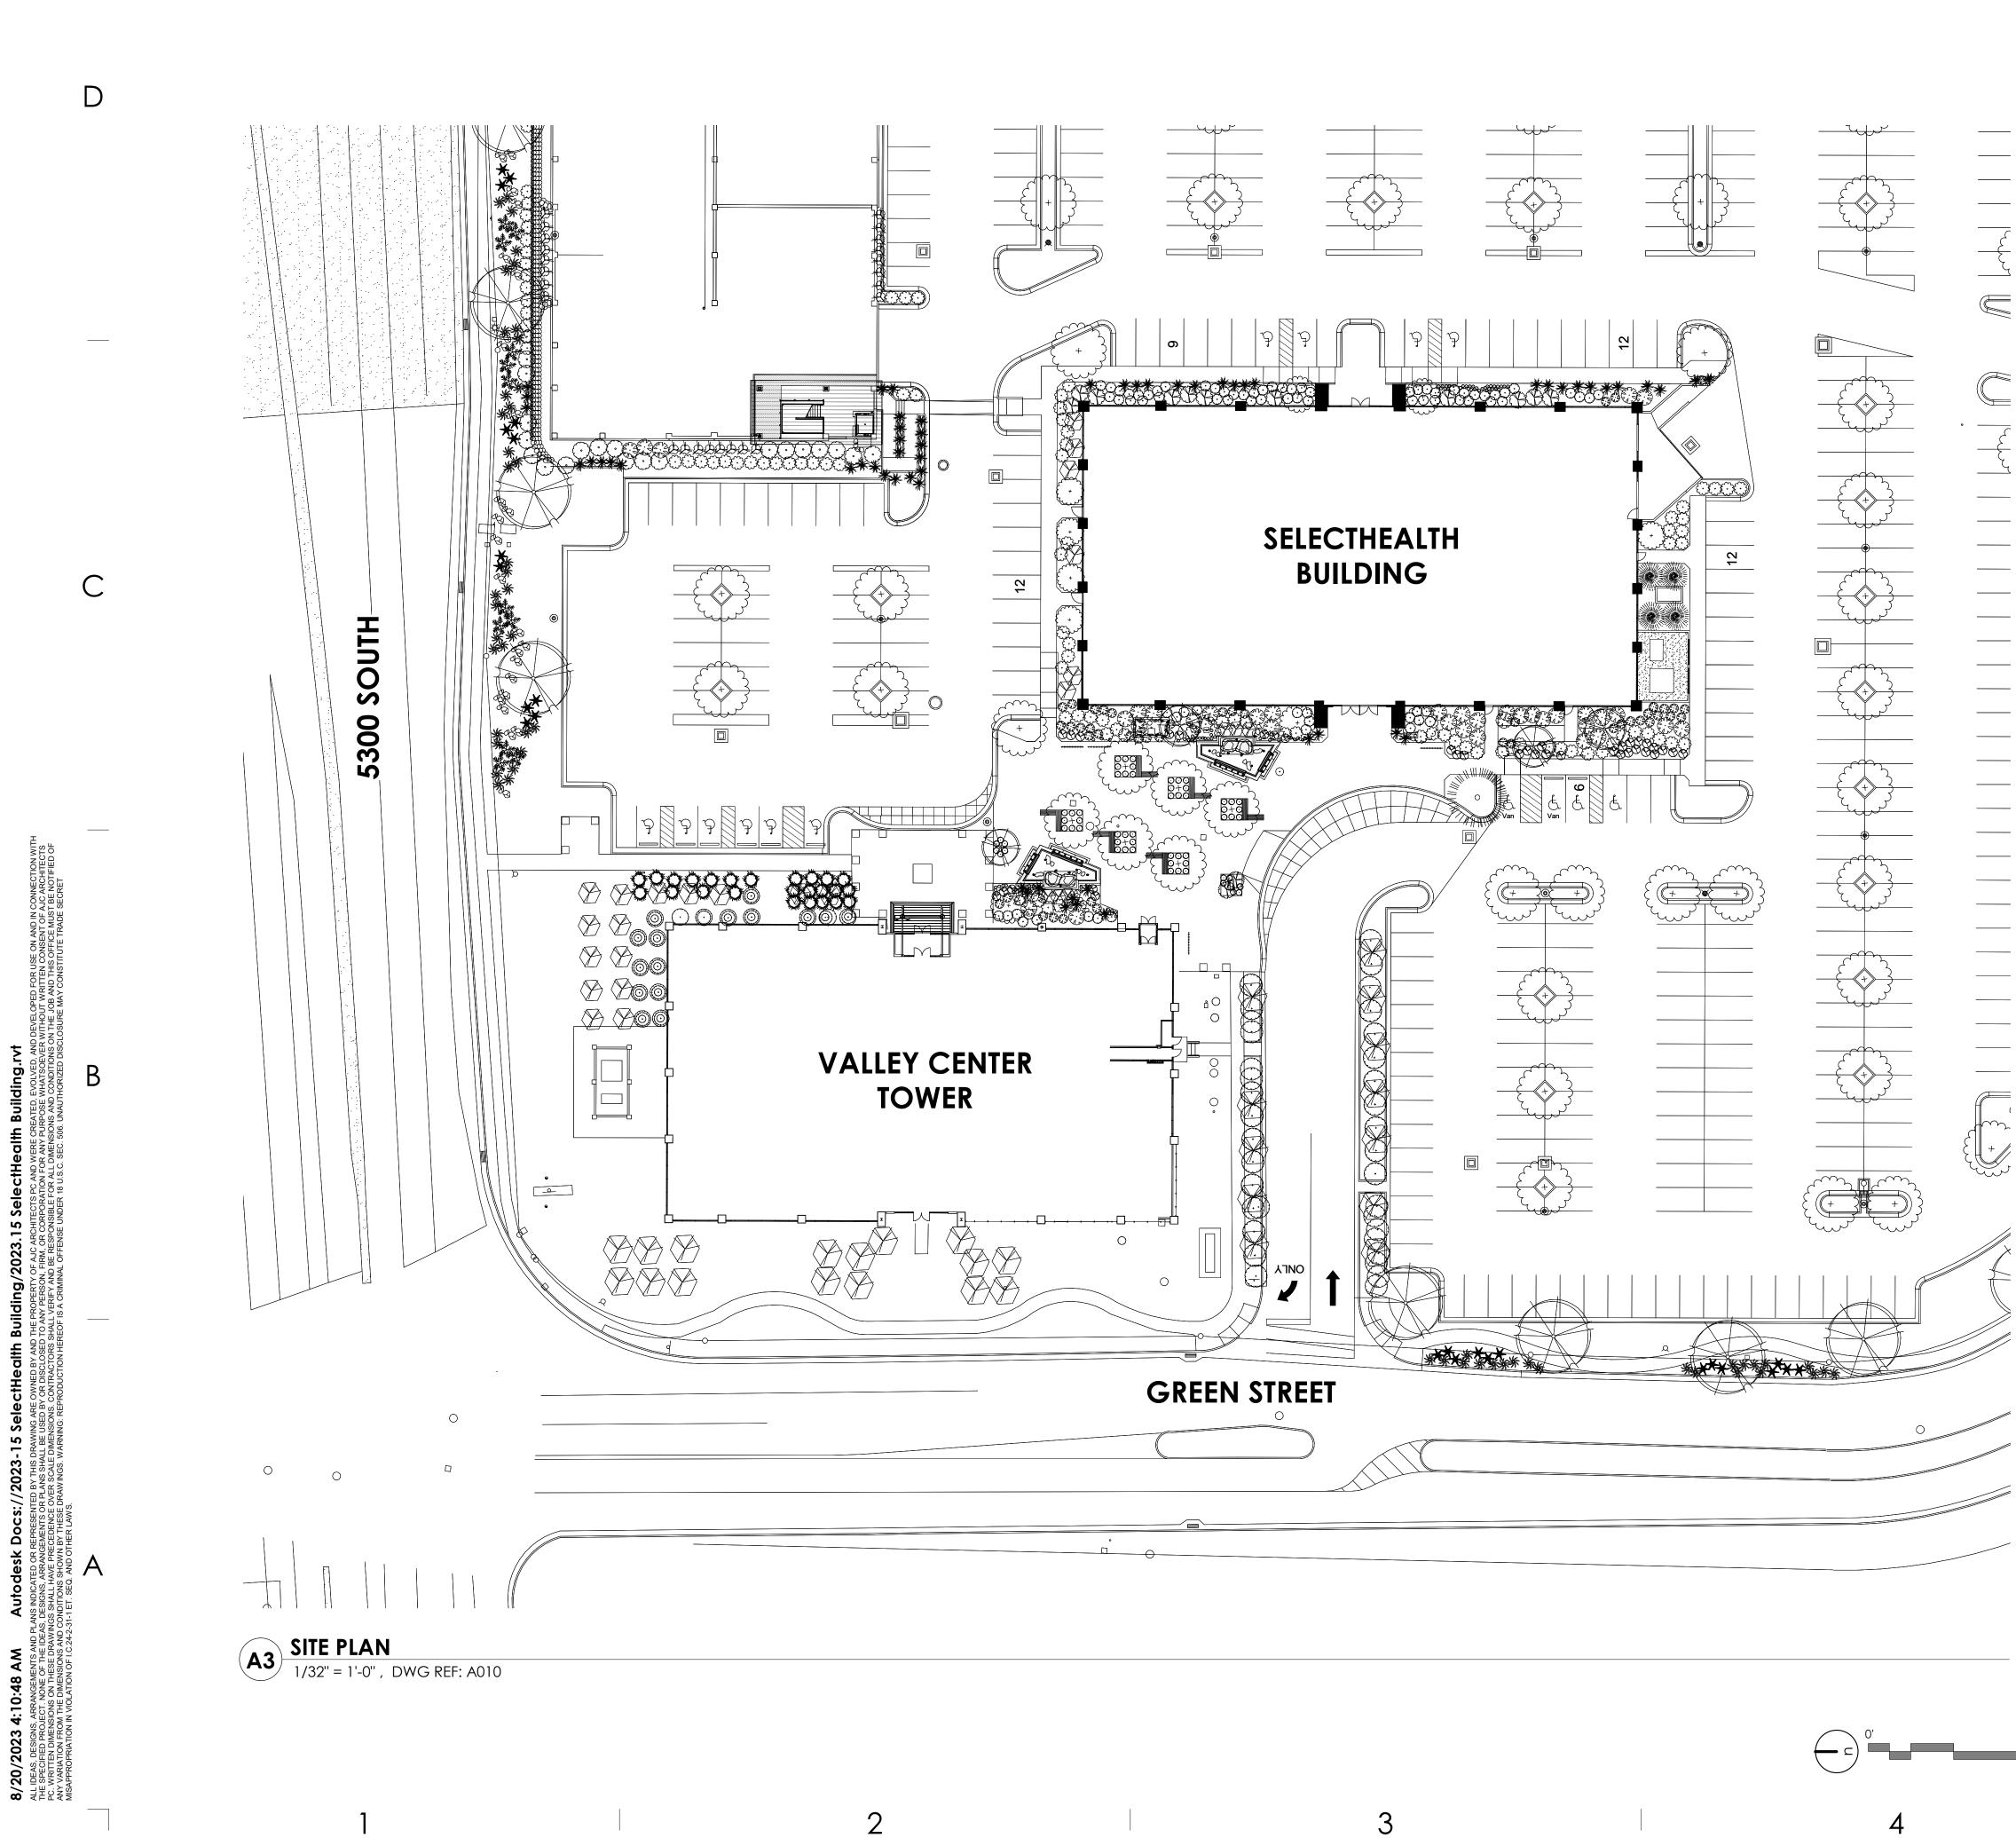SEE SHEET AG000 FOR GENERAL ARCHITECTURAL NOTES AND ABBREVIATIONS.

do not scale drawings.

CONTRACTOR / SUBCONTRACTOR SHALL VERIFY ALL DIMENSIONS AND CONDITIONS BEFORE BEGINNING WORK, AND SHALL REPORT TO THE ARCHITECT ANY ERRORS, INCONSISTENCIES OR OMISSIONS BEFORE BEGINNING WORK. SEE GENERAL NOTES AND SPECIFICATIONS.

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ajc architects 🗲

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ARCHITECT / CONSULTANT



PROJECT DESCRIPTION

#### SELECTHEALTH BUILDING TENANT IMPROVEMENT

5381 S GREEN STREET MURRAY, UT 84123

Sheet NAME:


**ARCHITECTURAL SITE** PLAN

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ISSUE DATE: ISSUE TYPE: DRAWN BY: CHECKED BY: R. OLSON PROJECT#:

08/17/2023 **BID SET** J. HALBERT 2023-15




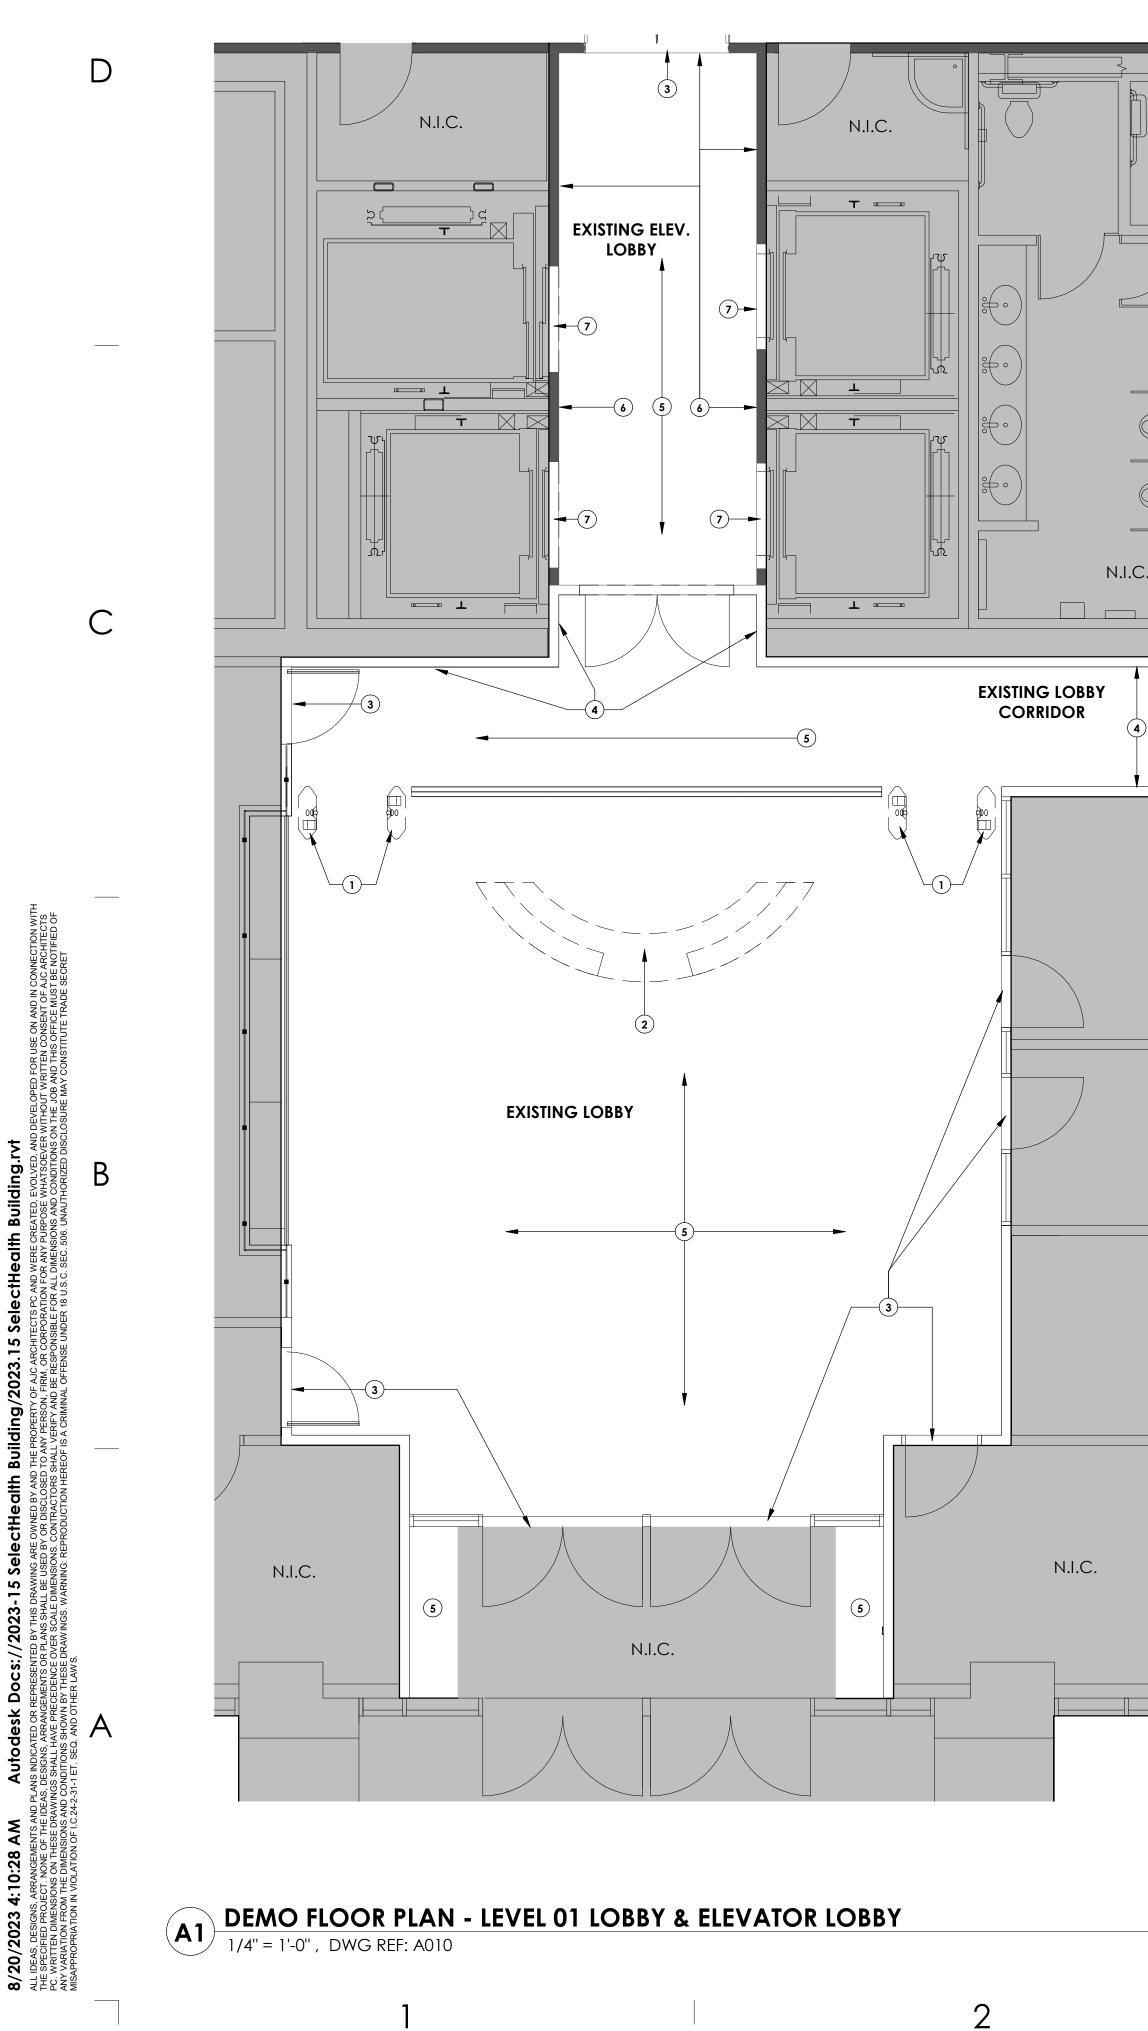

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# **GENERAL NOTES:**

SEE SHEET GOO1 FOR DRAWING INDEX.

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## **DEMOLITION NOTES**

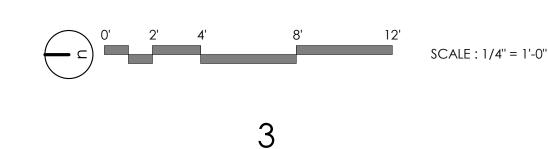ALL ITEMS SHOWN ON THIS PAGE ARE EXISTING TO REMAIN UNLESS NOTED OTHERWISE GRAPHICALLY OR BY KEYED NOTE. EXTENTS OF THIS SELECTIVE DEMOLITION PACKAGE ARE THE BUILDING'S ENVELOPE AND ANY SMALL PENETRATIONS TO BE SEALED TO MAINTAIN AN AIRTIGHT ENVELOPE. CONTRACTOR TO PROVIDE ANY TEMPORARY CONSTRUCTION TO MAINTAIN ENVELOPE INTEGRITY.

STANDARD GRAPHIC REPRESENTATIONS OF WALLS, DOORS, PLUMBING FIXTURES & TOILET ACCESSORIES INDEPENDENTLY REFERENCE DEMO OR EXISTING TO REMAIN CONDITIONS WITH OR WITHOUT AN ATTACHED KEYED NOTE. PROVIDE DEMO OF ALL ITEMS SHOWN DASHED. (SEE PRECEDING NOTE).

SEE MECHANICAL/PLUMBING (MD/PD) DEMO & ELECTRICAL (ED) DEMO SHEETS AND SPECIFICATIONS FOR ADDITIONAL DEMOLITION OR EXISTING CONDITIONS INFORMATION. WHERE PLUMBING, MECHANICAL OR ELECTRICAL ITEMS ARE SHOWN DEMO'D ON THIS PAGE. THE INFORMATION IS SUPPLIED AS A SUPPLEMENT TO THE MD SHEETS AND ED SHEETS. THE EXTENT OF THE DEMOLITION IS AS PER REQUIRED BY THE SPECIFICATIONS, MD SHEETS AND ED SHEETS.

DISPOSE OF ALL MATERIALS MARKED AS "REMOVE" OR "DEMO" RECYCLE REMOVED MATERIALS WHENEVER PRACTICAL." CONDITIONS MARKED "SALVAGED" ARE REUSED DURING NEW CONSTRUCTION AND SHOULD BE PROTECT UNTIL REINSTALLATION. COORDINATE WITH ARCHITECT ANY DISCREPENCIES.

REMOVE EXISTING MILLWORK AND PLUMBING FIXTURE(S) WHERE SHOWN. REMOVE PLUMBING PER SPEC. & PD SHEETS. CAP PLUMBING LINES AT BUILDING ENVELOPE.

REMOVE ALL INTERIOR DOOR/WINDOW FRAME AND GLAZING WHERE SHOWN.

EXISTING ROOF DRAIN LINE DROPS TO REMAIN U.N.O. PROTECT. SEE PLUMBING.

REMOVE EXISTING (STUBBED OUT OR PARTIALLY DEMO'D) PIPING AS PER SPEC. & MECHANICAL/PLUMBING SHEETS. CAP AT BUILDING ENVELOPE WHERE OCCURS.

REMOVE EXISTING ELECTRICAL AND LIGHTING WHERE SHOWN. SEAL PENETRATIONS THROUGH BUILDING ENVELOPE WHERE OCCURS.

REMOVE EXISTING CARPET AND BASE WHERE SHOWN. RECYCLE TO EXTENT POSSIBLE. REMOVE EXISTING TILE, BASE AND SETTING BEDS, WHERE SHOWN. RECYCLE TO EXTENT

REFLECTED CEILING PLANS ARE NOT INTENDED TO BE A LIGHTING DEMOLITION PLAN. NO WALL MOUNTED LIGHTING FIXTURES OR OTHER WALL MOUNTED APPURTENANCES ARE SHOWN. SEE THE LIGHTING DEMO PLAN FOR ALL LIGHTING AND EGRESS SIGNS, SIZE AND TYPES OF ELECTRICAL FIXTURES ETC. SEE MECHANICAL PLANS FOR ALL CEILING MOUNTED DIFFUSERS /GRILLES ETC.

MAINTAIN EXISTING FLOOR/CEILING/ROOF/CEILING AND SHAFT FIRE RATINGS AND ASSEMBLIES. REPAIR AND SEAL ALL PUNCTURES AND GAPS.

EXISTING METAL STUD & GYP BOARD WALL SHOWN DASHED TO BE REMOVED/RECYCLED IN ITS ENTIRETY.

EXISTING DOOR & FRAME SHOWN DASHED TO BE REMOVED/RECYCLED IN ITS ENTIRETY.

REMOVE AND RECYCLE/SALVAGE ALL EXISTING FURNITURE, FIXTURES, AND EQUIPMENT, SHOWN DASHED.

## **DEMOLITION DEFINITIONS**

**REMOVE:** UNLESS ITEMS ARE OTHERWISE INDICATED TO BE REINSTALLED OR SLAVAGED, REMOVE AND DISPOSE BY RECYCLING TO GREATEST EXTENT POSSIBLE OR IS PRACTICAL

**REMOVE AND REINSTALL:** REMOVE ITEMS INDICATED; CLEAN, SERVICE ND OTHERWISE PERPARE FOR SERVICE; REINSTALL IN THE SAME LOCATION (OR IN THE LOCATION INDICATED).

**REMOVE AND INSTALL NEW:** REMOVE AND DISPOSE OF ITEMS INDCATED AND INSTALL NEW ITEMS IN THE SAME LOCATION (OR IN THE LOCATION INDICATED).

**REMOVE AND SALVAGE:** ITEMS INDICATED TO BE SALVAGED WILL REMAIN THE OWNER'S PROPERTY. CAREFULLY REMOVE AND CLEAN ITEMS INDICATED TO BE SALVAGED; PACK OR CRATE TO PROTECT AGAINST DAMAGE; IDENTIFY CONTENTS OF CONTAINERS; DELIVER TO THE LOCATION INDICATED.

**REMOVE AND RECYCLE:** REMOVE AND RECYCLE TO THE GREATEST EXTENT PRACTICAL OF ITEMS INDICATED. ALL DEMOLISHED OR REMOVED ITEMS AND MATERIALS SHALL BE CONSIDERED SCRAP, EXCEPT FOR THOSE INDICATED TO REMAIN, THOSE INDICATED TO BE REINSTALLED, AND THOSE INDICATED TO BE salvaged.

EXISTING TO REMAIN: CONSTRUCTION OR ITEMS INDICATED TO REMAIN SHALL BE PROTECTED AGAINST DAMAGE DURING DEMOLITION OPERATIONS. WHERE PRACTICABLE, AND WITH THE ARCHITECT'S PERMISSION, THE CONTRACTOR MAY ELECT TO REMOVE ITEMS TO A SUITABLE STORAGE LOCATION DURING DEMOLITION AND THEN PROPERLY CLEAN AND REINSTALL THE ITEMS.

## **KEY NOTES:**

- EXISTING TURNSTILES TO BE REMOVED.
- DEMOLISH EXISTING CASEWORK
- EXISTING DOOR TO REMAIN AND BE PROTECTED DURING CONSTRUCTION. DEMO EXISTING TILE ON WALLS, PATCH AND REPAIR SUBSTRATE AS 4
- REQUIRED DEMO EXISTING FLOOR FINISH AND WALL BASE, PREP FOR NEW FLOOR
- FINISH MATERIAL. EXISTING WOOD WALL PANEL MILLWORK TO BE PATCHED AND REPAIRED 6
- TO RECEIVE NEW FINISH. DEMO EXISTING GRAPHIC ON ELEVATOR DOORS, DOORS TO REMAIN & BE PROTECTED DURING CONSTRUCTION

ISSUE DATE: 08/17/2023 ISSUE TYPE: BID SET DRAWN BY: J. HALBERT CHECKED BY: R. OLSON 2023-15 PROJECT#:

SHEET NUMBER:



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PROJECT DESCRIPTION

## SELECTHEALTH BUILDING **TENANT IMPROVEMENT**


**5381 S GREEN STREET MURRAY, UT 84123** 

SHEET NAME:

## **DEMOLITION FLOOR** PLAN - LEVEL 01 -LOBBY & ELEVATOR LOBBY

REVISIONS MARK DATE DESCRIPTION

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GENERAL NOTES:	
SEE SHEET G001 FOR DRAWING INDEX.	<b>•</b> • • •
SEE SHEET AG000 FOR GENERAL ARCHITECTURAL NOTES AND ABBREVIATIONS.	ajc architects
DO NOT SCALE DRAWINGS.	703 east 1700 south
CONTRACTOR / SUBCONTRACTOR SHALL VERIFY ALL DIMENSIONS AND CONDITIONS BEFORE BEGINNING WORK, AND SHALL REPORT TO THE ARCHITECT ANY ERRORS, INCONSISTENCIES OR OMISSIONS BEFORE BEGINNING WORK. SEE GENERAL NOTES AND SPECIFICATIONS.	salt lake city, ut 84105 ajcarchitects.com
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REMOVE ALL INTERIOR DOOR/WINDOW FRAME AND GLAZING WHERE SHOWN.	6137252-0301
EXISTING ROOF DRAIN LINE DROPS TO REMAIN U.N.O. PROTECT. SEE PLUMBING.	0/17/2015
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REMOVE EXISTING CARPET AND BASE WHERE SHOWN. RECYCLE TO EXTENT POSSIBLE.	PROJECT DESCRIPTION
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DEMOLITION DEFINITIONS	SHEET NAME:
<b>REMOVE</b> : UNLESS ITEMS ARE OTHERWISE INDICATED TO BE REINSTALLED OR SLAVAGED, REMOVE AND DISPOSE BY RECYCLING TO GREATEST EXTENT POSSIBLE OR	DEMOLITION RCP - LEVEL 01 - LOBBY &
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KEY NOTES:	
1 EXISTING CEILING TO REMAIN AND BE PRESERVED DURING CONSTRUCTION	
2 EXISTING CEILING TO REMAIN AND RECEIVE NEW PAINT 3 DEMO EXISTING WALL LIGHT SCONCE	
4 EXISTING LIGHT FIXTURE TO REMAIN AND TO BE PROTECTED DURING CONSTRUCTION	
5 EXISTING MECHANICAL COMPONENT TO REMAIN AND TO BE PROTECTED DURING CONSTRUCTION	
	ISSUE DATE: 08/17/2023

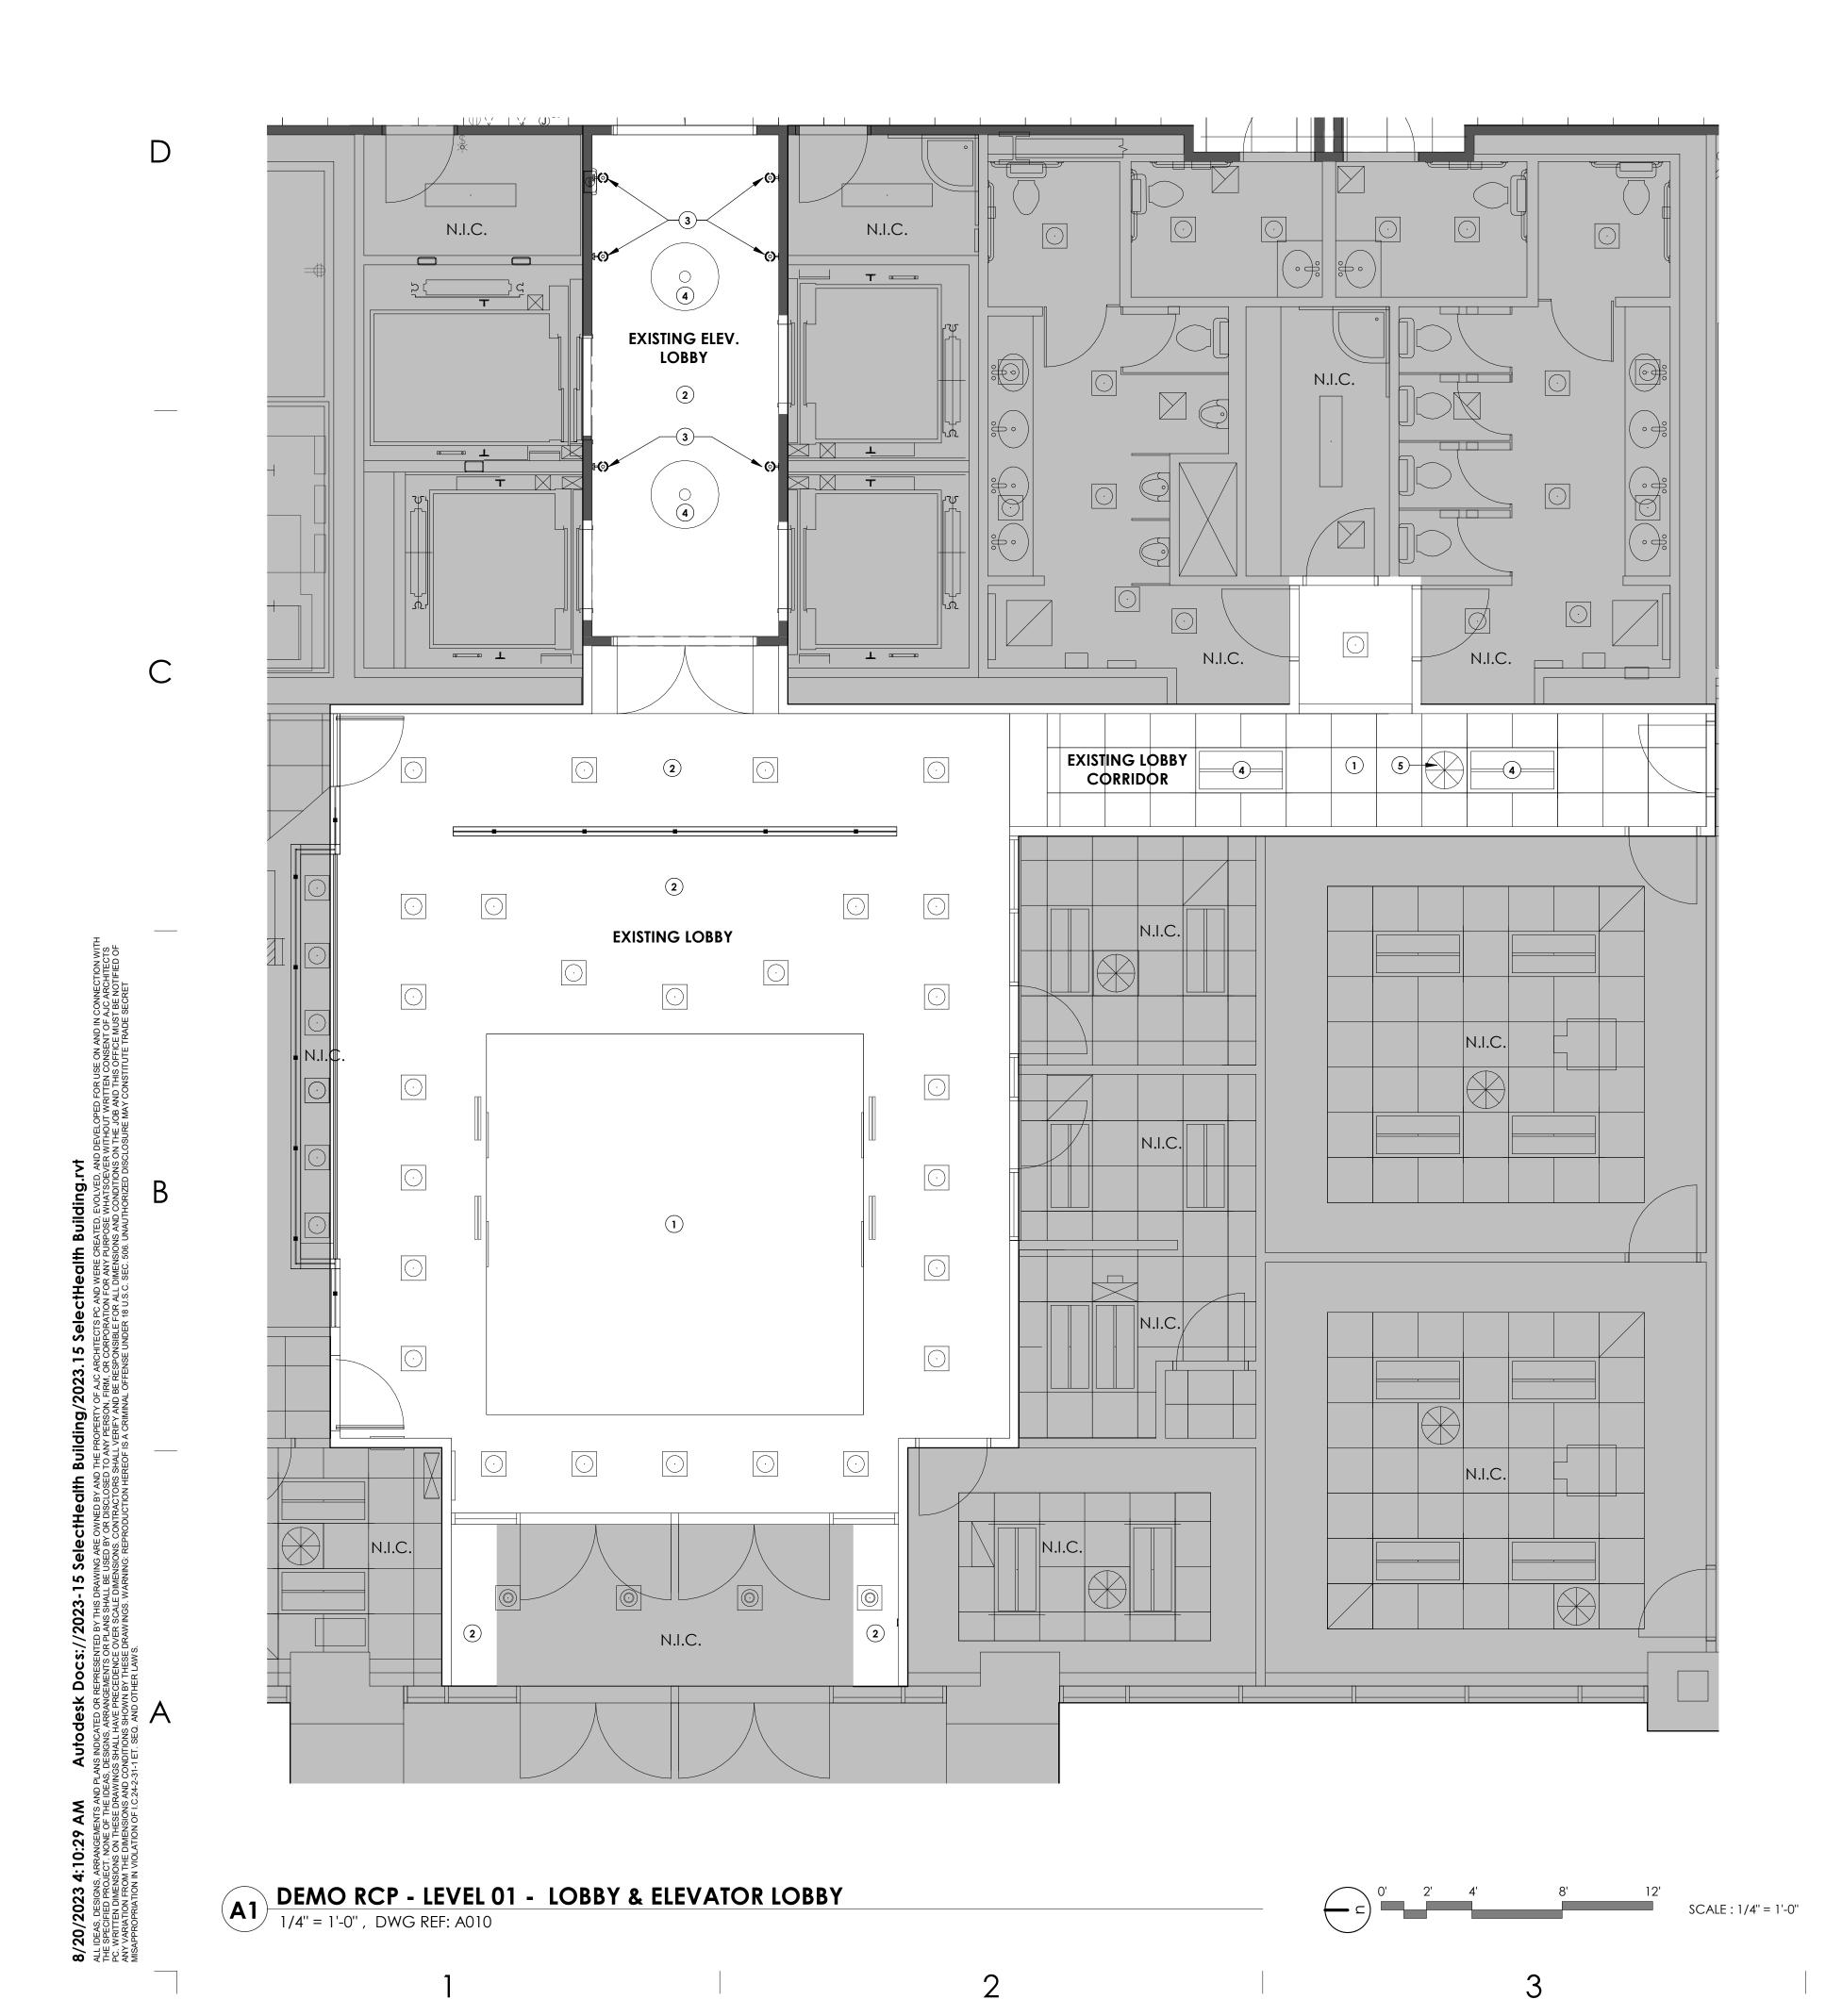**BID SET** 

J. HALBERT

ISSUE TYPE: DRAWN BY:

SHEET NUMBER:

 CHECKED BY:
 R. OLSON

 PROJECT#:
 2023-15

**AD002** 

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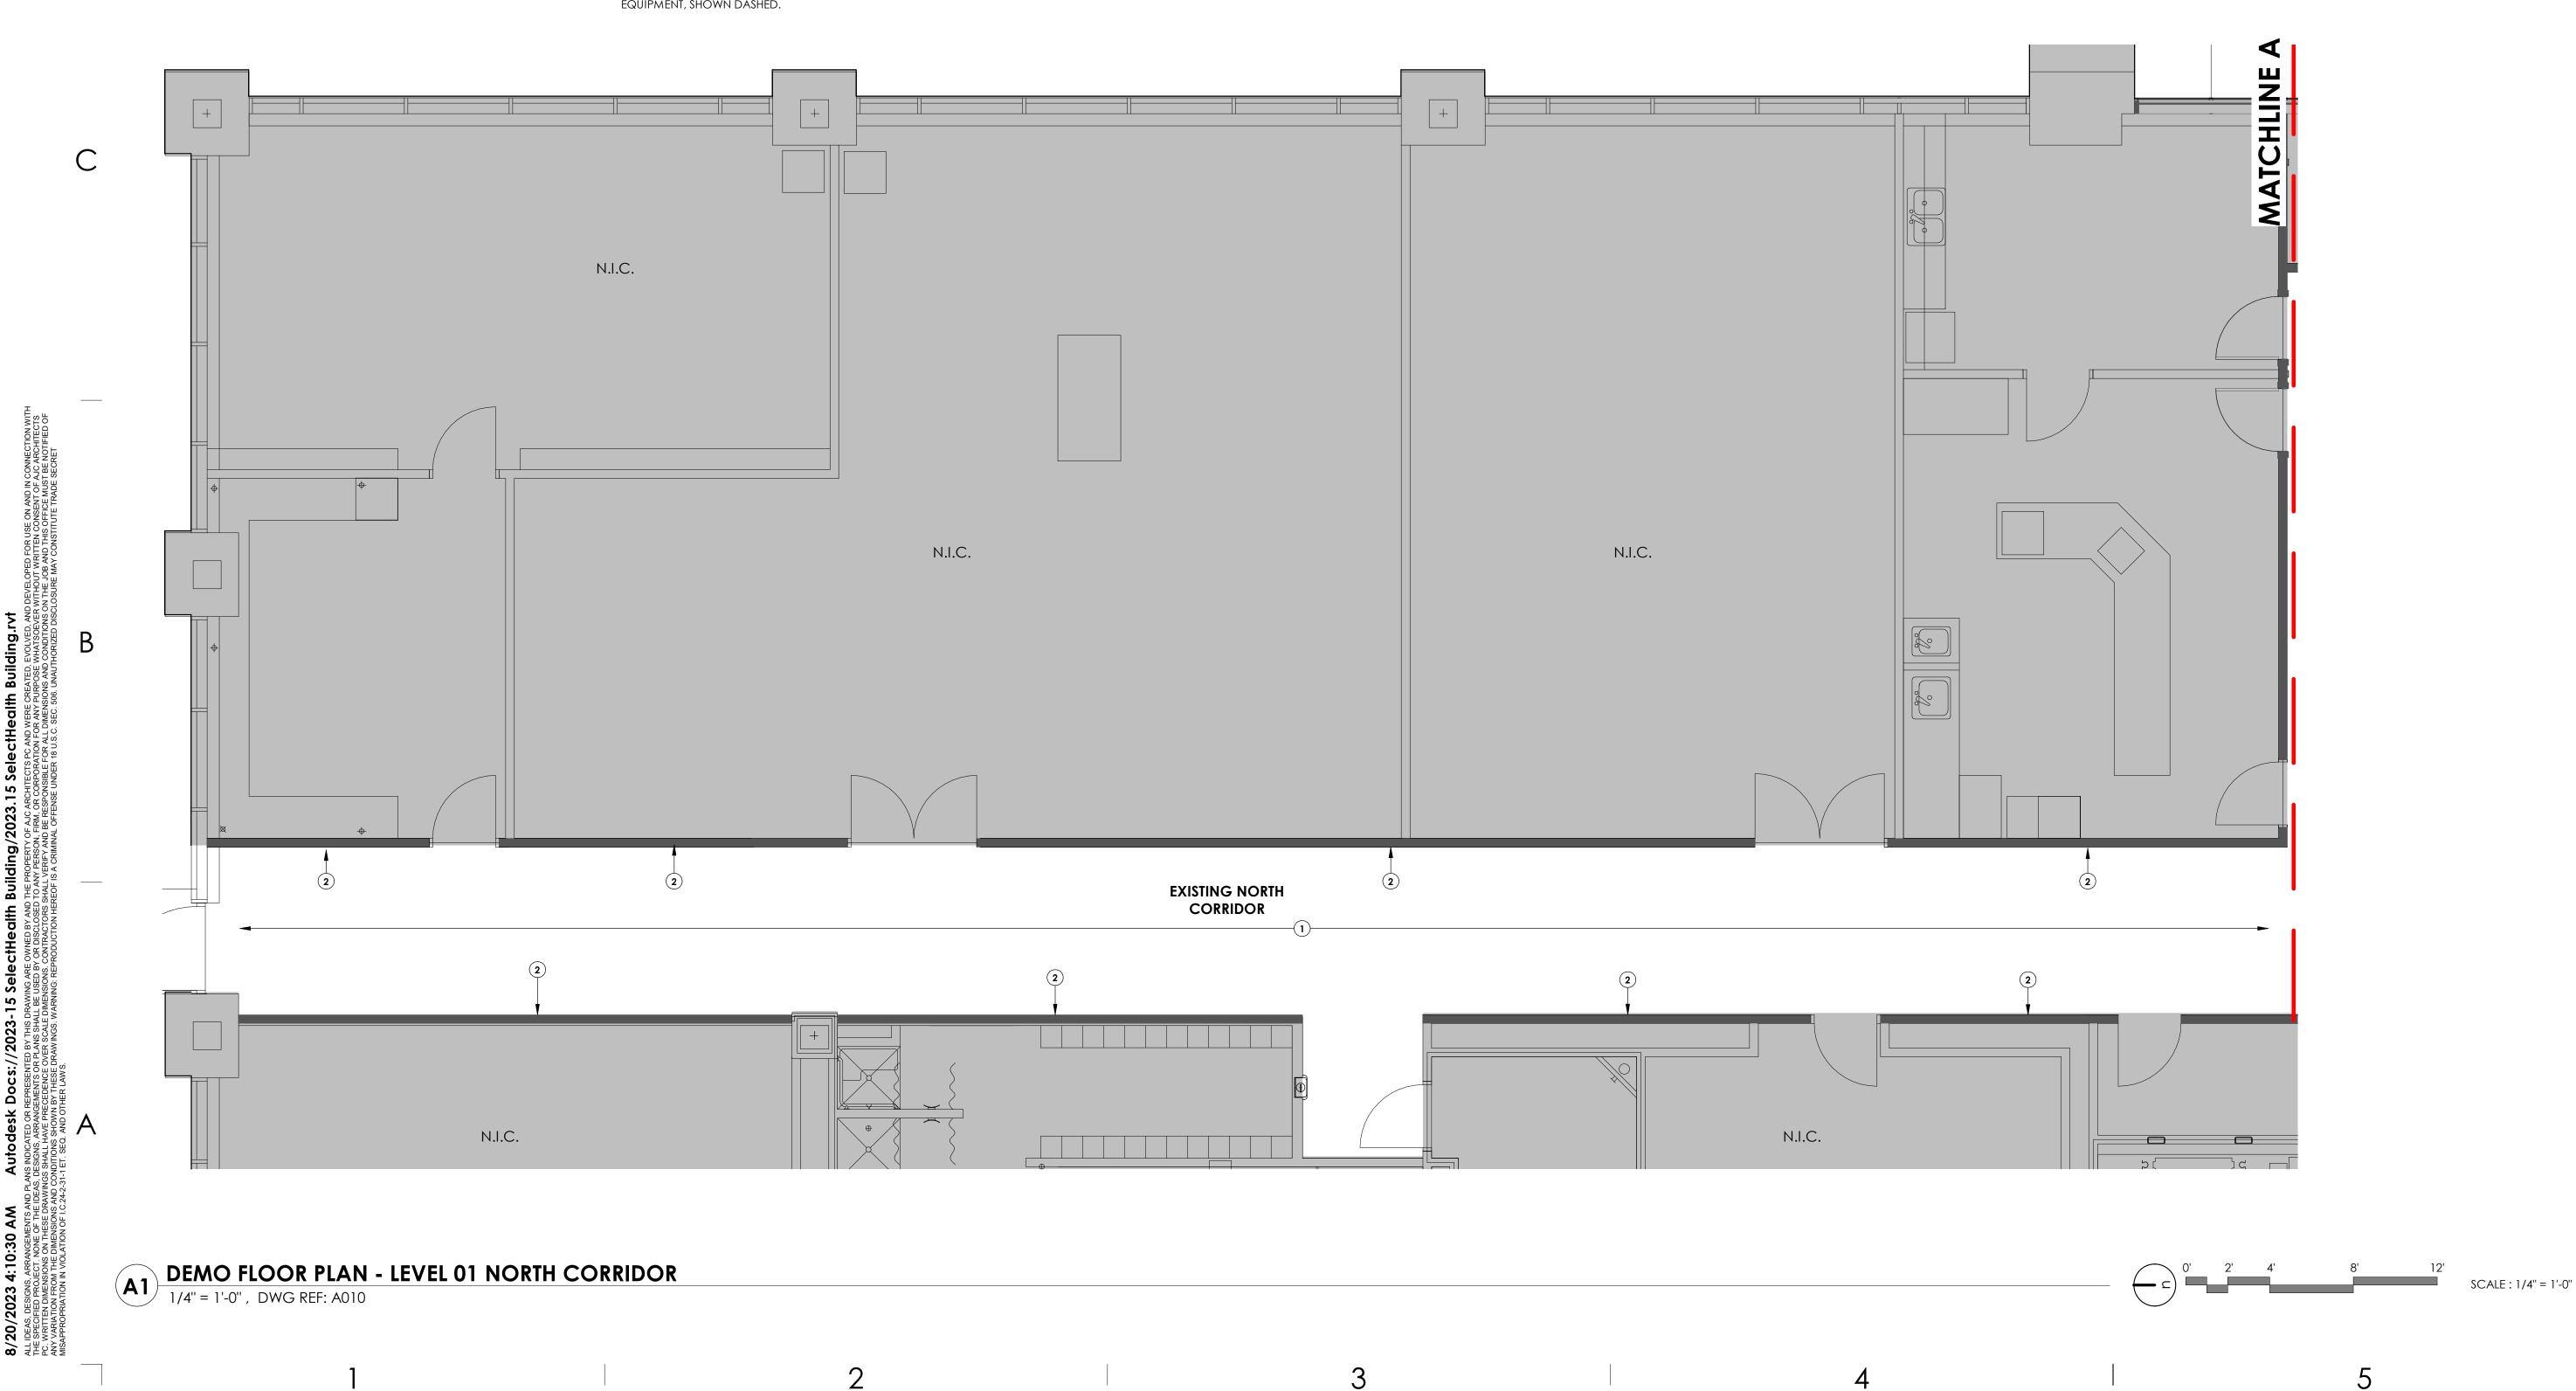
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#### **KEY NOTES: DEMOLITION DEFINITIONS REMOVE**: UNLESS ITEMS ARE OTHERWISE INDICATED TO BE REINSTALLED OR DEMO EXISTING FLOOR FINISH AND WALL BASE, PREP FOR NEW FLOOR 1 SLAVAGED, REMOVE AND DISPOSE BY RECYCLING TO GREATEST EXTENT POSSIBLE OR FINISH MATERIAL. **IS PRACTICAL** 2 DEMO EXISTING TILE ON WALLS, PATCH AND REPAIR SUBSTRATE AS REQUIRED **REMOVE AND REINSTALL:** REMOVE ITEMS INDICATED; CLEAN, SERVICE ND OTHERWISE PERPARE FOR SERVICE; REINSTALL IN THE SAME LOCATION (OR IN THE LOCATION INDICATED). **REMOVE AND INSTALL NEW:** REMOVE AND DISPOSE OF ITEMS INDCATED AND INSTALL NEW ITEMS IN THE SAME LOCATION (OR IN THE LOCATION INDICATED). **REMOVE AND SALVAGE:** ITEMS INDICATED TO BE SALVAGED WILL REMAIN THE OWNER'S PROPERTY. CAREFULLY REMOVE AND CLEAN ITEMS INDICATED TO BE SALVAGED; PACK OR CRATE TO PROTECT AGAINST DAMAGE; IDENTIFY CONTENTS OF CONTAINERS; DELIVER TO THE LOCATION INDICATED. **REMOVE AND RECYCLE**: REMOVE AND RECYCLE TO THE GREATEST EXTENT PRACTICAL OF ITEMS INDICATED. ALL DEMOLISHED OR REMOVED ITEMS AND MATERIALS SHALL BE CONSIDERED SCRAP, EXCEPT FOR THOSE INDICATED TO REMAIN, THOSE INDICATED TO BE REINSTALLED, AND THOSE INDICATED TO BE Salvaged. EXISTING TO REMAIN: CONSTRUCTION OR ITEMS INDICATED TO REMAIN SHALL BE PROTECTED AGAINST DAMAGE DURING DEMOLITION OPERATIONS. WHERE PRACTICABLE, AND WITH THE ARCHITECT'S PERMISSION, THE CONTRACTOR MAY ELECT TO REMOVE ITEMS TO A SUITABLE STORAGE LOCATION DURING DEMOLITION AND THEN PROPERLY CLEAN AND REINSTALL THE ITEMS.

4

## **GENERAL NOTES:**

SEE SHEET GOO1 FOR DRAWING INDEX.

SEE SHEET AG000 FOR GENERAL ARCHITECTURAL NOTES AND ABBREVIATIONS.

DO NOT SCALE DRAWINGS.

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ajc architects

703 east 1700 south salt lake city, ut 84105 ajcarchitects.com

ARCHITECT / CONSULTANT



PROJECT DESCRIPTION

#### SELECTHEALTH BUILDING **TENANT IMPROVEMENT**

**5381 S GREEN STREET MURRAY, UT 84123** 

Sheet Name:

#### **DEMOLITION FLOOR** PLAN - LEVEL 01 -NORTH CORRIDOR

REVISIONS

MARK DATE DESCRIPTION

ISSUE DATE: ISSUE TYPE: DRAWN BY: CHECKED BY: R. OLSON PROJECT#:

08/17/2023 **BID SET** J. HALBERT 2023-15



## **DEMOLITION DEFINITIONS**

**REMOVE:** UNLESS ITEMS ARE OTHERWISE INDICATED TO BE REINSTALLED OR SLAVAGED, REMOVE AND DISPOSE BY RECYCLING TO GREATEST EXTENT POSSIBLE OR IS PRACTICAL

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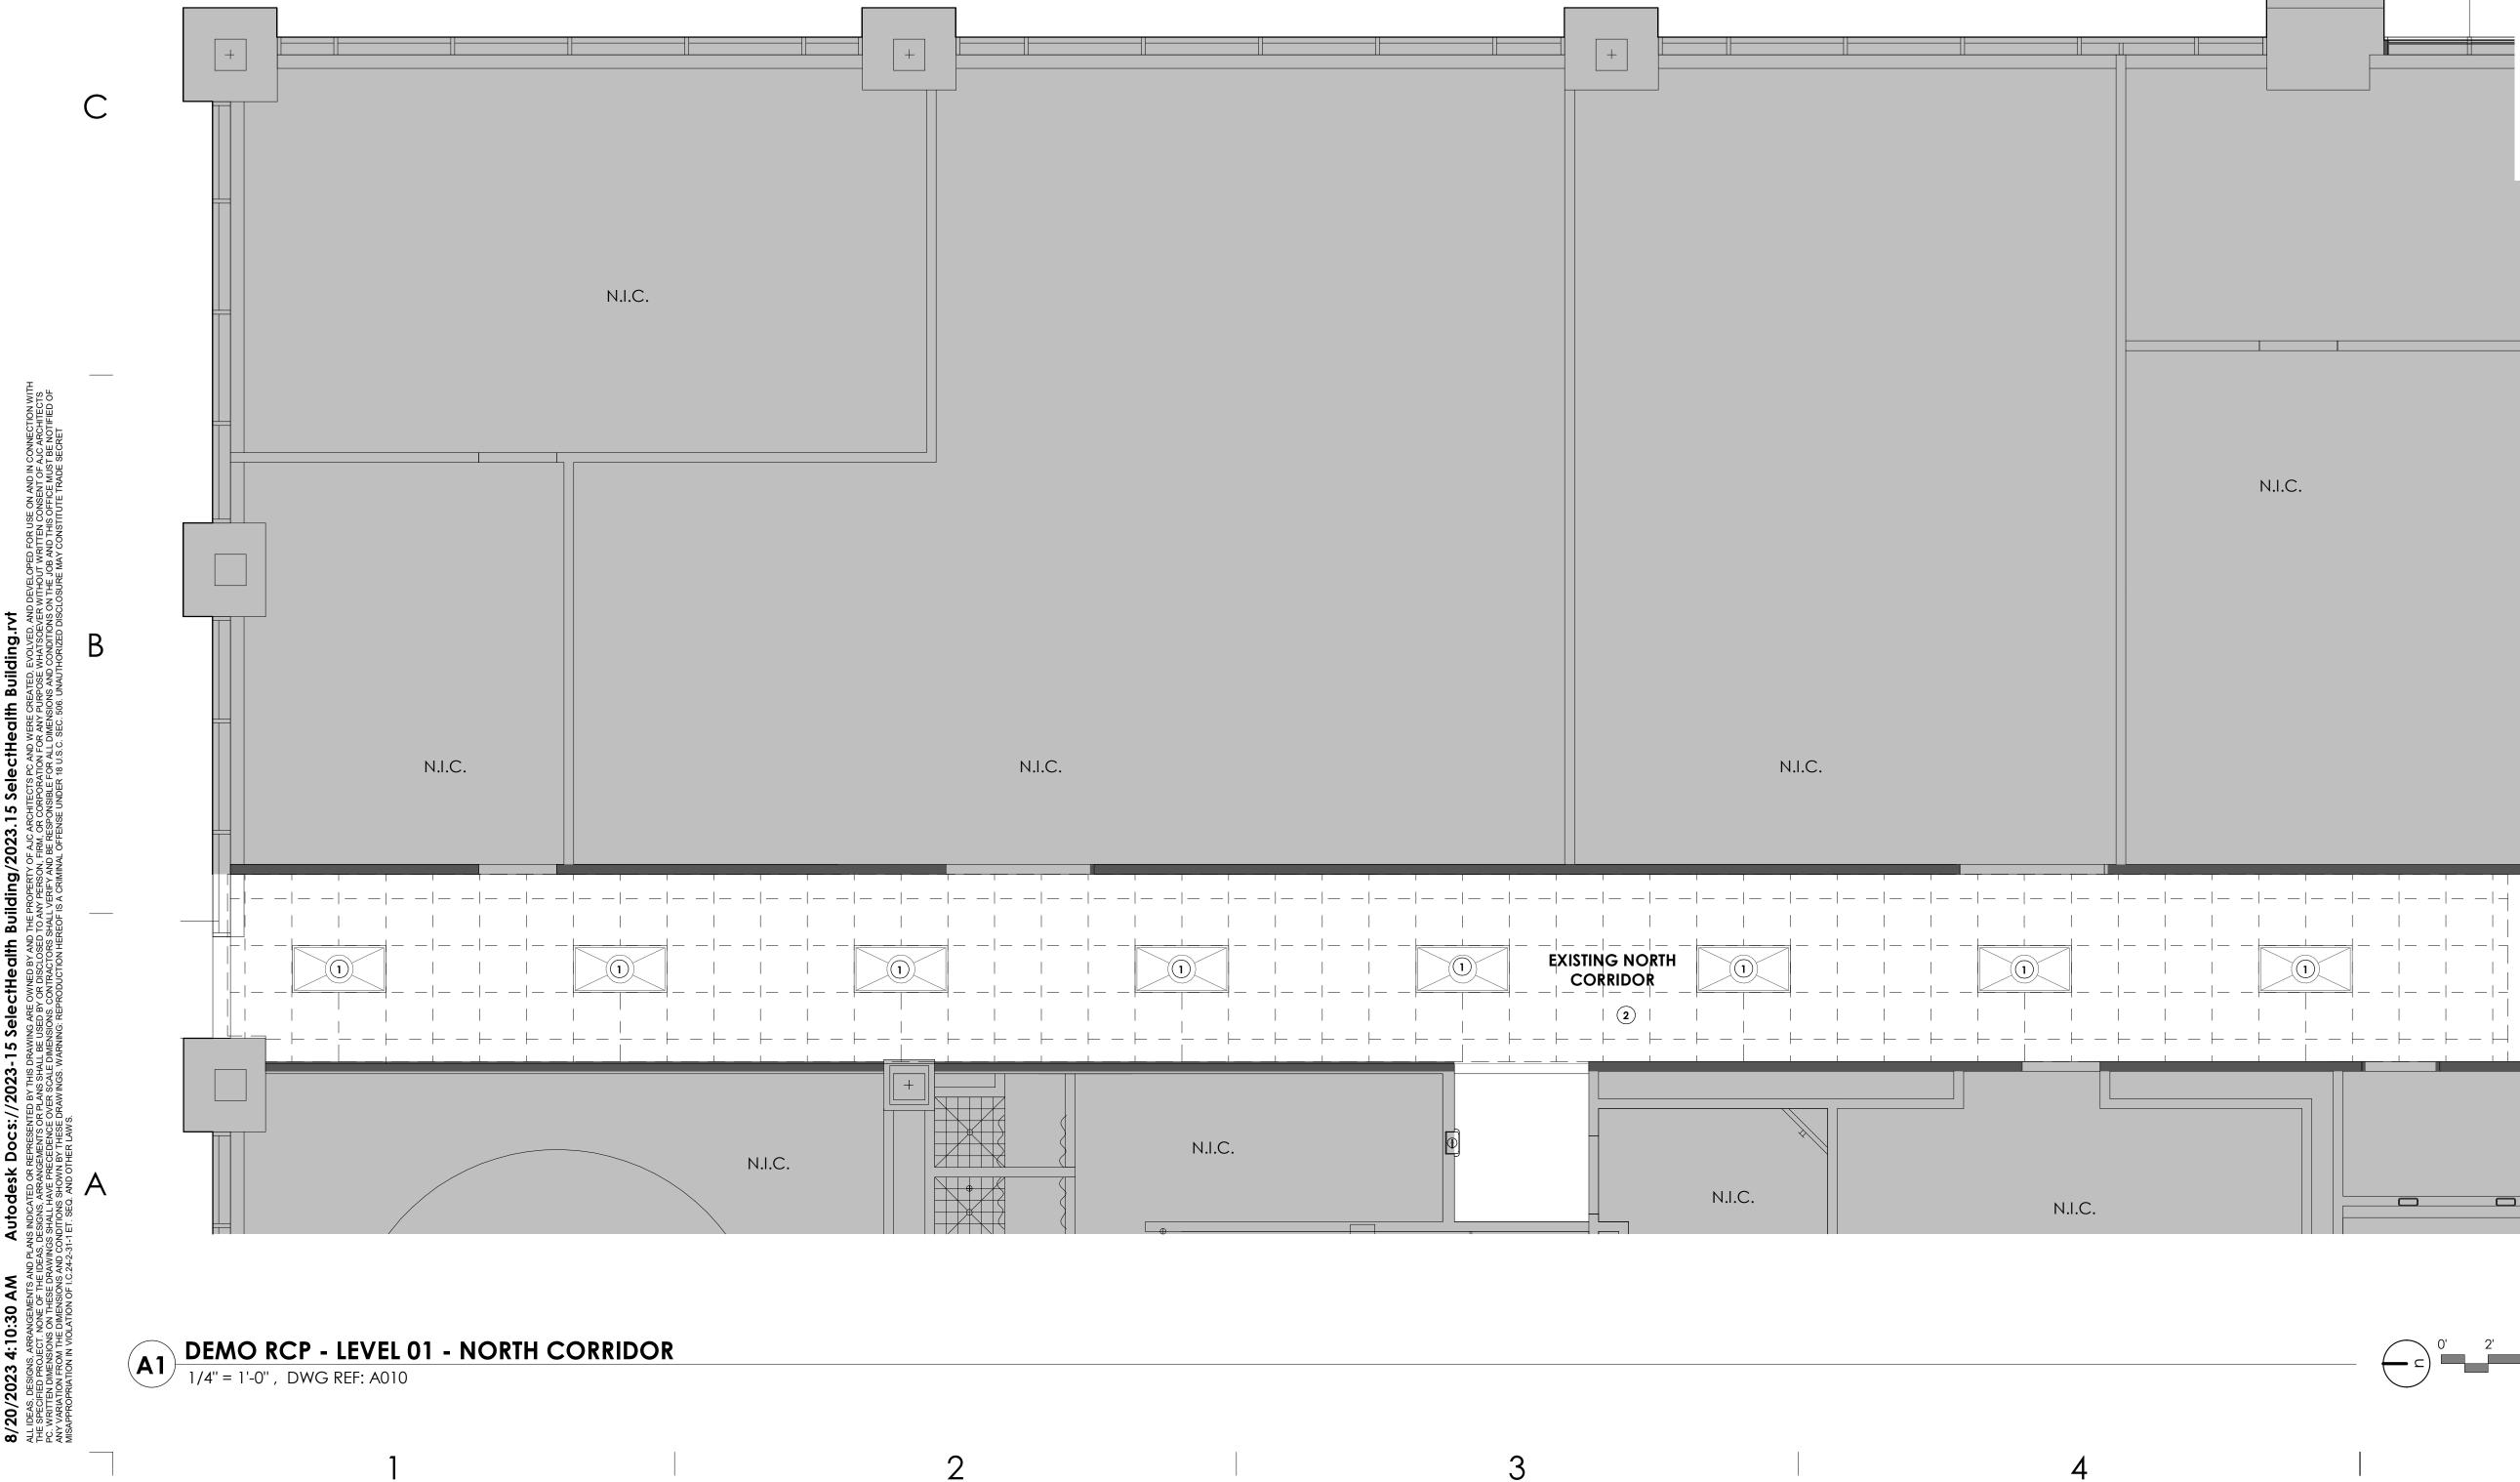
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ajc architects

703 east 1700 south salt lake city, ut 84105 ajcarchitects.com

ARCHITECT / CONSULTANT



PROJECT DESCRIPTION

#### SELECTHEALTH BUILDING **TENANT IMPROVEMENT**

5381 S GREEN STREET MURRAY, UT 84123

Sheet name:

#### **DEMOLITION RCP** -LEVEL 01 - NORTH CORRIDOR

REVISIONS


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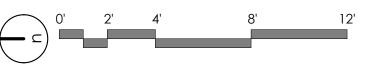
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08/17/2023 **BID SET** J. HALBERT 2023-15

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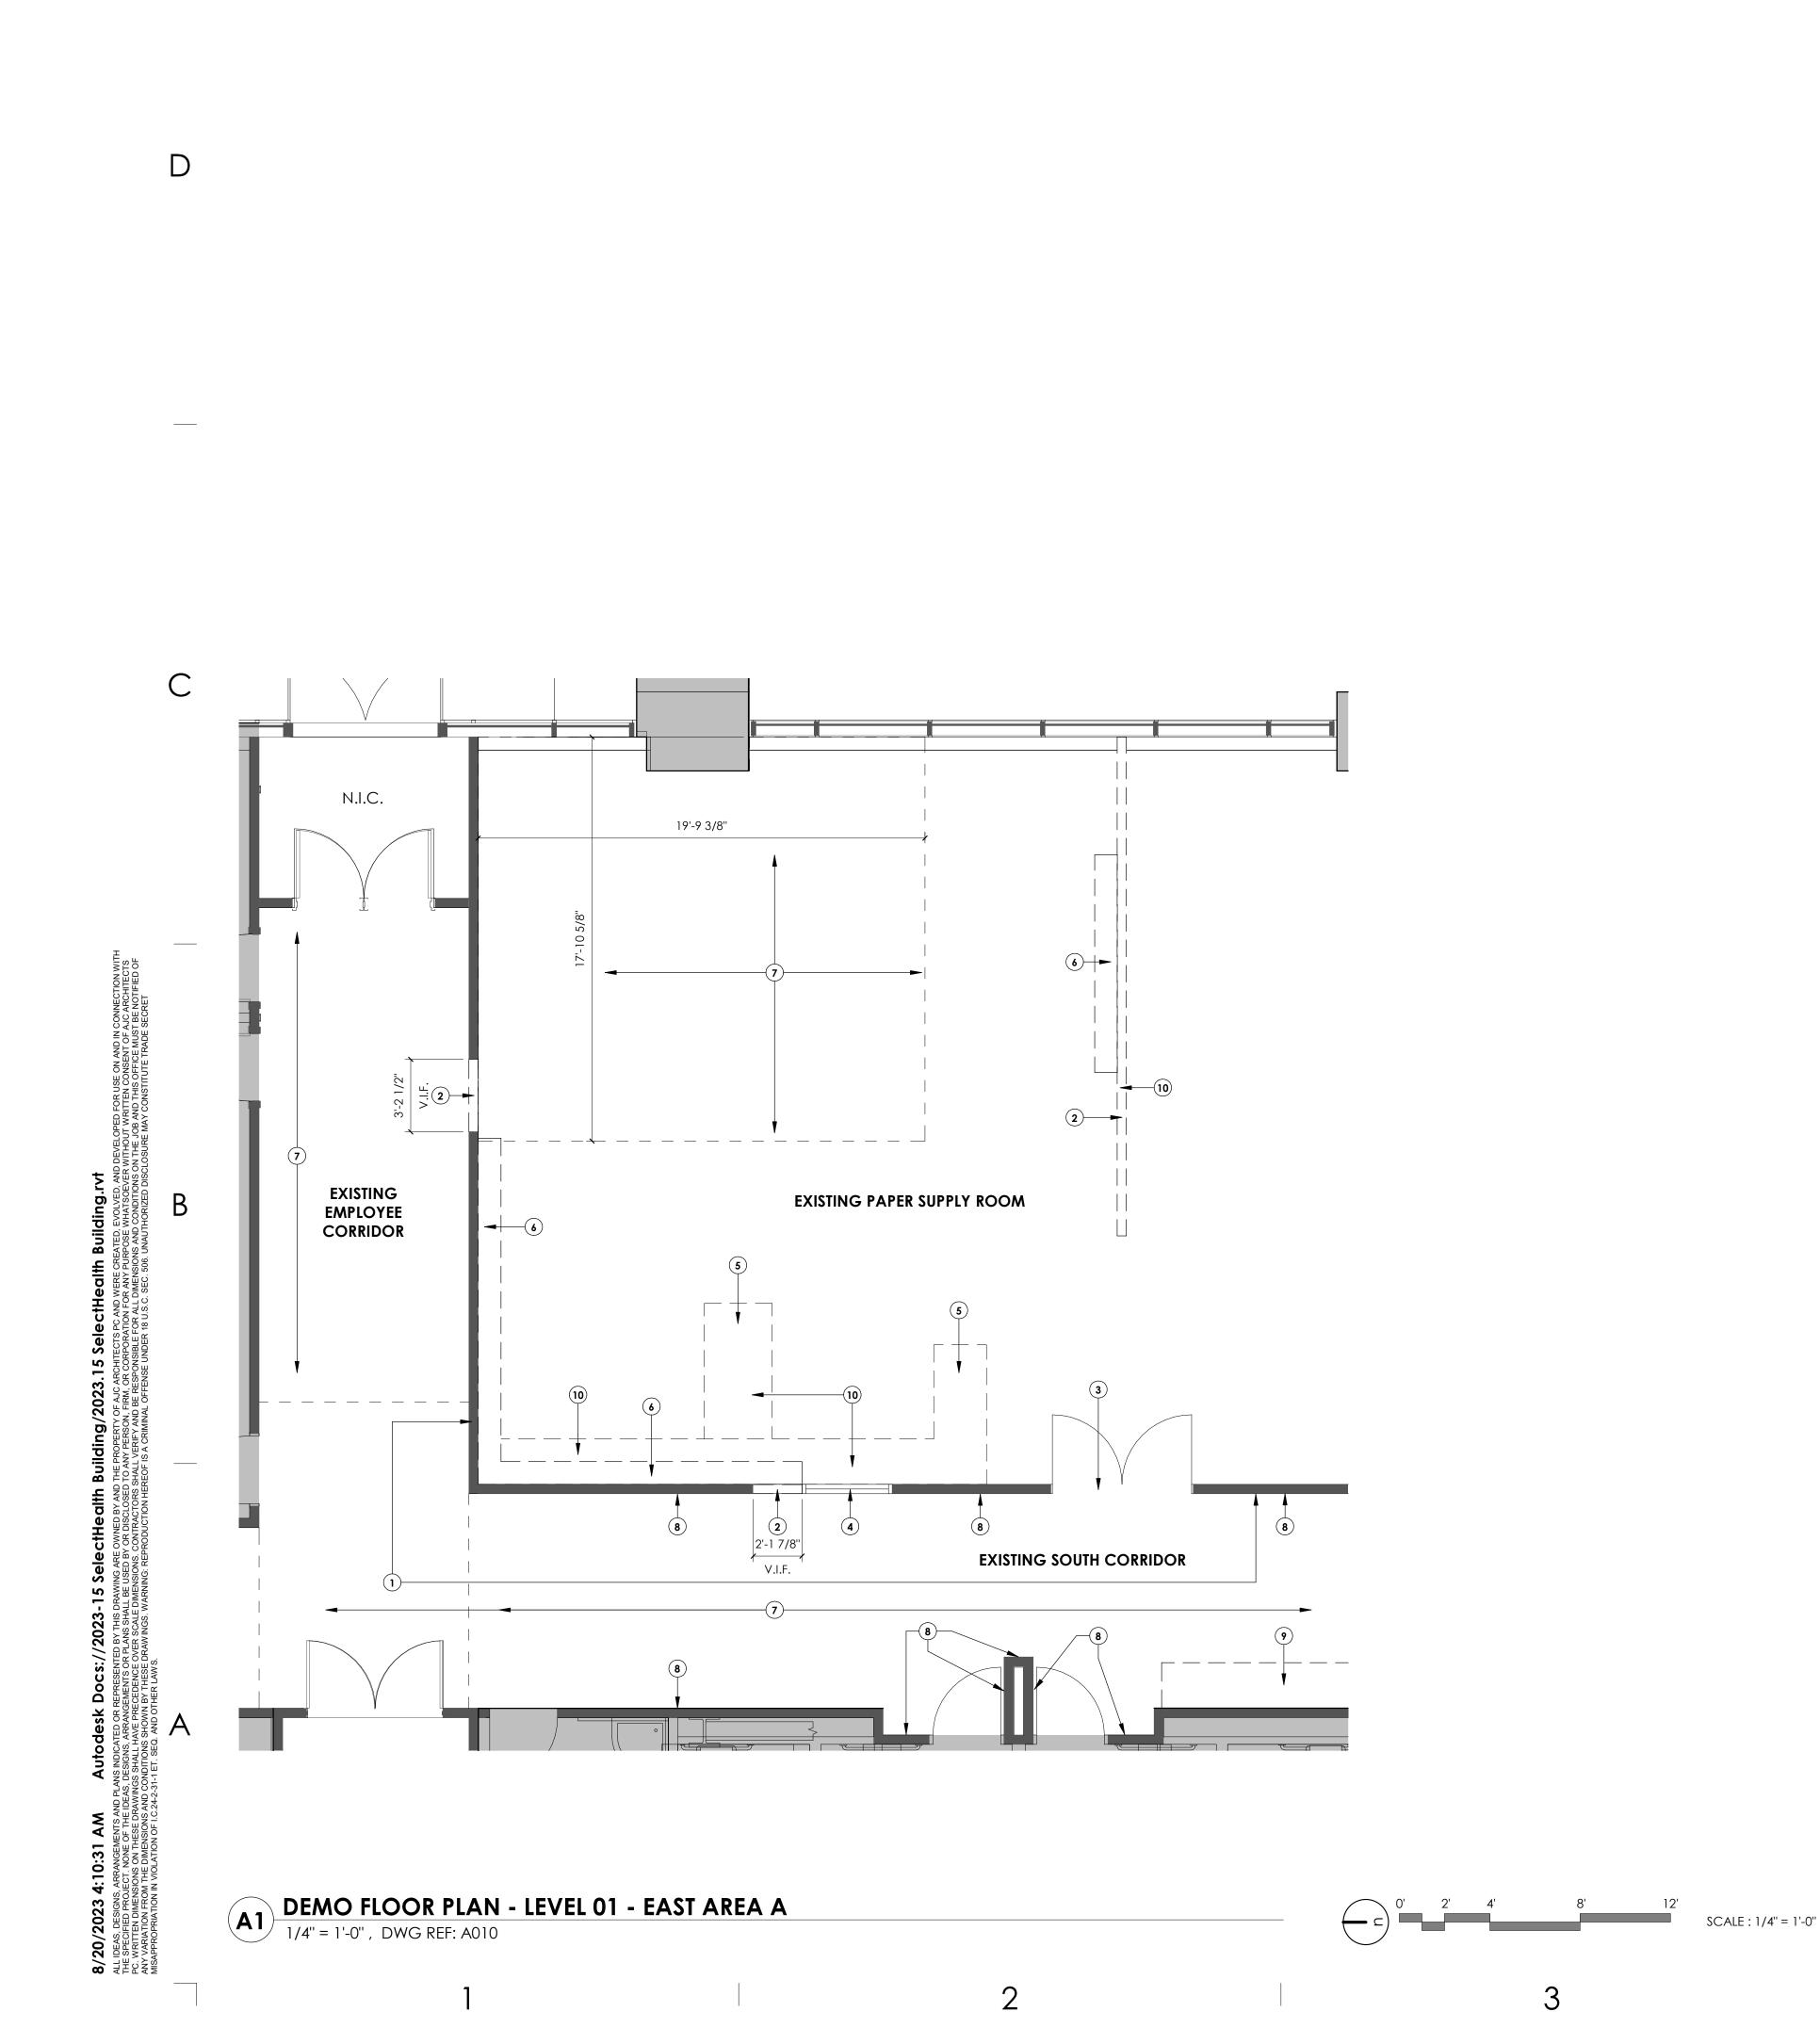




SCALE : 1/4" = 1'-0"

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EXISTING ACP.

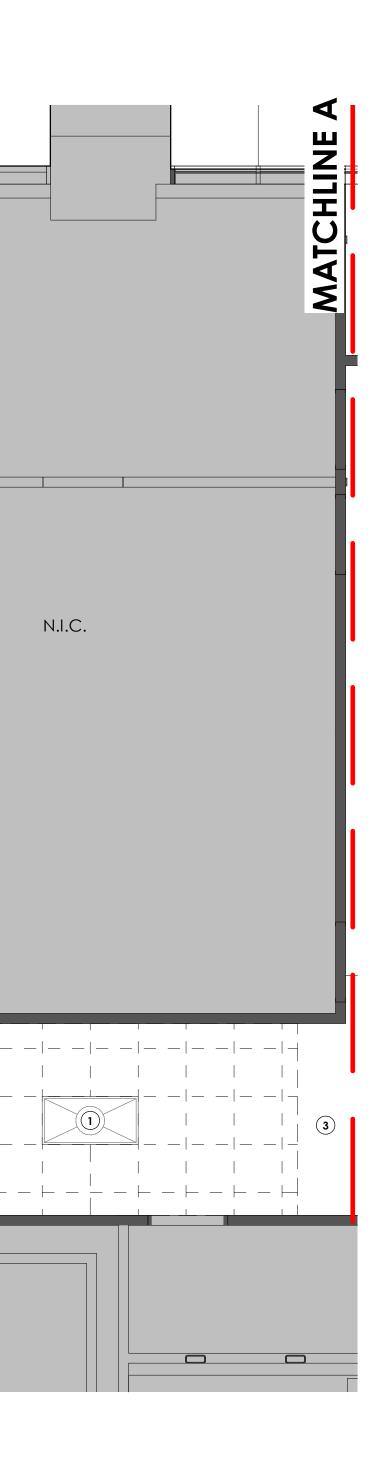

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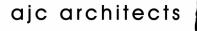
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## **KEY NOTES:**

- EXISTING FIRE RATED PARTITION TO REMAIN AND BE PROTECTED DURING CONSTRUCTION.
- DEMO PORTION OF EXISTING PARTITION TO ACCOMMODATE NEW DOOR EXISTING DOOR TO REMAIN AND BE PROTECTED DURING CONSTRUCTION. DEMO EXISTING OVERHEAD DOOR; OPENING TO REMAIN FOR NEW 4
- DOUBLE DOOR. DEMO EXISTING CASEWORK & COUNTERTOP. REMOVE, STORE, AND 5 PRESERVE CABINET HANDLES FOR REINSTALL
- DEMO EXISTING SHELF
- DEMO EXISTING FLOOR FINISH AND WALL BASE, PREP FOR NEW FLOOR FINISH MATERIAL. DEMO EXISTING TILE ON WALLS, PATCH AND REPAIR SUBSTRATE AS 8
- REQUIRED
- DEMO EXISTING CASEWORK 9
- EXISTING FLOOR TO REMAIN AND BE PROTECTED DURING 10 CONSTRUCTION. INFILL AS NEEDED TO MATCH EXISTING ADJACENT VINYL COMPOSITION TILE.



703 east 1700 south salt lake city, ut 84105 ajcarchitects.com

ARCHITECT / CONSULTANT



PROJECT DESCRIPTION

## SELECTHEALTH BUILDING **TENANT IMPROVEMENT**

**5381 S GREEN STREET MURRAY**, UT 84123

SHEET NAME:


#### **DEMOLITION FLOOR** PLAN - LEVEL 01 - EAST AREA A

REVISIONS MARK DATE DESCRIPTION

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08/17/2023 **BID SET** J. HALBERT 2023-15



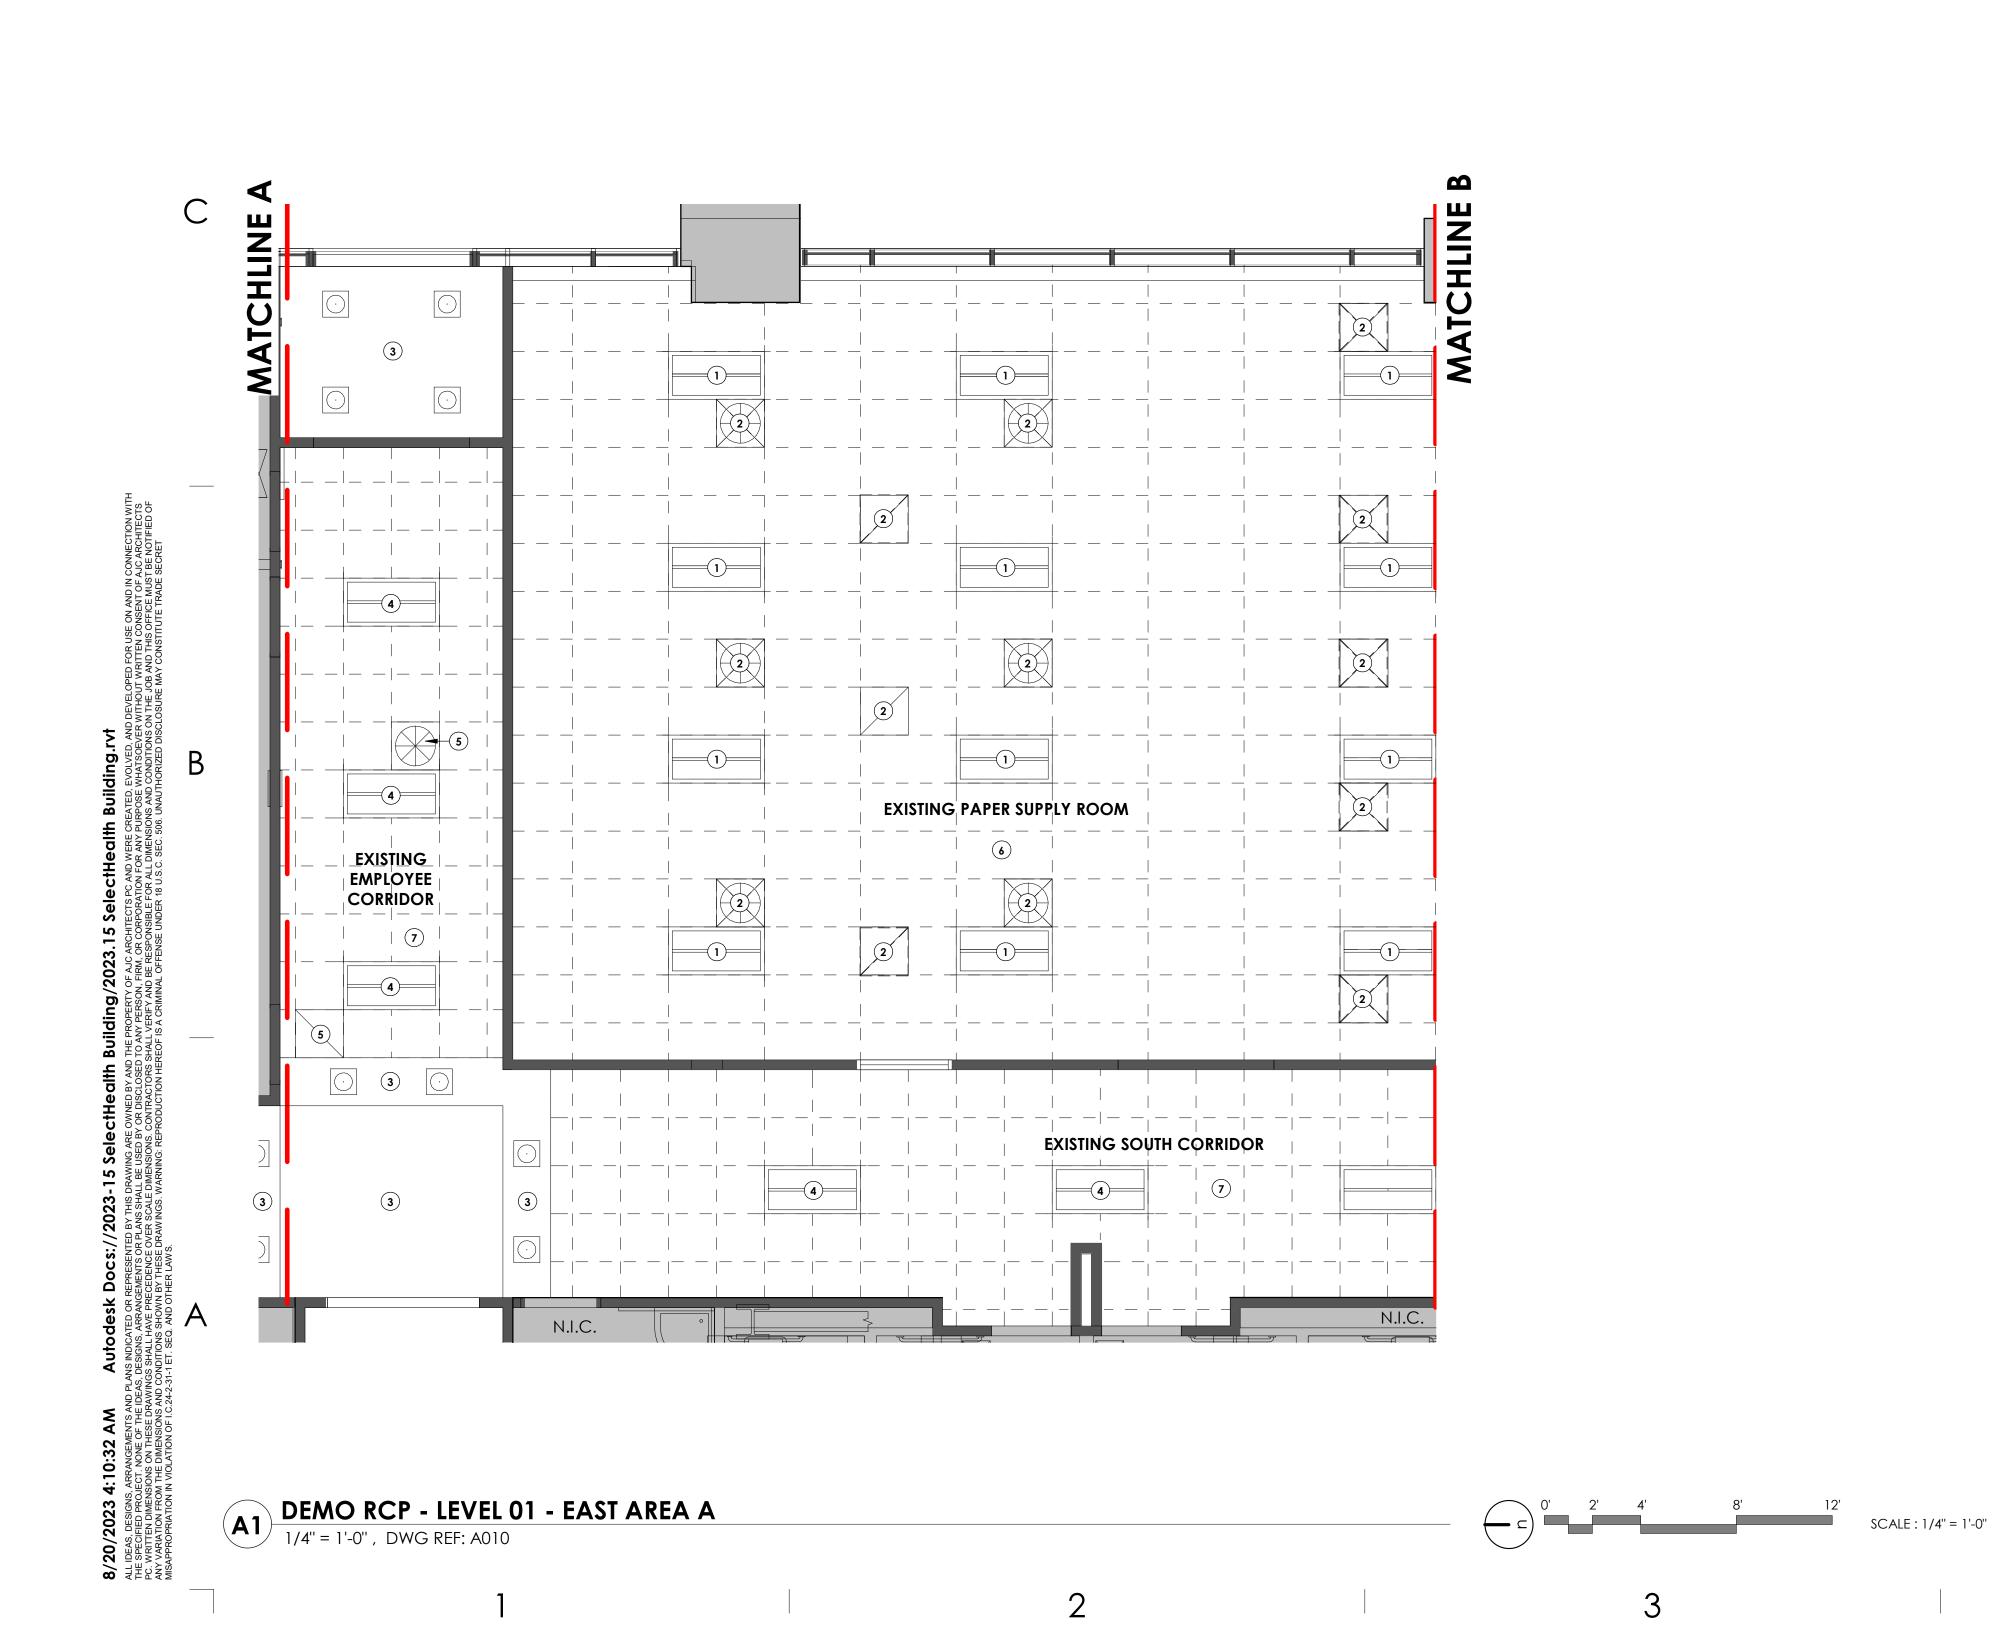

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# **GENERAL NOTES:**

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REMOVE EXISTING MILLWORK AND PLUMBING FIXTURE(S) WHERE SHOWN. REMOVE PLUMBING PER SPEC. & PD SHEETS. CAP PLUMBING LINES AT BUILDING ENVELOPE.

REMOVE ALL INTERIOR DOOR/WINDOW FRAME AND GLAZING WHERE SHOWN.

EXISTING ROOF DRAIN LINE DROPS TO REMAIN U.N.O. PROTECT. SEE PLUMBING.

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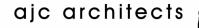
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## **KEY NOTES:**

- DEMO EXISTING LIGHT FIXTURE. REFER TO ELECTRICAL DEMO PLAN. 2 DEMO MECHANICAL COMPONENT. REFER TO MECHANICAL DEMO
- PLANS EXISTING CEILING TO REMAIN AND RECEIVE NEW PAINT
- BID ADD ALTERNATE: REFER TO ADD ALT. LIST; EXISTING LIGHT FIXTURE TO 4
- REMAIN AND BE PROTECTED DURING CONSTRUCTION. REFER TO ELECTRICAL DEMO PLAN.
- EXISTING MECHANICAL COMPONENT TO REMAIN AND TO BE PROTECTED DURING CONSTRUCTION DEMO EXISTING CEILING
- BID ADD ALTERNATE: REFER TO ADD ALT. LIST; DEMO EXISTING ACP.



703 east 1700 south salt lake city, ut 84105 ajcarchitects.com

ARCHITECT / CONSULTANT



PROJECT DESCRIPTION

#### SELECTHEALTH BUILDING **TENANT IMPROVEMENT**

**5381 S GREEN STREET MURRAY**, UT 84123


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## **DEMOLITION RCP** -LEVEL 01 - EAST AREA

REVISIONS MARK DATE DESCRIPTION

ISSUE DATE: 08/17/2023 ISSUE TYPE: **BID SET** DRAWN BY: J. HALBERT CHECKED BY: R. OLSON 2023-15 PROJECT#:



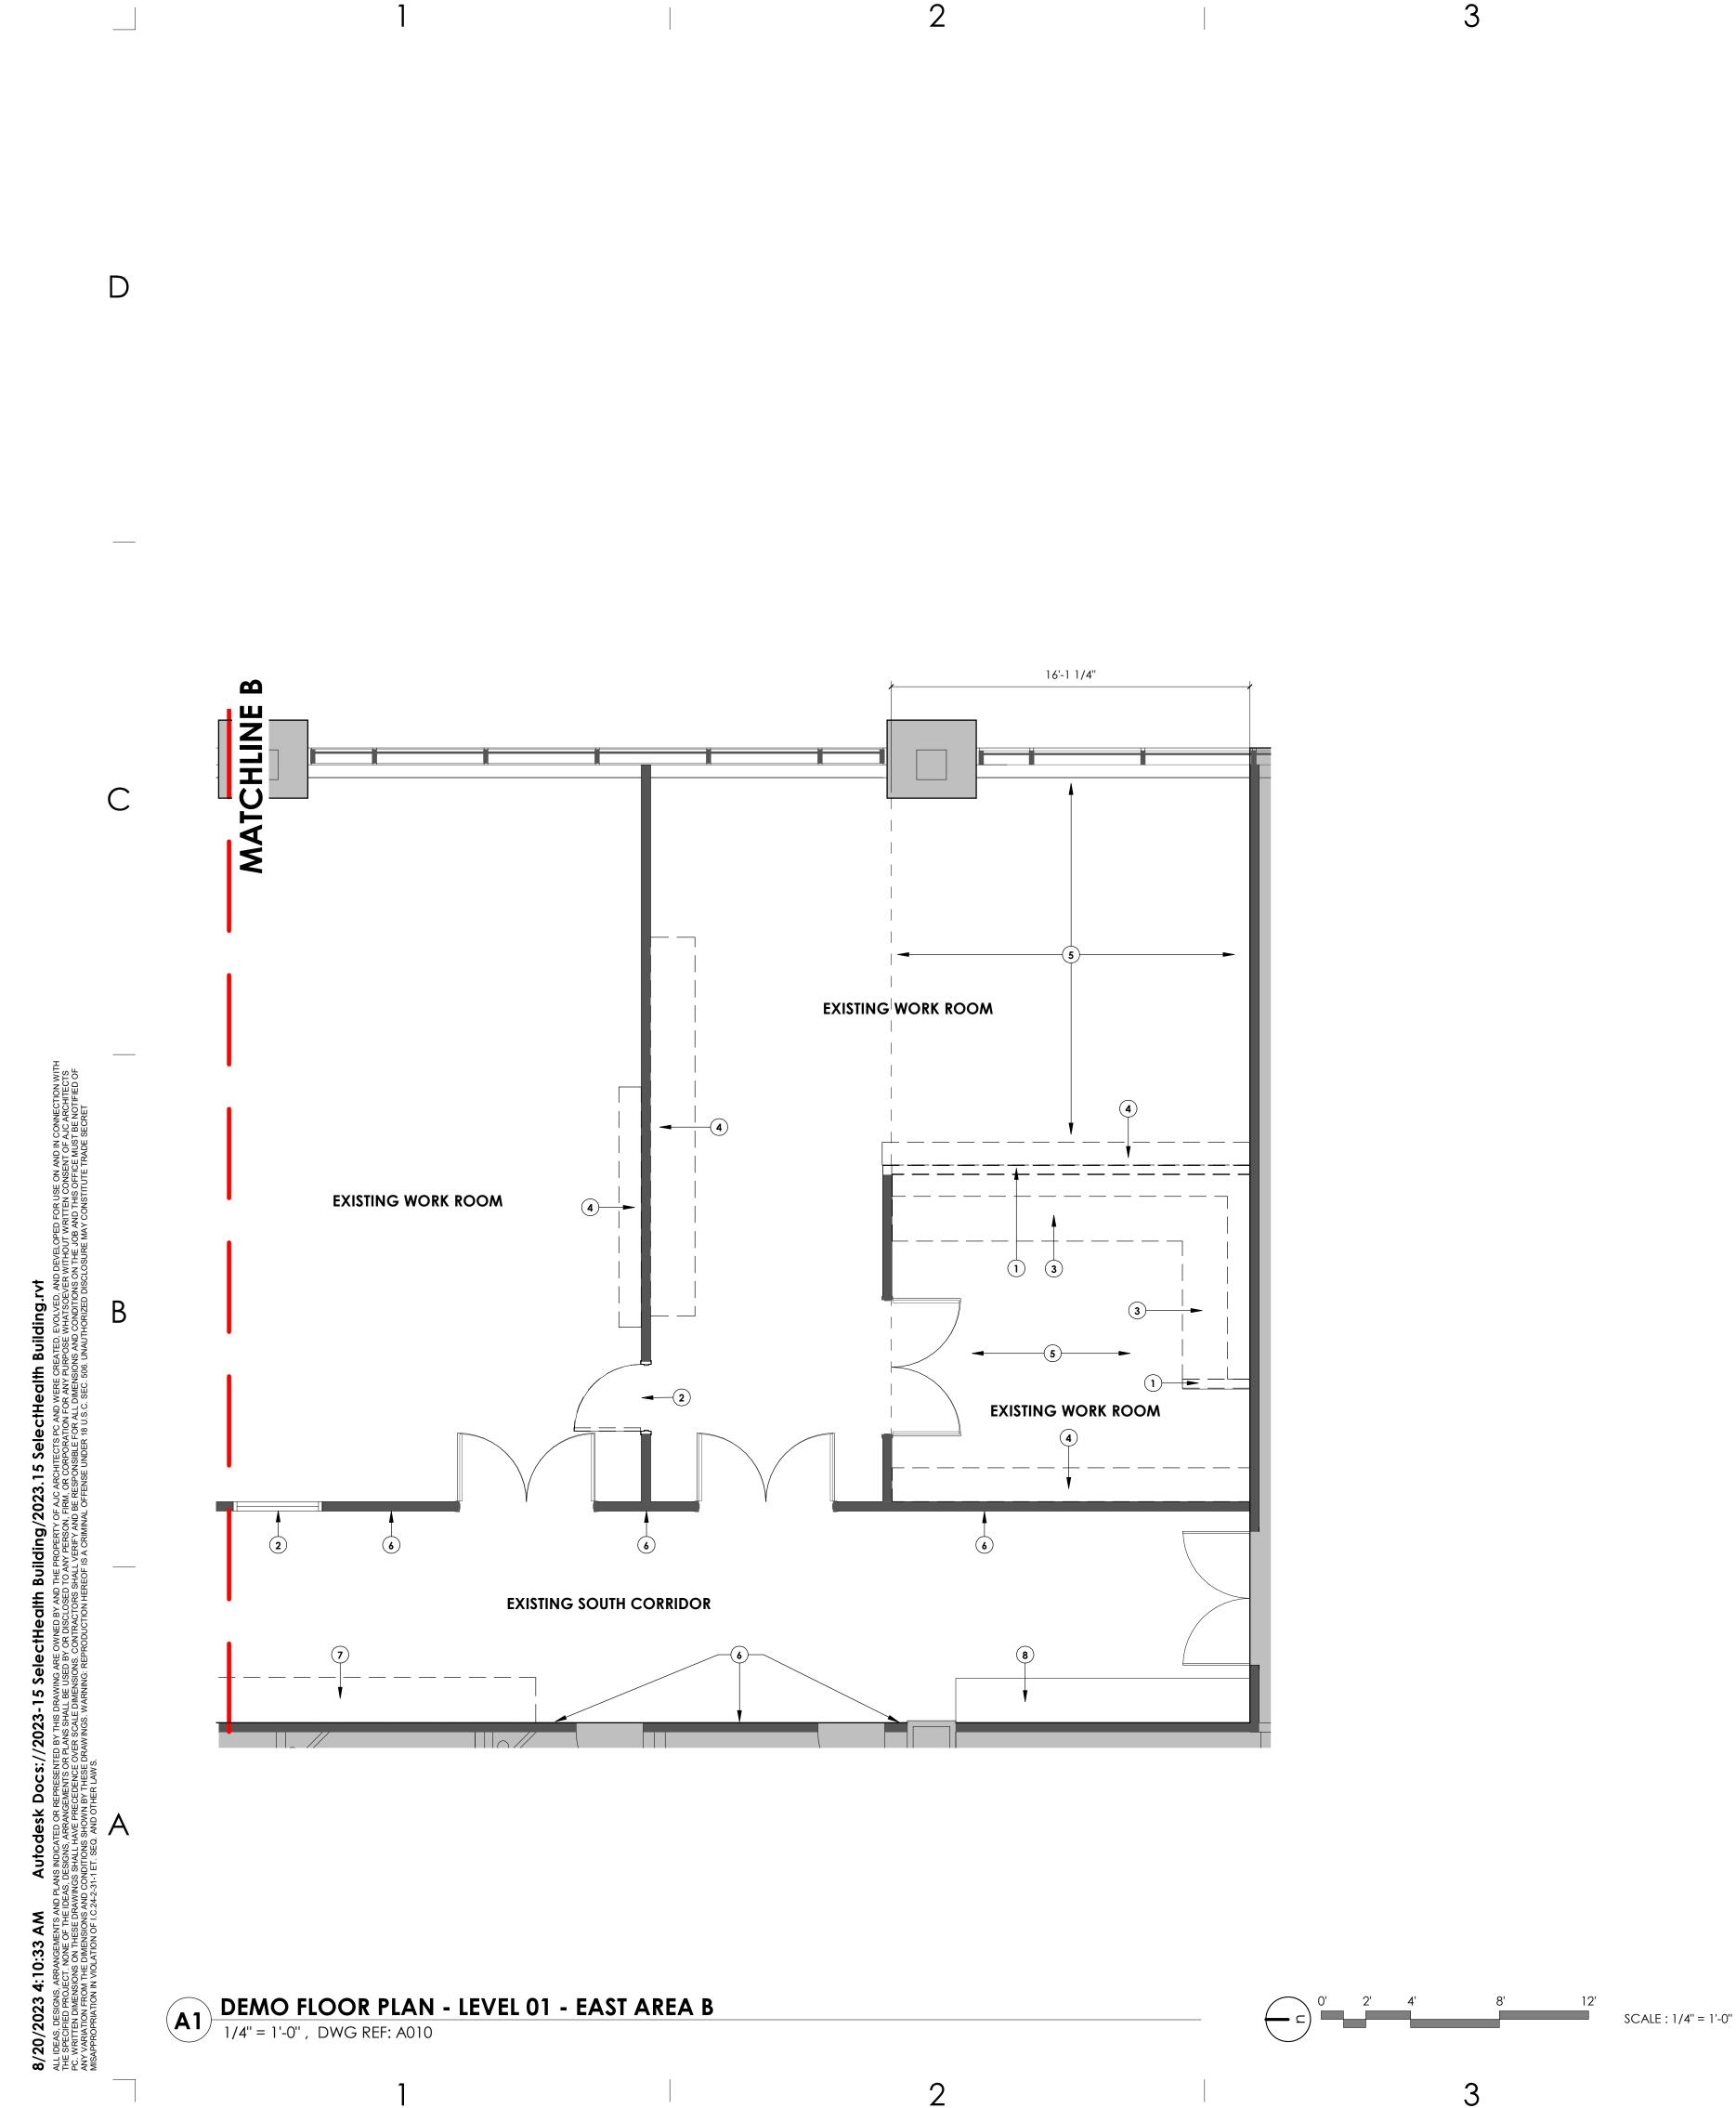

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## **KEY NOTES:**

- GYPSUM BOARD AND STUDS TO BE REMOVED
- DEMO EXISTING DOOR & FRAME; INFILL WITH NEW PARTITION TO MATCH 2 EXISTING ADJACENT PARTITION
- DEMO EXISTING CASEWORK & COUNTERTOP. REMOVE, STORE, AND 3 PRESERVE CABINET HANDLES FOR REINSTALL DEMO EXISTING SHELF
- DEMO EXISTING FLOOR FINISH AND WALL BASE, PREP FOR NEW FLOOR 5
- FINISH MATERIAL. DEMO EXISTING TILE ON WALLS, PATCH AND REPAIR SUBSTRATE AS 6 REQUIRED
- DEMO EXISTING CASEWORK
- EXISTING CASEWORK TO REMAIN AND TO BE PROTECTED DURING CONSTRUCTION

#### ajc architects

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ARCHITECT / CONSULTANT

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SHEET NAME:


#### **DEMOLITION FLOOR** PLAN - LEVEL 01 - EAST AREA B

REVISIONS MARK DATE DESCRIPTION

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## **KEY NOTES:**

- DEMO EXISTING CEILING
- DEMO EXISTING LIGHT FIXTURE. REFER TO ELECTRICAL DEMO PLAN. DEMO MECHANICAL COMPONENT. REFER TO MECHANICAL DEMO 3 PLANS
- BID ADD ALTERNATE: REFER TO ADD ALT. LIST; EXISTING LIGHT FIXTURE TO 4 REMAIN AND BE PROTECTED DURING CONSTRUCTION. REFER TO
- ELECTRICAL DEMO PLAN.
- EXISTING MECHANICAL COMPONENT TO REMAIN AND TO BE PROTECTED DURING CONSTRUCTION

#### ajc architects
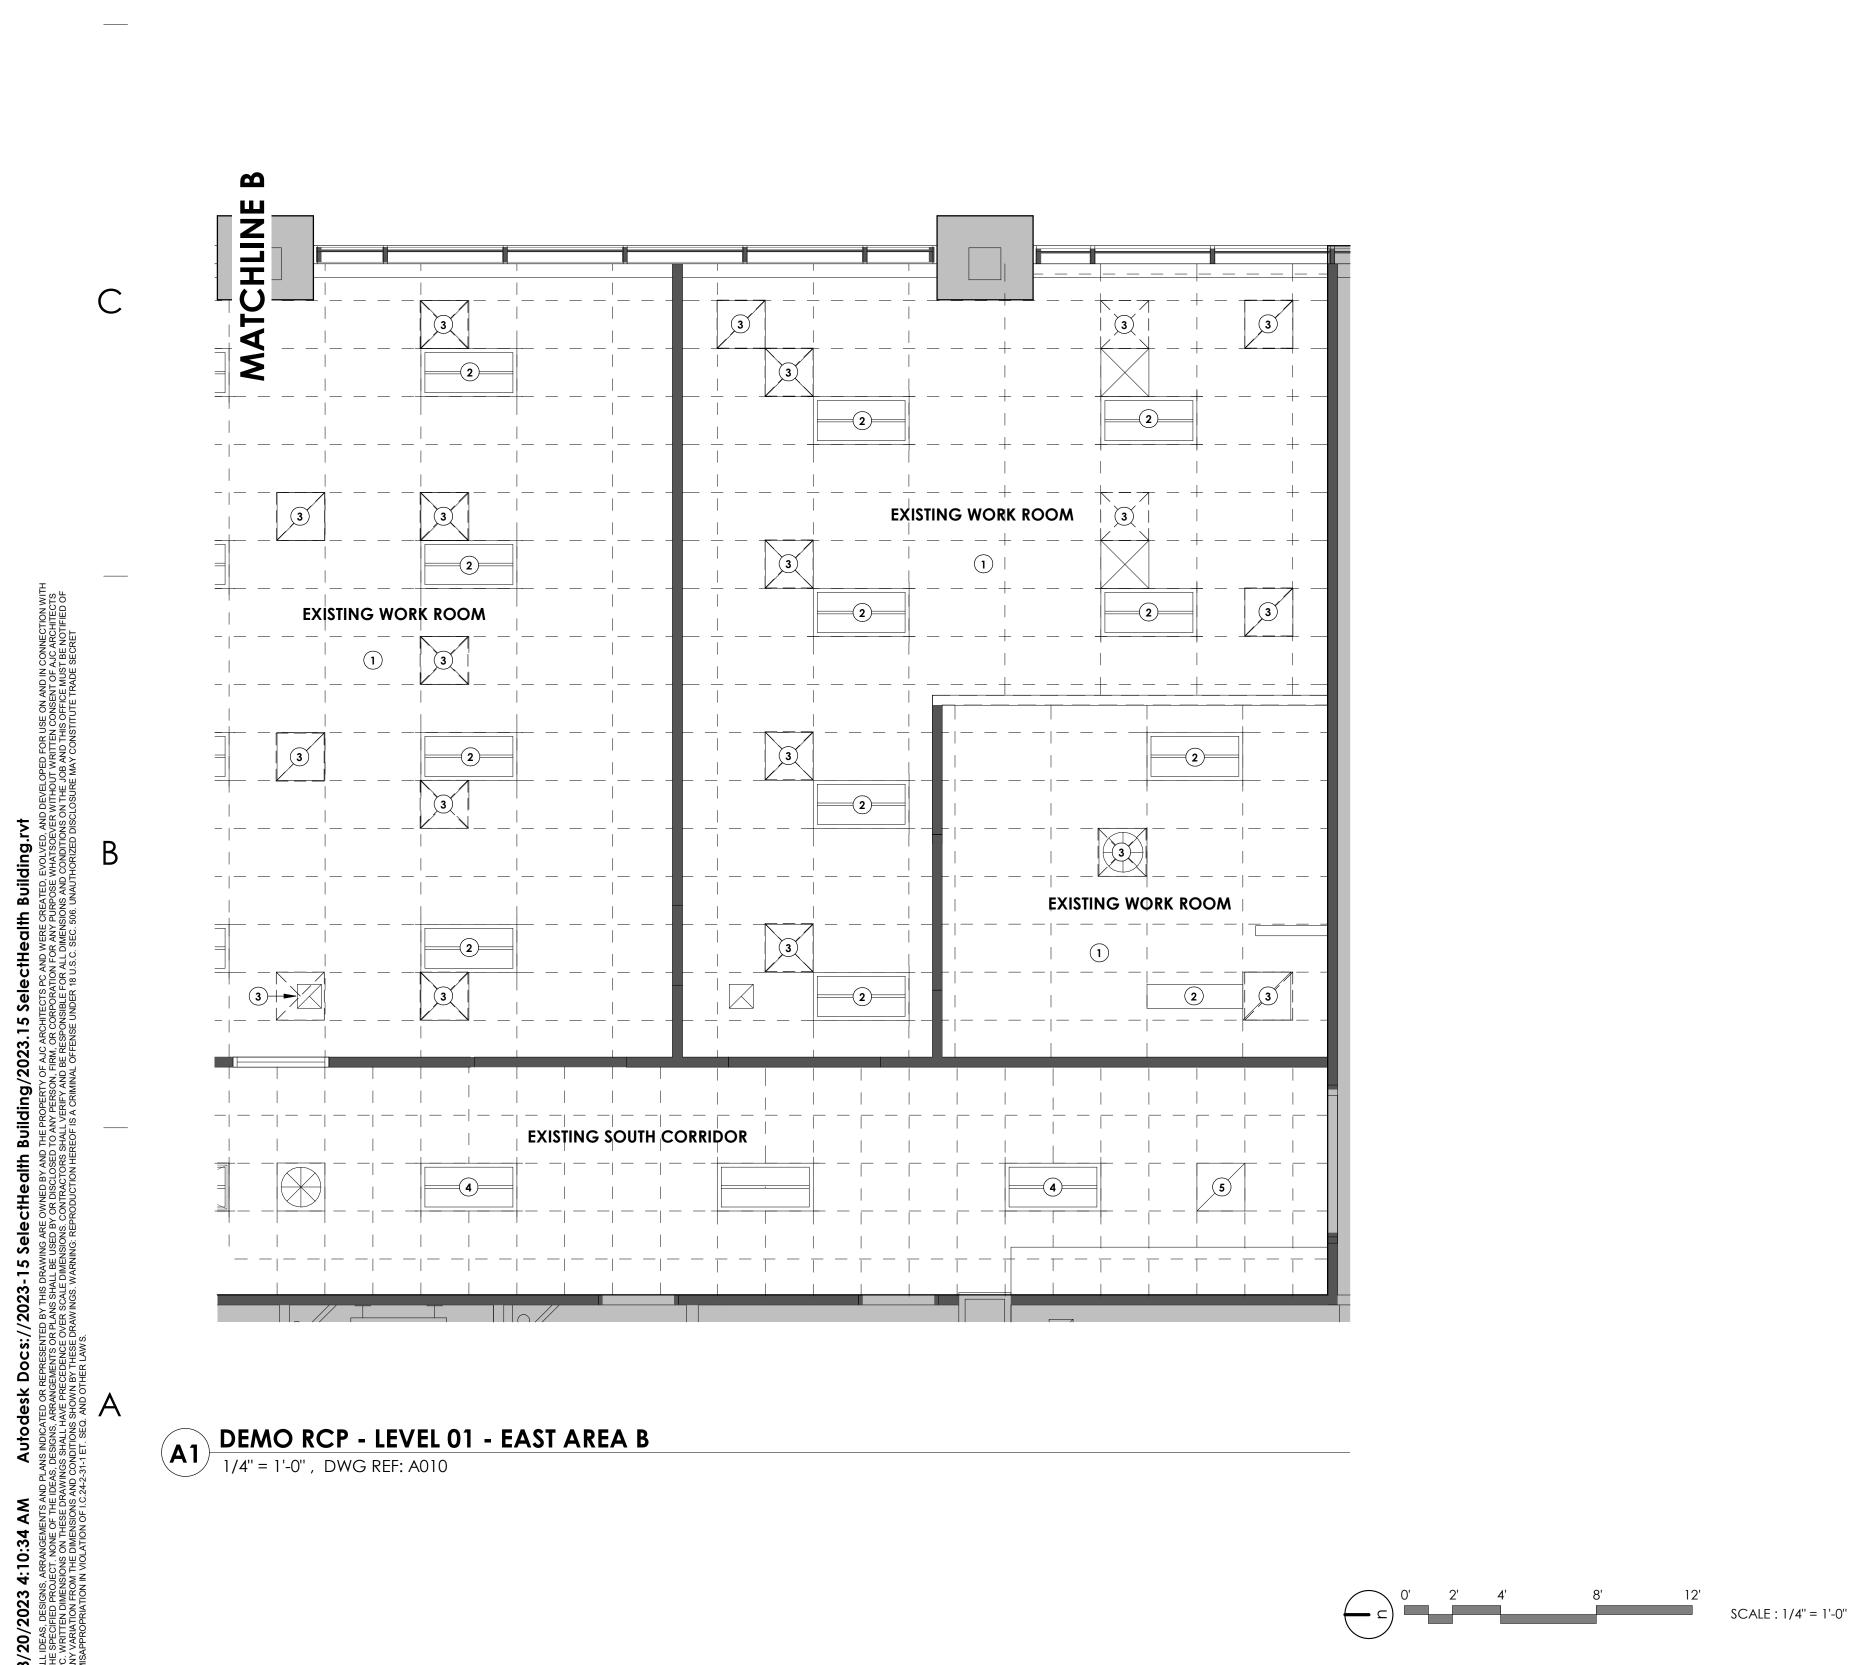
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ARCHITECT / CONSULTANT

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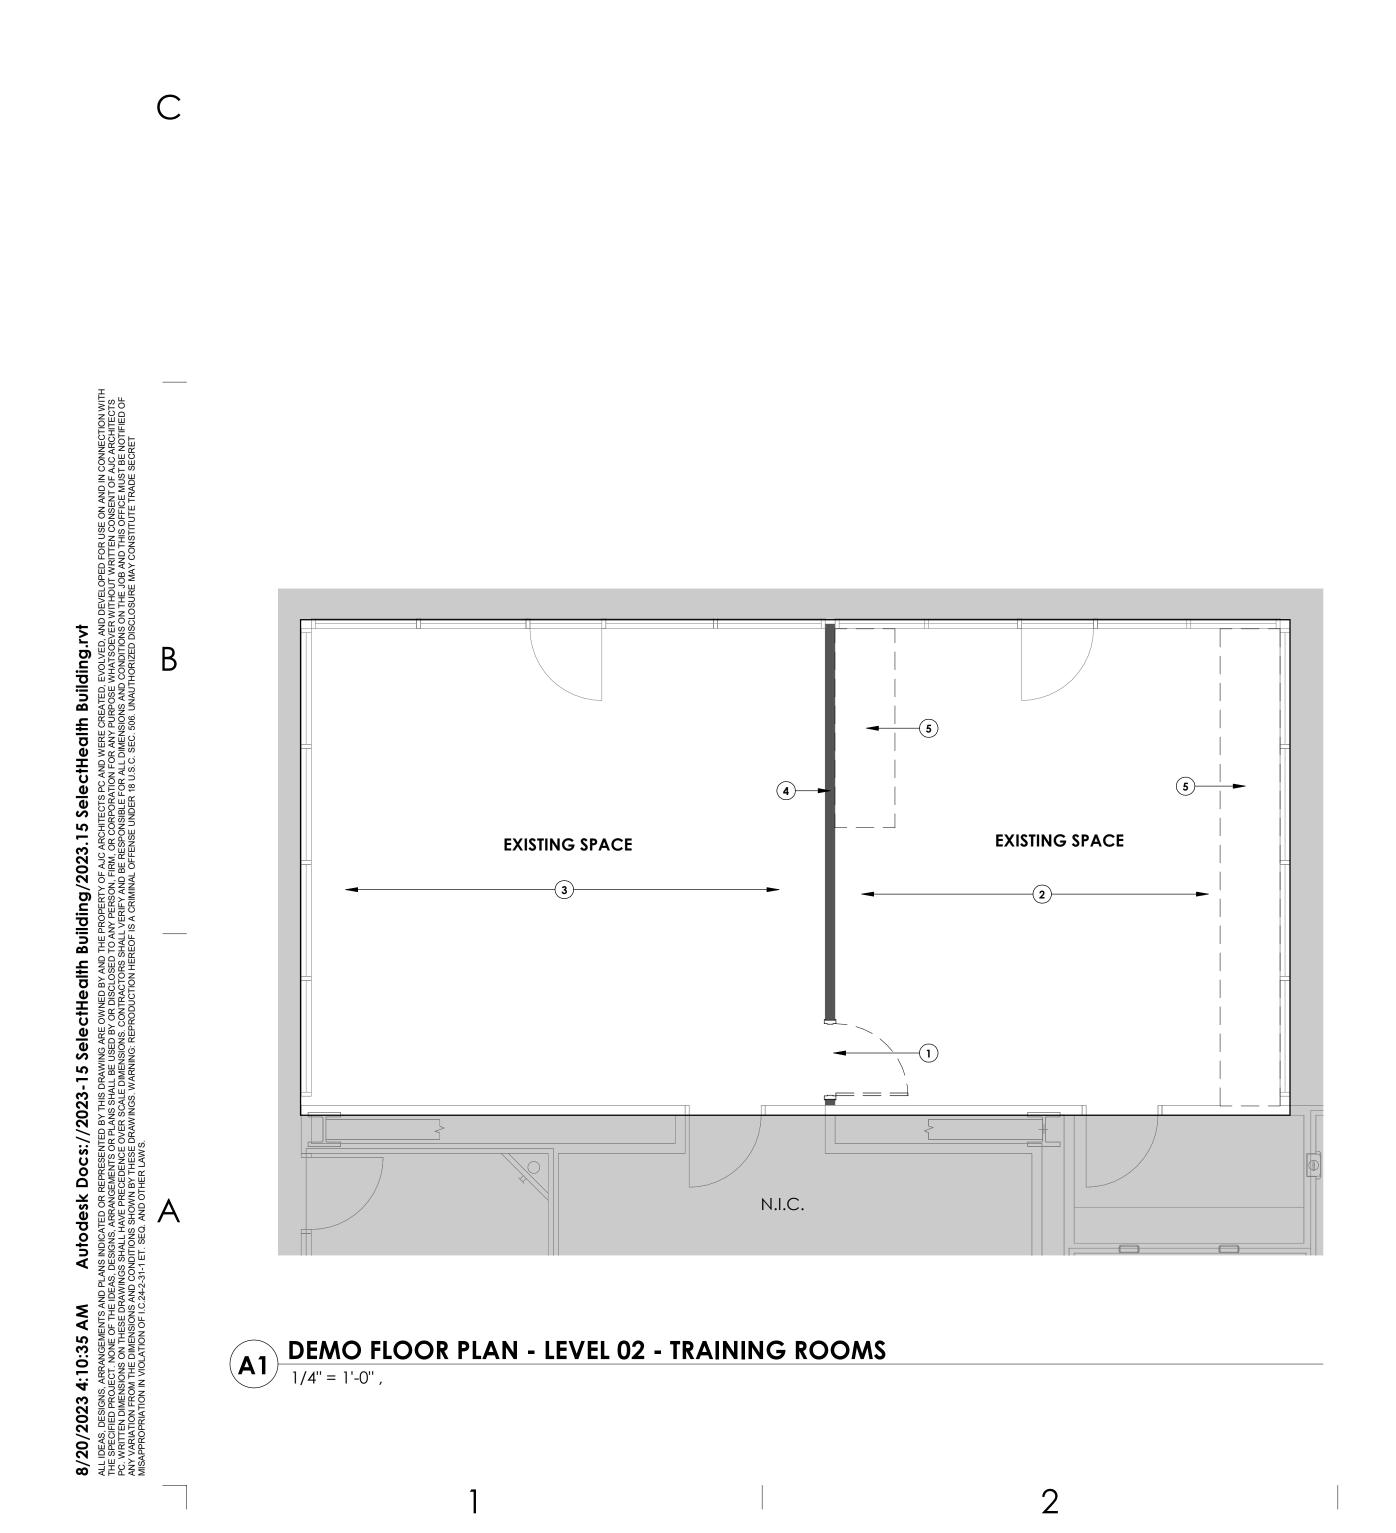
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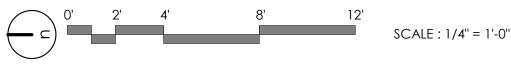




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- DEMO EXISTING DOOR & FRAME; INFILL WITH NEW PARTITION TO MATCH EXISTING ADJACENT PARTITION
- DEMO EXISTING LUXURY VINYL PLANK FLOORING & RESILIENT BASE EXISTING CARPET AND RESILIENT BASE TO REMAIN AND BE PROTECTED 3 DURING CONSTRUCTION
- EXISTING FIRE RATED PARTITION TO REMAIN AND BE PROTECTED DURING 4
- CONSTRUCTION. DEMO EXISTING CASEWORK AND COUNTERTOP

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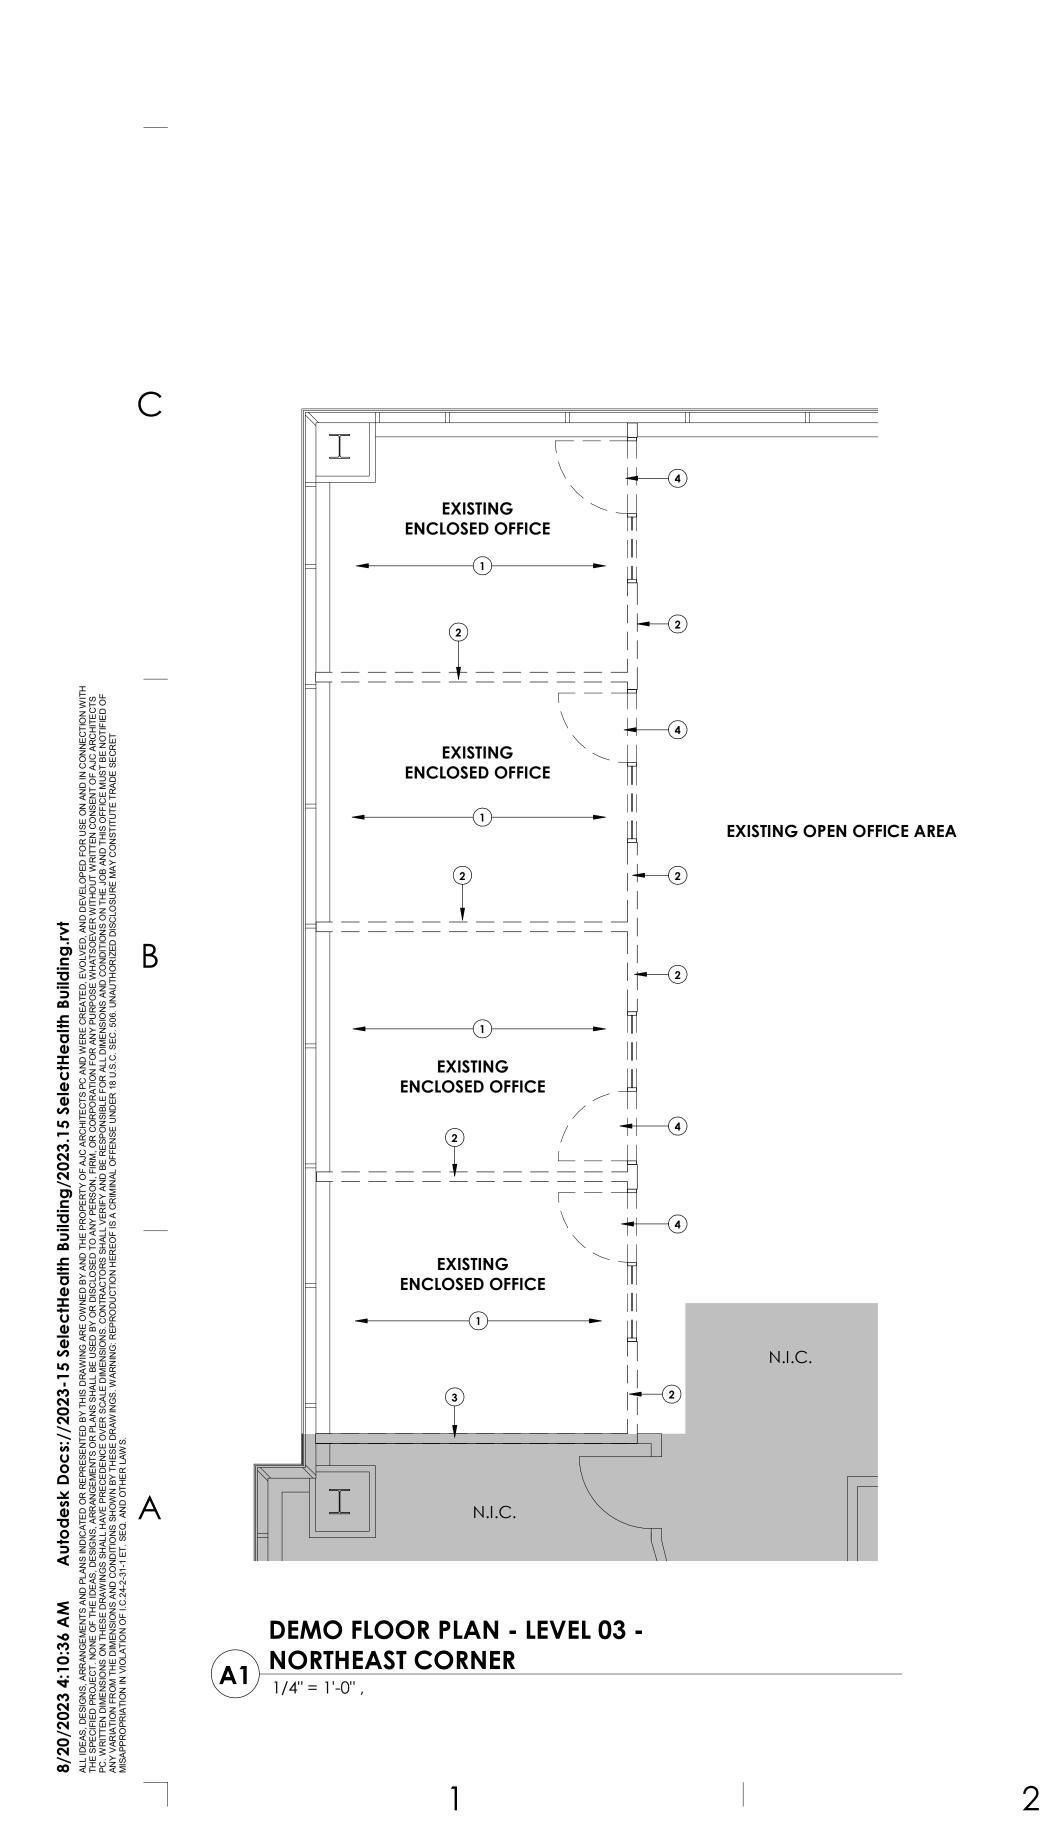
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SHEET NAME:

## **DEMOLITION FLOOR** PLAN - LEVEL 02 -**TRAINING ROOMS**

REVISIONS MARK DATE DESCRIPTION



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# A2 DEMO RCP - LEVEL 03 - NORTHEAST CORNER

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## **KEY NOTES:**

- EXISTING MODULAR CARPET TILES TO BE REMOVED, SALVAGED, STORED & 1 REINSTALLED IN NEW LOCATIONS
- DEMO PORTION OF EXISTING PARTITION TO ACCOMMODATE NEW DOOR 2 EXISTING FIRE RATED PARTITION TO REMAIN AND BE PROTECTED DURING 3 CONSTRUCTION.
- EXISTING DOOR TO BE REMOVED 4
- DEMO AND REPLACE EXISTING ACOUSTIC CEILING PANELS AS REQUIRED 5



703 east 1700 south salt lake city, ut 84105 ajcarchitects.com

ARCHITECT / CONSULTANT



PROJECT DESCRIPTION

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**5381 S GREEN STREET MURRAY, UT 84123** 


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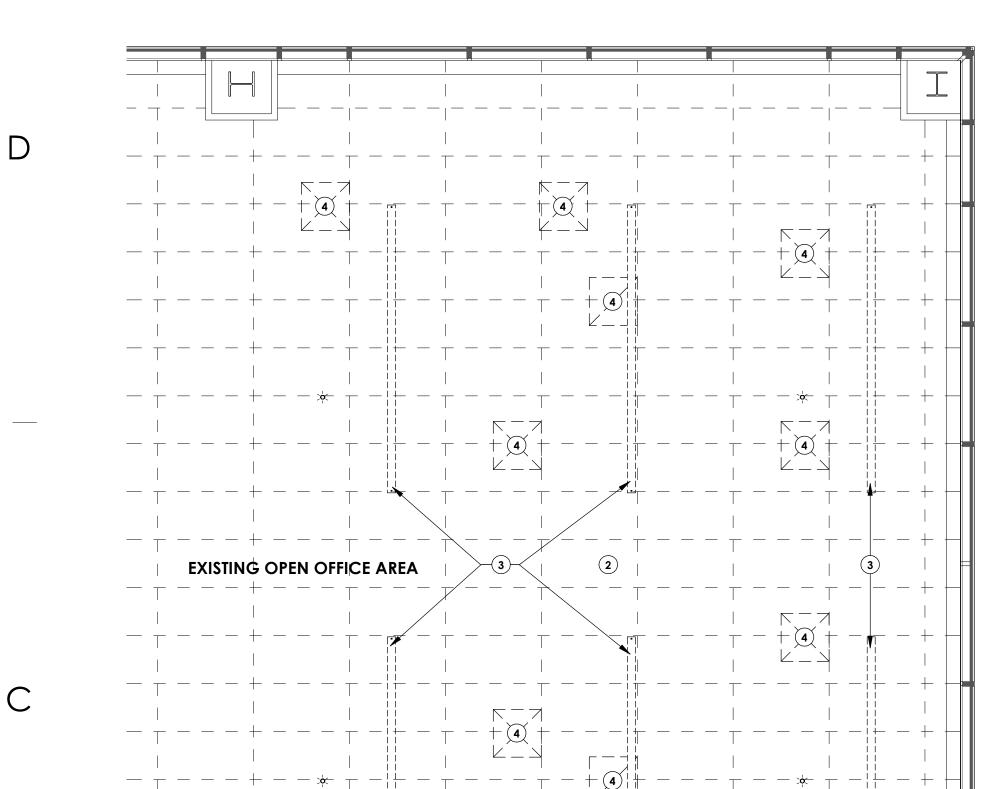
#### **DEMOLITION FLOOR** PLAN & RCP - LEVEL 03 - NORTHEAST CORNER

REVISIONS MARK DATE DESCRIPTION

ISSUE DATE: 08/17/2023 ISSUE TYPE: BID SET DRAWN BY: J. HALBERT CHECKED BY: R. OLSON 2023-15 PROJECT#:






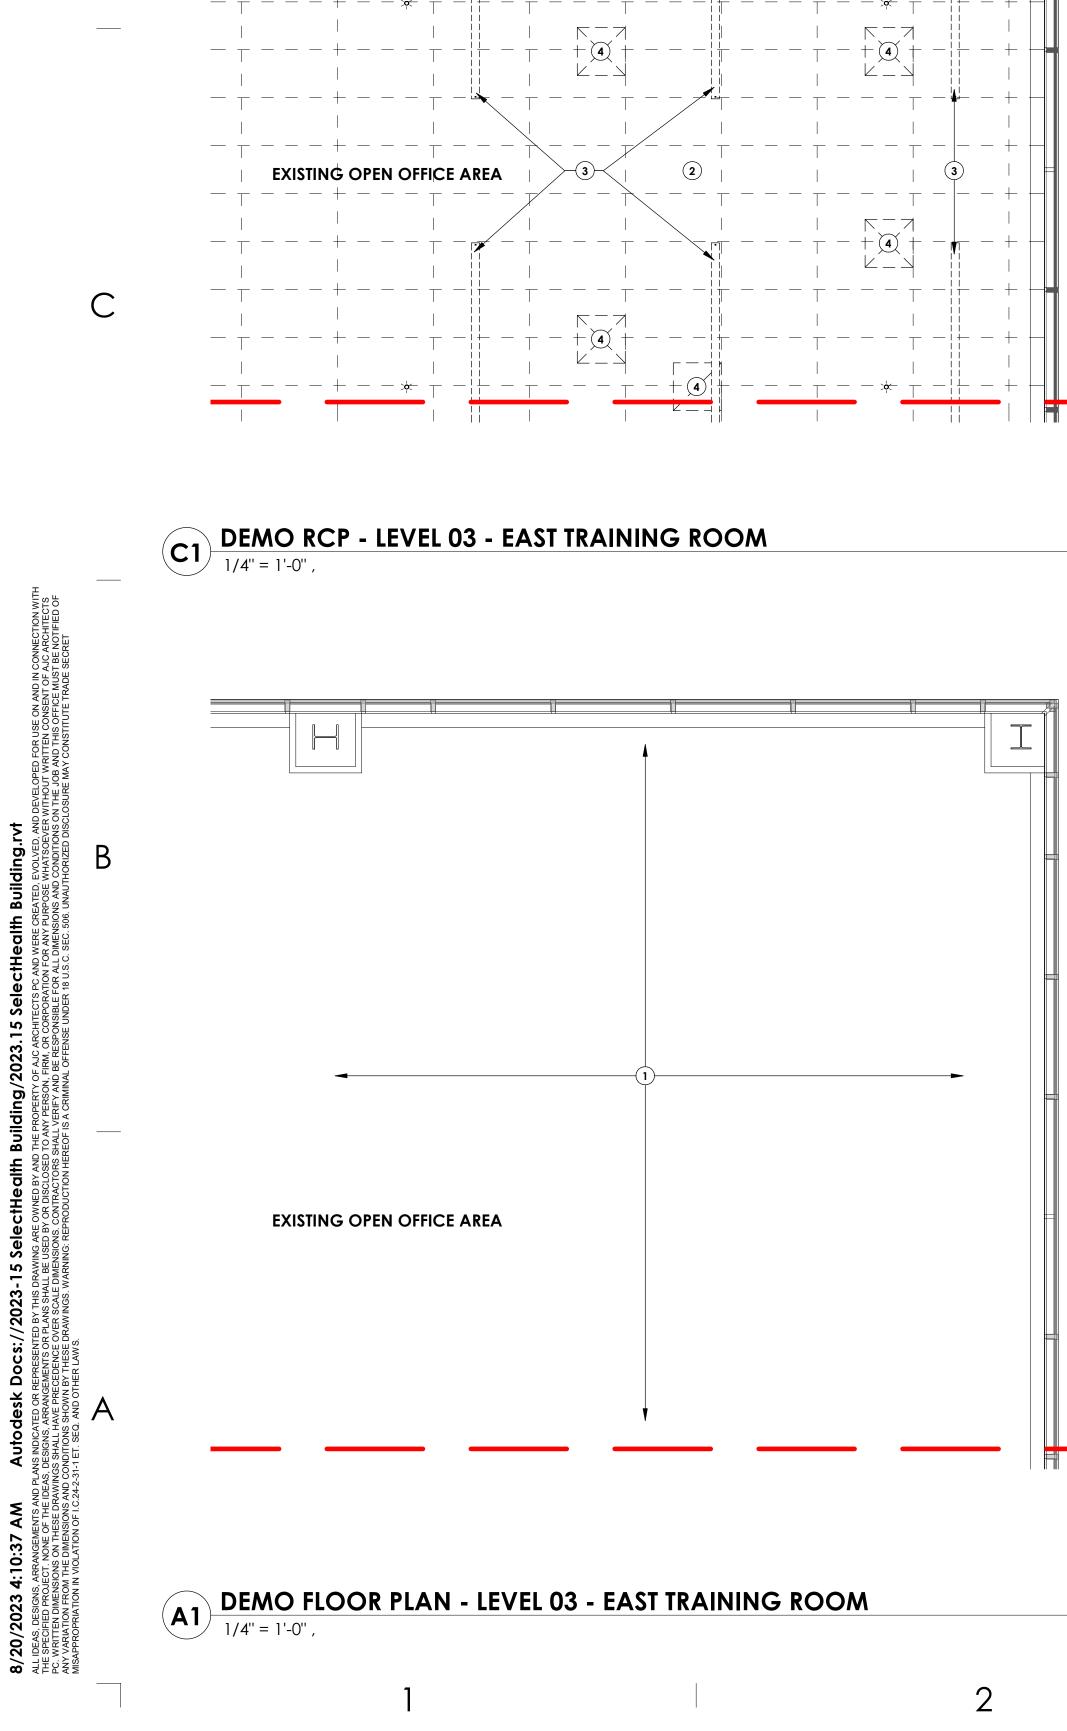

**MATCHLINE A** 

## **MATCHLINE A**

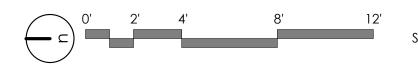

SCALE : 1/4" = 1'-0"

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- EXISTING MODULAR CARPET TILES TO BE REMOVED, SALVAGED, STORED & REINSTALLED IN NEW LOCATIONS
- DEMO EXISTING CEILING
- DEMO EXISTING LIGHT FIXTURE. REFER TO ELECTRICAL DEMO PLAN. DEMO MECHANICAL COMPONENT. REFER TO MECHANICAL DEMO 4 Plans

#### ajc architects

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ARCHITECT / CONSULTANT

PROJECT DESCRIPTION

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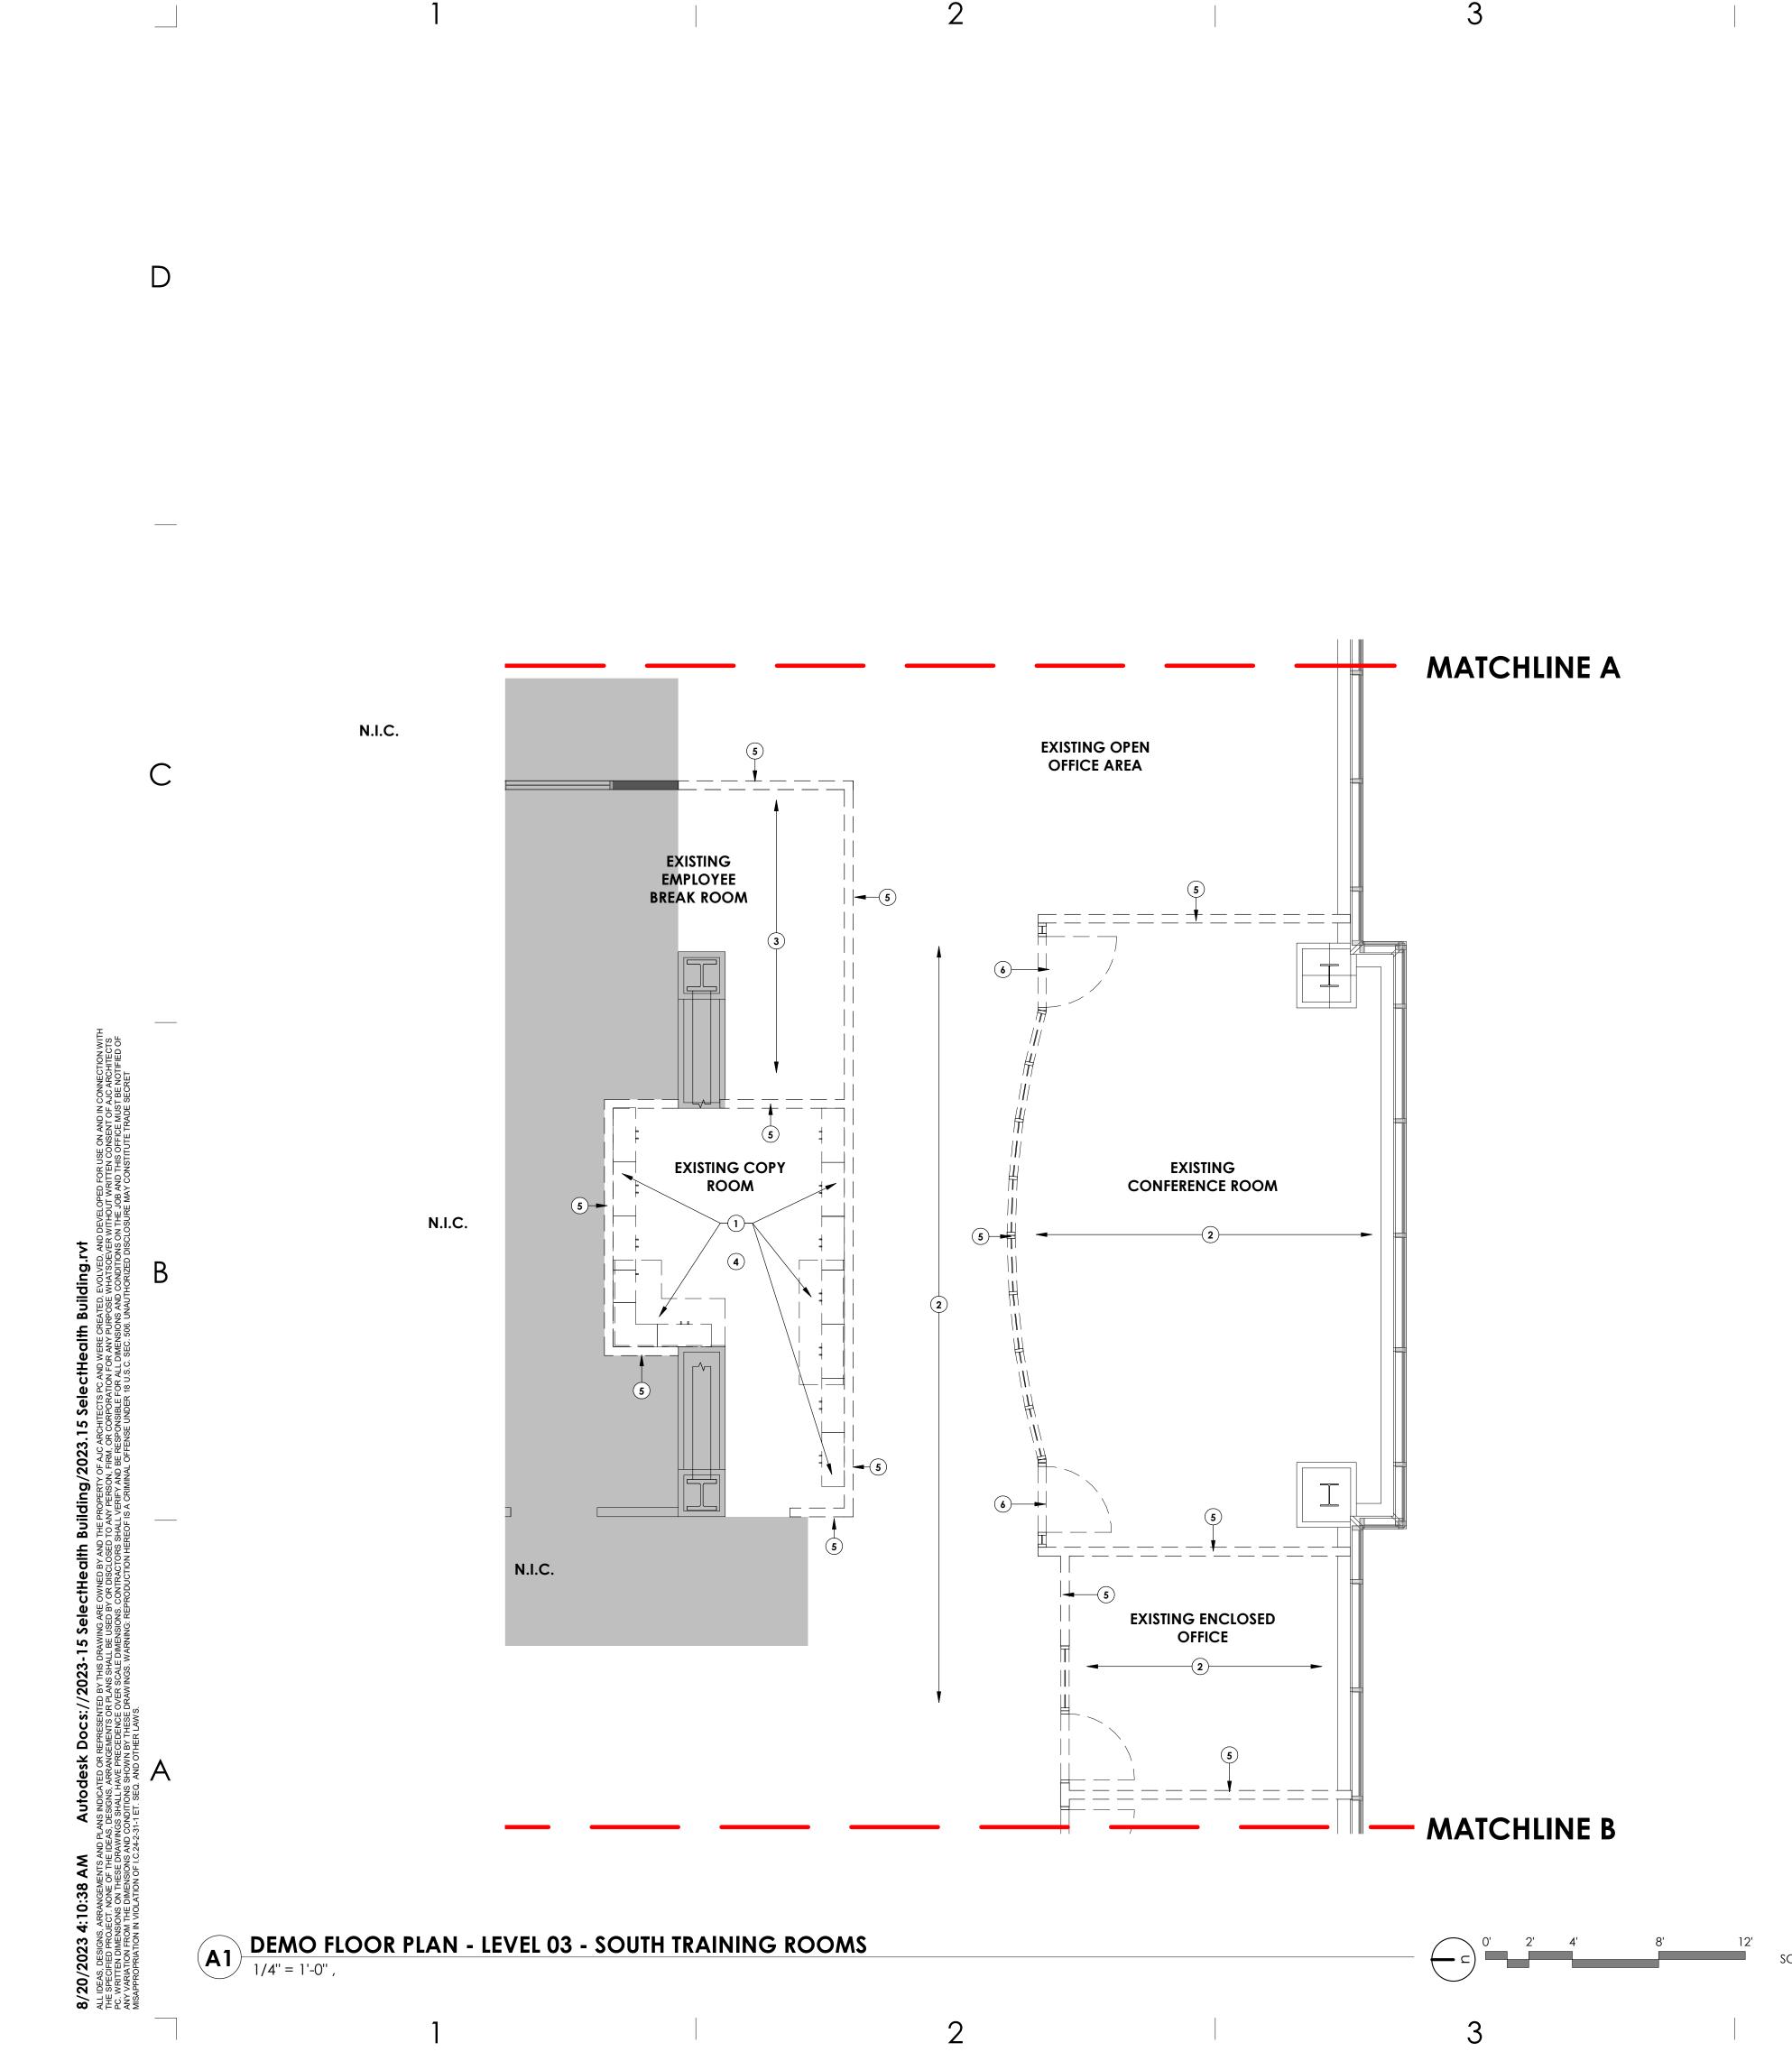
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REVISIONS MARK DATE DESCRIPTION

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## **KEY NOTES:**

- DEMO EXISTING CASEWORK
- EXISTING MODULAR CARPET TILES TO BE REMOVED, SALVAGED, STORED & REINSTALLED IN NEW LOCATIONS
- DEMO EXISTING LUXURY VINYL PLANK FLOORING & RESILIENT BASE DEMO EXISTING FLOOR FINISH 4
- DEMO PORTION OF EXISTING PARTITION TO ACCOMMODATE NEW DOOR EXISTING DOOR TO BE REMOVED

#### ajc architects

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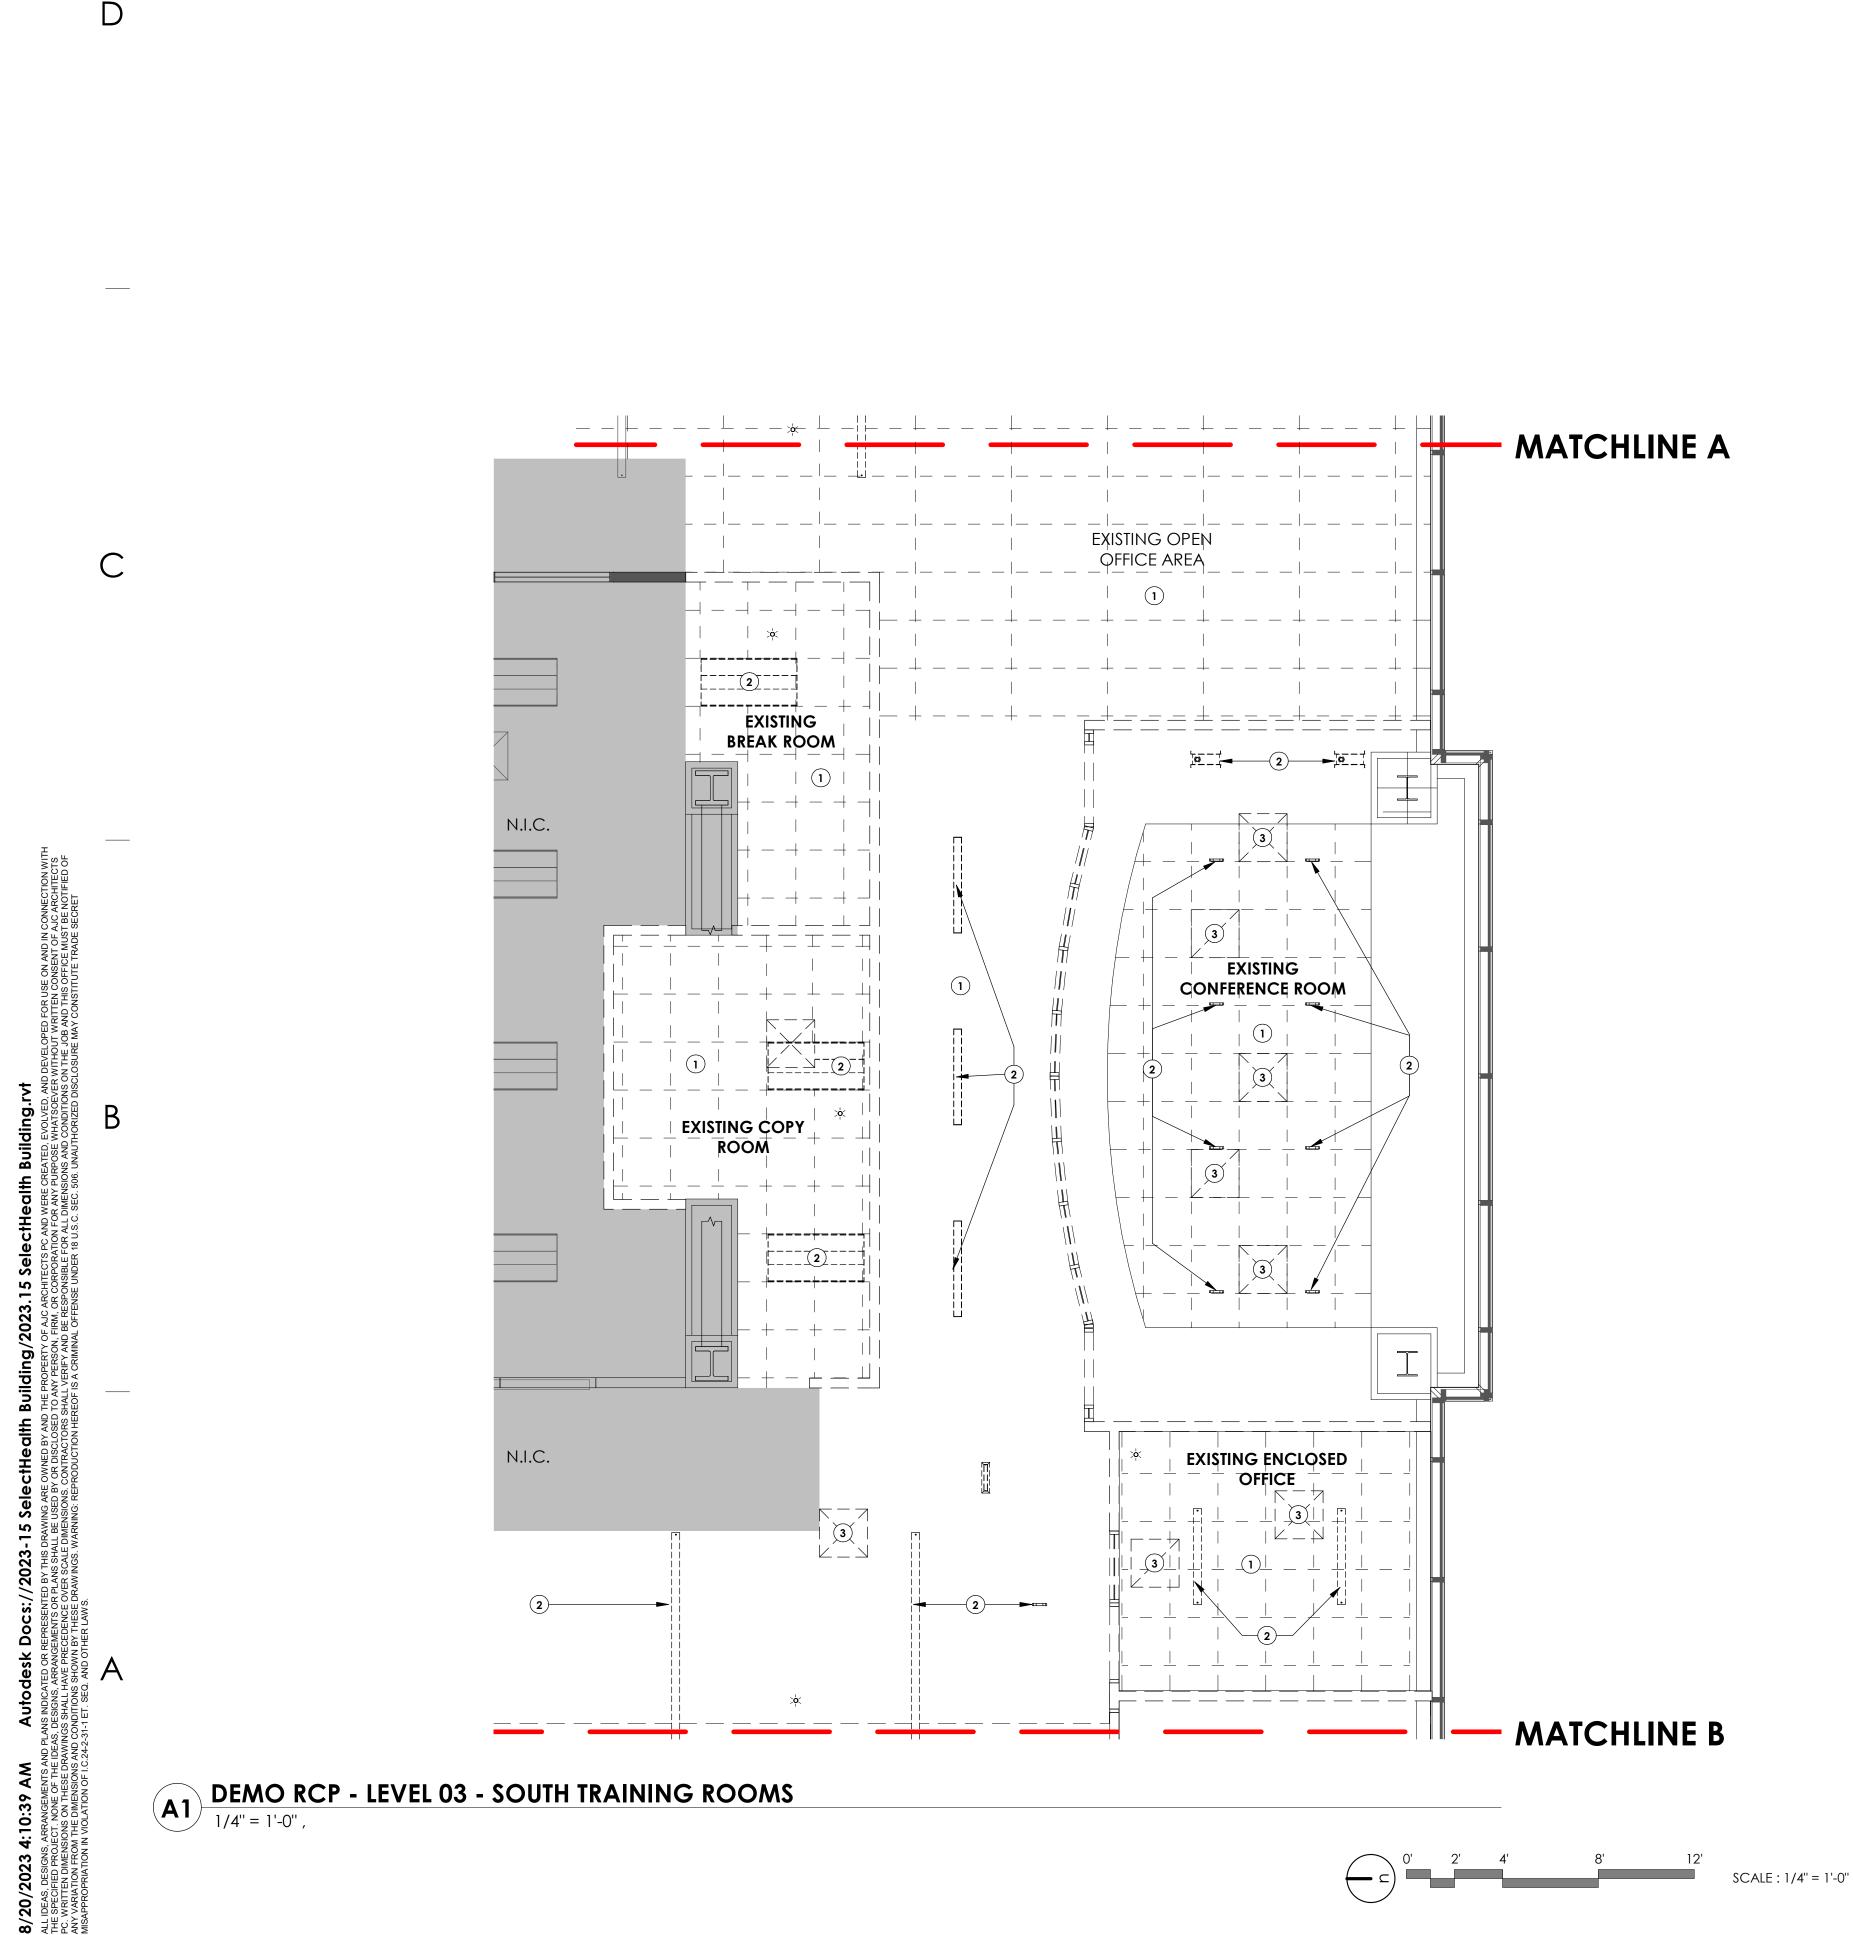
## **DEMOLITION FLOOR** PLAN - LEVEL 03 -**SOUTH TRAINING** ROOMS

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08/17/2023 BID SET J. HALBERT 2023-15





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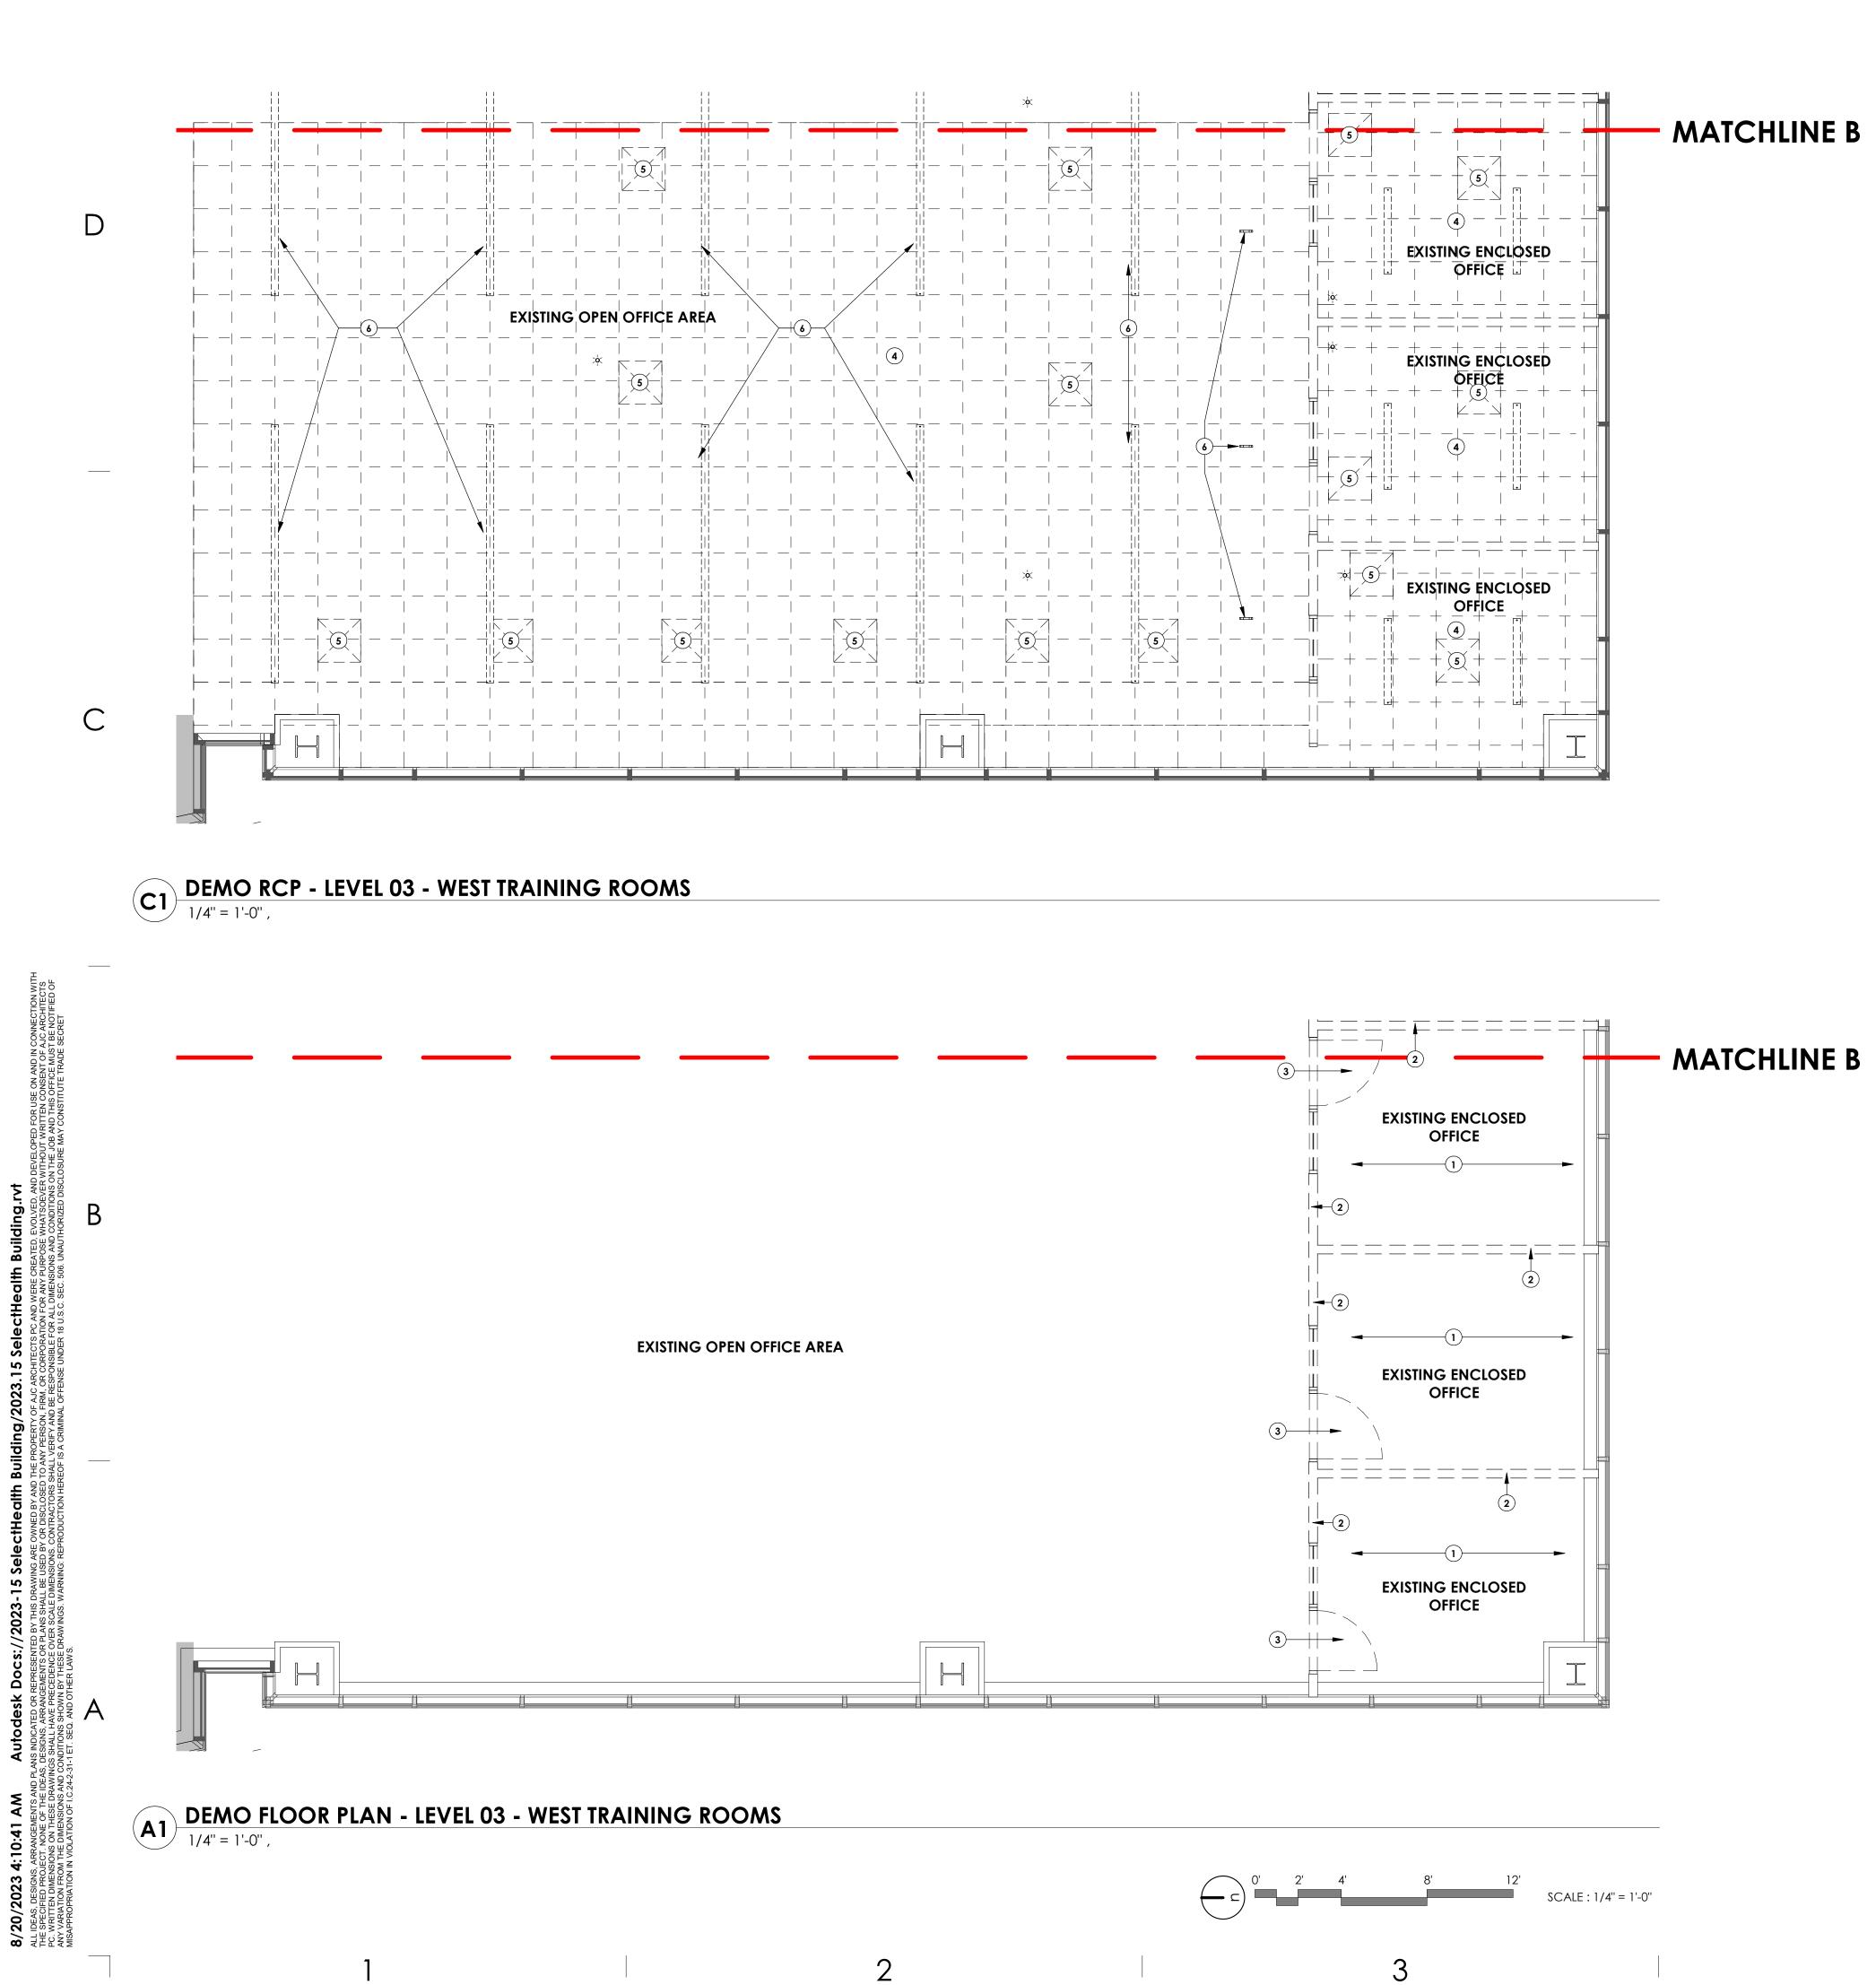
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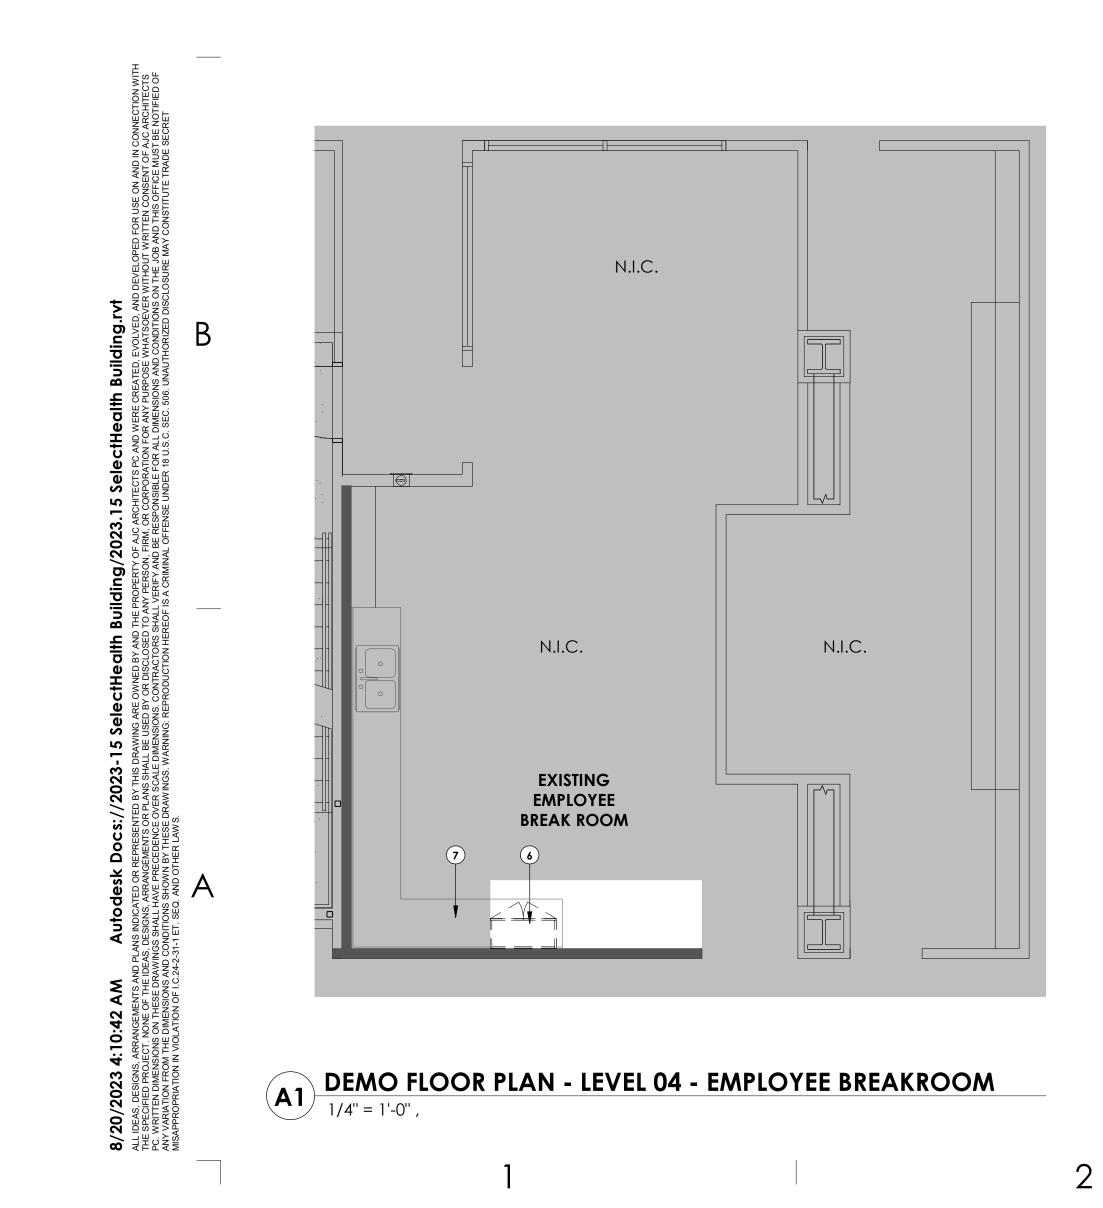
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SEE SHEET G001 FOR DRAWING INDEX.	<b>p</b>
SEE SHEET AG000 FOR GENERAL ARCHITECTURAL NOTES AND ABBREVIATIONS.	ajc architects
do not scale drawings. Contractor / subcontractor shall verify all dimensions and conditions	703 east 1700 south salt lake city, ut 84105
BEFORE BEGINNING WORK, AND SHALL REPORT TO THE ARCHITECT ANY ERRORS, INCONSISTENCIES OR OMISSIONS BEFORE BEGINNING WORK. SEE GENERAL NOTES AND SPECIFICATIONS.	ajcarchitects.com
DEMOLITION NOTES	
ALL ITEMS SHOWN THIS PAGE ARE EXISTING TO REMAIN UNLESS NOTED OTHERWISE GRAPHICALLY OR BY KEYED NOTE. EXTENTS OF THIS SELECTIVE DEMOLITION PACKAGE	
ARE THE BUILDING'S ENVELOPE AND ANY SMALL PENETRATIONS TO BE SEALED TO MAINTAIN AN AIRTIGHT ENVELOPE. CONTRACTOR TO PROVIDE ANY TEMPORARY CONSTRUCTION TO MAINTAIN ENVELOPE INTEGRITY.	
STANDARD GRAPHIC REPRESENTATIONS OF WALLS, DOORS, PLUMBING FIXTURES & TOILET ACCESSORIES INDEPENDENTLY REFERENCE DEMO OR EXISTING TO REMAIN	
CONDITIONS WITH OR WITHOUT AN ATTACHED KEYED NOTE. PROVIDE DEMO OF ALL ITEMS SHOWN DASHED. (SEE PRECEDING NOTE).	
SEE MECHANICAL/PLUMBING (MD/PD) DEMO & ELECTRICAL (ED) DEMO SHEETS AND SPECIFICATIONS FOR ADDITIONAL DEMOLITION OR EXISTING CONDITIONS	ARCHITECT / CONSULTANT
INFORMATION. WHERE PLUMBING, MECHANICAL OR ELECTRICAL ITEMS ARE SHOWN DEMO'D ON THIS PAGE. THE INFORMATION IS SUPPLIED AS A SUPPLEMENT TO THE MD SHEETS AND ED SHEETS. THE EXTENT OF THE DEMOLITION IS AS PER REQUIRED BY THE	
SPECIFICATIONS, MD SHEETS AND ED SHEETS. DISPOSE OF ALL MATERIALS MARKED AS "REMOVE" OR "DEMO" RECYCLE REMOVED	
MATERIALS WHENEVER PRACTICAL." CONDITIONS MARKED "SALVAGED" ARE REUSED DURING NEW CONSTRUCTION AND SHOULD BE PROTECT UNTIL REINSTALLATION. COORDINATE WITH ARCHITECT ANY DISCREPENCIES.	TE OF UTAK
REMOVE EXISTING MILLWORK AND PLUMBING FIXTURE(S) WHERE SHOWN. REMOVE PLUMBING PER SPEC. & PD SHEETS. CAP PLUMBING LINES AT BUILDING ENVELOPE.	JUSTIN K.
REMOVE ALL INTERIOR DOOR/WINDOW FRAME AND GLAZING WHERE SHOWN.	HEPPLER 6137252-0301
EXISTING ROOF DRAIN LINE DROPS TO REMAIN U.N.O. PROTECT. SEE PLUMBING.	8/17/2023
REMOVE EXISTING (STUBBED OUT OR PARTIALLY DEMO'D) PIPING AS PER SPEC. & MECHANICAL/PLUMBING SHEETS. CAP AT BUILDING ENVELOPE WHERE OCCURS.	CD ARO
REMOVE EXISTING ELECTRICAL AND LIGHTING WHERE SHOWN. SEAL PENETRATIONS THROUGH BUILDING ENVELOPE WHERE OCCURS.	
REMOVE EXISTING CARPET AND BASE WHERE SHOWN. RECYCLE TO EXTENT POSSIBLE.	
REMOVE EXISTING TILE, BASE AND SETTING BEDS, WHERE SHOWN. RECYCLE TO EXTENT POSSIBLE.	SELECTHEALTH BUILDING TENANT IMPROVEMENT
REMOVE EXISTING BRICK FLOORING AND MORTAR WHERE OCCURS	
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MAINTAIN EXISTING FLOOR/CEILING/ROOF/CEILING AND SHAFT FIRE RATINGS AND ASSEMBLIES. REPAIR AND SEAL ALL PUNCTURES AND GAPS.	
EXISTING 8" REINFORCED MASONRY WALL SHOWN DASHED TO BE	
EXISTING METAL STUD & GYP BOARD WALL SHOWN DASHED TO BE	
REMOVED/RECYCLED IN ITS ENTIRETY. EXISTING ALUMINUM STOREFRONT SYSTEM & GLAZING SHOWN DASHED TO BE	
REMOVED/RECYCLED IN ITS ENTIRETY. EXISTING DOOR & FRAME SHOWN DASHED TO BE REMOVED/RECYCLED IN ITS	
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EQUIPMENT, SHOWN DASHED.	- WEST TRAINING
DEMOLITION DEFINITIONS	ROOM
<b>REMOVE</b> : UNLESS ITEMS ARE OTHERWISE INDICATED TO BE REINSTALLED OR	
SLAVAGED, REMOVE AND DISPOSE BY RECYCLING TO GREATEST EXTENT POSSIBLE OR IS PRACTICAL	REVISIONS
<b>REMOVE AND REINSTALL</b> : REMOVE ITEMS INDICATED; CLEAN, SERVICE ND OTHERWISE PERPARE FOR SERVICE; REINSTALL IN THE SAME LOCATION (OR IN THE LOCATION INDICATED).	MARK DATE DESCRIPTION
<b>REMOVE AND INSTALL NEW:</b> REMOVE AND DISPOSE OF ITEMS INDCATED AND INSTALL NEW ITEMS IN THE SAME LOCATION (OR IN THE LOCATION INDICATED).	
<b>REMOVE AND SALVAGE:</b> ITEMS INDICATED TO BE SALVAGED WILL REMAIN THE OWNER'S PROPERTY. CAREFULLY REMOVE AND CLEAN ITEMS INDICATED TO BE	
SALVAGED; PACK OR CRATE TO PROTECT AGAINST DAMAGE; IDENTIFY CONTENTS OF CONTAINERS; DELIVER TO THE LOCATION INDICATED.	
<b>REMOVE AND RECYCLE:</b> REMOVE AND RECYCLE TO THE GREATEST EXTENT PRACTICAL OF ITEMS INDICATED. ALL DEMOLISHED OR REMOVED ITEMS AND MATERIALS SHALL BE CONSIDERED SCRAP, EXCEPT FOR THOSE INDICATED TO REMAIN, THOSE INDICATED TO BE REINSTALLED, AND THOSE INDICATED TO BE SALVAGED.	
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KEY NOTES:	
1 EXISTING MODULAR CARPET TILES TO BE REMOVED, SALVAGED, STORED & REINSTALLED IN NEW LOCATIONS	ISSUE DATE:         08/17/2023           ISSUE TYPE:         BID SET

- DEMO PORTION OF EXISTING PARTITION TO ACCOMMODATE NEW DOOR EXISTING DOOR TO BE REMOVED 3 DEMO EXISTING CEILING 4
- DEMO MECHANICAL COMPONENT. REFER TO MECHANICAL DEMO 5
- PLANS DEMO EXISTING LIGHT FIXTURE. REFER TO ELECTRICAL DEMO PLAN. 6

BID SET DRAWN BY: J. HALBERT CHECKED BY: R. OLSON PROJECT#: 2023-15






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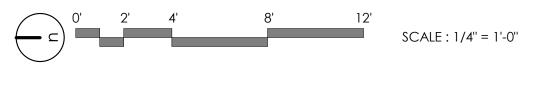
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## DEMO FLOOR PLAN - LEVEL 06 -A2 **EXECUTIVE BREAKROOM** 1/4" = 1'-0",

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GENERAL NOTES:	
SEE SHEET G001 FOR DRAWING INDEX.	
EE SHEET AG000 FOR GENERAL ARCHITECTURAL NOTES AND ABBREVIATIONS.	ajc architects
oo not scale drawings.	703 east 1700 south
CONTRACTOR / SUBCONTRACTOR SHALL VERIFY ALL DIMENSIONS AND CONDITIONS EFORE BEGINNING WORK, AND SHALL REPORT TO THE ARCHITECT ANY ERRORS, NCONSISTENCIES OR OMISSIONS BEFORE BEGINNING WORK. SEE GENERAL NOTES AND PECIFICATIONS.	salt lake city, ut 84105 ajcarchitects.com
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DISPOSE OF ALL MATERIALS MARKED AS "REMOVE" OR "DEMO" RECYCLE REMOVED MATERIALS WHENEVER PRACTICAL." CONDITIONS MARKED "SALVAGED" ARE REUSED DURING NEW CONSTRUCTION AND SHOULD BE PROTECT UNTIL REINSTALLATION. COORDINATE WITH ARCHITECT ANY DISCREPENCIES.	SE GTATE OF UTAGE
REMOVE EXISTING MILLWORK AND PLUMBING FIXTURE(S) WHERE SHOWN. REMOVE PLUMBING PER SPEC. & PD SHEETS. CAP PLUMBING LINES AT BUILDING ENVELOPE.	JUSTIN K. HEPPLER
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XISTING ROOF DRAIN LINE DROPS TO REMAIN U.N.O. PROTECT. SEE PLUMBING. REMOVE EXISTING (STUBBED OUT OR PARTIALLY DEMO'D) PIPING AS PER SPEC. &	SED ARCHING
AECHANICAL/PLUMBING SHEETS. CAP AT BUILDING ENVELOPE WHERE OCCURS.	~~~~~~~~~~~~~~~~~~~~~~~~~~~~~~~~~~~~~~
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EMOVE EXISTING CARPET AND BASE WHERE SHOWN. RECYCLE TO EXTENT POSSIBLE.	PROJECT DESCRIPTION
EMOVE EXISTING TILE, BASE AND SETTING BEDS, WHERE SHOWN. RECYCLE TO EXTENT OSSIBLE. EMOVE EXISTING BRICK FLOORING AND MORTAR WHERE OCCURS	SELECTHEALTH BUILDING
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EMOVED/RECYCLED IN ITS ENTIRETY.	
NTIRETY. EMOVE AND RECYCLE/SALVAGE ALL EXISTING FURNITURE, FIXTURES, AND QUIPMENT, SHOWN DASHED.	DEMOLITION FLOOR PLAN - LEVEL 04 - EMPLOYEE BREAK ROOM AND LEVEL 06 -
DEMOLITION DEFINITIONS	EXECUTIVE BREAK
EMOVE: UNLESS ITEMS ARE OTHERWISE INDICATED TO BE REINSTALLED OR	ROOM
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EY NOTES:	
DEMO EXISTING FLOOR FINISH	ISSUE DATE: 08/17/2023

RK & COUNTERTOP. REMOVE, STORE, AND PRESERVE CABINET HANDLES FOR REINSTALL 3 SALVAGE ITEM, RETURN TO OWNER

ISSUE TYPE:

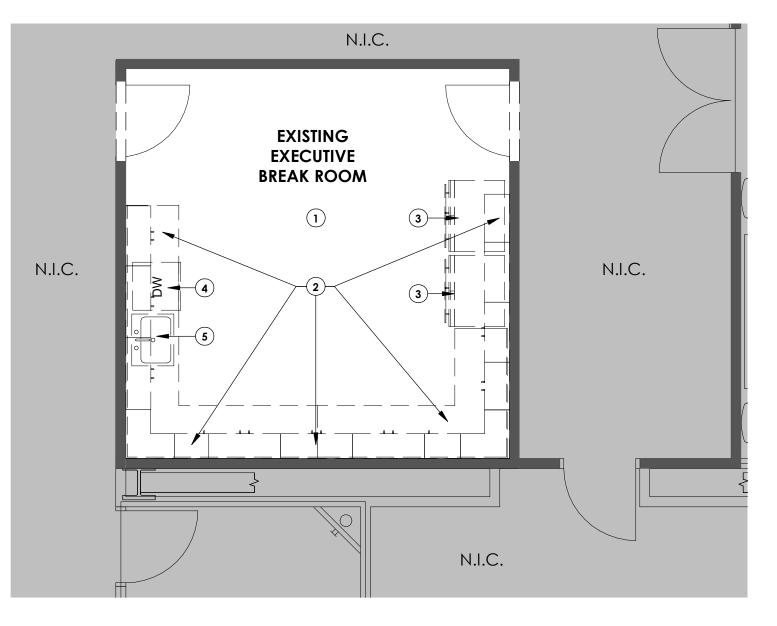DRAWN BY:

SHEET NUMBER:

CHECKED BY: R. OLSON

PROJECT#: 2023-15

AD015

**BID SET** 

J. HALBERT

- 4 SALVAGE ITEM, RE-USE IN NEW WORK
- DEMO PLUMBING FIXTURE 5
- DEMO EXISTING CASEWORK, PATCH AND REPAIR SUBSTRATE AS REQUIRED. 6 REMOVE, STORE, AND PRESERVE CABINET HANDLES FOR REINSTALL
- 7
- EXISTING CASEWORK TO REMAIN AND TO BE PROTECTED DURING CONSTRUCTION



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# **CEILING TYPES**

CEILING SUSPENSION WIRE —

2'x4' SUSPENDED ACOUSTIC PANEL — CEILING SYSTEM, SEE SPECIFICATION

CROSS TEE GRID, SEE SPECIFICATION

SUSPENDED ACOUSTIC TILE CEILING

WALL TYPES	
5/8" GYP. BD, REFER TO FINISH LEGEND, TYP. FOR FINISH	ajc architects
3-5/8" METAL STUD @ 16" O.C.	703 east 1700 south salt lake city, ut 84105 ajcarchitects.com
5/8" GYP. BD, REFER TO FINISH LEGEND, TYP. FOR FINISH	
*NOTE: EXTEND WALL & GYP BD. 6" MIN ABOVE ADJACENT CEILING HEIGHT, U.N.O. SEE TYPICAL WALL DETAILS.	
3-5/8" METAL STUD PARTITION WALL M1	

ARCHITECT / CONSULTANT



PROJECT DESCRIPTION

## SELECTHEALTH BUILDING TENANT IMPROVEMENT

5381 S GREEN STREET MURRAY, UT 84123

Sheet name:

ASSEMBLIES - CEILING & WALL

REVISIONS


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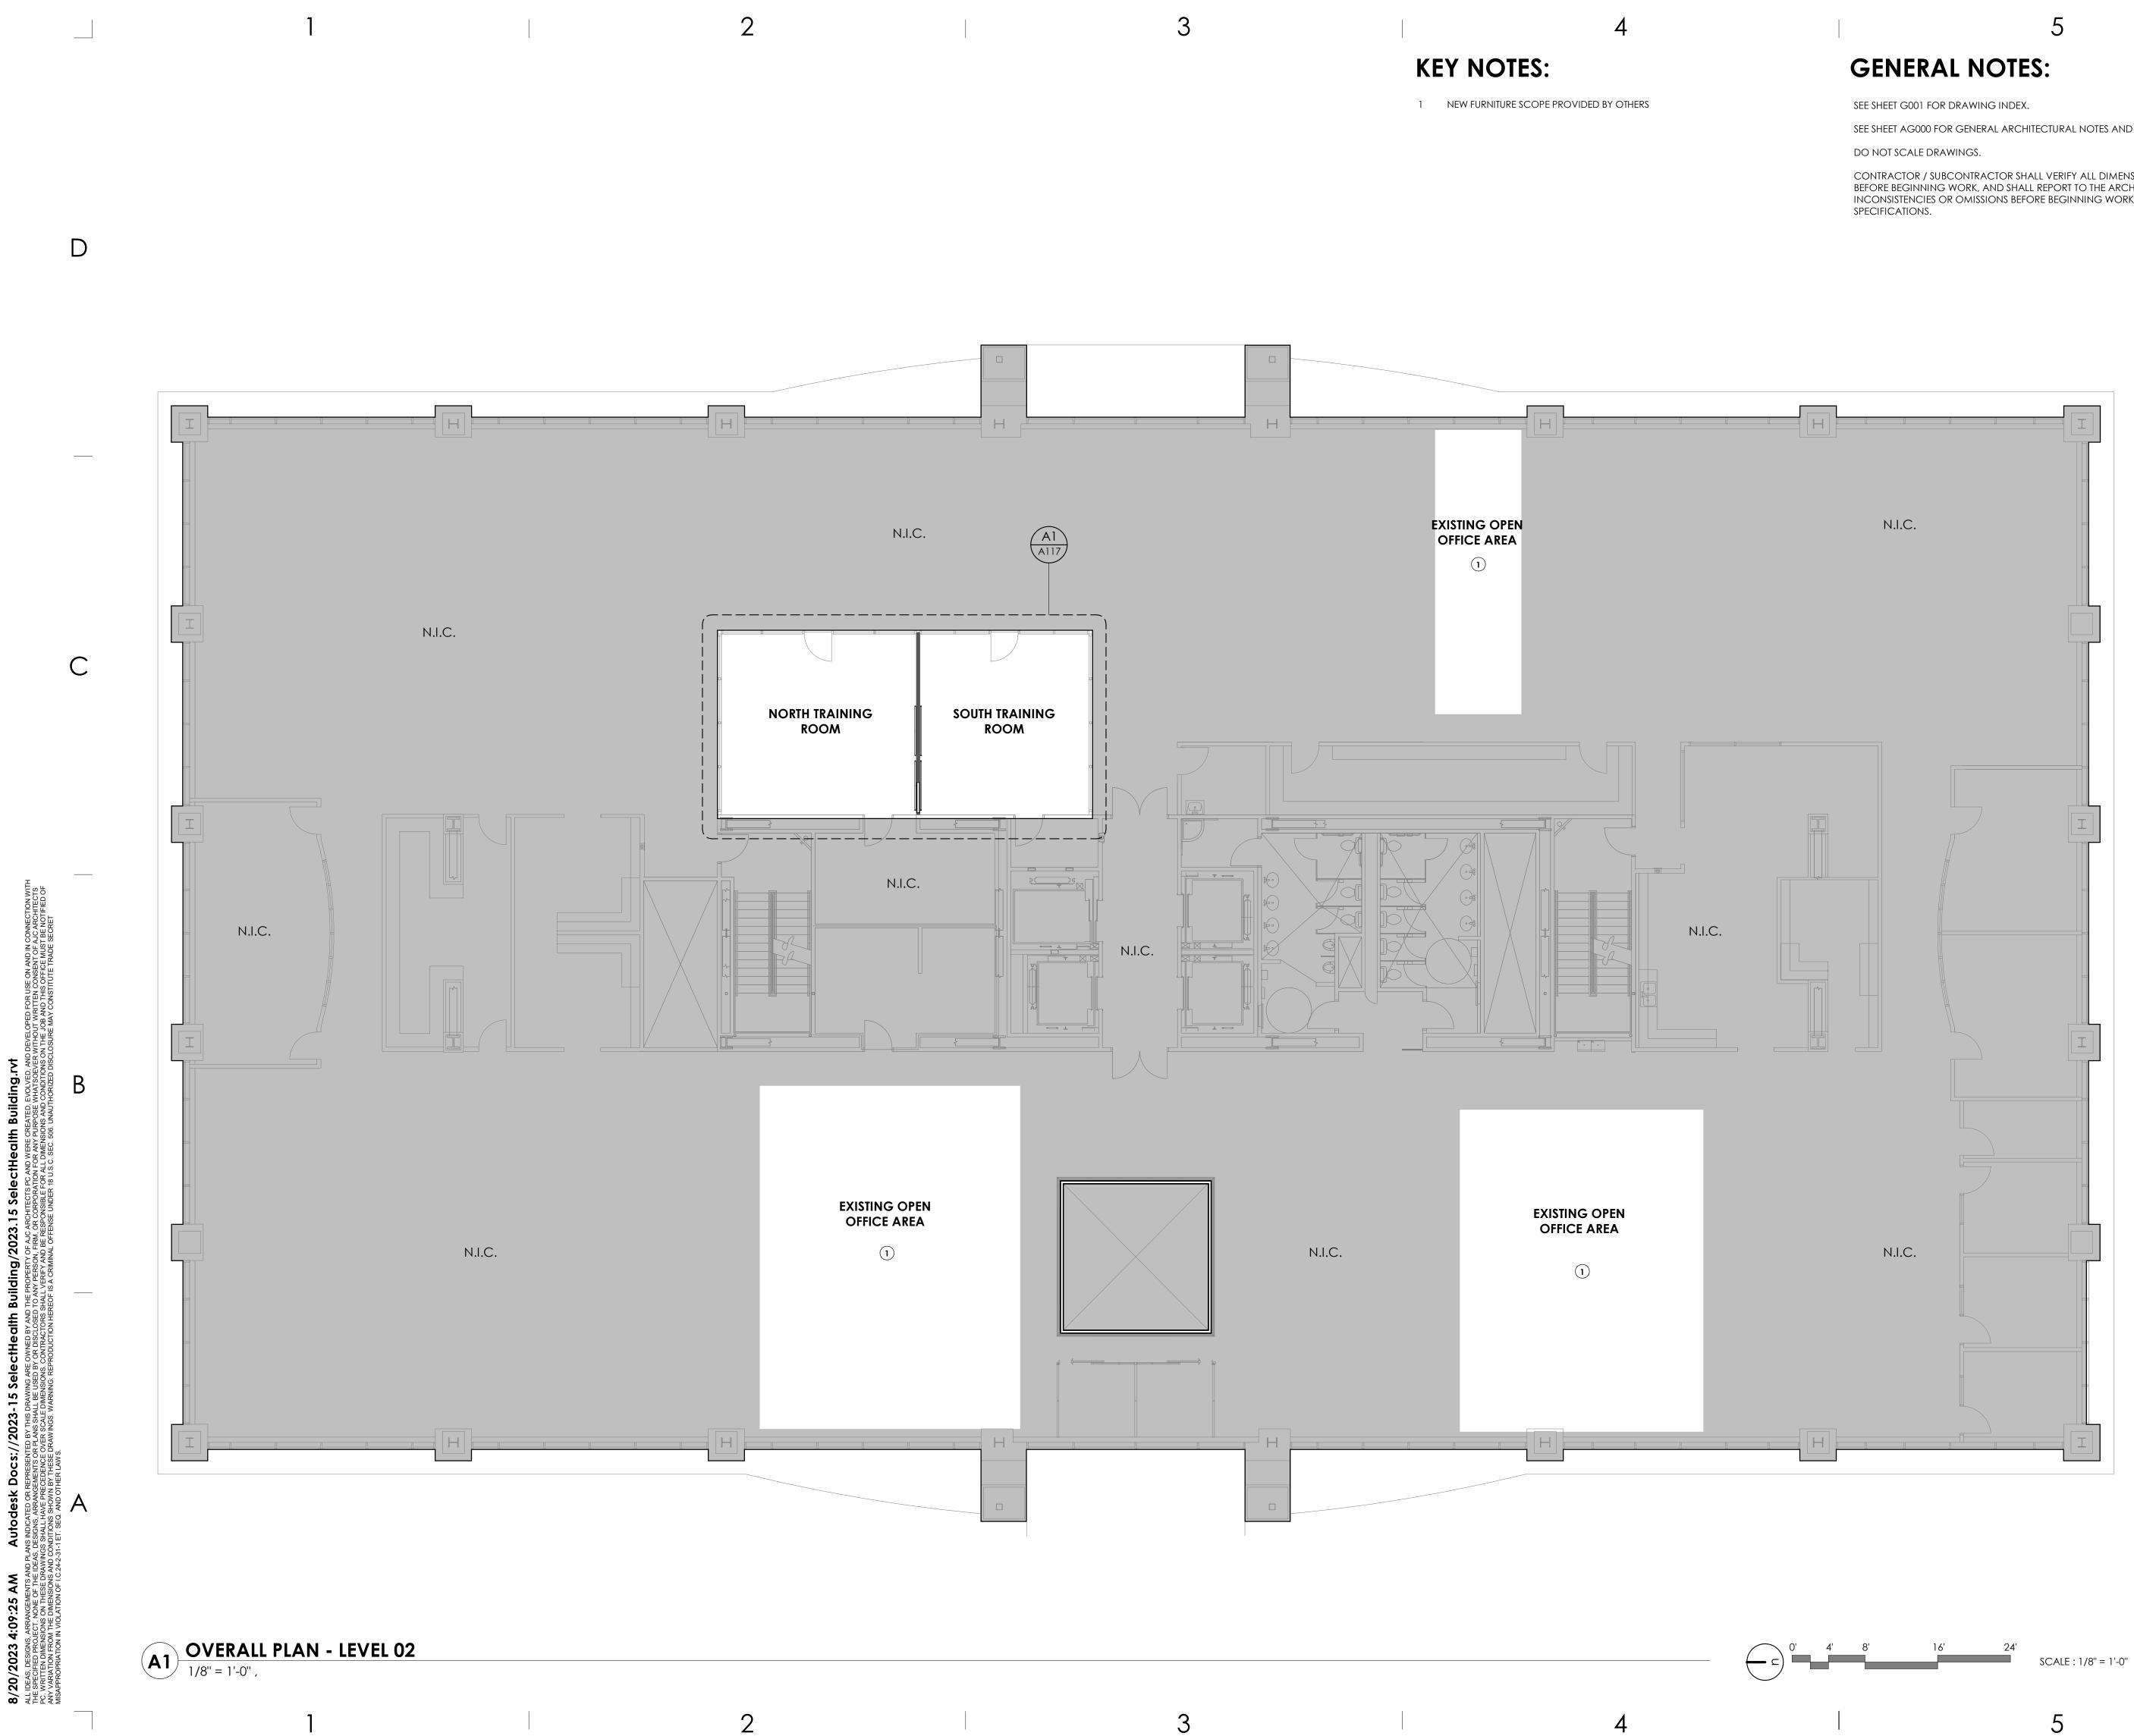
ISSUE DATE: ISSUE TYPE: DRAWN BY: CHECKED BY: R. OLSON PROJECT#: 2023-15

08/17/2023 **BID SET** J. HALBERT



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ARCHITECT / CONSULTANT PROJECT DESCRIPTION SELECTHEALTH BUILDING **TENANT IMPROVEMENT** 5381 S GREEN STREET MURRAY, UT 84123

Sheet name: LEVEL 02 - OVERALL ANNOTATED FLOOR

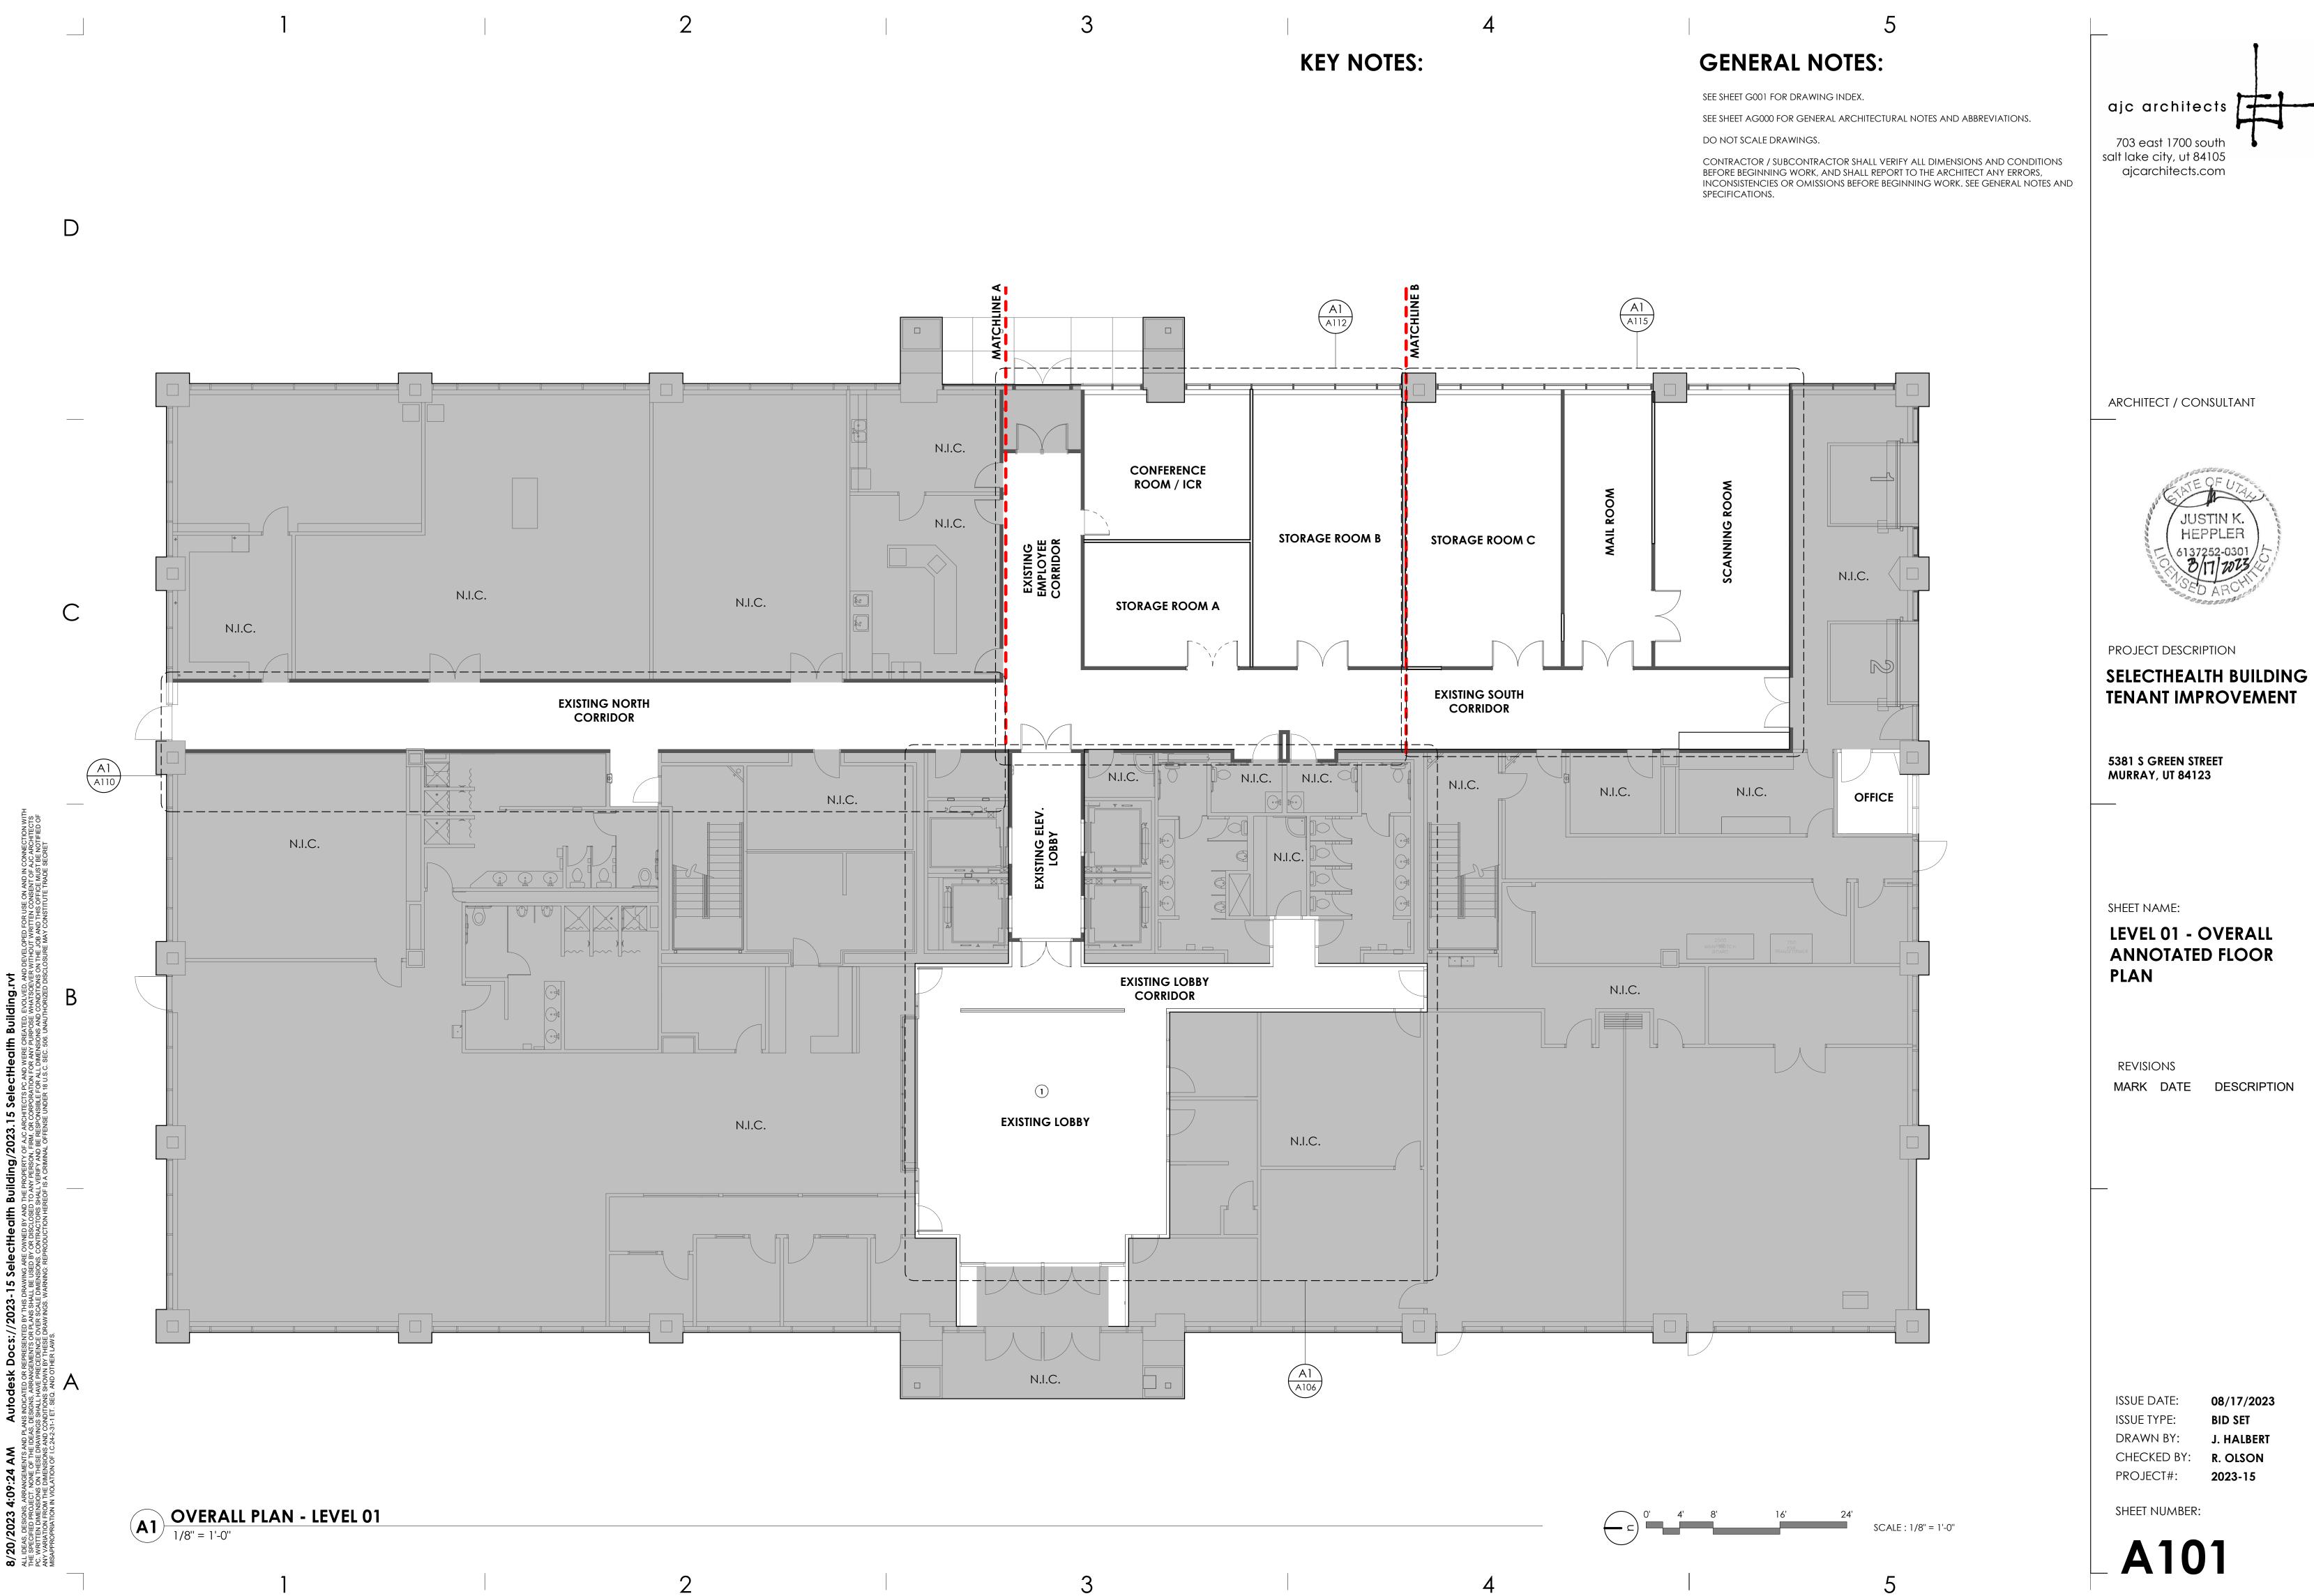JUSTIN K

HEPPLER

REVISIONS

PLAN


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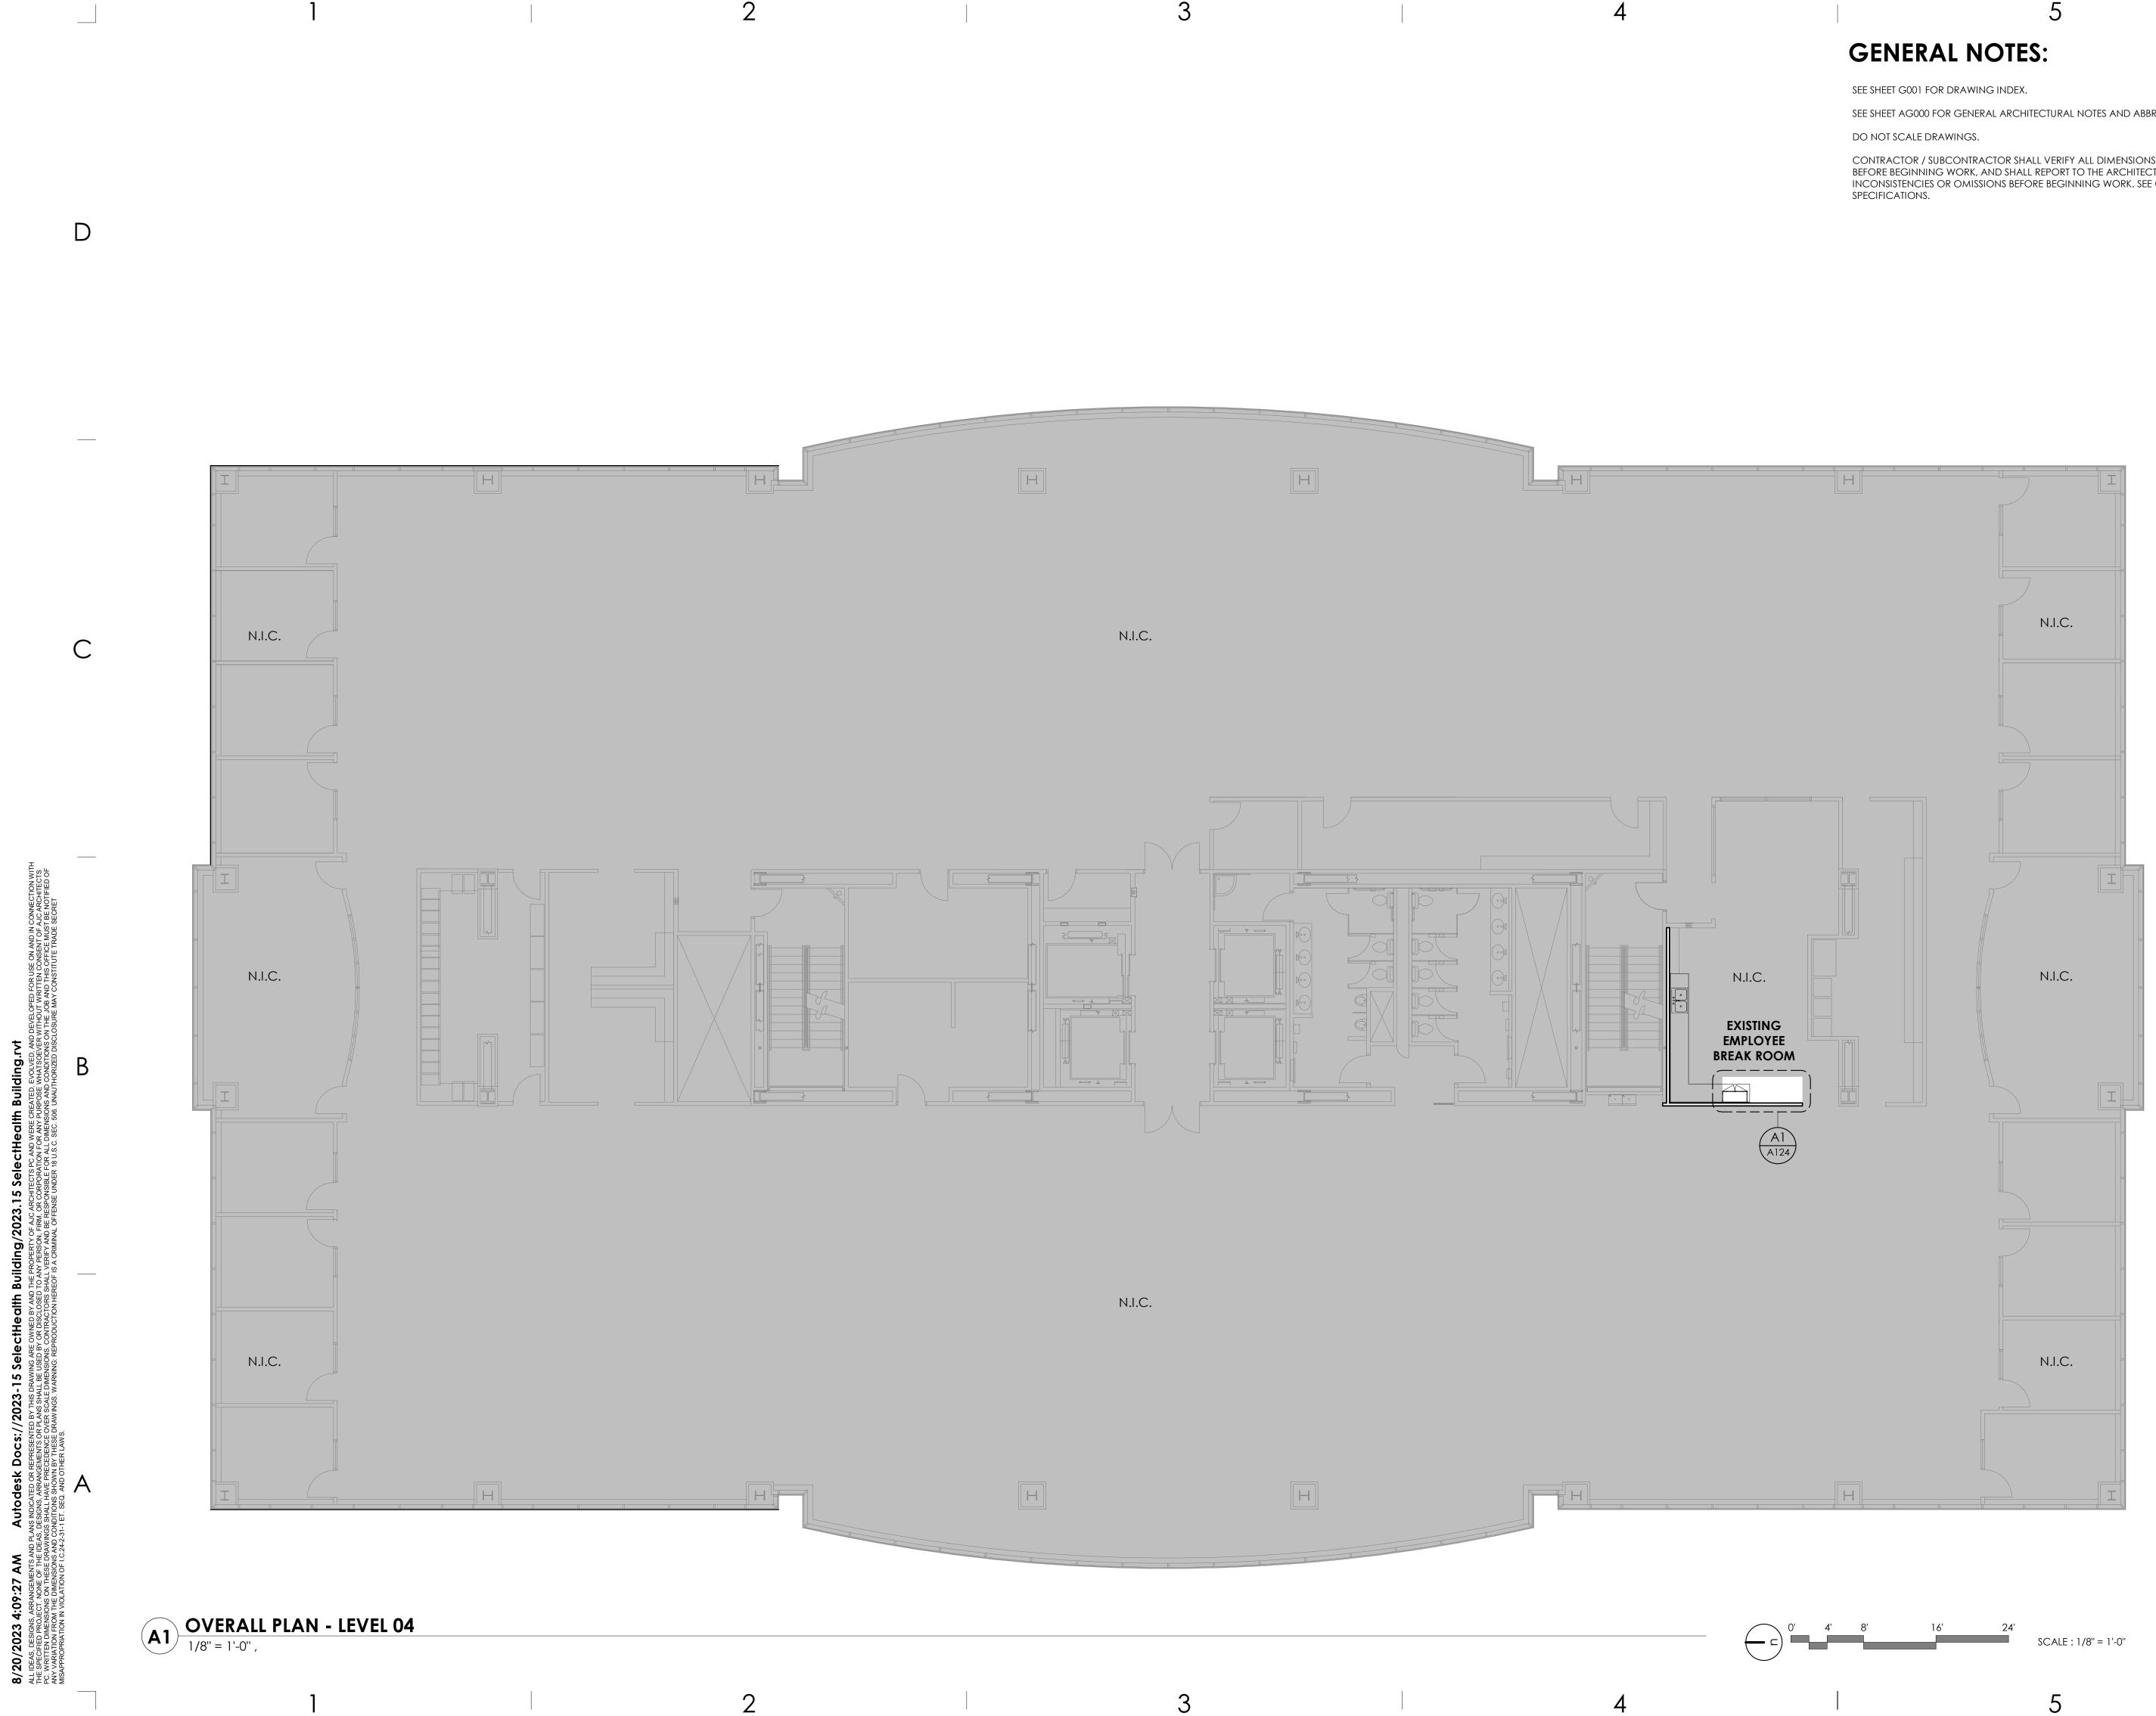
ISSUE DATE: 08/17/2023 ISSUE TYPE: **BID SET** DRAWN BY: J. HALBERT CHECKED BY: R. OLSON PROJECT#: 2023-15

SHEET NUMBER:

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JUSTIN K HEPPLER PROJECT DESCRIPTION

## SELECTHEALTH BUILDING **TENANT IMPROVEMENT**

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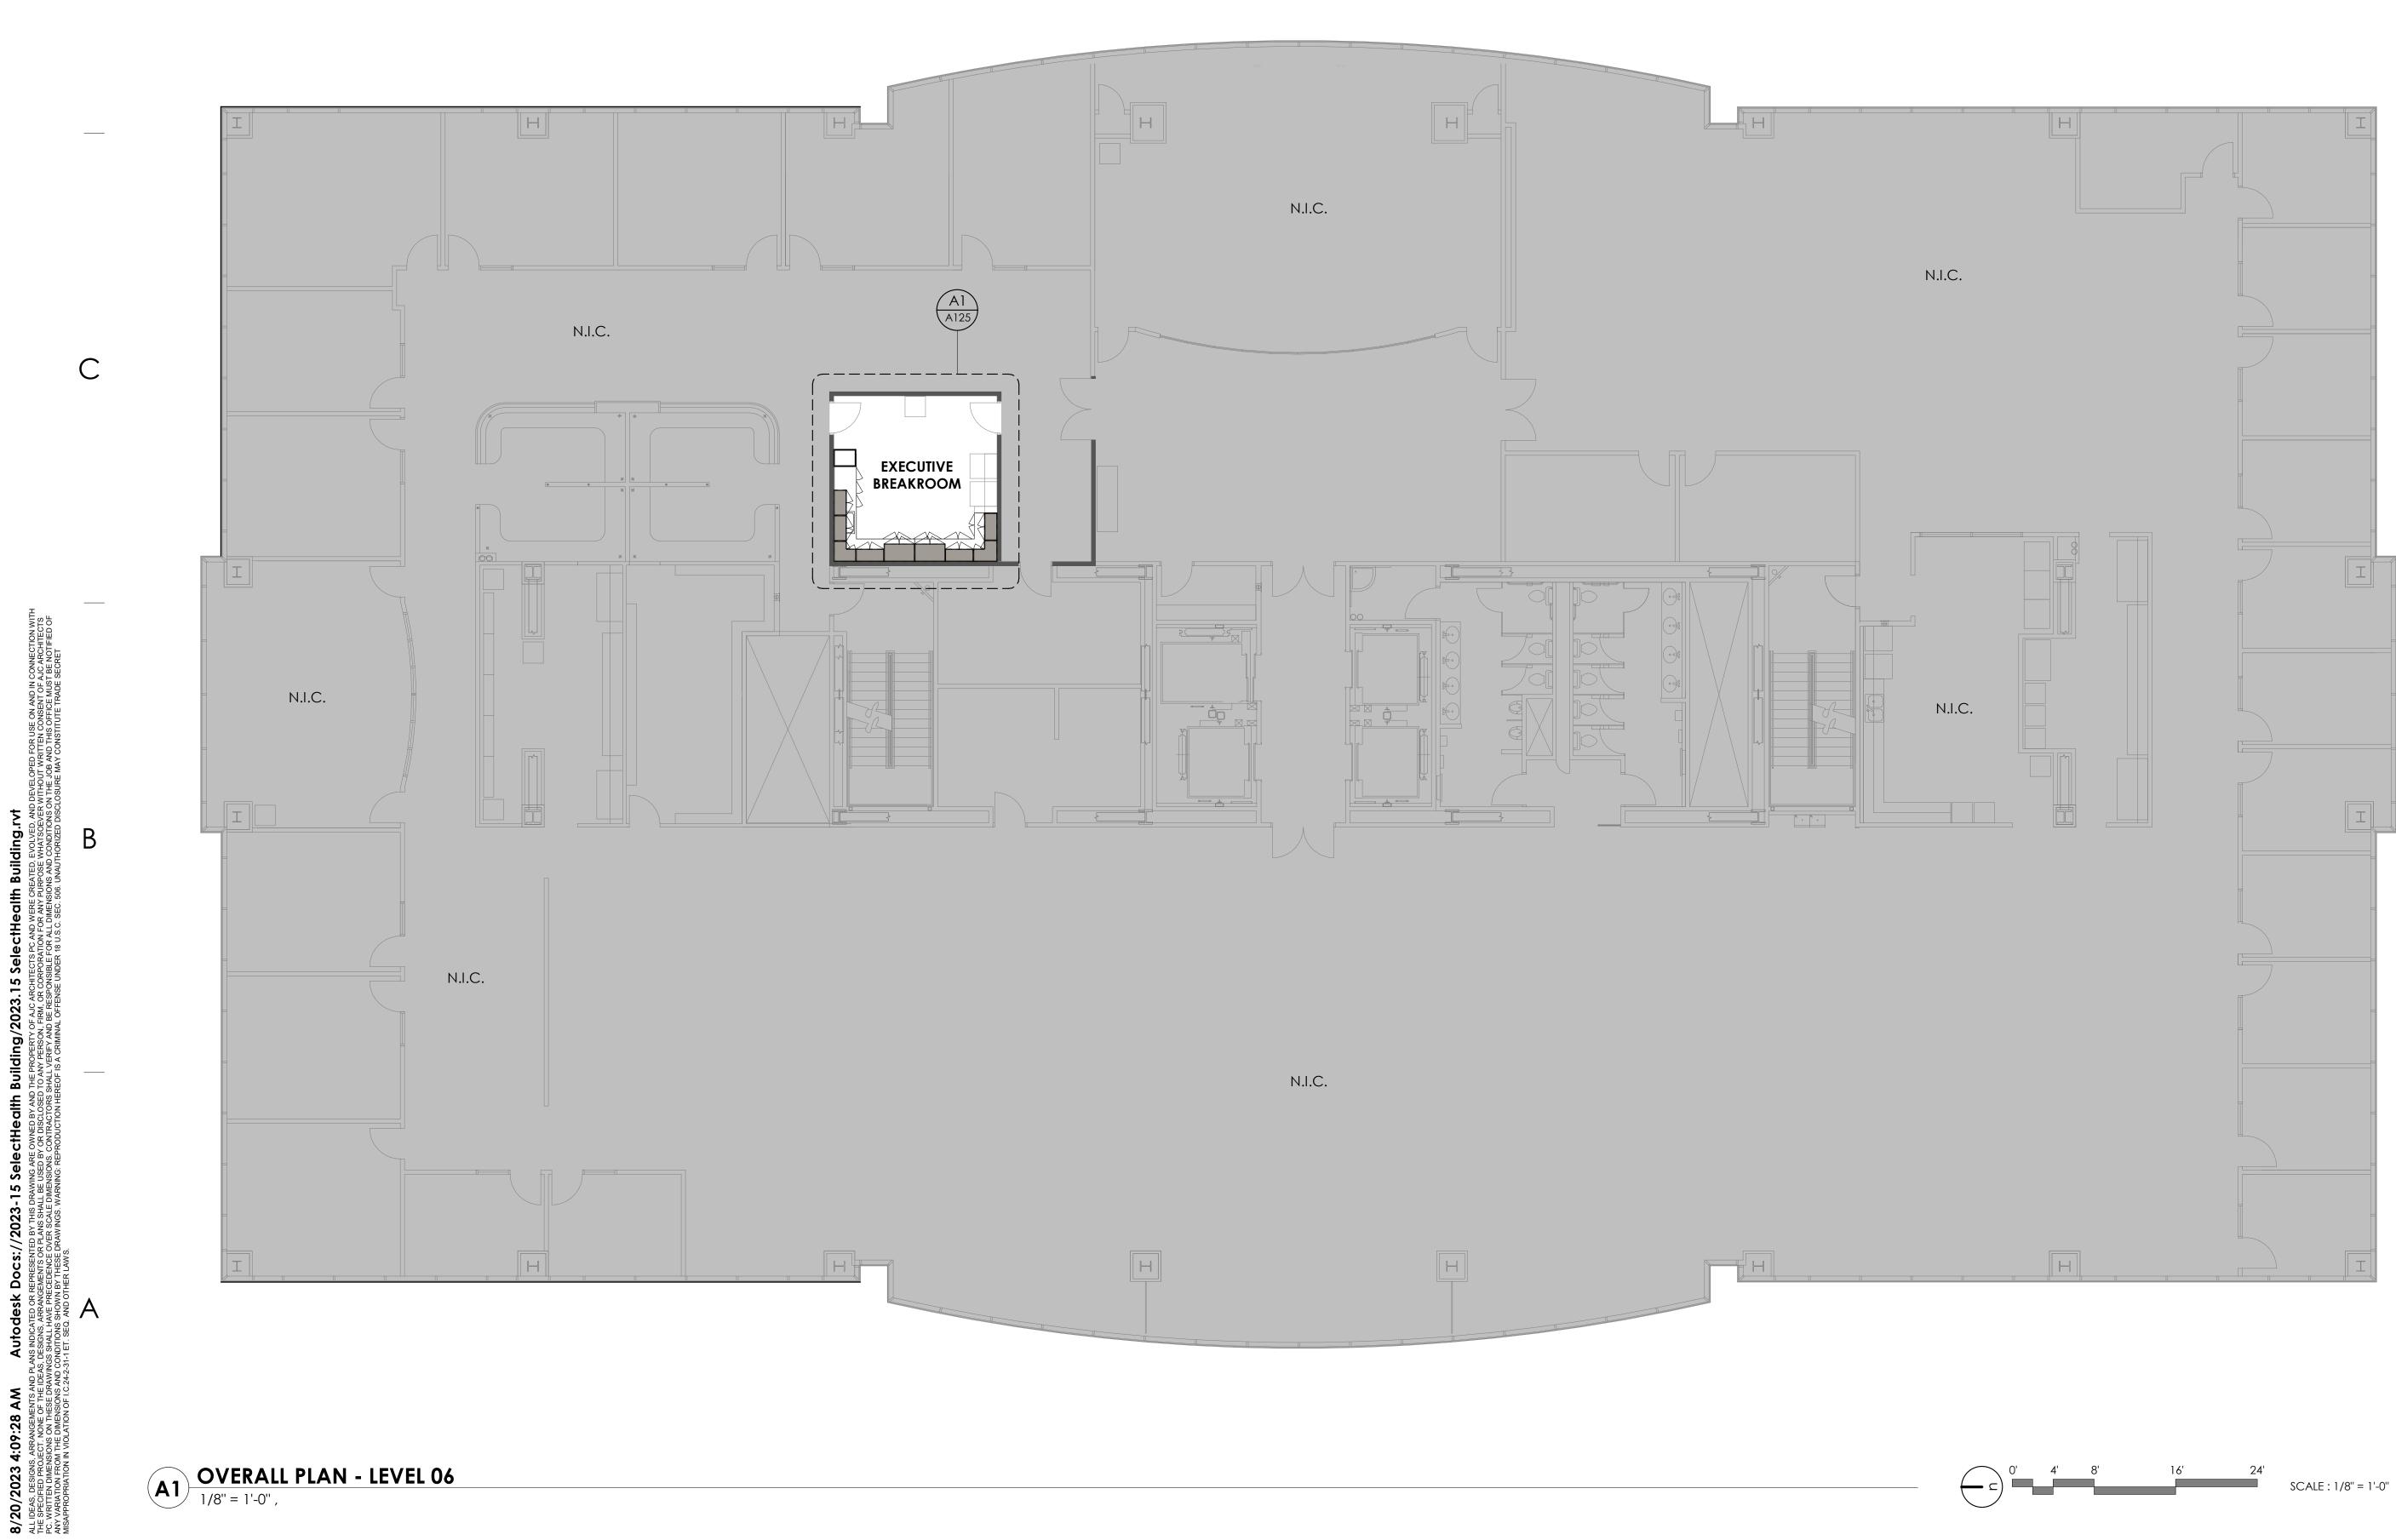
Sheet name:
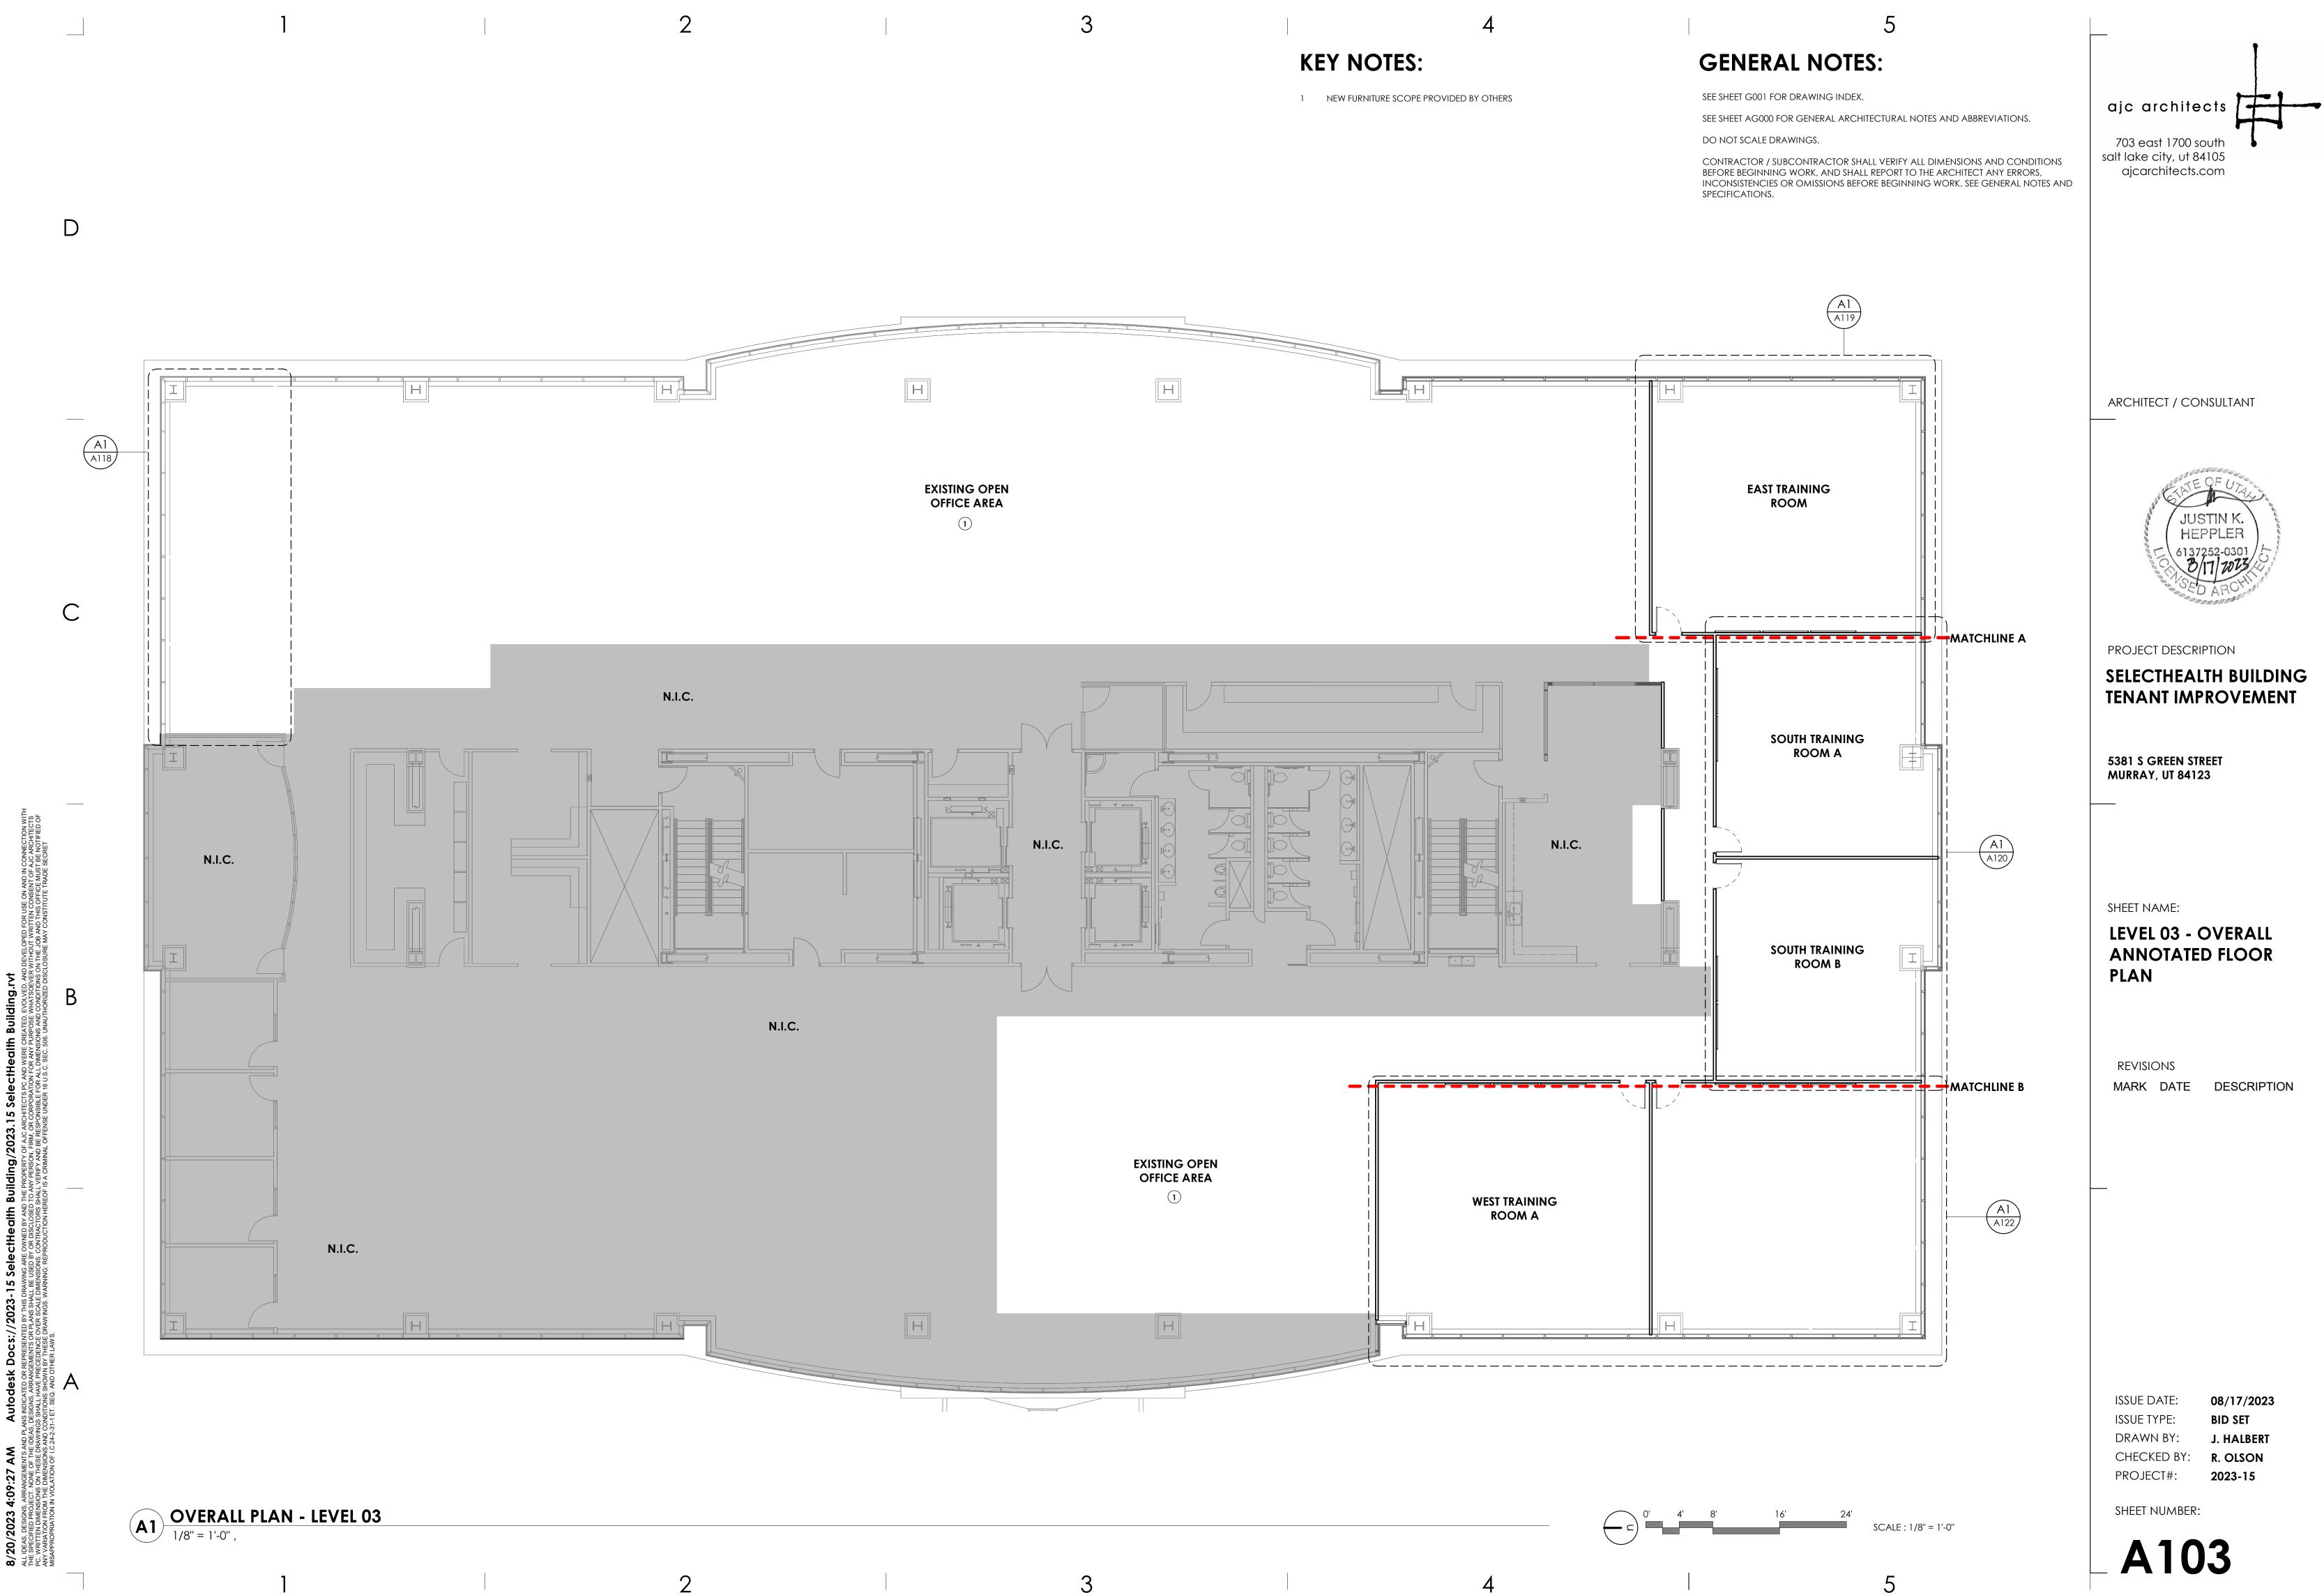
## LEVEL 04 - OVERALL ANNOTATED FLOOR PLAN

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ISSUE DATE: 08/17/2023 ISSUE TYPE: **BID SET** J. HALBERT DRAWN BY: CHECKED BY: R. OLSON PROJECT#: 2023-15





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do not scale drawings.

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PROJECT DESCRIPTION

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#### SELECTHEALTH BUILDING TENANT IMPROVEMENT

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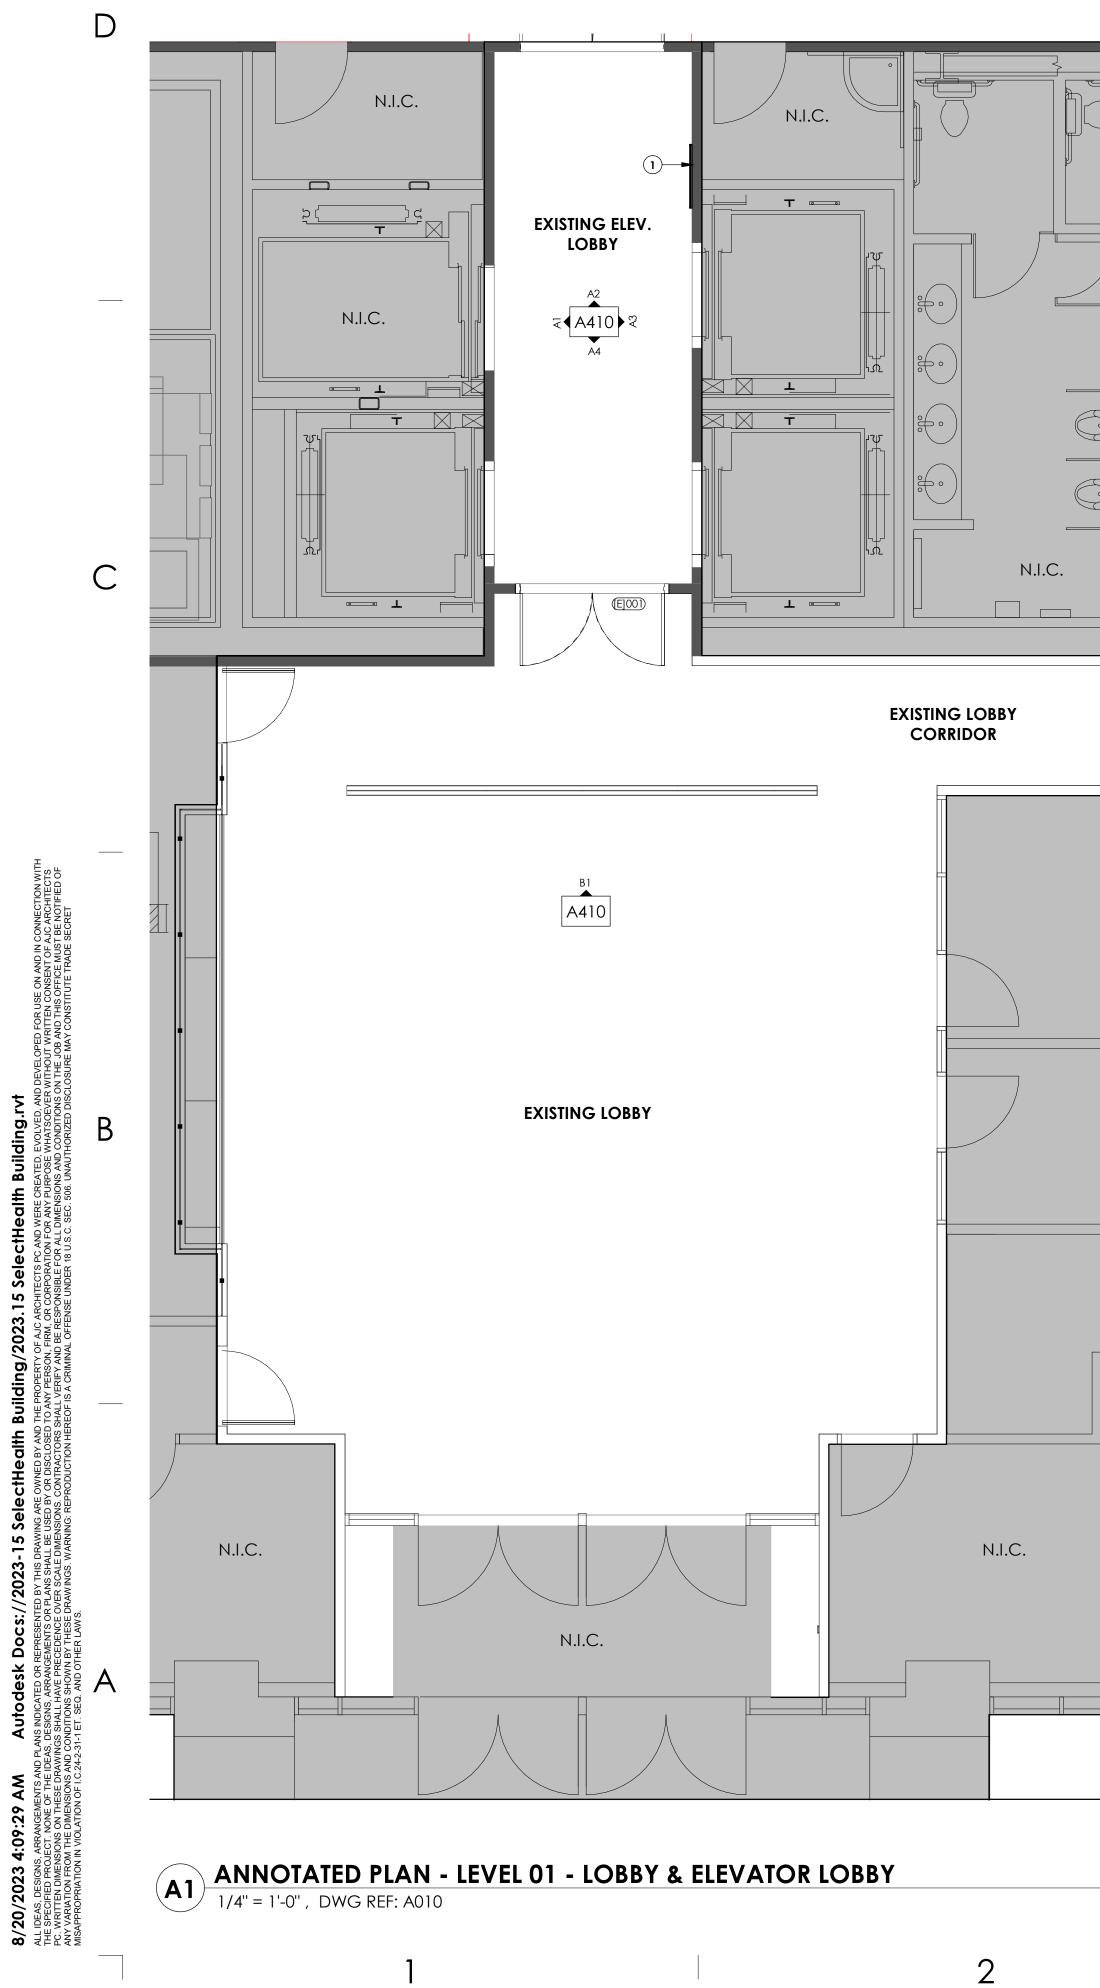
Sheet name:

## LEVEL 06 - OVERALL ANNOTATED FLOOR PLAN

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ISSUE DATE: 08/17/2023 ISSUE TYPE: **BID SET** J. HALBERT DRAWN BY: CHECKED BY: R. OLSON PROJECT#: 2023-15





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# **GENERAL NOTES:**

SEE SHEET GOO1 FOR DRAWING INDEX.

SEE SHEET AG000 FOR GENERAL ARCHITECTURAL NOTES AND ABBREVIATIONS.

do not scale drawings.

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## **KEY NOTES:**

1 TV O.F.C.I. PROVIDE BLOCKING IN WALL. SEE ELECTRICAL DRAWINGS

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PROJECT DESCRIPTION

## SELECTHEALTH BUILDING **TENANT IMPROVEMENT**

5381 S GREEN STREET MURRAY, UT 84123

Sheet name:

## LEVEL 01 - ANNOTATED FLOOR PLAN - LOBBY AND ELEVATOR LOBBY


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# **GENERAL NOTES:**

SEE SHEET G001 FOR DRAWING INDEX.

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do not scale drawings.

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CONTRACTOR / SUBCONTRACTOR SHALL VERIFY ALL DIMENSIONS AND CONDITIONS BEFORE BEGINNING WORK, AND SHALL REPORT TO THE ARCHITECT ANY ERRORS, INCONSISTENCIES OR OMISSIONS BEFORE BEGINNING WORK. SEE GENERAL NOTES AND SPECIFICATIONS.

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PROJECT DESCRIPTION
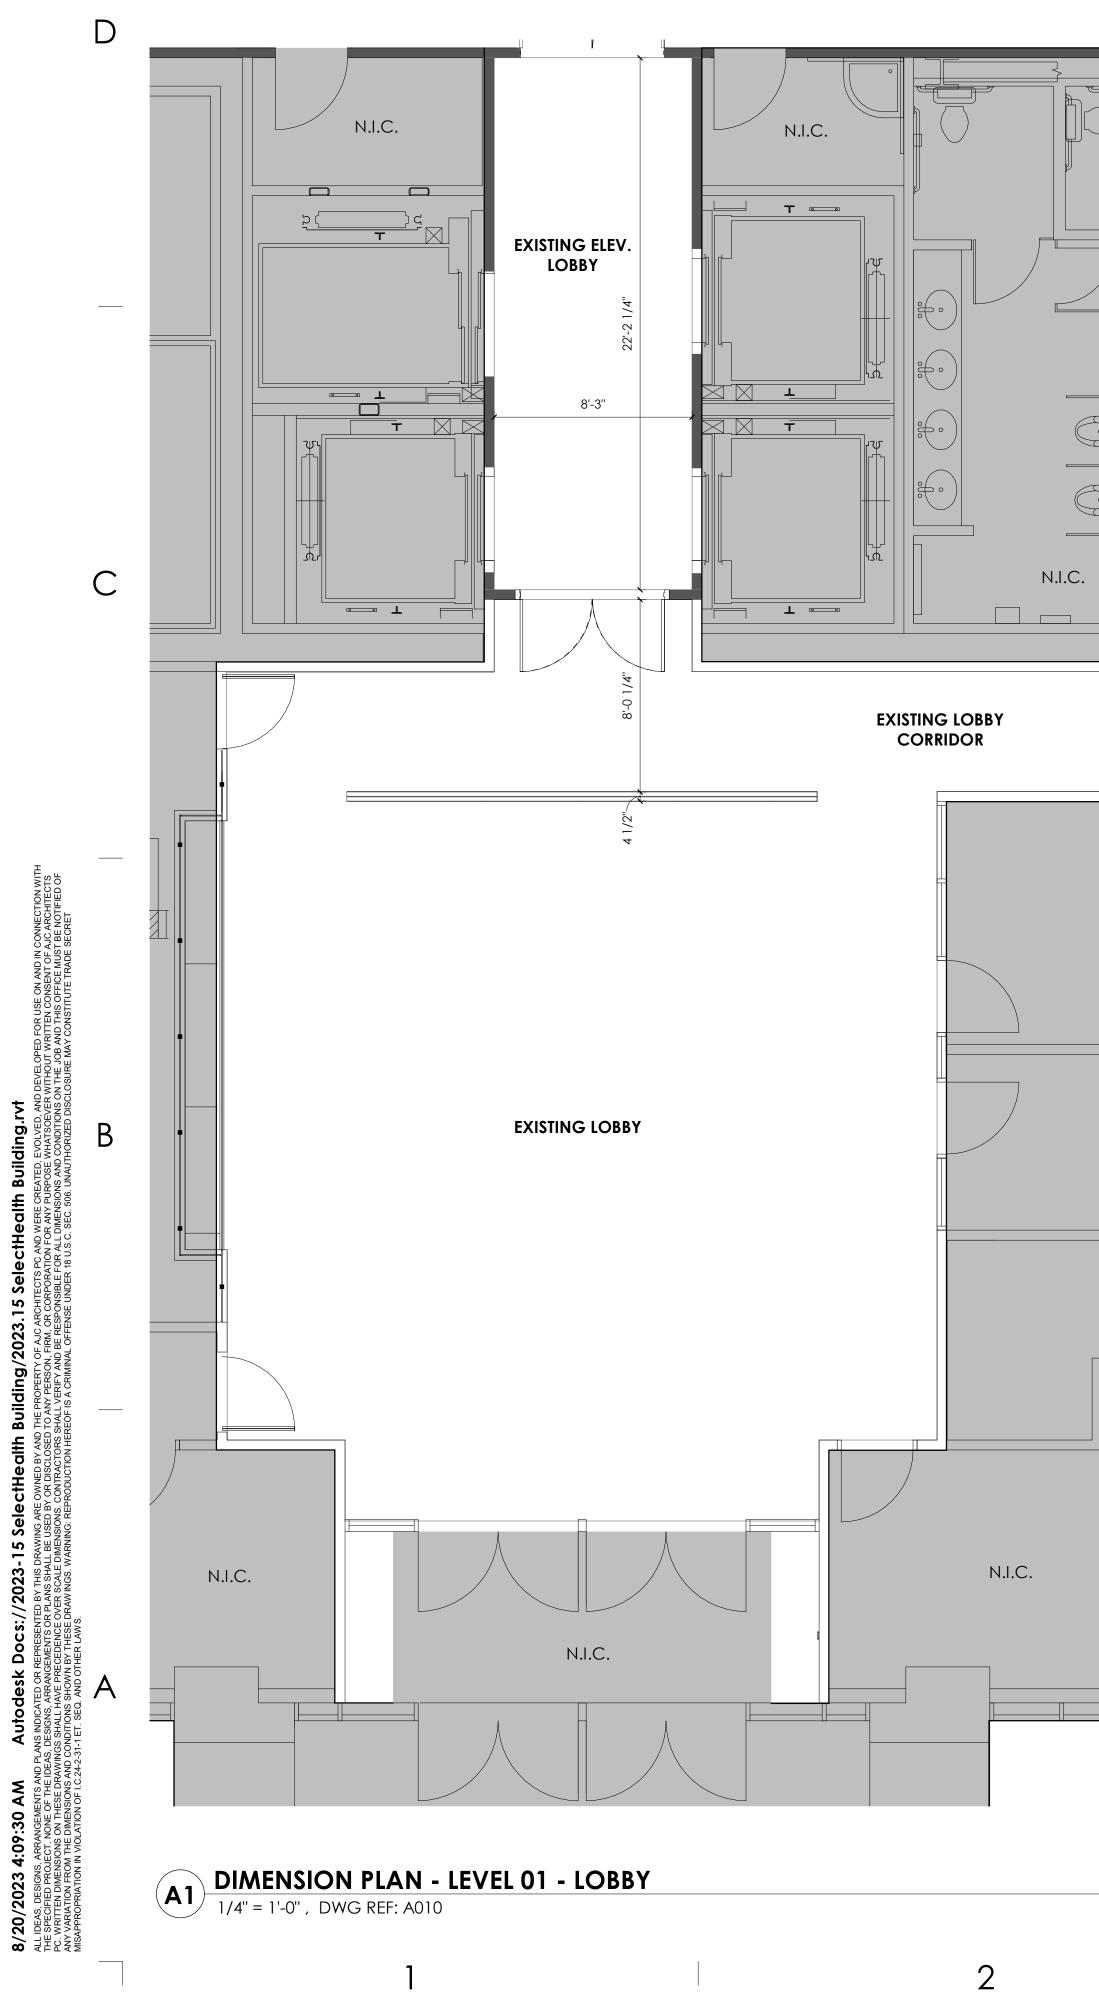
#### SELECTHEALTH BUILDING **TENANT IMPROVEMENT**

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Sheet name:

## **LEVEL 01 - DIMENSION** FLOOR PLAN - LOBBY AND ELEVATOR LOBBY

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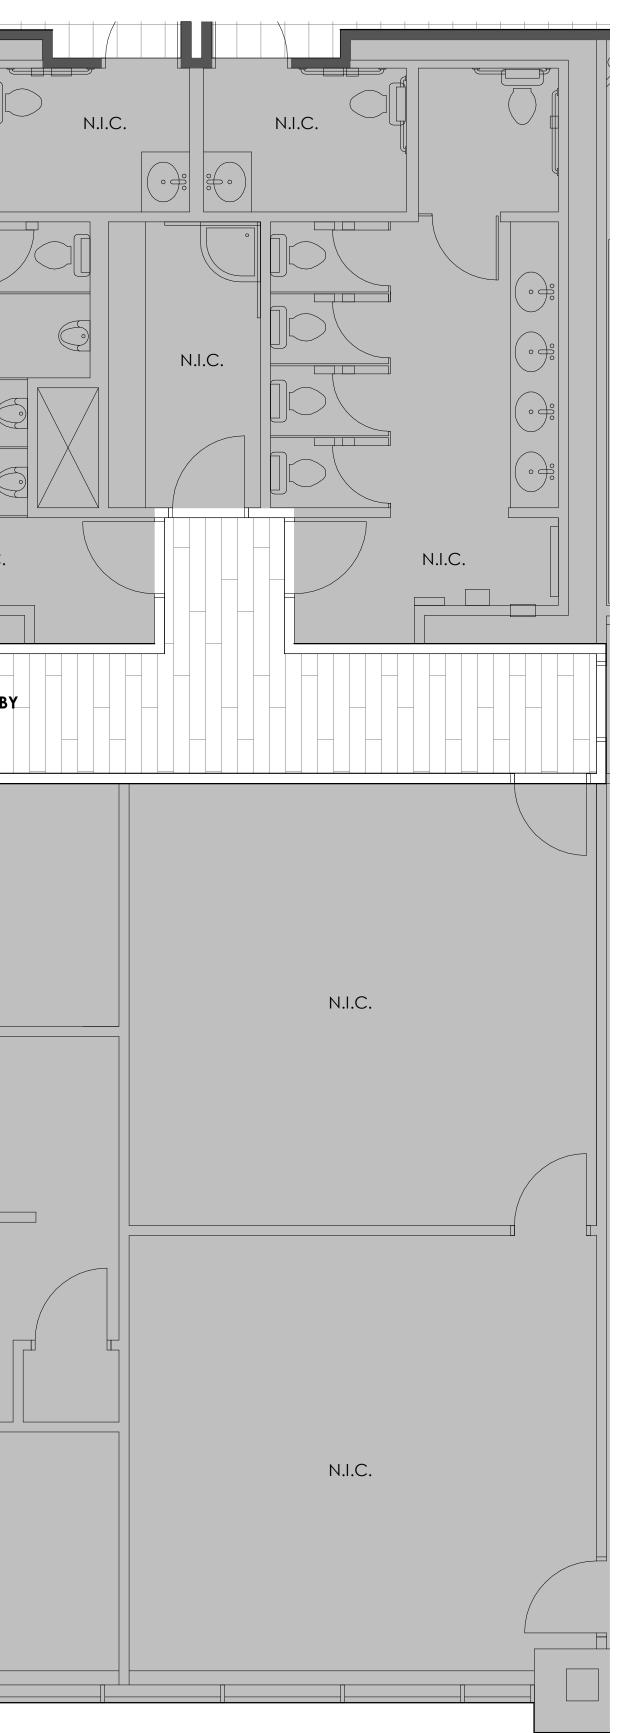
SHEET NUMBER:



SCALE : 1/4" = 1'-0"

3' 12'

D N.I.C. N.I.C. Τ 🚥  $\frac{1}{2}$ EXISTING ELEV. LOBBY \_\_\_\_\_ F4 W1 W2 B2 T T С N.I.C. < D1 X D2 > ⊥ ===== **EXISTING LOBBY** CORRIDOR \_\_\_\_\_ \_\_\_\_\_\_F2 > N AND IN CONNEC SENT OF AJC ARC ICE MUST BE NO E TRADE SECRET EXISTING LOBBY В \_\_\_\_\_ N.I.C.  $\left( F4 \right)$ N.I.C. (P1 ) N.I.C. B2 A1 FINISH PLAN - LEVEL 01 - LOBBY AND ELEVATOR LOBBY 1/4" = 1'-0", DWG REF: A010 8/20/ All Ideas The Spect The Spect Net Ideas Any Varia




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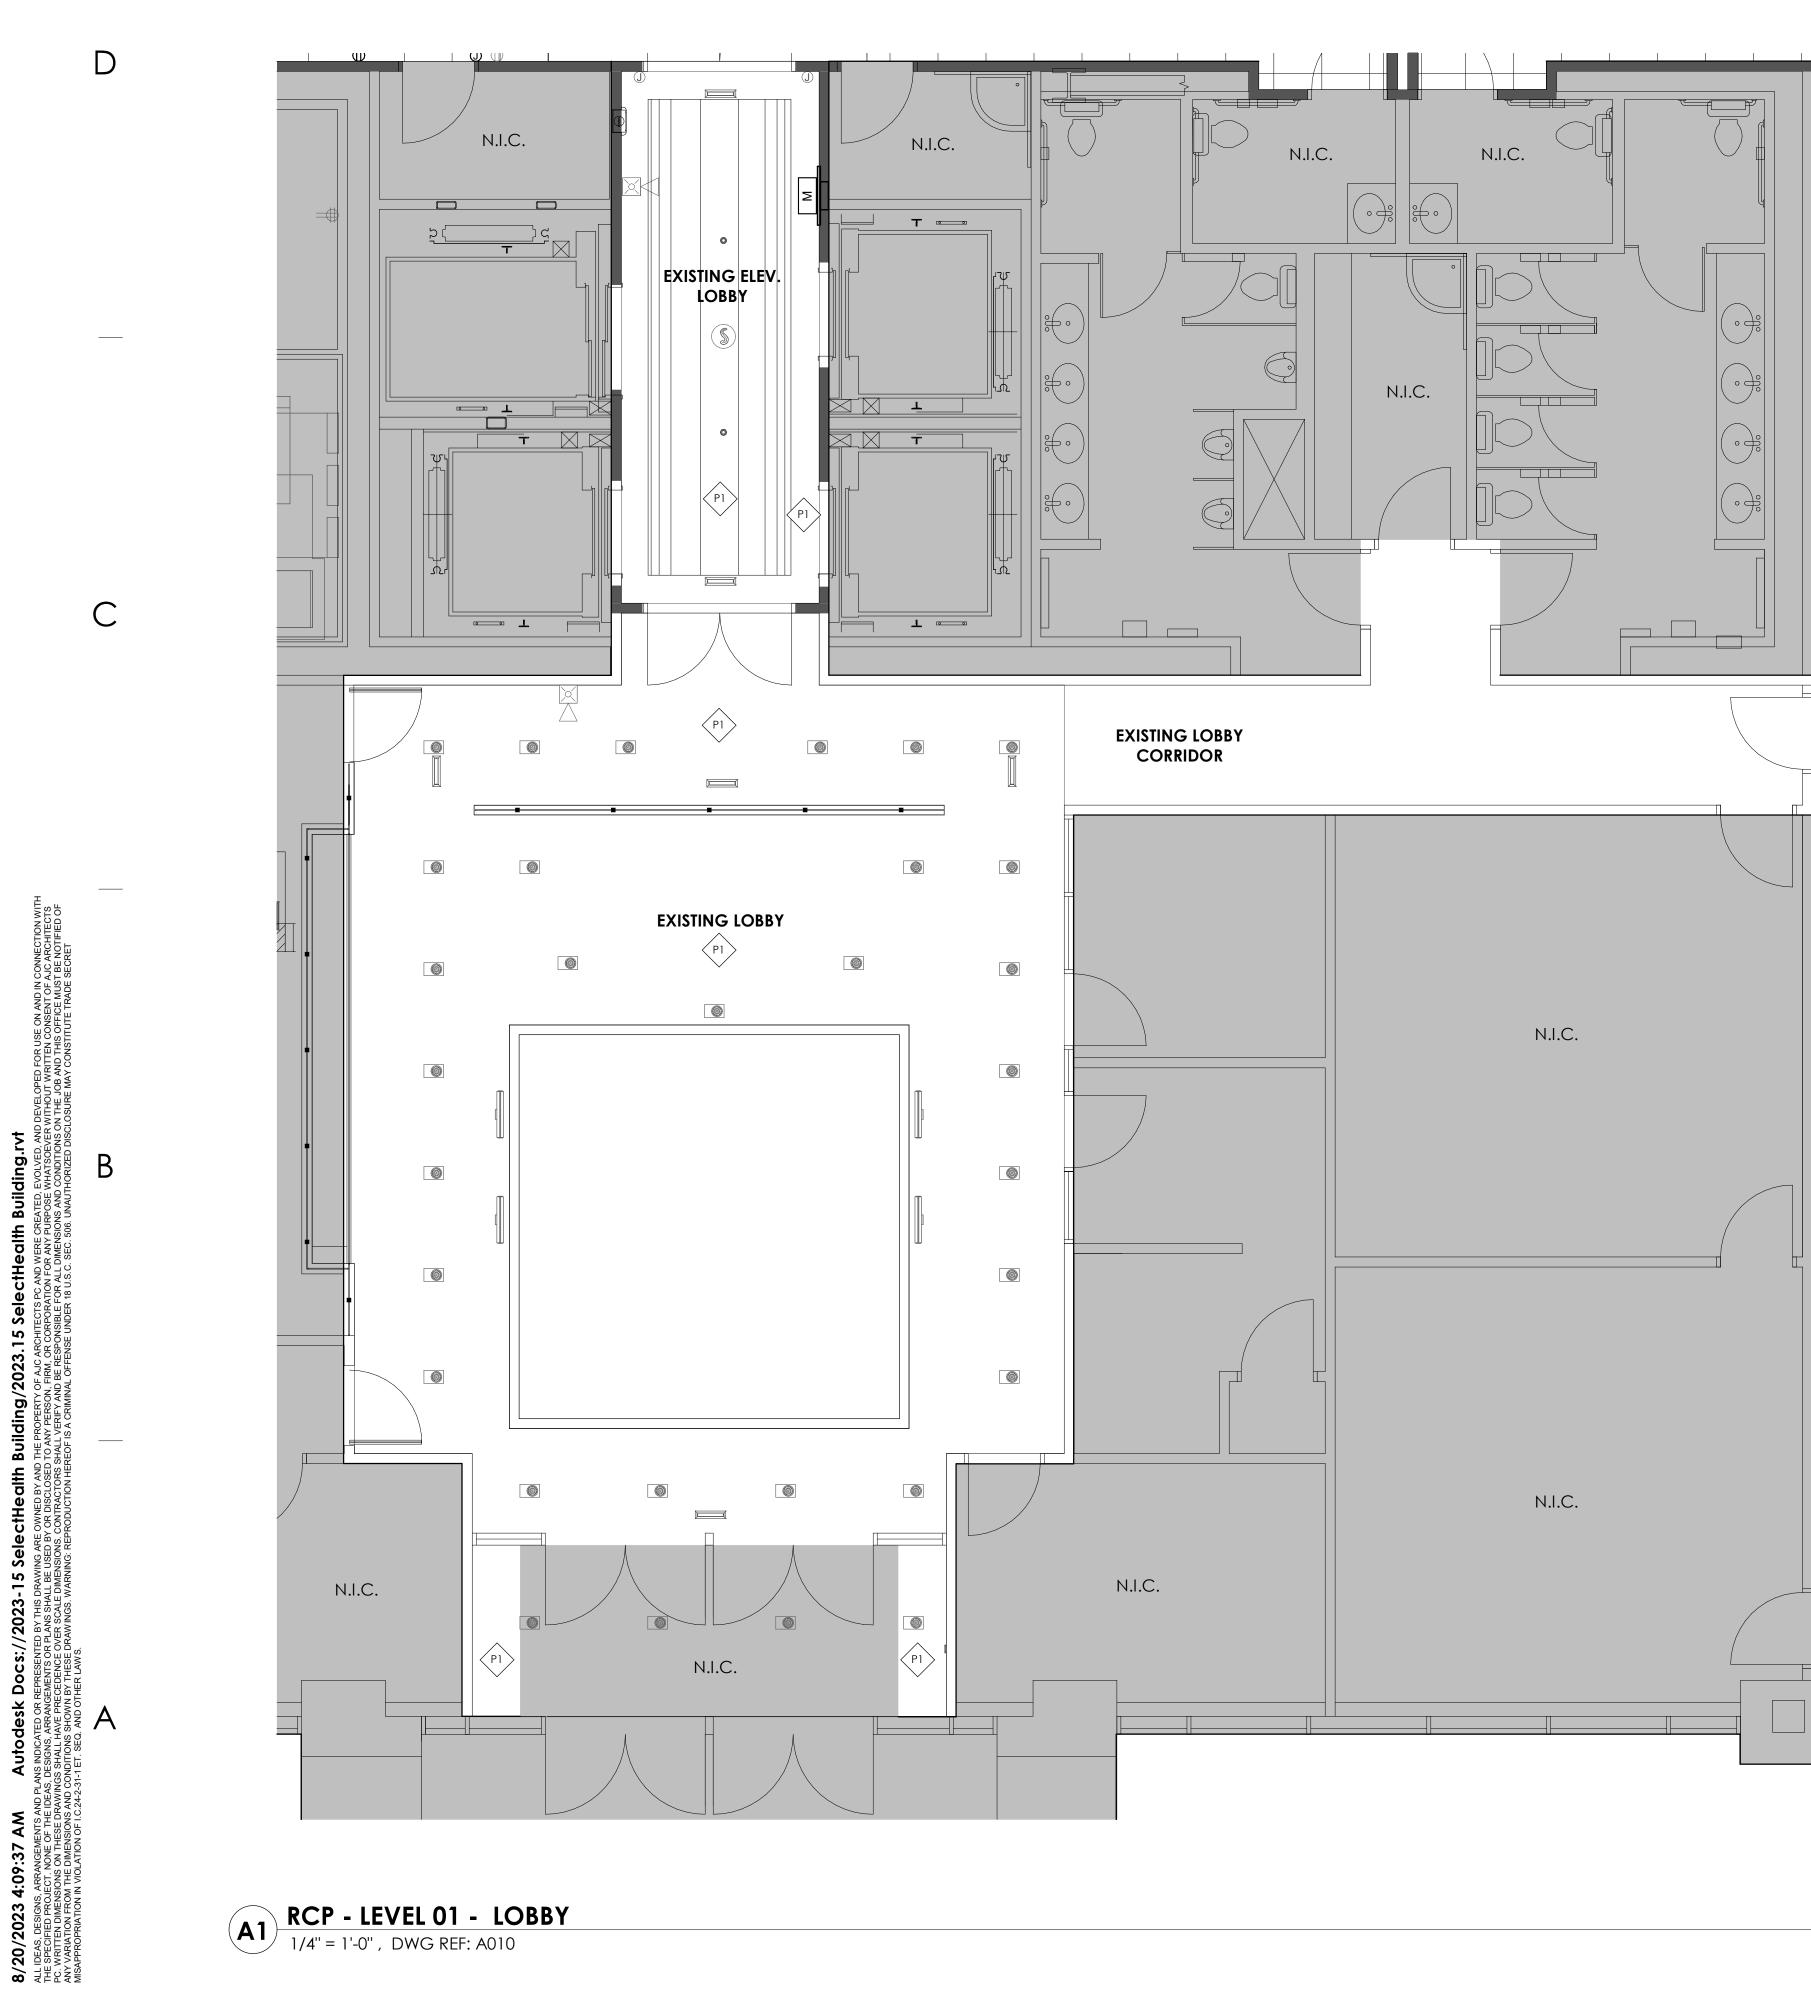
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C) 0' 2' 4' 12' SCALE : 1/4" = 1'-0"

GENERAL NOTES: SEE SHEET G001 FOR DRAWING INDEX.	
SEE SHEET GUUT FOR DRAWING INDEX. SEE SHEET AG000 FOR GENERAL ARCHITECTURAL NOTES AND ABBREVIAT	ajc architects
DO NOT SCALE DRAWINGS.	703 east 1700 south
CONTRACTOR / SUBCONTRACTOR SHALL VERIFY ALL DIMENSIONS AND BEFORE BEGINNING WORK, AND SHALL REPORT TO THE ARCHITECT ANY	
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REFLECTED CEILING PLAN	
THIS IS A REFLECTED CEILING PLAN AND IS NOT TO BE INTENDED TO BE A PLAN. NO WALL MOUNTED LIGHTING FIXTURES OR OTHER WALL MOUNTE	
APPURTENANCES ARE SHOWN. SEE THE LIGHTING PLAN FOR ALL LIGHTING SIGNS, SIZE AND TYPES OF ELECTRICAL FIXTURES ETC. SEE MECHANICAL P CEILING MOUNTED DIFFUSERS/GRILLES ETC.	g and egress
SYMBOL LEGEND SURFACE MOUNTED OR LAY-IN CEILING	
FLUORESCENT FIXTURE. SEE ELECTRICAL PLAN FOR SIZE AND TYPE.	
LINEAR SUSPENDED LIGHTING FIXTURE. SEE ELECTRICAL PLAN FOR SIZE AND	
TYPE. OCCUPANCY SENSOR. SEE ELECTRICAL	
PLAN.	*
LIFE SAFETY DEVICES. SEE ELECTRICAL	S SMOKE
LIFE SAFETY DEVICES. SEE ELECTRICAL	DETECTOR JUSTIN K.
PLAN.	FIRE HORN HEPPLER 6137252-0301
AUDIO/VISUAL EQUIPMENT.	<u> </u>
& OWNER. CAMERA	T = 7
DIFFUSERS/GRILLES. SEE MECHANICAL.	Y RETURN/
	PROJECT DESCRIPTION
	SELECTHEALTH BUILD
	TENANT IMPROVEME
	5381 S GREEN STREET MURRAY, UT 84123
	MORRAT, 01 04123
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	LEVEL 01 - RCP - LOP
	AND ELEVATOR LOB
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	ISSUE DATE: 08/17/2023 ISSUE TYPE: BID SET DRAWN BY: J. HALBERT CHECKED BY: R. OLSON

# **FINISH NOTES**

DO NOT SCALE DRAWINGS.

CONTRACTOR / SUBCONTRACTOR SHALL VERIFY ALL DIMENSIONS AND CONDITIONS BEFORE BEGINNING WORK, AND SHALL REPORT TO THE ARCHITECT ANY ERRORS, INCONSISTENCIES OR OMISSIONS BEFORE BEGINNING WORK. SEE GENERAL NOTES AND specifications.

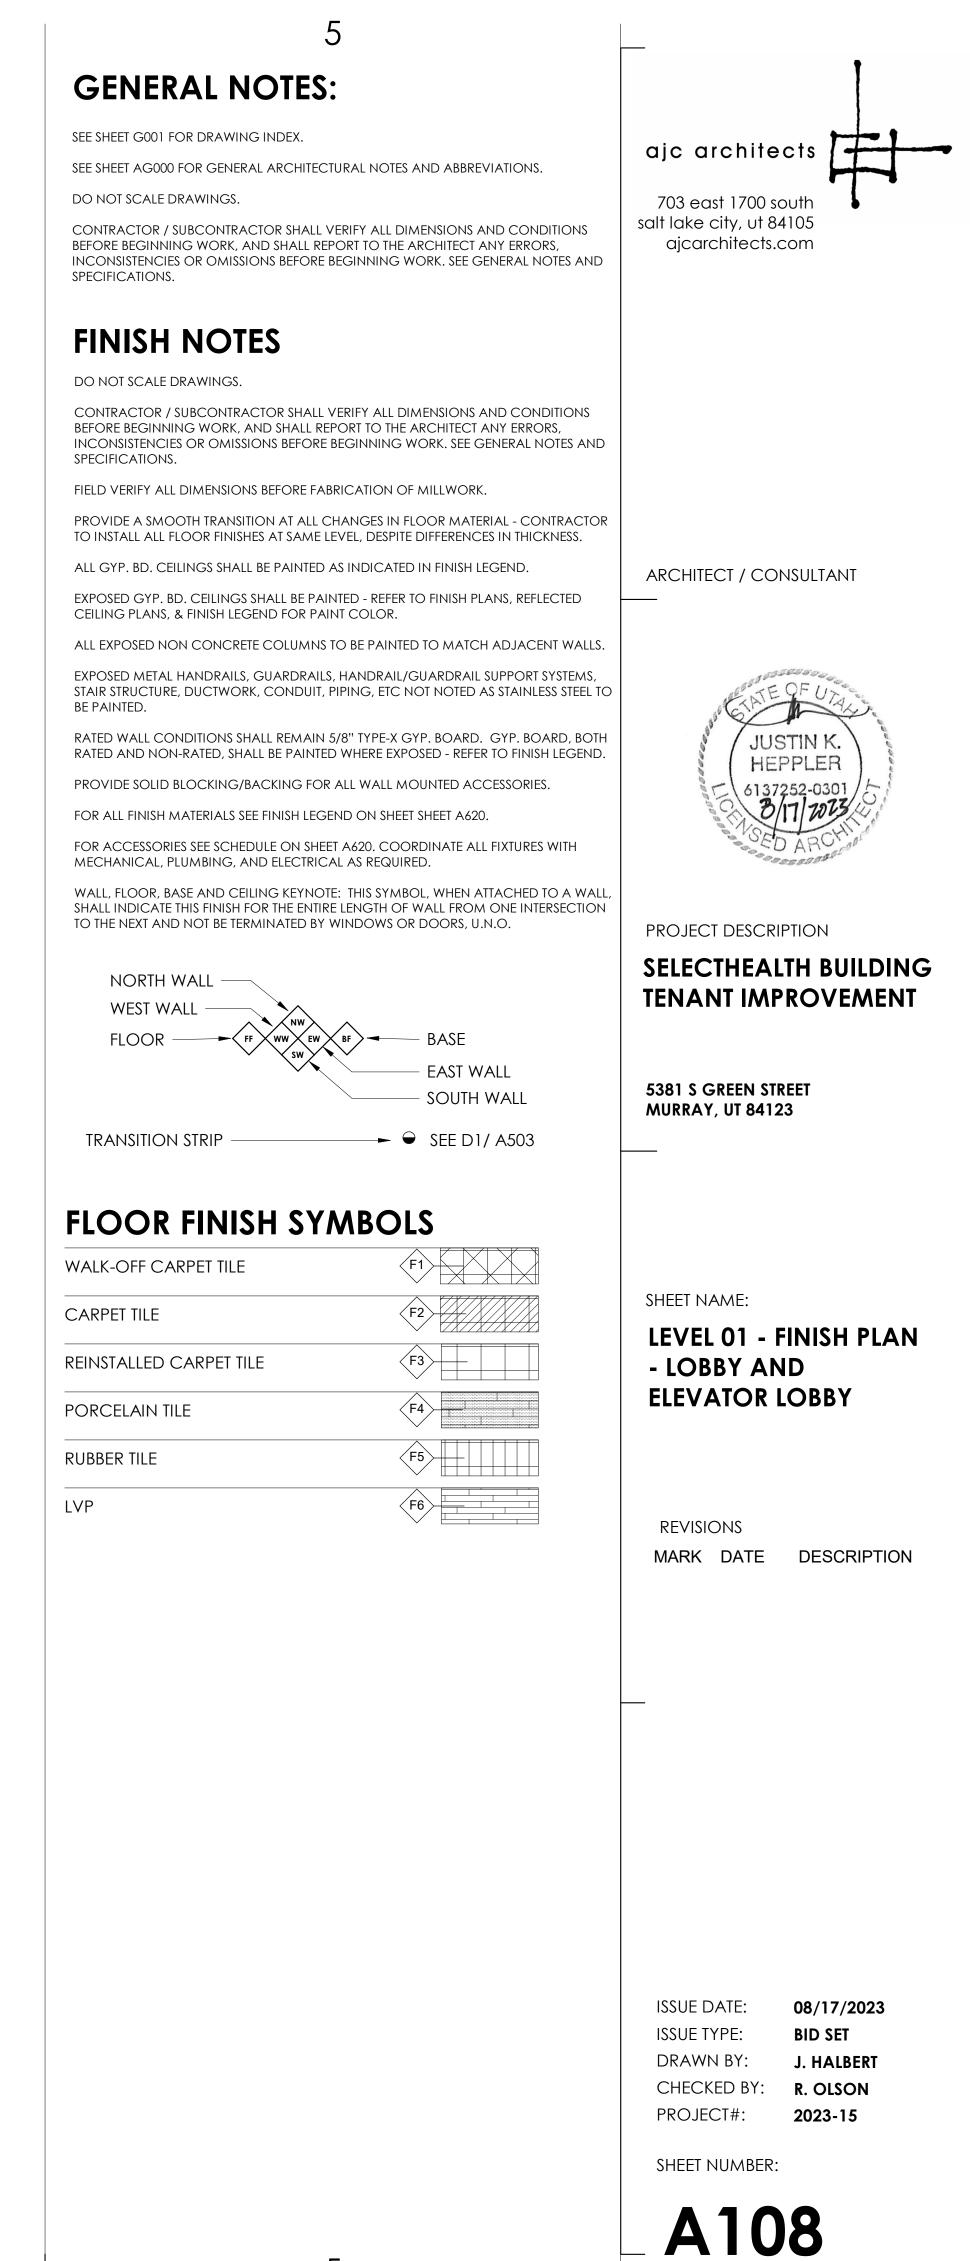FIELD VERIFY ALL DIMENSIONS BEFORE FABRICATION OF MILLWORK. PROVIDE A SMOOTH TRANSITION AT ALL CHANGES IN FLOOR MATERIAL - CONTRACTOR TO INSTALL ALL FLOOR FINISHES AT SAME LEVEL, DESPITE DIFFERENCES IN THICKNESS.


ALL GYP. BD. CEILINGS SHALL BE PAINTED AS INDICATED IN FINISH LEGEND.

EXPOSED GYP. BD. CEILINGS SHALL BE PAINTED - REFER TO FINISH PLANS, REFLECTED CEILING PLANS, & FINISH LEGEND FOR PAINT COLOR.

EXPOSED METAL HANDRAILS, GUARDRAILS, HANDRAIL/GUARDRAIL SUPPORT SYSTEMS, STAIR STRUCTURE, DUCTWORK, CONDUIT, PIPING, ETC NOT NOTED AS STAINLESS STEEL TO BE PAINTED.

RATED WALL CONDITIONS SHALL REMAIN 5/8" TYPE-X GYP. BOARD. GYP. BOARD, BOTH RATED AND NON-RATED, SHALL BE PAINTED WHERE EXPOSED - REFER TO FINISH LEGEND.


PROVIDE SOLID BLOCKING/BACKING FOR ALL WALL MOUNTED ACCESSORIES.

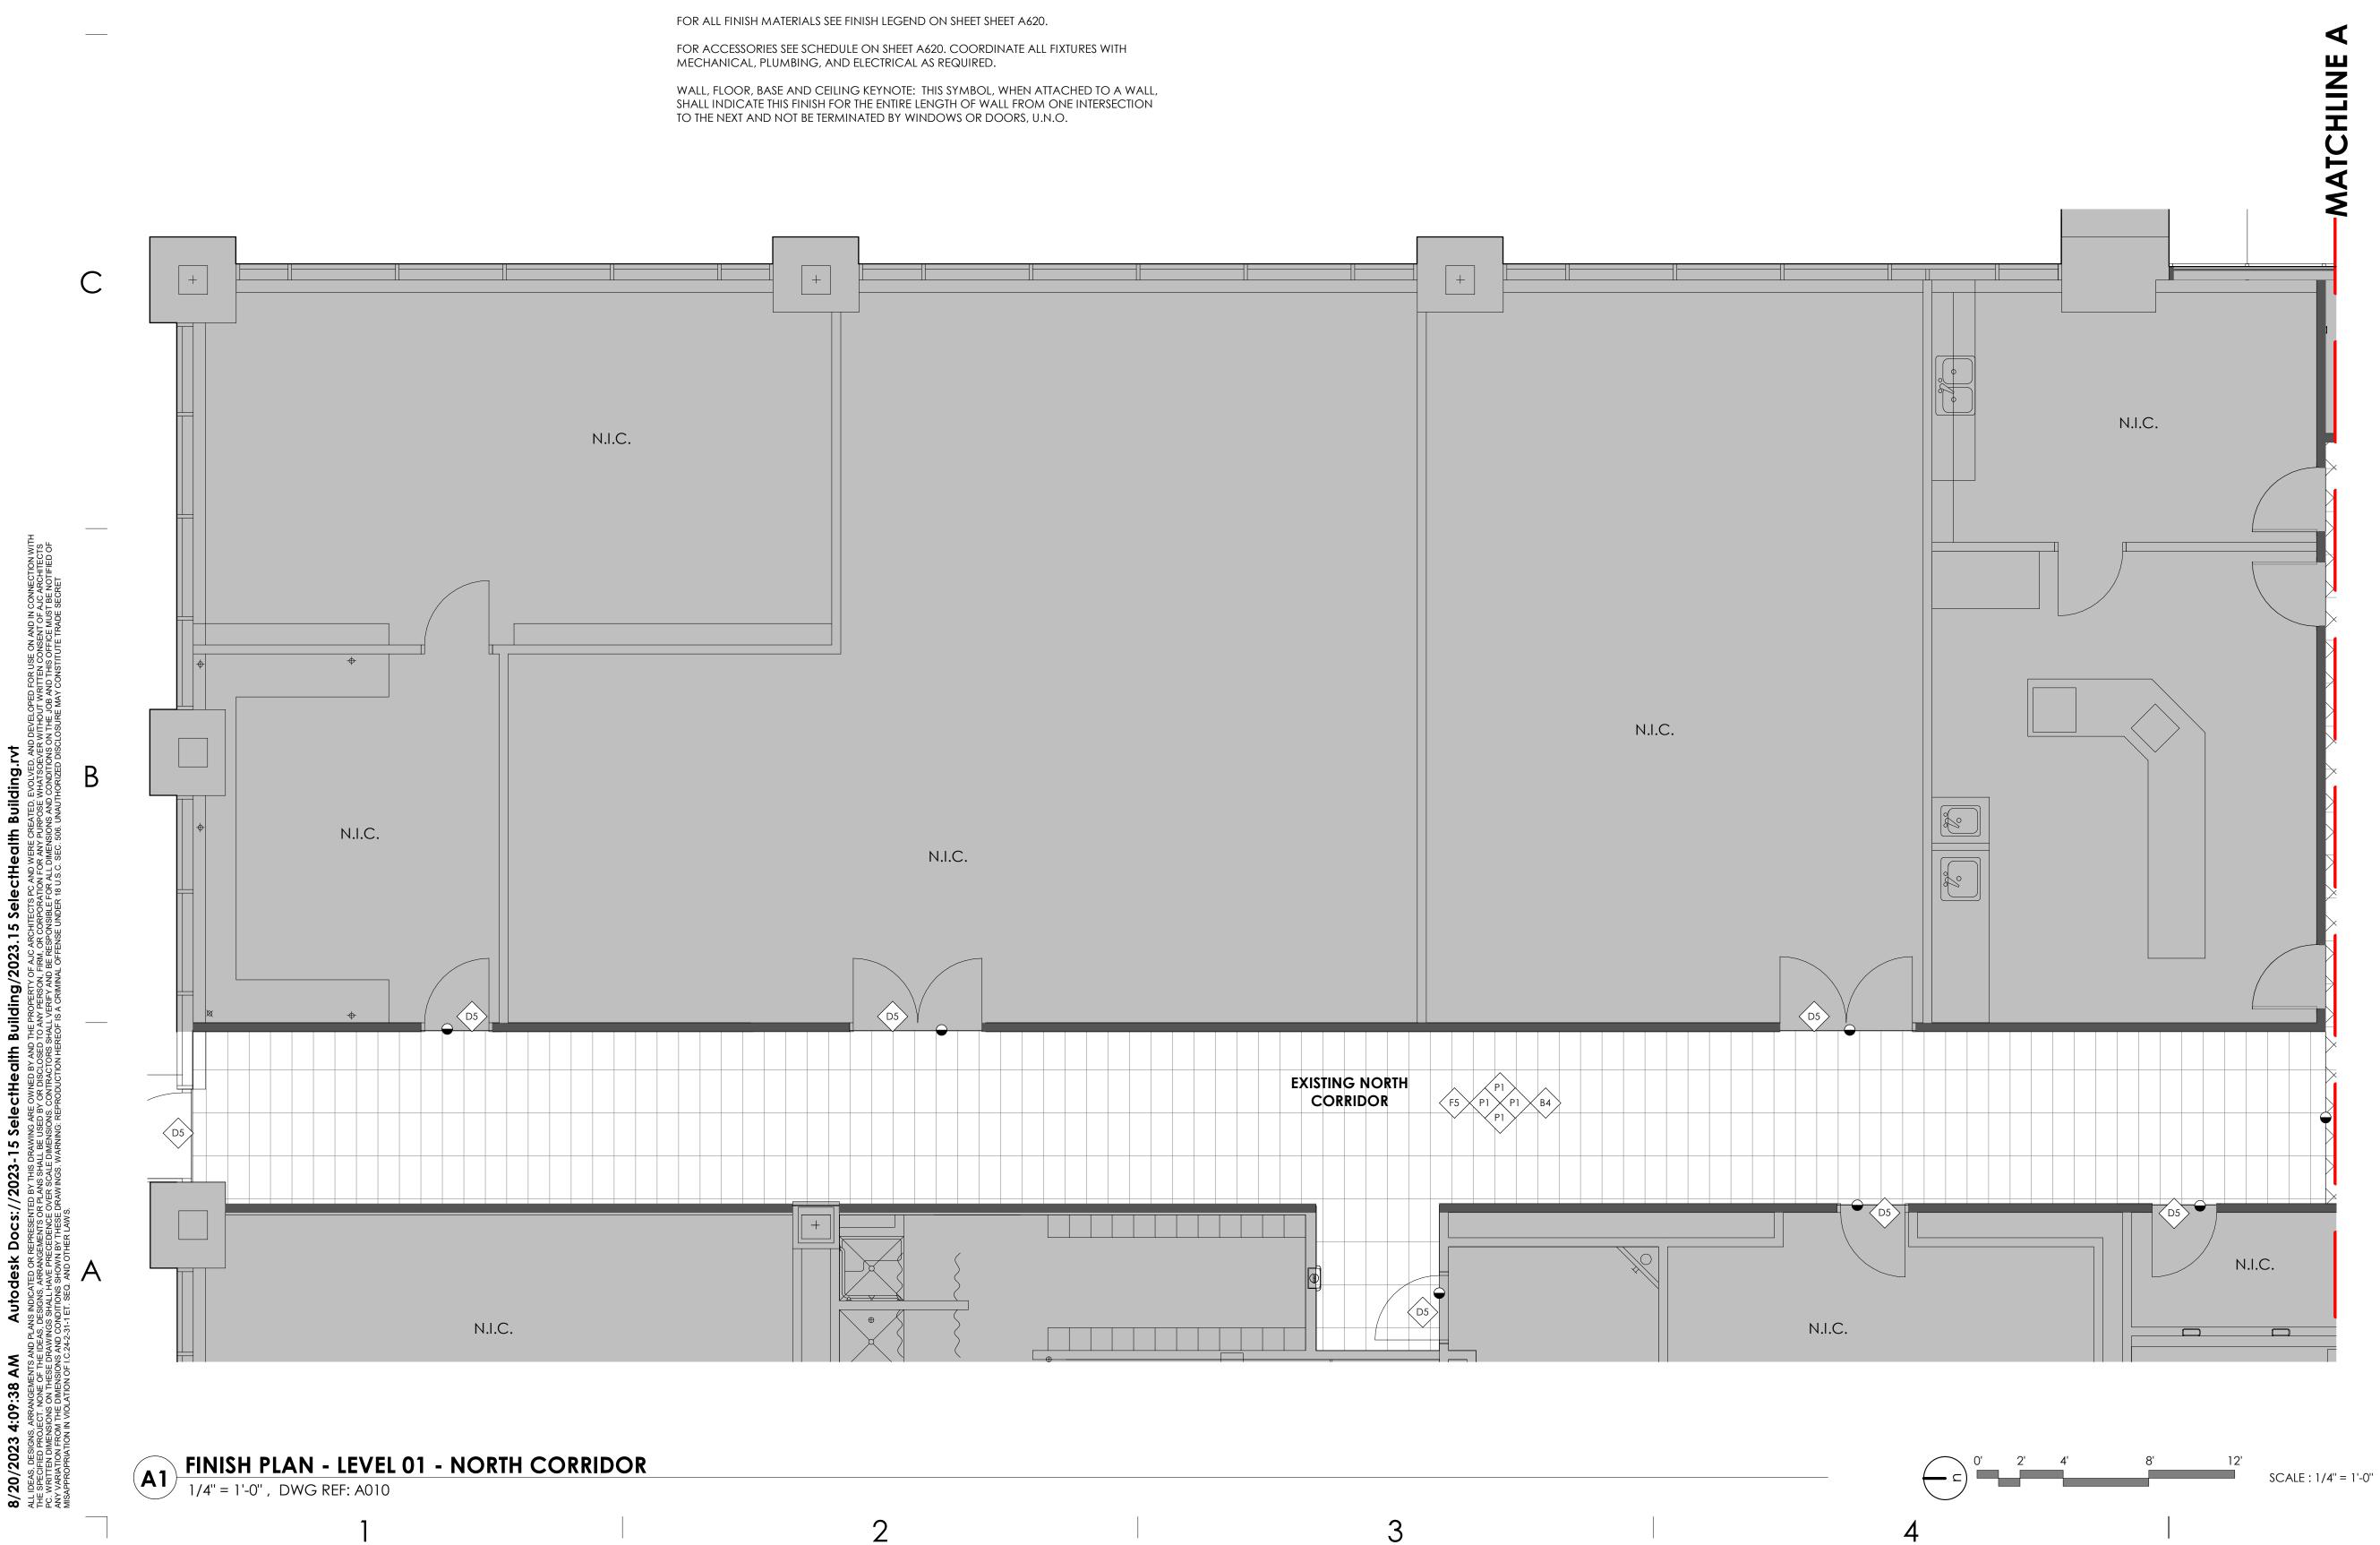

D



TRANSITION STRIP

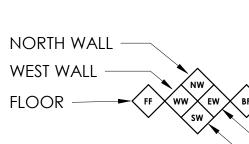

3

# - BASE EAST WALL

SOUTH WALL

→ ⊖ SEE D1/A503

# FLOOR FINISH SYMBOLS

WALK-OFF CARPET TILE	(F1)
CARPET TILE	F2
REINSTALLED CARPET TILE	F3
PORCELAIN TILE	<b>F</b> 4
RUBBER TILE	<b>F5</b>
LVP	F6

ALL EXPOSED NON CONCRETE COLUMNS TO BE PAINTED TO MATCH ADJACENT WALLS.



# **GENERAL NOTES:**

SEE SHEET G001 FOR DRAWING INDEX.

SEE SHEET AG000 FOR GENERAL ARCHITECTURAL NOTES AND ABBREVIATIONS.


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ajc architects

703 east 1700 south salt lake city, ut 84105 ajcarchitects.com

ARCHITECT / CONSULTANT



PROJECT DESCRIPTION
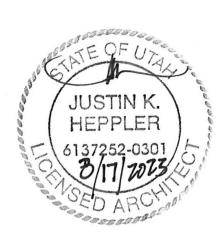
### SELECTHEALTH BUILDING TENANT IMPROVEMENT

5381 S GREEN STREET MURRAY, UT 84123

SHEET NAME:

### LEVEL 01 - FINISH PLAN - NORTH CORRIDOR


REVISIONS

MARK DATE DESCRIPTION

ISSUE DATE: ISSUE TYPE: DRAWN BY: CHECKED BY: R. OLSON PROJECT#:

08/17/2023 **BID SET** J. HALBERT 2023-15



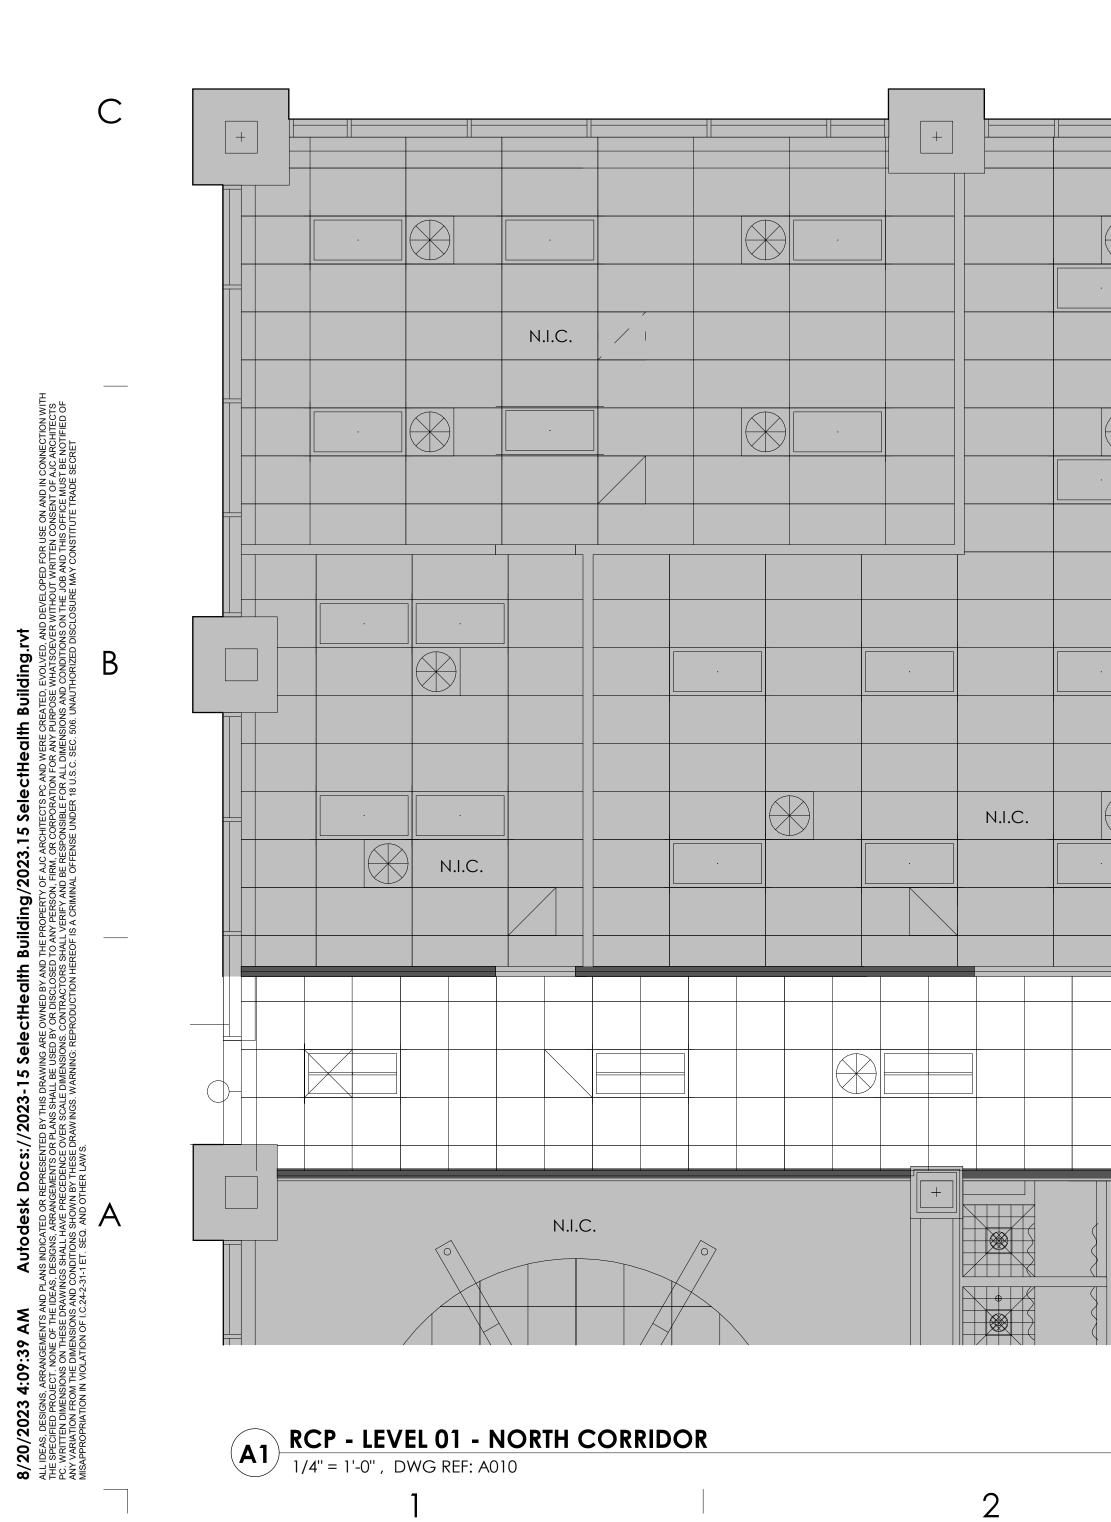

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2

# **REFLECTED CEILING PLAN**

THIS IS A REFLECTED CEILING PLAN AND IS NOT TO BE INTENDED TO BE A LIGHTING PLAN. NO WALL MOUNTED LIGHTING FIXTURES OR OTHER WALL MOUNTED APPURTENANCES ARE SHOWN. SEE THE LIGHTING PLAN FOR ALL LIGHTING AND EGRESS SIGNS, SIZE AND TYPES OF ELECTRICAL FIXTURES ETC. SEE MECHANICAL PLANS FOR ALL CEILING MOUNTED DIFFUSERS/GRILLES ETC.

CEILING MOUNTED DIFFUSERS/GRILLES ETC.		
SYMBOL LEGEND		
SURFACE MOUNTED OR LAY-IN CEILING FLUORESCENT FIXTURE. SEE ELECTRICAL PLAN FOR SIZE AND TYPE.		
LINEAR SUSPENDED LIGHTING FIXTURE. SEE ELECTRICAL PLAN FOR SIZE AND TYPE.		
OCCUPANCY SENSOR. SEE ELECTRICAL PLAN.		*
LIFE SAFETY DEVICES. SEE ELECTRICAL PLAN.	EXIT SIGN	S SMOKE DETECTOR
LIFE SAFETY DEVICES. SEE ELECTRICAL PLAN.		FIRE HORN
AUDIO/VISUAL EQUIPMENT. COORDINATE LOCATION W/ ELECTRICAL & OWNER.	Û DUAL SIDED CAMERA	() CAMERA
SUPPLY, RETURN & EXHAUST DIFFUSERS/GRILLES. SEE MECHANICAL.	SUPPLY	RETURN/

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C 0' 2' 4' 8' 12' SCALE : 1/4" = 1'-0" 4

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SEE SHEET AG000 FOR GENERAL ARCHITECTURAL NOTES AND ABBREVIATIONS.

4

do not scale drawings.

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ajc architects

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ARCHITECT / CONSULTANT



PROJECT DESCRIPTION

### SELECTHEALTH BUILDING TENANT IMPROVEMENT

5381 S GREEN STREET MURRAY, UT 84123

Sheet name:

### LEVEL 01 - RCP -NORTH CORRIDOR

REVISIONS


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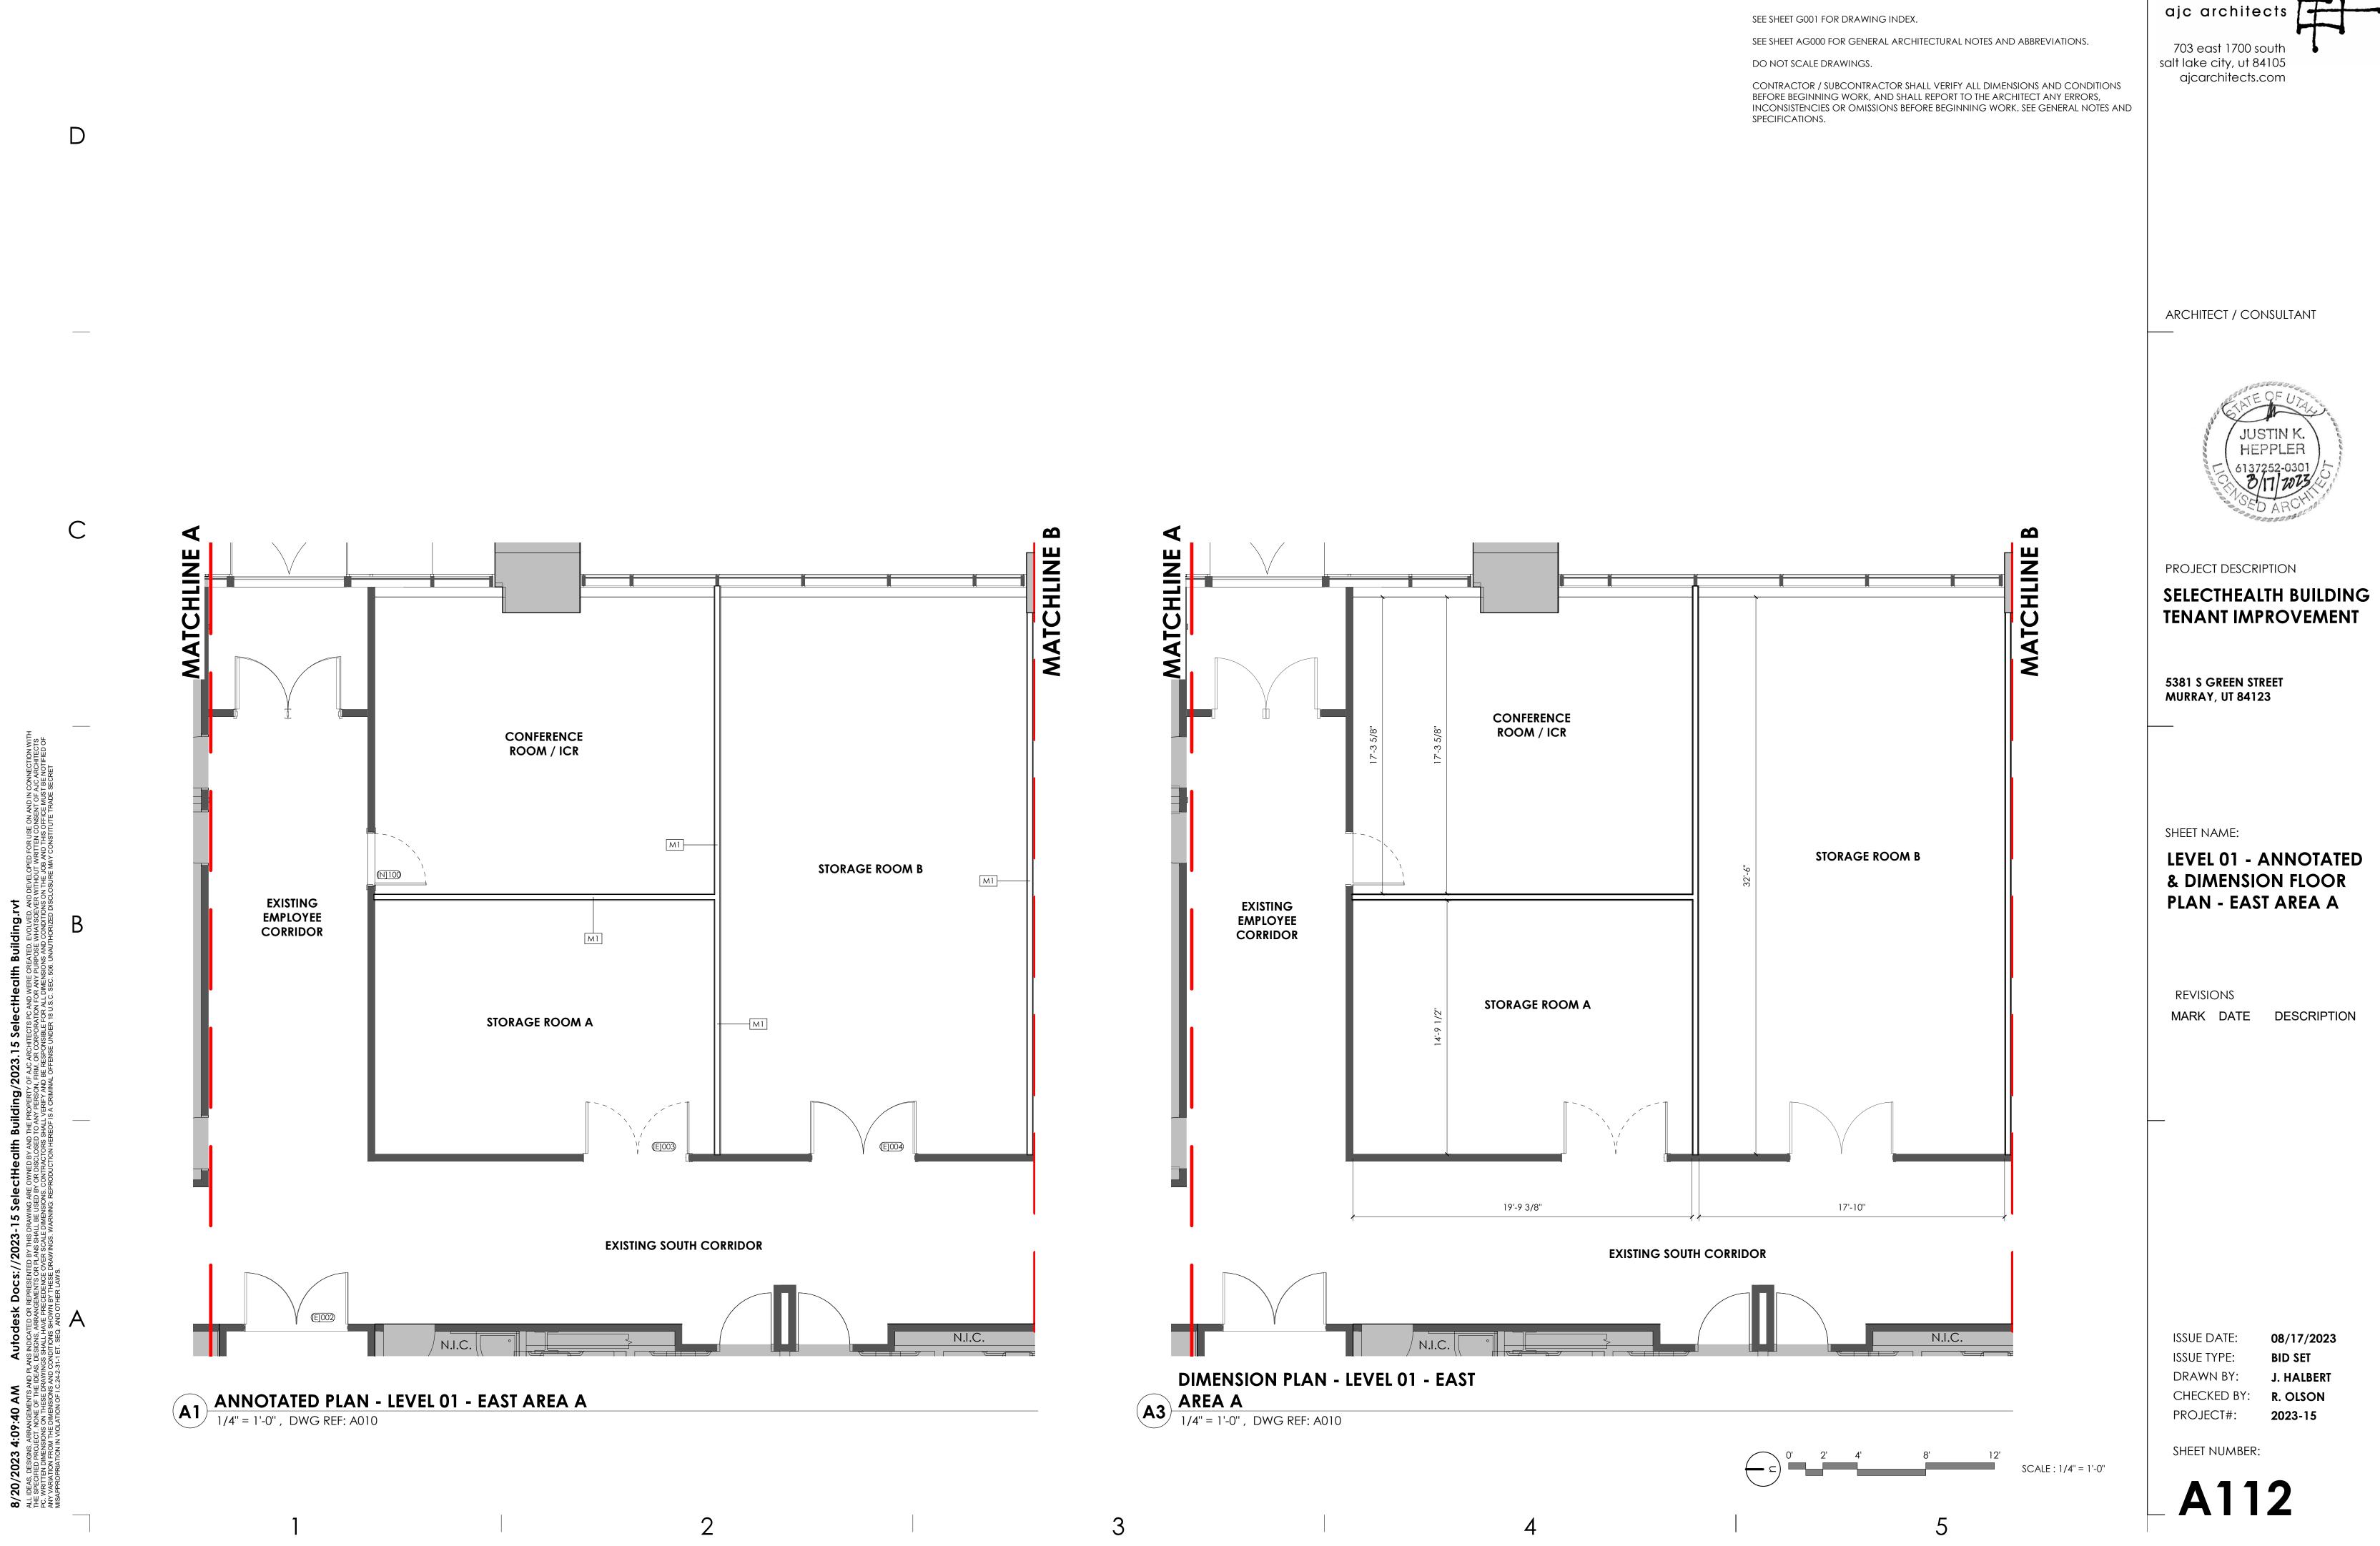
ISSUE DATE: ISSUE TYPE: DRAWN BY: CHECKED BY: R. OLSON PROJECT#: 2023-15

08/17/2023 **BID SET** J. HALBERT


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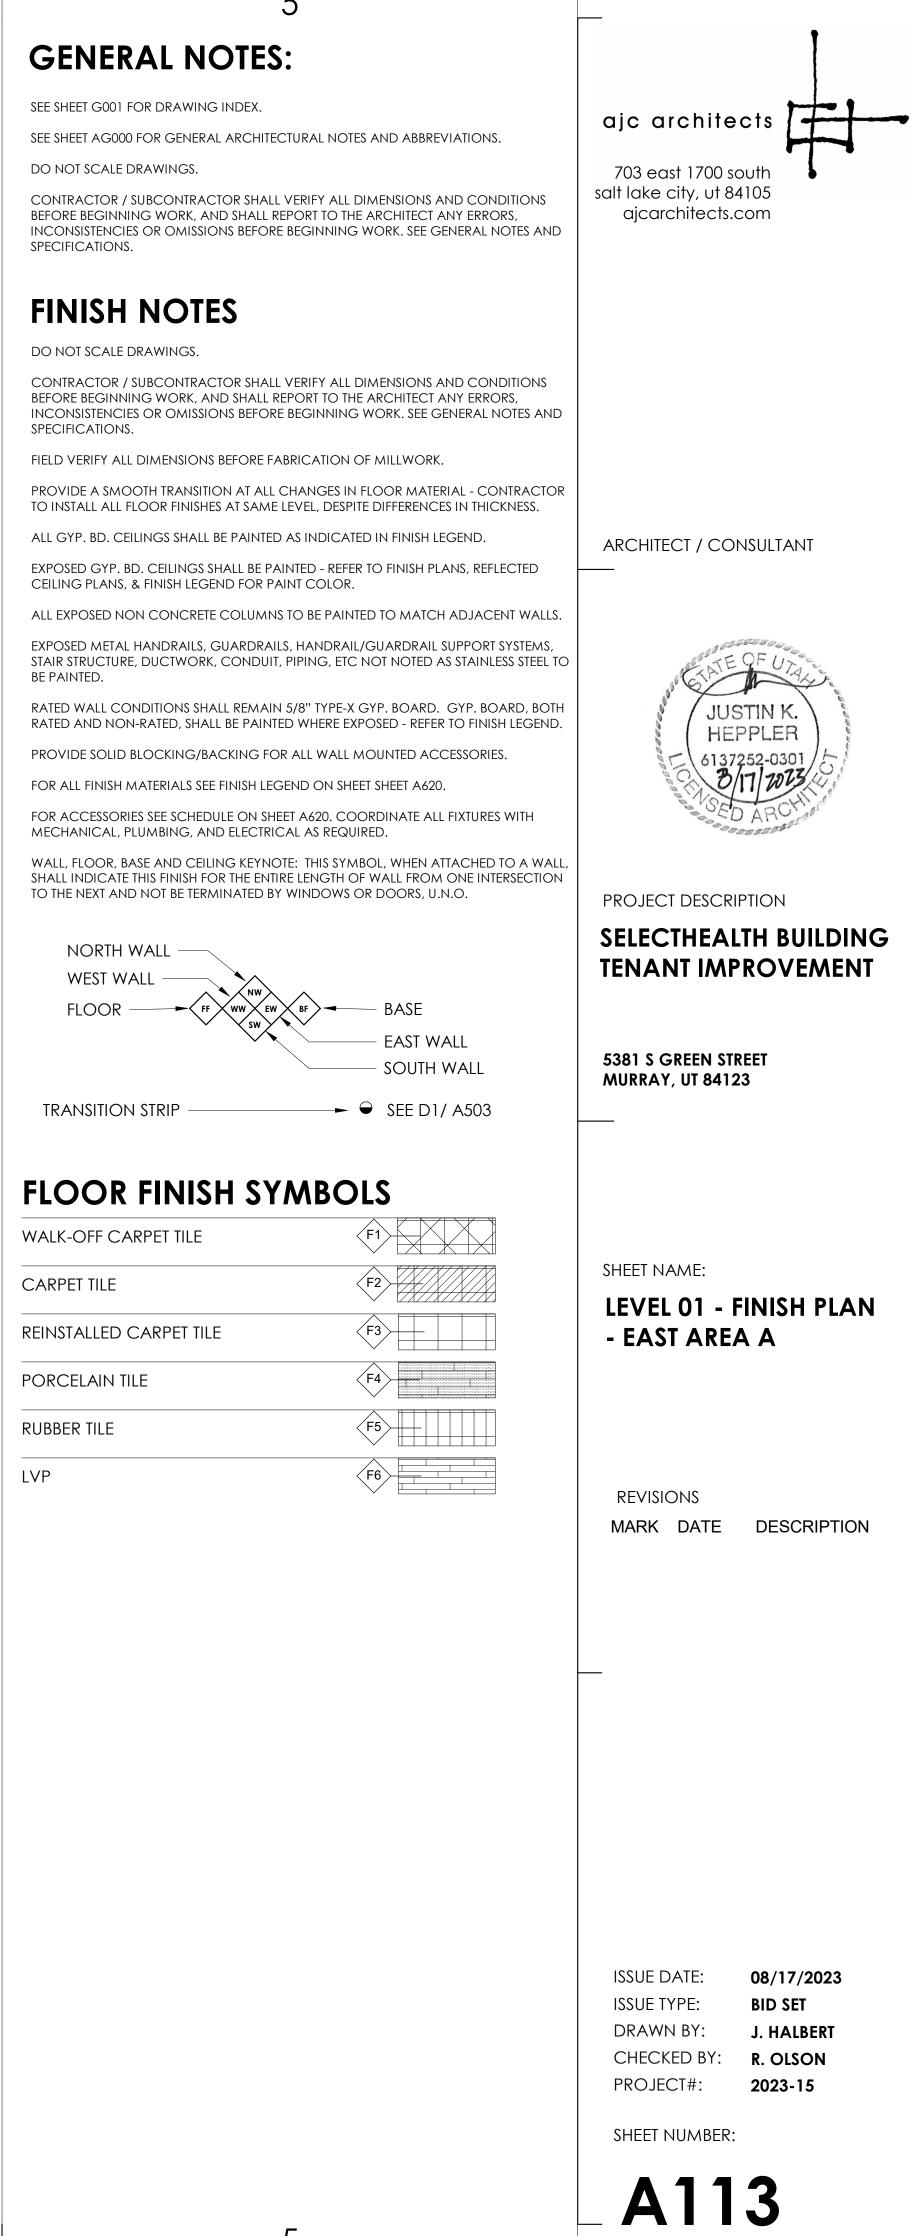





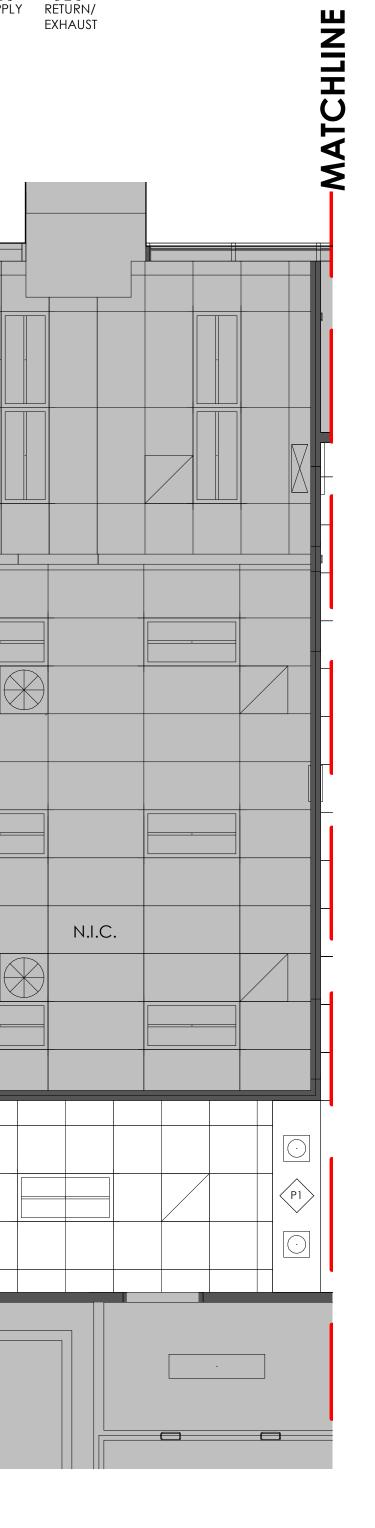

**GENERAL NOTES:** 



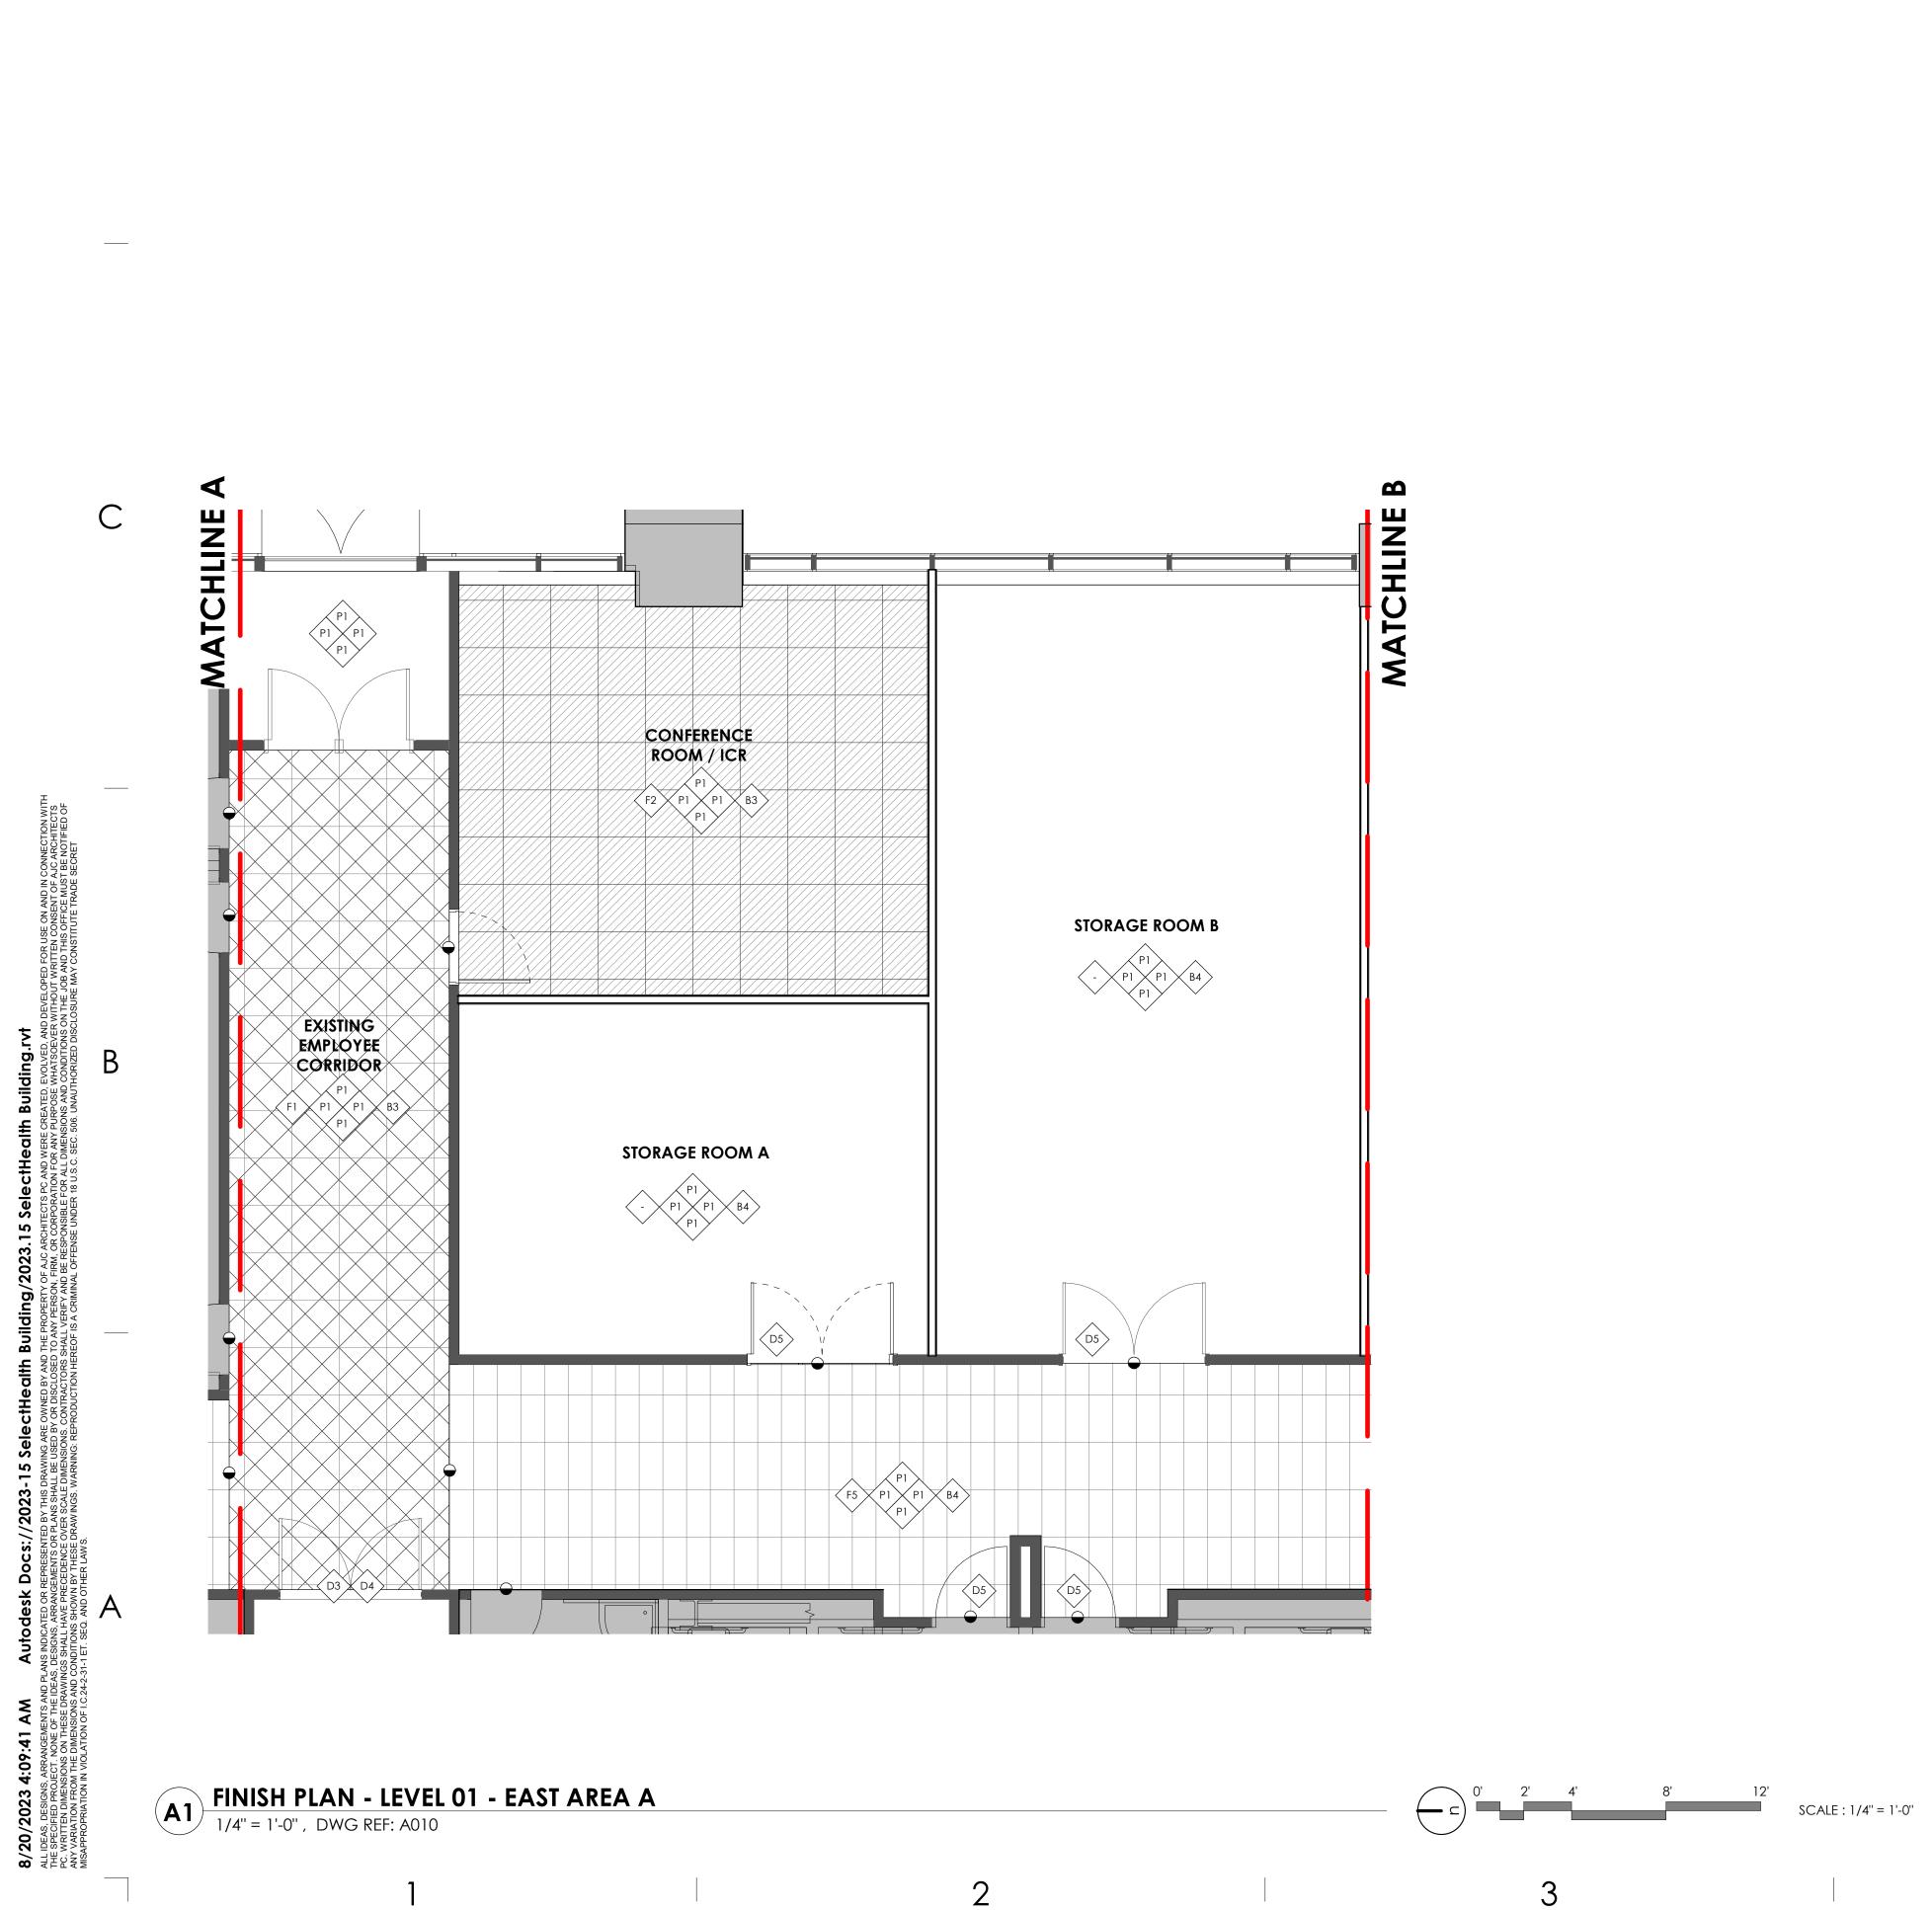

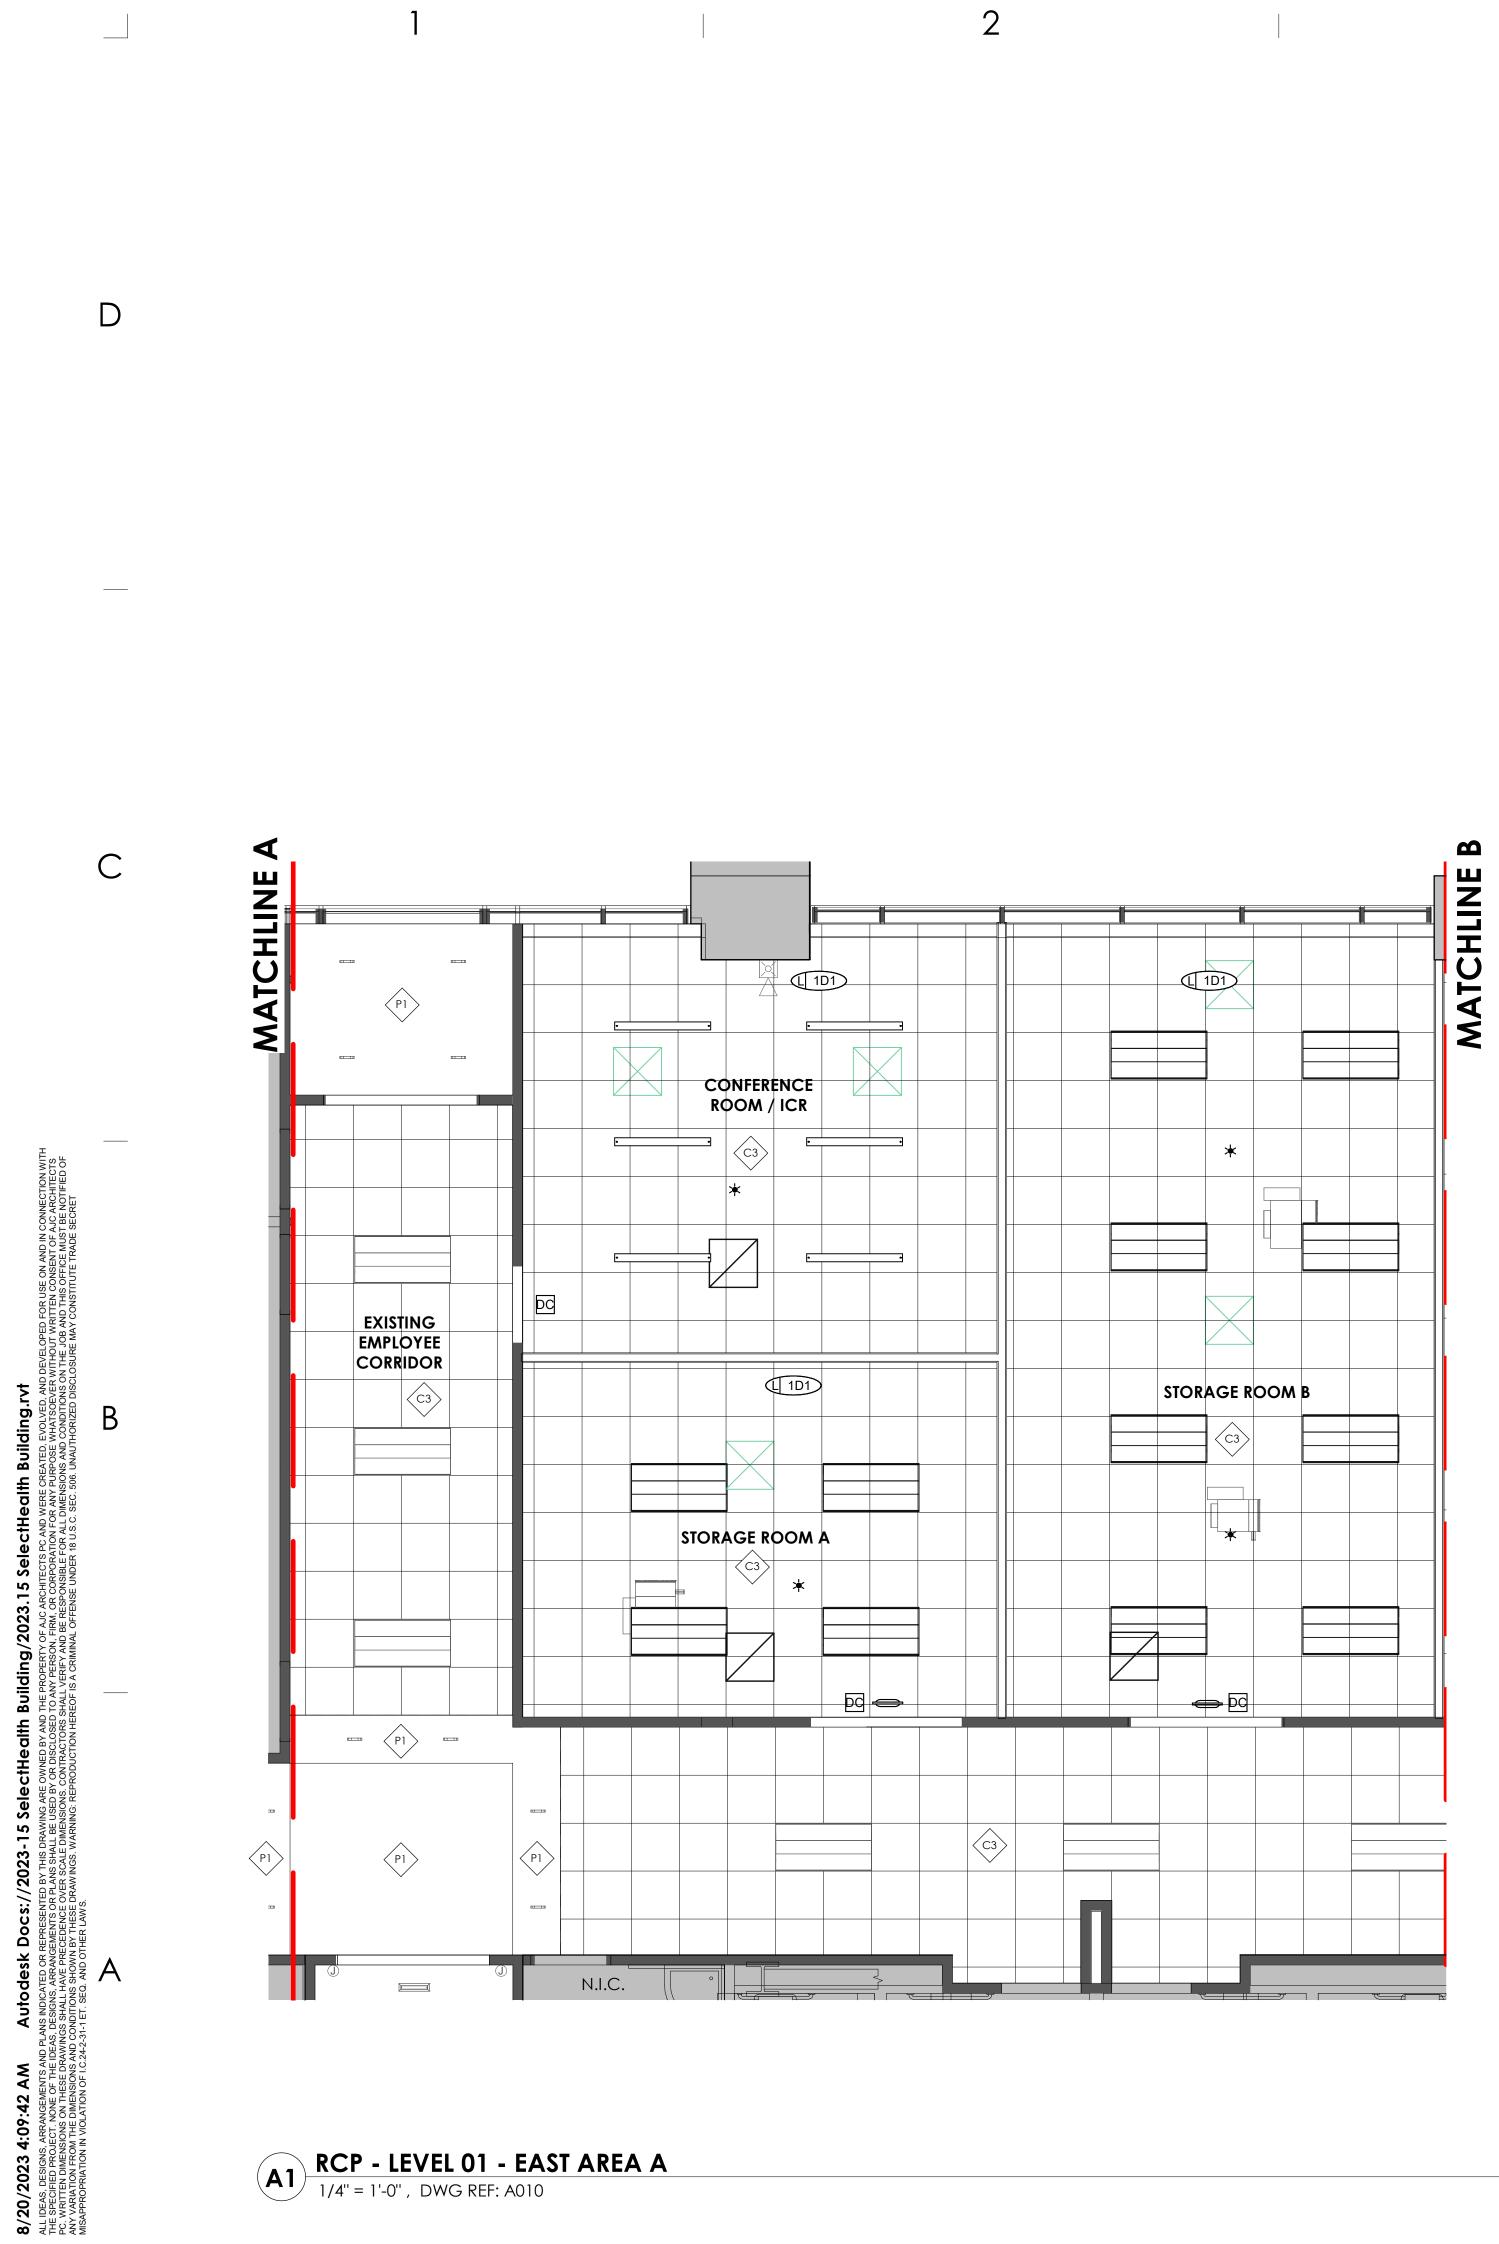

C 0' 2' 4' 8' 12' SCALE : 1/4" = 1'-0" 

4	5	
	GENERAL NOTES:	
	SEE SHEET G001 FOR DRAWING INDEX.	ajc architects
	SEE SHEET AG000 FOR GENERAL ARCHITECTURAL NOTES AND ABBREVIATIONS. DO NOT SCALE DRAWINGS.	703 east 1700 south
	CONTRACTOR / SUBCONTRACTOR SHALL VERIFY ALL DIMENSIONS AND CONDITIONS BEFORE BEGINNING WORK, AND SHALL REPORT TO THE ARCHITECT ANY ERRORS,	salt lake city, ut 84105 ajcarchitects.com
	INCONSISTENCIES OR OMISSIONS BEFORE BEGINNING WORK. SEE GENERAL NOTES AND SPECIFICATIONS.	
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	SURFACE MOUNTED OR LAY-IN CEILING FLUORESCENT FIXTURE. SEE ELECTRICAL	
	PLAN FOR SIZE AND TYPE.	ARCHITECT / CONSULTANT
	SEE ELECTRICAL PLAN FOR SIZE AND TYPE.	
	OCCUPANCY SENSOR. SEE ELECTRICAL	A STITUTE CON
	LIFE SAFETY DEVICES. SEE ELECTRICAL PLAN. EXIT SIGN SMOKE DETECTOR LIFE SAFETY DEVICES. SEE ELECTRICAL	JUSTIN K. HEPPLER
	PLAN. FIRE HORN	6137252-0301 /- B/17/7073
	COORDINATE LOCATION W/ ELECTRICAL & OWNER. DUAL SIDED CAMERA CAMERA	SED ARCHING
	SUPPLY, RETURN & EXHAUST <ul> <li>I × I</li> <lii i<="" li="" ×=""> <lii i<="" li="" ×=""> <lii td="" ×<=""><td></td></lii></lii></lii></ul>	
	EXHAUST	PROJECT DESCRIPTION SELECTHEALTH BUILDING
		TENANT IMPROVEMENT
		5381 S GREEN STREET
		MURRAY, UT 84123
		SHEET NAME: LEVEL 01 - RCP - EAST
		AREA A
		REVISIONS
		MARK DATE DESCRIPTION
		ISSUE DATE:         08/17/2023           ISSUE TYPE:         BID SET
		DRAWN BY: J. HALBERT CHECKED BY: R. OLSON
		PROJECT#: 2023-15
		SHEET NUMBER:
		A114
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2

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4



SEE SHEET G001 FOR DRAWING INDEX.

SEE SHEET AG000 FOR GENERAL ARCHITECTURAL NOTES AND ABBREVIATIONS.

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5

ajc architects

703 east 1700 south salt lake city, ut 84105 ajcarchitects.com

ARCHITECT / CONSULTANT



PROJECT DESCRIPTION

### SELECTHEALTH BUILDING **TENANT IMPROVEMENT**

5381 S GREEN STREET MURRAY, UT 84123

sheet name:

### LEVEL 01 - ANNOTATED & DIMENSION FLOOR PLANS - EAST AREA B


REVISIONS

MARK DATE DESCRIPTION

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08/17/2023 **BID SET** J. HALBERT



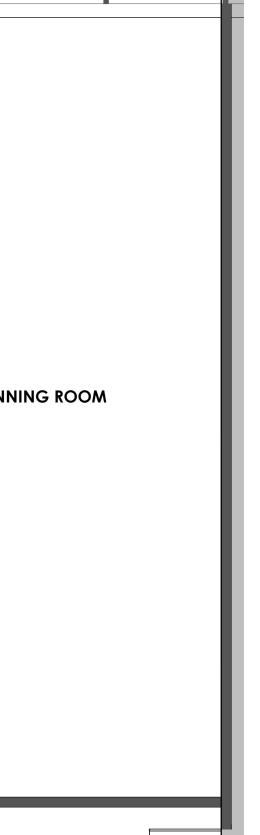

# **FINISH NOTES**

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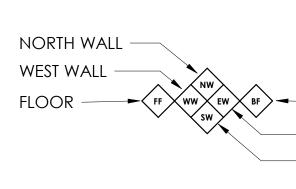
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PROVIDE SOLID BLOCKING/BACKING FOR ALL WALL MOUNTED ACCESSORIES.

FOR ALL FINISH MATERIALS SEE FINISH LEGEND ON SHEET SHEET A620.

FOR ACCESSORIES SEE SCHEDULE ON SHEET A620. COORDINATE ALL FIXTURES WITH MECHANICAL, PLUMBING, AND ELECTRICAL AS REQUIRED.

WALL, FLOOR, BASE AND CEILING KEYNOTE: THIS SYMBOL, WHEN ATTACHED TO A WALL, SHALL INDICATE THIS FINISH FOR THE ENTIRE LENGTH OF WALL FROM ONE INTERSECTION TO THE NEXT AND NOT BE TERMINATED BY WINDOWS OR DOORS, U.N.O.



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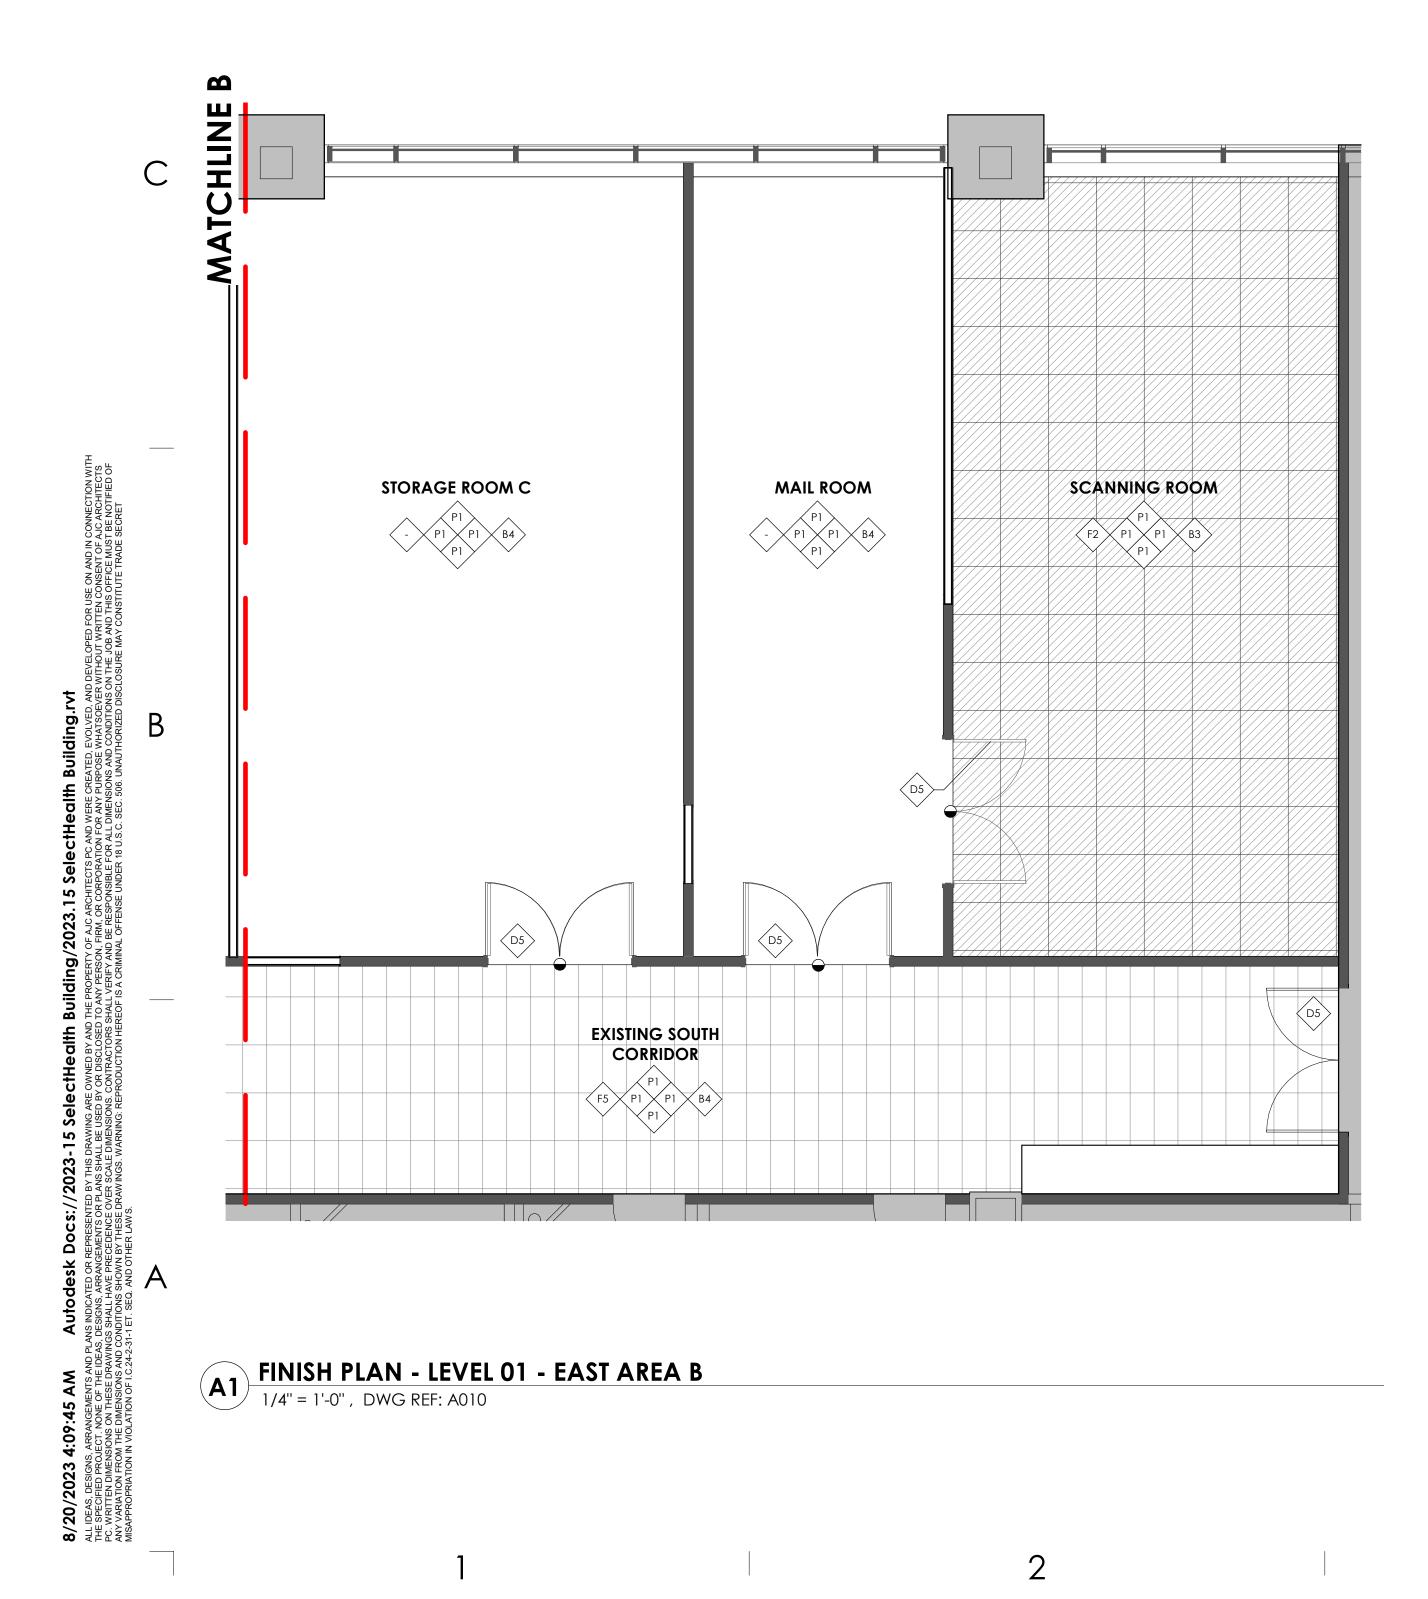
BASE

EAST WALL

SOUTH WALL

→ ⊖ SEE D1/ A503

TRANSITION STRIP



3


# FLOOR FINISH SYMBOLS

WALK-OFF CARPET TILE	F1
CARPET TILE	F2
REINSTALLED CARPET TILE	F3
PORCELAIN TILE	F4
RUBBER TILE	F5
LVP	F6

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LIFE SAFETY DEVICES. SEE ELECTRICAL PLAN.	
AUDIO/VISUAL EQUIPMENT. COORDINATE LOCATION W/ ELECTRICAL & OWNER.	DUAL
SUPPLY, RETURN & EXHAUST DIFFUSERS/GRILLES. SEE MECHANICAL.	S



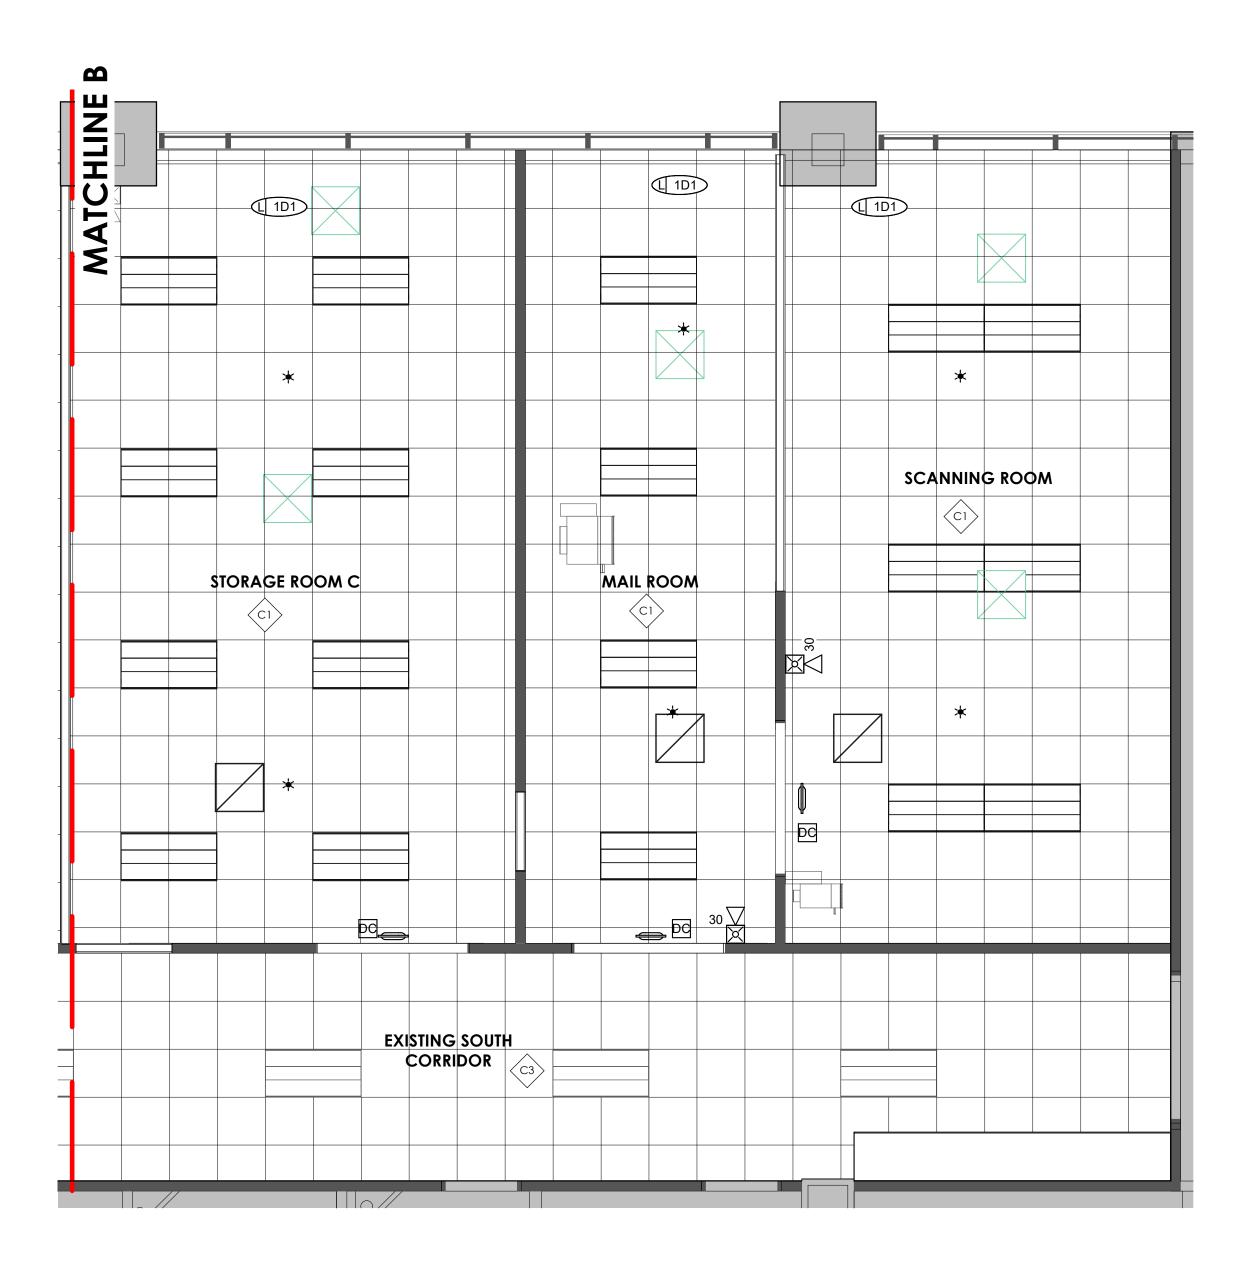

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× λ Smoke DETECTOR  $\geq$ FIRE HORN LSIDED CAMERA AMERA SUPPLY RETURN/ exhaust **GENERAL NOTES:** 

SEE SHEET GOO1 FOR DRAWING INDEX.

SEE SHEET AG000 FOR GENERAL ARCHITECTURAL NOTES AND ABBREVIATIONS.

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ajc architects

703 east 1700 south salt lake city, ut 84105 ajcarchitects.com

ARCHITECT / CONSULTANT



PROJECT DESCRIPTION

### SELECTHEALTH BUILDING **TENANT IMPROVEMENT**

5381 S GREEN STREET MURRAY, UT 84123

Sheet NAME:

### LEVEL 01 - FINISH PLAN & RCP - EAST AREA B


REVISIONS


MARK DATE DESCRIPTION


ISSUE DATE: ISSUE TYPE: DRAWN BY: CHECKED BY: R. OLSON PROJECT#: 2023-15

08/17/2023 **BID SET** J. HALBERT



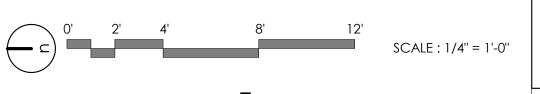

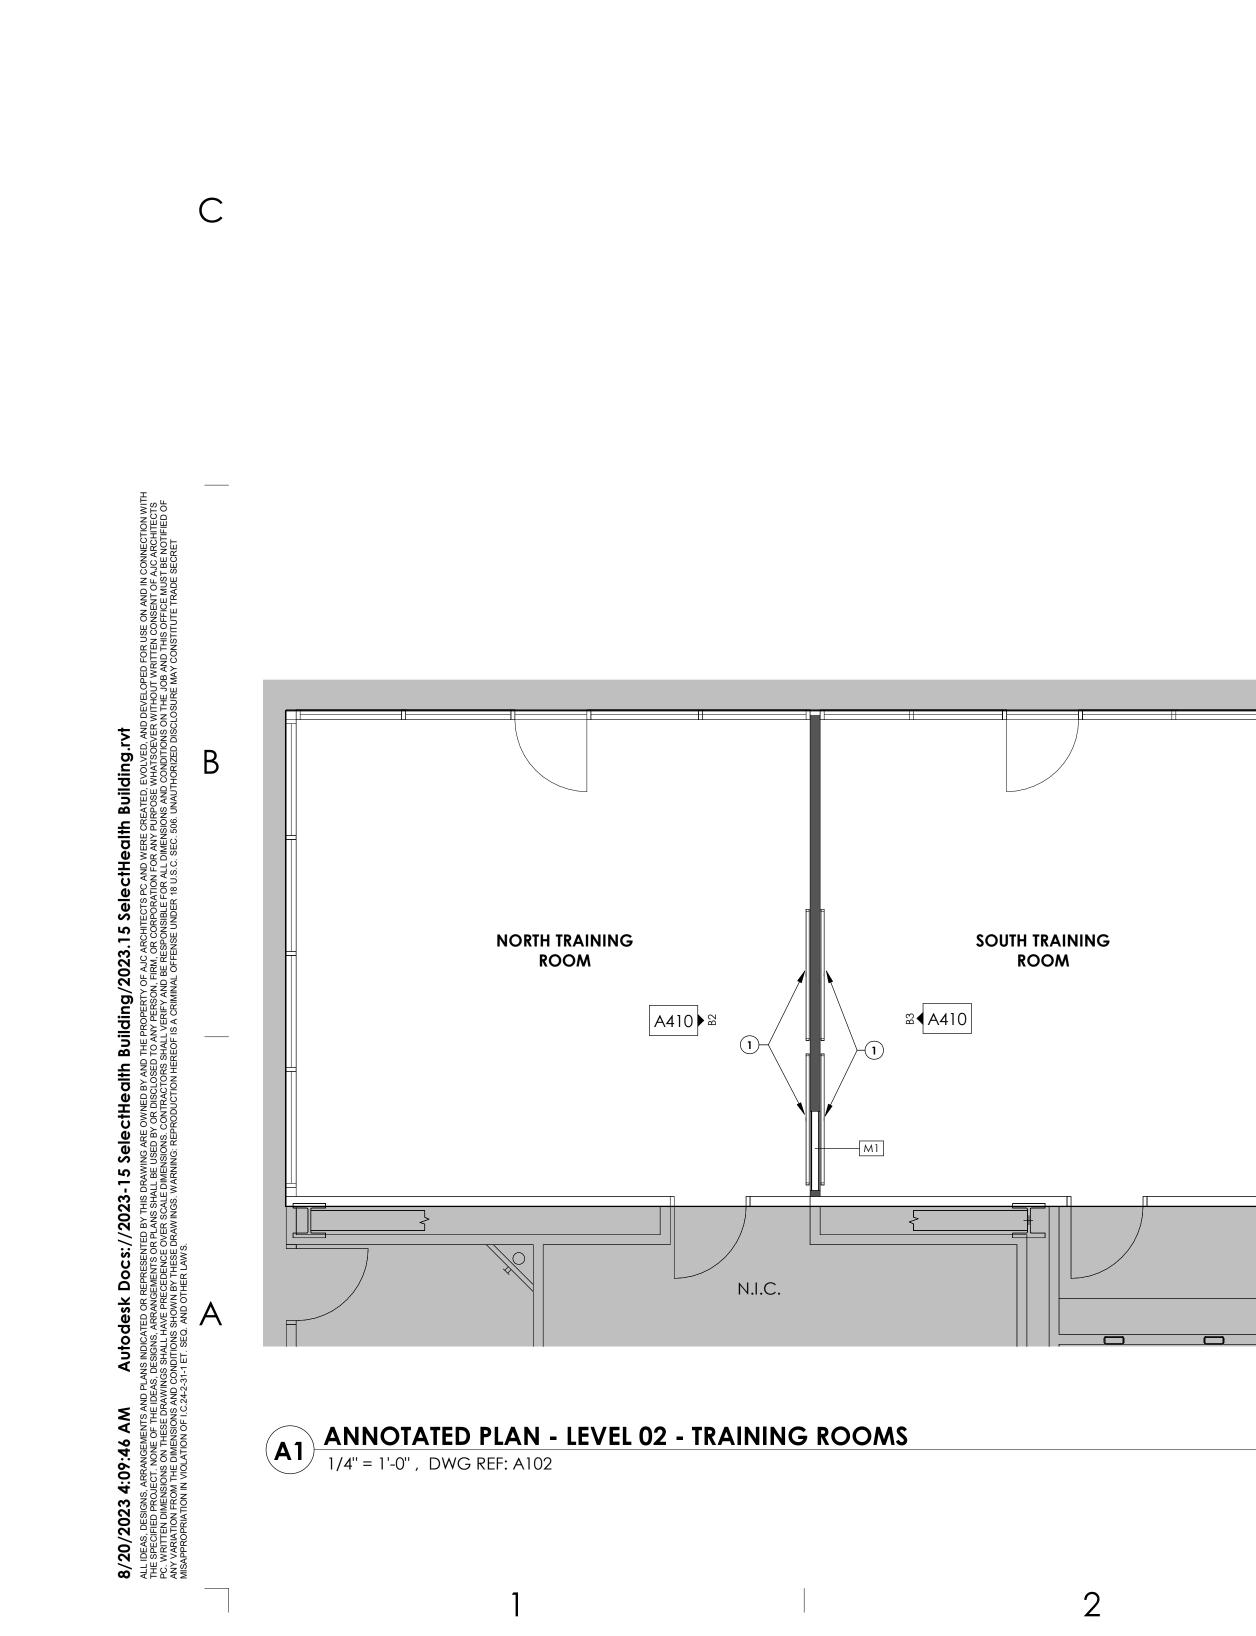

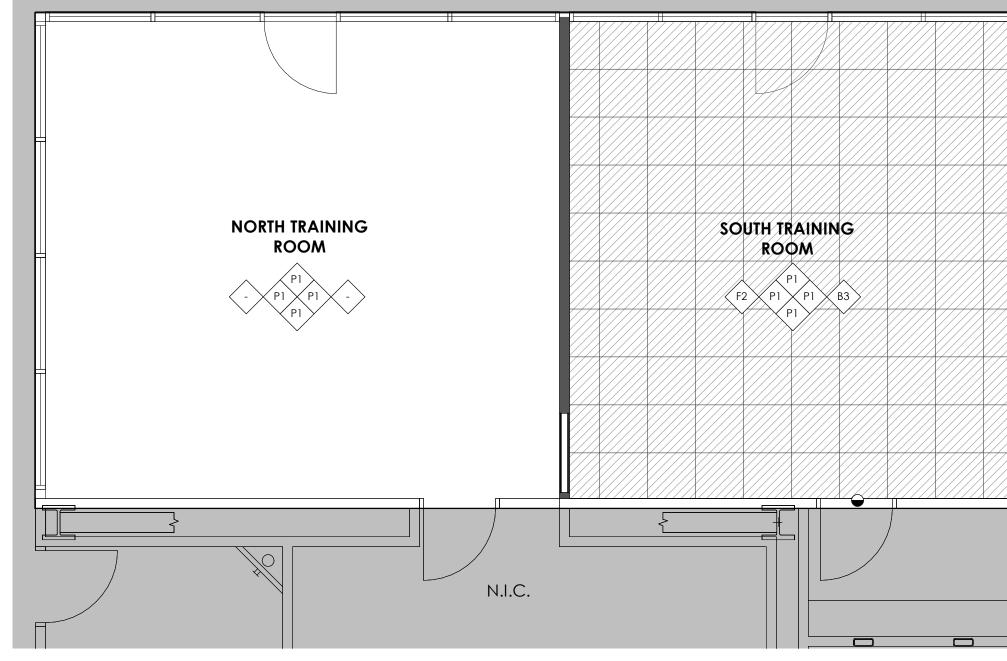



	1 2	3	4	5	
				GENERAL NOTES:         SEE SHEET G001 FOR DRAWING INDEX.         SEE SHEET AG000 FOR GENERAL ARCHITECTURAL NOTES AND ABBREVIATIONS.         DO NOT SCALE DRAWINGS.         CONTRACTOR / SUBCONTRACTOR SHALL VERIFY ALL DIMENSIONS AND CONDITIONS BEFORE BEGINNING WORK, AND SHALL REPORT TO THE ARCHITECT ANY ERRORS, INCONSISTENCIES OR OMISSIONS BEFORE BEGINNING WORK. SEE GENERAL NOTES AND SPECIFICATIONS.	ajc architects
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С				FOR ALL FINISH MATERIALS SEE FINISH LEGEND ON SHEET SHEET A620. FOR ACCESSORIES SEE SCHEDULE ON SHEET A620. COORDINATE ALL FIXTURES WITH MECHANICAL, PLUMBING, AND ELECTRICAL AS REQUIRED. WALL, FLOOR, BASE AND CEILING KEYNOTE: THIS SYMBOL, WHEN ATTACHED TO A WALL SHALL INDICATE THIS FINISH FOR THE ENTIRE LENGTH OF WALL FROM ONE INTERSECTION TO THE NEXT AND NOT BE TERMINATED BY WINDOWS OR DOORS, U.N.O. NORTH WALL WEST WALL FLOOR FLO	SELECTHEALTH BUILDING TENANT IMPROVEMENT
ND THIS OFFICE MUST BE NOTIFIED OF CONSTITUTE TRADE SECRET				SOUTH WALL TRANSITION STRIP $\rightarrow$ SEE D1/ A503 FLOOR FINISH SYMBOLS WALK-OFF CARPET TILE	MURRAY, UT 84123
B U.S.C. SEC. 508. UNAUTHORIZED DISCLOSURE MAY				CARPET TILE $F_2$ REINSTALLED CARPET TILE $F_3$ PORCELAIN TILE $F_4$ RUBBER TILE $F_5$ LVP $F_6$	LEVEL 02 - ANNOTATED & FINISH FLOOR PLANS - TRAINING ROOMS REVISIONS
DDUCTION HEREOF IS A CRIMINAL OFFENSE UNDER 18	NORTH TRAINING ROOM	NORTH TRAINING ROOM	SOUTH TRAINING ROOM F2 P1 P1 B3 P1 P1 B3	KEY NOTES:     1      TV OUTLET, SEE ELECTRICAL DRAWINGS	MARK DATE DESCRIPTION
L HAVE PRECEDENCE OVER SCALE DIMENSIONS. CO L HAVE PRECEDENCE OVER SCALE DIMENSIONS. CO DNS SHOWN BY THESE DRAWINGS. WARNING: REPRO SEQ. AND OTHER LAWS. SEQ. AND OTHER LAWS.					ISSUE DATE: 08/17/2023
, DE SIGNS, ARKRANGENIENTS AND CLAVE INC. EIED DIMENSIONS ON THE IDEAS, DESIGN EIED DIMENSIONS ON THESE DRAWINGS SHAL TION FROM THE DIMENSIONS AND CONDITIO PRIATION IN VIOLATION OF I.C.24-2-31-1 ET. S	A1 ANNOTATED PLAN - LEVEL 02 - TRAINING ROOMS	A3 FINISH PLAN - LEVEL 02 - TRA		2' 4' 8' 12'	ISSUE DATE: 08/17/2023 ISSUE TYPE: BID SET DRAWN BY: J. HALBERT CHECKED BY: R. OLSON PROJECT#: 2023-15 SHEET NUMBER:
ALL IDEAS, THE SPECT PC. WRITC ANY VARIA MISAPPRO	1 2	3	4	SCALE : 1/4" = 1'-0"	<b>_ A117</b>

# **FINISH NOTES**

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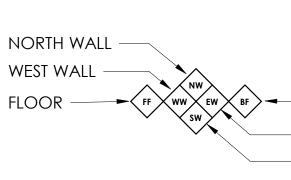
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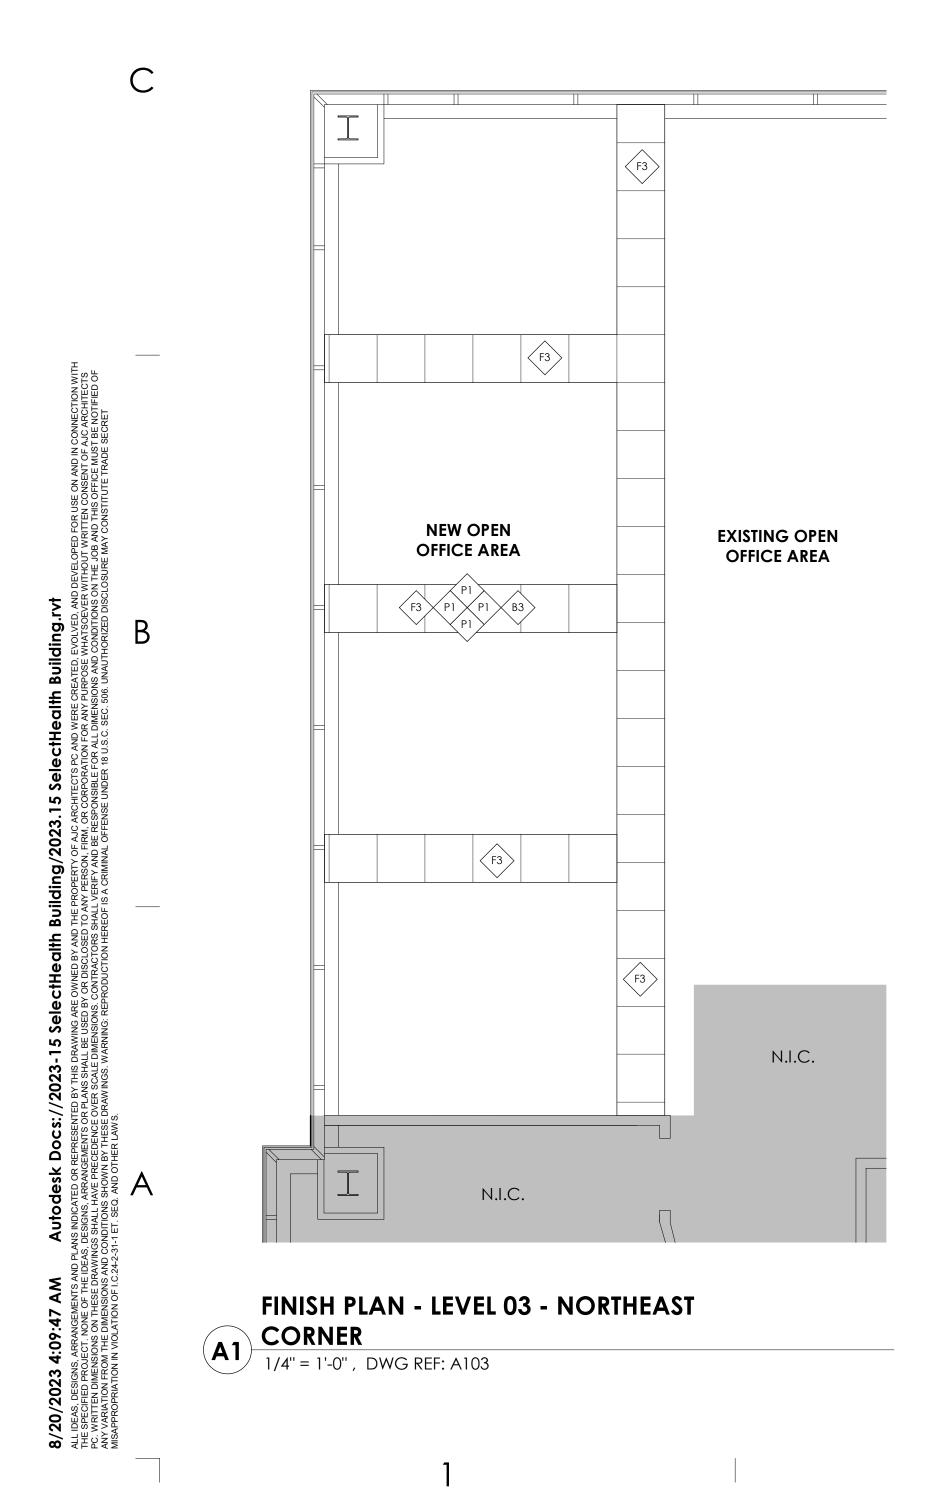
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TRANSITION STRIP



# 3

# FLOOR FINISH SYMBOLS

- BASE - EAST WALL SOUTH WALL

→ ⊖ SEE D1/ A503


WALK-OFF CARPET TILE	<
CARPET TILE	<
REINSTALLED CARPET TILE	<
PORCELAIN TILE	<
RUBBER TILE	<
LVP	<

O	LS			
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$\langle$	<b>F6</b>	- 1		I

# **REFLECTED CEILING PLAN**


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2

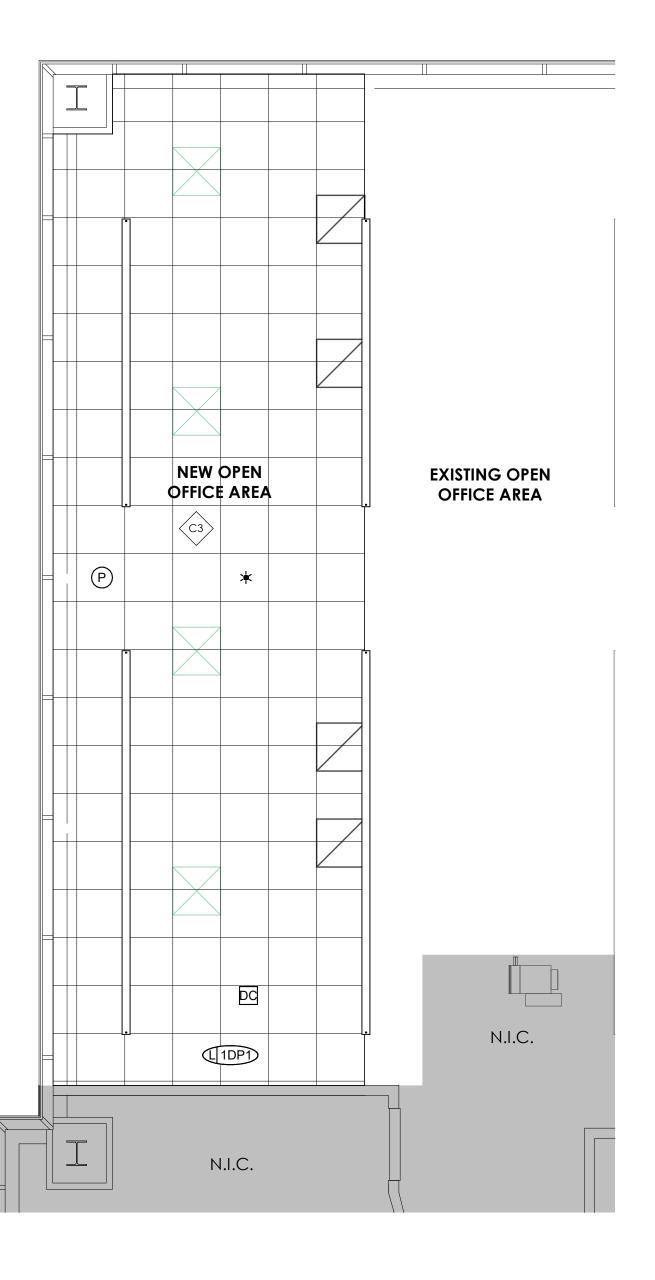

# **GENERAL NOTES:**

(S)SMOKE DETECTOR []FIRE HORN ~ DUAL SIDED CAMERA SUPPLY RETURN/

EXHAUST

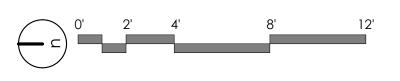SEE SHEET G001 FOR DRAWING INDEX.

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ajc architects

703 east 1700 south salt lake city, ut 84105 ajcarchitects.com

> JUSTIN K HEPPLER 137252-030

ARCHITECT / CONSULTANT

PROJECT DESCRIPTION

# SELECTHEALTH BUILDING **TENANT IMPROVEMENT**

5381 S GREEN STREET **MURRAY, UT 84123** 

SHEET NAME:

# LEVEL 03 - FINISH PLAN & RCP - NORTHEAST CORNER


REVISIONS


MARK DATE DESCRIPTION

ISSUE DATE: ISSUE TYPE: DRAWN BY: CHECKED BY: R. OLSON PROJECT#: 2023-15

08/17/2023 **BID SET** J. HALBERT



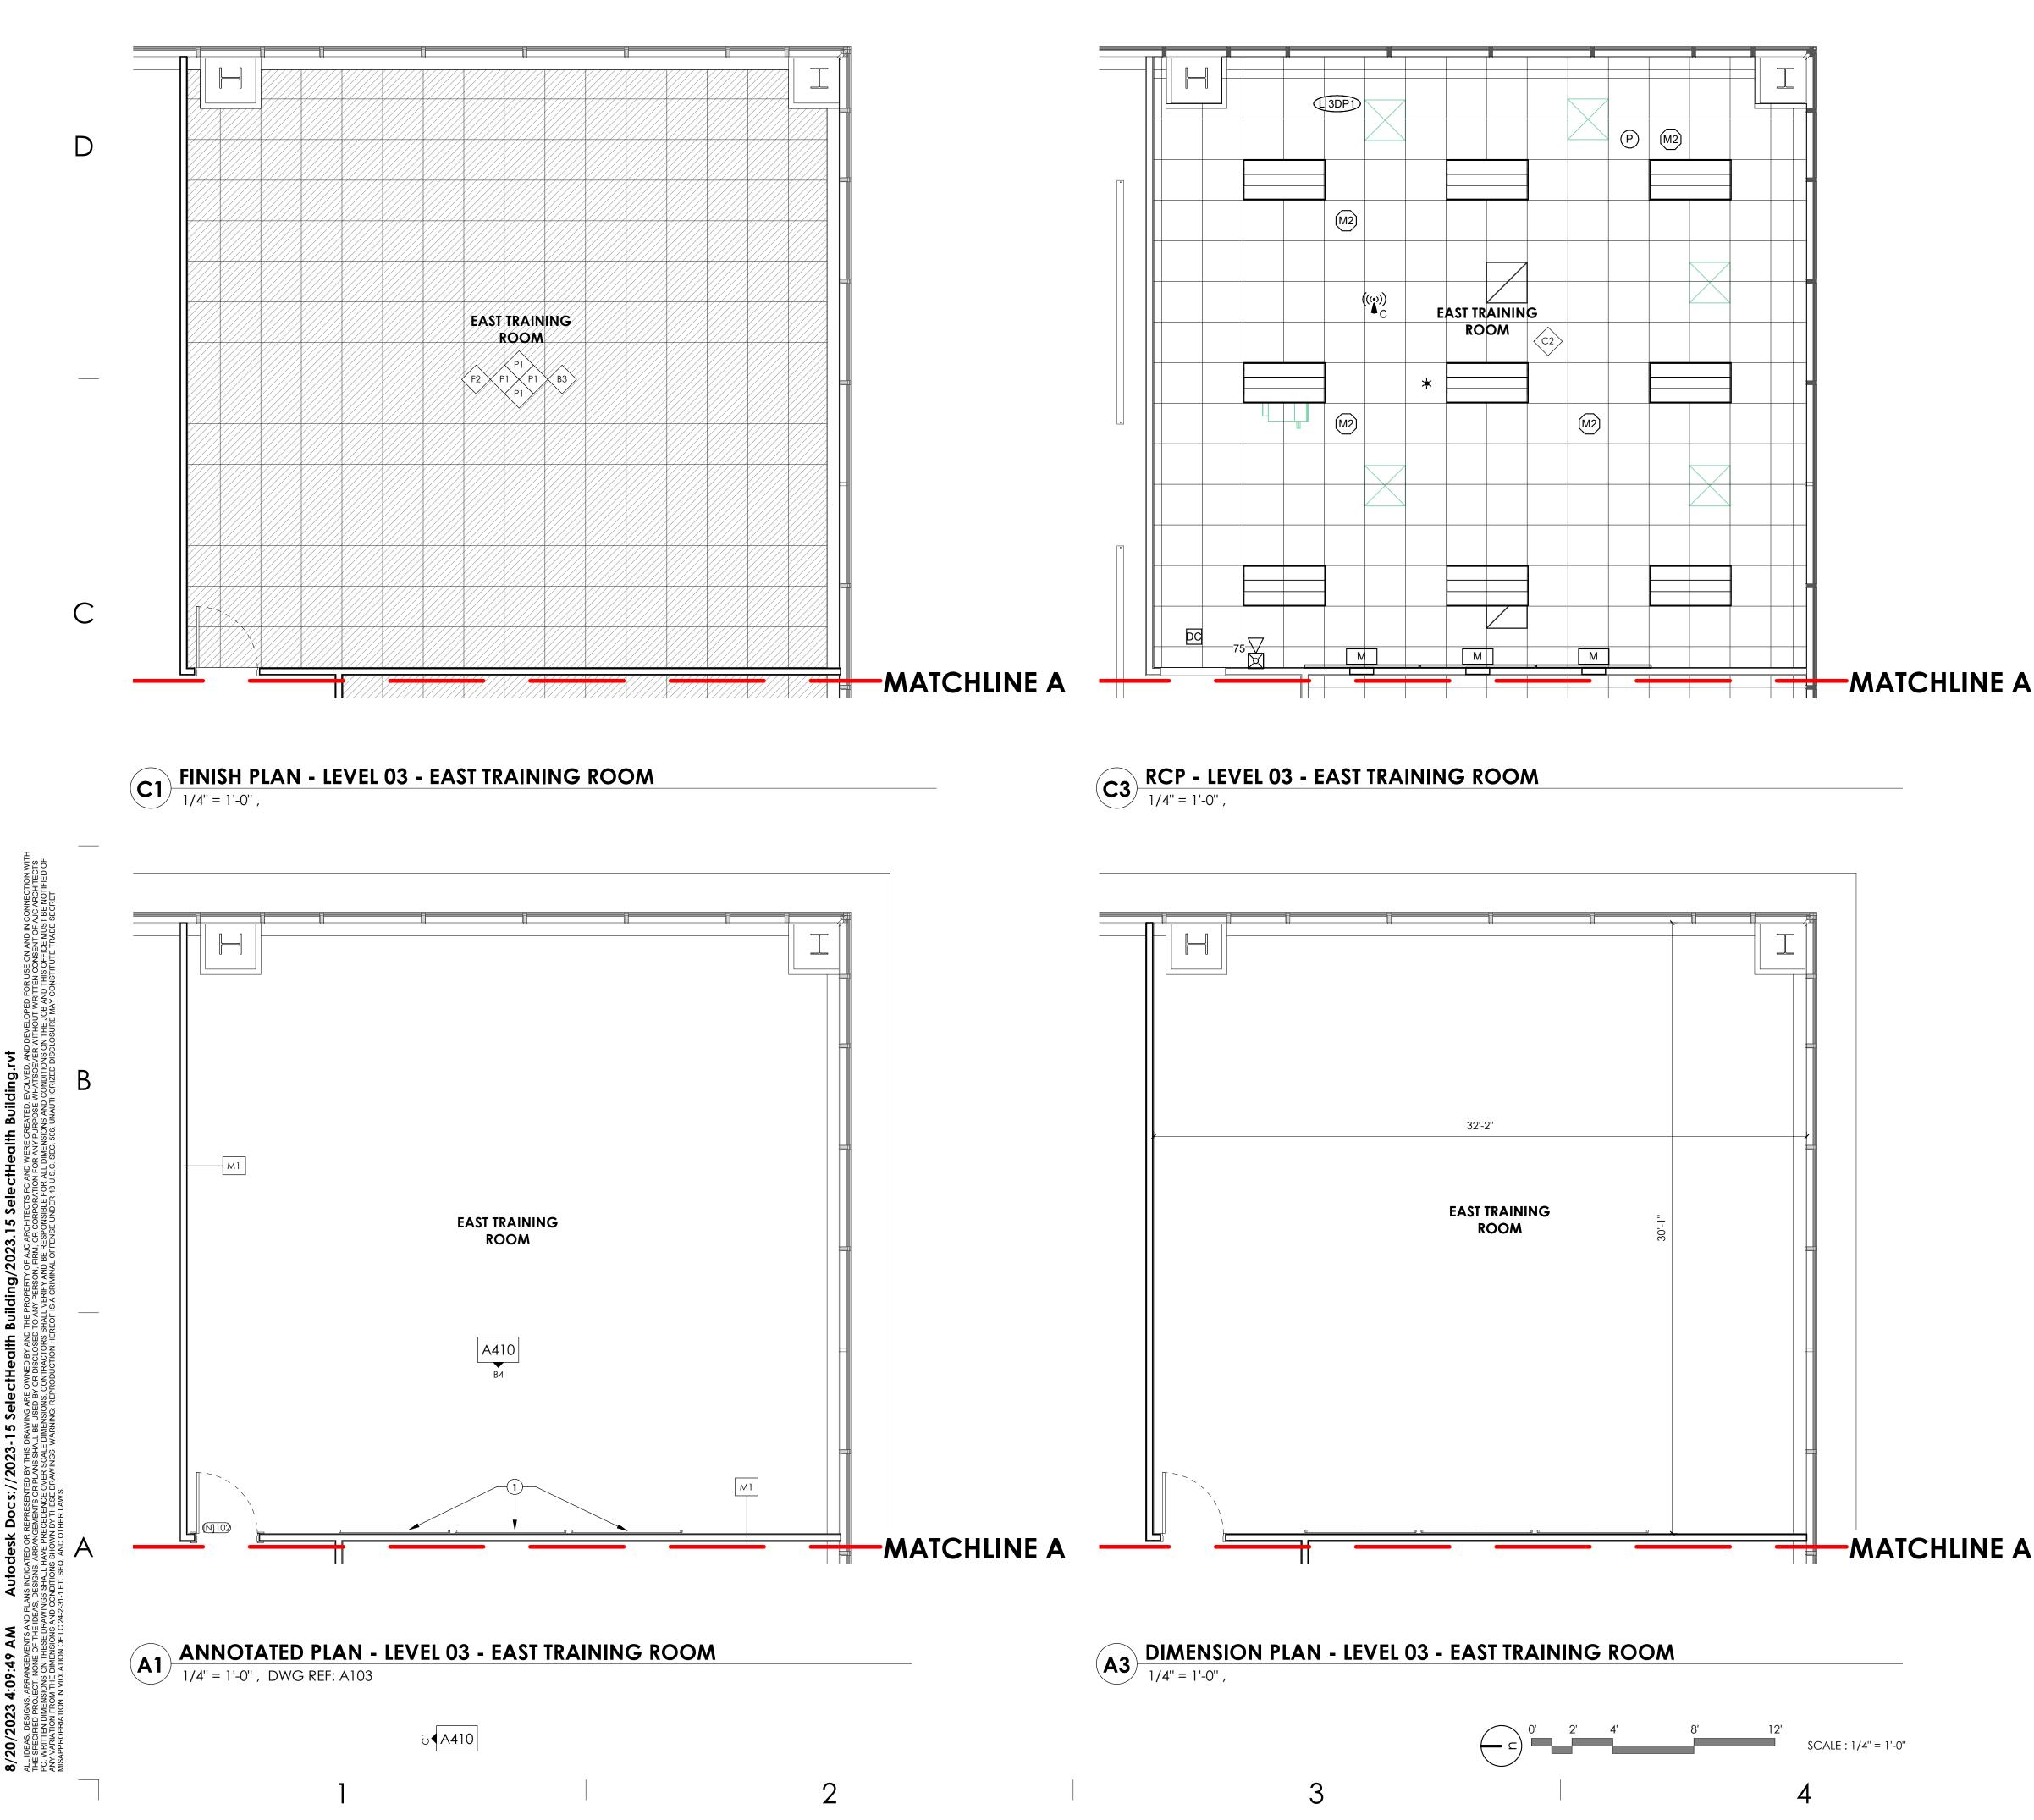

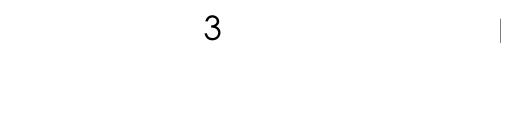

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GENERAL NO					
SEE SHEET GOO1 FOR DRAWING		) TES AND ABBREVIATIO	ONS.	ajc archite	
DO NOT SCALE DRAWINGS.					
CONTRACTOR / SUBCONTRAC BEFORE BEGINNING WORK, AN INCONSISTENCIES OR OMISSIC SPECIFICATIONS.	ND SHALL REPORT TO T	THE ARCHITECT ANY E	RRORS,	703 east 1700 so salt lake city, ut 84 ajcarchitects.c	4105
REFLECTED C	CEILING	PLAN			
THIS IS A REFLECTED CEILING P PLAN. NO WALL MOUNTED LIG APPURTENANCES ARE SHOWN SIGNS, SIZE AND TYPES OF ELEC CEILING MOUNTED DIFFUSERS, SYMBOL LEGEND	GHTING FIXTURES OR C . SEE THE LIGHTING PL. CTRICAL FIXTURES ETC	OTHER WALL MOUNTE AN FOR ALL LIGHTINC	d G and egress		
SURFACE MOUNTED OR LAY-IN FLUORESCENT FIXTURE. SEE ELE					
PLAN FOR SIZE AND TYPE.					
TYPE.					
PLAN.			*	ARCHITECT / COI	NSULTANT
LIFE SAFETY DEVICES. SEE ELEC PLAN.	TRICAL	EXIT SIGN	S SMOKE DETECTOR		
LIFE SAFETY DEVICES. SEE ELEC PLAN.	TRICAL		FIRE HORN	A GTATE	OF UTAK
AUDIO/VISUAL EQUIPMENT. COORDINATE LOCATION W/ E & OWNER.	ELECTRICAL	Û DUAL SIDEI CAMERA		8	STIN K.
SUPPLY, RETURN & EXHAUST DIFFUSERS/GRILLES. SEE MECH,	ANICAL.			7.4	252-0301 / - 17 2023
FINISH NOTE	ES				A CONTRACT
do not scale drawings.				PROJECT DESCRI	PTION
CONTRACTOR / SUBCONTRAC BEFORE BEGINNING WORK, AI INCONSISTENCIES OR OMISSIC SPECIFICATIONS.	ND SHALL REPORT TO	THE ARCHITECT ANY E	ERRORS,	SELECTHEAL TENANT IMP	
FIELD VERIFY ALL DIMENSIONS					
PROVIDE A SMOOTH TRANSITI	es at same level, des	Spite differences in	THICKNESS.	5381 S GREEN STR MURRAY, UT 8412	
ALL GYP. BD. CEILINGS SHALL EXPOSED GYP. BD. CEILINGS S	SHALL BE PAINTED - RE	FER TO FINISH PLANS,		MUKKAT, UI 0412	
CEILING PLANS, & FINISH LEGE ALL EXPOSED NON CONCRETE			IACENT WALLS.		
EXPOSED METAL HANDRAILS, ( STAIR STRUCTURE, DUCTWORK BE PAINTED.					
RATED WALL CONDITIONS SHA RATED AND NON-RATED, SHAL				Sheet Name:	
PROVIDE SOLID BLOCKING/BA			ORIES.	LEVEL 03 - F PLANS - EA	
FOR ACCESSORIES SEE SCHED MECHANICAL, PLUMBING, AN			URES WITH	TRAINING R	ROOM
WALL, FLOOR, BASE AND CEIL SHALL INDICATE THIS FINISH FO TO THE NEXT AND NOT BE TERM	OR THE ENTIRE LENGTH	I OF WALL FROM ONE			
NORTH WALL				REVISIONS	
	NW WW EW BF	— BASE		MARK DATE	DESCRIPTIO
	SW	EAST WALL			
TRANSITION STRIP —		-		_	
FLOOR FINIS	H SYMBO				
WALK-OFF CARPET TILE		F1			
CARPET TILE		F2			
REINSTALLED CARPET TIL	E	<b>F3</b>			
PORCELAIN TILE		F4			
		F5		ISSUE DATE:	08/17/2023
RUBBER TILE		*			
LVP				ISSUE TYPE: DRAWN BY:	BID SET J. HALBERT

SHEET NUMBER:

A119



# **FINISH NOTES**

DO NOT SCALE DRAWINGS.

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CONTRACTOR / SUBCONTRACTOR SHALL VERIFY ALL DIMENSIONS AND CONDITIONS BEFORE BEGINNING WORK, AND SHALL REPORT TO THE ARCHITECT ANY ERRORS, INCONSISTENCIES OR OMISSIONS BEFORE BEGINNING WORK. SEE GENERAL NOTES AND SPECIFICATIONS.

FIELD VERIFY ALL DIMENSIONS BEFORE FABRICATION OF MILLWORK.

PROVIDE A SMOOTH TRANSITION AT ALL CHANGES IN FLOOR MATERIAL - CONTRACTOR TO INSTALL ALL FLOOR FINISHES AT SAME LEVEL, DESPITE DIFFERENCES IN THICKNESS. ALL GYP. BD. CEILINGS SHALL BE PAINTED AS INDICATED IN FINISH LEGEND.

EXPOSED GYP. BD. CEILINGS SHALL BE PAINTED - REFER TO FINISH PLANS, REFLECTED CEILING PLANS, & FINISH LEGEND FOR PAINT COLOR.

ALL EXPOSED NON CONCRETE COLUMNS TO BE PAINTED TO MATCH ADJACENT WALLS.

EXPOSED METAL HANDRAILS, GUARDRAILS, HANDRAIL/GUARDRAIL SUPPORT SYSTEMS, STAIR STRUCTURE, DUCTWORK, CONDUIT, PIPING, ETC NOT NOTED AS STAINLESS STEEL TO BE PAINTED.

RATED WALL CONDITIONS SHALL REMAIN 5/8" TYPE-X GYP. BOARD. GYP. BOARD, BOTH RATED AND NON-RATED, SHALL BE PAINTED WHERE EXPOSED - REFER TO FINISH LEGEND.

PROVIDE SOLID BLOCKING/BACKING FOR ALL WALL MOUNTED ACCESSORIES.

FOR ALL FINISH MATERIALS SEE FINISH LEGEND ON SHEET SHEET A620.

FOR ACCESSORIES SEE SCHEDULE ON SHEET A620, COORDINATE ALL FIXTURES WITH MECHANICAL, PLUMBING, AND ELECTRICAL AS REQUIRED.

WALL, FLOOR, BASE AND CEILING KEYNOTE: THIS SYMBOL, WHEN ATTACHED TO A WALL, SHALL INDICATE THIS FINISH FOR THE ENTIRE LENGTH OF WALL FROM ONE INTERSECTION TO THE NEXT AND NOT BE TERMINATED BY WINDOWS OR DOORS, U.N.O.

NORTH WALL WEST WALL Floor

2

TRANSITION STRIP

\_\*X - \_ \_ \_ X - \_ \_ \_ X - \_ \_ X  $\langle P1 \rangle P1 \rangle B3 \rangle$ С SOUTH TRAINING ROOMA F2 
 P1 
 P1 
 B3
 B3 N.I.C. F3 🗙 P1 🗙 P1 🗙 B3 F6 В SOUTH TRAINING ROOM B F2 P1 P1 B3 N.I.C. A1 FINISH PLAN - LEVEL 03 - SOUTH TRAINING ROOMS 1/4'' = 1'-0'',

AND ALL

# 3

# FLOOR FINISH SYMBOLS

BASE	
— EAST WALL	

WALK-OFF CARPET TILE
CARPET TILE
REINSTALLED CARPET TILE
PORCELAIN TILE
RUBBER TILE
LVP

F1	
F2	
F3	
F4	
F5	
<b>F6</b>	

# **REFLECTED CEILING PLAN**

THIS IS A REFLECTED CEILING PLAN AND IS NOT TO BE INTENDED TO BE A LIGHTING PLAN. NO WALL MOUNTED LIGHTING FIXTURES OR OTHER WALL MOUNTED APPURTENANCES ARE SHOWN. SEE THE LIGHTING PLAN FOR ALL LIGHTING AND EGRESS SIGNS, SIZE AND TYPES OF ELECTRICAL FIXTURES ETC. SEE MECHANICAL PLANS FOR ALL CEILING MOUNTED DIFFUSERS/GRILLES ETC.

### SYMBOL LEGEND

SURFACE MOUNTED OR LAY-IN CEILING FLUORESCENT FIXTURE. SEE ELECTRICAL PLAN FOR SIZE AND TYPE.

LINEAR SUSPENDED LIGHTING FIXTURE. SEE ELECTRICAL PLAN FOR SIZE AND TYPE.


OCCUPANCY SENSOR. SEE ELECTRICAL PLAN.


LIFE SAFETY DEVICES. SEE ELECTRICAL PLAN.

LIFE SAFETY DEVICES. SEE ELECTRICAL PLAN.

AUDIO/VISUAL EQUIPMENT. COORDINATE LOCATION W/ ELECTRICAL & OWNER.

SUPPLY, RETURN & EXHAUST DIFFUSERS/GRILLES. SEE MECHANICAL.

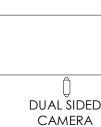

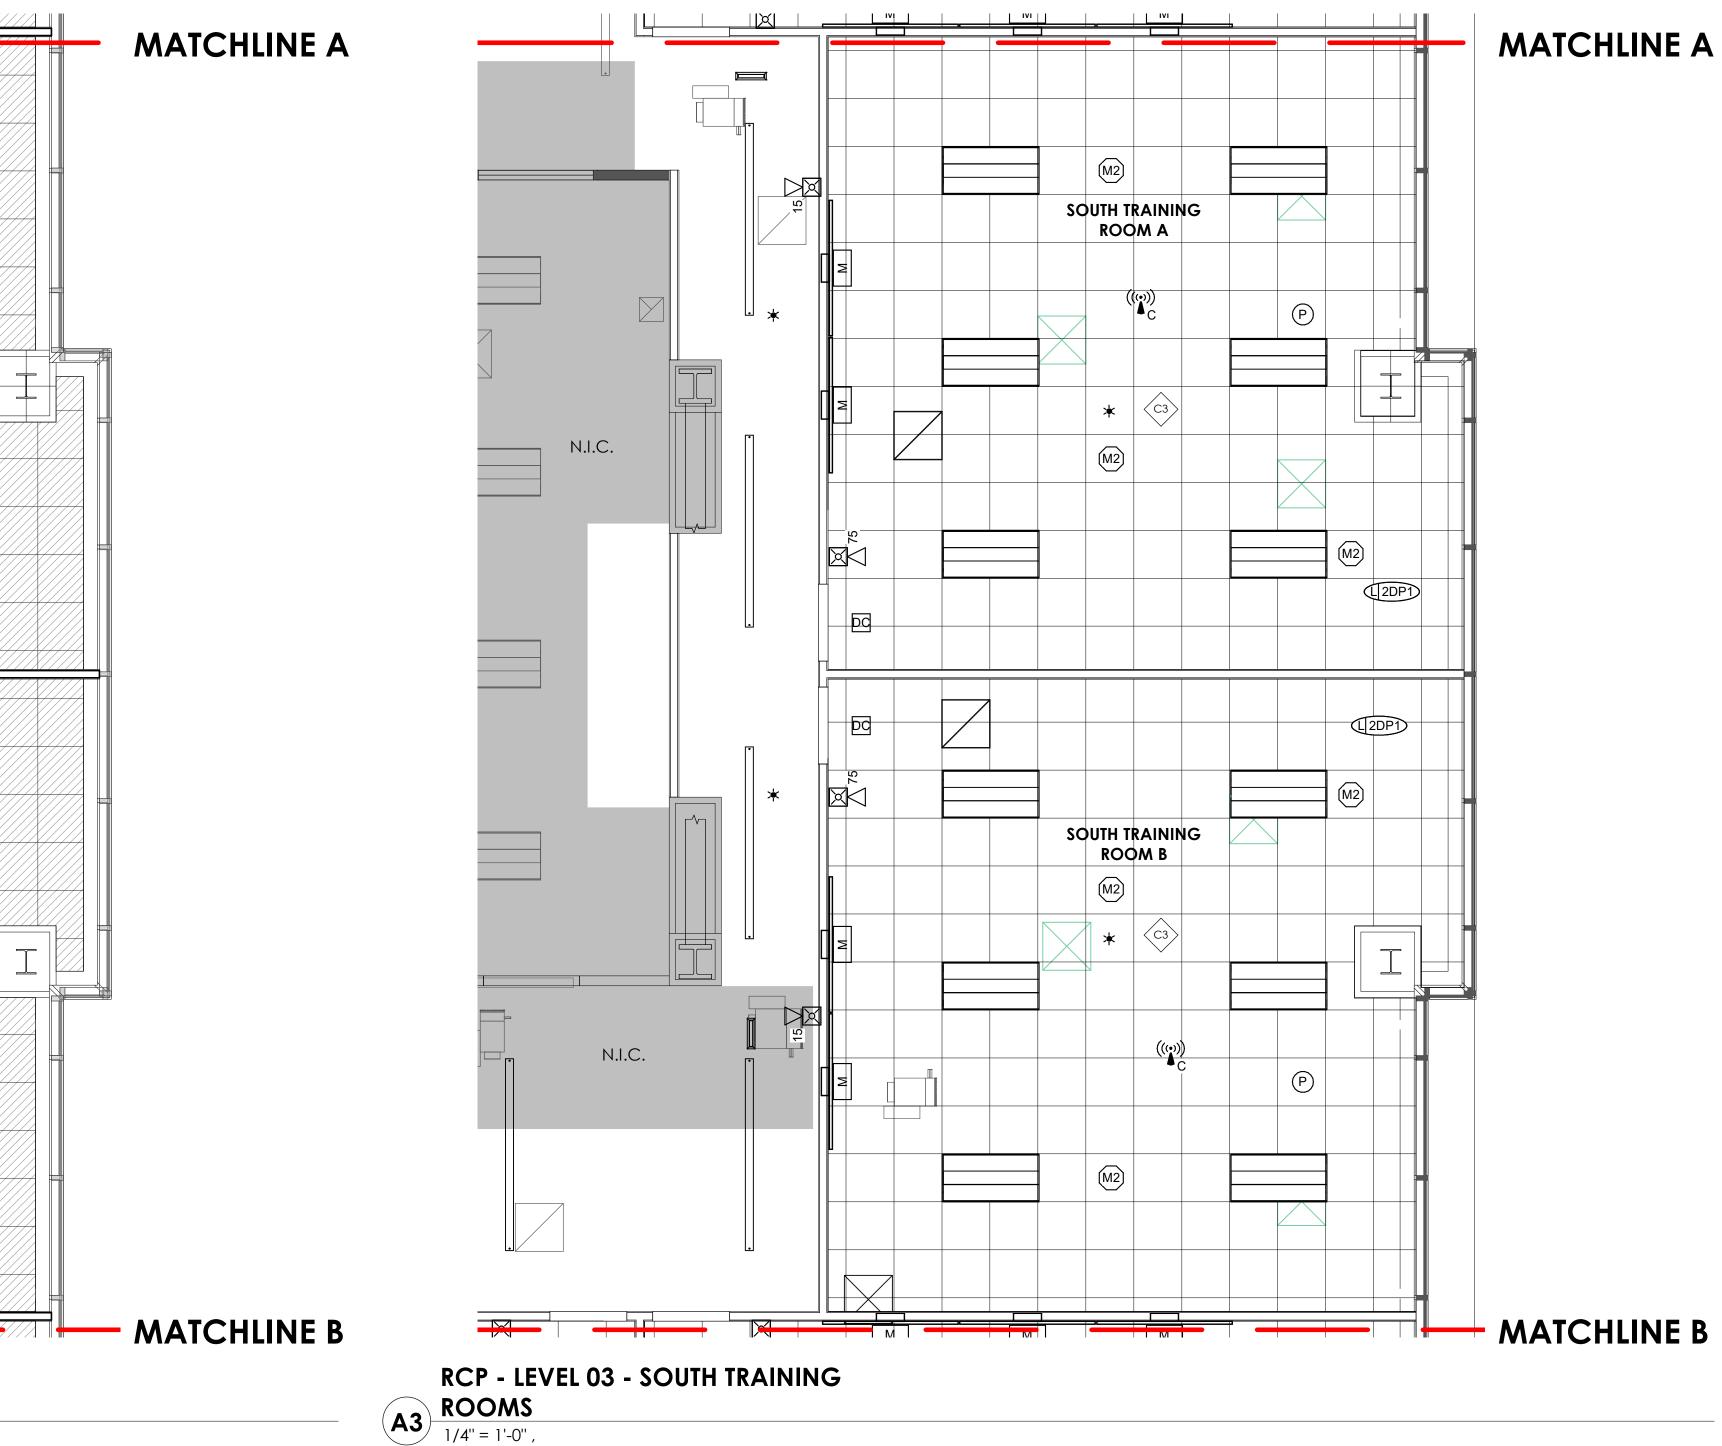

3

# **GENERAL NOTES:** SEE SHEET G001 FOR DRAWING INDEX.

SEE SHEET AG000 FOR GENERAL ARCHITECTURAL NOTES AND ABBREVIATIONS. DO NOT SCALE DRAWINGS.

CONTRACTOR / SUBCONTRACTOR SHALL VERIFY ALL DIMENSIONS AND CONDITIONS BEFORE BEGINNING WORK, AND SHALL REPORT TO THE ARCHITECT ANY ERRORS, INCONSISTENCIES OR OMISSIONS BEFORE BEGINNING WORK. SEE GENERAL NOTES AND SPECIFICATIONS.

ajc architects 🕂

703 east 1700 south salt lake city, ut 84105 ajcarchitects.com

ARCHITECT / CONSULTANT



PROJECT DESCRIPTION

# SELECTHEALTH BUILDING TENANT IMPROVEMENT

5381 S GREEN STREET MURRAY, UT 84123

SHEET NAME:

# LEVEL 03 - FINISH PLAN & RCP - SOUTH **TRAINING ROOMS**

REVISIONS MARK DATE DESCRIPTION

ISSUE DATE: ISSUE TYPE: DRAWN BY: CHECKED BY: R. OLSON PROJECT#:

08/17/2023 **BID SET** J. HALBERT 2023-15

SHEET NUMBER:




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> 12' SCALE : 1/4" = 1'-0"

(S)exit sign Smoke DETECTOR  $\boxed{}$ FIRE HORN

DUAL SIDED CAMERA <u>к</u> — д I X I SUPPLY RETURN/

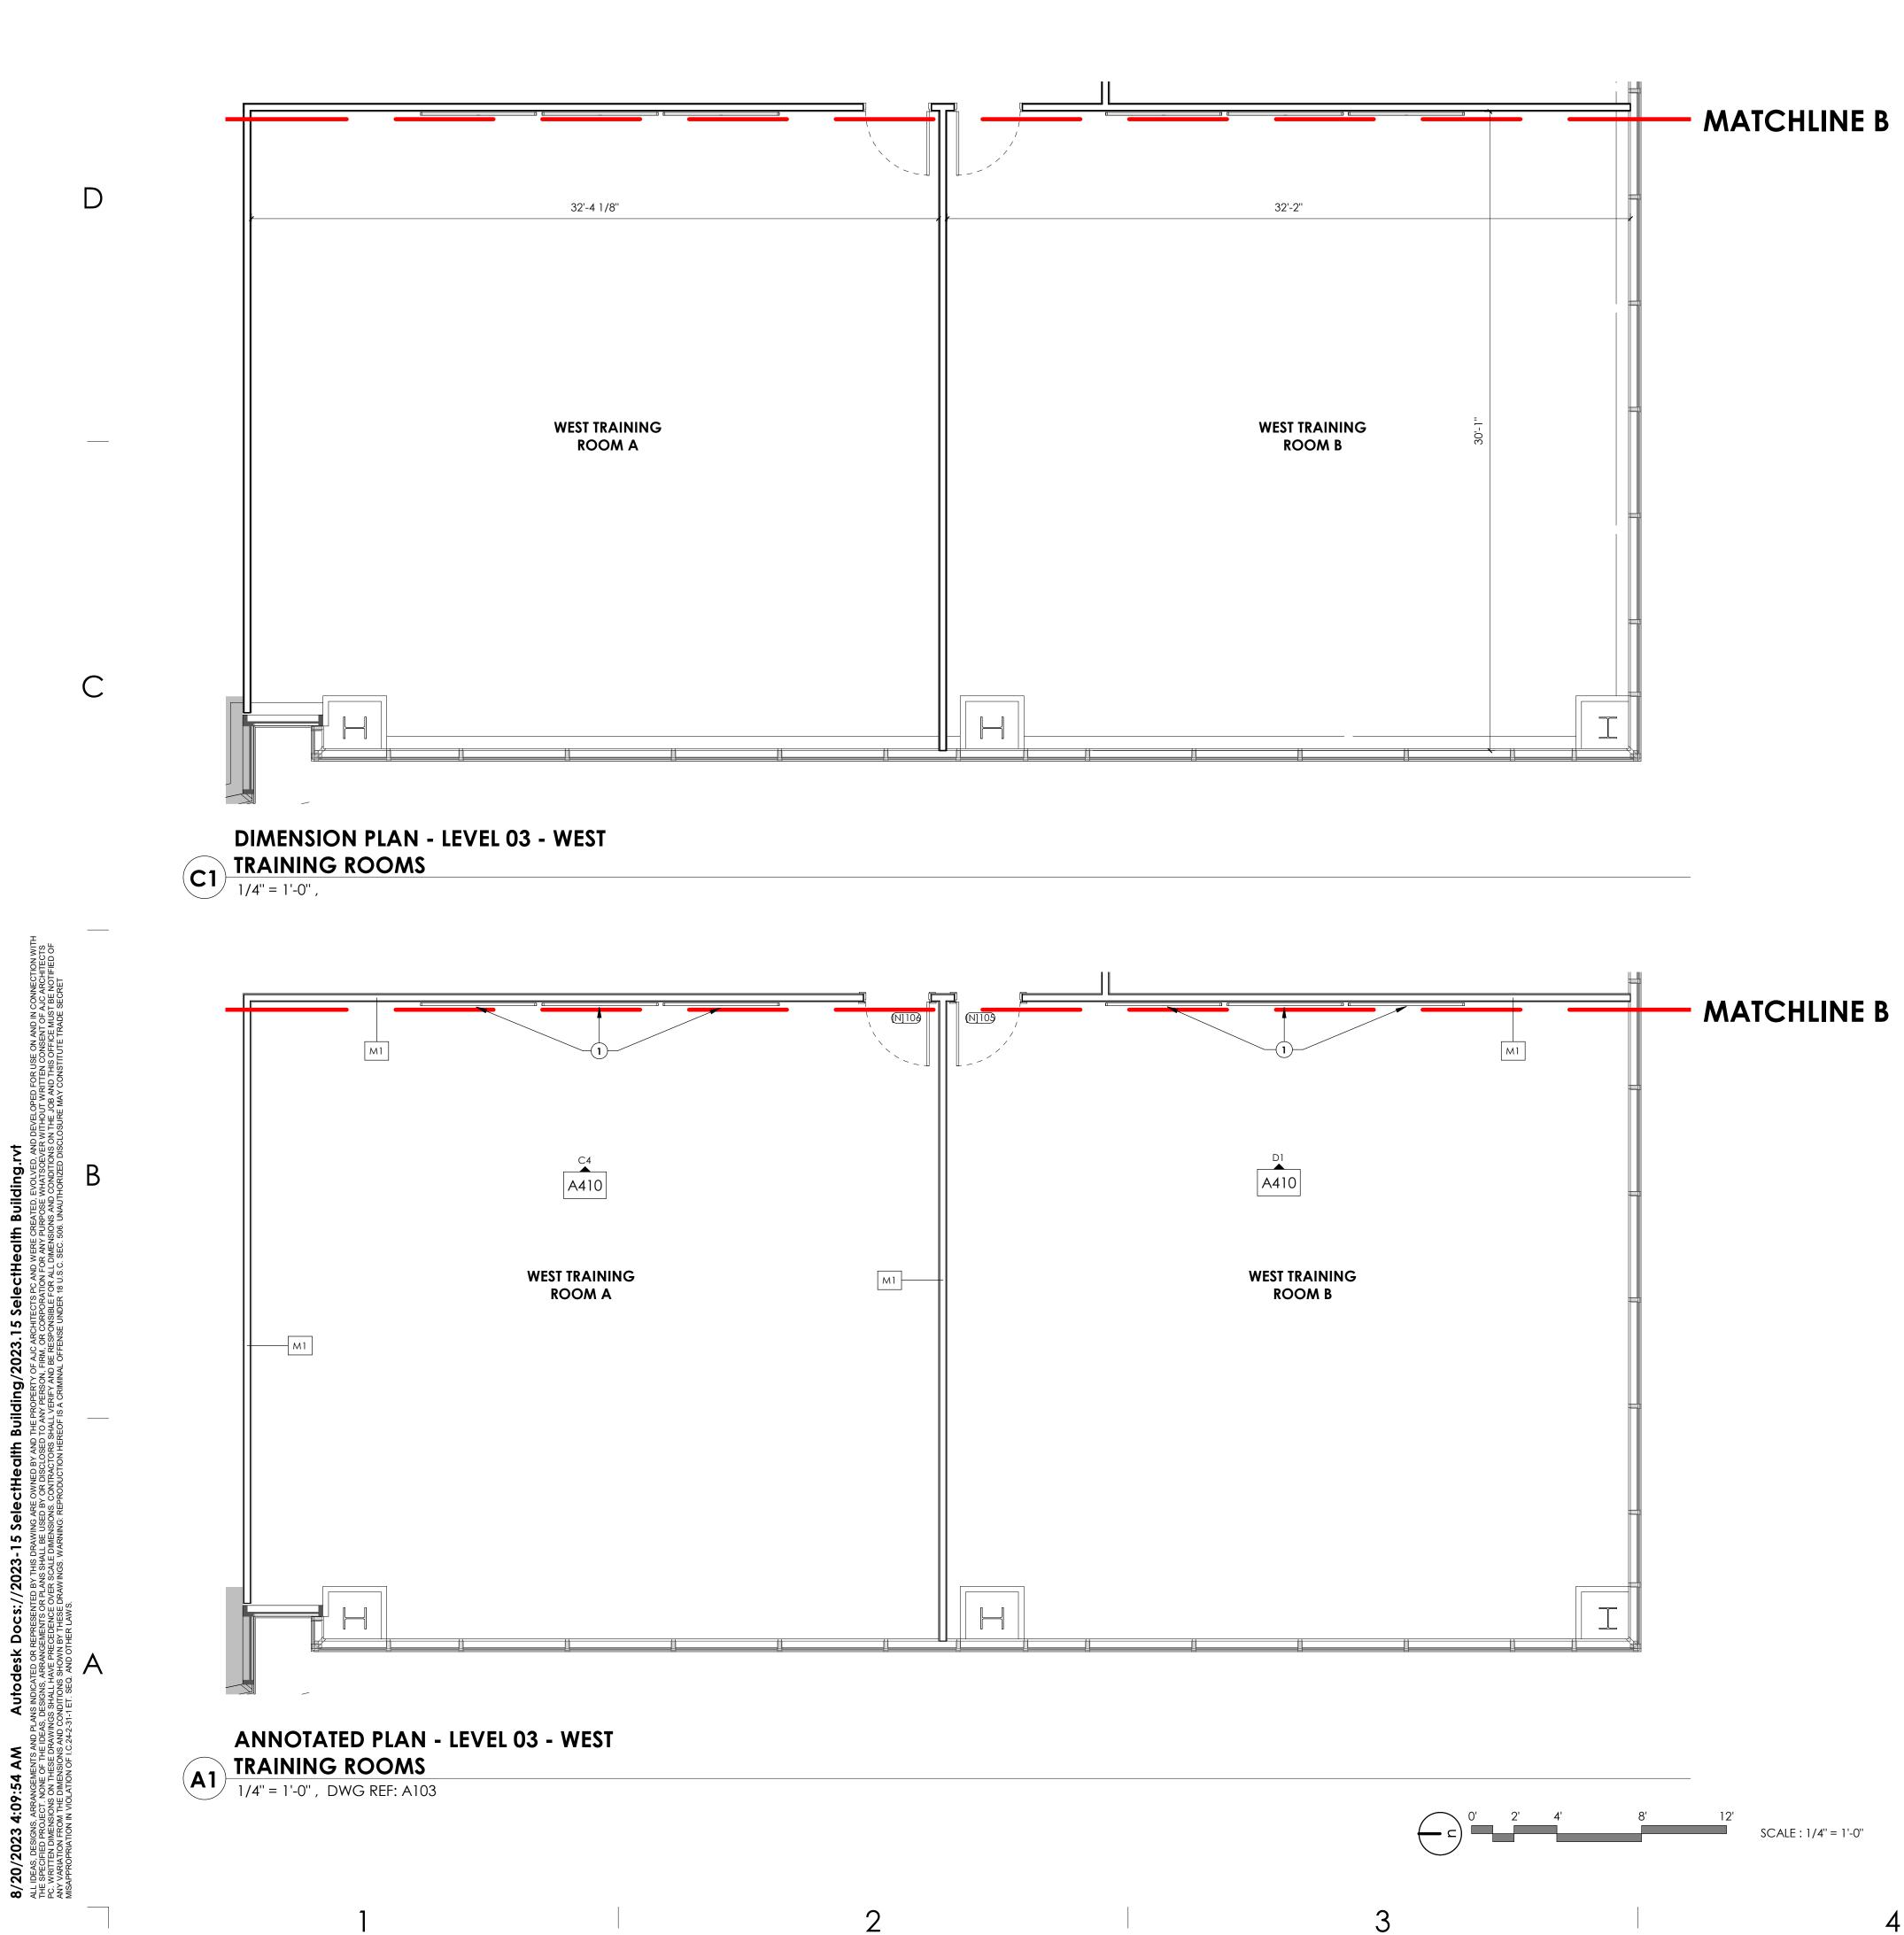

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3

# **GENERAL NOTES:**

SEE SHEET GOO1 FOR DRAWING INDEX.

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ajc architects

703 east 1700 south salt lake city, ut 84105 ajcarchitects.com

# **KEY NOTES:**

1 TV OUTLET, SEE ELECTRICAL DRAWINGS

ARCHITECT / CONSULTANT



PROJECT DESCRIPTION

### SELECTHEALTH BUILDING TENANT IMPROVEMENT

5381 S GREEN STREET MURRAY, UT 84123

Sheet name:

### LEVEL 03 - ANNOTATED & DIMENSION FLOOR PLANS - WEST TRAINING ROOMS


REVISIONS

MARK DATE DESCRIPTION


ISSUE DATE: ISSUE TYPE: DRAWN BY: CHECKED BY: R. OLSON PROJECT#: 2023-15

08/17/2023 **BID SET** J. HALBERT



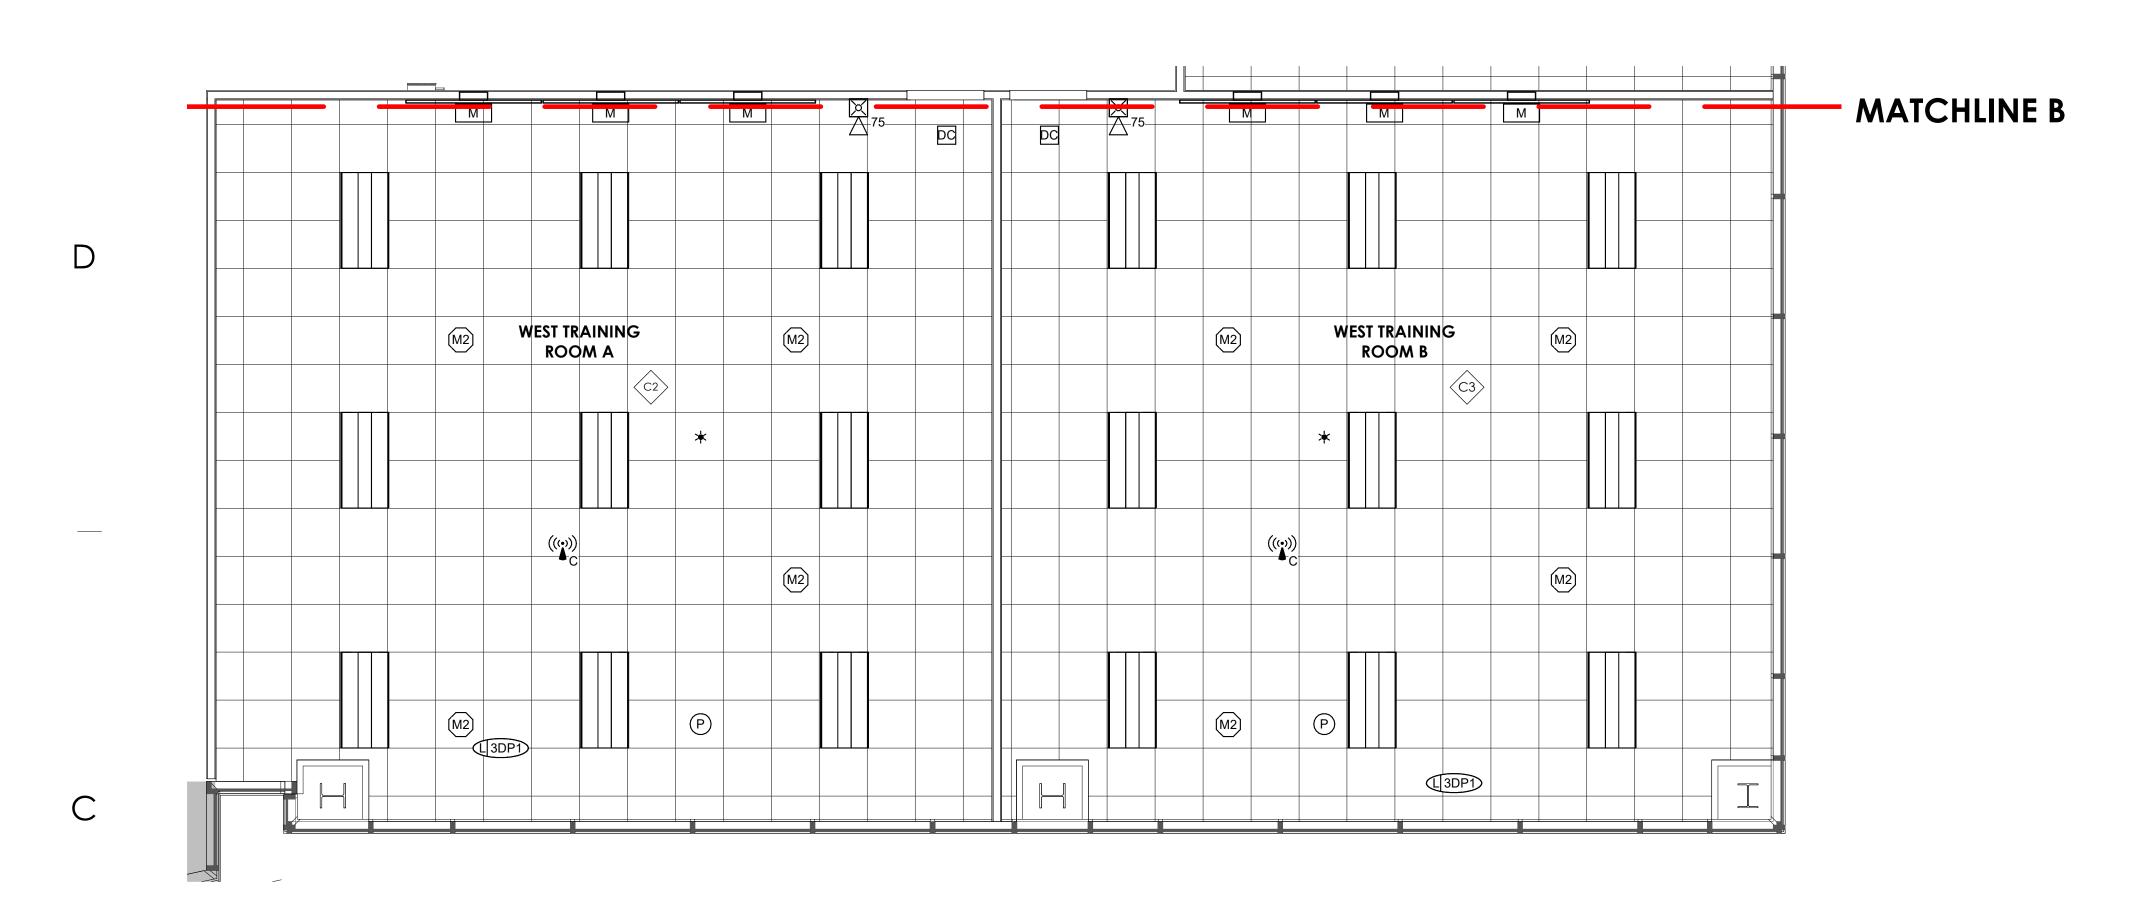

# C1 RCP - LEVEL 03 - WEST TRAINING ROOMS 1/4'' = 1'-0'',

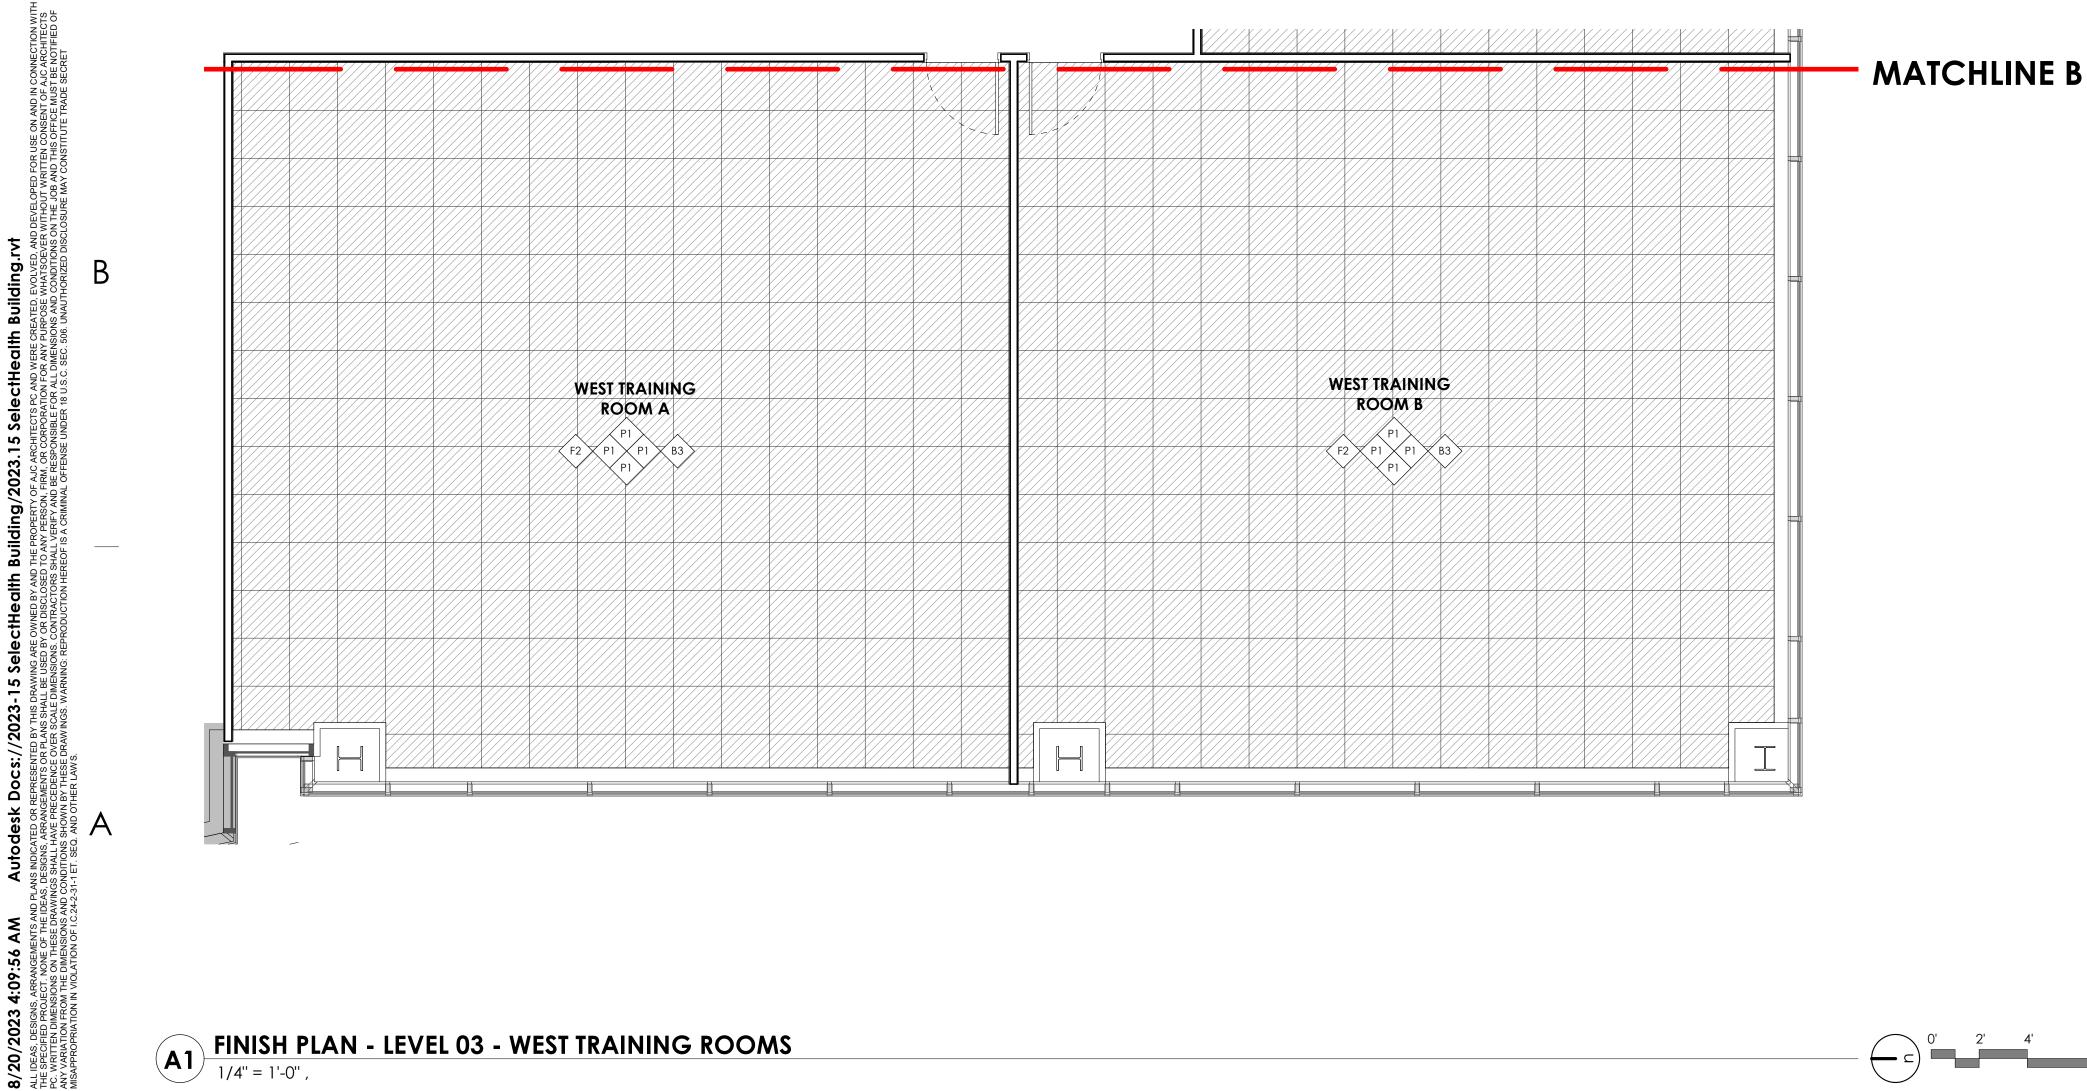

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# **GENERAL NOTES:**

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### SYMBOL LEGEND

SURFACE MOUNTED OR LAY-IN CEILING FLUORESCENT FIXTURE. SEE ELECTRICAL plan for size and type.

LINEAR SUSPENDED LIGHTING FIXTURE SEE ELECTRICAL PLAN FOR SIZE AND TYPF.

OCCUPANCY SENSOR. SEE ELECTRICAL PLAN.

LIFE SAFETY DEVICES. SEE ELECTRICAL PLAN.

LIFE SAFETY DEVICES. SEE ELECTRICAL PLAN.

AUDIO/VISUAL EQUIPMENT. COORDINATE LOCATION W/ ELECTRICAL

& OWNER. SUPPLY, RETURN & EXHAUST DIFFUSERS/GRILLES. SEE MECHANICAL

# **FINISH NOTES**

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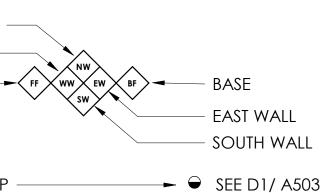
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NORTH WALL WEST WAL FLOOR



-	BASE
_	EAST WALL
_	South Wall

TRANSITION STRIP

FLOOR FINISH SYMBOLS

F1 WALK-OFF CARPET TILE CARPET TILE REINSTALLED CARPET TILE **F3** F4 PORCELAIN TILE RUBBER TILE <br/>
<br/> **F6** LVP

ajc architects 🗗

703 east 1700 south salt lake city, ut 84105 ajcarchitects.com

ARCHITECT / CONSULTANT

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Smoke

DETECTOR

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FIRE HORN

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EXHAUST

DUAL SIDED CAMERA

SUPPLY RETURN/

CAMERA

5-7

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exit sign



PROJECT DESCRIPTION

# SELECTHEALTH BUILDING **TENANT IMPROVEMENT**

**5381 S GREEN STREET** MURRAY, UT 84123

Sheet NAME:


# LEVEL 03 - FINISH PLAN & RCP - WEST TRAINING ROOMS

REVISIONS MARK DATE DESCRIPTION

ISSUE DATE: ISSUE TYPE: DRAWN BY: CHECKED BY: R. OLSON PROJECT#:

08/17/2023 BID SET J. HALBERT 2023-15



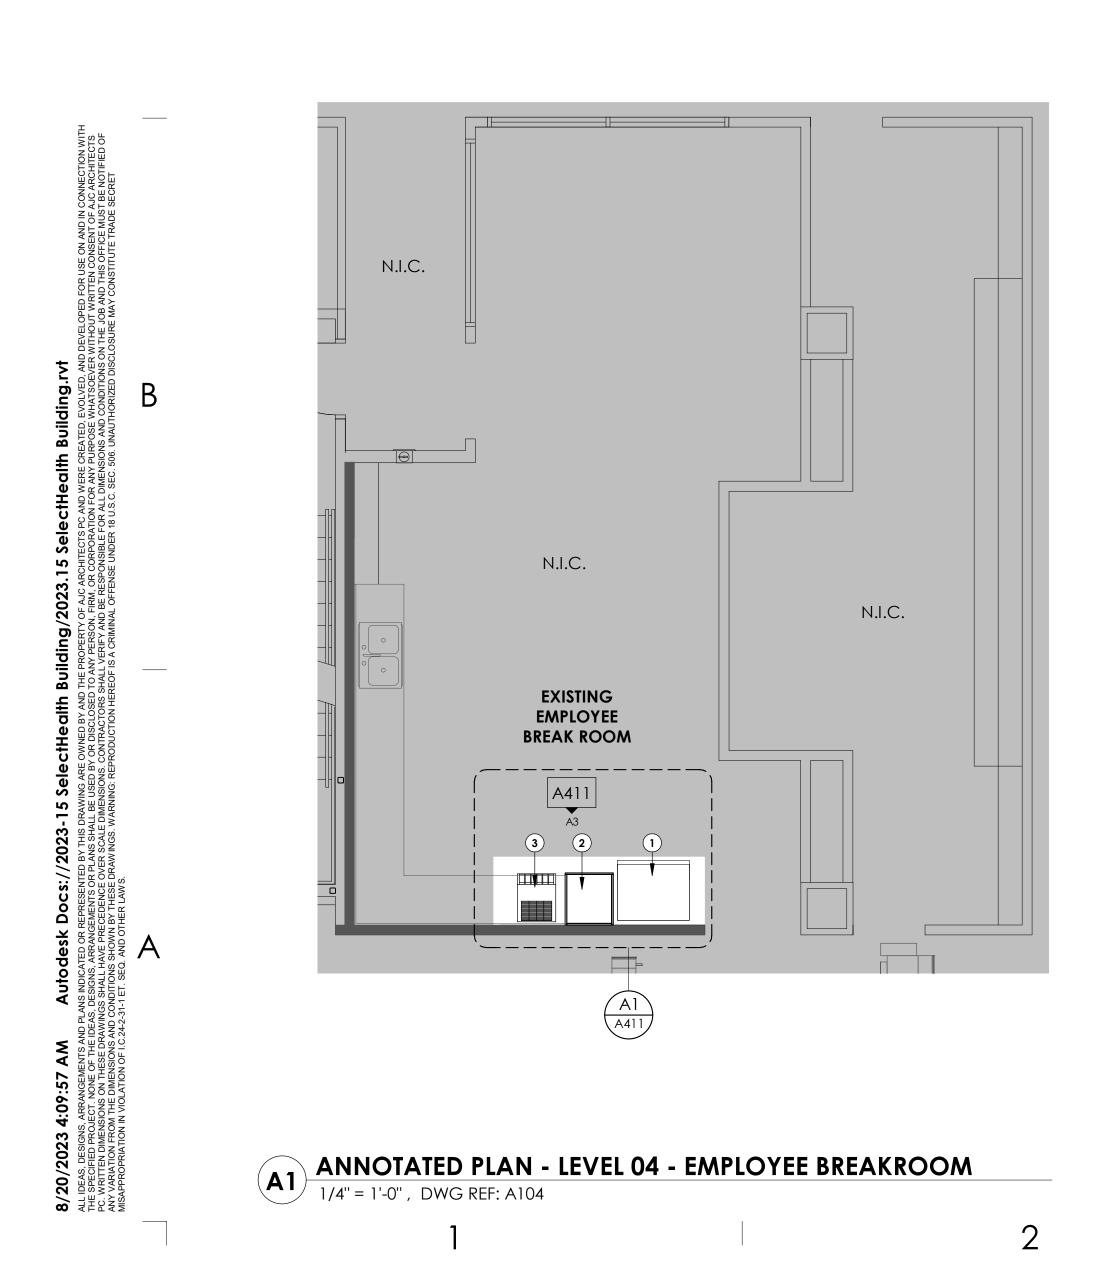


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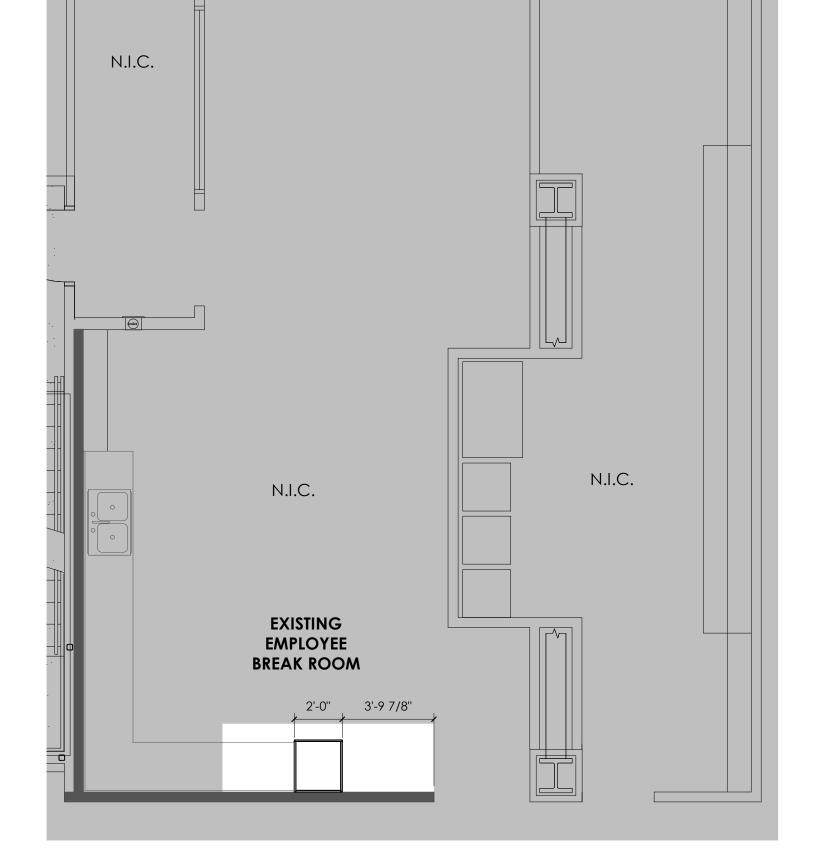
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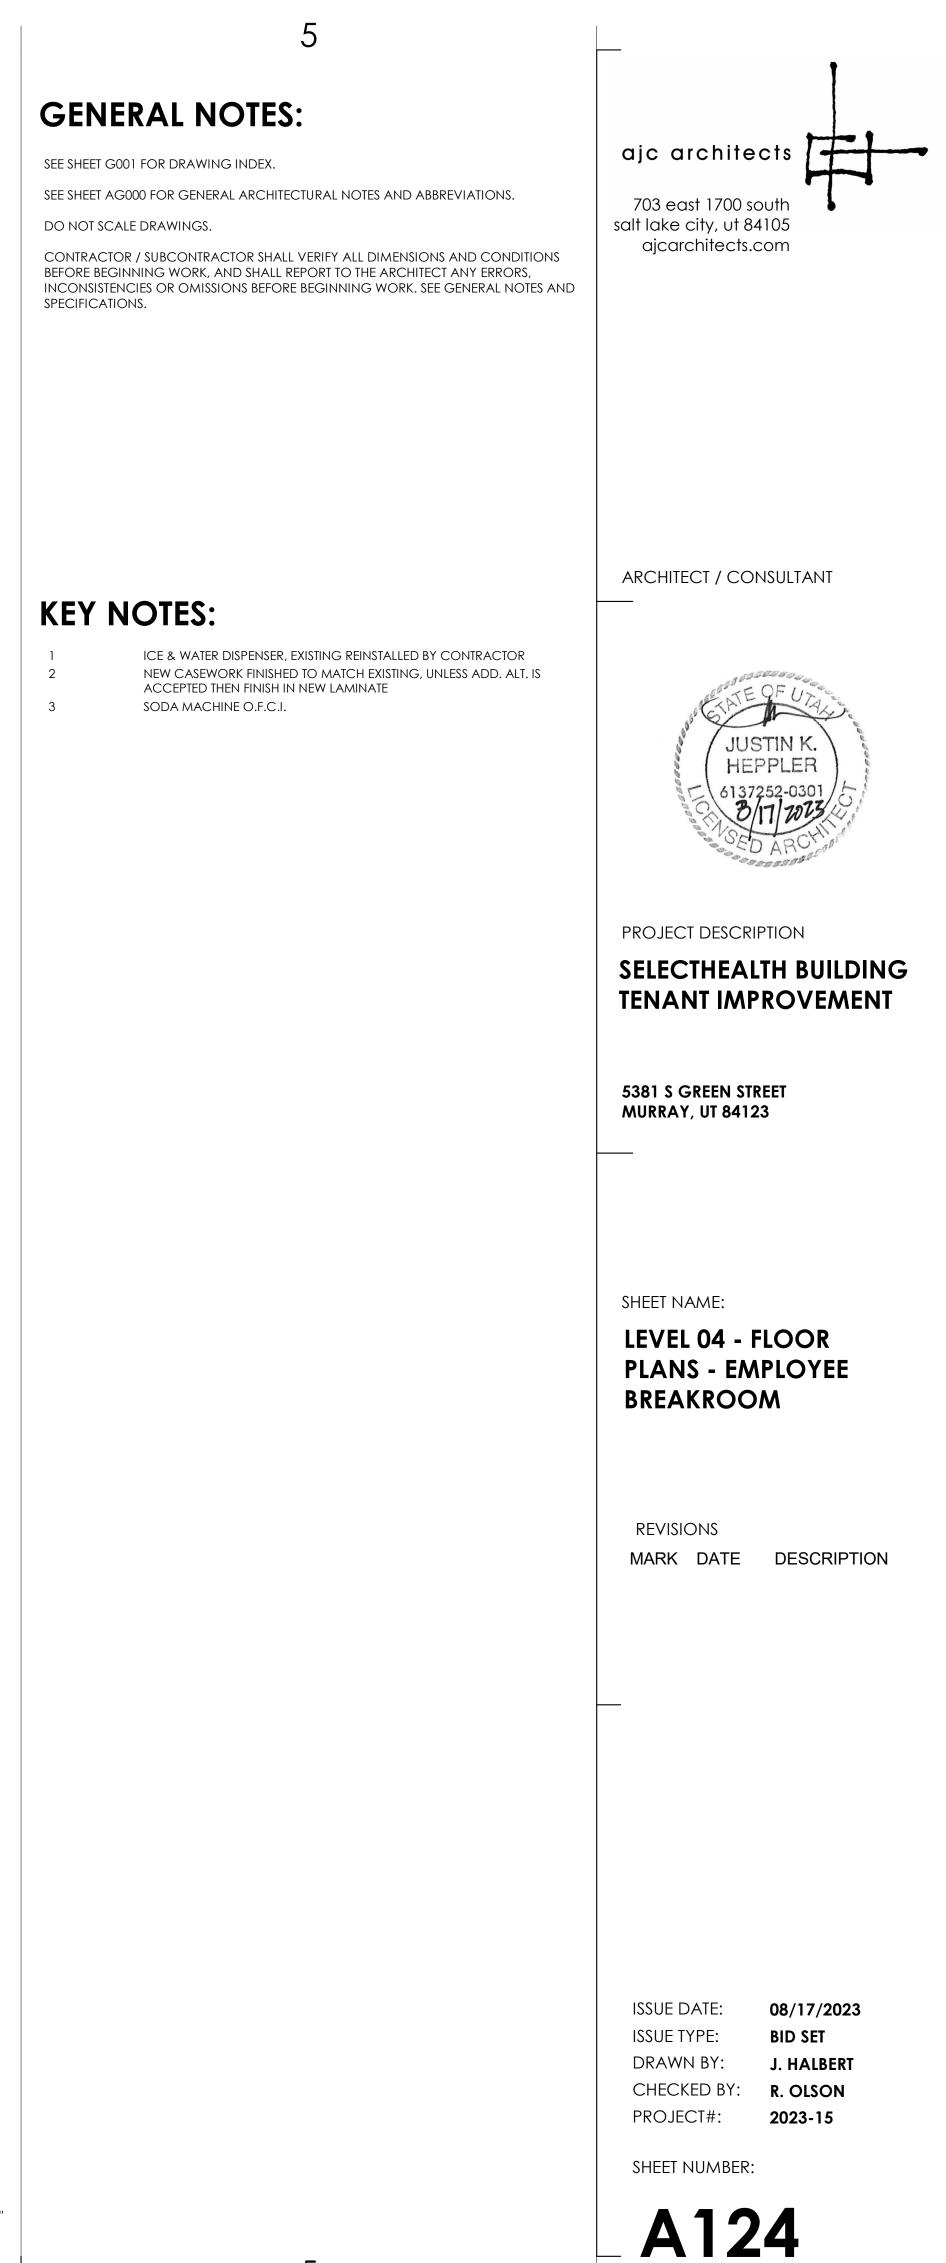
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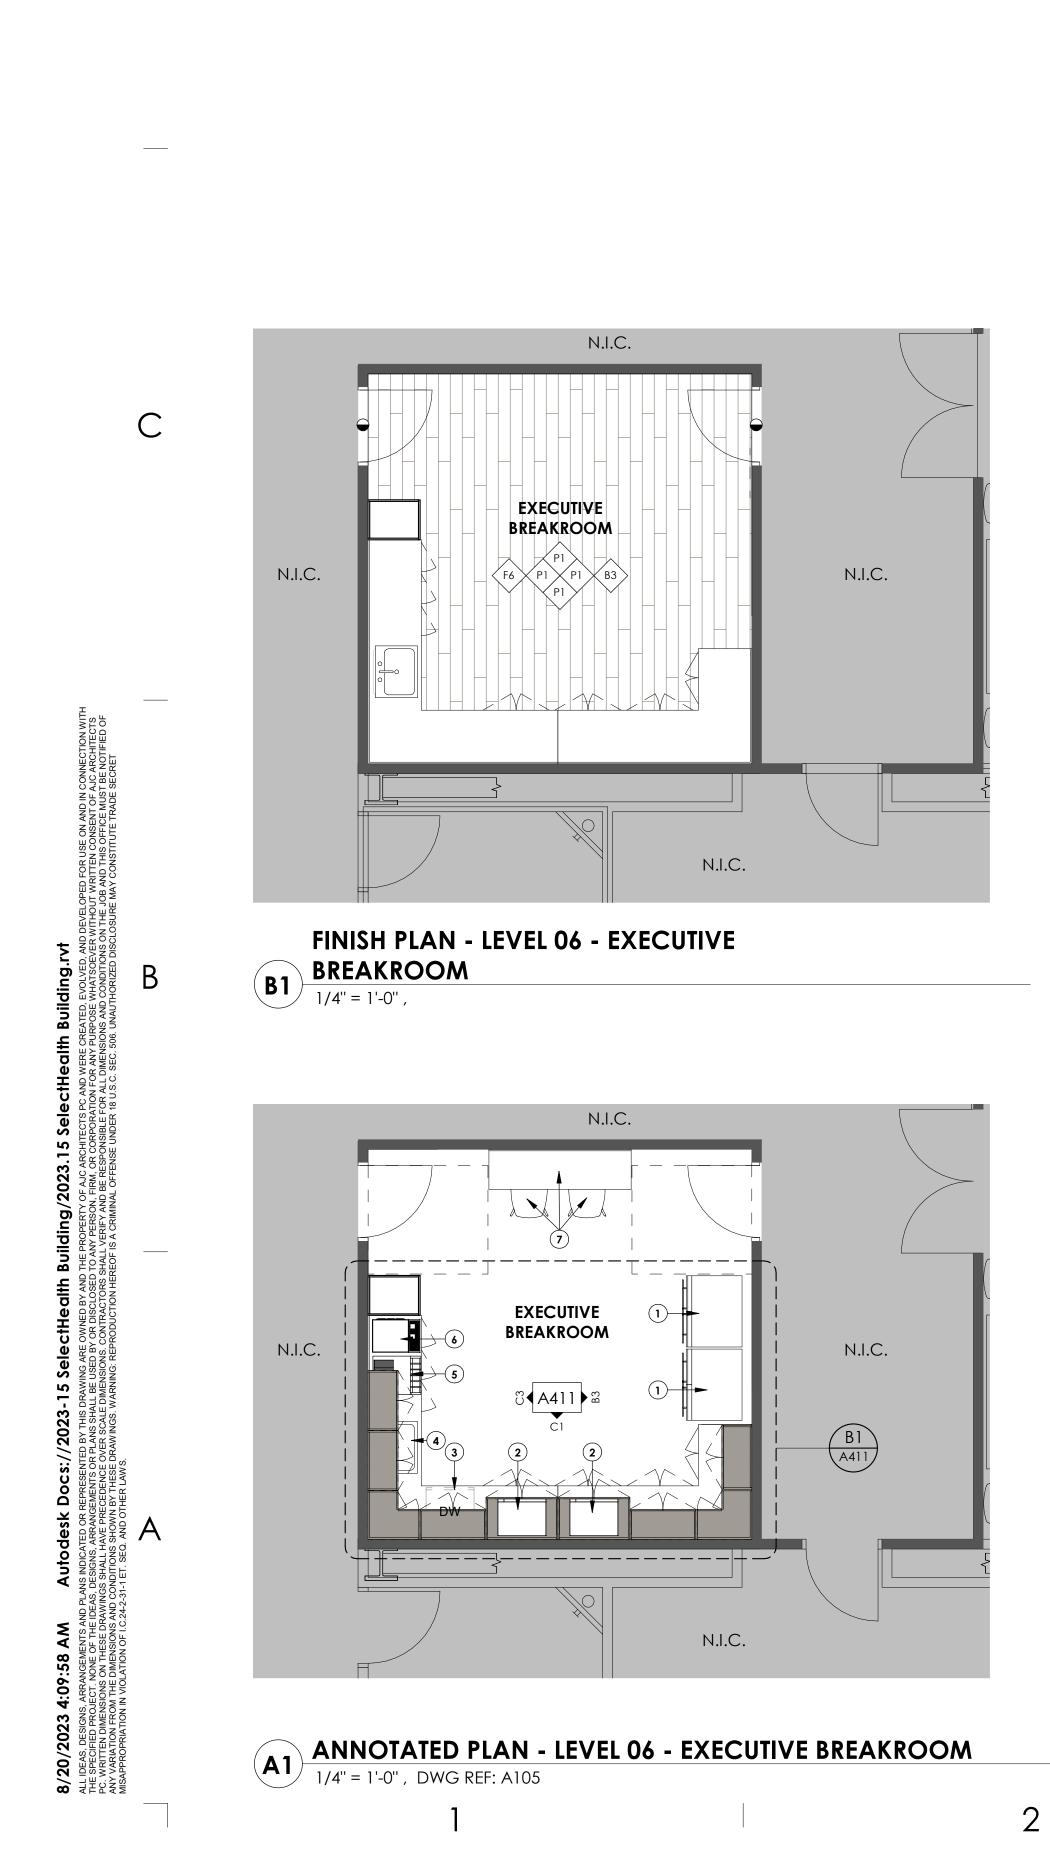
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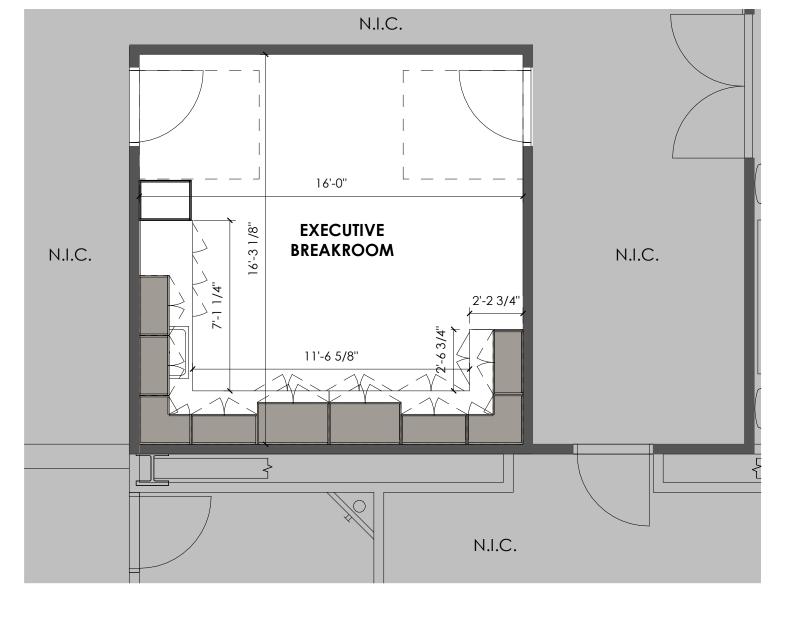










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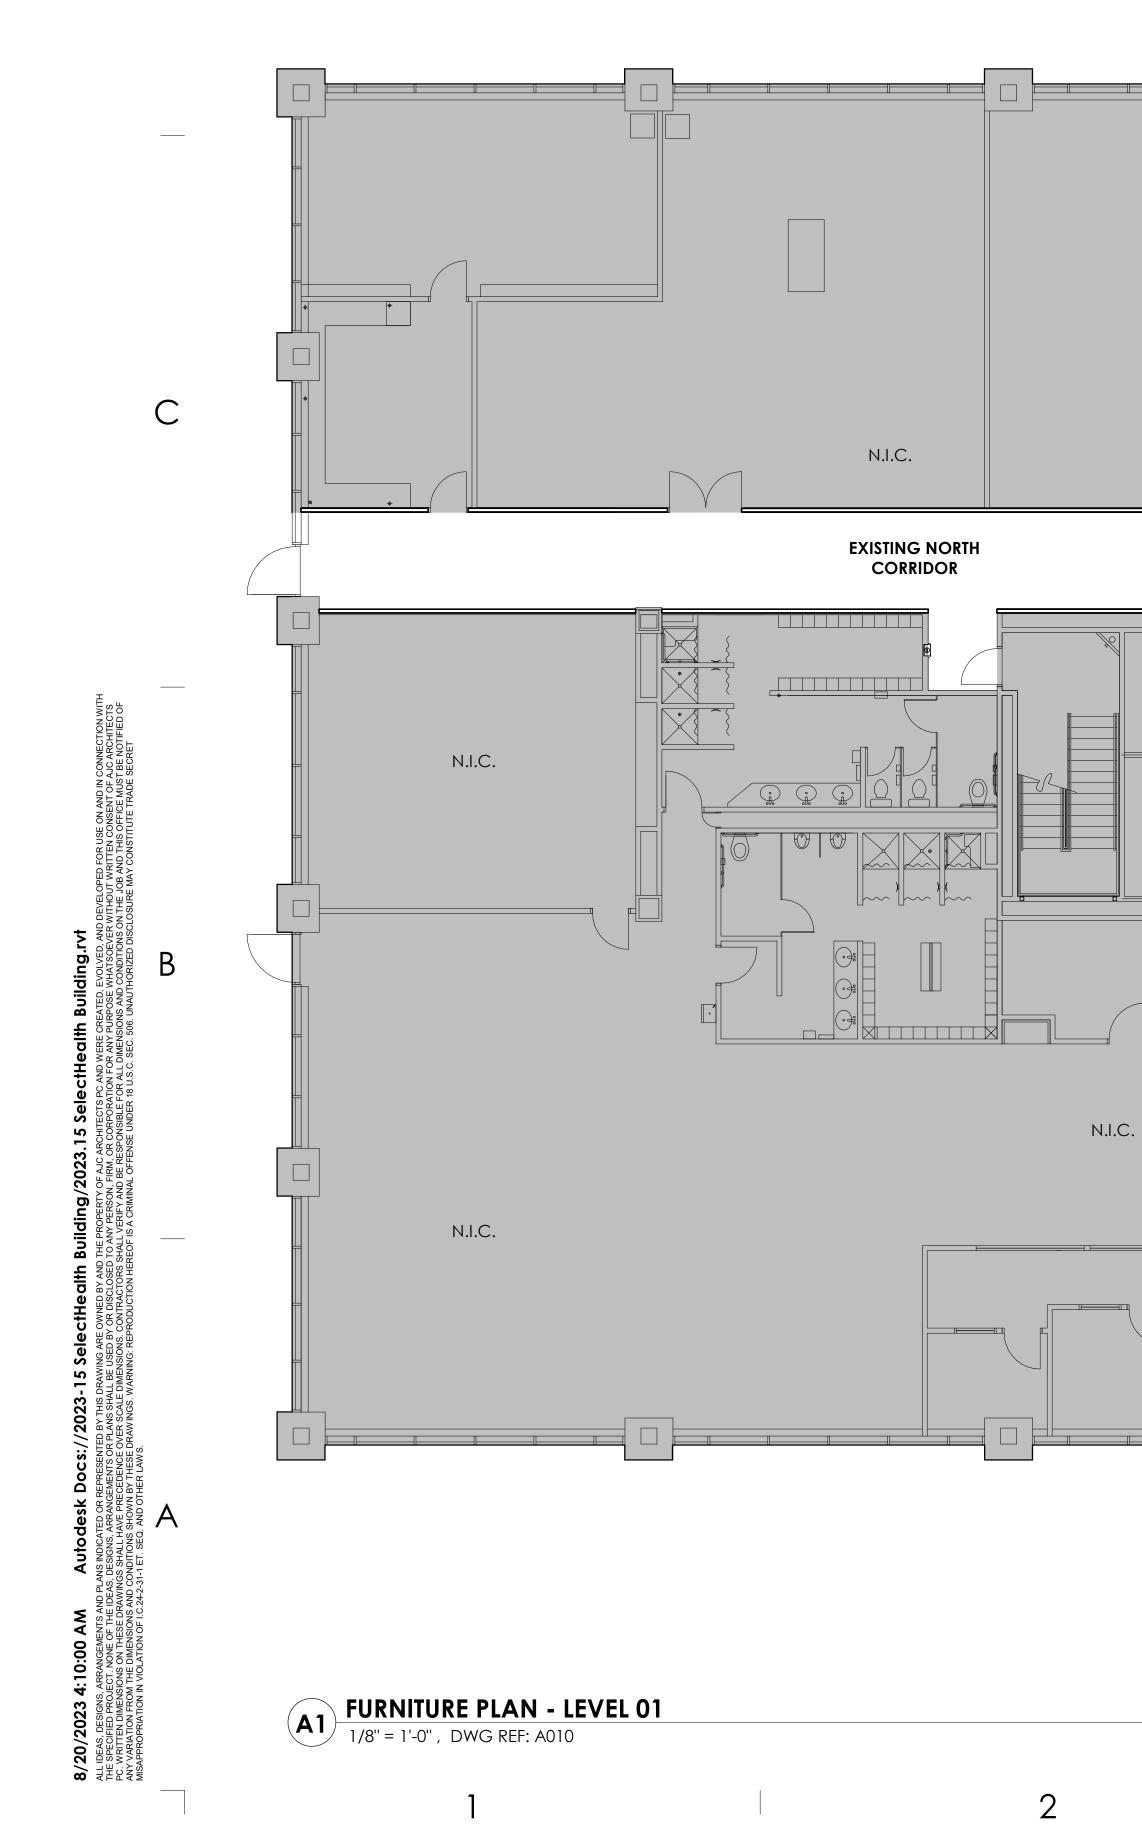
# A2 DIMENSION PLAN - LEVEL 06 - EXECUTIVE BREAKROOM

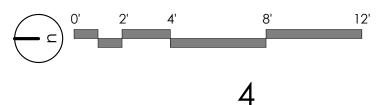


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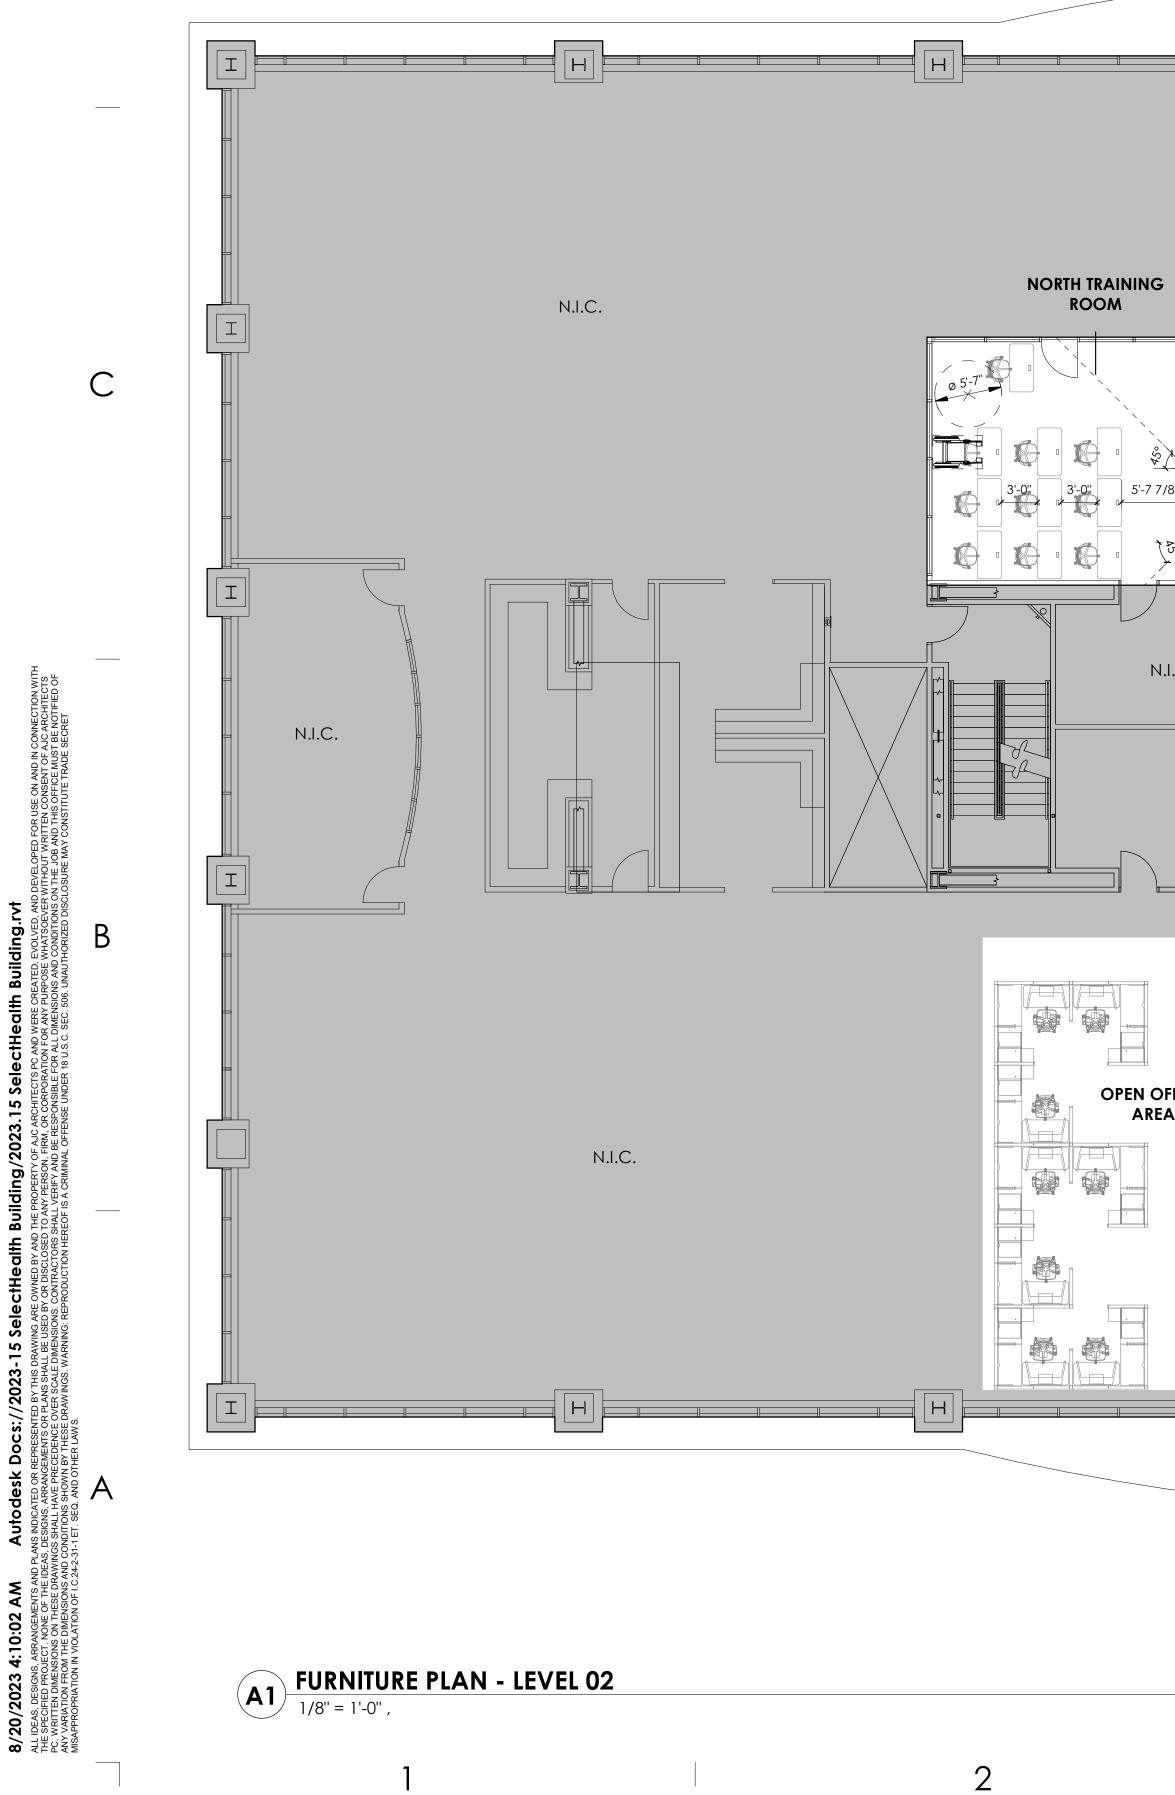

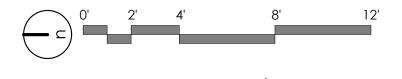
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FURNITURE NOTES: NEW FURNITURE SCOPE PROVIDED BY OTHERS

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N.I.C. OPEN OFFICE AREA N.I.C. SOUTH TRAINING ROOM \_\_\_\_\_ \_ P\_\_\_\_ I N.I.C. <u> 2007</u>5 N.I.C. N.I.C. I { OPEN OFFICE AREA **OPEN OFFICE** AREA N.I.C. N.I.C. **Ø**. Н Н 
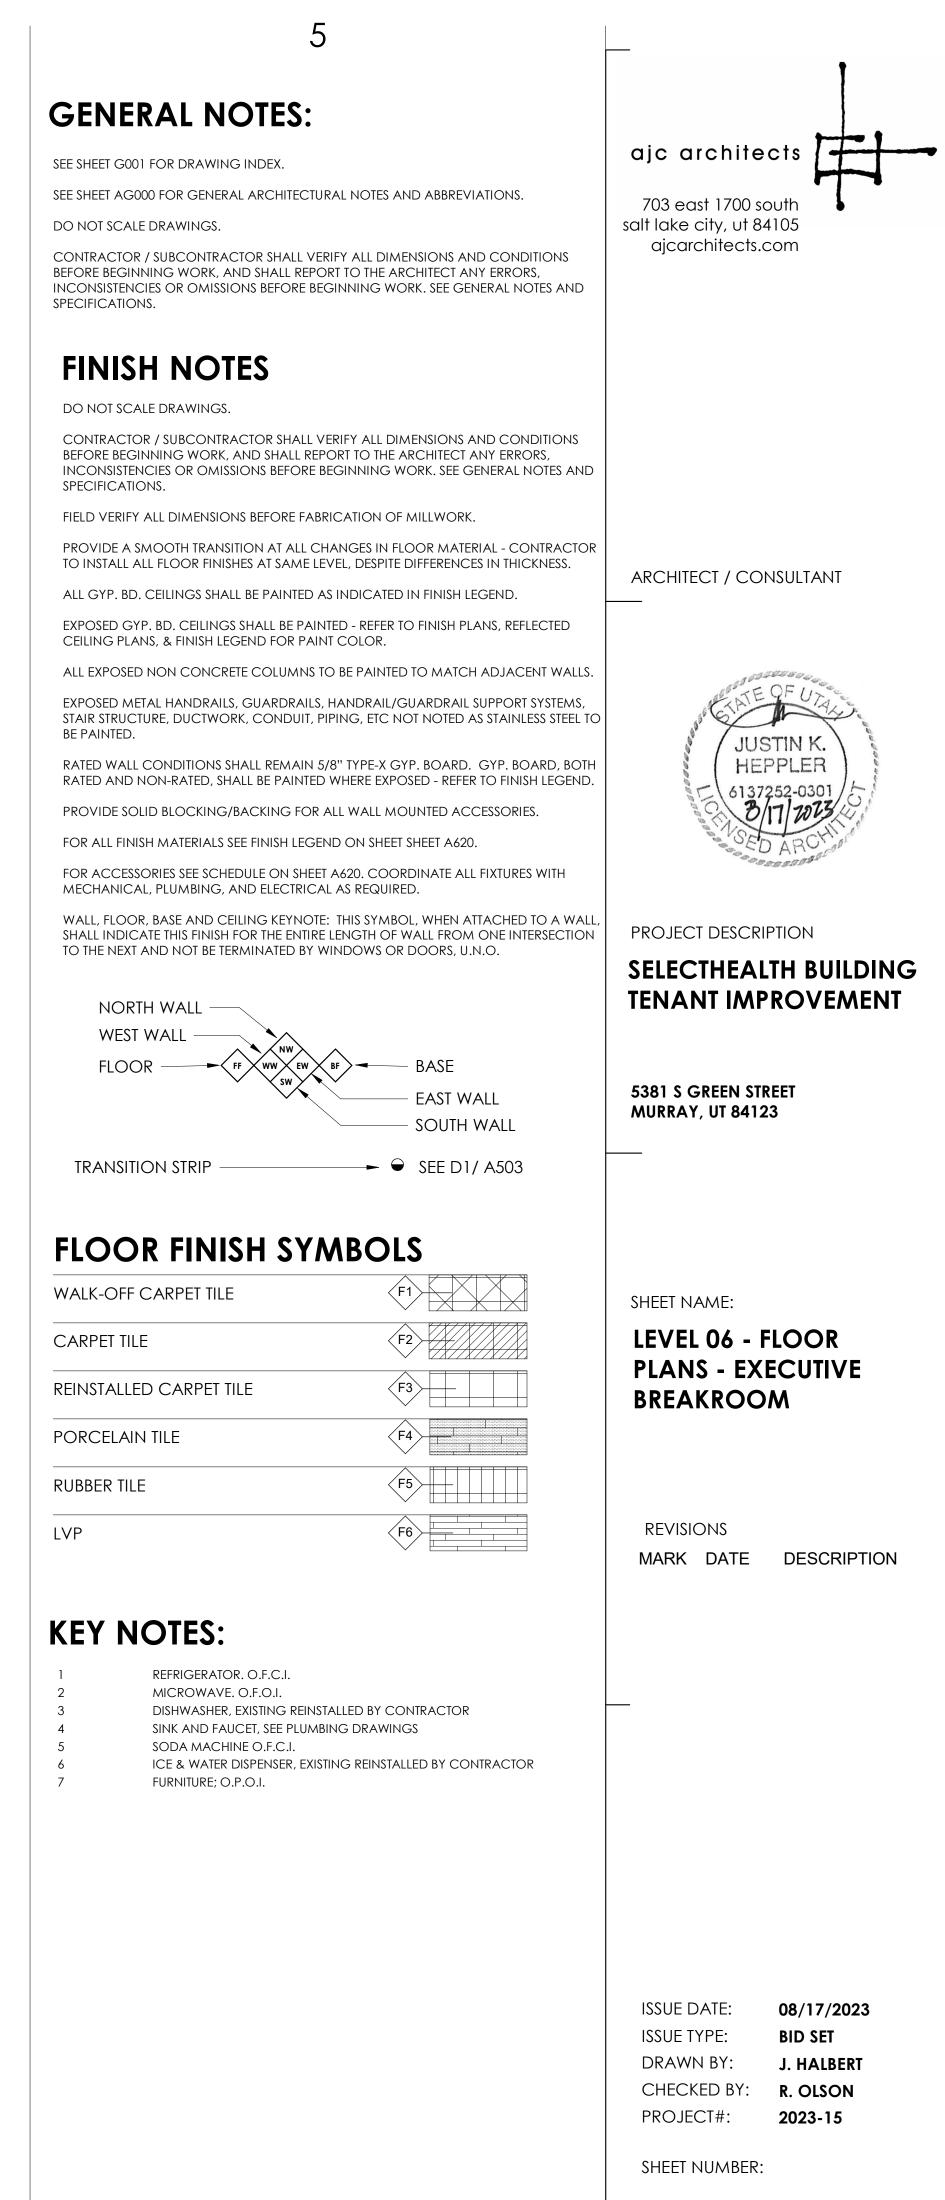
# FOR REFERENCE ONLY

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SEE SHEET G001 FOR DRAWING INDEX.

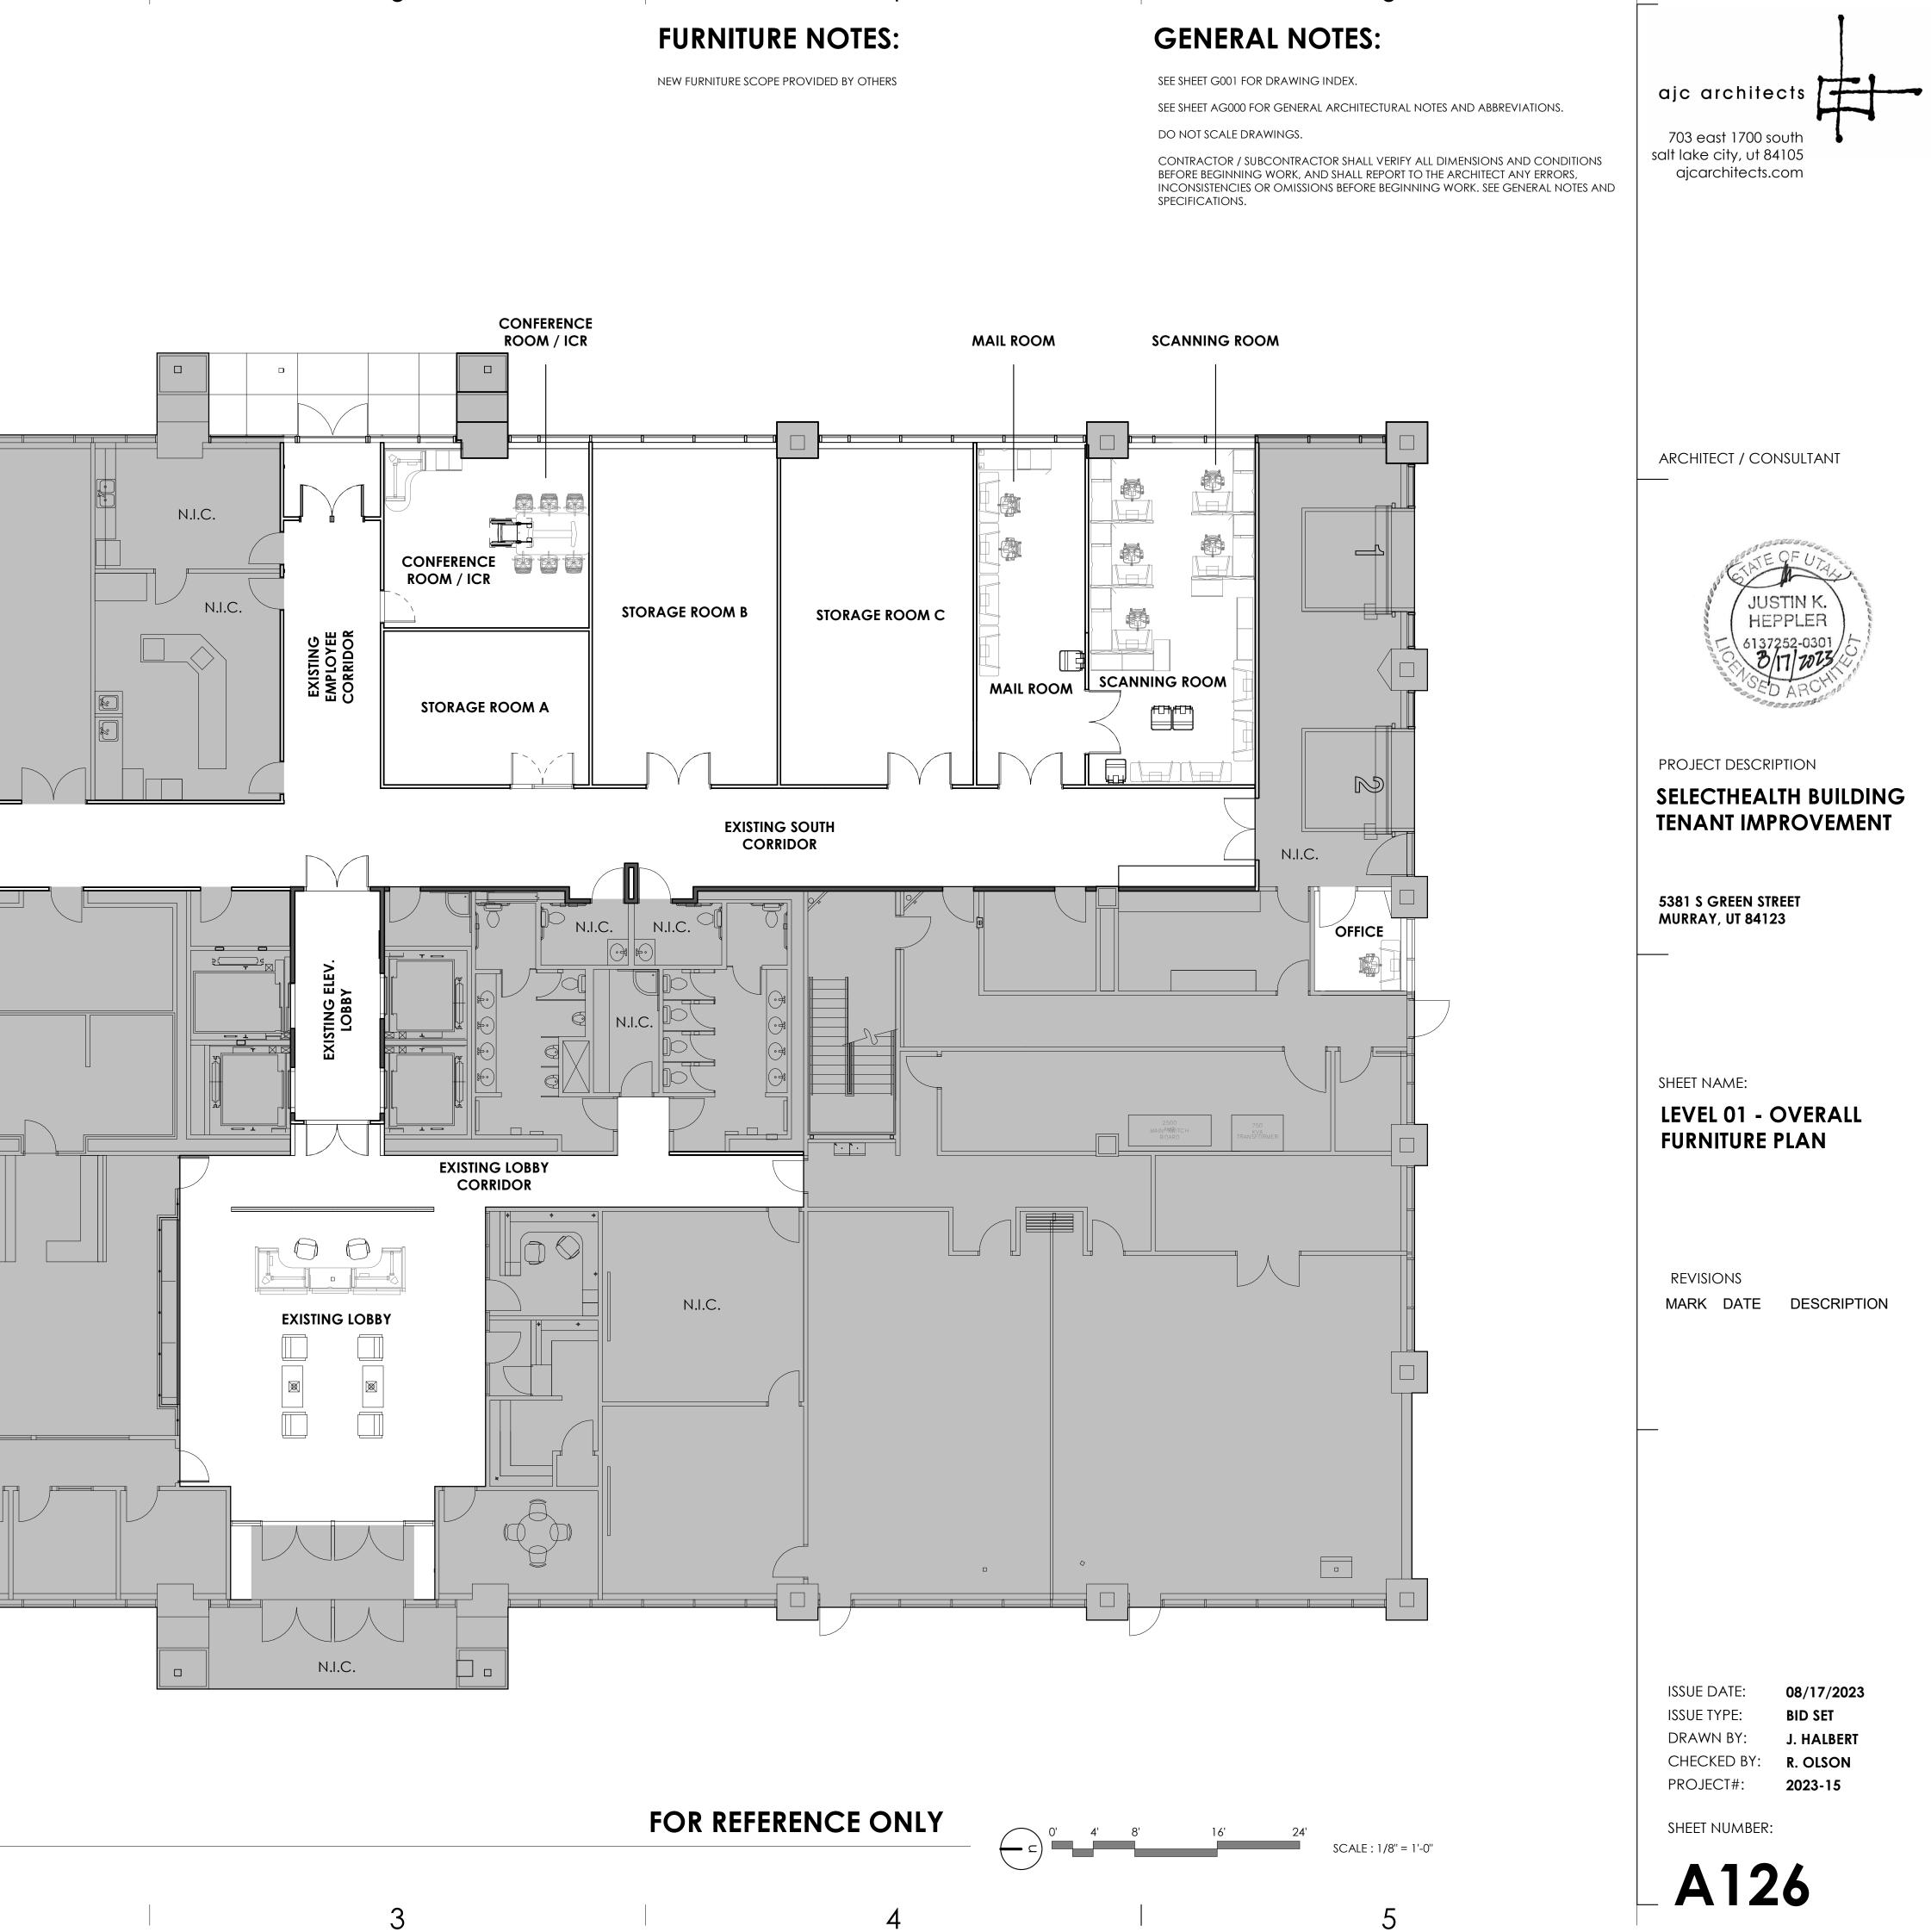SEE SHEET AG000 FOR GENERAL ARCHITECTURAL NOTES AND ABBREVIATIONS.

do not scale drawings.

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ajc architects

703 east 1700 south salt lake city, ut 84105 ajcarchitects.com

24'

SCALE : 1/8" = 1'-0"

JUSTIN K HEPPLER

PROJECT DESCRIPTION

ARCHITECT / CONSULTANT

### SELECTHEALTH BUILDING TENANT IMPROVEMENT

5381 S GREEN STREET MURRAY, UT 84123

Sheet NAME:


### LEVEL 02 - OVERALL FURNITURE PLAN

REVISIONS MARK DATE DESCRIPTION

ISSUE DATE: ISSUE TYPE: DRAWN BY: CHECKED BY: R. OLSON PROJECT#:

08/17/2023 **BID SET** J. HALBERT 2023-15



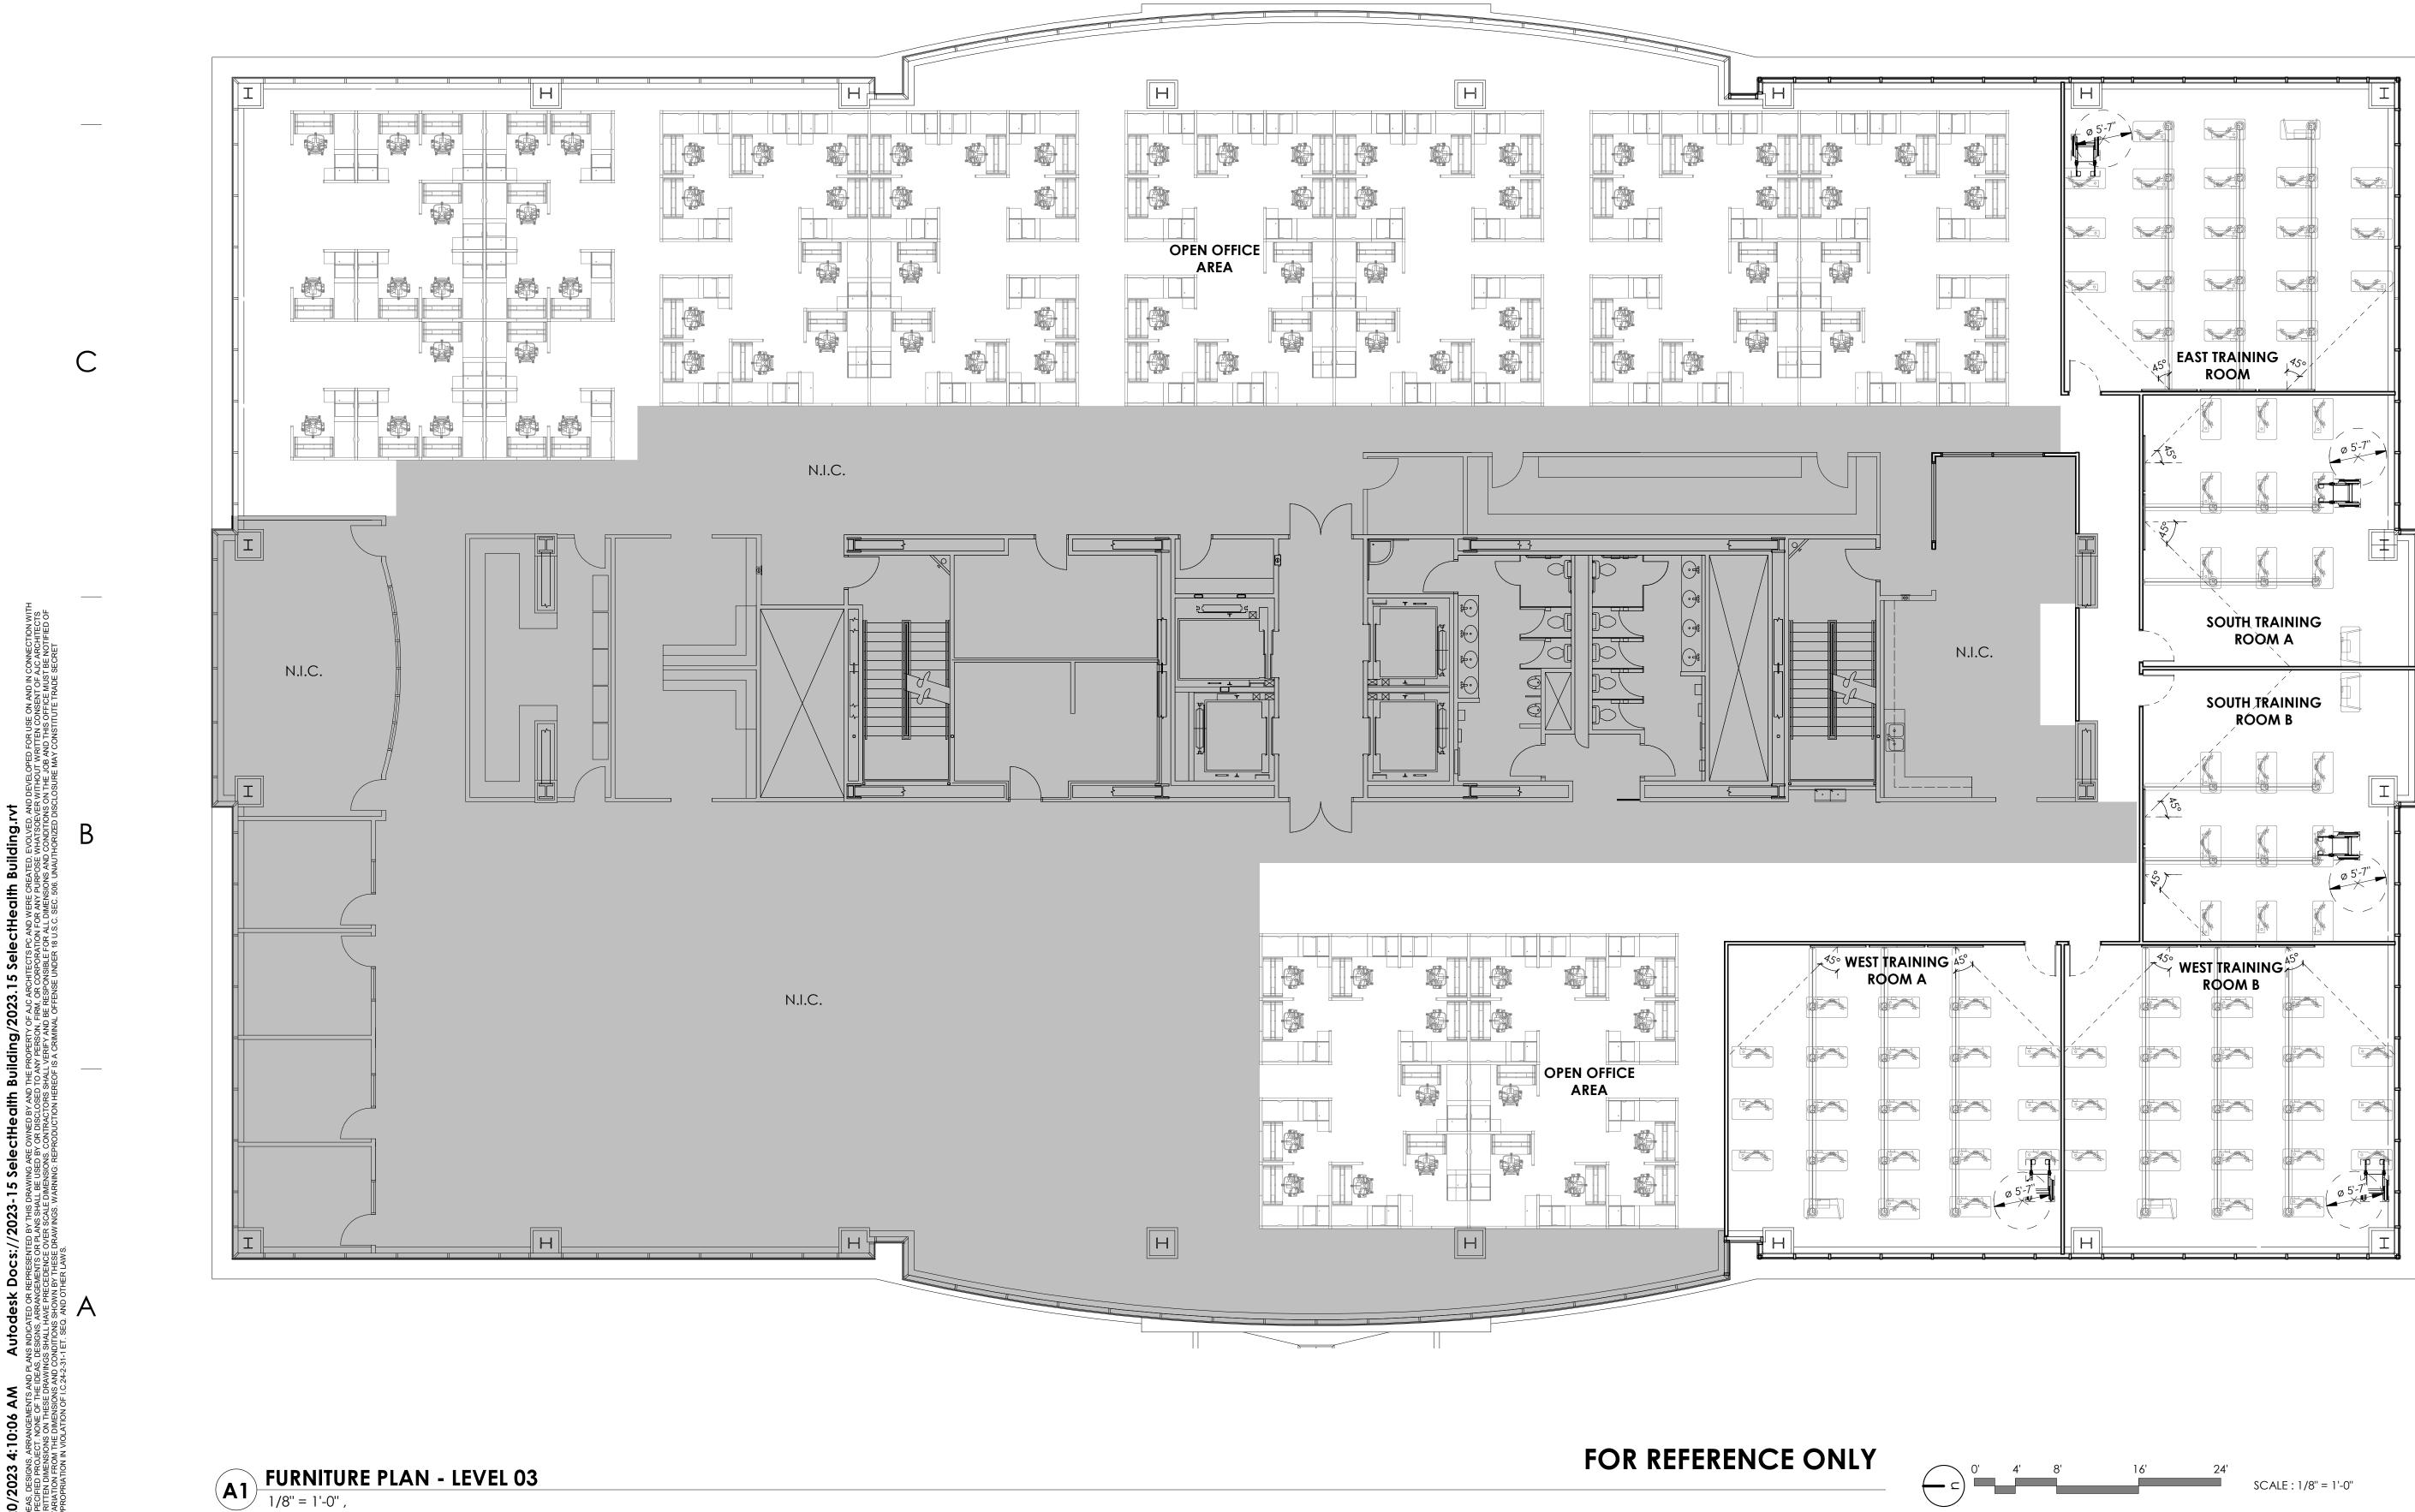

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# **GENERAL NOTES:**

SEE SHEET GOO1 FOR DRAWING INDEX.

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ARCHITECT / CONSULTANT JUSTIN K. HEPPLER 137252-0301 PROJECT DESCRIPTION SELECTHEALTH BUILDING TENANT IMPROVEMENT 5381 S GREEN STREET MURRAY, UT 84123 Sheet NAME: LEVEL 03 - OVERALL FURNITURE PLAN REVISIONS MARK DATE DESCRIPTION

ajc architects

703 east 1700 south salt lake city, ut 84105

ajcarchitects.com


ISSUE DATE: ISSUE TYPE: DRAWN BY: CHECKED BY: R. OLSON


08/17/2023 **BID SET** J. HALBERT 2023-15


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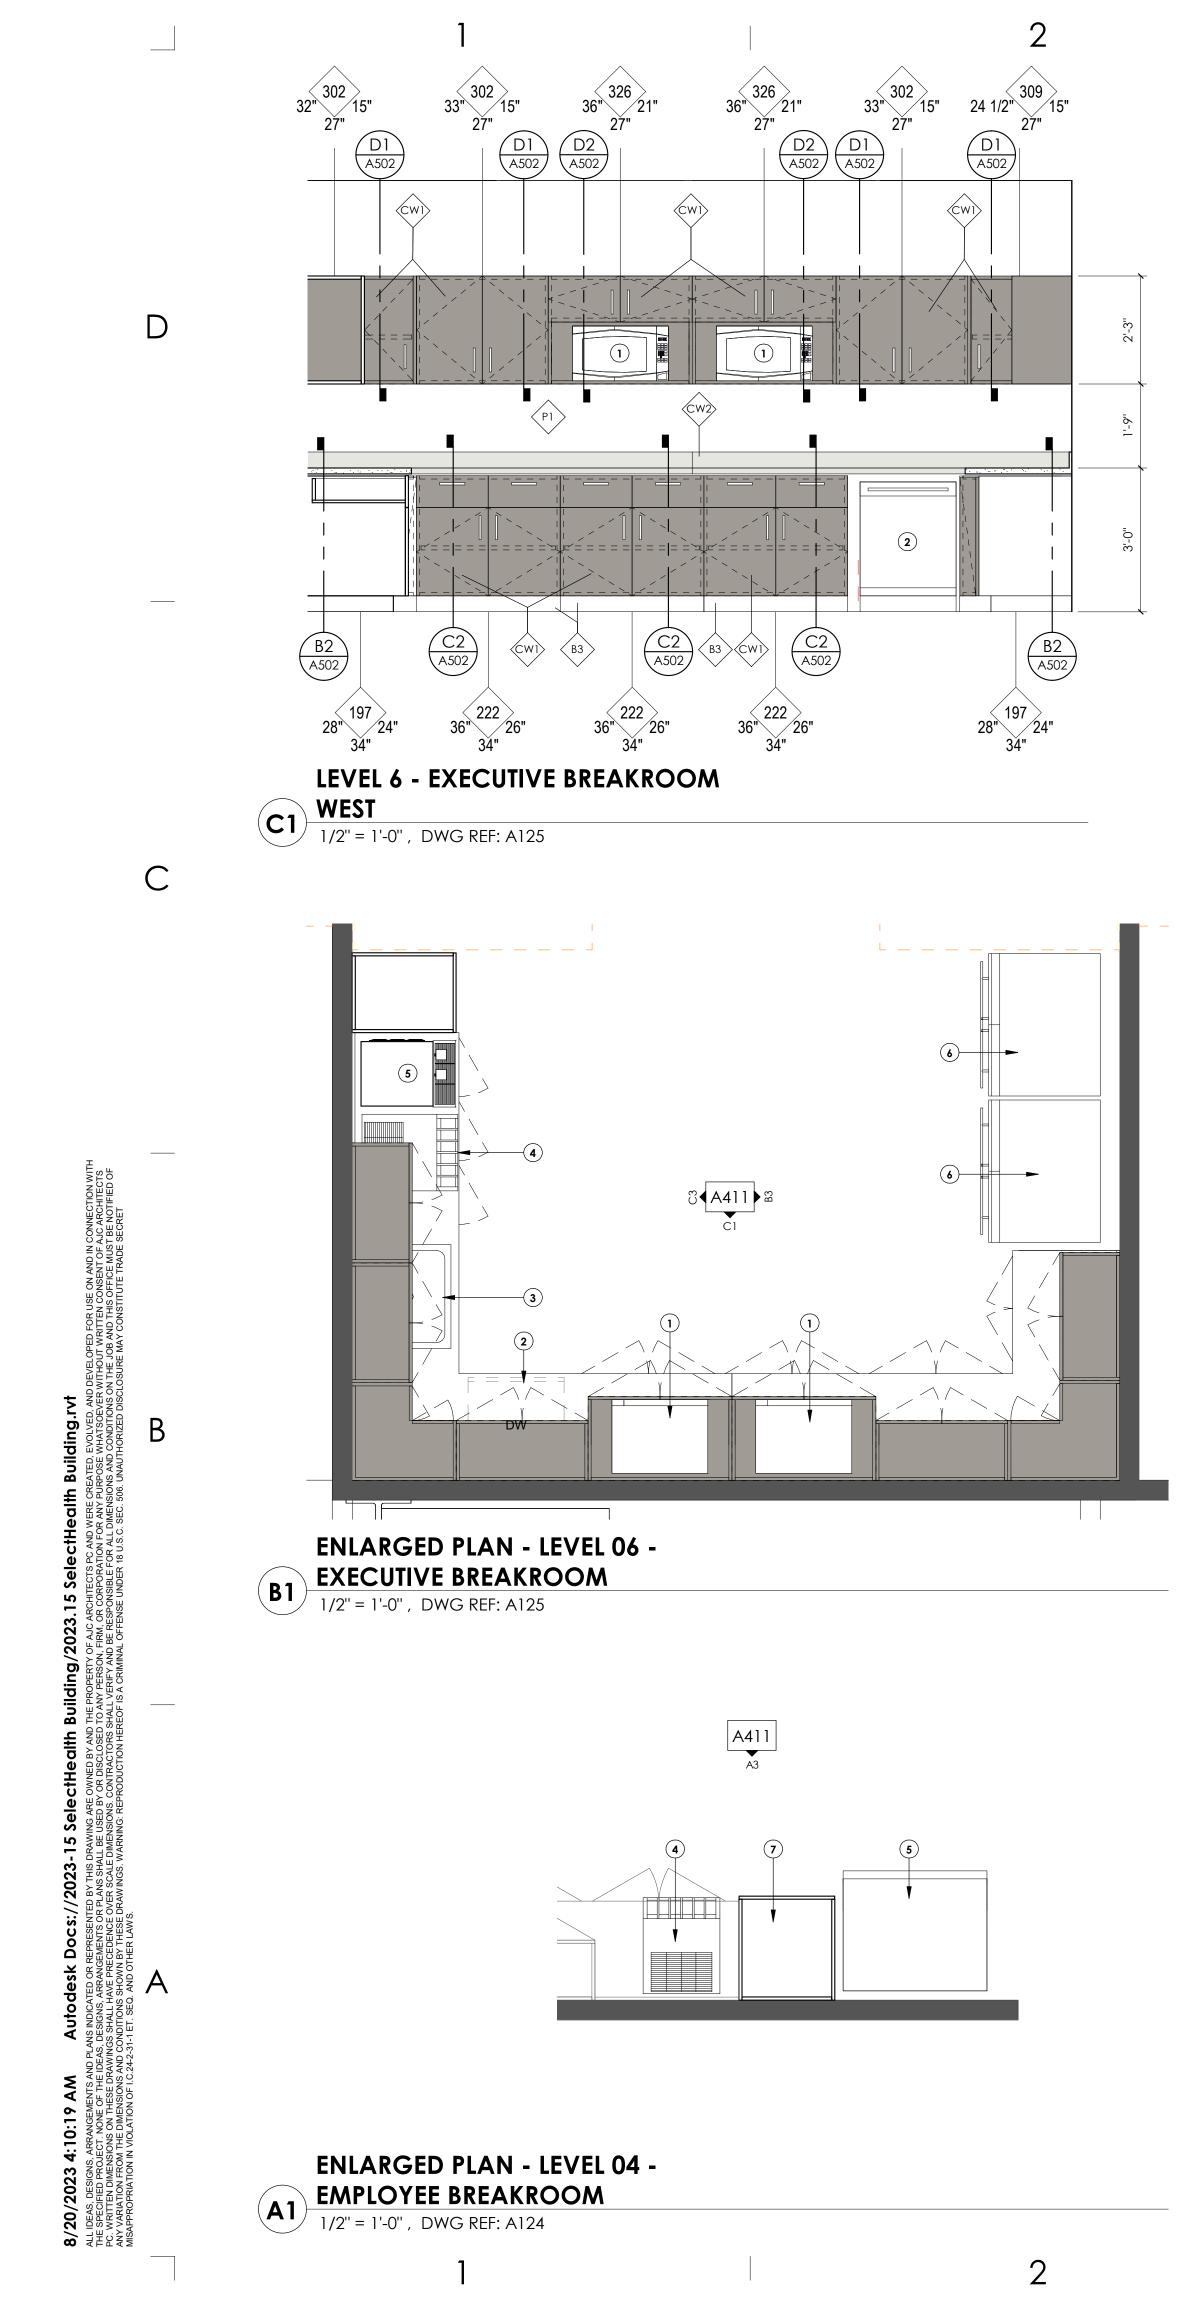
PROJECT#:







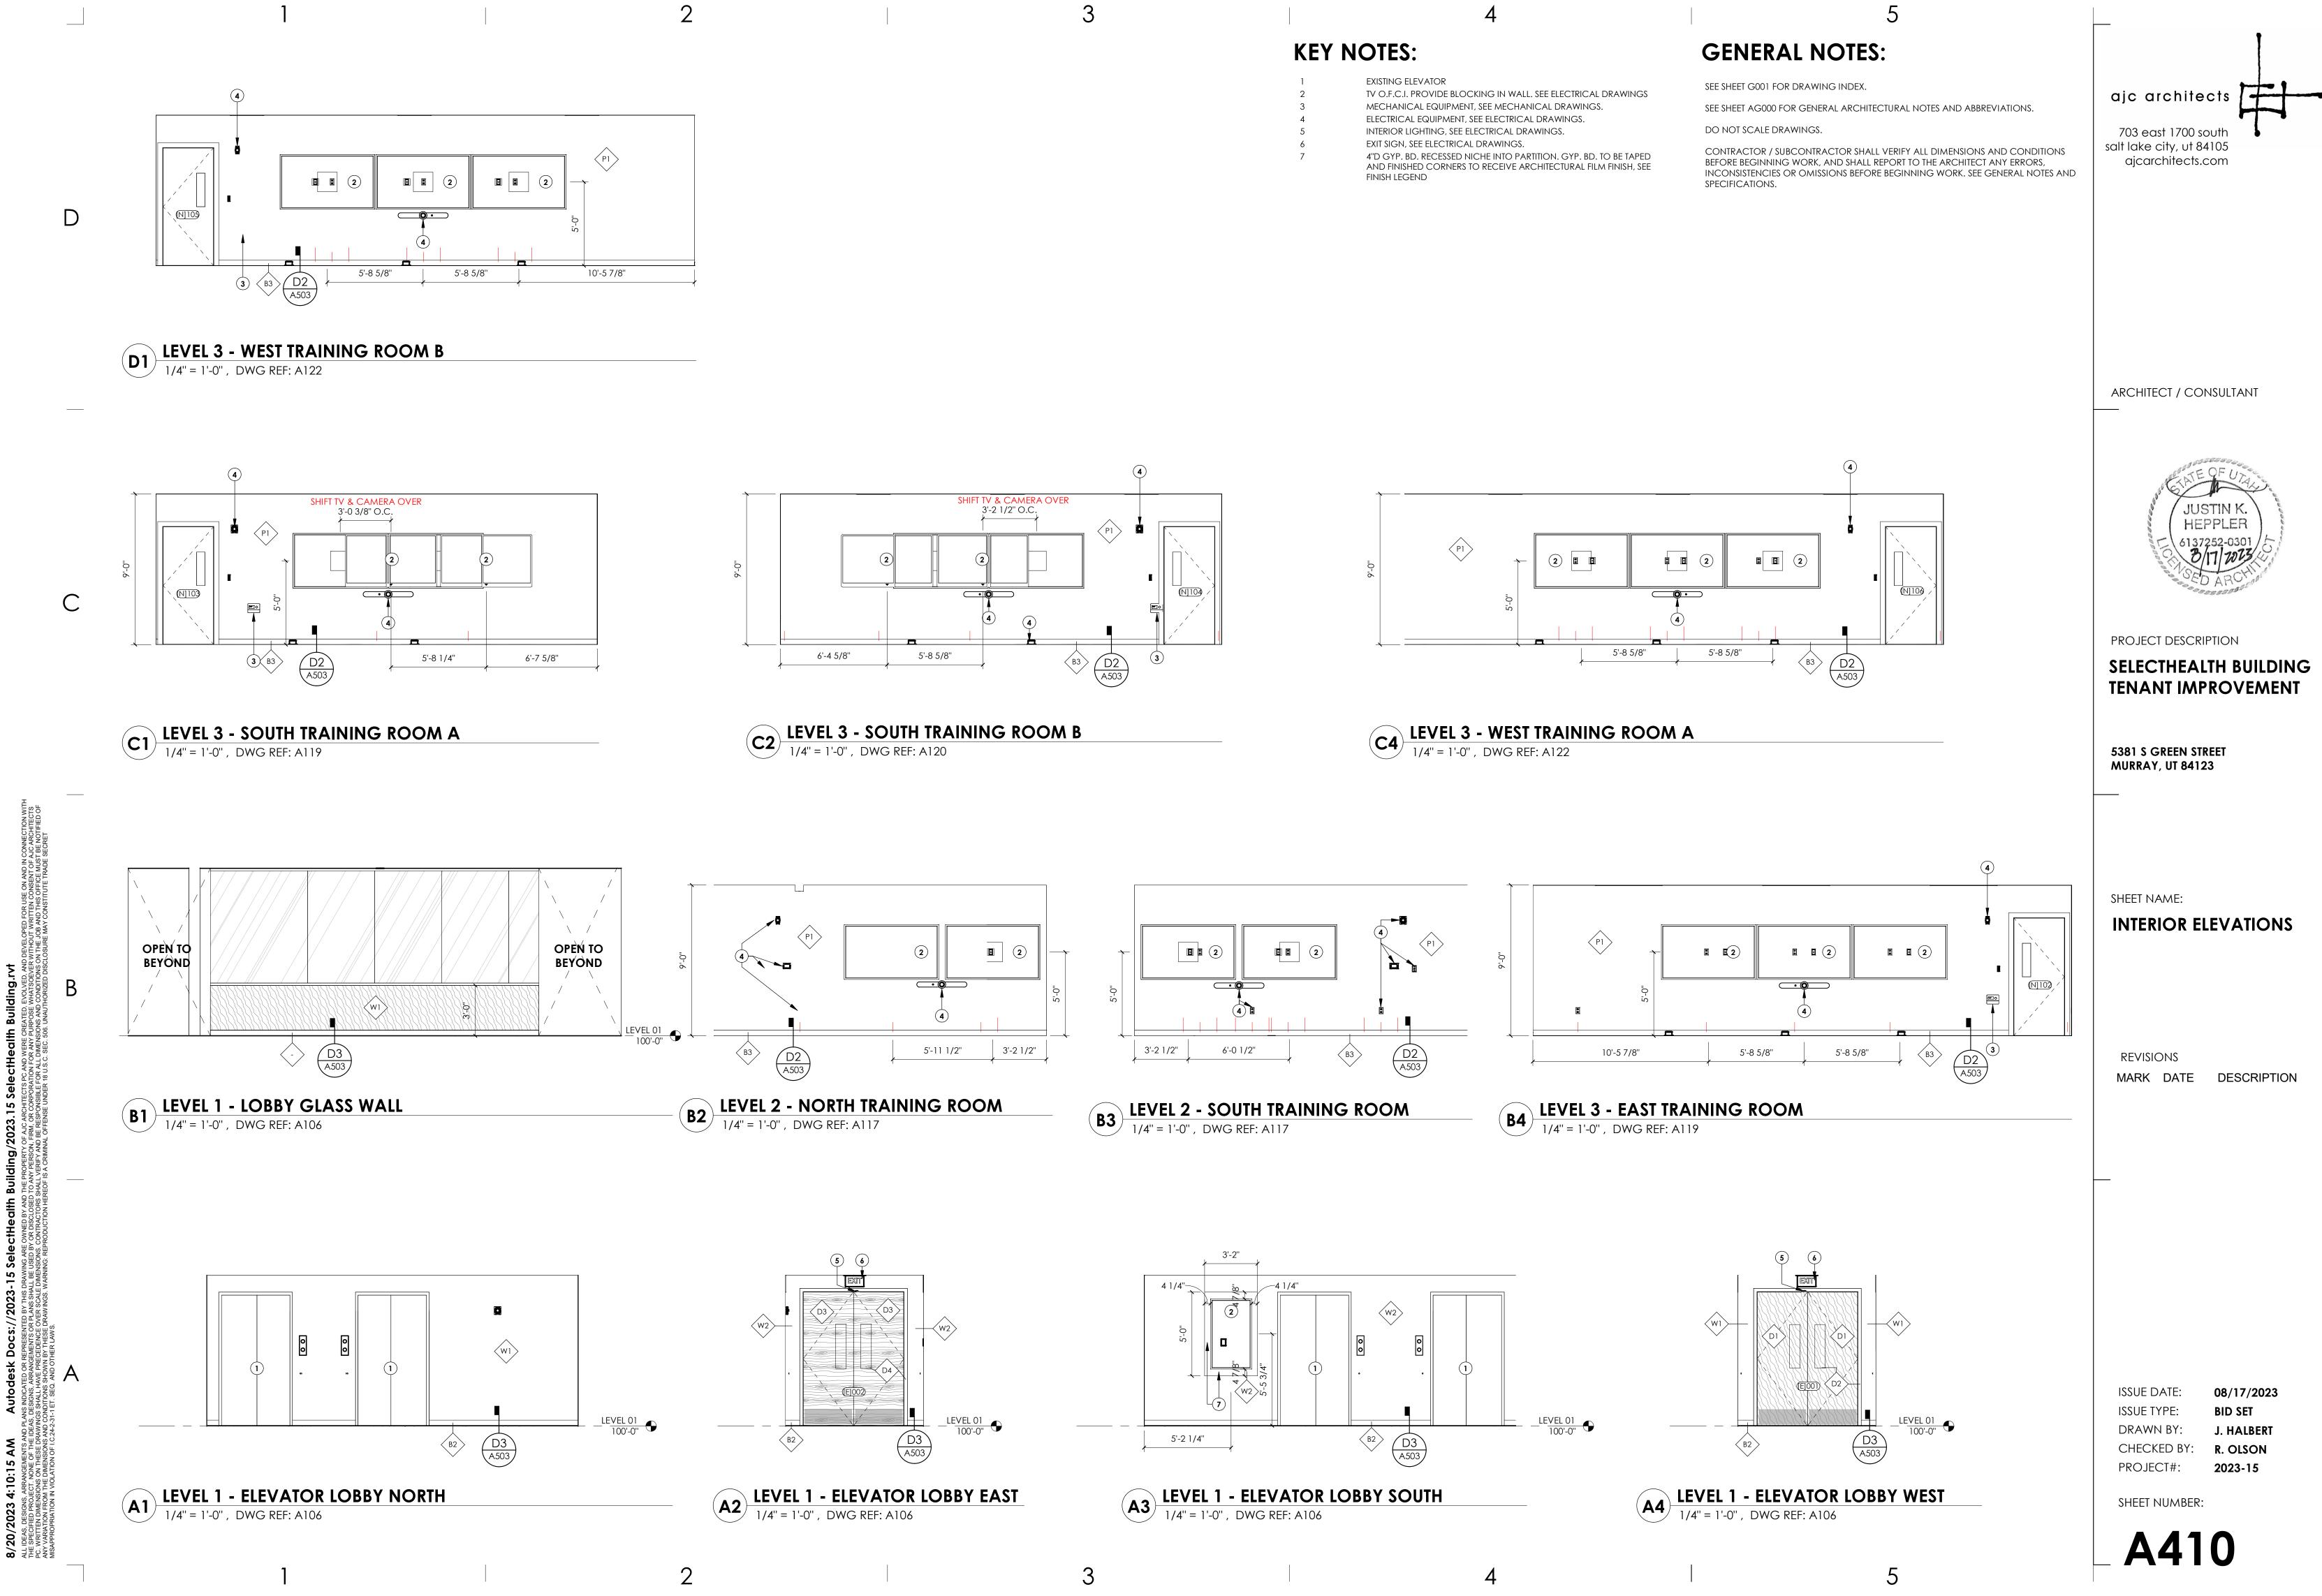

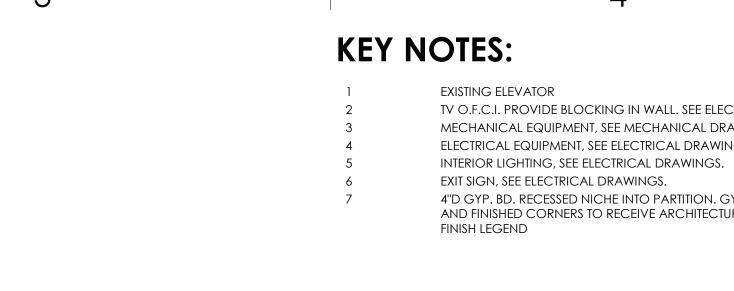


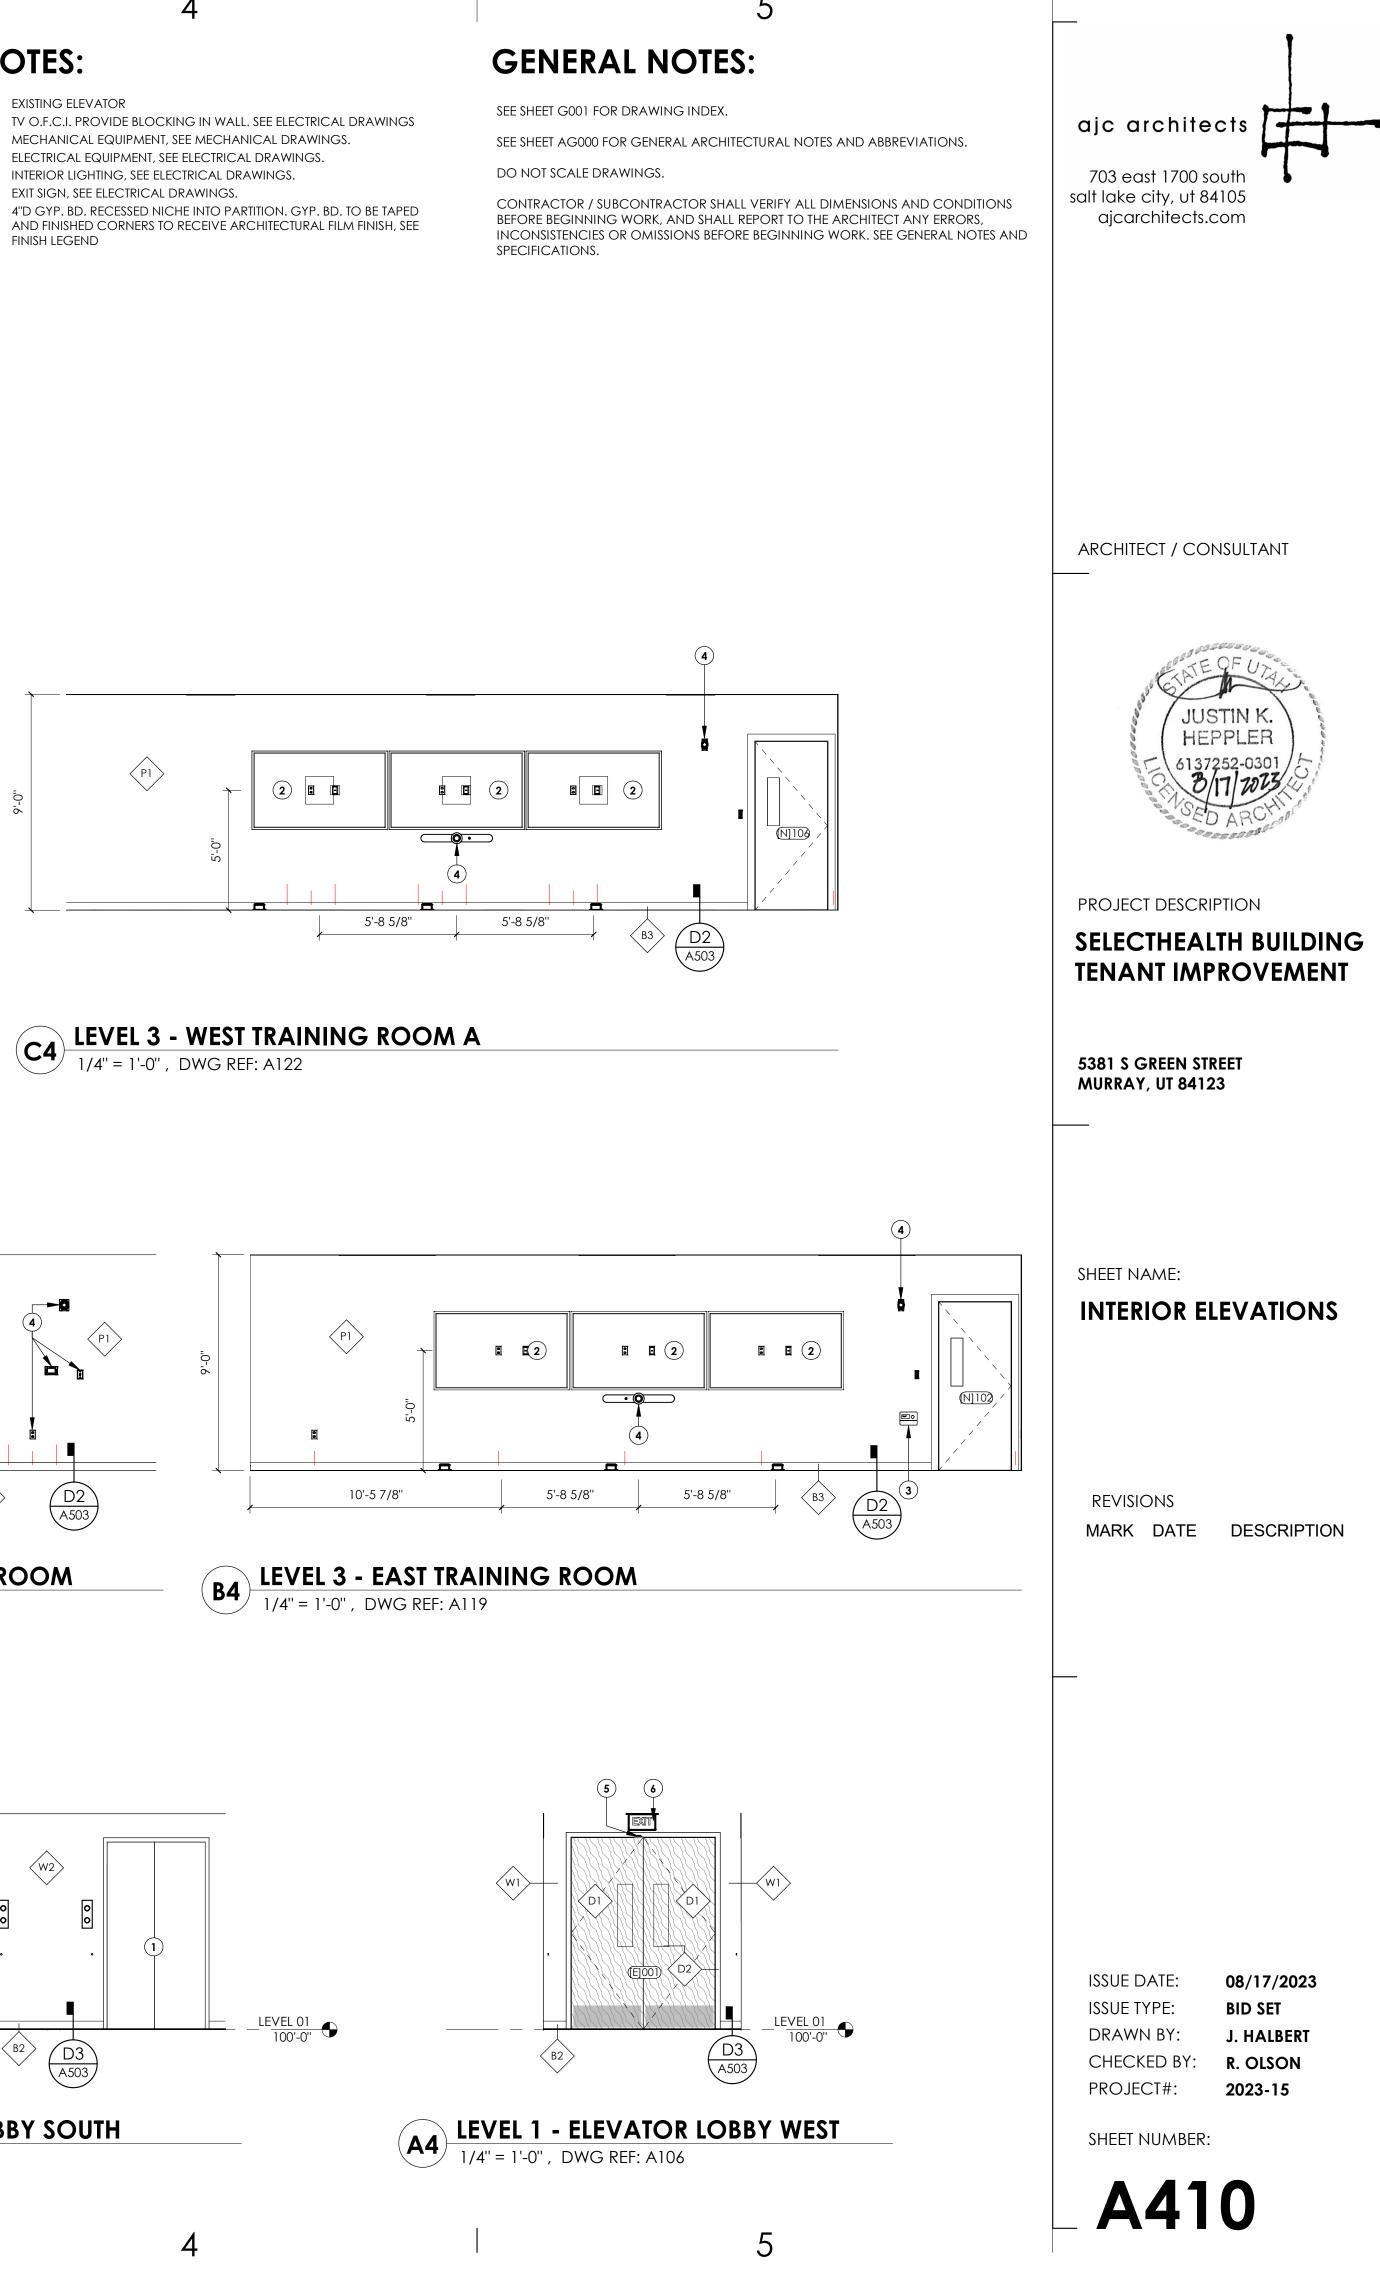

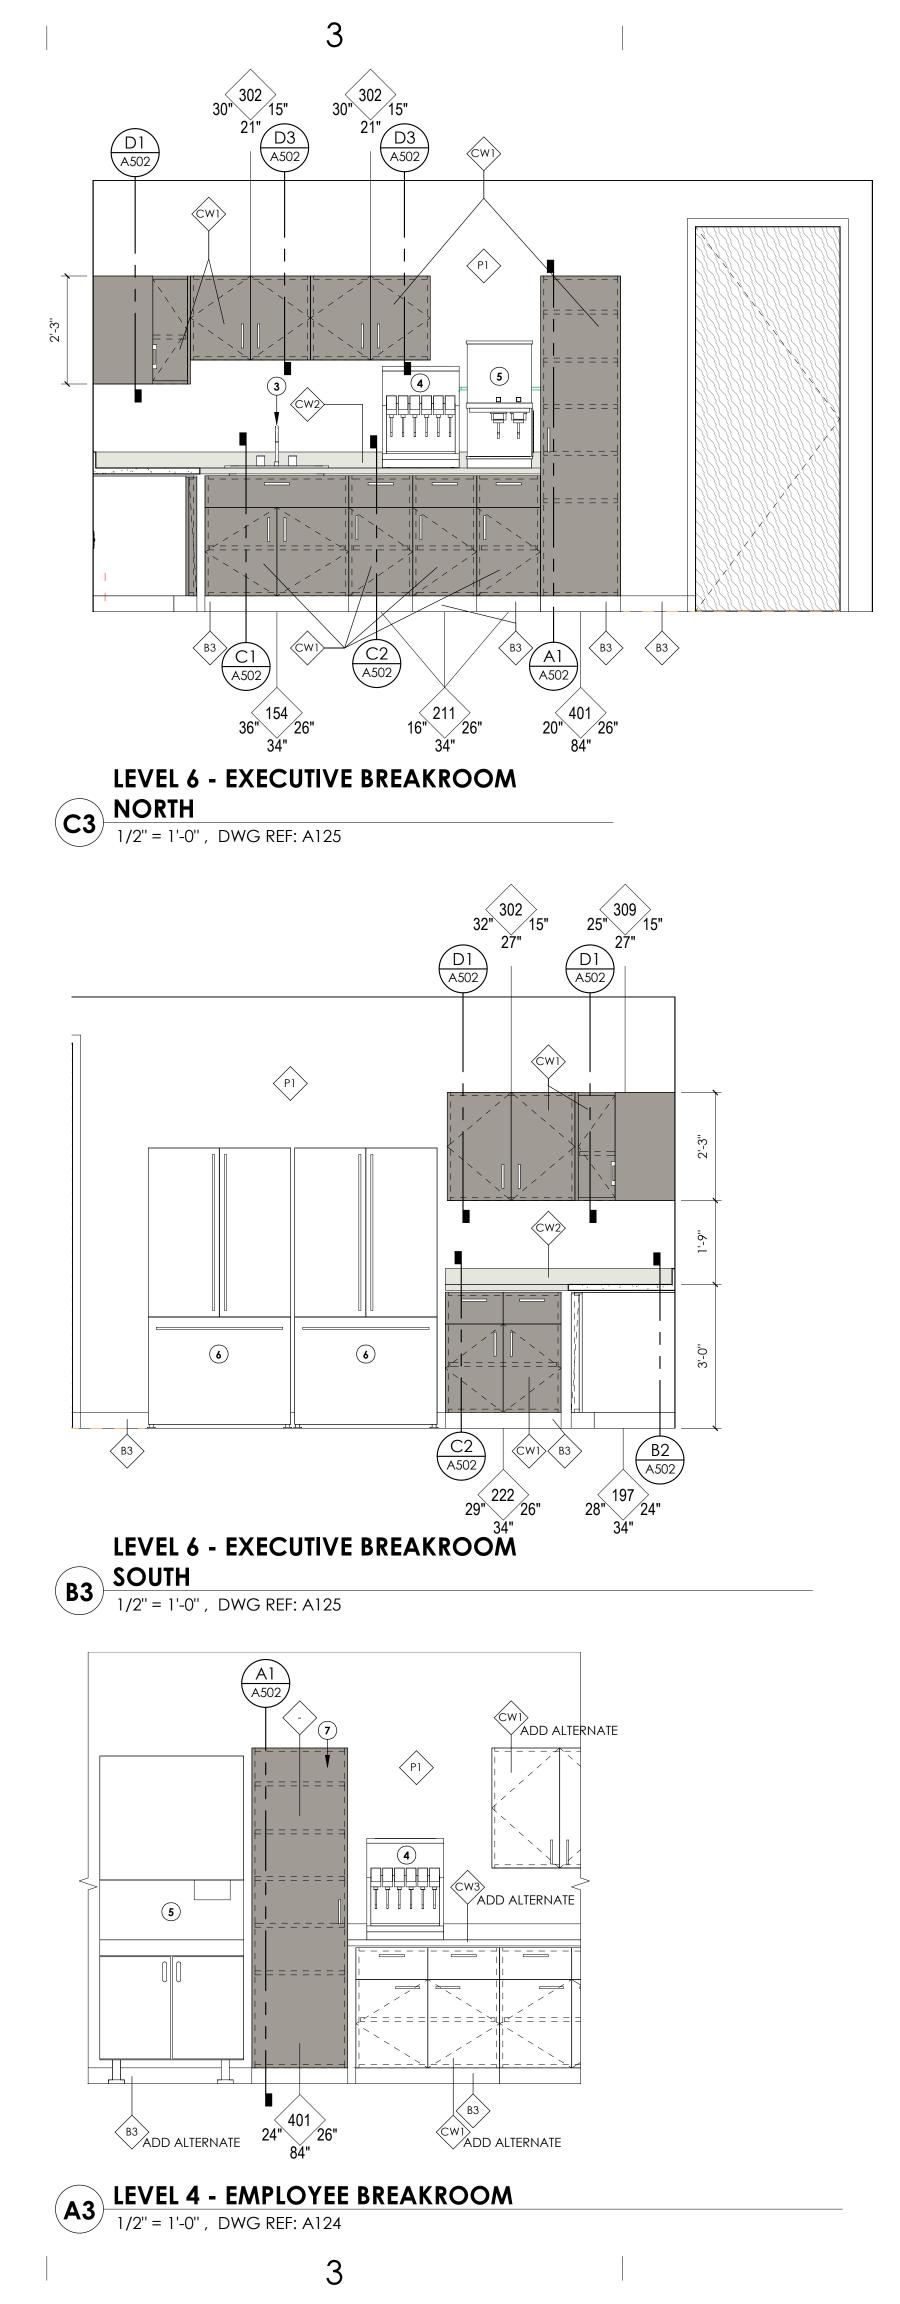

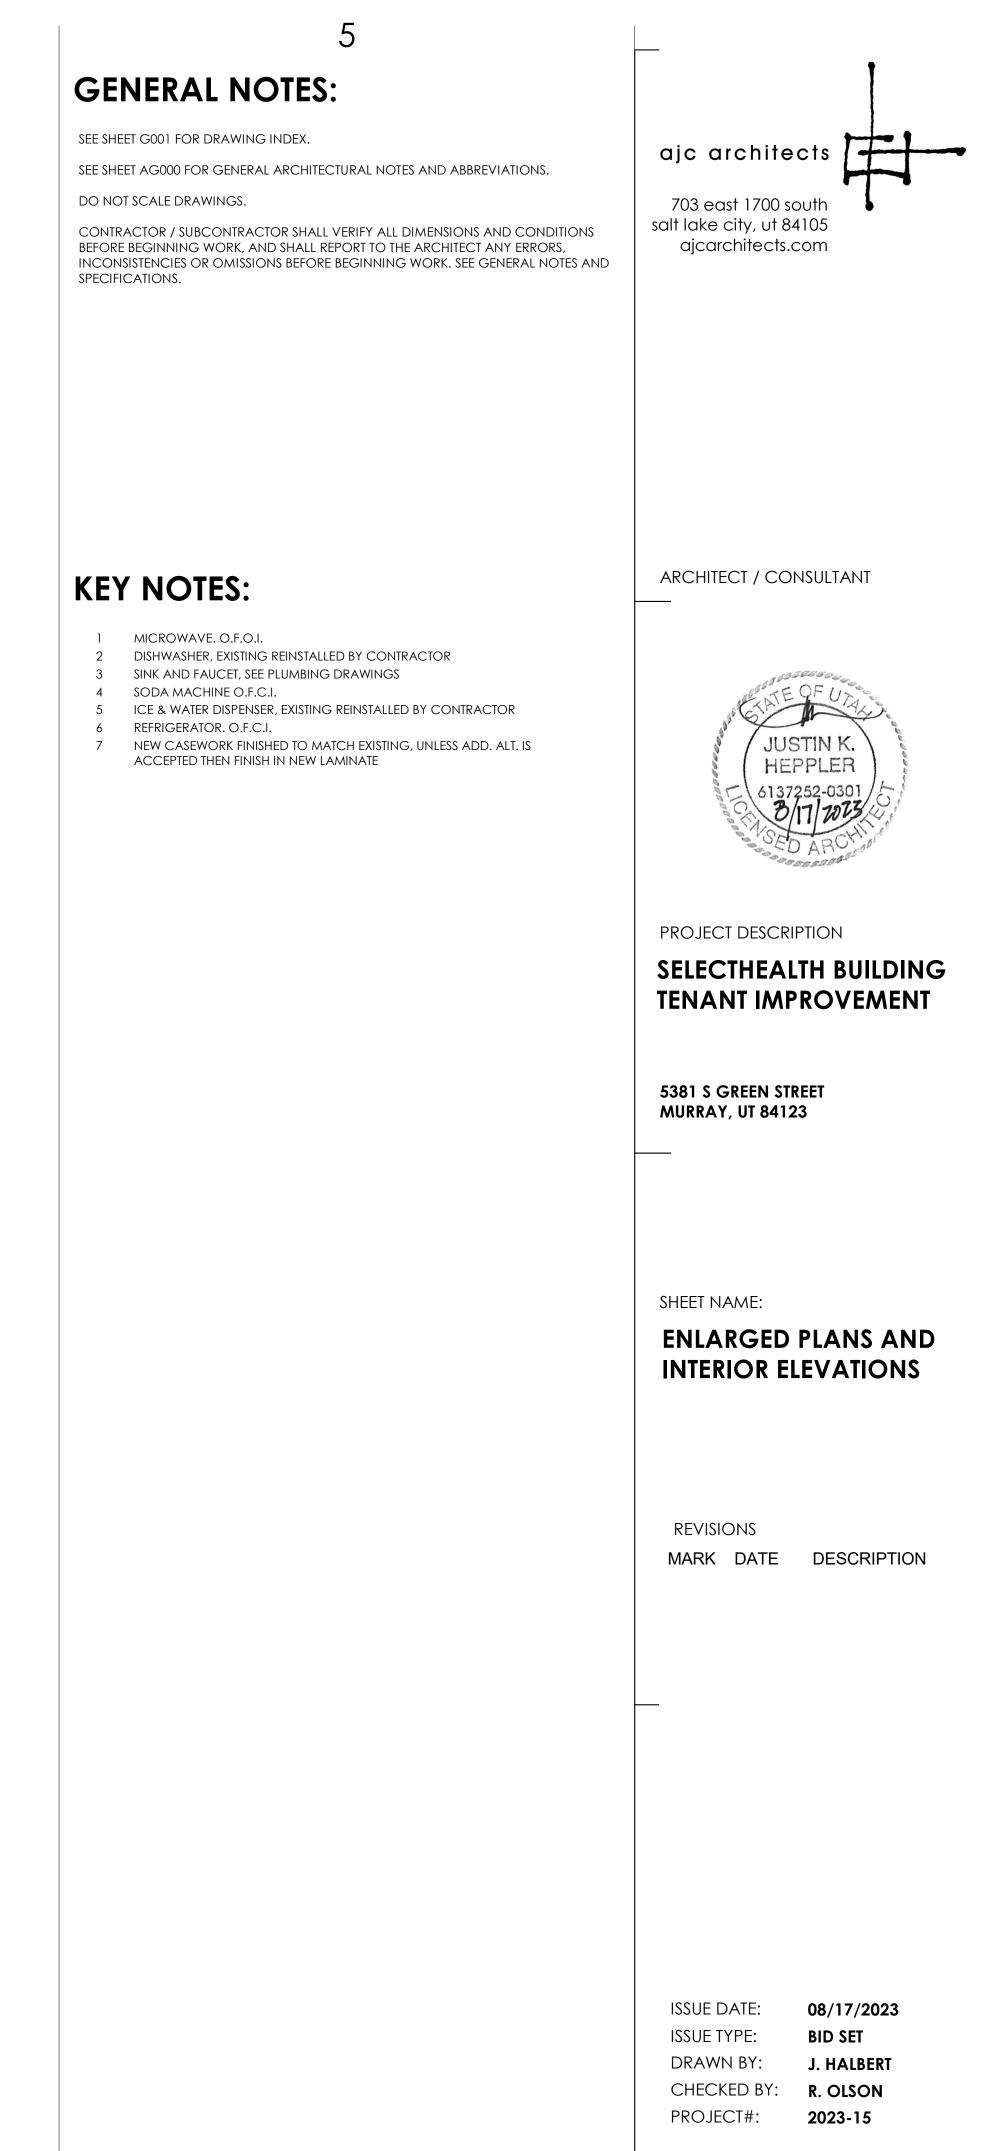




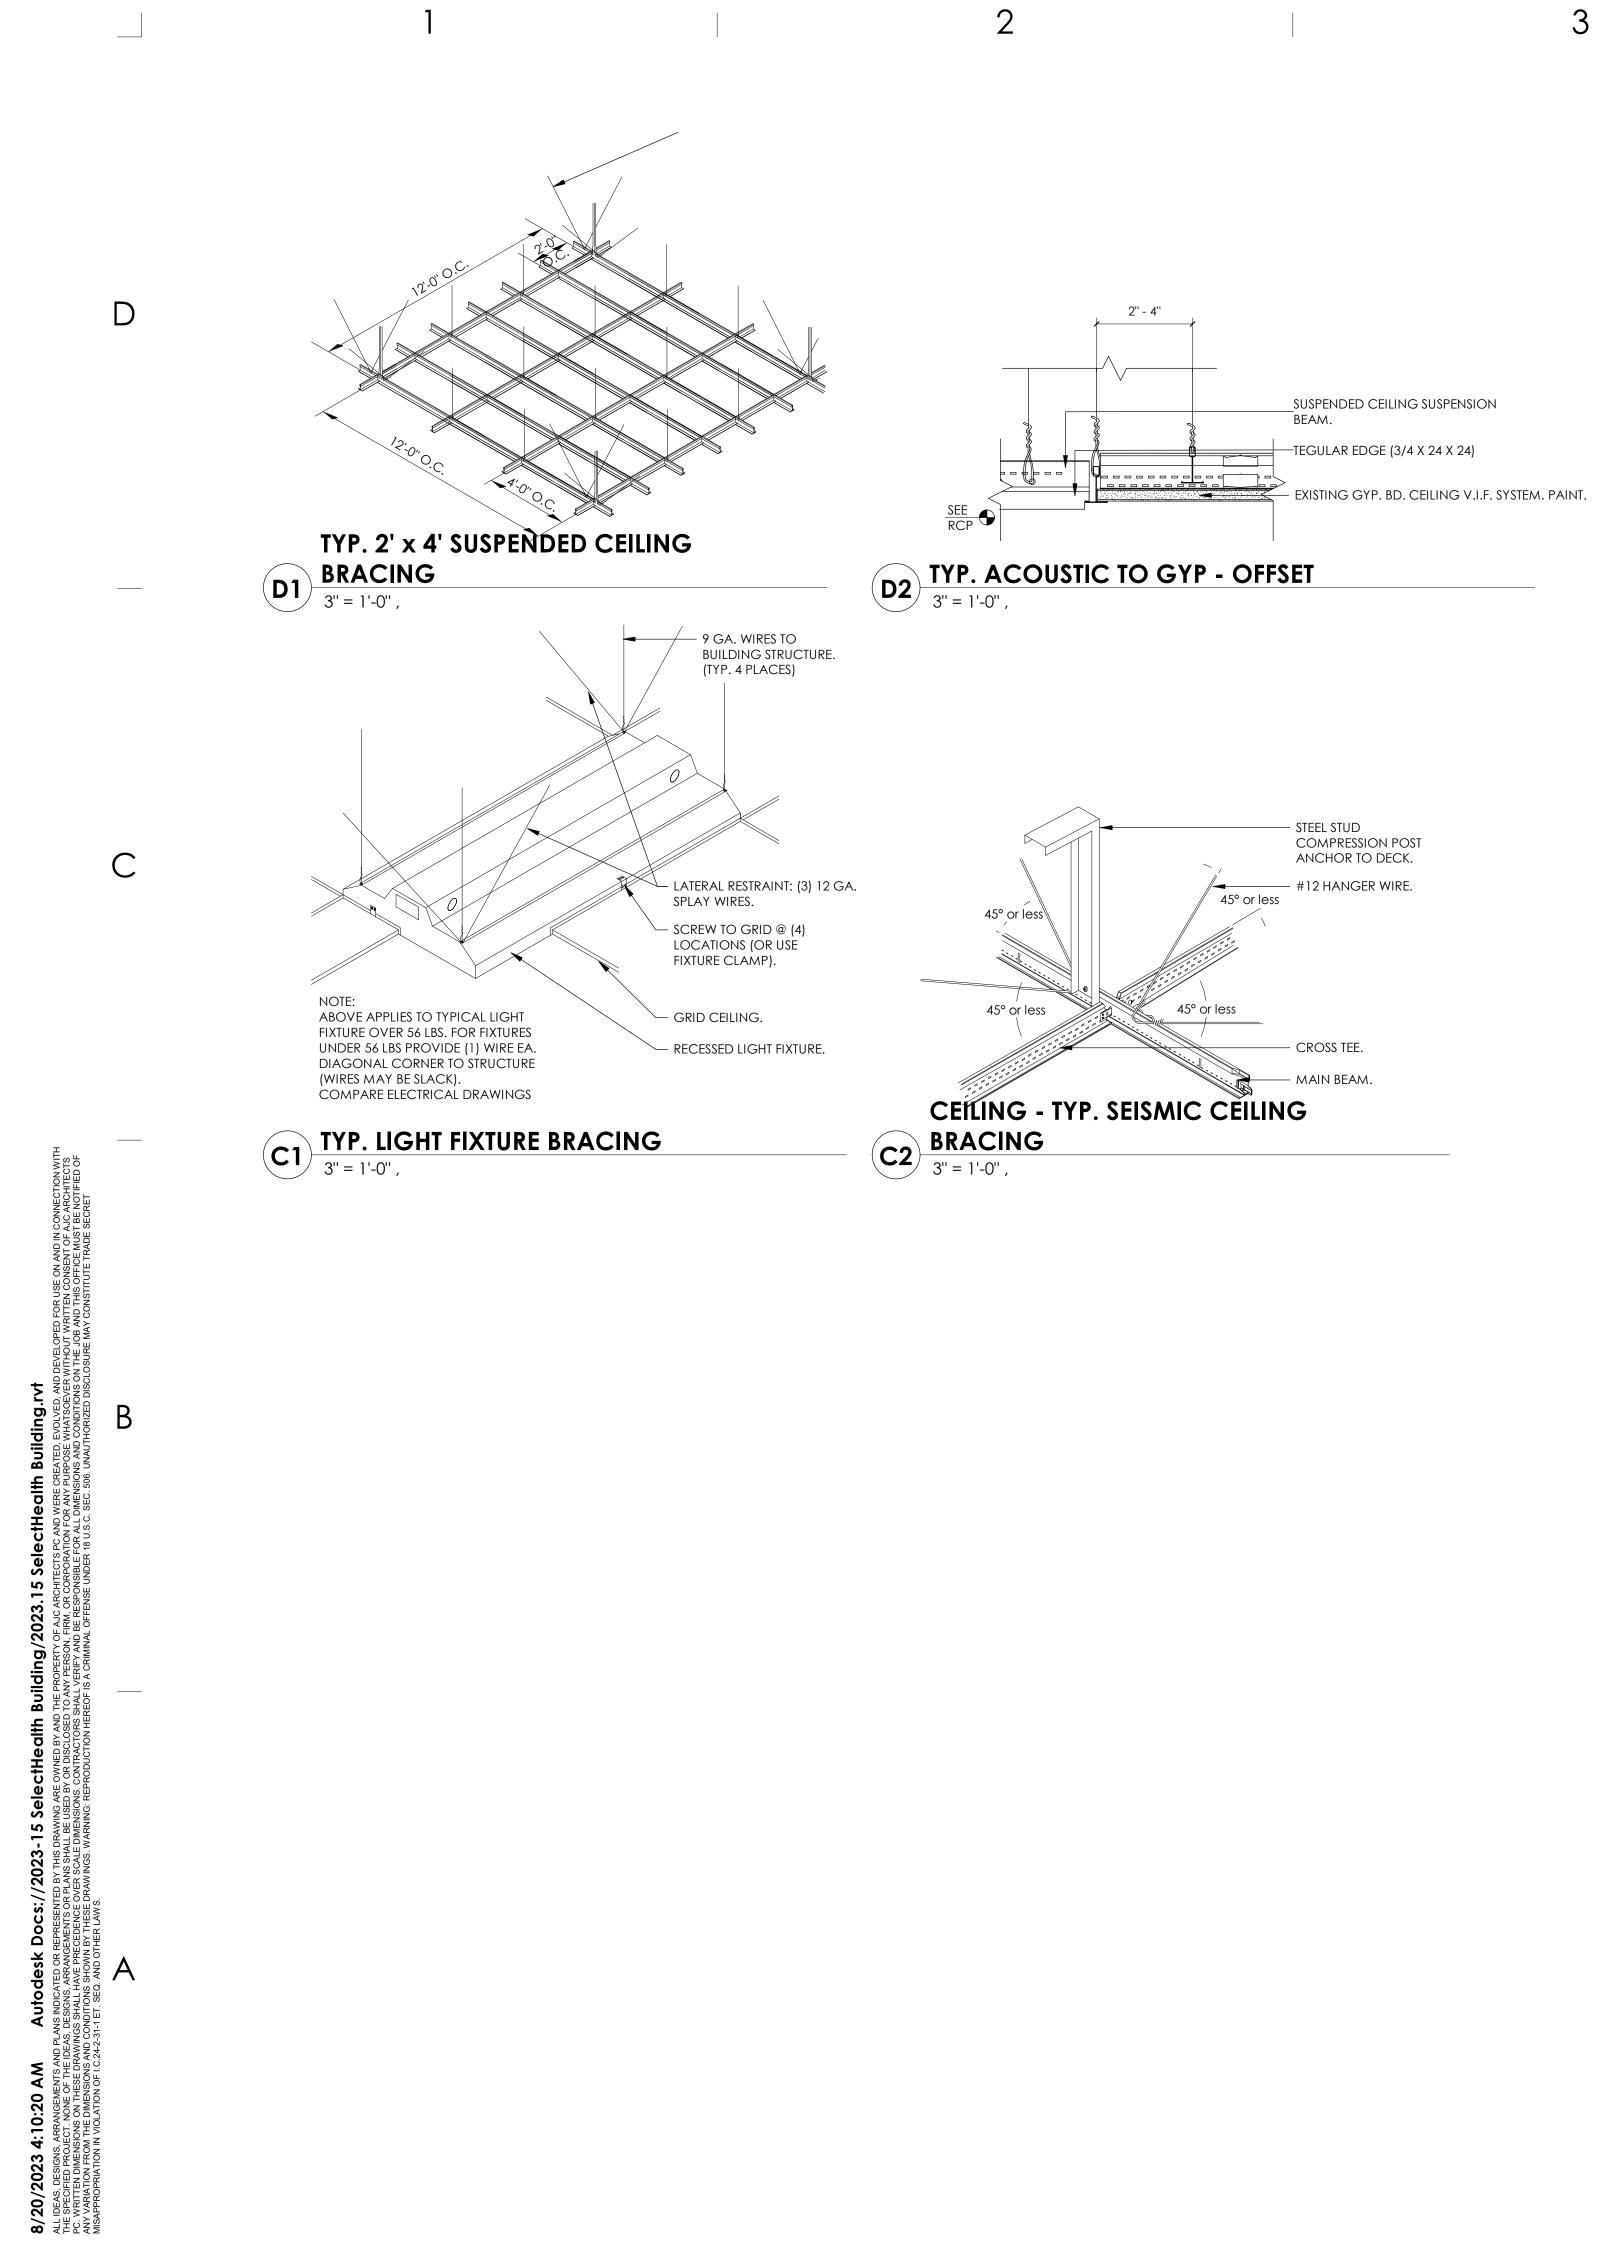







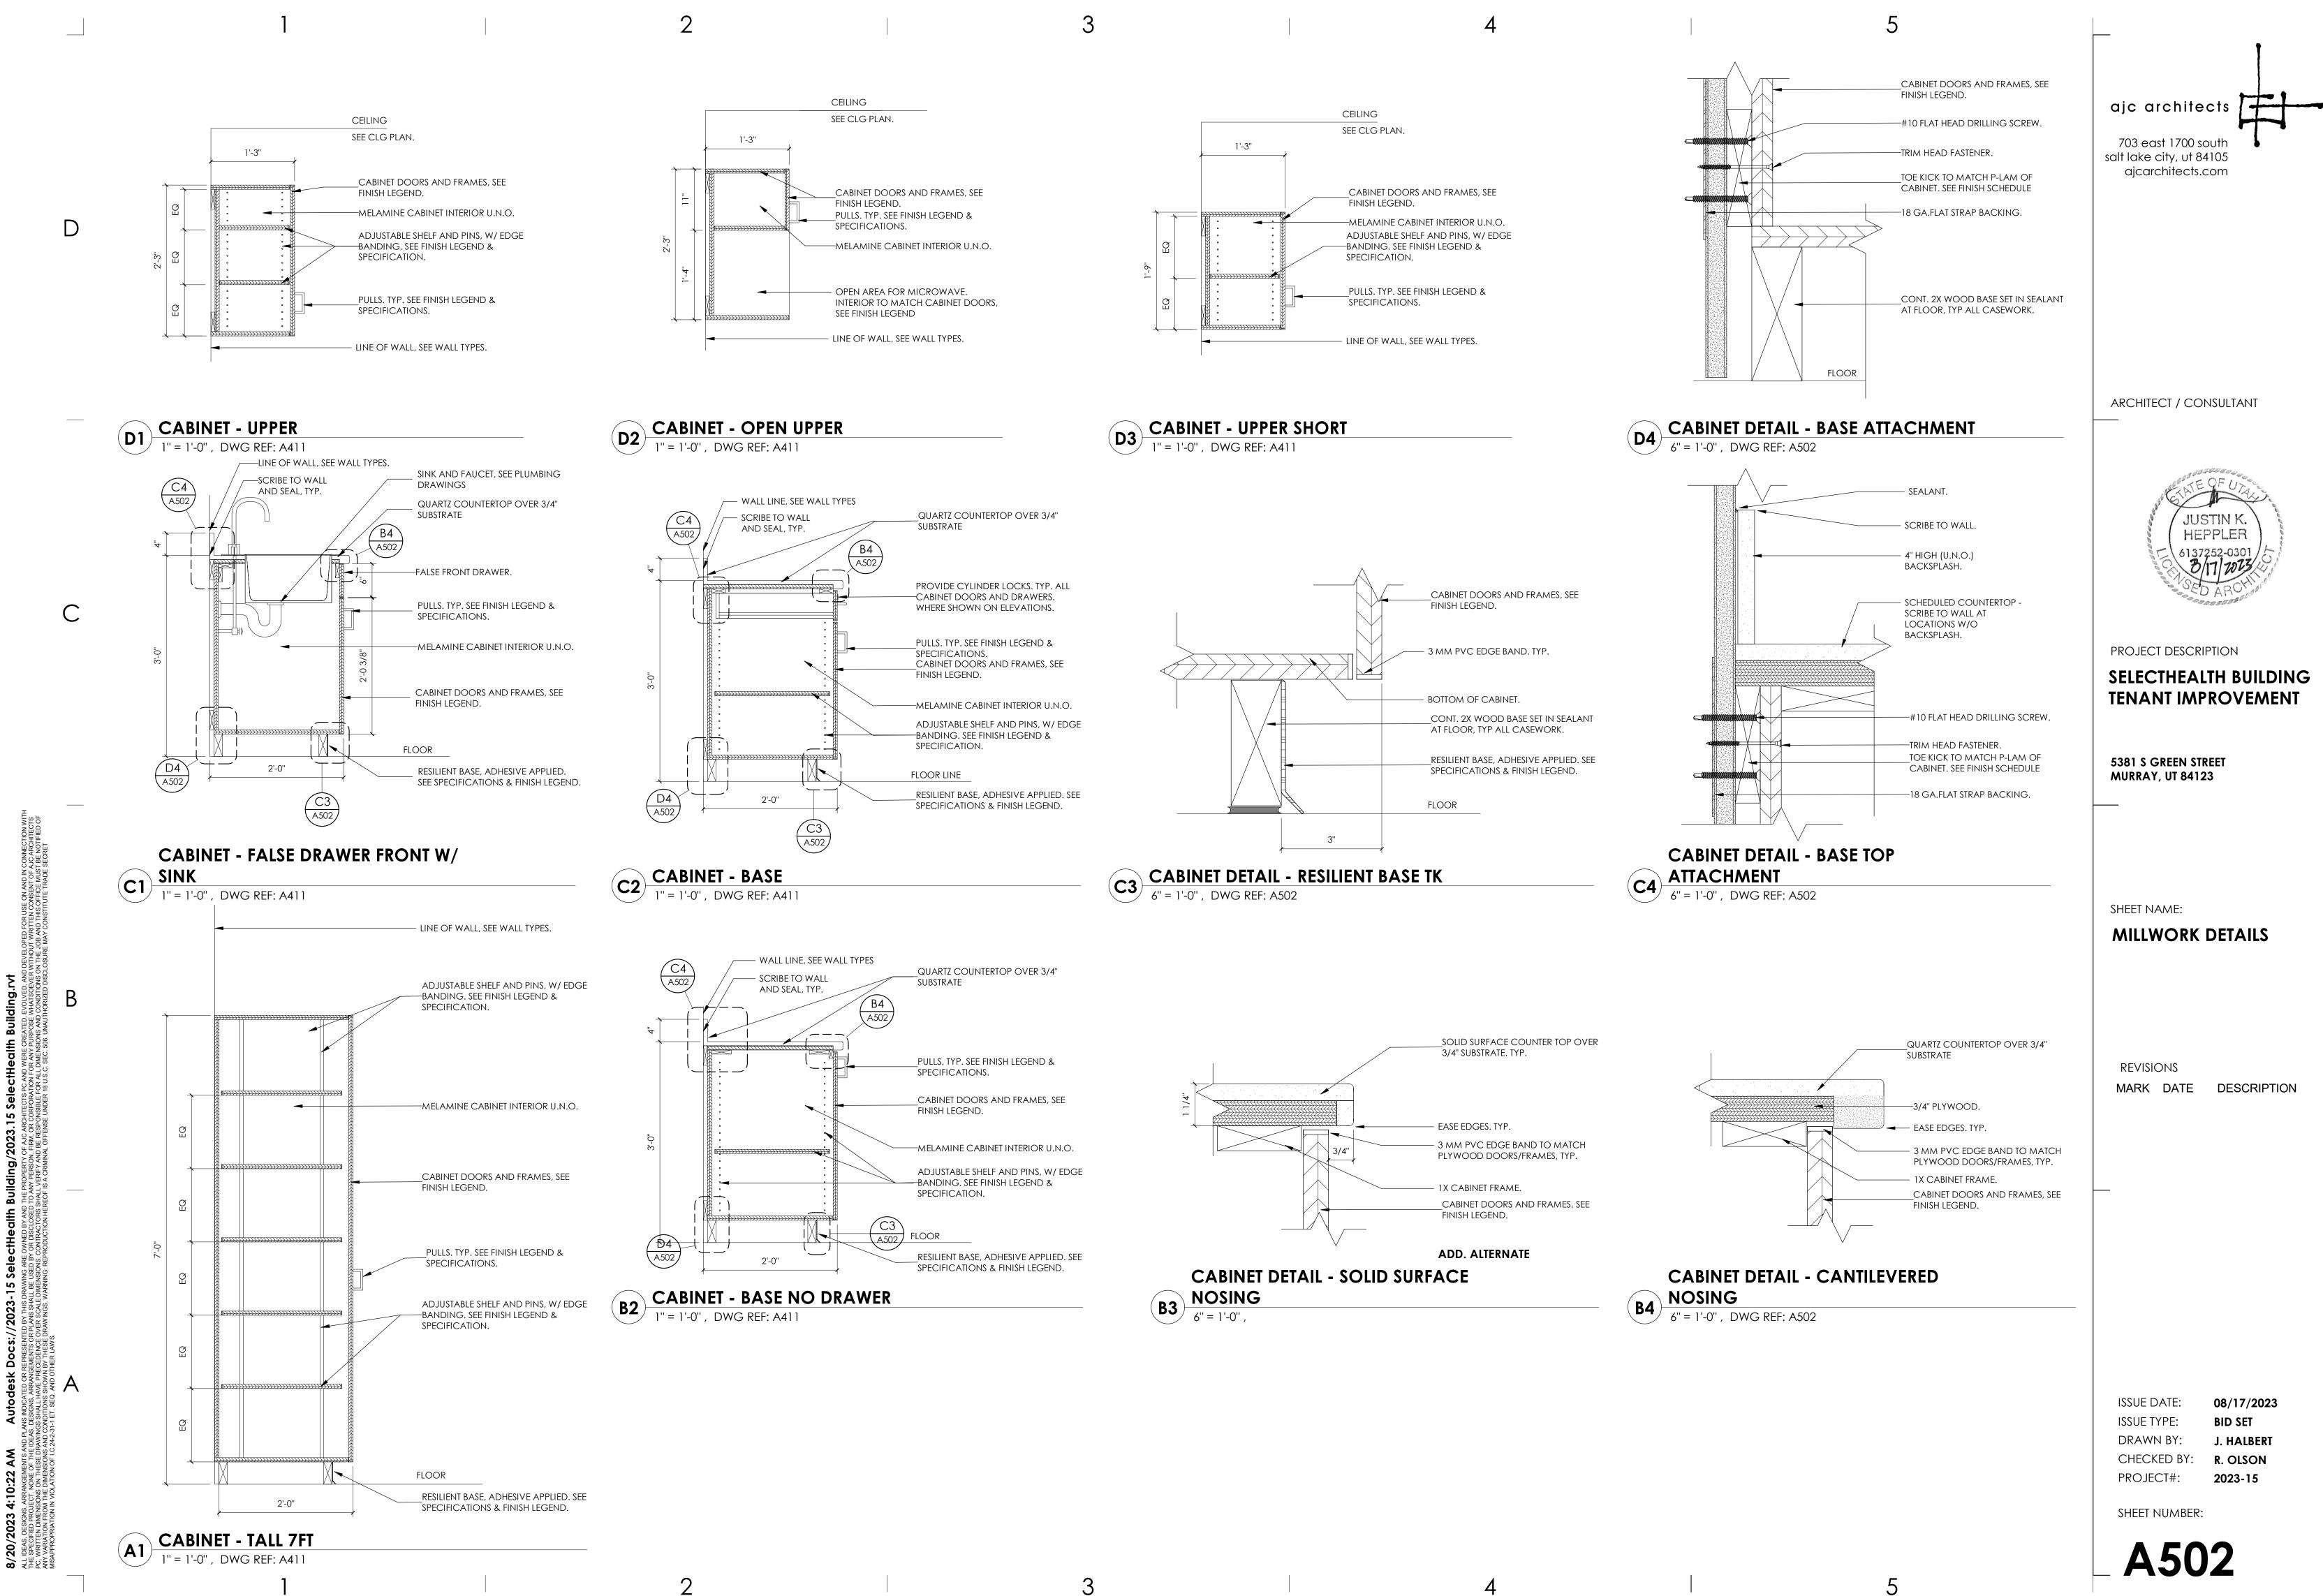






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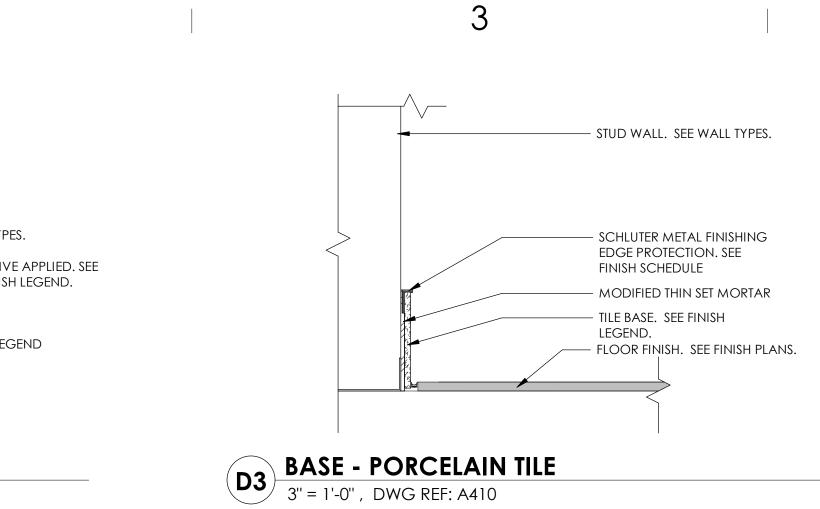
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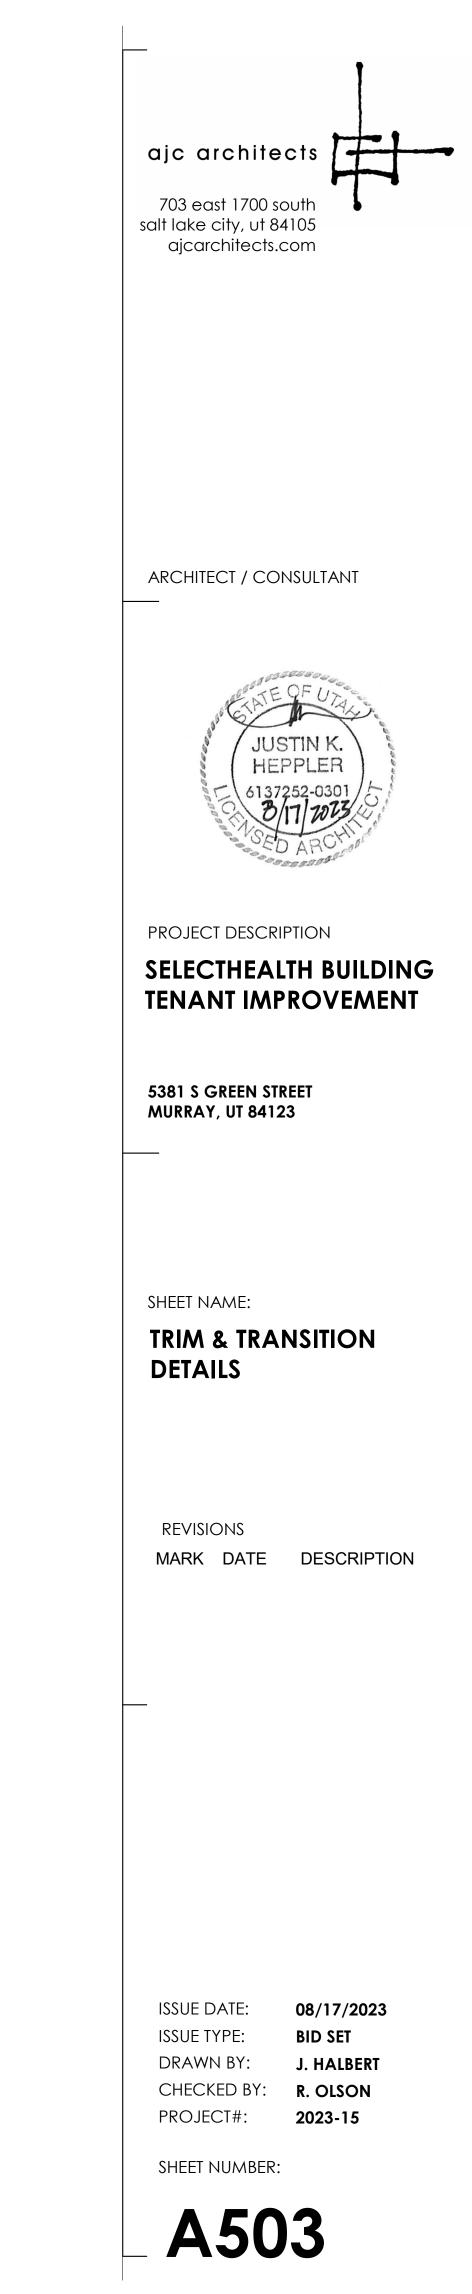
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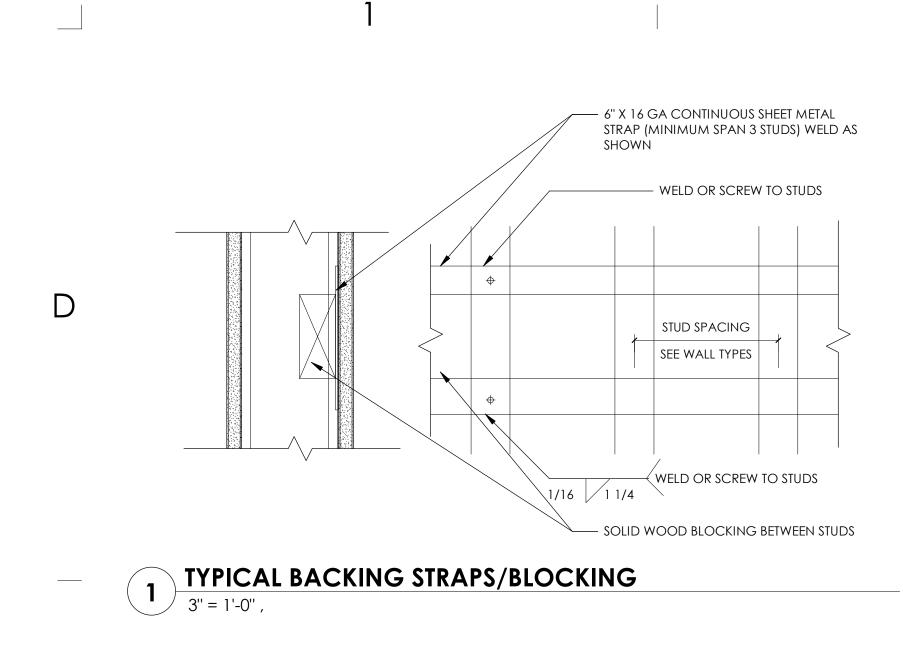


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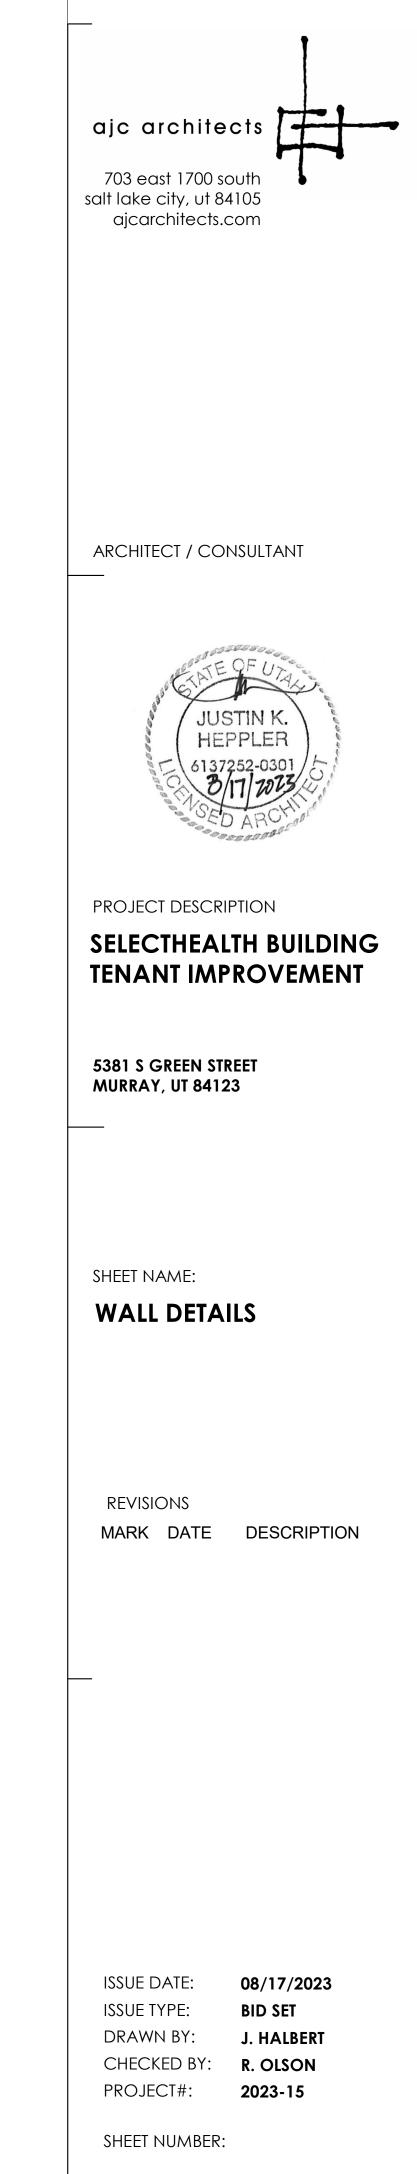







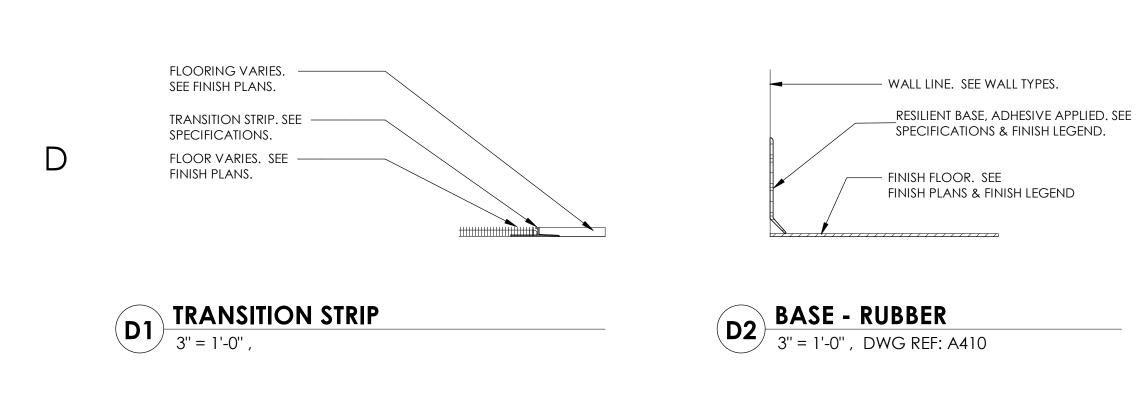





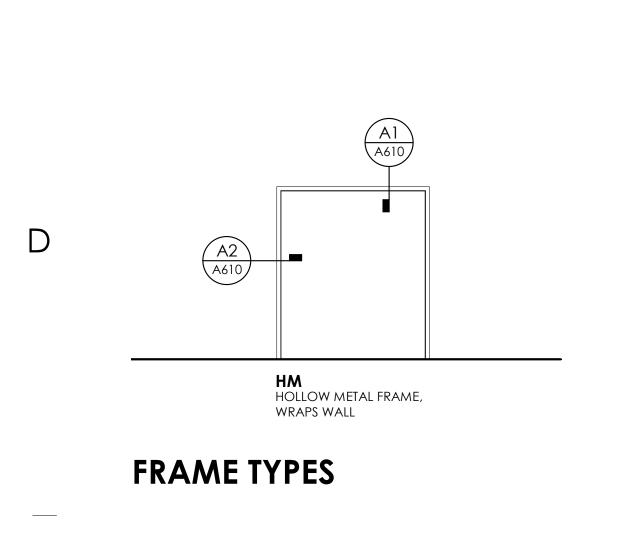

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PWD-VL PAIRED WOOD DOOR W/ **VISION LITE** 

**DOOR TYPES** 



WD-FL

WD SOLID WOOD DOOR W/SOLID WOOD DOOR W/FULL LITEFULL LITE



2


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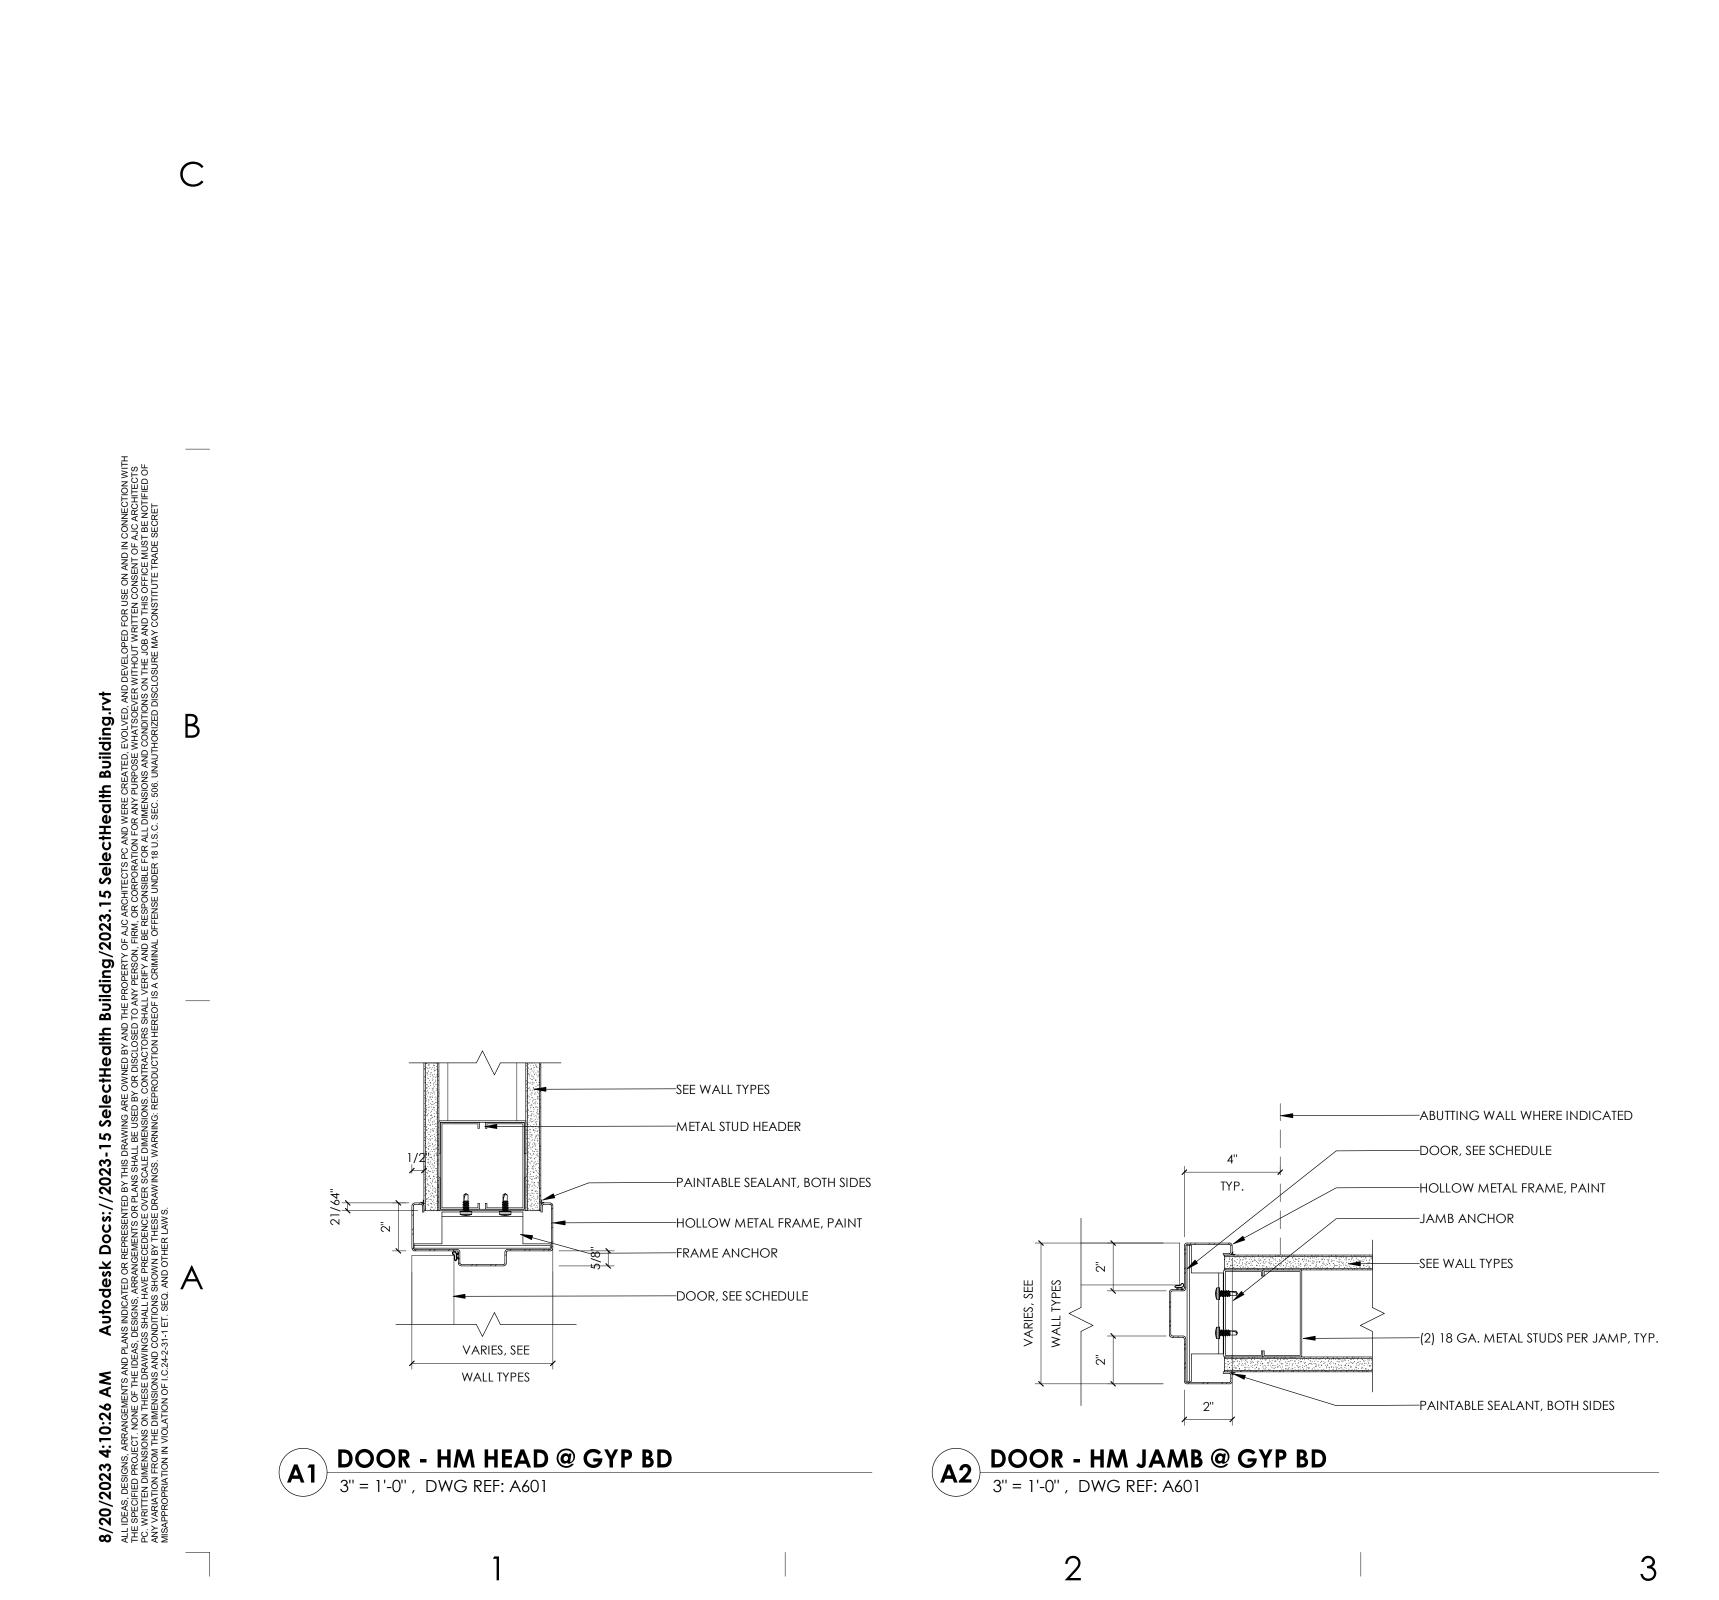
- BASIS OF DESIGN INDICATED BELOW. SEE SPECIFICATIONS. SUBSTITUTIONS MUST BE APPROVED BY ARCHITECT.
- NOTE: CONTRACTOR AND DOOR SUPPLIER TO COORDINATE DOOR UNDER-CUTS WITH MECHANICAL DRAWINGS FOR ADEQUATE VENTILATION.
- ADEQUATE VENITIATION. DOOR HARDWARE SHALL MEET THE REQUIREMENTS OF IBC 1010.1.9.1. HARDWARE SHALL NOT REQUIRE PINCHING, TIGHT GRASPING, OR TWISTING OF THE WRIST IN ORDER TO OPERATE. FIELD VERIFY ALL DOOR OPENINGS AND CLEARANCES PRIOR TO DOOR FABRICATION AND INSTALLATION. VERIFY ALL THROAT WIDTHS OF FRAMES WITH WALL TYPES AS INDICATED ON PLAN DRAWINGS. REFER TO SPECIFICATION FOR DOOR HARDWARE SETS.

- REFER TO FINISH SCHEDULE FOR DOOR AND FRAME FINISH DESCRIPTIONS

	DOOR & FRAME SCHEDULE									
	PANEL FRAME GENERAL INFO									
DOOR NO.	WIDTH	HEIGHT	TYPE	FINISH	GLASS LITE	ТҮРЕ	FINISH	HARDWARE SET	FIRE RATING	COMMENTS
						•				
[E]001	6'-0''	8'-0''	PWD	D1	EXISTING	HM-F	D2	REFER TO SHEET G002	existing	EXISTING TO BE RESURFACED, REFER TO FINISH LEGEND
[E]002	6'-0''	8'-0''	PWD	D3	EXISTING	HM-F	D4	REFER TO SHEET G002	existing	EXISTING TO BE RESURFACED, REFER TO FINISH LEGEND
[E]003	6'-0''	7'-0''	PHM	D5	EXISTING	HM-W	D5	REFER TO SHEET G002	existing	Specify cylinder hardware
[E]004	6'-0''	7'-0''	PHM	D5	existing	HM-W	D5	REFER TO SHEET G002	existing	Specify cylinder hardware
[E]005	6'-0''	7'-0''	PHM	D5	existing	HM-W	D5	REFER TO SHEET G002	existing	Specify cylinder hardware
[E]006	6'-0''	7'-0''	PHM	D5	existing	HM-W	D5	REFER TO SHEET G002	existing	Specify cylinder hardware
[E]007	6'-0''	7'-0''	PHM	D5	existing	HM-W	D5	REFER TO SHEET G002	existing	Specify cylinder hardware
[N]100	3'-0''	7'-0''	WD-FL	TBD		WD-R	D5	REFER TO SHEET G002	20 MIN.	Specify cylinder hardware
[N]102	3'-0''	7'-0''	WD	TBD		WD-R	D5	REFER TO SHEET G002	N/A	
[N]103	3'-0''	7'-0''	WD	TBD		WD-R	D5	REFER TO SHEET G002	N/A	
[N]104	3'-0''	7'-0''	WD	TBD		WD-R	D5	REFER TO SHEET G002	N/A	
[N]105	3'-0''	7'-0''	WD	TBD		WD-R	D5	REFER TO SHEET G002	N/A	
[N]106	3'-0''	7'-0''	WD	TBD		WD-R	D5	REFER TO SHEET G002	N/A	



A601

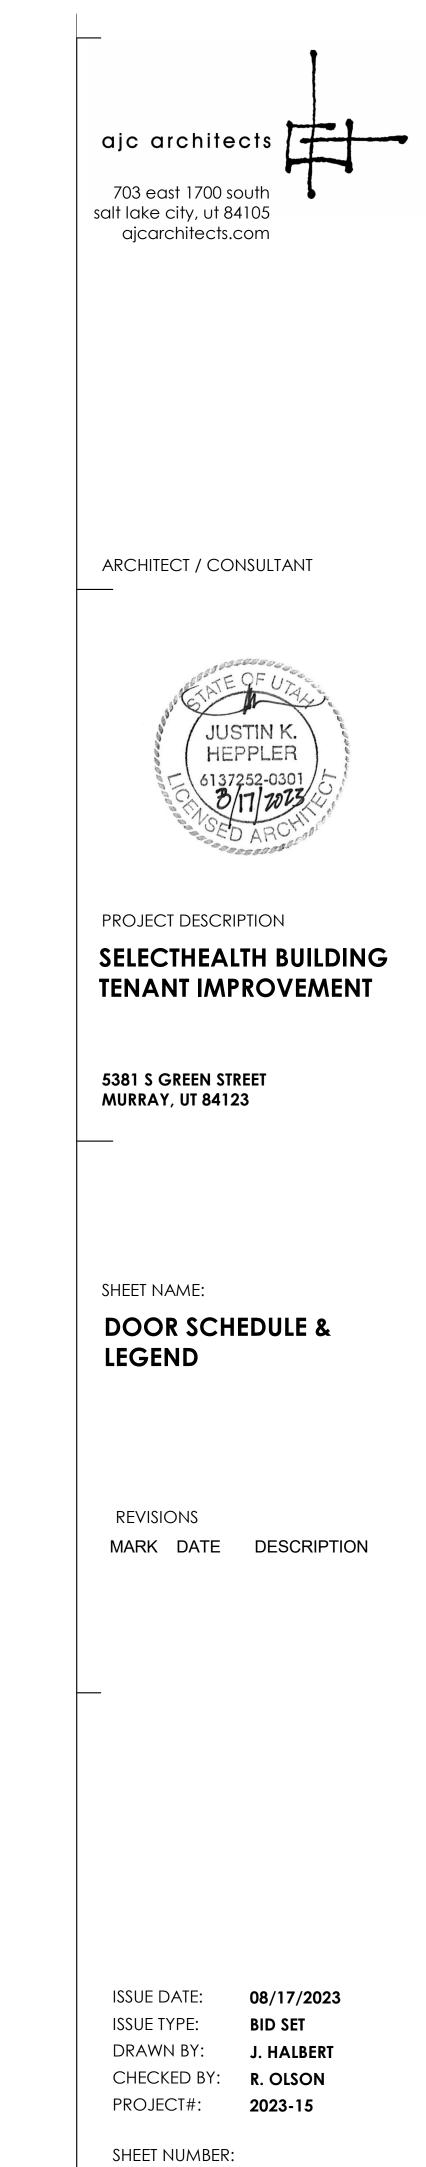

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		CABINET HARDWARE CABINET HARDWARE	ITEM		DCATIONS YEE BREAKROOP		NSTALL EXISTING	CABINET HARDWARE CABINET HARDWARE
	D				EQUIF	PMENT	SCHE	DULE
		COUNTER ELECTRIC DISF	ITEM 'ENSER - EXTERNAL CARBONATI	ION (CED 1500)		MFR.	QUANITY 2	ROOM BREAKROOMS
	С							
NNECTION WITH S ARCHITECTS E NOTIFIED OF CRET								
VELOPED FOR USE ON AND IN CC HOUT WRITTEN CONSENT OF AJ HE JOB AND THEN OFFICE MUST URE MAY CONSTITUTE TRADE SE								
SelectHealth Building.rvt Ects pc and were created, evolved, and de Reoration For any purpose whatsoever wit sible For all Dimensions and conditions on i NDER 18 U.S.C. SEC. 506. UNAUTHORIZED DISCLOS	В							
<b>2023.15 SelectHec</b> of AJC ARCHITECTS PC AND WE I, FIRM. OR CORPORATION FOR A ID BE RESPONSIBLE FOR ALL DIM ID BFENSE UNDER 18 U.S.C. SE								
<b>C†Health Building/2023.15</b> OWNED BY AND THE PROPERTY OF AUC ARCHI OWNED BY AND THE PROPERTY OF AUC ARCHI CONTECTORS SHALL VERIEY AND BE RESPON RODUCTION HEREOF IS A CRIMINAL OFFENSE U								
<b>CS://2023-15 Sele</b> SENTED BY THIS DRAWING ARE IS OR PLANS SHALL BE USED BY VICE OVER SCALE DIMENSIONS. CESE DRAWINGS. WARNING: REPR AWS.								
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<b>8/20/2023 11:43:56 AM Autodesk Docs://2023-15 SelectHealth Building/2023.15 SelectHealth Building.rvt</b> ALL DEAS, DESIGNS, ARRANGEMENTS AND PLANS INDICATED OR REPRESENTED BY THIS DRAWING ARE OWNED BY AND THE PROPERTY OF AJC ARCHITECTS PC AND WREE CREATED, EVOLVED, AND DEVELOPED FOR USE ON AND IN CONNECTION WITH THE SPECIFIC PROJECT, NONE OF THE DRAWINGS SHALL HAVE REPRESENTED BY THIS DRAWING FROM THE PROPERTY OF AJC ARCHITECTS PC AND WREE CREATED, EVOLVED, AND DEVELOPED FOR USE ON AND IN CONNECTION WITH THE SPECIFIC PROJECT, NONE OF THE DEAS, DESIONS, ARRANGEMENTS OR PLANS SHALL HAVE REPRESENT OF AJC ARCHITECTS TO KINTTEN DIMENSIONS ON THESE DRAWINGS SHALL HAVE RECEDENCE OVER SCALE DIMENSIONS, CONTRACTORS SHALL HAVE RECEDENCE OVER SCALE DIMENSIONS, CONTRACTORS SHALL VEREY AND BE RESPONSIBLE FOR ALL DIMENSIONS AND CONDITIONS SHALL HAVE RECEDENCE OVER SCALE DIMENSIONS, CONTRACTORS SHALL VEREY AND BE RESPONSIBLE FOR ALL DIMENSIONS AND CONDITIONS SHALL HAVE RECEDENCE OVER SCALE DIMENSIONS, CONTRACTORS SHALL VEREY AND BE RESPONSIBLE FOR ALL DIMENSIONS AND CONDITIONS SHALL HAVE RECEDENCE OVER SCALE DIMENSIONS, CONTRACTORS SHALL VEREY AND BE RESPONSIBLE FOR ALL DIMENSIONS AND CONDITIONS SHALL HAVE RECEDENCE OVER SCALE DIMENSIONS, CONTRACTORS SHALL VEREY AND BE RESPONSIBLE FOR ALL DIMENSIONS AND CONDITIONS SHALL HAVE RECEDENCE OVER SCALE DIMENSIONS, CONTRACTORS SHALL VEREY AND BE RESPONSIBLE FOR ALL DIMENSIONS AND CONDITIONS SHALL HAVE RECEDENCE OVER SCALE DIMENSIONS, CONTRACTORS SHALL VEREY AND BE RESPONSIBLE FOR ALL DIMENSIONS AND CONDITIONS SHALL HAVE RECEDENCE OVER SCALE DIMENSIONS, CONTRACTORS SHALL VEREY AND BE RESPONSIBLE FOR ALL DIMENSIONS AND CONDITIONS SHALL HAVE RECEDENCE OVER SCALE DIMENSIONS, CONTRACTORS SHALL VEREY AND BE RESPONSIBLE FOR ALL DIMENSIONS AND CONDITIONS SHALL HAVE RECEDING WANT OF AND								
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NOTE RE ON NEW CABINETS ARE ON NEW CABINETS

NOTE O.F.C.I.

BASIS OF DESIGN INDICATED BELOW. SEE SPECIFICATIONS FOR FURTHER INFORMATION ON ALL FINISH ITEMS. SUBSTITUTIONS MUST BE APPROVED BY ARCHITECT.

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			FINISH	LEGEND
ID	PRODUCT	MANUFACTURER	LOCATION	
BASE			1	
DAJE	EXISTING TO REMAIN	EXISTING TO REMAIN	VARIES	
 B1	STAINLESS STEEL BASE	TBD	LOBBY PERIMETER	TBD
B1 B2	PORCELAIN TILE BASE	DALTILE	VARIES	COLLECTION: EM BASE; GROUT: CU ALUMINUM, COL
B3	RESILIENT WALL BASE	TARKETT	VARIES	29 MOONROCK
B4	RESILIENT WALL BASE	TARKETT	VARIES	55 SILVER GREY
CASEWORK				
-	PLASTIC LAMINATE	MATCH EXISTING	EMPLOYEE BREAKROOM	MATCH EXISTING
CW1	PLASTIC LAMINATE	WILSONART	BREAKROOM(S)	TITANIUM ALLOY,
CW2	QUARTZ	CORIAN	EXECUTIVE BREAKROOM	STRATUS WHITE
CW3	SOLID SURFACE	CORIAN	EMPLOYEE BREAKROOM	ARTISTA CANVAS
CEILING				
C1	ACOUSTIC CEILING PANEL	MATCH EXISTING BLDG. SPEC.	VARIES	24" x 48", REPLAC
C2	ACOUSTIC CEILING PANEL		VARIES	24" x 24", REPLAC
C3	ACOUSTIC CEILING PANEL		VARIES	
			1	
DOOR D1	ARCHITECTURAL FILM	3M <sup>™</sup> DI-NOC <sup>™</sup> FINE WOOD	ELEVATOR LOBBY	FW-1273
D2	PAINT	SHERWIN WILLIAMS	ELEVATOR LOBBY	SW 7508 TAVERN
D3	ARCHITECTURAL FILM	3M™ DI-NOC™ METALLIC HAIRLINE	ELEVATOR LOBBY	CH-2117
D4	PAINT	SHERWIN WILLIAMS	ELEVATOR LOBBY	SW 7646 FIRST STA
D5	PAINT	SHERWIN WILLIAMS	SOUTH CORRIDOR	SW 7008 ALABAS
		•		
FLOOR	EXISTING TO REMAIN	EXISTING TO REMAIN	VARIES	
F1	ENTRYWAY CARPET TILE	SHAW CONTRACT	VARIES	ALL ACCESS, PAT
F2	CARPET TILE	SHAW CONTRACT	VARIES	LIGHT SERIES, VIBI E:5500D, F:5657D
F3	CARPET TILE	SHAW CONTRACT	VARIES	REINSTALLED SAL
F4	PORCELAIN TILE	DALTILE	VARIES	EMERSON WOOD GROUT: CUSTOM
F5	RUBBER TILE	TARKETT	CORRIDORS	MINERALITY™, PA SILVER
F6	LUXURY VINYL PLANK	SHAW CONTRACT	VARIES	TERRAIN II 0453V, COLOR: 00500 SII
	1			ł
ΡΔΙΝΙΤ				
PAINT P1	PAINT	Sherwin Williams	THROUGHOUT	SW 7008 ALABAST
	PAINT	Sherwin Williams	THROUGHOUT	SW 7008 ALABAS
P1	PAINT ARCHITECTURAL FILM	SHERWIN WILLIAMS	THROUGHOUT	SW 7008 ALABAST FW-1273

LEGEND

DESCRIPTION

COLLECTION: EMERSON WOOD, COLOR: BUTTER PECAN PLANK EP01, MATTE, FIELD CUT TO 4" HIGH FOR BASE; GROUT: CUSTOM BUILDING PRODUCTS COLOR:#145 LIGHT SMOKE; SCHLUTER-JOLLY TRIM, ALUMINUM, COLOR: BRUSHED NICKEL, INSTALLED ON TOP TO BE FLUSH WITH THE TILE 29 MOONROCK

MATCH EXISTING ADJACENT CABINET FACE LAMINATE

TITANIUM ALLOY, 5058K-18, LINEARITY FINISH

24" x 48", REPLACE AS NEEDED

24" x 24", REPLACE AS NEEDED OPTIMA PB CONCEALED, SIZE: 24" x 24" x 7/8", COLOR: 8537PB IN WHITE FACE PROFILE 15/16"

SW 7508 TAVERN TAUPE CH-2117 SW 7646 FIRST STAR

SW 7008 ALABASTER

ALL ACCESS, PATH TILE 5T034, EBONY 34500, SHAWCONTRACT MICRO TRANSITION #267VS, COLOR: 00100 CHAMPAGNE LIGHT SERIES, VIBRANT 5T001, EQUINOX, CUSTOM COLOR FORMULA; A:CF042, B:6025, C:5223D, D:6180, E:5500D, F:5657D, 24"SQ., SHAWCONTRACT MICRO TRANSITION #267VS, COLOR: 00100 CHAMPAGNE

REINSTALLED SALVAGED CARPET TILES, 24" SQ. EMERSON WOOD, BUTTER PECAN EP01, MATTE, 8"x48"

GROUT: CUSTOM BUILDING PRODUCTS COLOR:#145 LIGHT SMOKE MINERALITY™, PA8 META, STRATA 12"x24"; SHAWCONTRACT MICRO TRANSITION #267VS, COLOR: 00500

SILVER TERRAIN II 0453V, ROOT 00568, 6"x48", 12 MIL, 2.5 THICK, SHAWCONTRACT MICRO TRANSITION #267VS, COLOR: 00500 SILVER

SW 7008 ALABASTER



# SELECTHEALTH BUILDING **TENANT IMPROVEMENT**

5381 S GREEN STREET MURRAY, UT 84123

Sheet name:

### FINISH LEGEND, ACCESSORY & EQUIPMENT SCHEDULE


REVISIONS

MARK DATE DESCRIPTION


ISSUE DATE: ISSUE TYPE: DRAWN BY: CHECKED BY: R. OLSON PROJECT#: 2023-15

08/17/2023 **BID SET** J. HALBERT




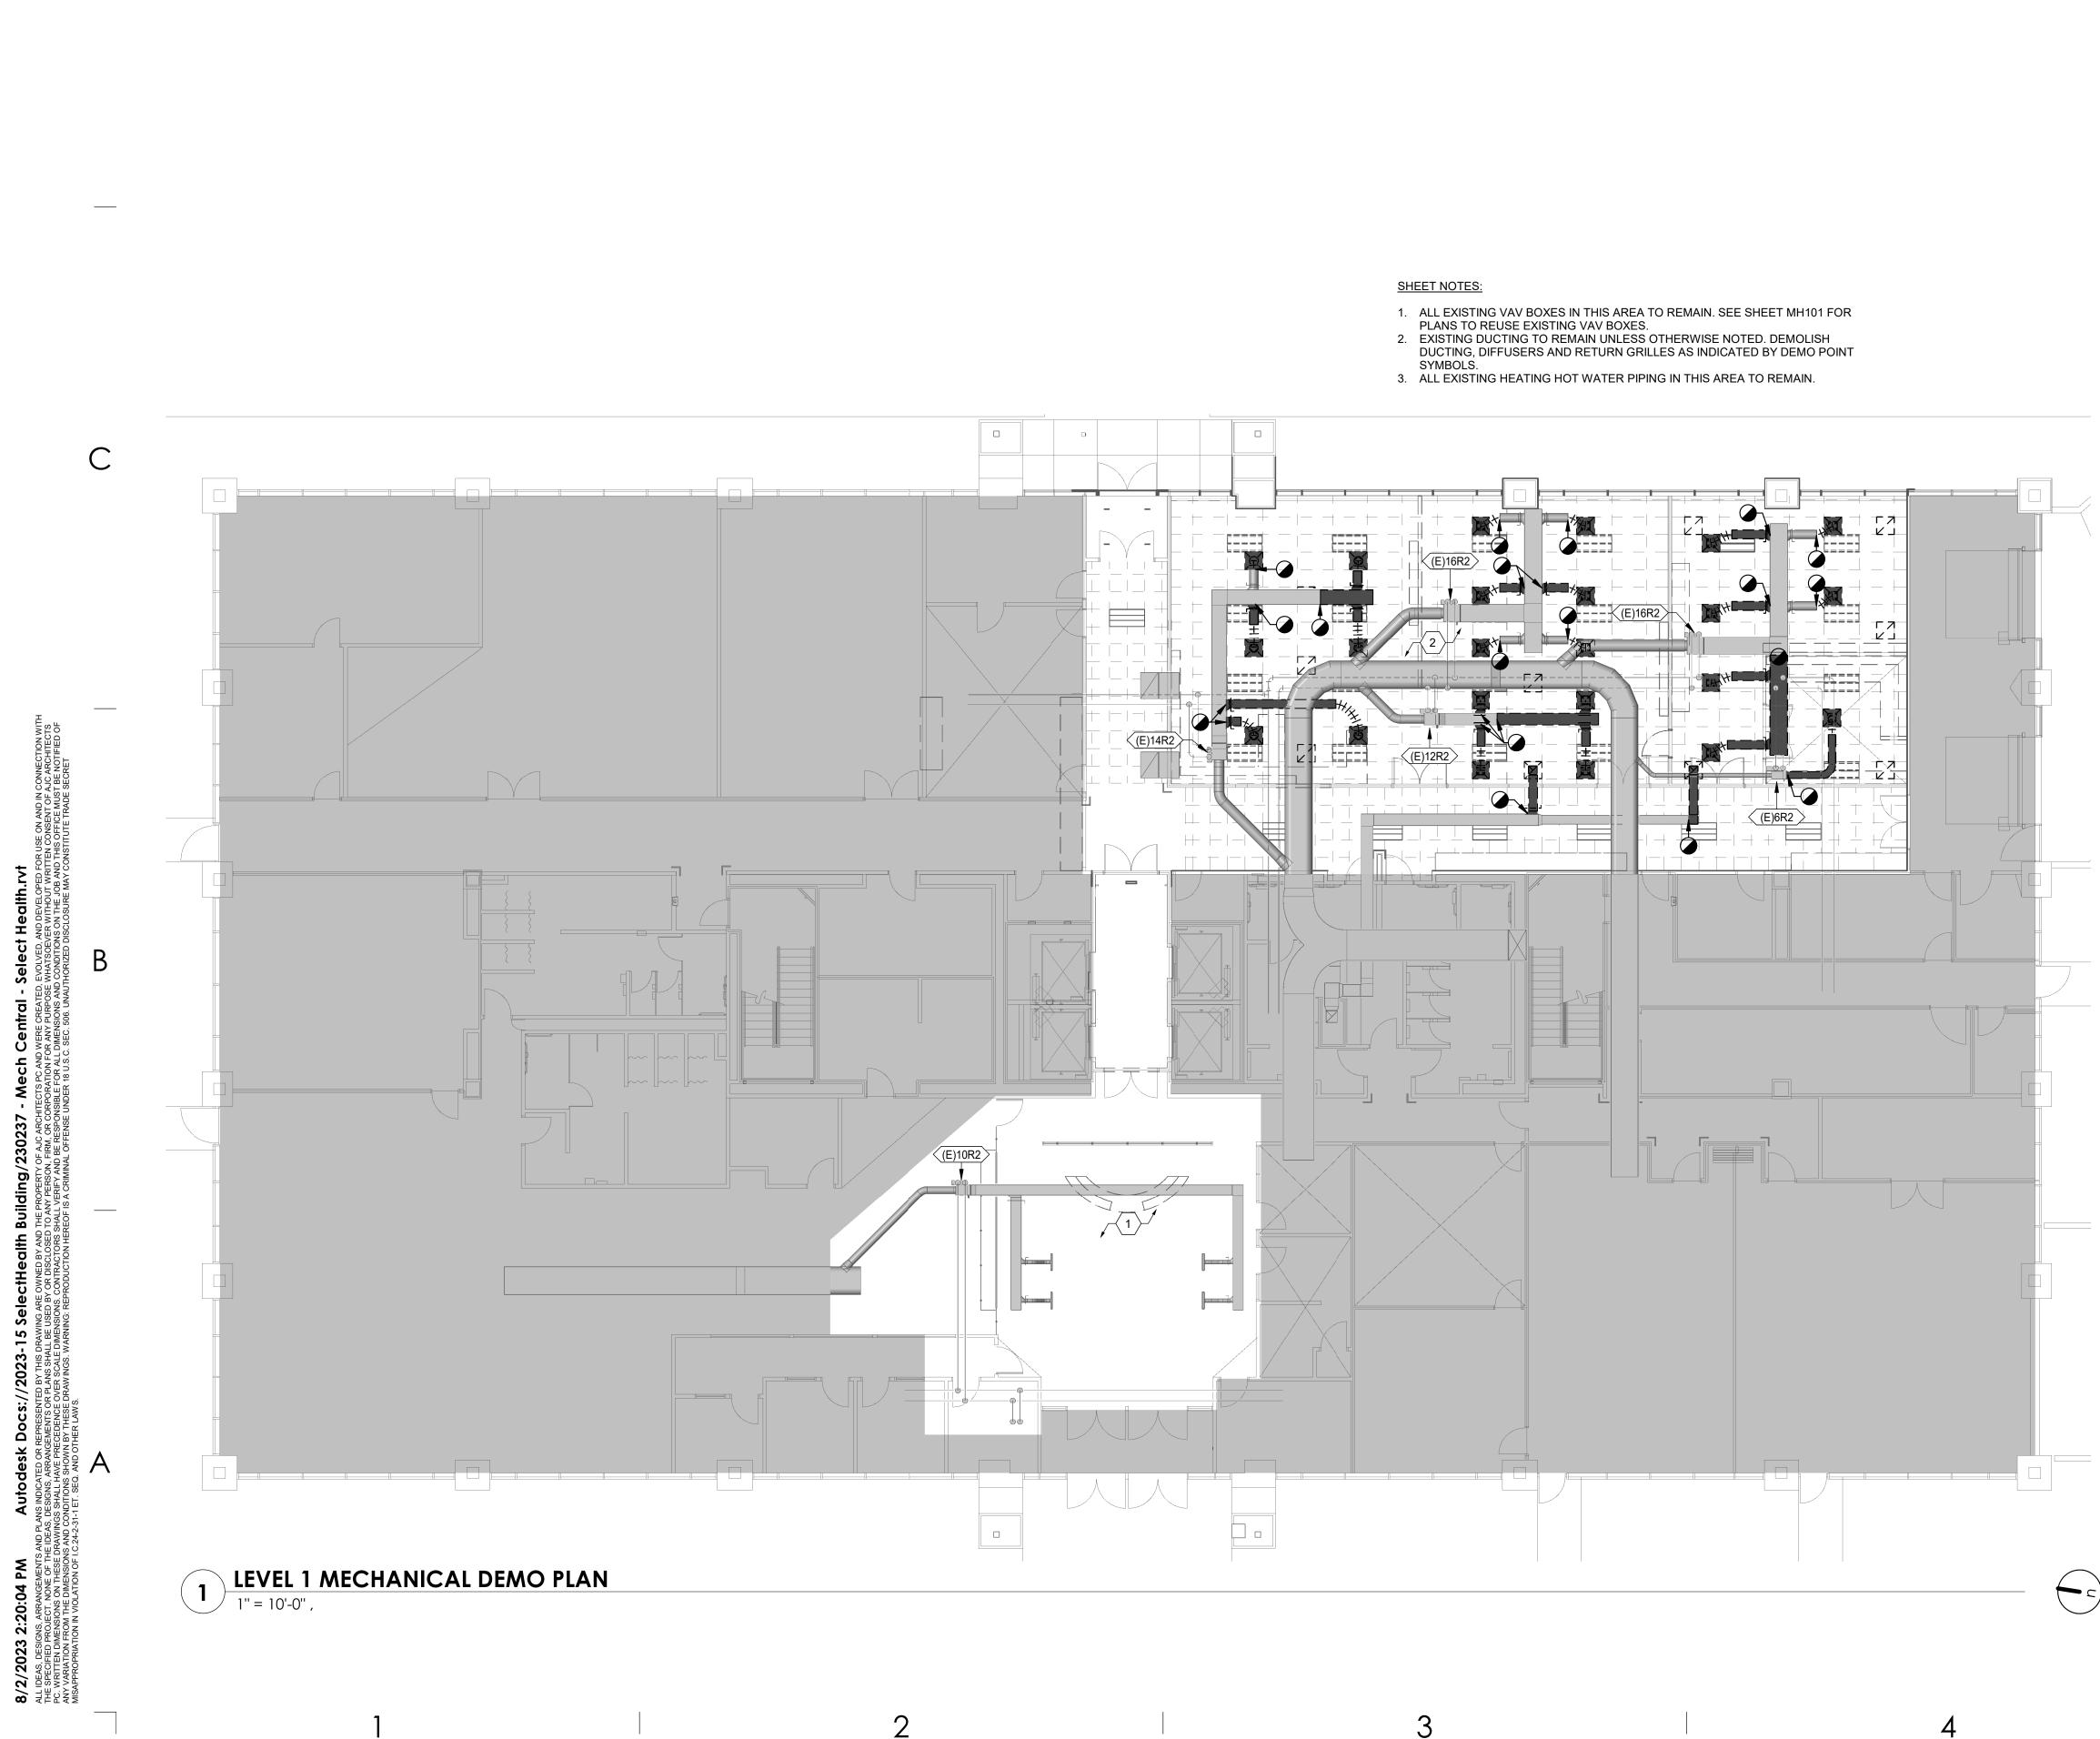


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**MD101** 

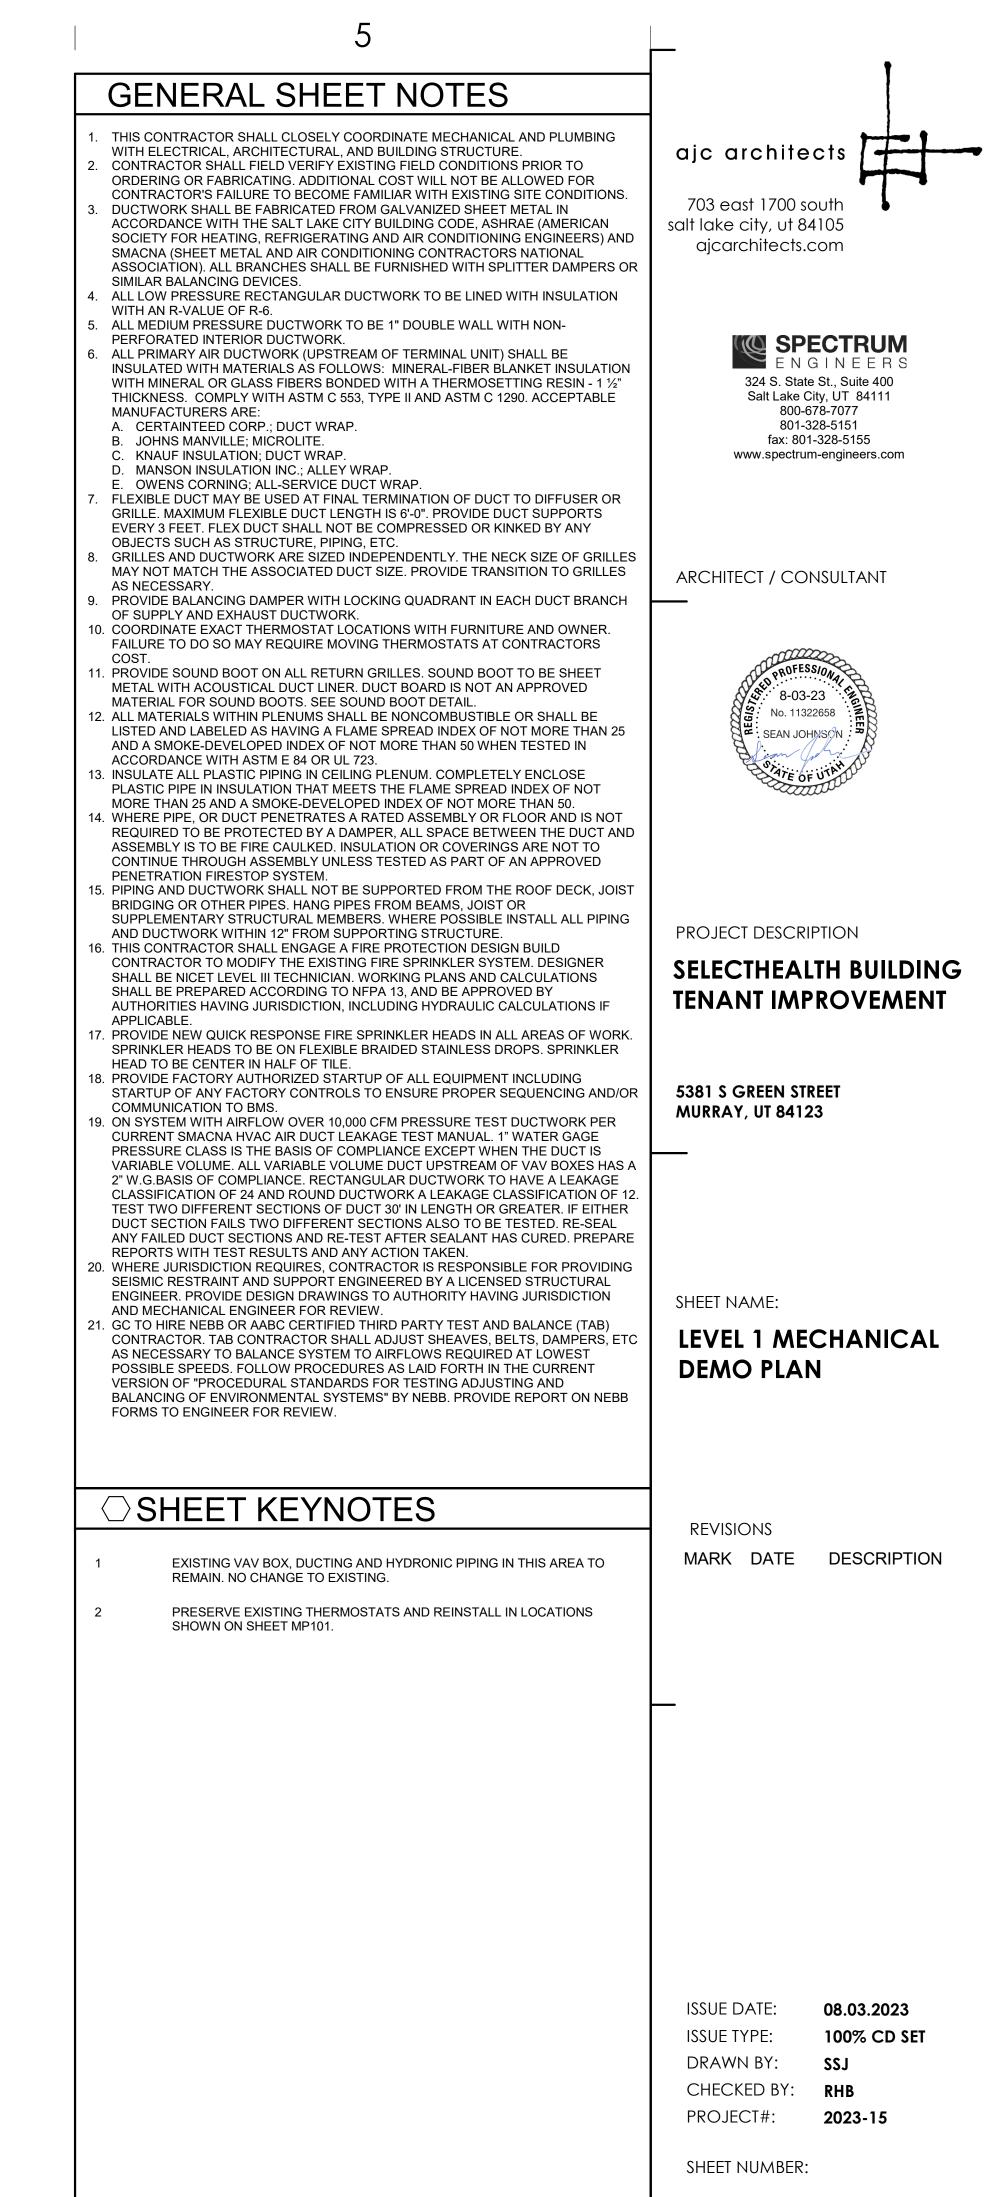

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**MD103** 

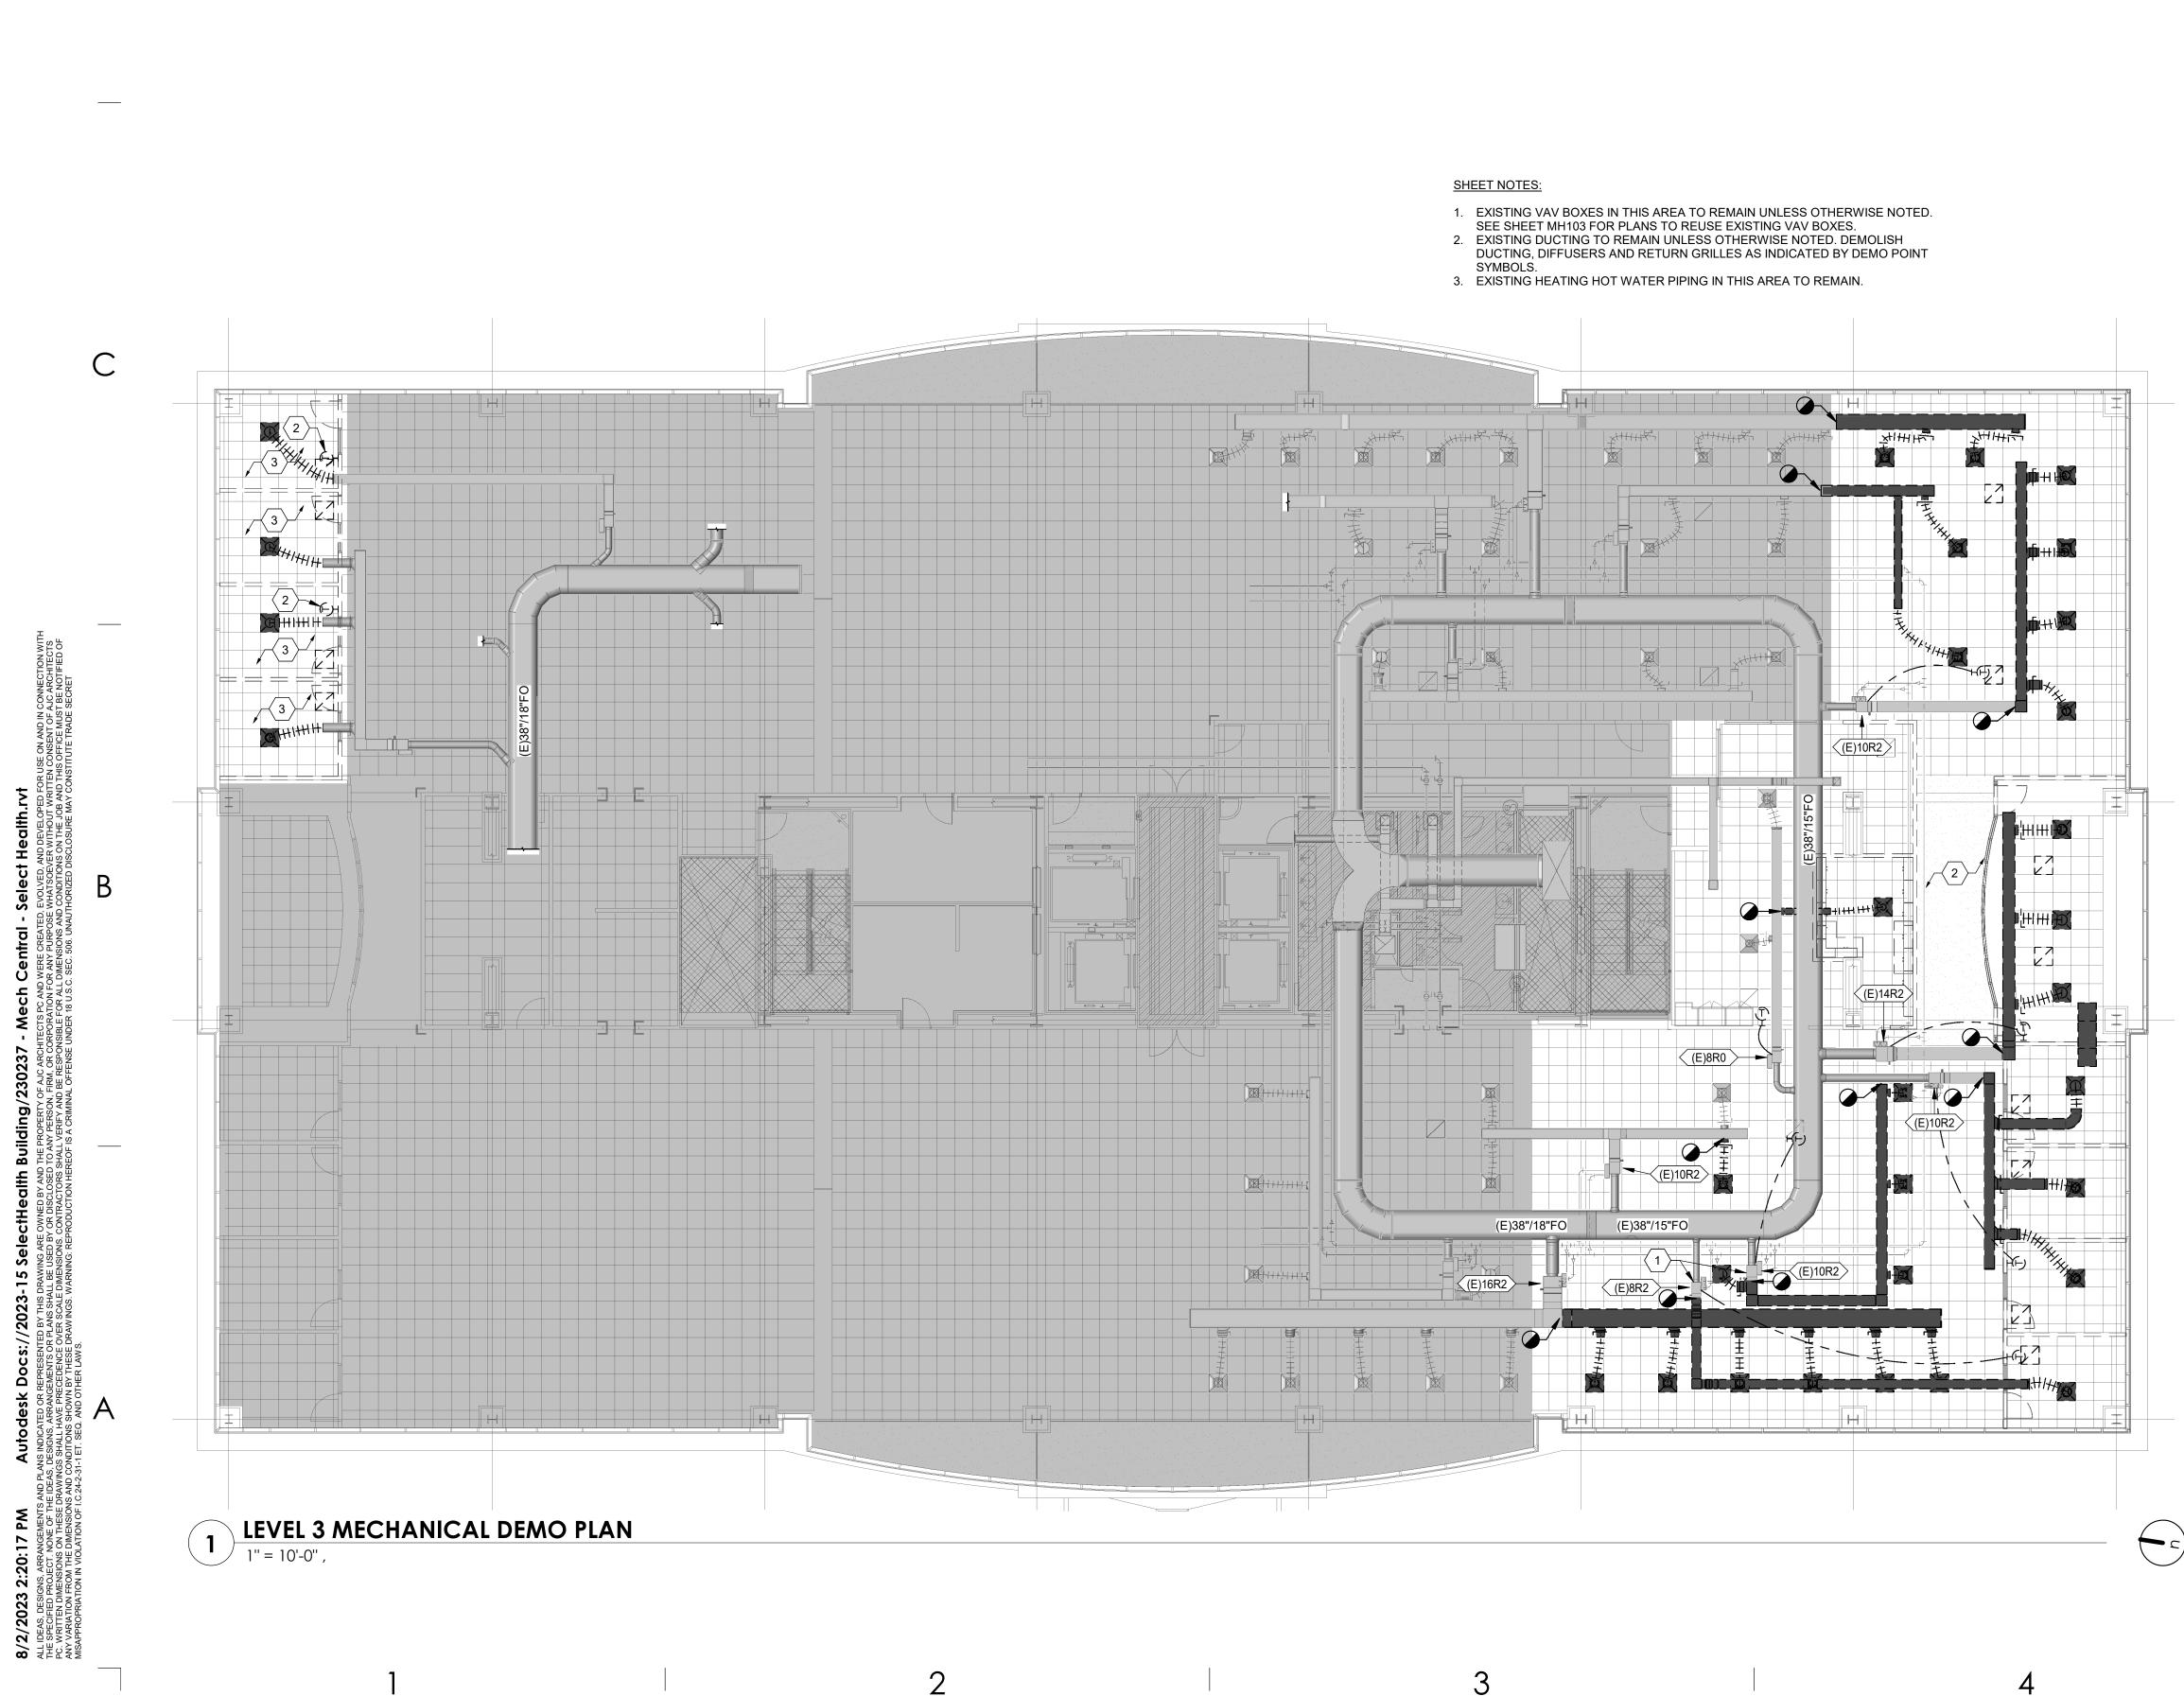		GEND - PIPING	SVMROL LEOE	ND - DUCTWORK		PING LEGEND
		IONS MAY NOT BE USED.		TIONS MAY NOT BE USED.		L ABBREVIATIONS MAY NOT BE USED.
	SYMBOL	DESCRIPTION	SYMBOL	DESCRIPTION	ABBREVIATION	
		SHUT OFF VALVE				CHILLED WATER RETURN
		GATE VALVE		RECTANGULAR SUPPLY DUCT UP		CHILLED WATER SUPPLY
		CHECK VALVE				COMPRESSED AIR
		AUTOMATIC 2-WAY VALVE		RECTANGULAR SUPPLY DUCT DOWN		CONDENSATE DRAIN
D		AUTOMATIC 3-WAY VALVE				
D				RECTANGULAR RETURN DUCT UP		
		GLOBE VALVE				CONDENSER WATER RETURN
	φ t.	BALL VALVE		RECTANGULAR RETURN DUCT DOWN		CONDENSER WATER SUPPLY
		RELIEF VALVE			FP F	FIRE PROTECTION
		PRESSURE REDUCING VALVE		RECTANGULAR EXHAUST DUCT UP	FOR F	FUEL OIL RETURN
		BUTTERFLY VALVE			FOS F	FUEL OIL SUPPLY
		SOLENOID VALVE		RECTANGULAR EXHAUST DUCT DOWN	FOV F	FUEL OIL VENT
		ANGLE VALVE			GR (	GLYCOL RETURN
		VENTURI VALVE		ROUND SUPPLY DUCT UP	GS (	GLYCOL SUPPLY
	$\boxtimes$	BALANCING OR PLUG COCK		NOUND SUFFET DUCT OF	HPC	HIGH PRESSURE CONDENSATE
	$\boxtimes$	FLOW SETTER			MPC N	MEDIUM PRESSURE CONDENSATE
	$\otimes$	EXPANSION VALVE		ROUND SUPPLY DUCT DOWN	LPC L	LOW PRESSURE CONDENSATE
	$\overline{\nabla}$	GAS COCK			HPS	HIGH PRESSURE STEAM
		MANUAL AIR VENT		ROUND RETURN DUCT UP	MPS N	MEDIUM PRESSURE STEAM
		STRAINER			LPS-LPS-LPS-LPS-LPS-LPS-LPS-LPS-LPS-LPS-	LOW PRESSURE STEAM
$\sim$	От	GAUGE COCK		ROUND RETURN DUCT DOWN	HHWR—	HEATING HOT WATER RETURN
C		FLEXIBLE CONNECTION				HEATING HOT WATER SUPPLY
	<u> </u>	PRESSURE GAUGE		ROUND EXHAUST DUCT UP		LIQUID PROPANE GAS
		THERMOMETER				LOW PRESSURE STEAM
		PIPE REDUCER		ROUND EXHAUST DUCT DOWN		MEDICAL AIR
		REFRIGERANT SITE GLASS				
		REFRIGERANT STRAINER		OVAL SUPPLY DUCT UP		
		REFRIGERANT FILTER DRIER	E E E	OVAL SUPPLY DUCT DOWN		OXYGEN
	o	90 DEGREE ELBOW UP			PC F	PUMPED CONDENSATE
		90 DEGREE ELBOW DOWN		OVAL RETURN DUCT UP	RG F	REFRIGERANT GAS
	O	90 DEGREE TEE UP			RL F	REFRIGERANT LIQUID
		90 DEGREE TEE DOWN		OVAL RETURN DUCT DOWN	SMRS	SNOW MELT RETURN
		PIPE UNION			SMS S	SNOW MELT SUPPLY
		PIPE CAP		OVAL EXHAUST DUCT UP	VAC \	VACUUM
	×	PIPE ANCHOR				
D		FLOAT AND THERMOSTATIC TRAP		OVAL EXHAUST DUCT DOWN	SVMB	OL LEGEND - MEC
В				OVAL EXHAUST DUCT DOWN		LLABBREVIATIONS MAY NOT BE USED.
		EGEND - MISC			SYMBO	
		NES AND SYMBOLS		SPIRAL OVAL DUCT		SQUARE OR RECTANGULA
	SYMBOL DESCRIPTION	NES AND STWDOLS				SUPPLY DIFFUSER
				SPIRAL ROUND DUCT		SQUARE OR RECTANGULAI RETURN DIFFUSER
		CATOR: # INDICATES DETAIL NUMBER, RAWING SHEET WHERE VIEW OR DETAIL	<u> </u>			SQUARE OR RECTANGULAR
				DUCT INSULATION		EXHAUST DIFFUSER
	NUMBER, SHEET IND	ION INDICATOR: # INDICATES VIEW ICATES DRAWING SHEET WHERE VIEW IS				ROUND DIFFUSER
				DUCT LINING		LINEAR SLOT GRILLE OR DI
A				90° RECTANGULAR ELBOW WITH TURNING VANES		FLEXIBLE DUCT
		<u> </u>				
	XX-## PLUMBING FIXTURE I	NDICATOR		90° ROUND RADIUS ELBOW		SIDEWALL GRILLE OR REGI
	EQUIPMENT INDICAT	OR				• · ·
	TAG CFM REGISTER, GRILLE, C	R DIFFUSER INDICATOR				DUCT HIGH EFFICIENCY TA
٨	OR BREAKLINE			GORED OVAL RADIUS ELBOW		
A	MATCH LINE SEE XX/XXX MATCHLINE INDICATO	DR				BALANCING DAMPER
	CONTRACT LIMIT LIN	E: DASHDOT, WIDE LINE				
	NEW CONNECTION T	O EXISTING		DUCT SIZE OR SHAPE TRANSITION		FIRE DAMPER
	POINT OF DEMOLITIC	N	<u> </u>			
				DUCT TO BE DEMOLISHED		FIRE / SMOKE COMBINATIO
						DAMPER

	ABBREVIATIONS
	NOTE: ALL ABBREVIATIONS MAY NOT BE USED.
(E) (F)	EXISTING FUTURE
AC	AIR CONDITION(-ING,-ED)
APD	AIR PRESSURE DROP
BD BHP	BALANCING DAMPER BRAKE HORSE POWER
BTU	BRITISH THERMAL UNIT
BTUH	BTU/HOUR
CFH CFM	CUBIC FEET PER HOUR CUBIC FEET PER MINUTE
CV	CONTROL VALVE
DB	DRY BULB TEMPERATURE
DCW DHW	DOMESTIC COLD WATER DOMESTIC HOT WATER
DHWR	DOMESTIC HOT WATER RECIRC
DP	DEPTH, DEEP, OR DROP IN PRESSURE
EA EER	EXHAUST AIR ENERGY EFFICIENCY RATIO
EFF	EFFICIENCY
ELEC	ELECTRIC
ELEV ENT	ELEVATION ENTERING
EVAP	EVAPORAT(-E, -ING, -ED, -OR)
EWT	ENTERING WATER TEMPERATURE
EXT	
FD FLA	FIRE DAMPER FULL LOAD AMPS
FPI	FINS PER INCH
FPM	FEET PER MINUTE
FPS FSD	FEET PER SECOND FIRE SMOKE DAMPER
GE	GREASE EXHAUST
GPH	GALLONS PER HOUR
GPM HD	GALLONS PER MINUTE HEAD
HG	MERCURY
HP	HORSEPOWER
HR HTG	HOUR HEATING
HZ	HERTZ (FREQUENCY)
IN	INCH
KW LAT	KILOWATT LEAVING AIR TEMPERATURE
LAT	POUNDS
LH	LATENT HEAT
LRA LVG	LOCKED ROTOR AMPS LEAVING
LWT	LEAVING LEAVING WATER TEMPERATURE
MBH	THOUSAND BTU PER HOUR
MCA MFR	MINIMUM CIRCUIT AMPS MANUFACTUR(-ER, -ED)
NC	NORMALLY CLOSED OR NOISE CRITERIA
NIC	NOT IN CONTRACT
NO NPSH	NORMALLY OPEN NET POSITIVE SUCTION HEAD
NTS	NOT TO SCALE
OA	OUTSIDE AIR
OD OZ	OUTSIDE DIAMETER OUNCE
PD	PRESSURE DROP OR DIFFERENCE
PG	PROPOLENE GLYCOL
PH PPM	PHASE PARTS PER MILLION
PSF	POUNDS PER SQUARE FOOT
PSI	POUNDS PER SQUARE INCH
PSIA PSIG	PSI ABSOLUTE
RA	PSI GAUGE RETURN AIR
RECIRC	RECIRCULATE (-ER, -ED, -ING)
REFR REQD	REFRIGERATION REQUIRED
RLA	RATED LOAD AMPS
RPM	REVOLUTIONS PER MINUTE
SA SCFM	SUPPLY AIR STANDARD CUBIC FEET PER MINUTE
SCW	SOFT COLD WATER
SH	SENSIBLE HEAT
SP SPEC(S)	STATIC PRESSURE SPECIFICATION(S)
SQ	SQUARE
STD	STANDARD
SW TA(R)	SOIL, WASTE TRANSFER AIR (RETURN)
TA(S)	TRANSFER AIR (SUPPLY)
TD	TEMP. DROP OR DIFF.
TEMP TOT	TEMPERATURE TOTAL
TSTAT	THERMOSTAT
V	VOLT, VOLTAGE OR VENT
VAC VAV	VACUUM VARIABLE AIR VOLUME
VEL	VARIABLE AIR VOLUME VELOCITY
VENT	VENT, VENTILATION
VERT VFD	VERTICAL VARIABLE FREQUENCY DRIVE
VED VOL	VARIABLE FREQUENCY DRIVE
VTR	VENT THROUGH ROOF
WB WC	WET BULB TEMP WATER COLUMN
WG	WATER GAUGE
WPD	WATER PRESSURE DROP
WTR	WATER

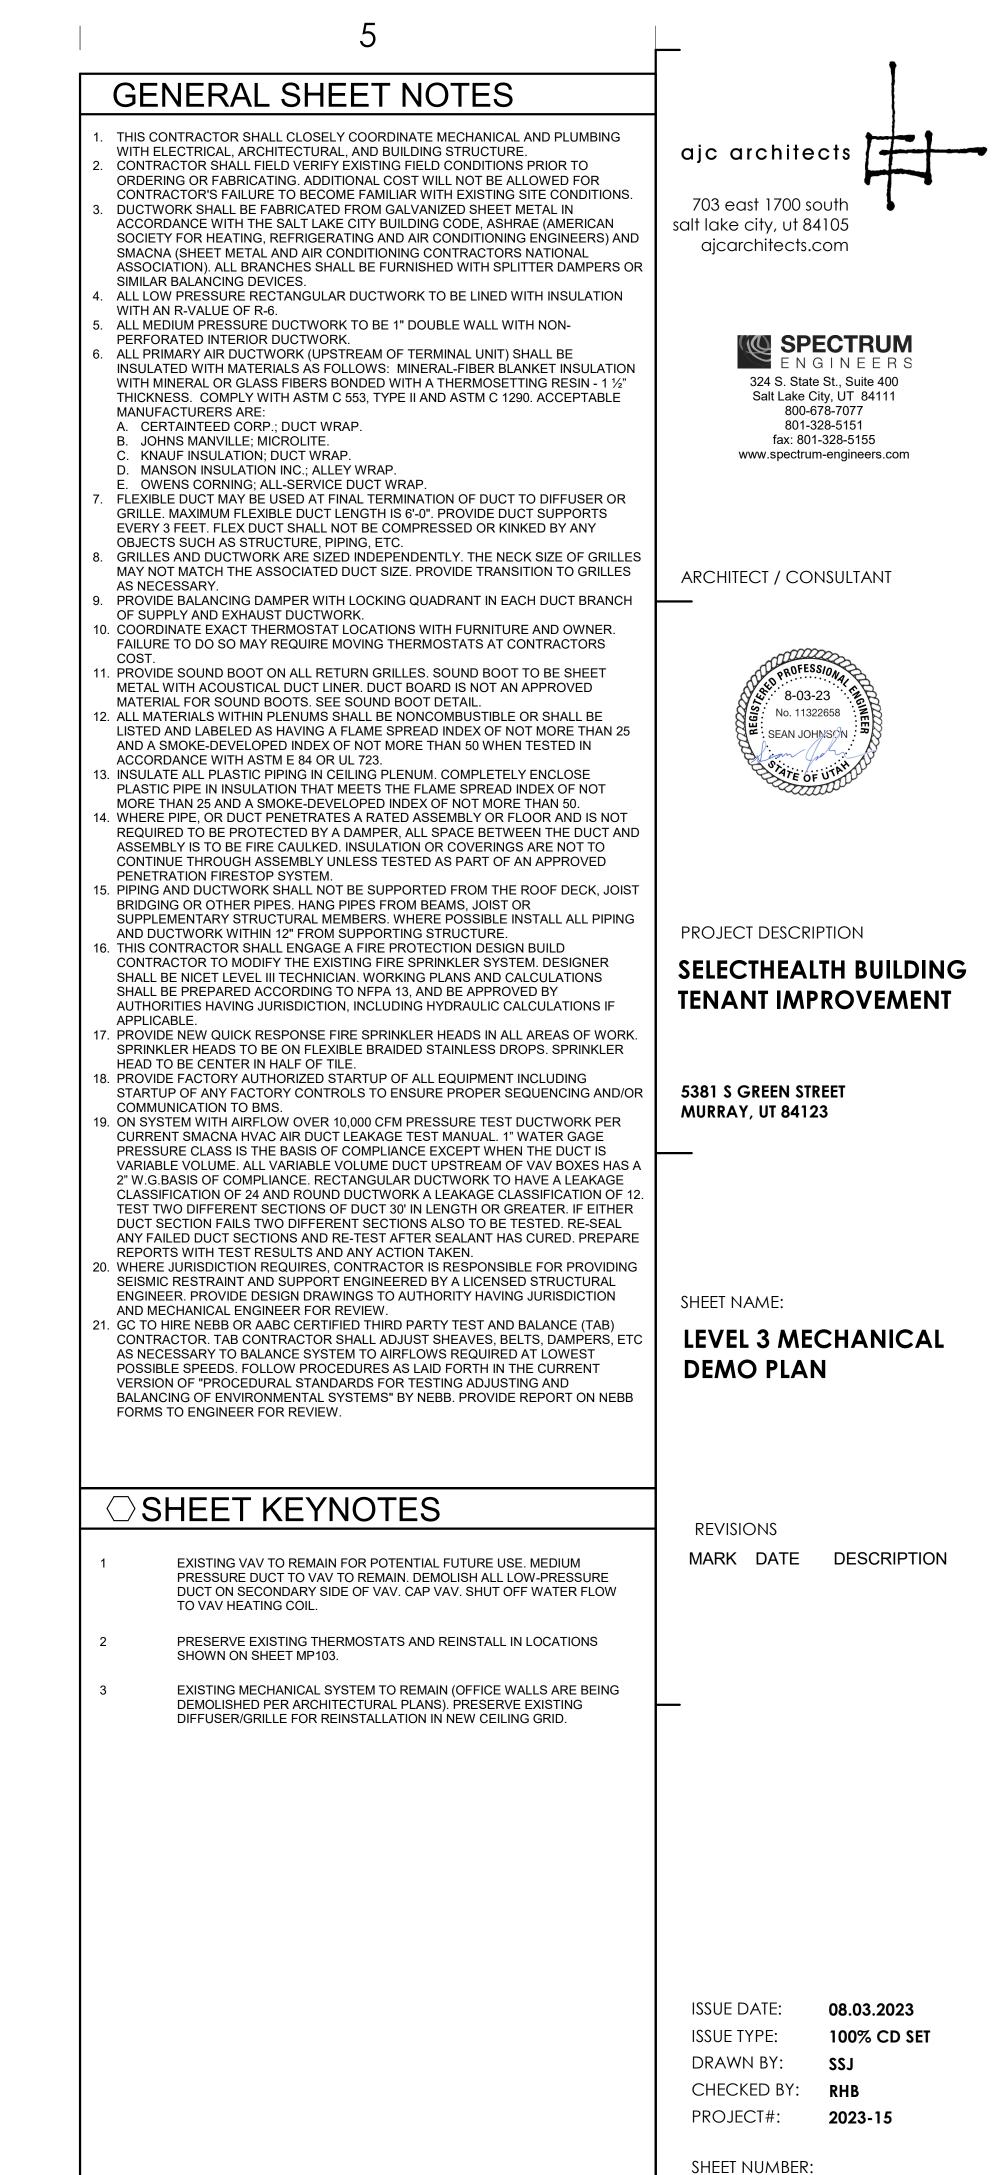4

### MECHANICAL GENERAL NOTES THE MECHANICAL DRAWINGS SHOW THE GENERAL DESIGN, ARRANGEMENT, & EXTENT OF THE MECHANICAL SYSTEM. BECAUSE OF THE SMALL SCALE OF THE DRAWINGS, THESE DRAWINGS DO NOT SHOW ALL OFFSETS, BENDS, OR ajc architects ELBOWS NECESSARY FOR THE COMPLETE INSTALLATION IN THE SPACE PROVIDED. CONTRACTOR SHALL MAKE ALTERATIONS AS MAY BE NECESSARY TO MAKE THE SYSTEM COMPLETE & OPERATIONAL IN ACCORDANCE WITH THE DESIGN INTENT. 2. MAJOR DEVIATIONS SUCH AS CHANGES IN SIZES, WEIGHTS, QUANTITIES, OR salt lake city, ut 84105 MATERIAL REQUIRE PRIOR APPROVAL BY THE DESIGN ENGINEER. THE DRAWINGS & SPECIFICATIONS HAVE BEEN PREPARED TO SUPPLEMENT EACH OTHER & SHALL BE INTERPRETED AS AN INTEGRAL UNIT WITH THE ITEMS SHOWN ON ONE & NOT THE OTHER BEING FURNISHED & INSTALLED AS THOUGH SHOWN AND CALLED OUT IN BOTH DOCUMENTS. THE ENTIRE MECHANICAL INSTALLATION SHALL CONFORM TO THE REQUIREMENTS OF THE MOST RECENTLY ADOPTED BUILDING CODES. MECHANICAL CODE, PLUMBING CODE, ELECTRICAL CODE, & ALL OTHER APPLICABLE CITY, COUNTY, STATE, & FEDERAL CODES & REGULATIONS IN EFFECT. 5. THE ENTIRE MECHANICAL INSTALLATION SHALL CONFORM TO ALL CODES, RULES, REGULATIONS, & REQUIREMENTS OF THE BUILDING OWNER. 6. ALL MECHANICAL COMPONENTS AND EQUIPMENT SHALL BE INSTALLED TO CONFORM WITH ANY APPLICABLE LOCAL SEISMIC REQUIREMENTS. PRIOR TO FABRICATION & INSTALLATION OF ANY MECHANICAL COMPONENT THE CONTRACTOR SHALL COORDINATE THE INSTALLATION OF ALL MECHANICAL WORK WITH ALL OTHER BUILDING TRADES, INCLUDING BUILDING TRADES HIRED DIRECTLY BY THE OWNER. WHERE CONFLICTS MAY OCCUR, THEY SHALL BE RESOLVED PRIOR TO INSTALLATION. 8. VERIFY ALL REQUIRED SERVICE CONNECTIONS, INCLUDING ELECTRICAL CHARACTERISTICS, FOR ALL EQUIPMENT PRIOR TO ORDERING OR FABRICATING MECHANICAL EQUIPMENT AND COMPONENTS. . THE SPACE ABOVE CEILINGS IS LIMITED. CAREFUL COORDINATION IS REQUIRED WITH ALL TRADES BEFORE ANY PIPE, DUCT, OR EQUIPMENT IS ORDERED &/OR INSTALLED. ANY CONFLICTS &/OR CHANGES FOUND DURING INSTALLATION THAT RESULTS FROM THE LACK OF COORDINATION BY THE CONTRACTORS DURING THE SHOP DRAWING PROCESS ARE THE RESPONSIBILITY OF THE CONTRACTOR. 10. ALL MECHANICAL INFORMATION IS NOT SHOWN ON THE MECHANICAL DRAWINGS. THE CONTRACTOR SHALL BE RESPONSIBLE FOR COORDINATION OF ALL INFORMATION ON ALL OTHER CONSTRUCTION DOCUMENTS. 11. THE CONTRACTOR SHALL BE RESPONSIBLE TO REVIEW & USE, WHERE APROPRIATE, ALL THE MECHANICAL DETAILS SHOWN ON THE DRAWINGS. DETAILS MAY OR MAY NOT BE CALLED OUT ON THE DRAWINGS WITH SYMBOLS OR KEYED NOTES. ANY CHANGES RESULTING FROM FAILURE TO INSTALL THE MECHANICAL SYSTEM WITHOUT USING THE INCLUDED DETAILS SHALL BE THE RESPONSIBILITY OF THE CONTRACTOR. 12. ALL EQUIPMENT SHALL BE INDEPENDENTLY SUPPORTED FROM STRUCTURAL MEMBERS. STRUCTURAL ELEMENTS SHOWN IN DETAILS MAY OR MAY NOT PERTAIN TO ANY PORTION OF THE BUILDING. COORDINATE ALL MOUNTING REQUIREMENTS WITH ARCHITECTURAL & STRUCTURAL DRAWINGS AND SPECIFICATIONS. 13. ALL MECHANICAL COMPONENTS AND EQUIPMENT SHALL BE INSTALLED IN ACCORDANCE WITH ALL MANUFACTURER RECOMMENDATIONS. 14. ALL SIMILAR EQUIPMENT SHALL BE OF THE SAME MANUFACTURER. AIR INLETS & OUTLETS OF SIMILAR TYPES SHALL BE OF THE SAME MANUFACTURER. 15. ANY PART OF THE MECHANICAL INSTALLATION THAT FAILS, IS DEEMED UNFIT, OR BECOMES DAMAGED DURING CONSTRUCTION SHALL BE REPAIRED OR REPLACED BY THE CONTRACTOR AT NO ADDITIONAL COST TO THE OWNER. THE CONTRACTOR SHALL BE RESPONSIBLE FOR EQUIPMENT CHECK-IN, SAFEKEEPING, & DAMAGE. 16. COORDINATE WITH ARCHITECTURAL REFLECTED CEILING PLAN FOR EXACT LOCATION OF ALL CEILING DIFFUSERS & GRILLES. 17. CONTRACTOR SHALL OPERATE INSTALLED &/OR MODIFIED SYSTEMS & DEMONSTRATE ALL ASPECTS OF THE SYSTEM TO THE ENGINEER &/OR OWNER TO PROVE ALL ASSOCIATED SYSTEMS ARE OPERATIONAL. 18. DURING CONSTRUCTION THE CONTRACTOR SHALL MAINTAIN A SET OF AS-BUILT REDLINED RECORD DRAWINGS AT THE PROJECT SITE. ALL CHANGES OR DEVIATIONS IN LAYOUT, ROUTING, EQUIPMENT, COMPONENTS, & ACCESSORIES SHALL BE RECORDED. THESE REDLINED DRAWINGS SHALL BE GIVEN TO THE ARCHITECT / ENGINEER AFTER THE FINAL INSPECTION IN ACCORDANCE WITH PROJECT SPECIFICATIONS. DEFINITIONS NOTE: ALL DEFINITIONS MAY NOT BE USED. INDICATED: THE TERM "INDICATED" REFERS TO GRAPHIC REPRESENTATIONS, NOTES, OR SCHEDULES ON THE DRAWINGS, OTHER PARAGRAPHS OR SCHEDULES IN THE SPECIFICATIONS, AND SIMILAR REQUIREMENTS IN THE CONTRACT DOCUMENTS. WHERE TERMS SUCH AS "SHOWN", "NOTED", "SCHEDULED", AND "SPECIFIED" ARE USED, IT IS TO HELP THE READER LOCATE THE REFERENCE, NO LIMITATION ON LOCATION IS INTENDED. DIRECTED: TERMS SUCH AS "DIRECTED", "REQUESTED", AUTHORIZED", "SELECTED", "APPROVED", "REQUIRED", AND "PERMITTED" MEAN "DIRECTED BY THE ENGINEER", "REQUESTED BY THE ENGINEER", AND SIMILAR PHRASES. APPROVED: THE TERM "APPROVED", WHERE USED IN CONJUNCTION WITH THE ENGINEER'S ACTION ON THE CONTRACTOR'S SUBMITTALS, APPLICATIONS, AND REQUESTS, IS LIMITED TO THE ENGINEER'S DUTIES AND RESPONSIBILITIES AS STATED IN GENERAL AND SUPPLEMENTARY CONDITIONS. FURNISH: THE TERM "FURNISH" IS USED TO MEAN "SUPPLY AND DELIVER TO THE PROJECT SITE, READY FOR UNLOADING, UNPACKING, ASSEMBLY, INSTALLATION, AND SIMILAR OPERATIONS." INSTALL: THE TERM "INSTALL" IS USED TO DESCRIBE OPERATIONS AT PROJECT SITE INCLUDING THE ACTUAL "UNLOADING, UNPACKING, ASSEMBLY, ERECTION, PLACING, ANCHORING, APPLYING, WORKING TO DIMENSION, FINISHING, CURING, PROTECTING, CLEANING, AND SIMILAR OPERATIONS." PROVIDE: THE TERM "PROVIDE" MEANS "TO FURNISH AND INSTALL, COMPLETE AND READY FOR THE INTENDED USE." INSTALLER: AN "INSTALLER" IS THE CONTRACTOR OR AN ENTITY ENGAGED BY THE CONTRACTOR, EITHER AS AN EMPLOYEE, SUBCONTRACTOR, OR SUB-SUBCONTRACTOR, FOR PERFORMANCE OF A PARTICULAR CONSTRUCTION ACTIVITY, INCLUDING INSTALLATION, ERECTION, APPLICATION, AND SIMILAR OPERATIONS. INSTALLERS ARE REQUIRED TO BE EXPERIENCED IN THE OPERATIONS THEY ARE ENGAGED TO PERFORM. **MECHANICAL SHEET INDEX ME001** MECHANICAL COVER SHEET MECHANICAL DETAILS ME501 ME502 MECHANICAL DETAILS ME503 MECHANICAL DETAILS ME601 MECHANICAL SCHEDULES MD101 LEVEL 1 MECHANICAL DEMO PLAN MD103 LEVEL 3 MECHANICAL DEMO PLAN MH101 LEVEL 1 MECHANICAL PLAN

**SPECTRUM** 📓 E N G I N E E R S 324 S. State St., Suite 400 Salt Lake City, UT 84111 800-678-7077 801-328-5151 fax: 801-328-5155 www.spectrum-engineers.com ARCHITECT / CONSULTANT 8-03-23 No. 11322658 SEAN JOHNS ON PROJECT DESCRIPTION SELECTHEALTH BUILDING **TENANT IMPROVEMENT 5381 S GREEN STREET MURRAY, UT 84123** SHEET NAME:

703 east 1700 south

ajcarchitects.com

MECHANICAL COVER SHEET

REVISIONS MARK DATE DESCRIPTION

ISSUE DATE:	08.03.2023
ISSUE TYPE:	100% CD SE
DRAWN BY:	SSJ
CHECKED BY:	RHB
PROJECT#:	2023-15

SHEET NUMBER:



**LEVEL 2 MECHANICAL PLAN** 

LEVEL 3 MECHANICAL PLAN

LEVELS 4 & 6 MECHANICAL PLANS

LEVEL 1 MECHANICAL PIPING PLAN

LEVEL 3 MECHANICAL PIPING PLAN


MH102


MH103


MH104


MP101


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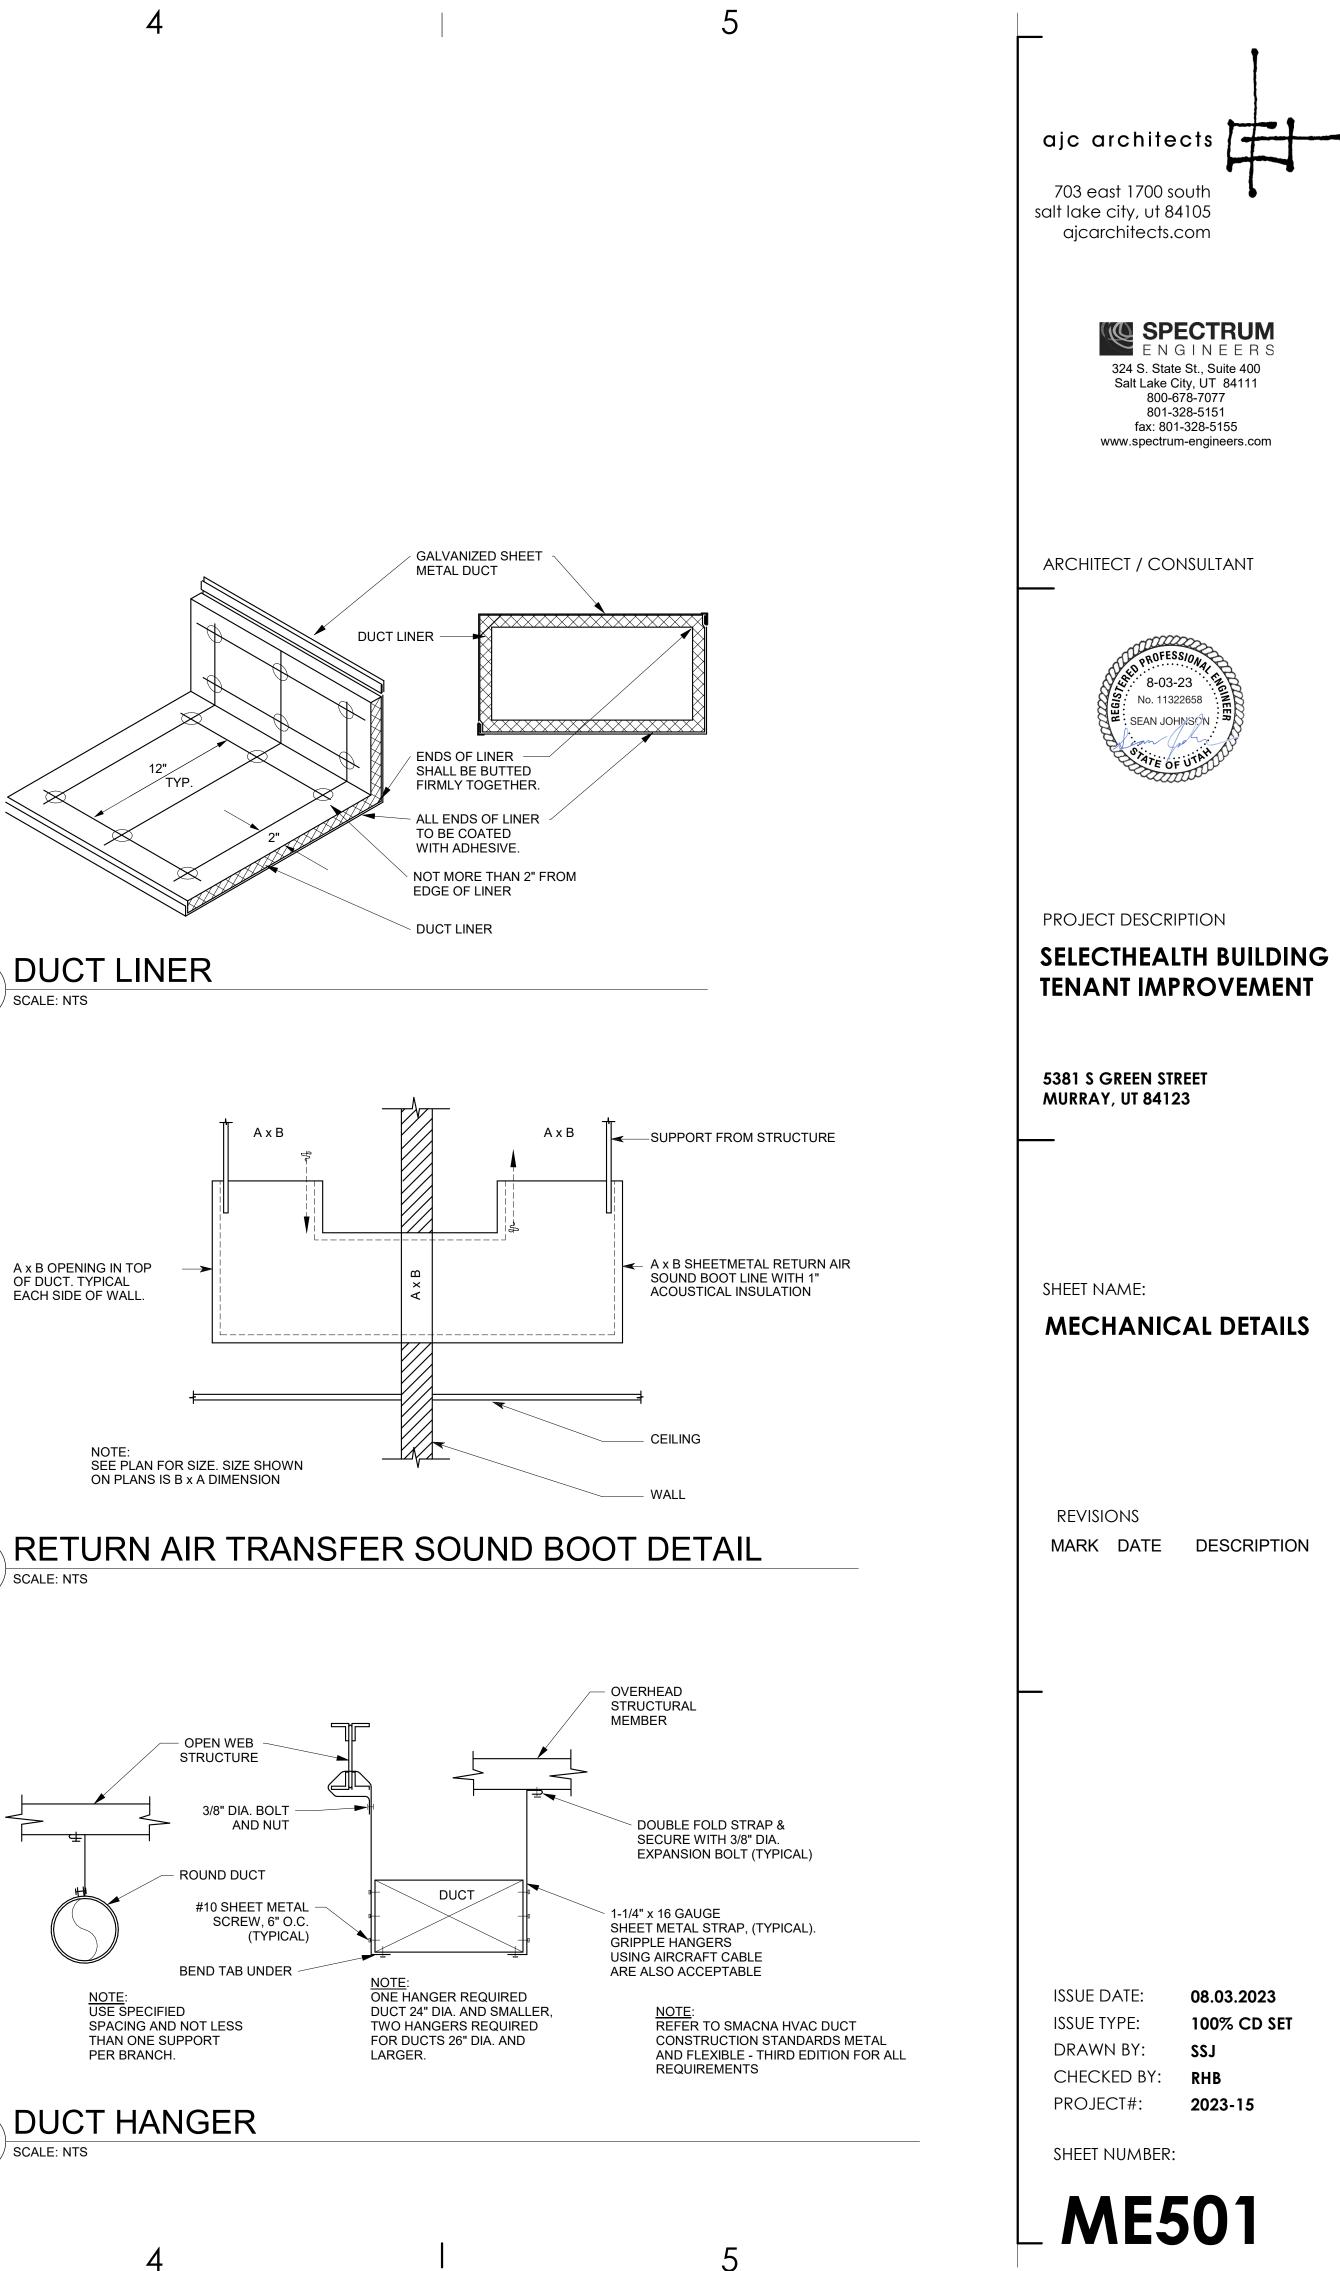


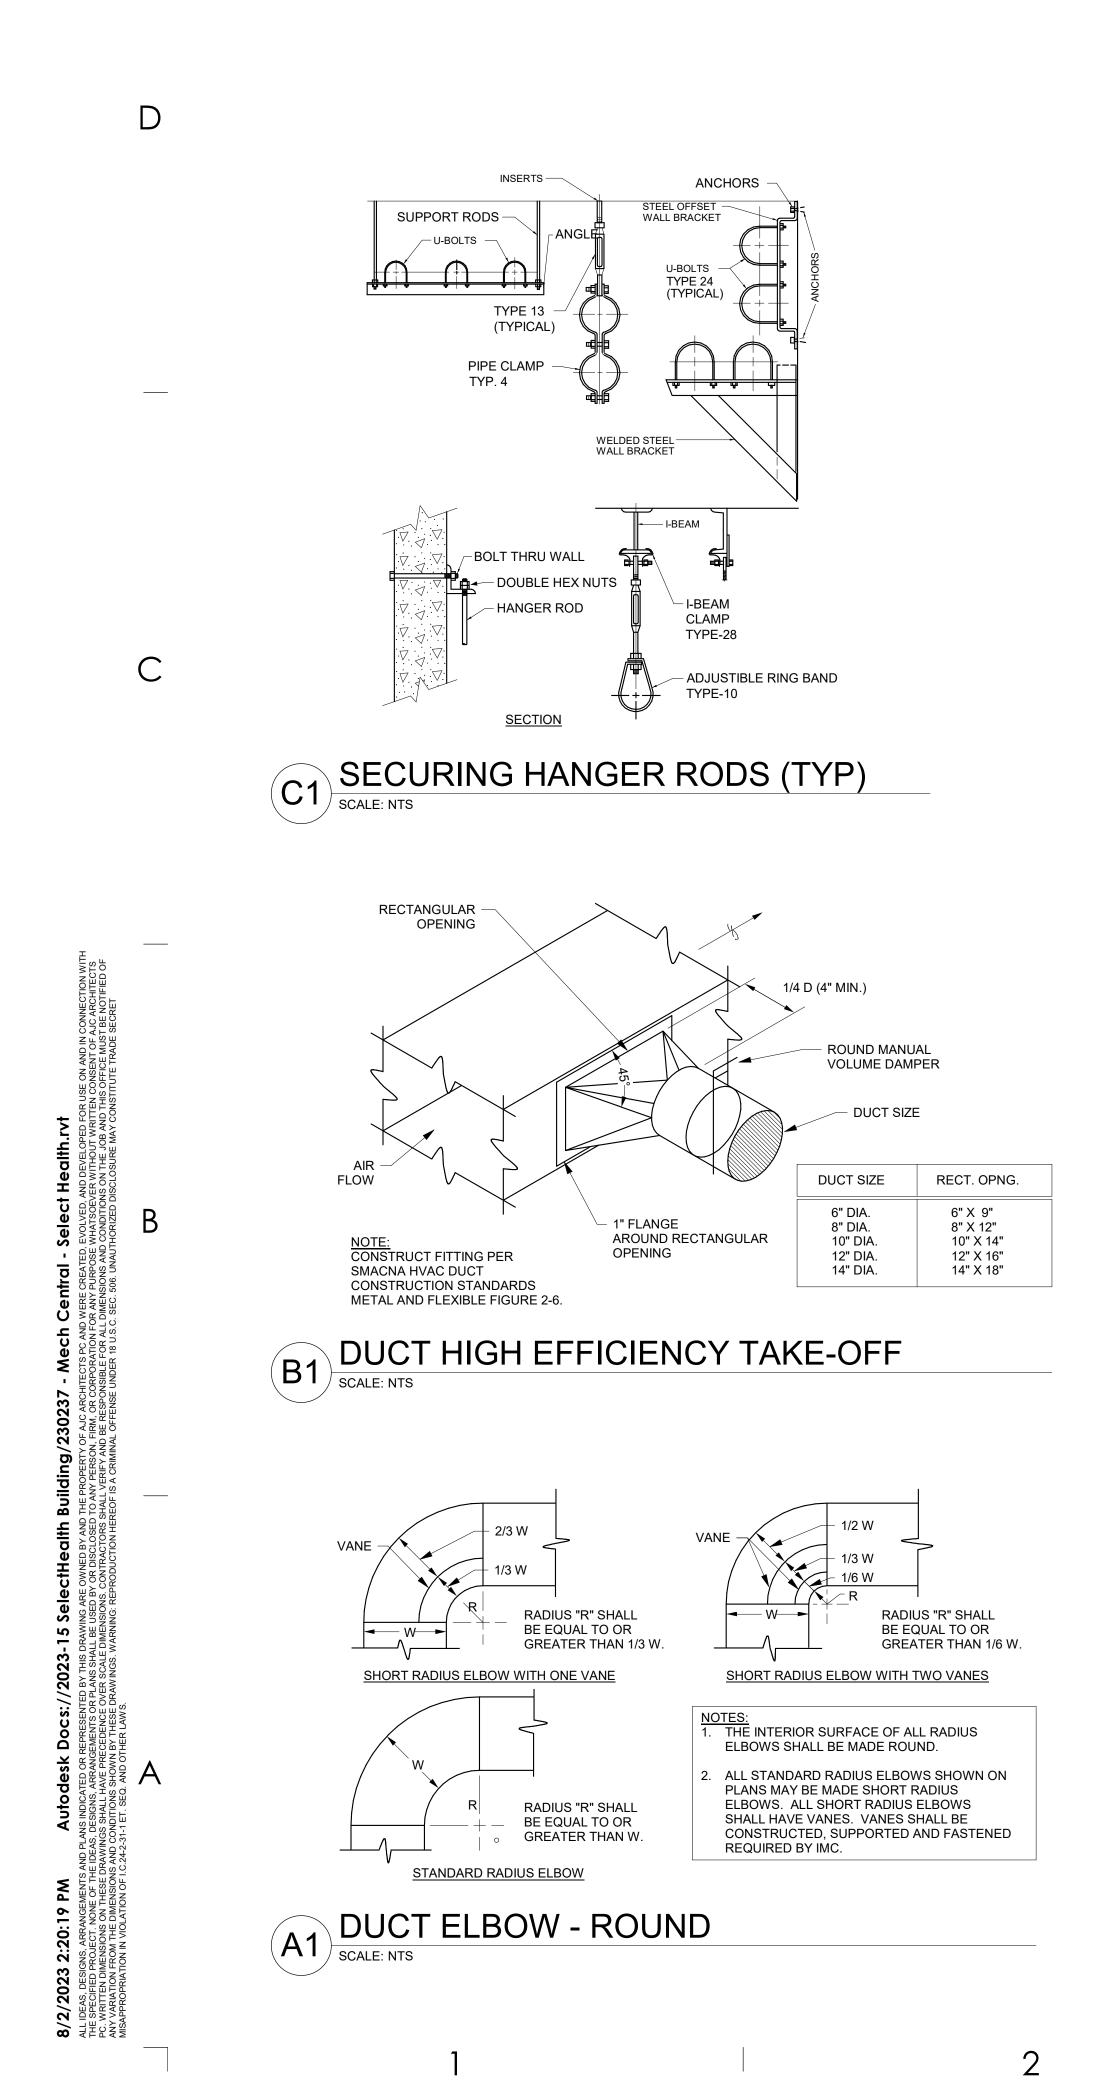


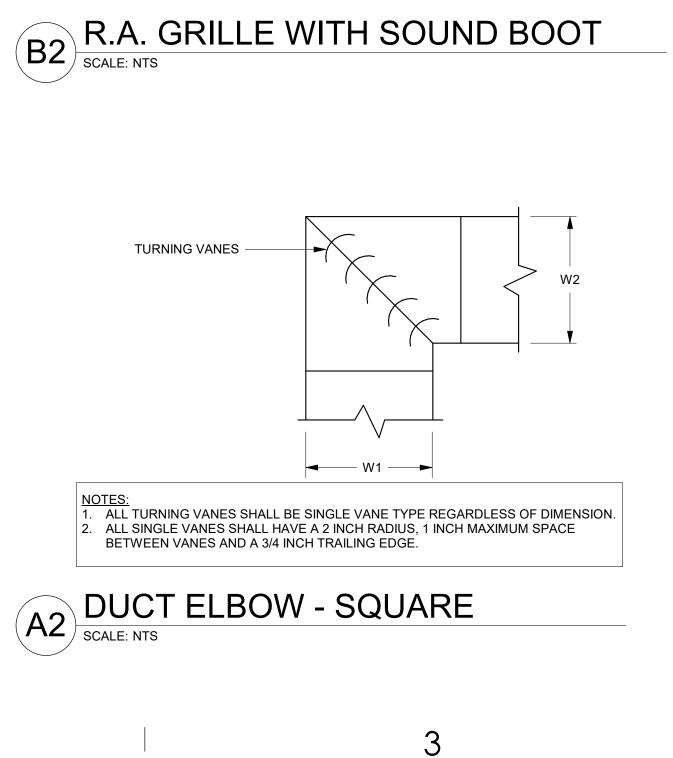

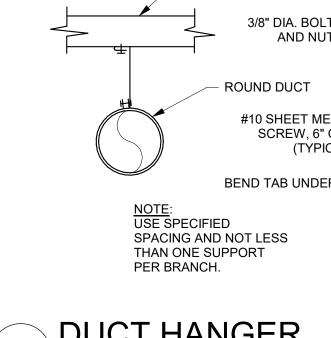

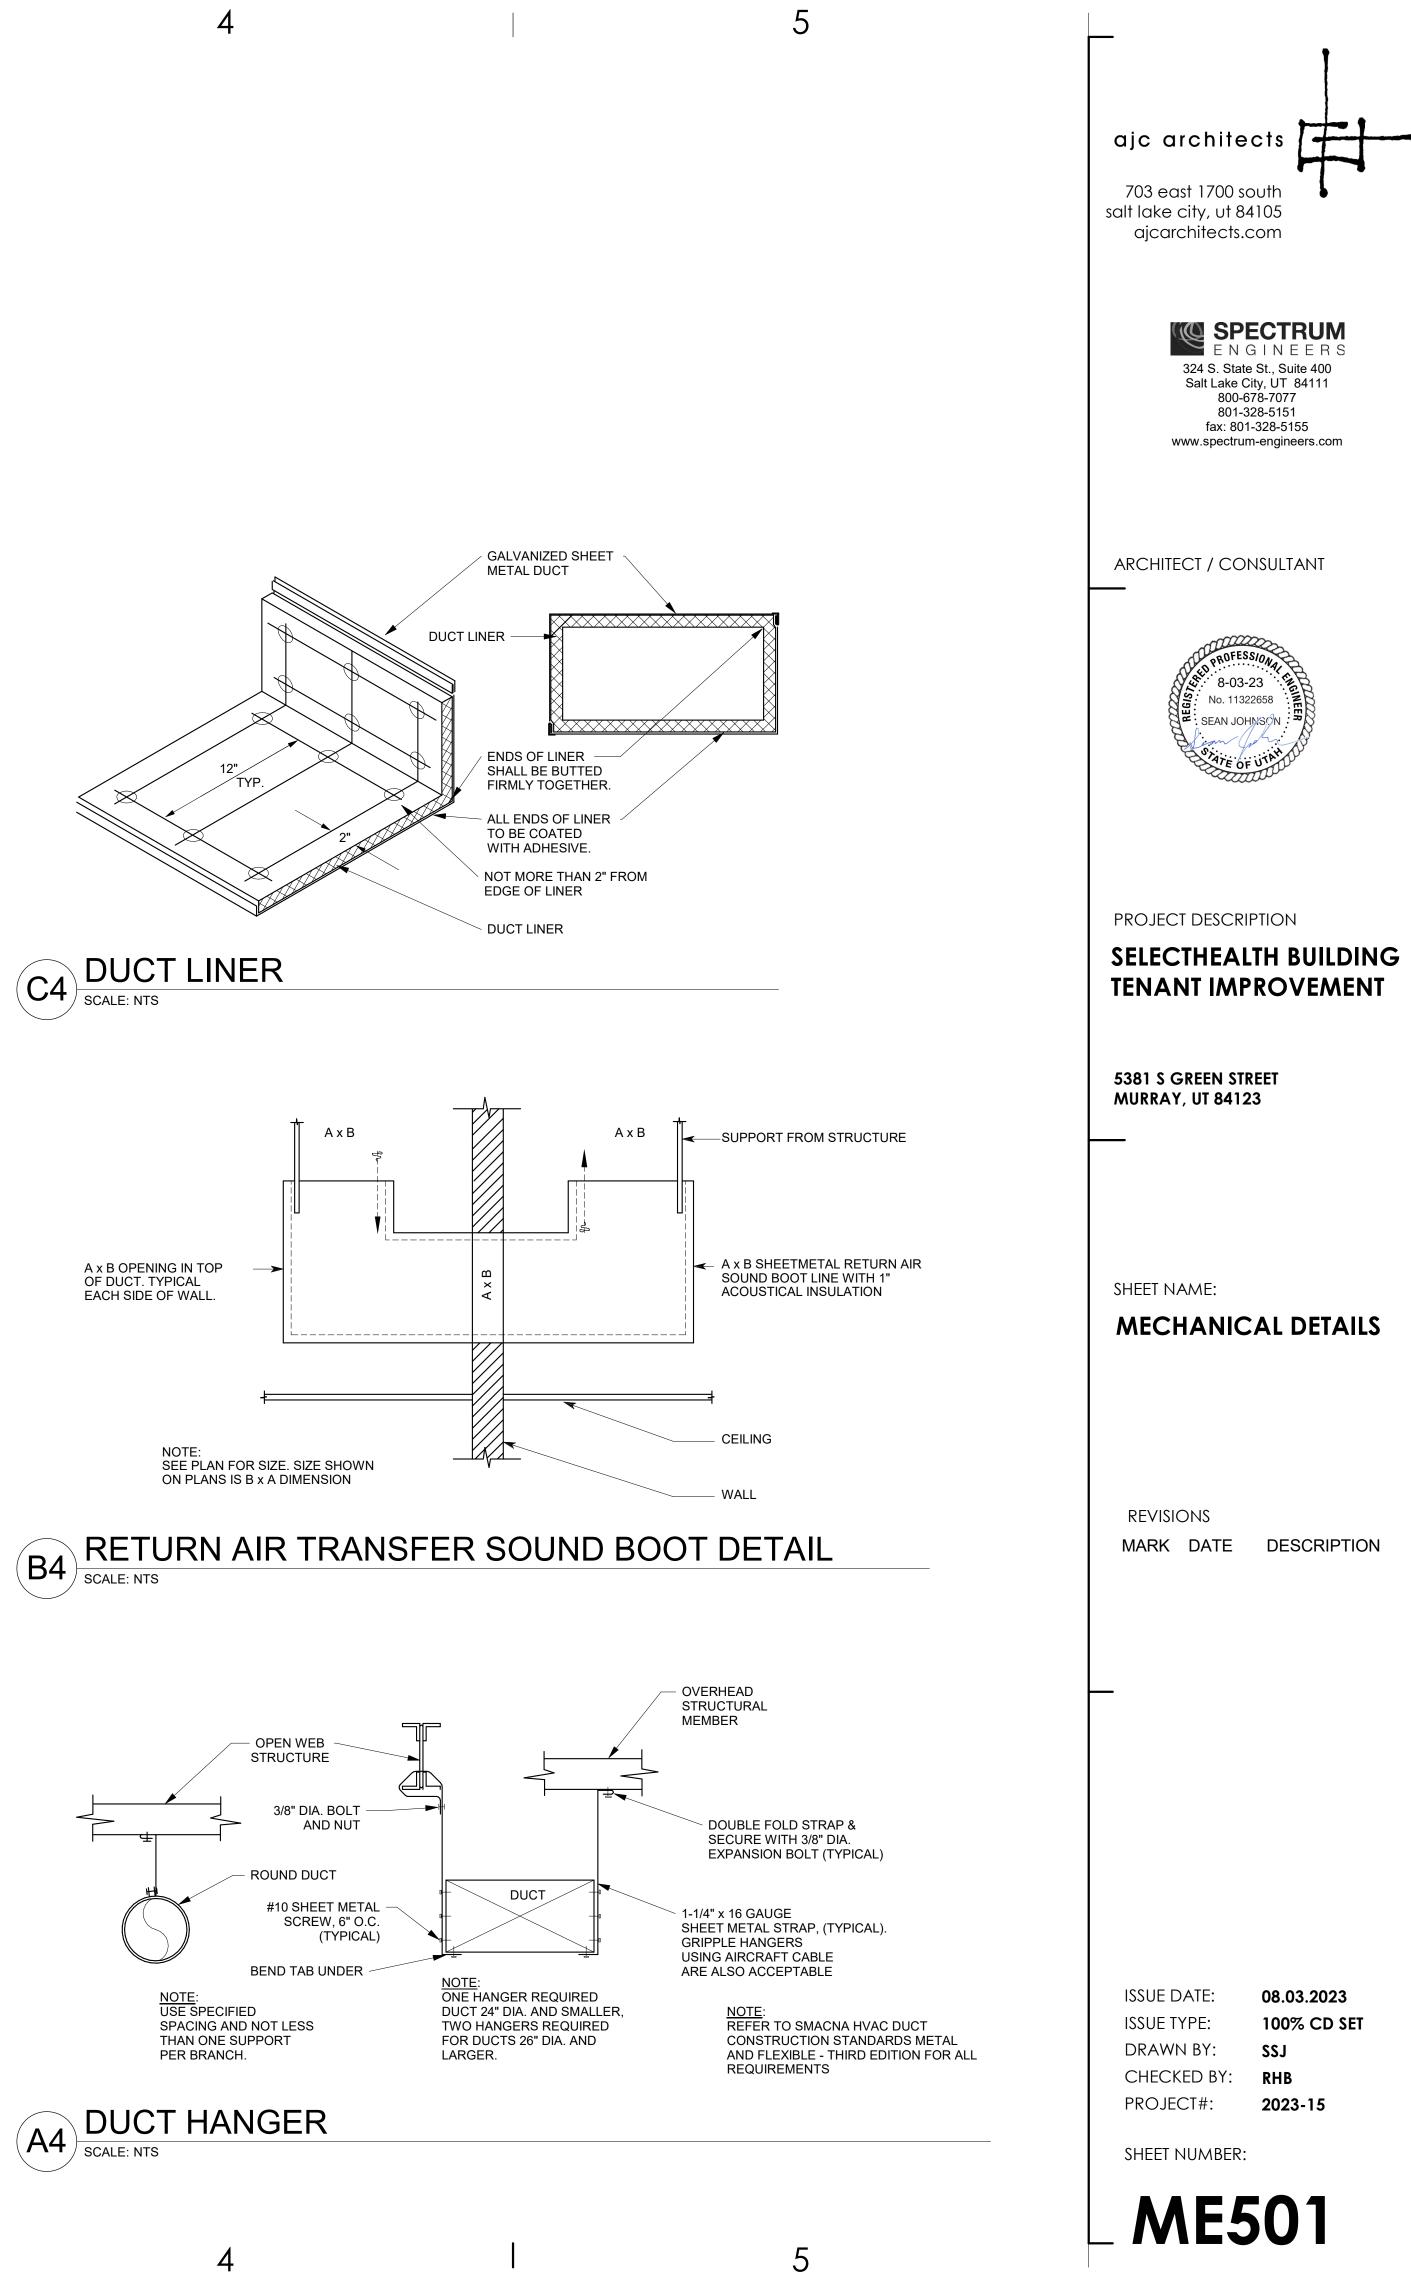

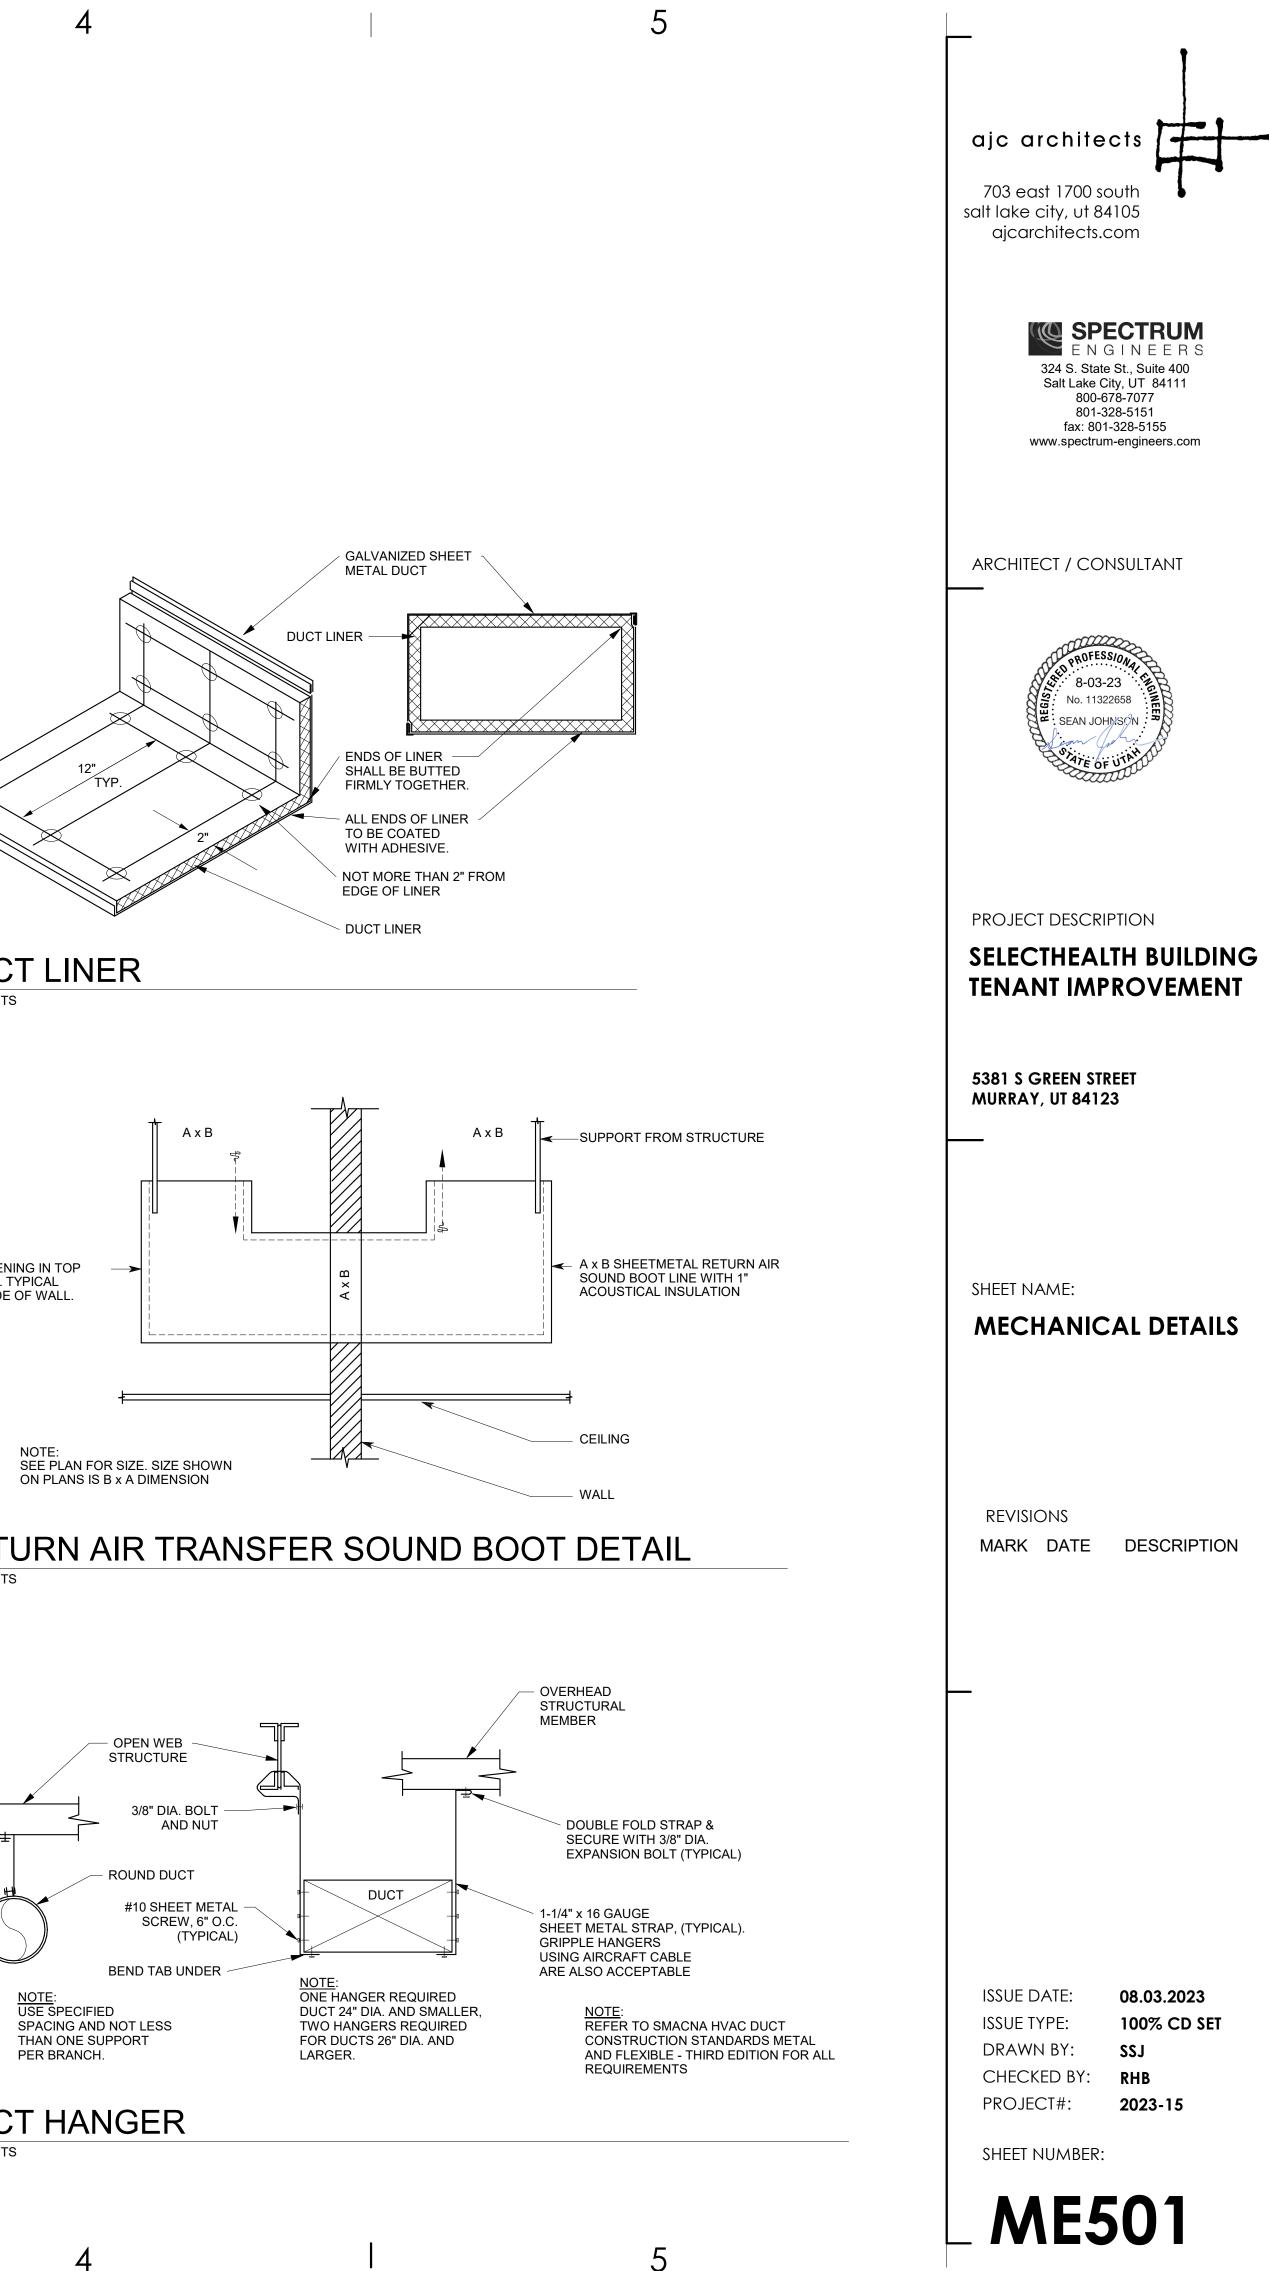

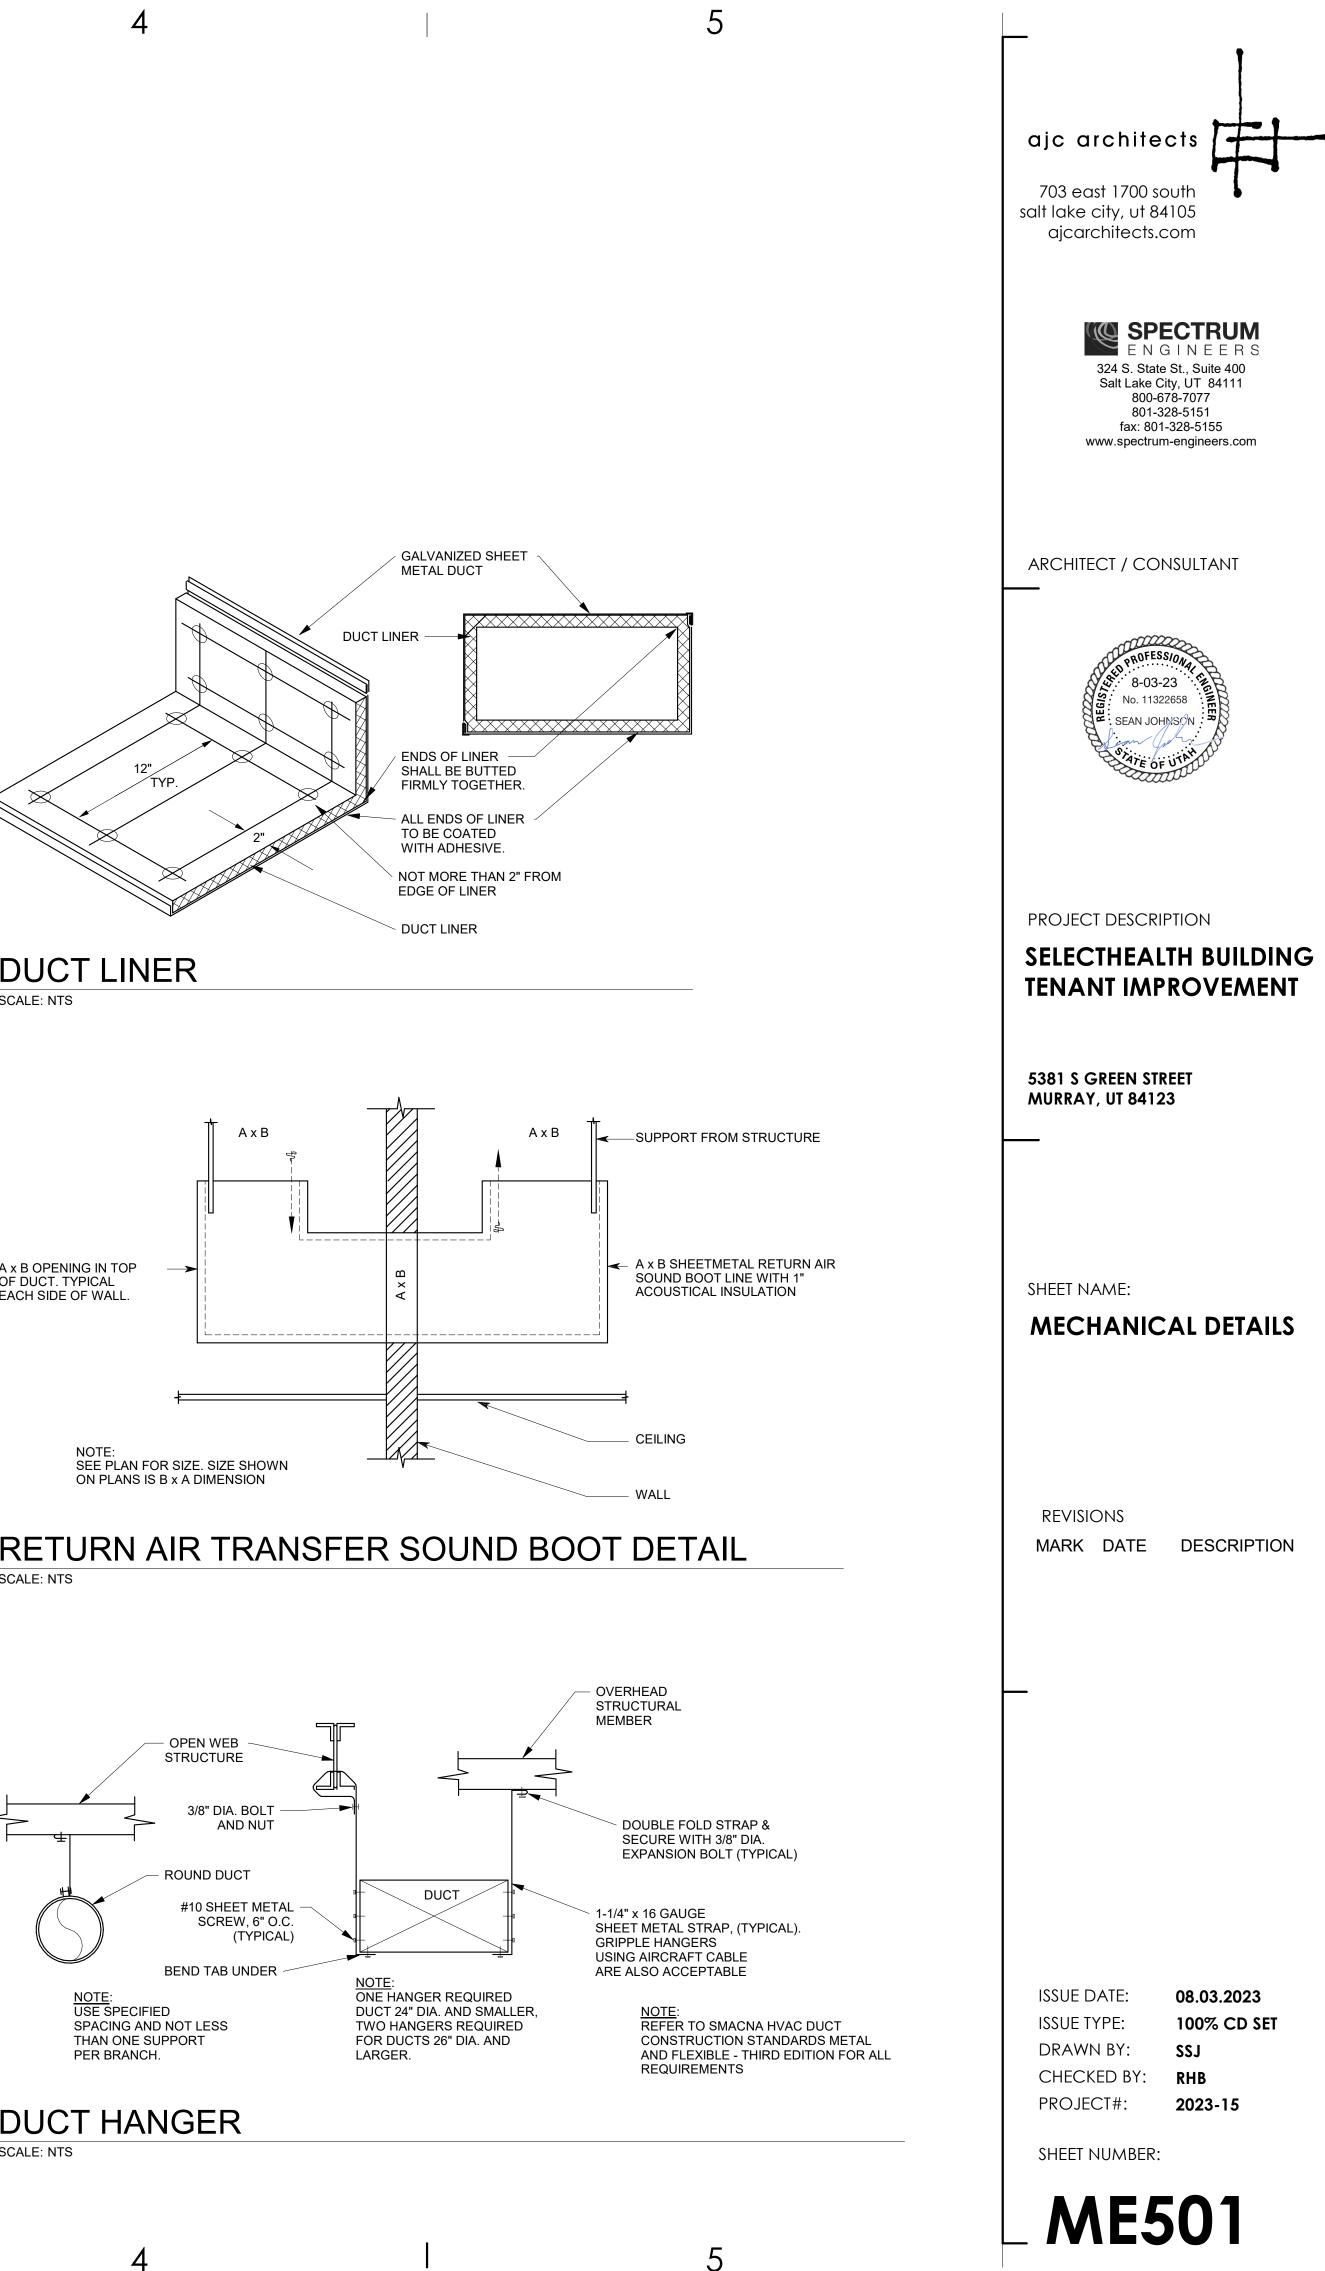




SHEET METAL SOUND BOOT W/ **1" ACCOUSTICAL DUCT LINER** 

> 1/2 GRILLE WIDTH (6"MINIMUM)

THE 3 OFFSET TYPES ABOVE.

<u>NOTES:</u>
 UNLESS OTHERWISE INDICATED ON PLANS, MAXIMUM ANGLES SHOWN SHALL APPLY.
 ALL OFFSETS SHOWN ON DRAWINGS MADE BE MADE WITH ANY OF THE A OFFSET TYPES ADOVE

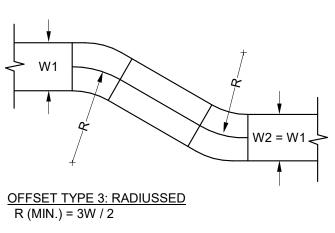

15° MAX.


30° MAX.

W1

OFFSET TYPE 1: ANGLED L (MIN.) = X / 0.26

OFFSET TYPE 2: MITERED L (MIN.) = X / 0.5

W1

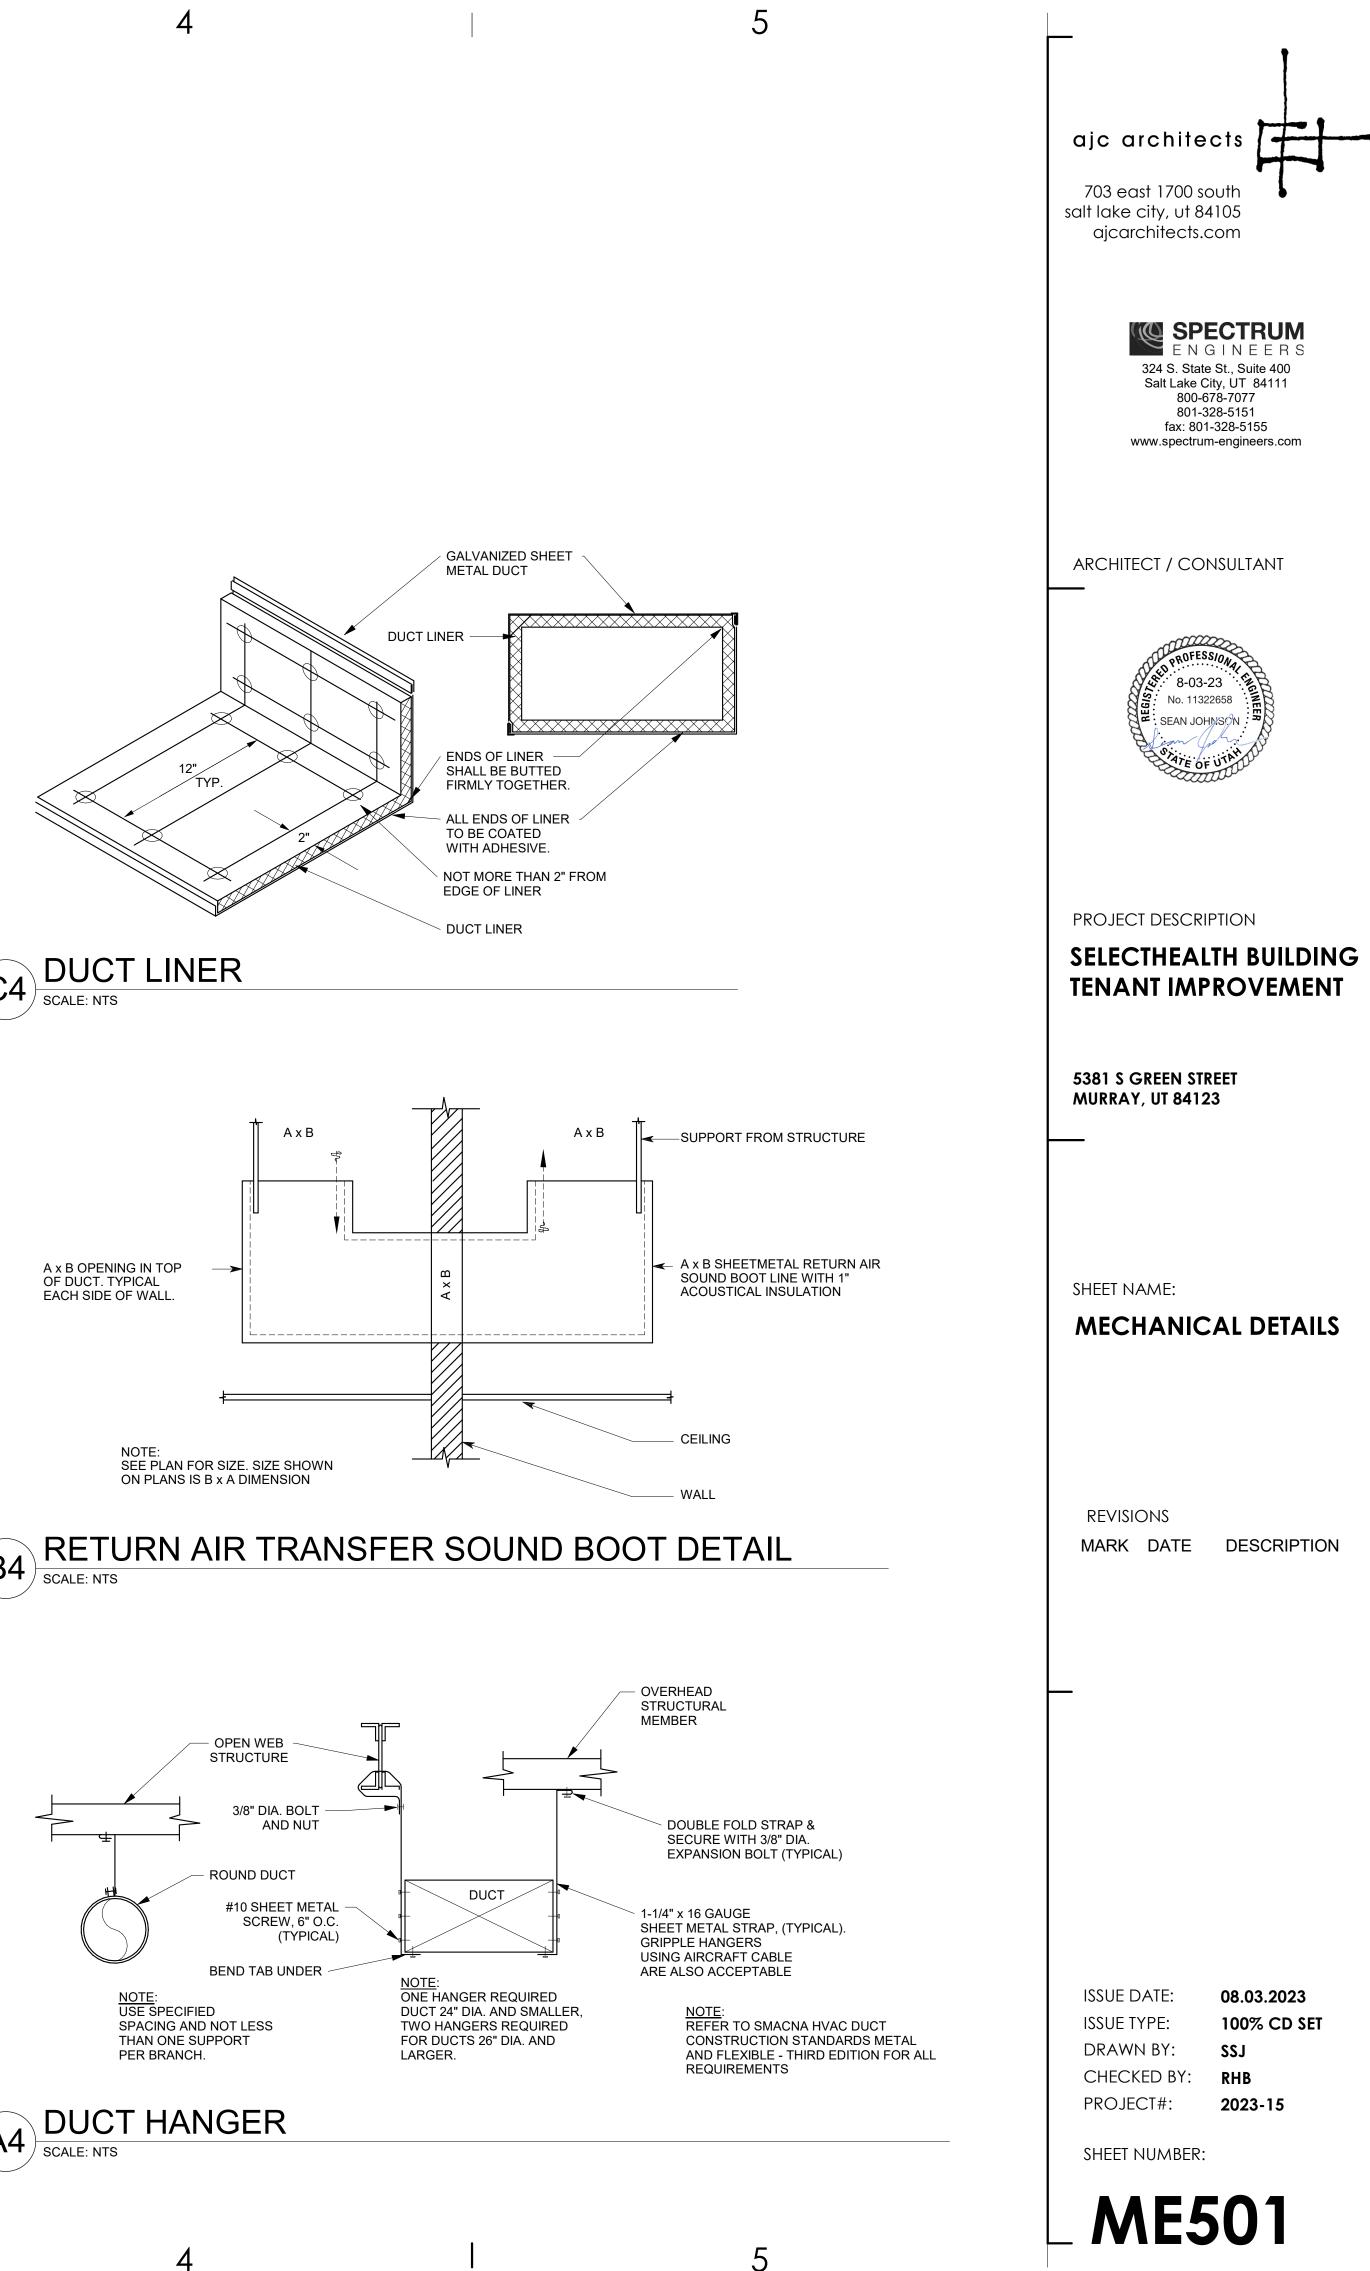

3

W2 = W1

W2 = W1

SUPPORT SOUND BOOT

ATTACH BOOT TO

**GRILLE W/ SHEET** 

METAL SCREWS (2) EACH SIDE

RETURN AIR GRILLE

— 6" MINIMUM THROAT

FROM STRUCTURE

12" MIN

1	SE	ISMI	10T	ES

HANGERS/SUPPORTS FOR PIPING.

9. DO NOT USE BRANCH LINES TO BRACE MAIN LINES.

BRACE AND (r) IS THE LEAST RADIUS OF GYRATION, BOTH IN INCHES.

5. SEE THE SPECIFICATIONS FOR REQUIRED STRENGTH OF BRACING.

RESPOND IN A DIFFERENT MODE DURING AN EARTHQUAKE, FOR EXAMPLE, A WALL AND A ROOF.

1. BRACE ALL PIPES 2-1/2-INCH INSIDE DIAMETER AND LARGER. EXCEPTIONS ARE AS FOLLOWS:

GRADE THAT COMPLIES WITH NOTE 1, SHALL HAVE AT LEAST ONE SEISMIC SUPPORT.

4. ATTACHMENT TO STRUCTURAL MEMBERS SHALL USE DEVICES INCLUDED IN MSS SP-58 OR BE

A. NO BRACING IS REQUIRED IF THE TOP OF THE PIPE IS SUSPENDED 12 INCHES OR LESS FROM THE

BRACING SHALL OCCUR AT 80-FOOT INTERVALS, MAXIMUM. EACH WATER MAIN AND TRUNK SEWER ABOVE

2. TRANSVERSE AND VERTICAL BRACING SHALL OCCUR AT 40-FOOT INTERVALS, MAXIMUM. LONGITUDINAL

3. WALLS, INCLUDING DRYWALL PARTITIONS, MAY REPLACE REQUIRED TRANSVERSE OR VERTICAL BRACING

BOLTED/WELDED AS APPROVED BY THE RESIDENT ENGINEER. BRACES SHALL BE CONNECTED TO THE

- ON THE DRAWINGS FOR PIPING.

6. LATERAL SEISMIC FORCE SHALL BE CONSIDERED TO ACT CONCURRENTLY WITH THE DEAD LOAD. THE

SLENDERNESS RATIO (I/r) OF BRACES SHALL NOT EXCEED 200, WHERE (1) IS THE LENGTH OF THE

- 7. SWAY BRACING METHODS SHOWN IN NFPA 13 (SPRINKLER PIPING) MAY BE USED IN LIEU OF DETAILS SHOWN

- 8. DO NOT FASTEN ONE RIGID PIPING SYSTEM TO TWO DISSIMILAR PARTS OF THE BUILDING THAT MAY

# **PIPE BRACING GENERAL NOTES**

- DETAILS SHOWN PROVIDE GENERAL GUIDELINES FOR A LATERAL BRACING SYSTEM.
- A TYPICAL VERTICAL SUPPORT SYSTEM MUST ALSO BE USED. BRACE ALL PIPES 1-1/2" I.D. AND LARGER.

 $\mathbf{O}$ 

- 3/4"APPROVED

**FIRESTOPINSULATION** 

WITH VAPOR BARRIER

FIRESTOP MATERIAL

FIRE/SMOKE BARRIER)

(IF WALL IS A

NOTE: CORE CUT EXISTING

WALLS.

SCHEDULE FOR TYPICAL CONNECTIONS

TO STRUCTURAL SUPPORTING MEMBERS

HARD ROCK

3/8'

3/8'

3/8'

1/2"

2-1/2" 2-5/8"

ANGLE TO SUPPORTING

STRUCTURAL MEMBER

3-1/2X2-1/2X5/16X0'-3" LLH

3-1/2X2-1/2X7/16X0'-4" LLH

2-3-1/2X2-1/2X7/16X0'-4'

3X2X1/4"X0'-3" LLH

5X3X1/2X0'-4" LLH

2-5X3X1/2X0'-4"

2. THE MECHANICAL CONTRACTOR SHALL SUBMIT SHOP DRAWINGS TO THE STRUCTURAL ENGINEER AND

THEN TO THE MECHANICAL ENGINEER, SHOWING CONNECTION TYPE AND LOCATION OF ALL RESTRAINT

3. FOR ESSENTIAL FACILITIES WHERE CONCRETE ANCHOR BOLTS OF THE EXPANSION TYPE ARE LOADED IN PULL OUT, 50 PERCENT OF THE BOLTS (ALTERNATE BOLTS IN ANY GROUP ARRANGEMENT) SHALL BE PROOF TESTED TO TWICE THE ALLOWABLE LOAD. IF THERE ARE FAILURES, THE IMMEDIATELY ADJACENT

CONC. CAST-IN

PLACE

INSERT

3/8

1/2'

1/2"

5/8'

2-1/2

2-5/8

BOLT OF

STL.BM. CLAMP

3/8"

3/8"

3/8" 1/2"

5/8" 5/8"

1/2" 1/2"

5/8" 3/4"

7/8" \*

7/8" \*\*

ROD SIZE

FOR PIPES

PHILLIP'S REDHEAD ANCHORS TO CONC.

LT. WT.

3/8" 1/2"

2-1/2"

2-5/8"

SPAN

ROD

3/8"

3/8"

1/2" 1/2"

1. FOR SLABS LESS THAN 5" THICK ONLY, THIN SLAB INSERTS MAY BE USED.

CRETE

PIPE SLEEVE

- 1/4"Ø ANCHOR ROD

FOR NEW CONSTRUCTION

-WEL

FLOOR, DECK OR CONCRETE WALL PENETRATION

NOTES: APPLICABLE TO PENETRATIONS OF ALL FIRE RATED MEMBRANES, IN

ACCORDANCE WITH NFPA 101. REFER TO SPECIFICATIONS SECTION,

PARTITION OR CHASE PENETRATION

MASONRY PARTITION

INSULATED PIPE

INSULATED PIPE

FIRESTOP MATERIAL FOR STEAM OR

CONDENSATE USE UL

RATED 2400°F

SCALE: NT

(C1)

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CERAMIC FIBER.

3/4" APPROVED

FIRESTOP INSULATION

WITH VAPOR BARRIER

FIRE STOPPING.

WALL PENETRATION

MAX. LOAD

TYPE CAPACITY POUNDS

500 1000

1500

2000

3000

4000

TYPE SPREADER

C4X54

C5X6.7

C6X8.5 C8X11.5

C9X13.4

C10X15.3

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VI

CONNECTIONS TO THE STRUCTURE.

BOLTS MUST THEN ALSO BE TESTED.

CABLE BRACING IS THE PREFERRED BRACING METHOD.

SUPPORTING STRUCTURAL MEMBER.

SEISMIC DETAIL

PIPE SEISMIC BRACING NOTES

FOR PIPING.

NOTES:

SCALE: NTS

DRYWALL PARTITION -

FLOOR

- CABLE RESTRAINTS AND BRACING NOT TO EXCEED 30'-0" CENTERS AND SHALL BE PROVIDED AT ALL CHANGES IN DIRECTION OF PIPE. ALL DROPS TO EQUIPMENT,
- AND ON EACH SIDE OF FLEXIBLE CONNECTIONS. BRACE POINTS SHALL NOT EXCEED 15'-0" FROM FLEXIBLE CONNECTION.
- ALL HOLES IN ANGLES ARE TO BE 1/16 INCH OVERSIZED. PLACE STANDARD CUT WASHERS BETWEEN SHEET METAL ANGLES AND NUT.
- EQUIPMENT WHICH ATTACHES TO THE PIPING SYSTEM SHALL BE BRACED
- INDEPENDENTLY OF THE PIPES. ALL SHEET METAL FOR BRACING TO BE FY=33 KSI MINIMUM. GAUGE FOR SHEET METAL BRACING SHALL BE AS FOLLOWS:

### 16 GA = (0.0598 INCH) 14 GA = (0.0747 INCH)


7

- 12 GA = (0.1046 INCH)
- MINIMUM DISTANCE FROM EDGE OF ANGLE TO BOLTS SHALL BE AS FOLLOWS: BOLT DIAMETER DISTANCE FROM EDGE

BOETBRANETER	
1/4" TO 1/2"	1"
5/8"	1 1/8"
3/4"	1 1/4"
7/8"	1 1/2"

- DO NOT FASTEN RESTRAINT SYSTEM TO TWO DISSIMILAR PARTS OF A BUILDING THAT 8 MAY RESPOND IN A DIFFERENT MODE DURING AN EARTHQUAKE. FOR EXAMPLE, A WALL AND A ROOF.
- ANTICIPATED DIFFERENTIAL MOVEMENTS DO NOT FASTEN ONE RIGID PIPING SYSTEM TO TWO DISSIMILAR PARTS OF A 10
- BUILDING THAT MAY RESPOND IN A DIFFERENT MODE DURING AN EARTHQUAKE. FOR EXAMPLE, A WALL AND A ROOF.
- BRACING DETAILS, SCHEDULE AND NOTES ARE TO BE USED WITH THE FOLLOWING 11 TYPES OF PIPE: STEEL PIPE SCHEDULE 40 AND 80, COPPER PIPE TYPE K,L,M (ONLY SILVER SOLDERED BRAZED JOINTS TO BE USED WITH COPPER PIPE).
- 12 ALTERNATE EVERY OTHER CABLE RESTRAINT IN OPPOSITE DIRECTION (SHOWN DOTTED).

### PIPE BRACING SEISMIC NOTES C2 PIPE

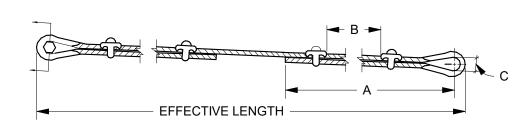

### NOTES:

1. CABLES, THIMBLES, CABLE CLIPS, GROMMETS, FLAT WASHERS AND NEOPRENE WASHERS ARE TO BE FURNISHED BY RESTRAINT MANUFACTURER. ALL OTHER HARDWARE TO BE PROVIDED BY CONTRACTOR.

- 2. CABLE CLIPS MUST BE ORIENTED AS SHOWN WITH SHORT END OF
- CABLE ON THE CURVED PART OF THE CLIP. 3. CABLE CLIPS (SAME SIZE AS CABLE) MUST BE ORIENTED AS SHOWN
- WITH SHORT END OF CABLE ON THE CURVED PART OF THE CLIP.
- 4. ENTIRE RESTRAINT SYSTEM SHALL BE AMBER BOOTH OR EQUAL.

	CABLE SCHEDULE									
CABLE DIA.	CABLE DESIGN	A	В	С	BOLT SIZE	ALLOWABLE LOAD (lbf)	BREAKING STRENGTH (lbf)			
1/8"	7X19 GALV.	5-1/4"	1-5/8"	5/8"	3/8"	660	2000			
3/16"	7X19 GALV.	5-3/4"	1-7/8"	5/8"	3/8"	1400	4200			
1/4"	7X19 GALV.	6-3/4"	2-3/8"	11/16"	3/8"	2330	7000			
5/16"	7X19 GALV.	7-3/8"	2-5/8"	13/16"	5/8"	3260	9800			
3/8"	7X19 GALV.	8-7/8"	3-1/4"	1"	5/8"	4800	14400			
7/16"	6X19 IWRC	17"	3-5/8"	1"	5/8"	5920	17800			
1/2"	6X19 IWRC	18"	3-7/8"	1-1/8"	3/4"	7660	23000			



10. ALL SEISMIC BRACING FOR FIRE SPRINKLER SYSTEM SHALL COMPLY WITH NFPA 13.

11. MINIMUM DISTANCE FROM EDGE OF ANGLE TO BOLTS SHALL BE AS FOLLOWS									
	BOLT DIAMETER	DISTANCE FROM EDGE							

1/4" TO 1/2"	1"
5/8"	1-1/8"
3/4"	1-1/4"
7/8"	1-1/2"


12. PROVIDE SWING JOINTS IN PIPING AT BUILDING SEISMIC/EXPANSION JOINTS.


13. REFER TO SPECIFICATIONS, COORDINATE FOR THE FOLLOWING

A. PIPE BRACING GENERAL NOTES AND SCHEDULES. B. SCHEDULE FOR BRACING PIPES.

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- C. DUCT CABLE BRACING SCHEDULE.
- D. GENERAL NOTES FOR BRACING OF DUCTS. E. EQUIPMENT ISOLATION SCHEDULE.
- F. SCHEDULE OF SIDE BRACING RECTANGULAR DUCT.
- G. SCHEDULE OF CENTER BRACING RECTANGULAR DUCT.
- H. SCHEDULE FOR TYPICAL CONNECTIONS TO STRUCTURAL SUPPORTING MEMBERS. RECTANGULAR DUCT HANGERS MINIMUM SIZE.
- J. MINIMUM HANGER SIZES FOR ROUND DUCT.



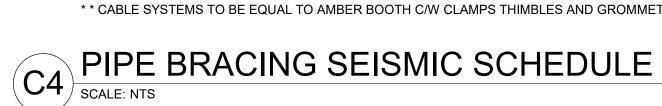

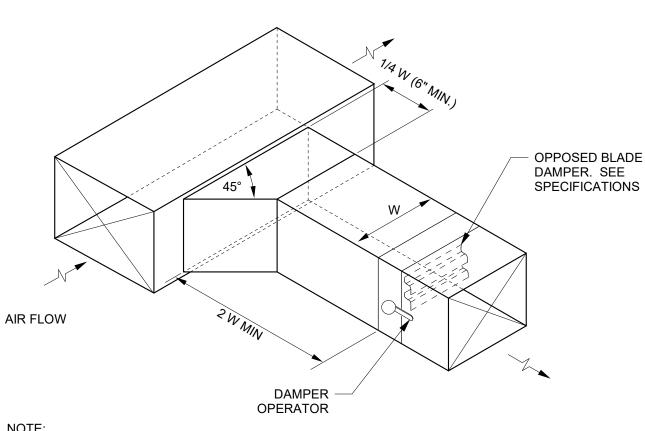INACCESSIBLE LOCATIONS



SECURE FLEXIBLE DUCT WITH CINCH BAND

> RIGID DUCT FIRE DAMPER (AS REQ'D) SEE PLAN

SECURE DUCT TO DIFFUSER WITH SHEET METAL SCREWS


NOTE: CEILING INLETS AND OUTLETS SHALL BE INDEPENDENTLY SUPPORTED





PROVIDE LARGE ENOUGH PIPE SLEEVES THROUGH WALLS OR FLOORS TO ALLOW FOR

# **CEILING DIFFUSER PANEL FACE**

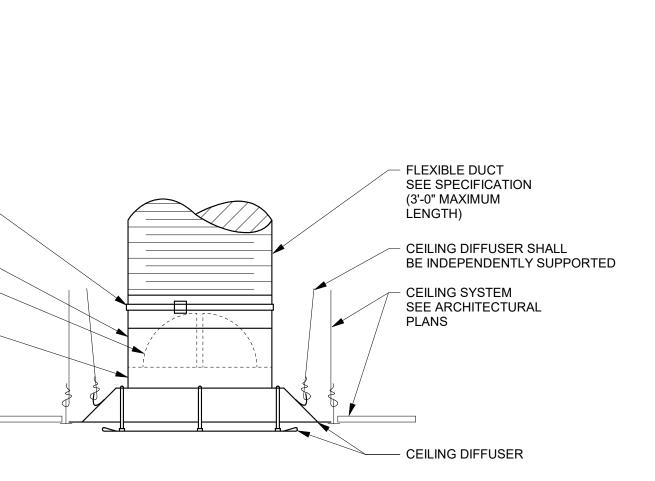

PROVIDE CONCEALED CEILING DAMPER REGULATOR FOR GYPSUM BOARD CEILINGS OR OTHER

PIPE SEISMIC BRACING SCHEDULE

HANGER TO

CLEVIS 3/8"

CLEVIS 3/8"

3/8"

3/8"

CLEVIS

CLEVIS

BOLTS

ANGLE SIZE

HANGER MAX.

ROD

25"

25'

31"

31"

LENGTH TYPE

ROD

SIZE

1/2"

5/8"

5/8"

1-1/2" 1/2"

FOR ANCHOR CONNECTIONS SEE LIST.

PIPE

SIZE

2"

3"

SEE PIPE BRACING DETAIL

2-1/2"

\*\* CABLE SYSTEMS TO BE EQUAL TO AMBER BOOTH C/W CLAMPS THIMBLES AND GROMMETS.

\* TWO CABLES REQUIRED AT EACH RESTRAINT POINT. EACH CABLE TO BE INSTALLED 45° TO LONGITUDINAL

\* CABLE \*\* CABLE

TYPE

7X19 GALV.

7X19 GALV.

7X19 GALV.

7X19 GALV.

DIRECTION OF PIPE. TO HORIZONTAL AND 45°

1/8"

1/8"

1/8"

3/16"

ARCHITECT / CONSULTANT

E N G I N E E R S 324 S. State St., Suite 400 Salt Lake City, UT 84111 800-678-7077 801-328-5151 fax: 801-328-5155 www.spectrum-engineers.com

**SPECTRUM** 

ajc architects

703 east 1700 south

ajcarchitects.com

salt lake city, ut 84105

ANCHOR

CONN.

TYPE



8-03-23 No. 11322658

SEAN JOHNSON

**PROJECT DESCRIPTION** 

**5381 S GREEN STREET** 

**MURRAY**, UT 84123

SHEET NAME:

REVISIONS

SELECTHEALTH BUILDING

**TENANT IMPROVEMENT** 

**MECHANICAL DETAILS** 

MARK DATE DESCRIPTION



08.03.2023

SSJ

RHB

2023-15

100% CD SET

SHEET NUMBER:

ISSUE DATE:


ISSUE TYPE:

DRAWN BY:

PROJECT#:

CHECKED BY:



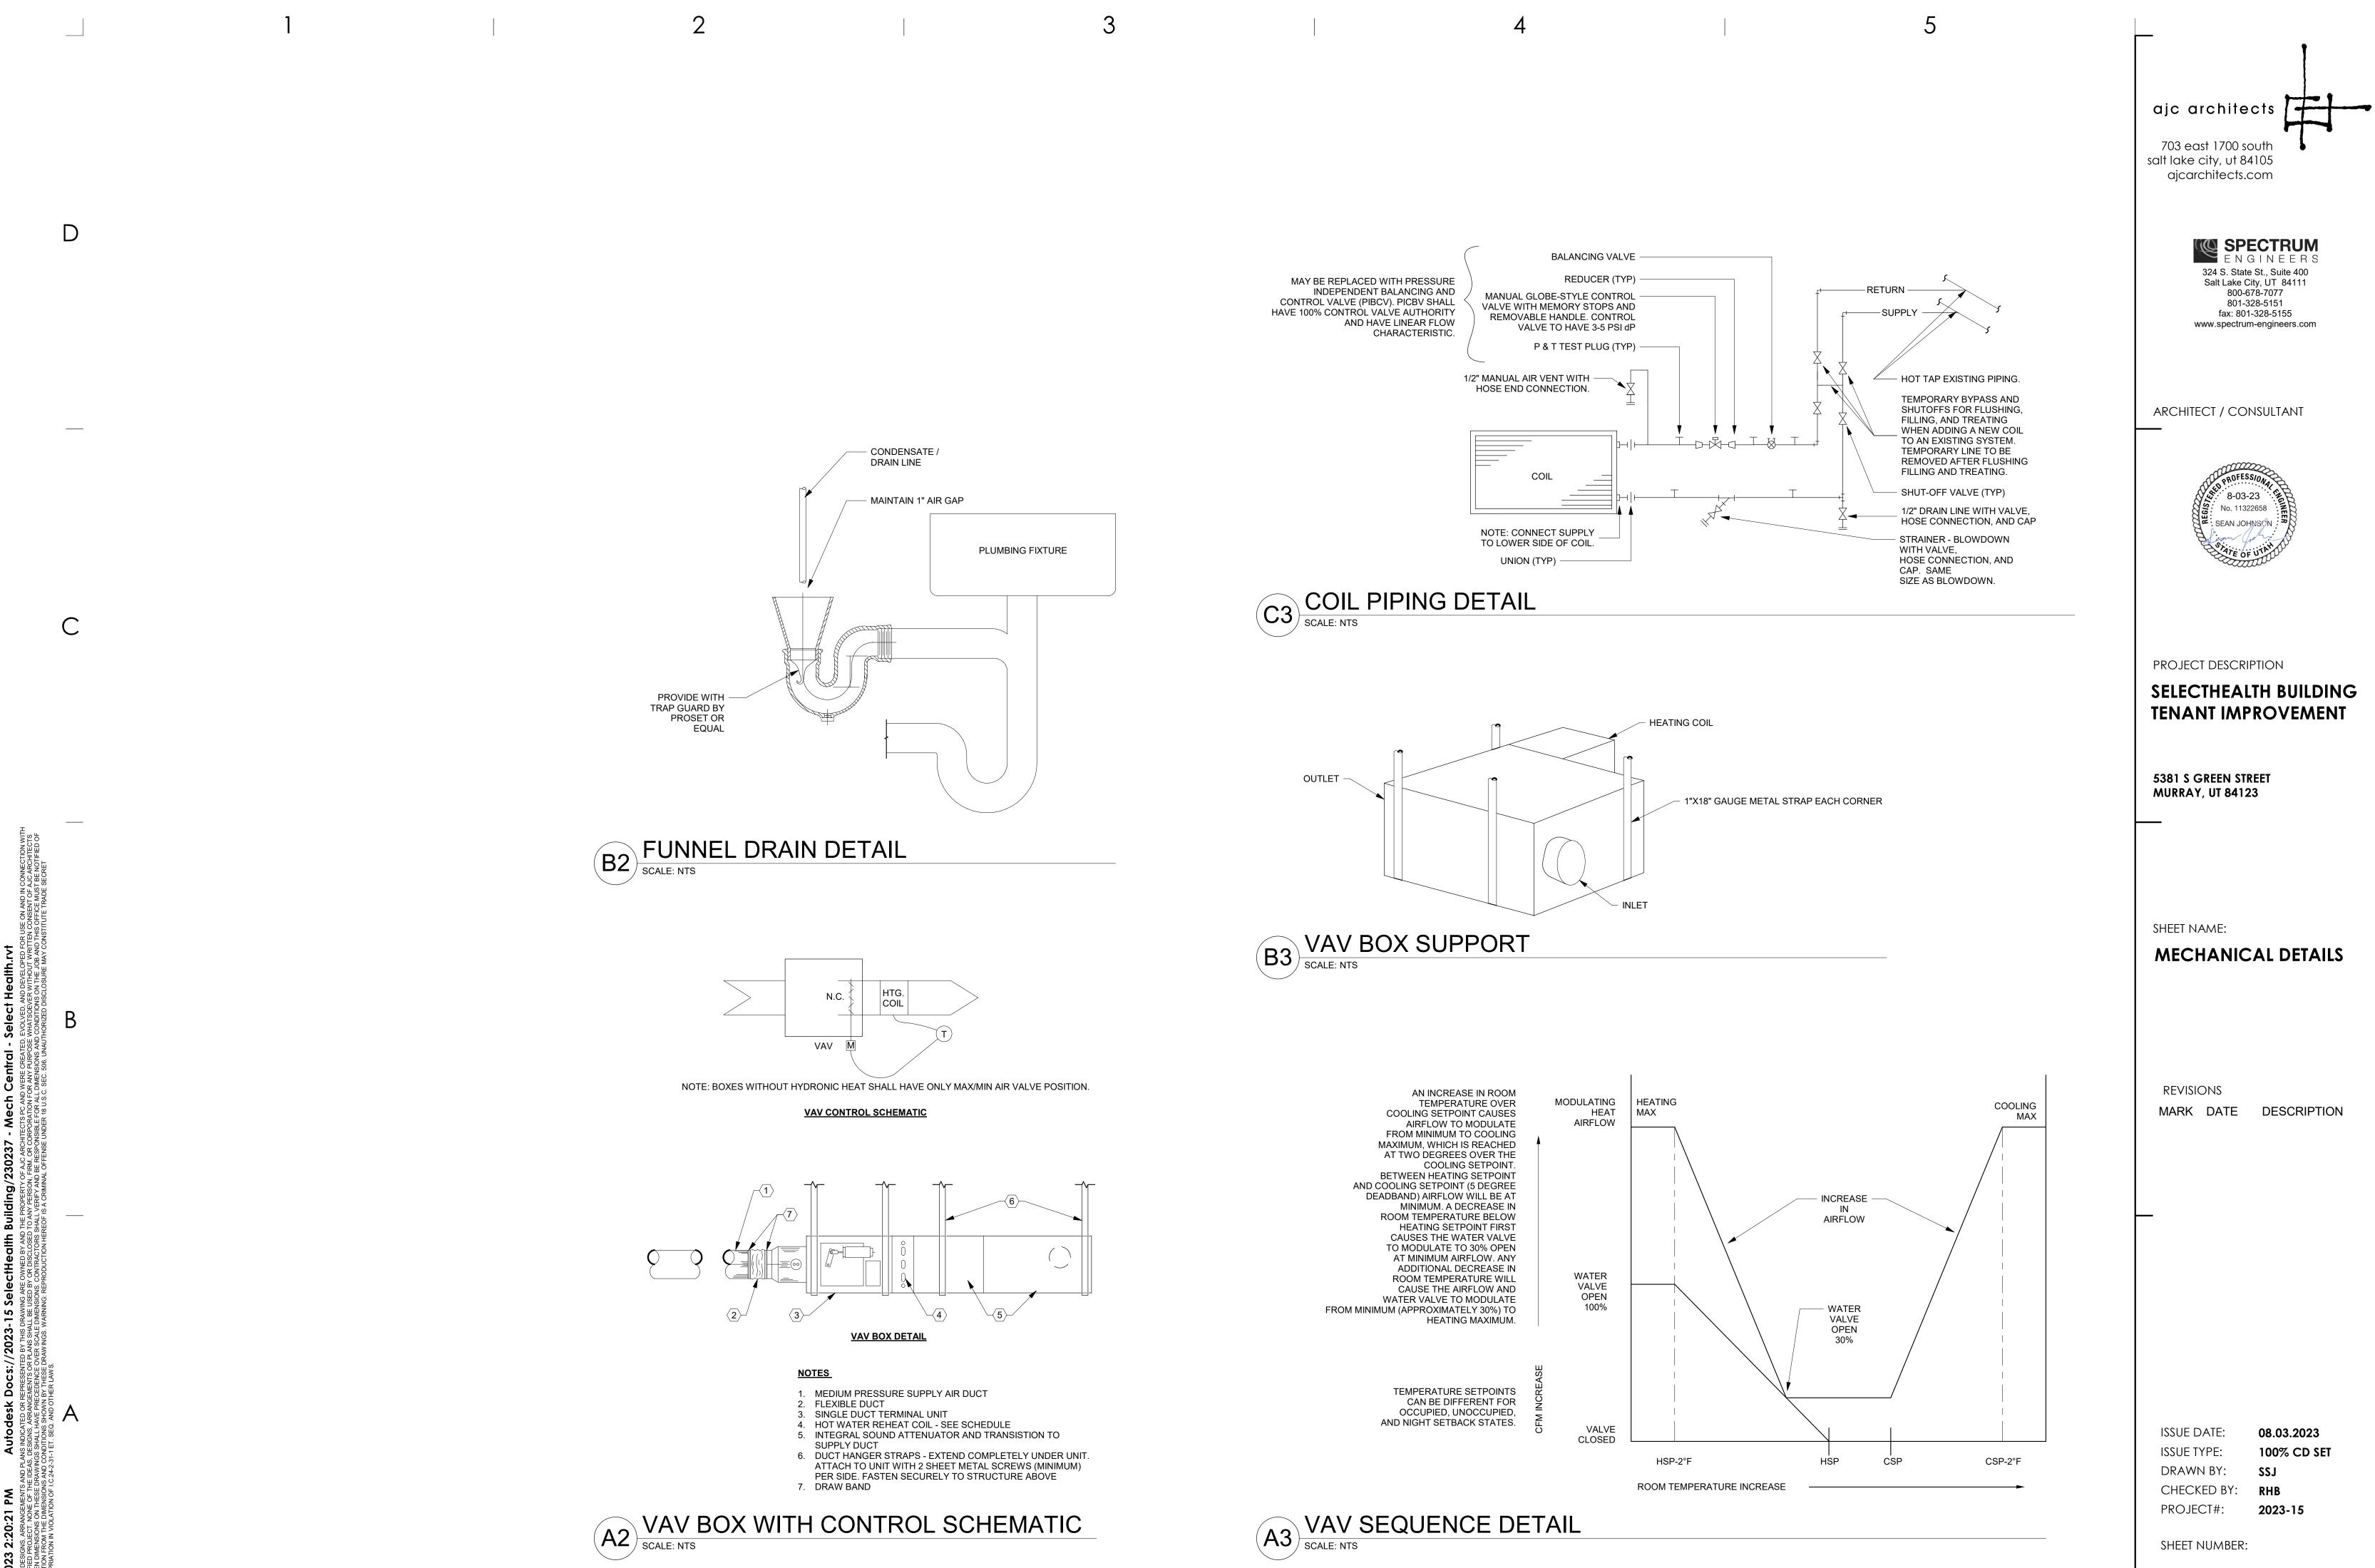

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LAB (E)6R2 (E)8R0 (E)8R1 (E)8R2 (E)10R2 (E)12R2 (E)14R2 (E)16R2 (E)VAV



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	NEW VAV TERMINAL UNIT SCHEDULE (HYDRONIC HEAT)																		
			AIRFLOW	1			HOT WATER HEATING COIL												
						MAX			MIN	FLOW						MAX			
	DESIGN	MIN	MAX	AIR PD	INLET	AIRFLOW	CAPACITY	EAT	LAT	RATE	EWT	LWT	WATER PD		CONTROL	DISCHARGE			
	AIRFLOW	(CFM)	(CFM)	(IN-WC)	SIZE	(CFM)	(BTUH)	(F°)	(F°)	(GPM)	(F°)	(F°)	(FT)	ROWS	VALVE	NC	MANUFACTURER	MODEL	REMARKS
Λ	1,600 CFM	205 CFM	2,060 CFM	0.37	12"	1,600 CFM	48,000 Btu/h	55	88 °F	2 GPM	180	140 °F	0.32 FT	2	DDC	30	Krueger	LMHS-LC	1-8
S ROOM	2,000 CFM	281 CFM	2,800 CFM	0.29	14"	2,000 CFM	68,000 Btu/h	55	88 °F	3 GPM	180	140 °F	0.41 FT	2	DDC	32	Krueger	LMHS-LC	1-8

DL COMPONENTS FURNISHED BY TEMPERATURE CONTROLS CONTRACTOR. ISITY FIBERGLASS INTERNAL INSULATION IS AND 20 GAGE GALVANIZED STEEL CONSTRUCTION.

FION. R CONTROLS. ER.

EL. ANSFORMER.

	EXISTING VAV TERMINAL UNIT SCHEDULE (HYDRONIC HEAT)																
		AIRFL	_OW					HOT WA	TER HEATING CO	IL							
ABEL	MIN (CFM)	MAX (CFM)	AIR PD @ MAX AIRFLOW (IN-WC)	INLET SIZE	MAX AIRFLOW (CFM)	CAPACITY (BTUH)	EAT (F°)	MIN LAT (F°)	MAX FLOW RATE @180°F (GPM)	EWT (F°)	LWT (F°)	MAX WATER PD (FT)	ROWS	MAX DISCHARGE NC	MANUFACTURER	MODEL	REMARKS
R2	80 CFM	500 CFM	0.53	6"	500 CFM	15,000 Btu/h	55	88 °F	0.6 GPM	180	140 °F	0.1 FT	2	31	Krueger	LMHS-LC	1-2
R0	150 CFM	800 CFM	0.33	8"	0 CFM	0 Btu/h	55	55 °F	0 GPM	0	0 °F	0 FT	0	31	Krueger	LMHS-LC	1-2
R1	150 CFM	900 CFM	0.33	8"	450 CFM	13,500 Btu/h	55	88 °F	1.6 GPM	180	140 °F	1.7 FT	1	31	Krueger	LMHS-LC	1-2
R2	150 CFM	800 CFM	0.48	8"	800 CFM	24,000 Btu/h	55	88 °F	0.9 GPM	180	140 °F	0.3 FT	2	29	Krueger	LMHS-LC	1-2
0R2	230 CFM	1,400 CFM	0.63	10"	1,400 CFM	36,000 Btu/h	55	88 °F	1.3 GPM	180	140 °F	0.8 FT	2	31	Krueger	LMHS-LC	1-2
2R2	325 CFM	1,600 CFM	0.46	12"	1,600 CFM	48,000 Btu/h	55	88 °F	1.7 GPM	180	140 °F	0.6 FT	2	32	Krueger	LMHS-LC	1-3
4R2	450 CFM	2,500 CFM	0.57	14"	2,500 CFM	68,000 Btu/h	55	88 °F	2.1 GPM	180	140 °F	0.8 FT	2	32	Krueger	LMHS-LC	1-3
6R2	580 CFM	2,900 CFM	0.52	16"	2,900 CFM	87,100 Btu/h	55	88 °F	3.3 GPM	180	140 °F	0.6 FT	2	29	Krueger	LMHS-LC	1-3
AV	0 CFM	900 CFM	1	8"	0 CFM	0 Btu/h	55	55 °F	0 GPM	0	0 °F	0 FT	0	30	Nailor	P3001	1-2


EXISTING VAV TO REMAIN.
 ADJUST VAV TO NEW DESIGN AIRFLOW - SEE AIRFLOWS SHOWN ON PLAN VIEWS.
 SOME EXISTING VAV'S WILL REQUIRE NEW CO2 CONTROLLERS/SENSORS TO BE PROVIDED. SEE KEYNOTE #3 ON SHEET MH101. THERE ARE 4 VAV'S IN TOTAL WITH THIS REQUIREMENT.

	REGISTER - GRILLE- DIFFUSER SCHEDULE										
LABEL	TYPE	MAX AIRFLOW (CFM)	FACE SIZE	NECK SIZE	<b>BLOW PATTERN</b>	PD (IN-WC)	THROW(S) (FT)	MAX NC	MANUFACTURER	MODEL	REMARKS
R-1	LOUVERED RETURN GRILLE	1750	24" X 24"	SEE PLANS	N/A	0.100	N/A	30	PRICE INDUSTRIES	535	1-3
SD-1	SUPPLY DIFFUSER - LAY IN	375	24" x 24"	8"Ø	4-WAY	0.050	4-6-10	30	PRICE INDUSTRIES	SCD	1-3
SD-2	SUPPLY DIFFUSER - LAY IN	575	24" x 24"	10"Ø	4-WAY	0.050	5-7-12	30	PRICE INDUSTRIES	SCD	1-3

4

PROVIDE TRANSITION AS NECESSARY.
 PROVIDE LAY-IN MODULE AS NECESSARY.
 ACCEPTABLE MANUFACTURERS: PRICE, KRUEGER, TITUS OR PRIOR APPROVED EQUAL.

				PLUM	IBING	<b>FIXTURE SO</b>	CH
LABEL	DESCRIPTION	WASTE	VENT	CW	HW	MANUFACTURER	
S-1	BREAKROOM SINK	1 1/2"	1 1/2"	1/2"	1/2"	FIXTURE: ELKAY FAUCET: DELTA TMV: BRADLEY	FIXT FAU TMV

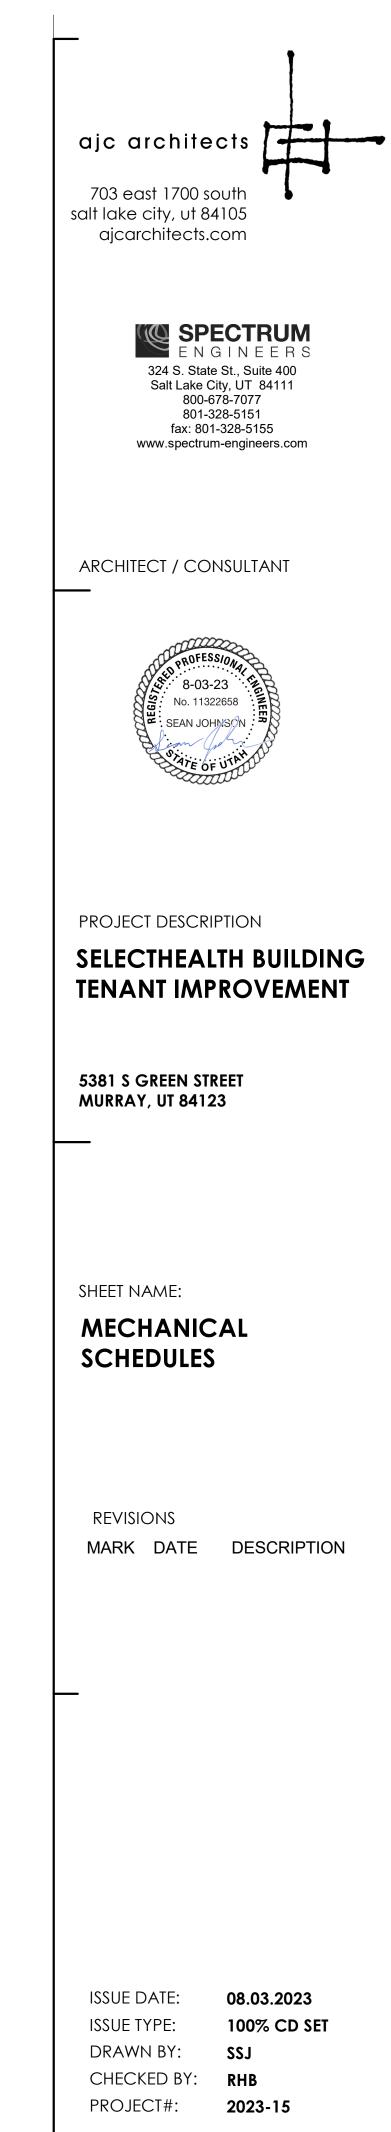



SHEET	NUMBER:




HEDULE MODEL FIXTURE: ELUH2115PD FAUCET: ESSA 9113-AR-DST TMV: S59-4016

REMARKS TMV TO BE ASSE 1070 COMPLIANT - SET TO 120°F

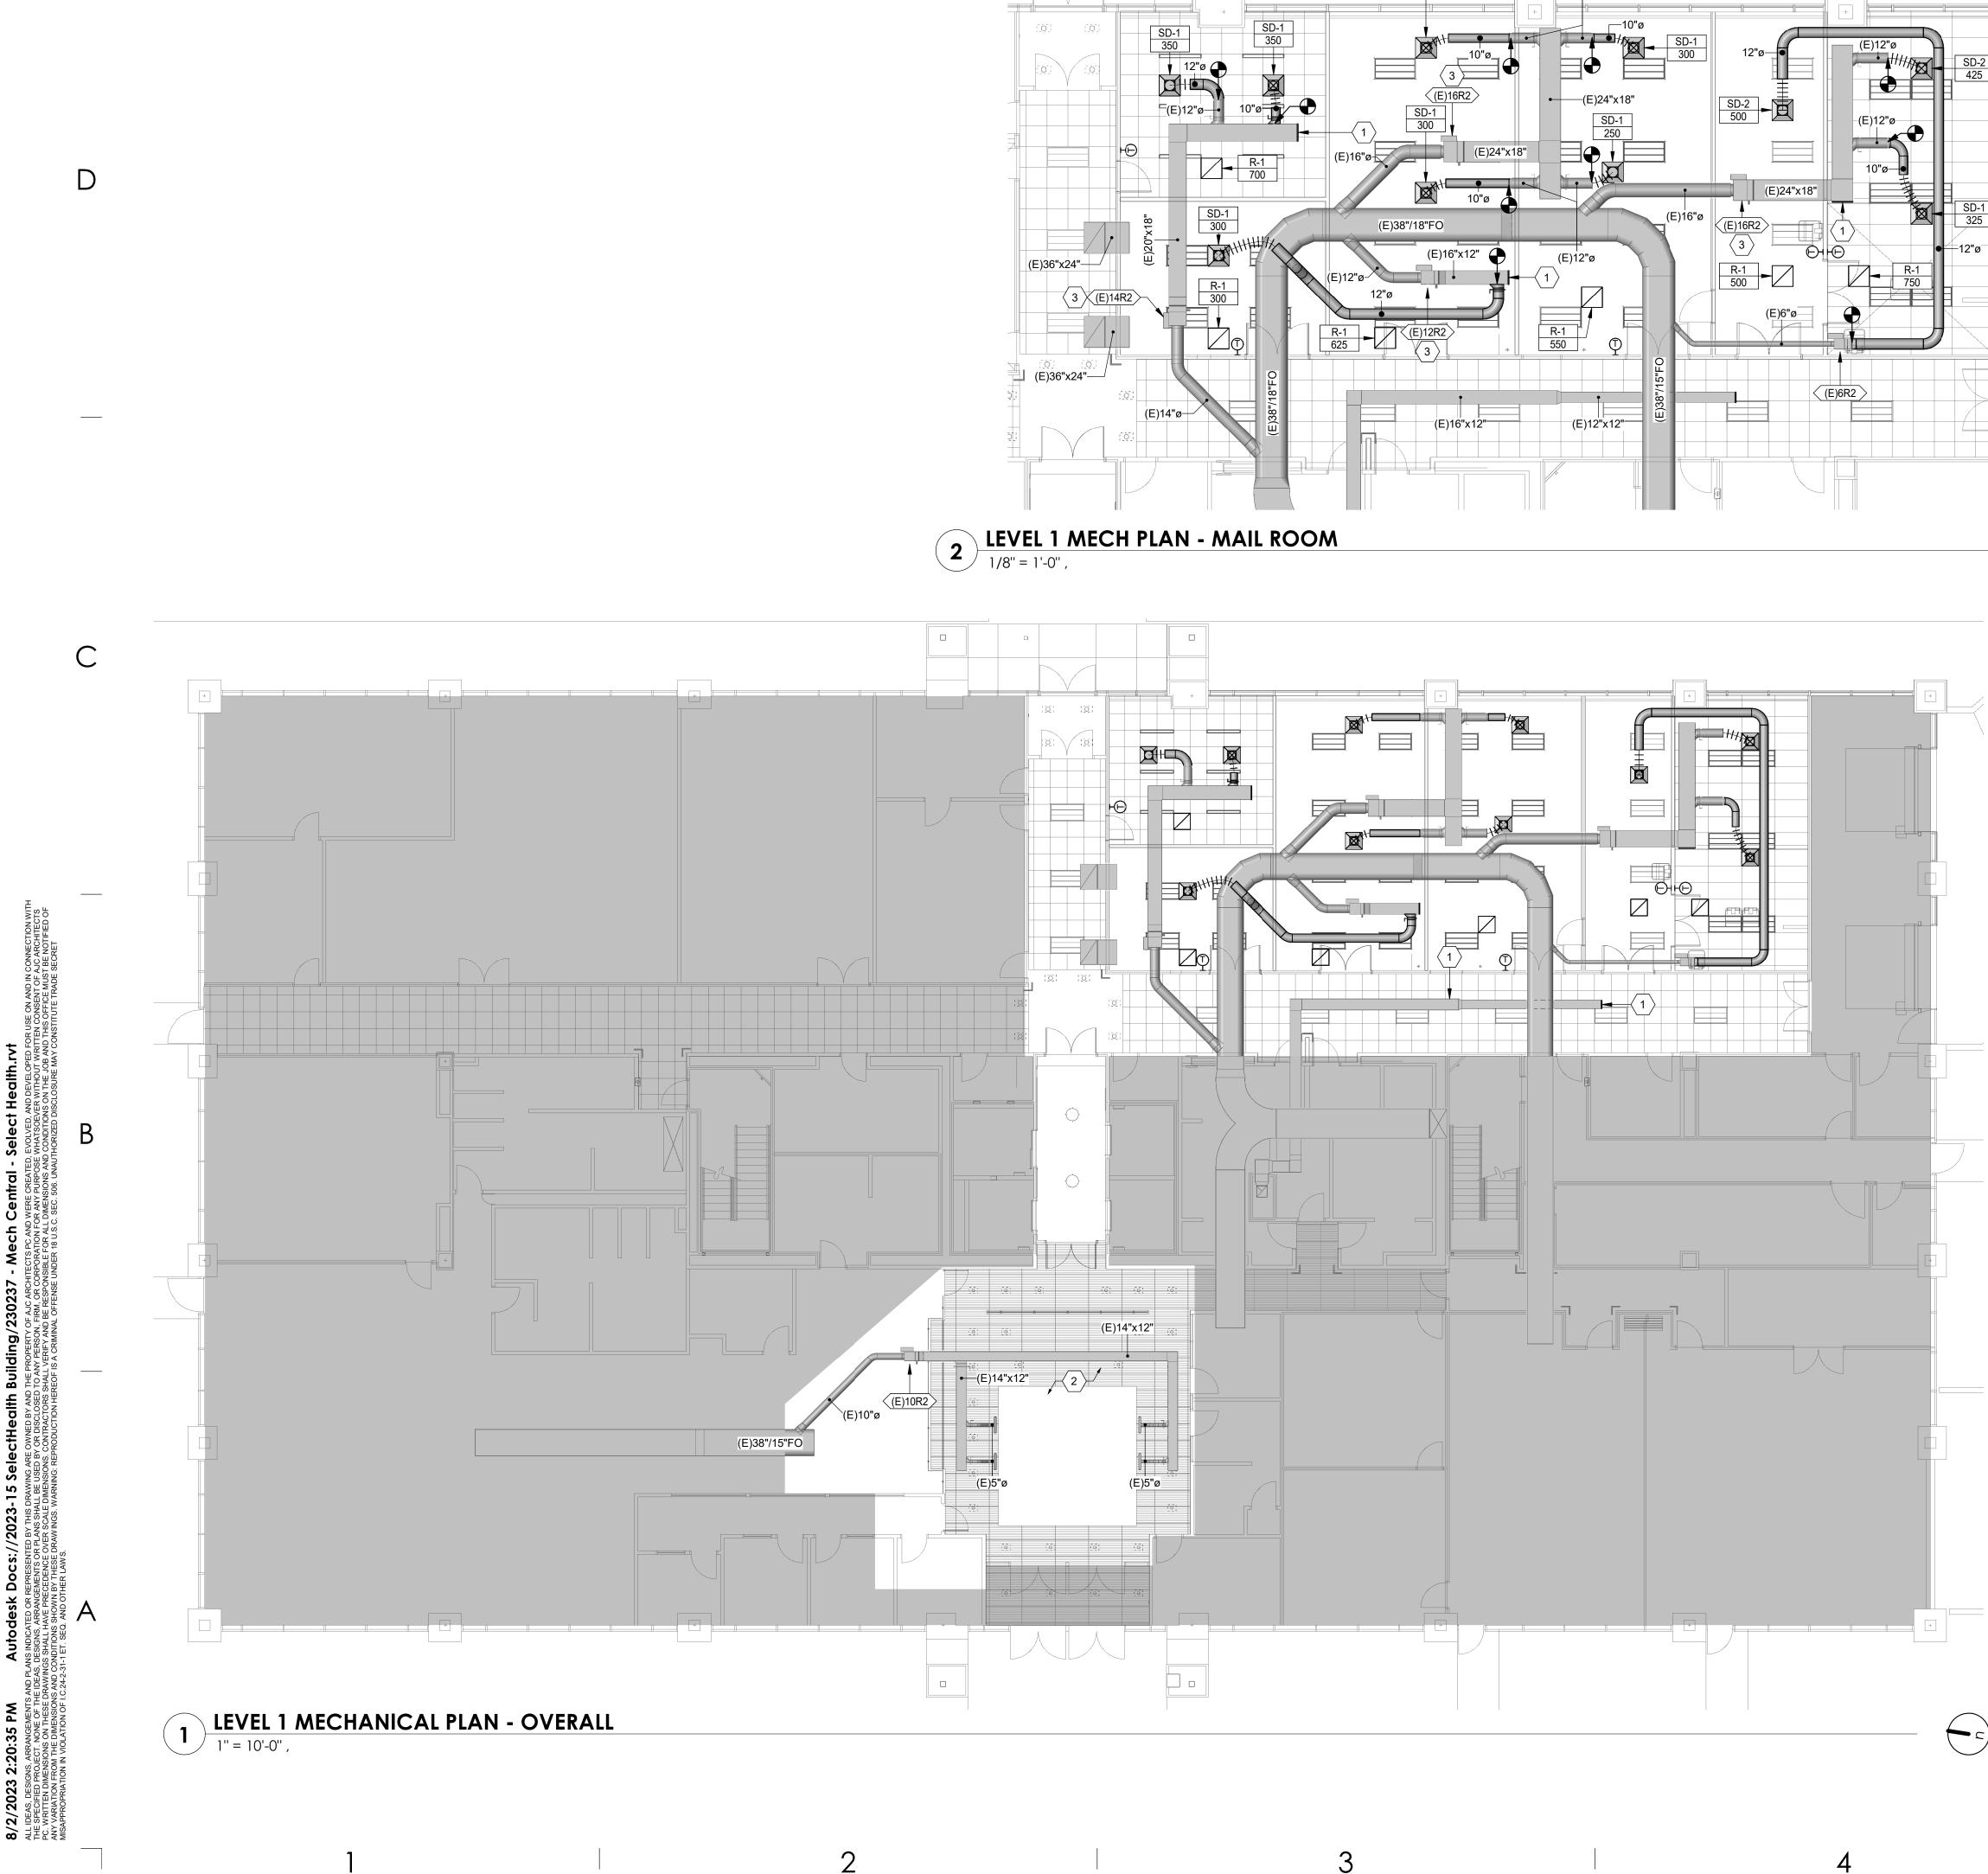

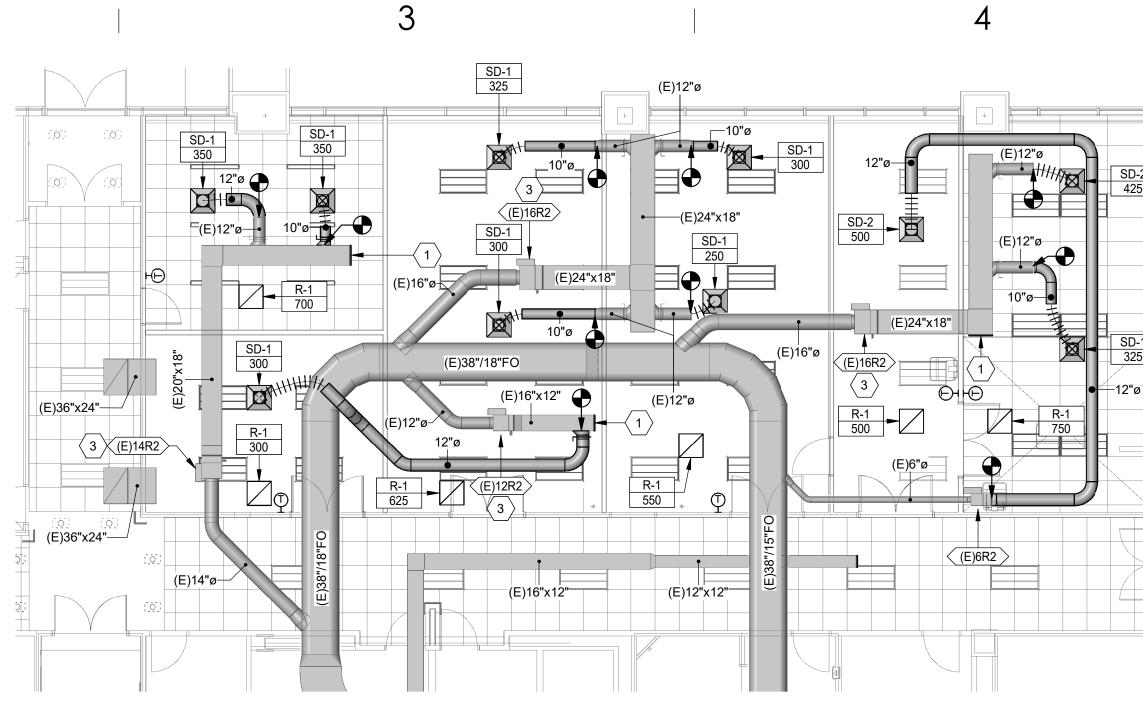

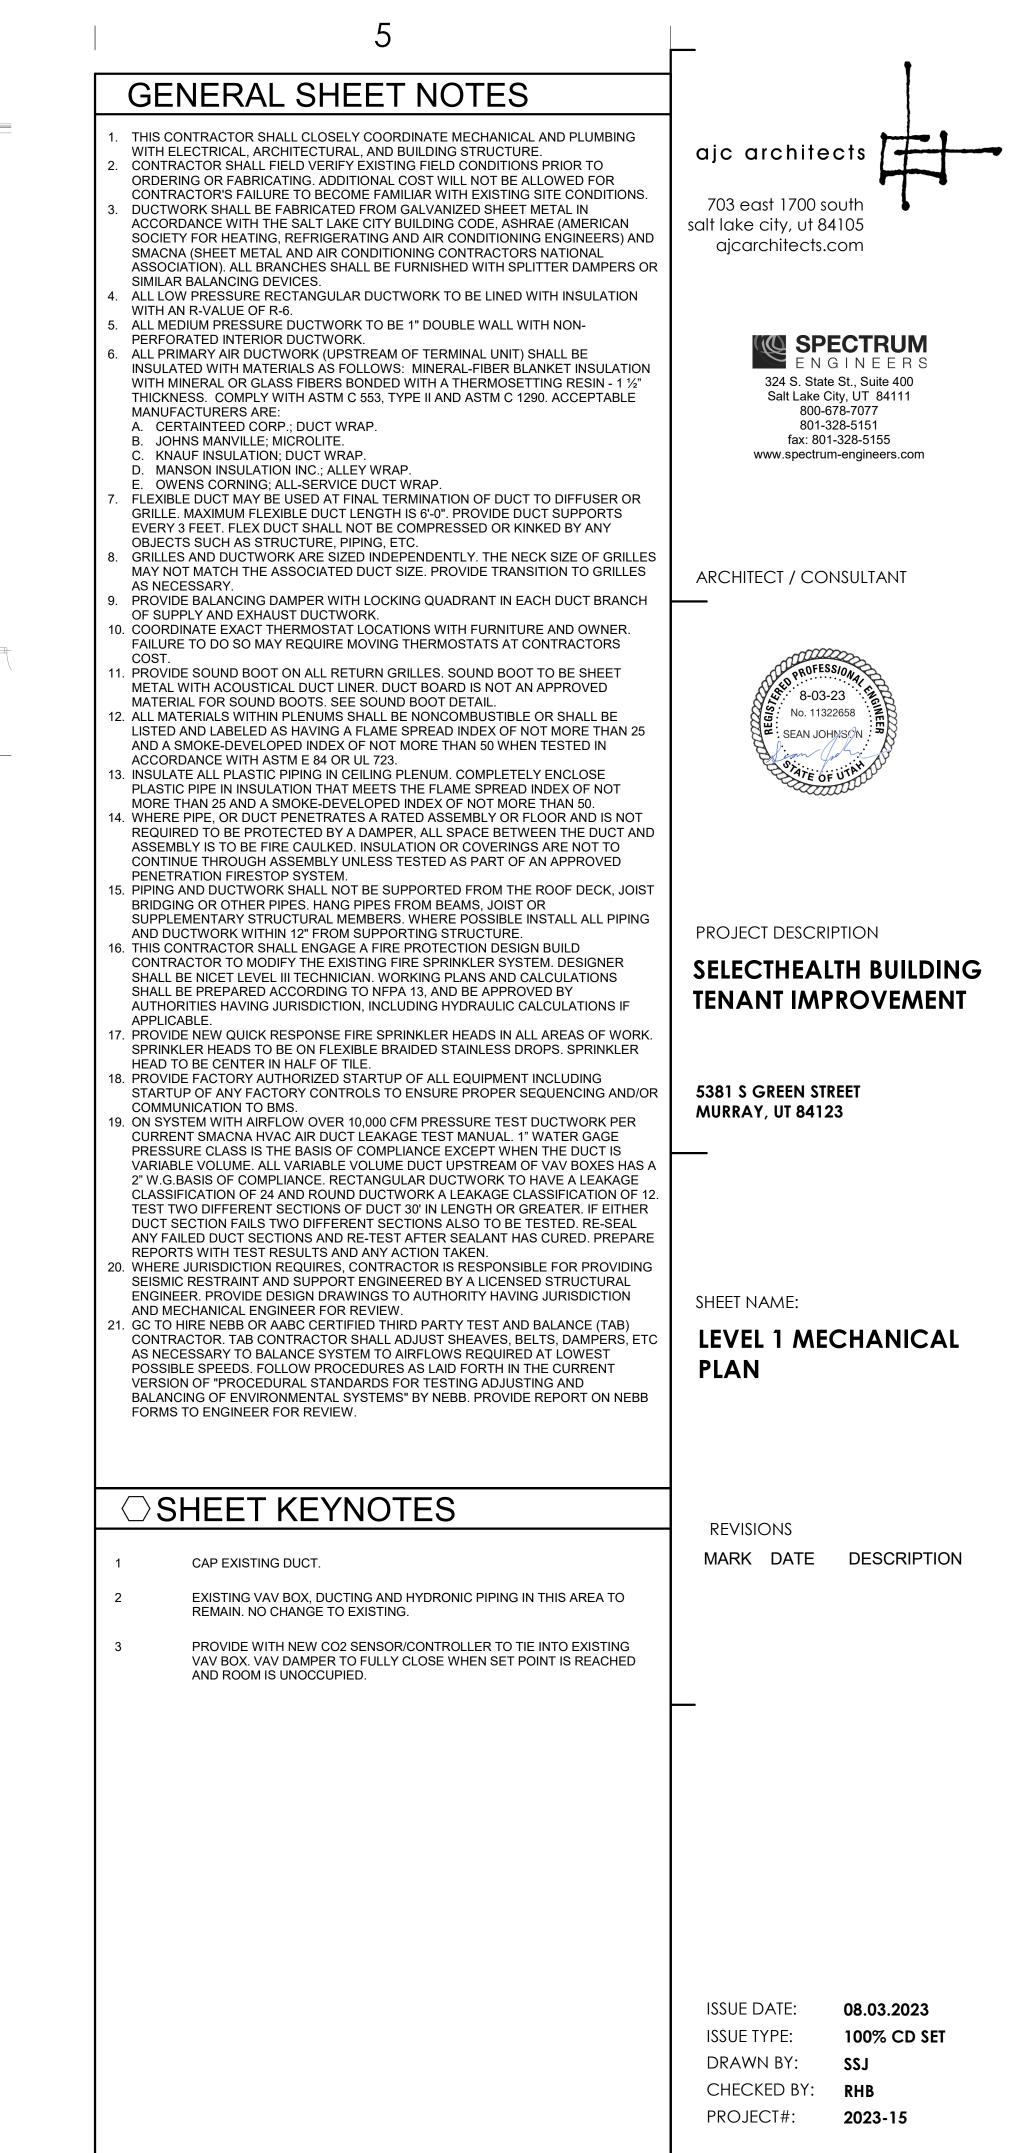

SHEET NUMBER:

**MH101**