

DPC shown indicative only and to be min 150 above external ground level
Window openings are structural openings. Window manufacture to allow tolerances

Job: Greenlands, Swineshead


**DWG:** Existing Site Plan

Scale: 1:200 @ A3

Date: Feb 20

DWG no: PL002 Rev -



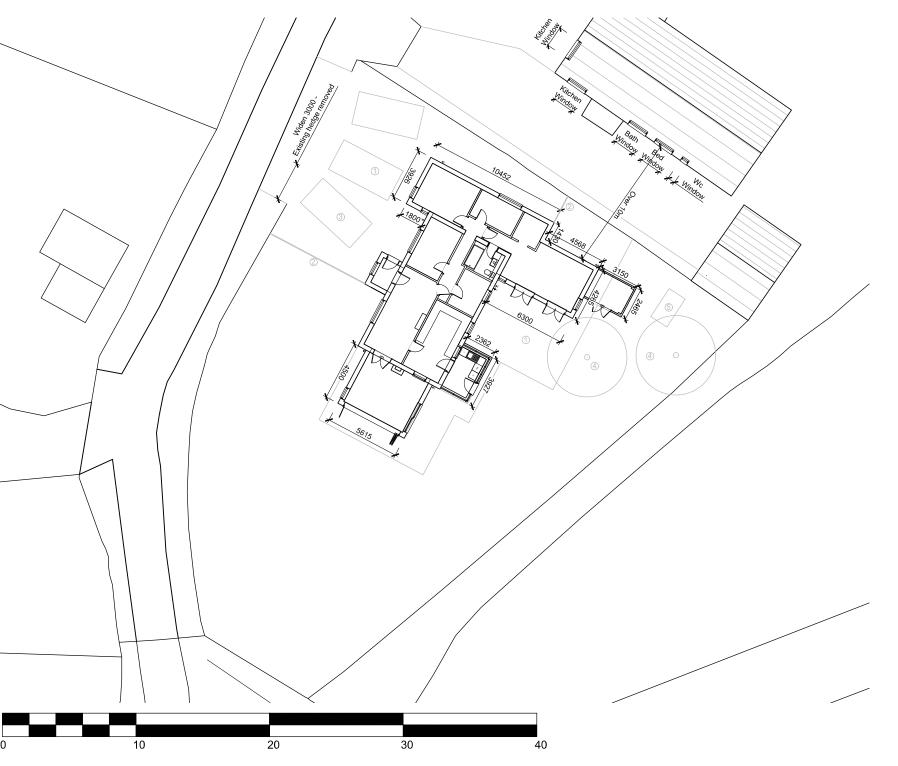

4. DPC shown indicative only and to be min 150 above external ground level Window openings are structural openings. Window manufacture to allow tolerance

## MATERIAL KEY

- 1. Hardstanding
- 2. 1.8m Closed Boarded Fencing
- 3. 3no Parking Spaces
- 4. Existing Tree Retained
- 5. Greenhouse Retained




Job: Greenlands, Swineshead

**DWG:** Proposed Site Plan

Scale: 1:200 @ A3

Date: Feb 20

DWG no: PL004 Rev -

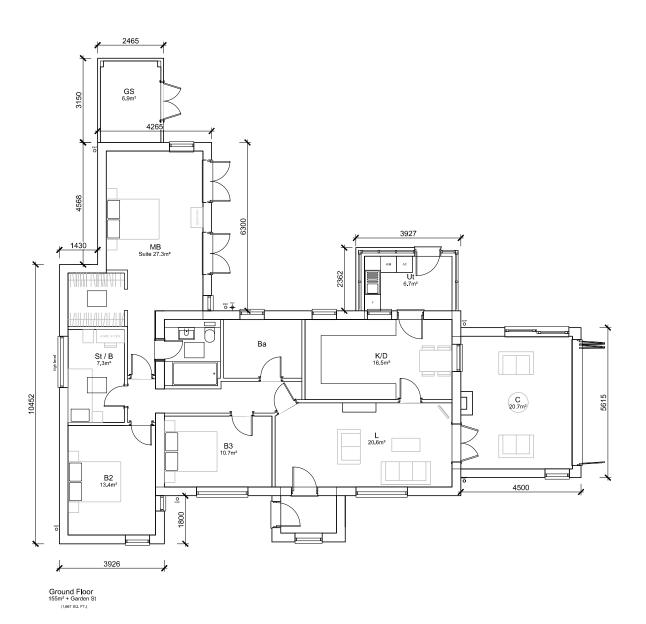



1. Internal dimensions are structural, to the face of the studs, blockwork or structural concrete

 Plot areas indicated are gross internal areas, room areas indicated are finished areas, not structural. Accuracy of areas shown on plans are subject to tolerances of site construction a

. For site setting out and ground levels, refer to civil engineer's drawings

DPC shown indicative only and to be min 150 above external ground level
Window openings are structural openings. Window manufacture to allow tolerance


Job: Greenlands, Swineshead

**DWG:** Proposed Floor Plan

Scale: 1:100 @ A3

Date: Feb 20

DWG no: PL005 Rev -

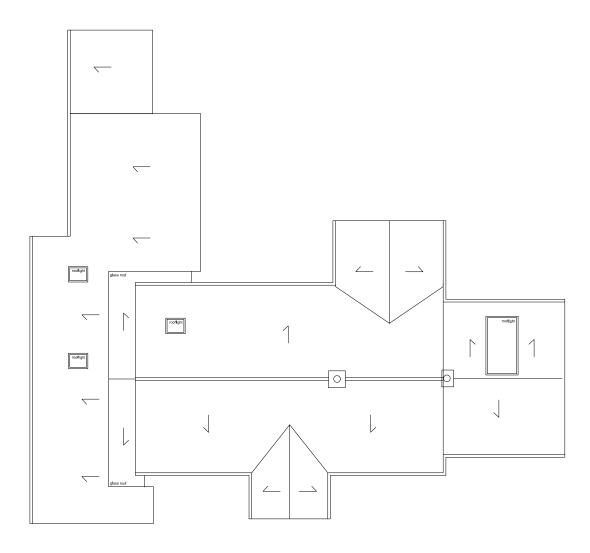

Roof Plan



Internal dimensions are structural, to the face of the studs, blockwork or structural concrete

Plot areas indicated are gross internal areas, room areas indicated are finished areas, not structural. Accuracy of areas shown on plans are subject to tolerances of site construction as detail decion.

3. For site setting out and ground levels, refer to civil engineer's drawings

For site secting out and ground levels, refer to civil engineers drawings.
DPC shown indicative only and to be min 150 above external ground level.

5. Window openings are structural openings. Window manufacture to allow tolerance

Job: Greenlands, Swineshead

**DWG:** Proposed Roof Plan

**Scale:** 1:100 @ A3

Date: Feb 20

DWG no: PL006 Rev -



Internal dimensions are structural, to the face of the studs, blockwork or structural concrete walls


Piot areas indicated are gross internal areas, room areas indicated are finished areas, not structural. Accuracy of areas shown on plans are subject to tolerances of site construction as detail design.


For eith patting out and ground levels, refer to civil angioner's drawlong

DPC shown indicative only and to be min 150 above external ground level
Window openings are structural openings. Window manufacture to allow tolers

## MATERIAL KEY

- New Windows / Doors Anthracite Grey External, White Internal
- Vertical Timber Cladding (Natural Finish)
- Metal roof
- Rooflights
- New Chimney
- 6. New Rendered Wall
- 7. New Concrete Blockwork Wall

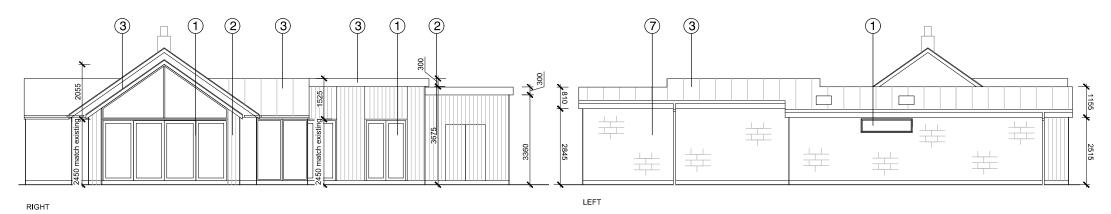

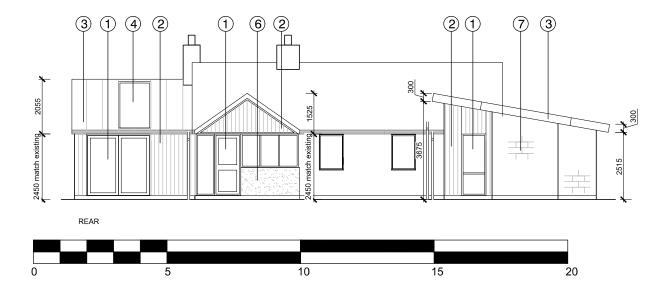

Job: Greenlands, Swineshead

**DWG:** Proposed Elevations

Scale: 1:100 @ A3

Date: Feb 20

DWG no: PL007 Rev -



Job: Greenlands, Swineshead

**DWG:** Rear Artist Visualidation

Scale: NTS @ A3

Date: Feb 20

DWG no: PL008 Rev -