
# CARROLL RESIDENCE


# 11303 KEEWAYDIN ISLAND NAPLES FLORIDA




ABBREVIATIONS LIST:				
ABY.	ABOVE	LAY.	LAVATORY	
ALUM.	ALUMINUM	LIN.	LINEN	
ARCH.	ARCHITECTURAL OR ARCHITECT	L.P.	LIQUID PROPANE	
BLDG.	BUILDING	L.P.	LOWER POINT	
BM.	BEAM	(M)	MEASURE	
C.C.C.L.	COASTAL CONSTRUCTION CONTROL LINE	MANUF.	MANUFACTURER	
CLG.	CEILING	MAX.	MAXIMUM	
C.M.U.	CONCRETE MASONRY UNIT	M.D.	MOTORIZED DRAPERY	
CONC.	CONCRETE	MECH.	MECHANICAL	
D.D.	DECK DRAIN	MIN.	MINIMUM	
DECO.	DECORATIVE	MIRR.	MIRROR	
D.E.P.	DEPARTMENT OF ENVIRONMENTAL PROTECTION	N.A.Y.D.	NORTH AMERICAN VERTICAL DATUM	
DISP.	DISPOSAL			
DIST.	DISTANCE	O.C.	ON CENTER	
D.S.	DOWN SPOUT	(P)	PLATTED	
DWGS.	DRAWINGS	R.D.	ROOF DRAIN	
ELEV.	ELEVATION	REF.	REFER	
ELEV.	ELEVATOR	REF.	REFRIGERATOR	
ELEC.	ELECTRICAL	RES.	RESIDENCE OR RESIDENTIAL	
ENG.	ENGINEER	SECT.	SECTION	
EQUIP.	EQUIPMENT	SHWR	SHOWER	
F.F.	FINISHED FLOOR	6.P.	SPRING POINT	
FIN.	FINISHED	SPECS.	SPECIFICATIONS	
FLR.	FLOOR	STO.	STORAGE	
FRZ.	FREEZER	STRUCT.	STRUCTURAL	
G.C.	GENERAL CONTRACTOR	T. & G.	TONGUE AND GROOVE	
GWB.	GYPSUM WALL BOARD	T.O.	TOP OF	
GYP. BD.	GYPSUM BOARD	TYP.	TYPICAL	
HABIT.	HABITABLE	u.c.	UNDER COUNTER	
H.B.	HOSE BIB	VEST.	VESTIBULE	
HDR.	HEADER	W.C.	WATER CLOSET	
<u>₽</u> .	HIGH POINT	W.D.	WARMER DRAWER	
HVAC.	HEATING, VENTILATING & AIR CONDITIONING	W.H.	WATER HEATER	
I.D.	INTERIOR DESIGNER	W.I.C.	WALK IN CLOSET	

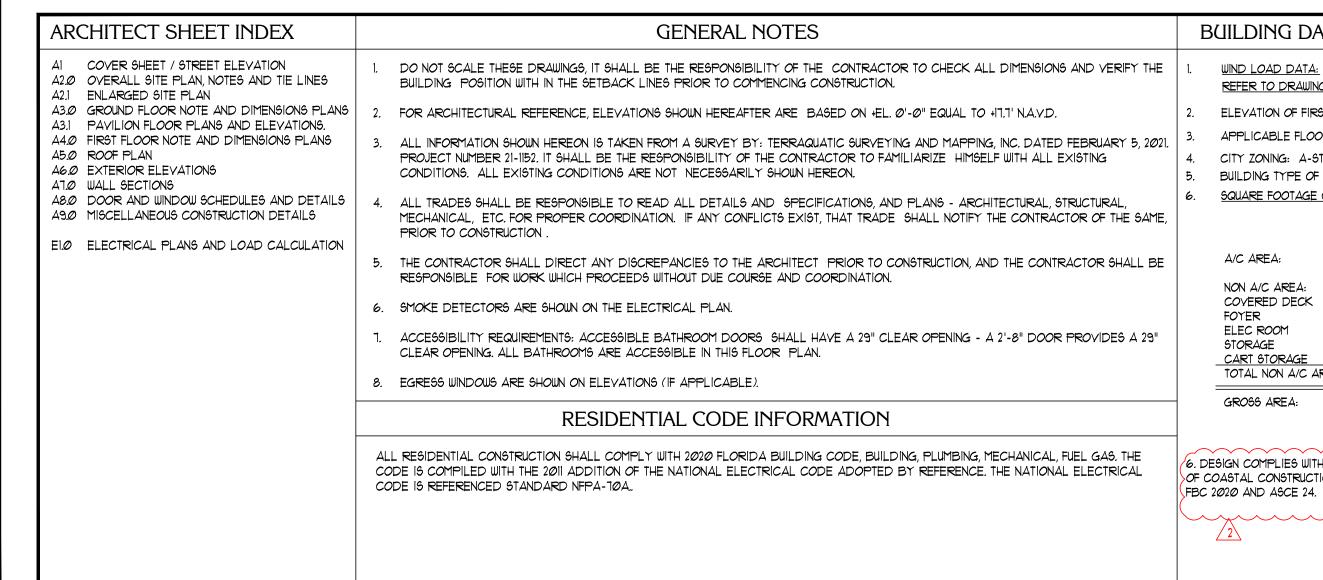



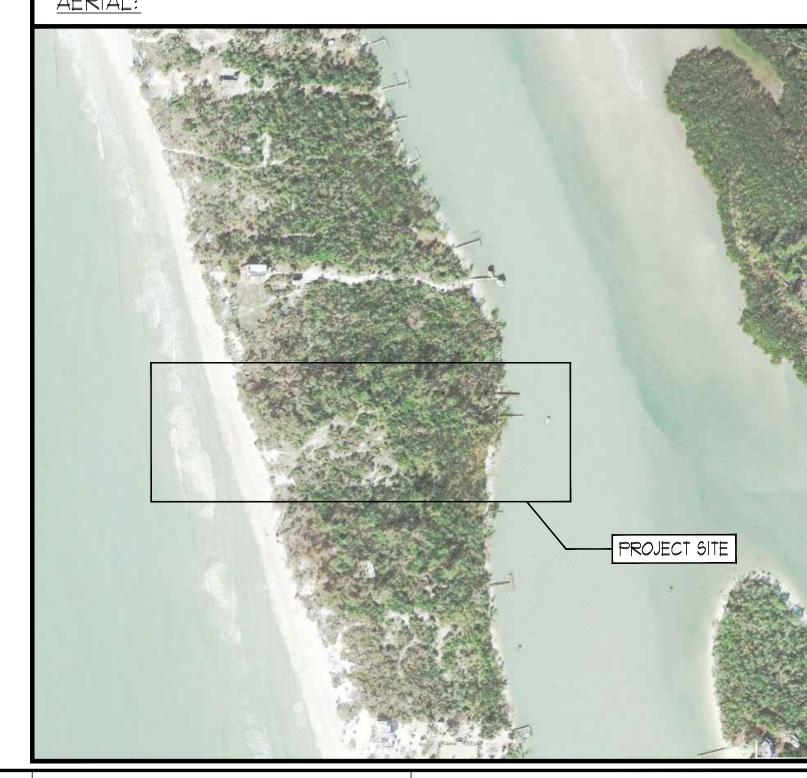

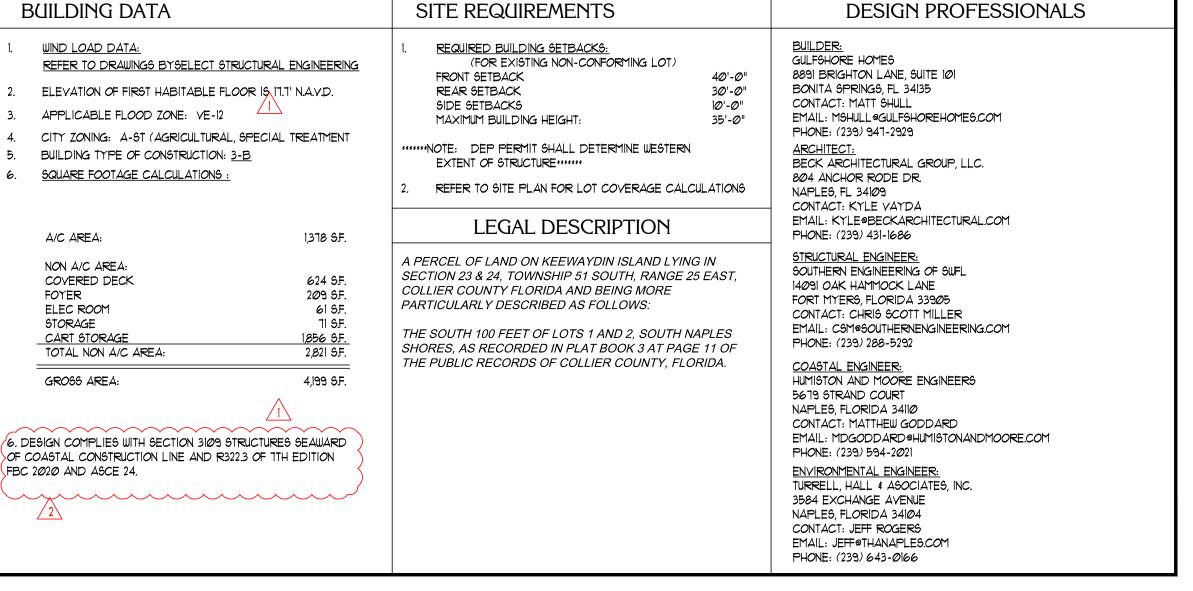








2104-03

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LEGEND

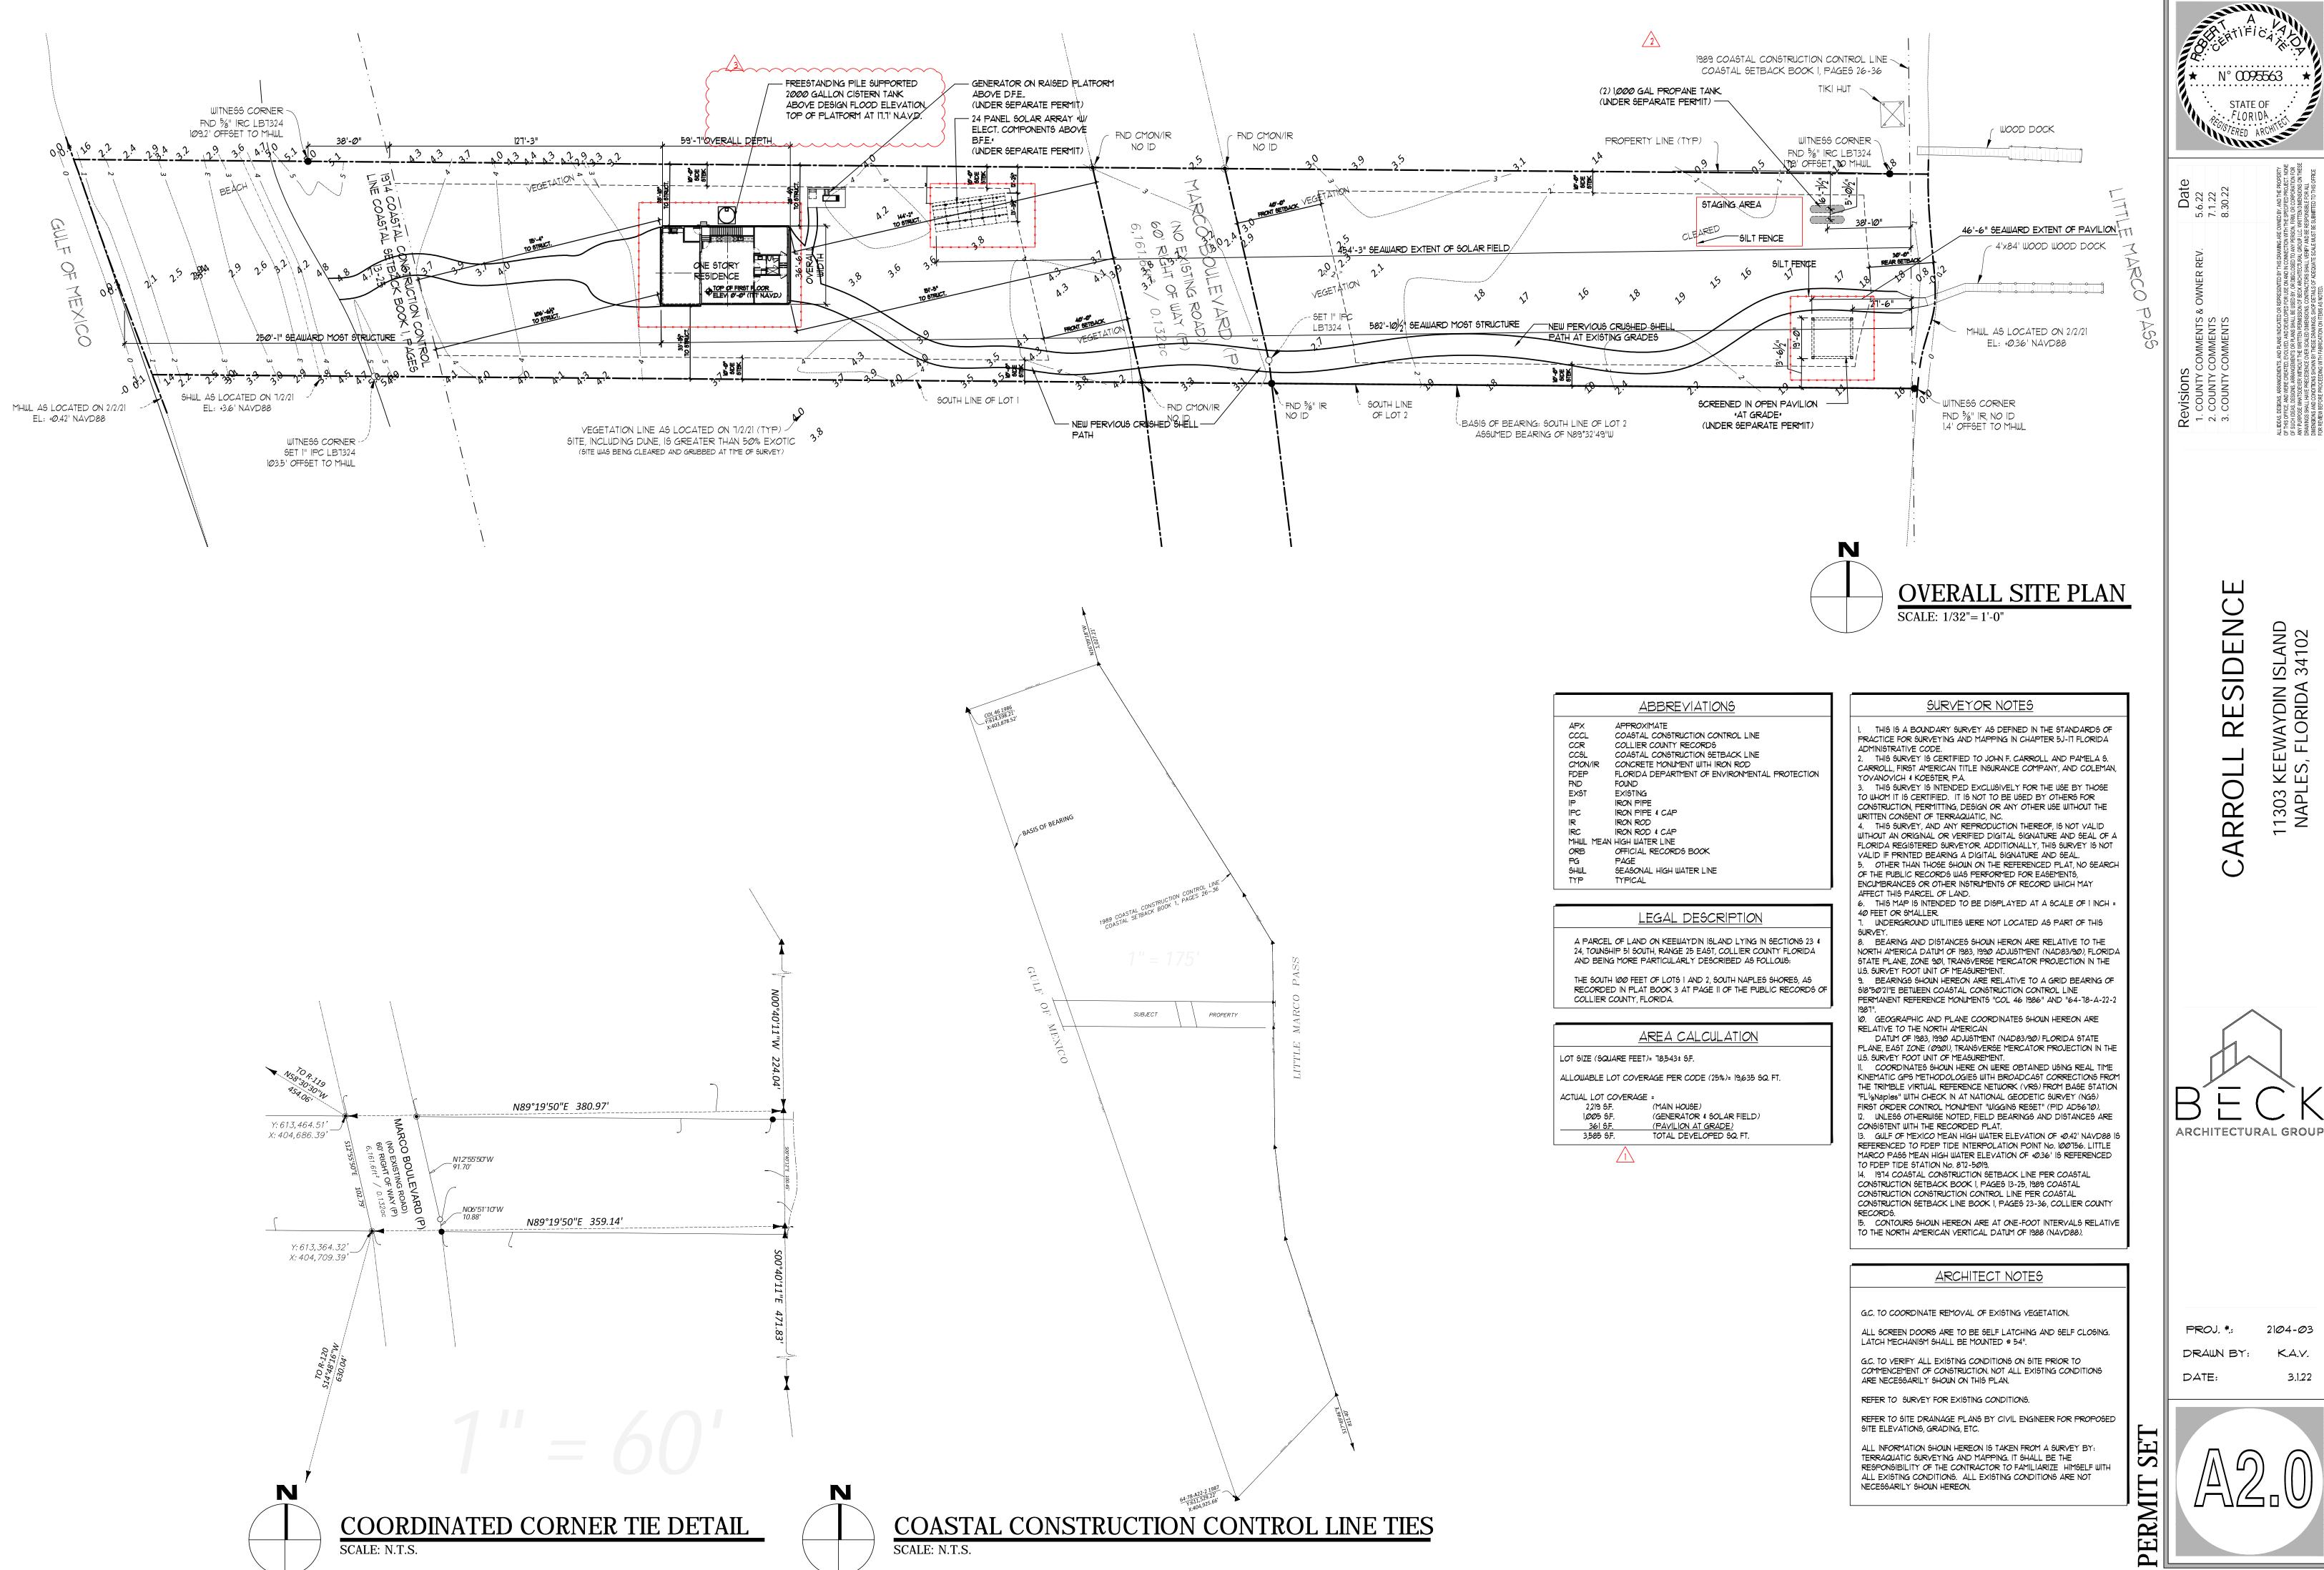CONCRETE COLUMN/ WALL. REFER TO STRUC.PLANS. INTERIOR STUD BEARING WALL

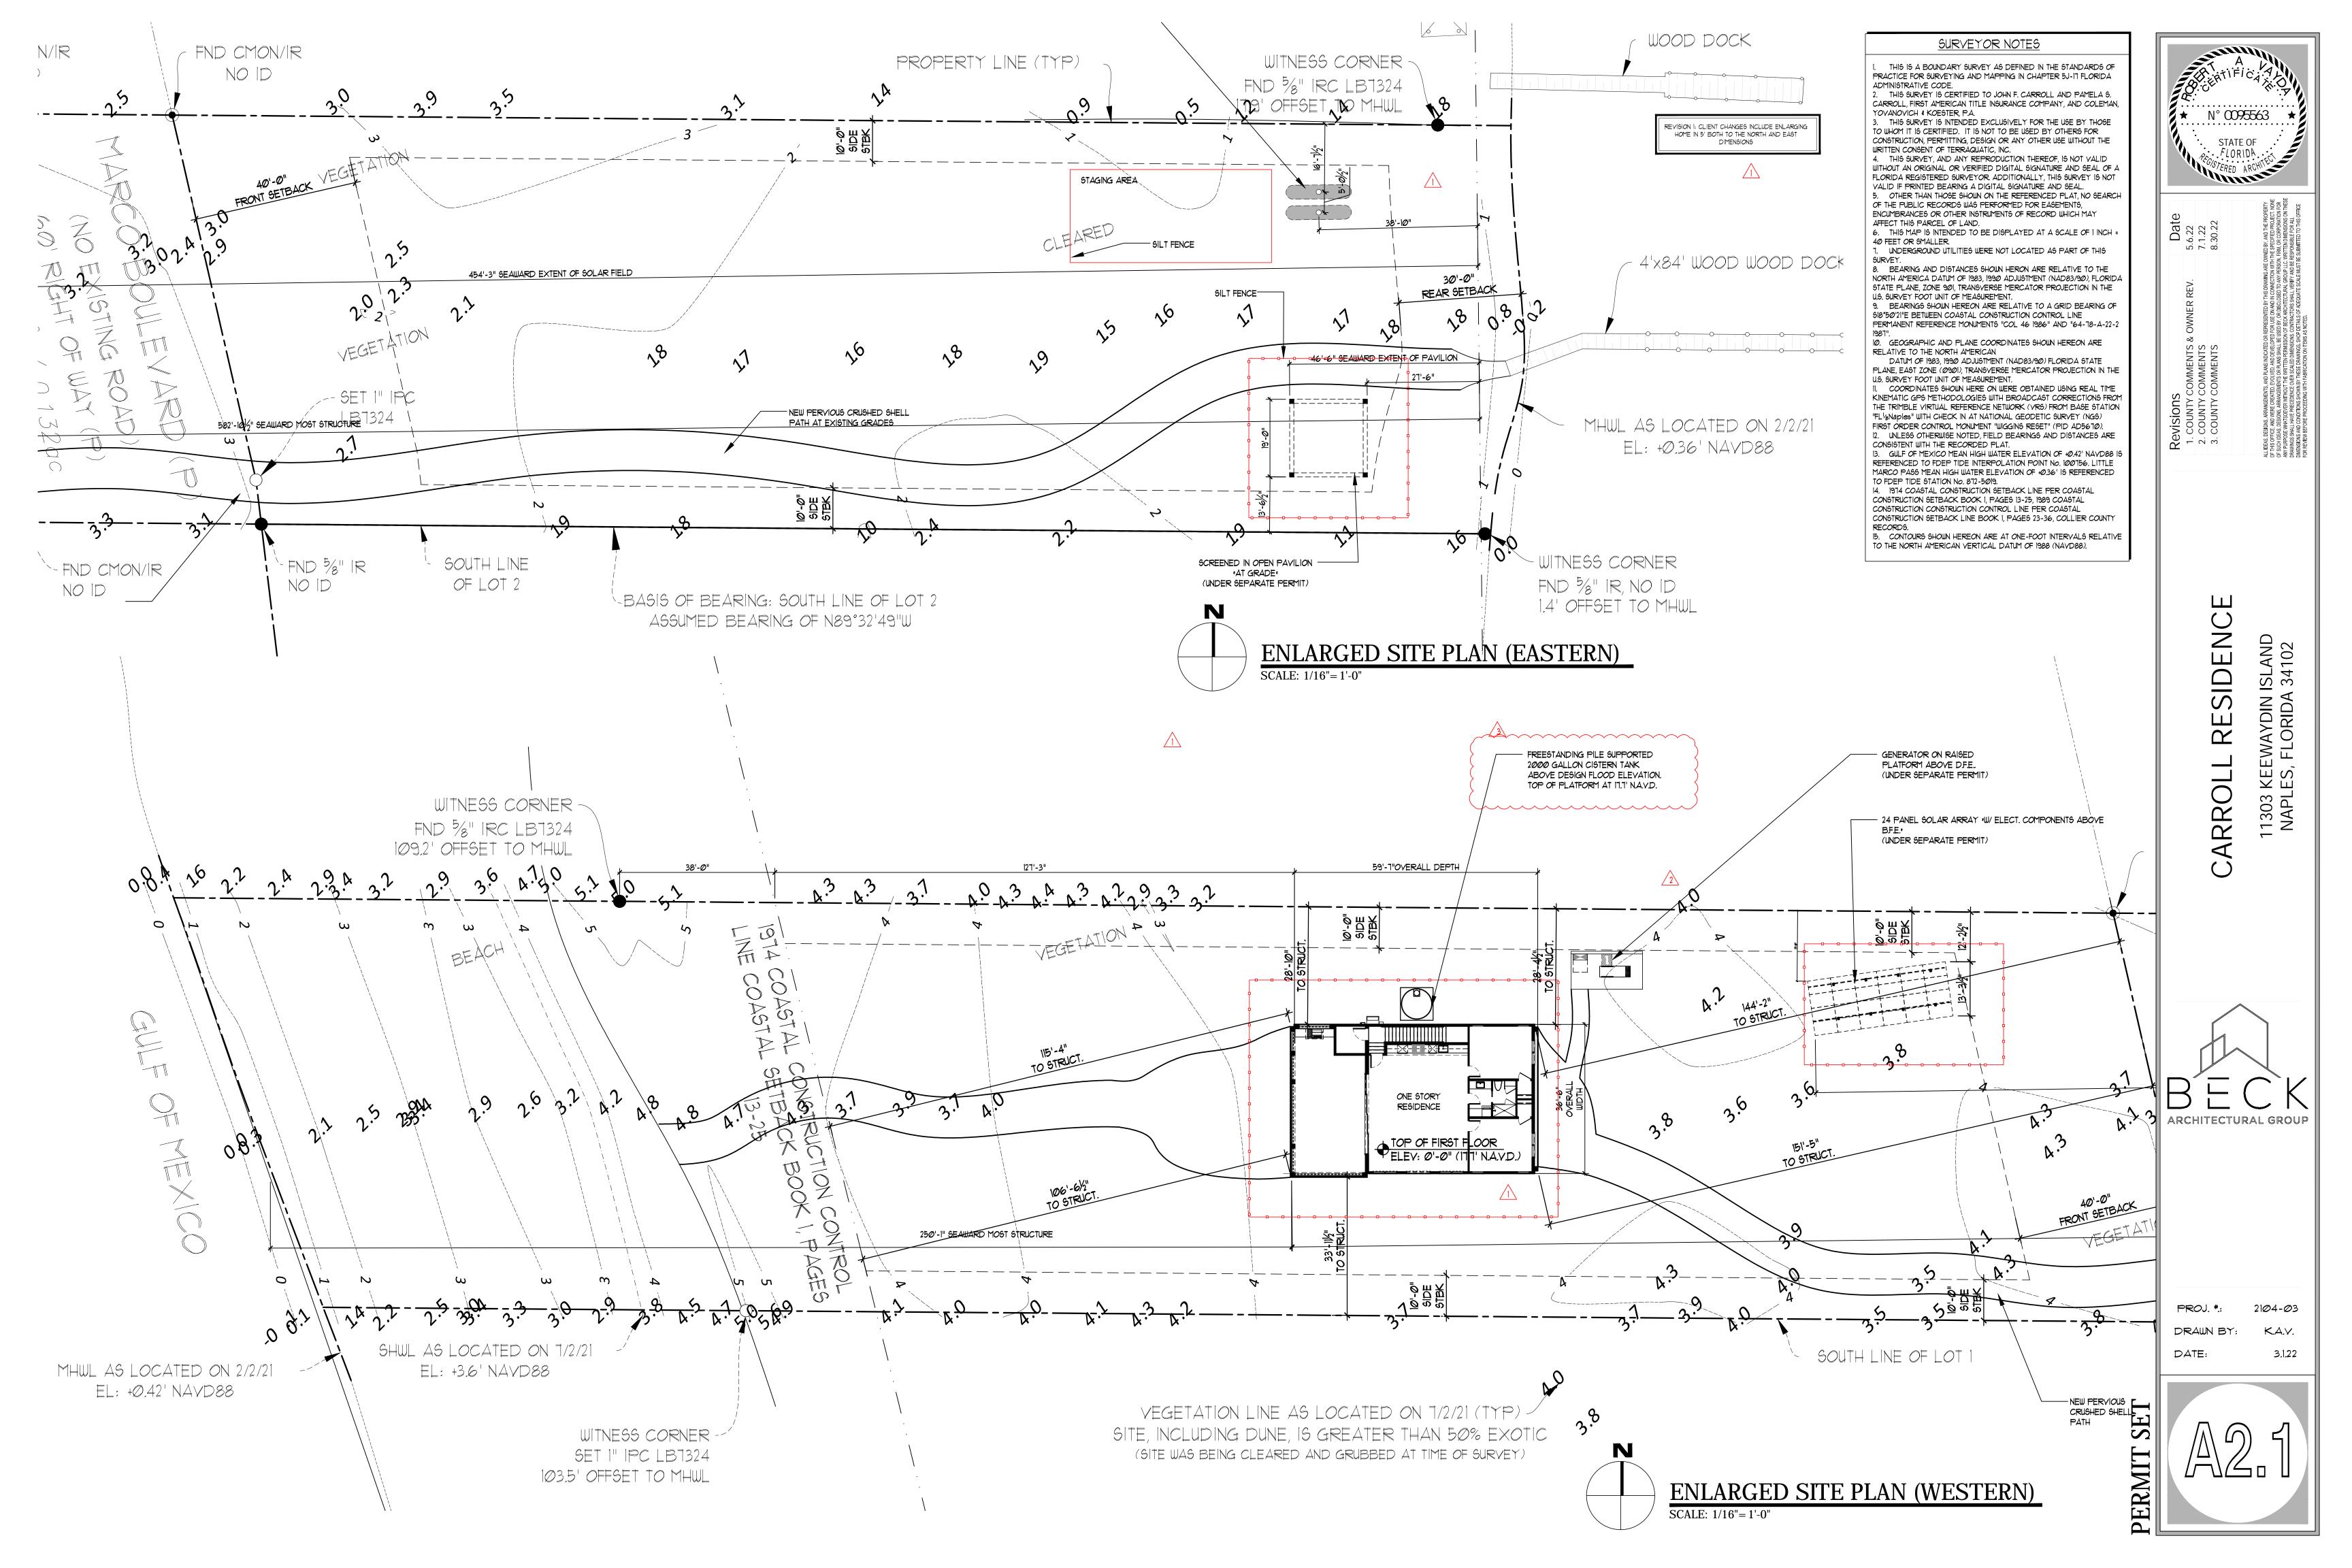STUD WALL

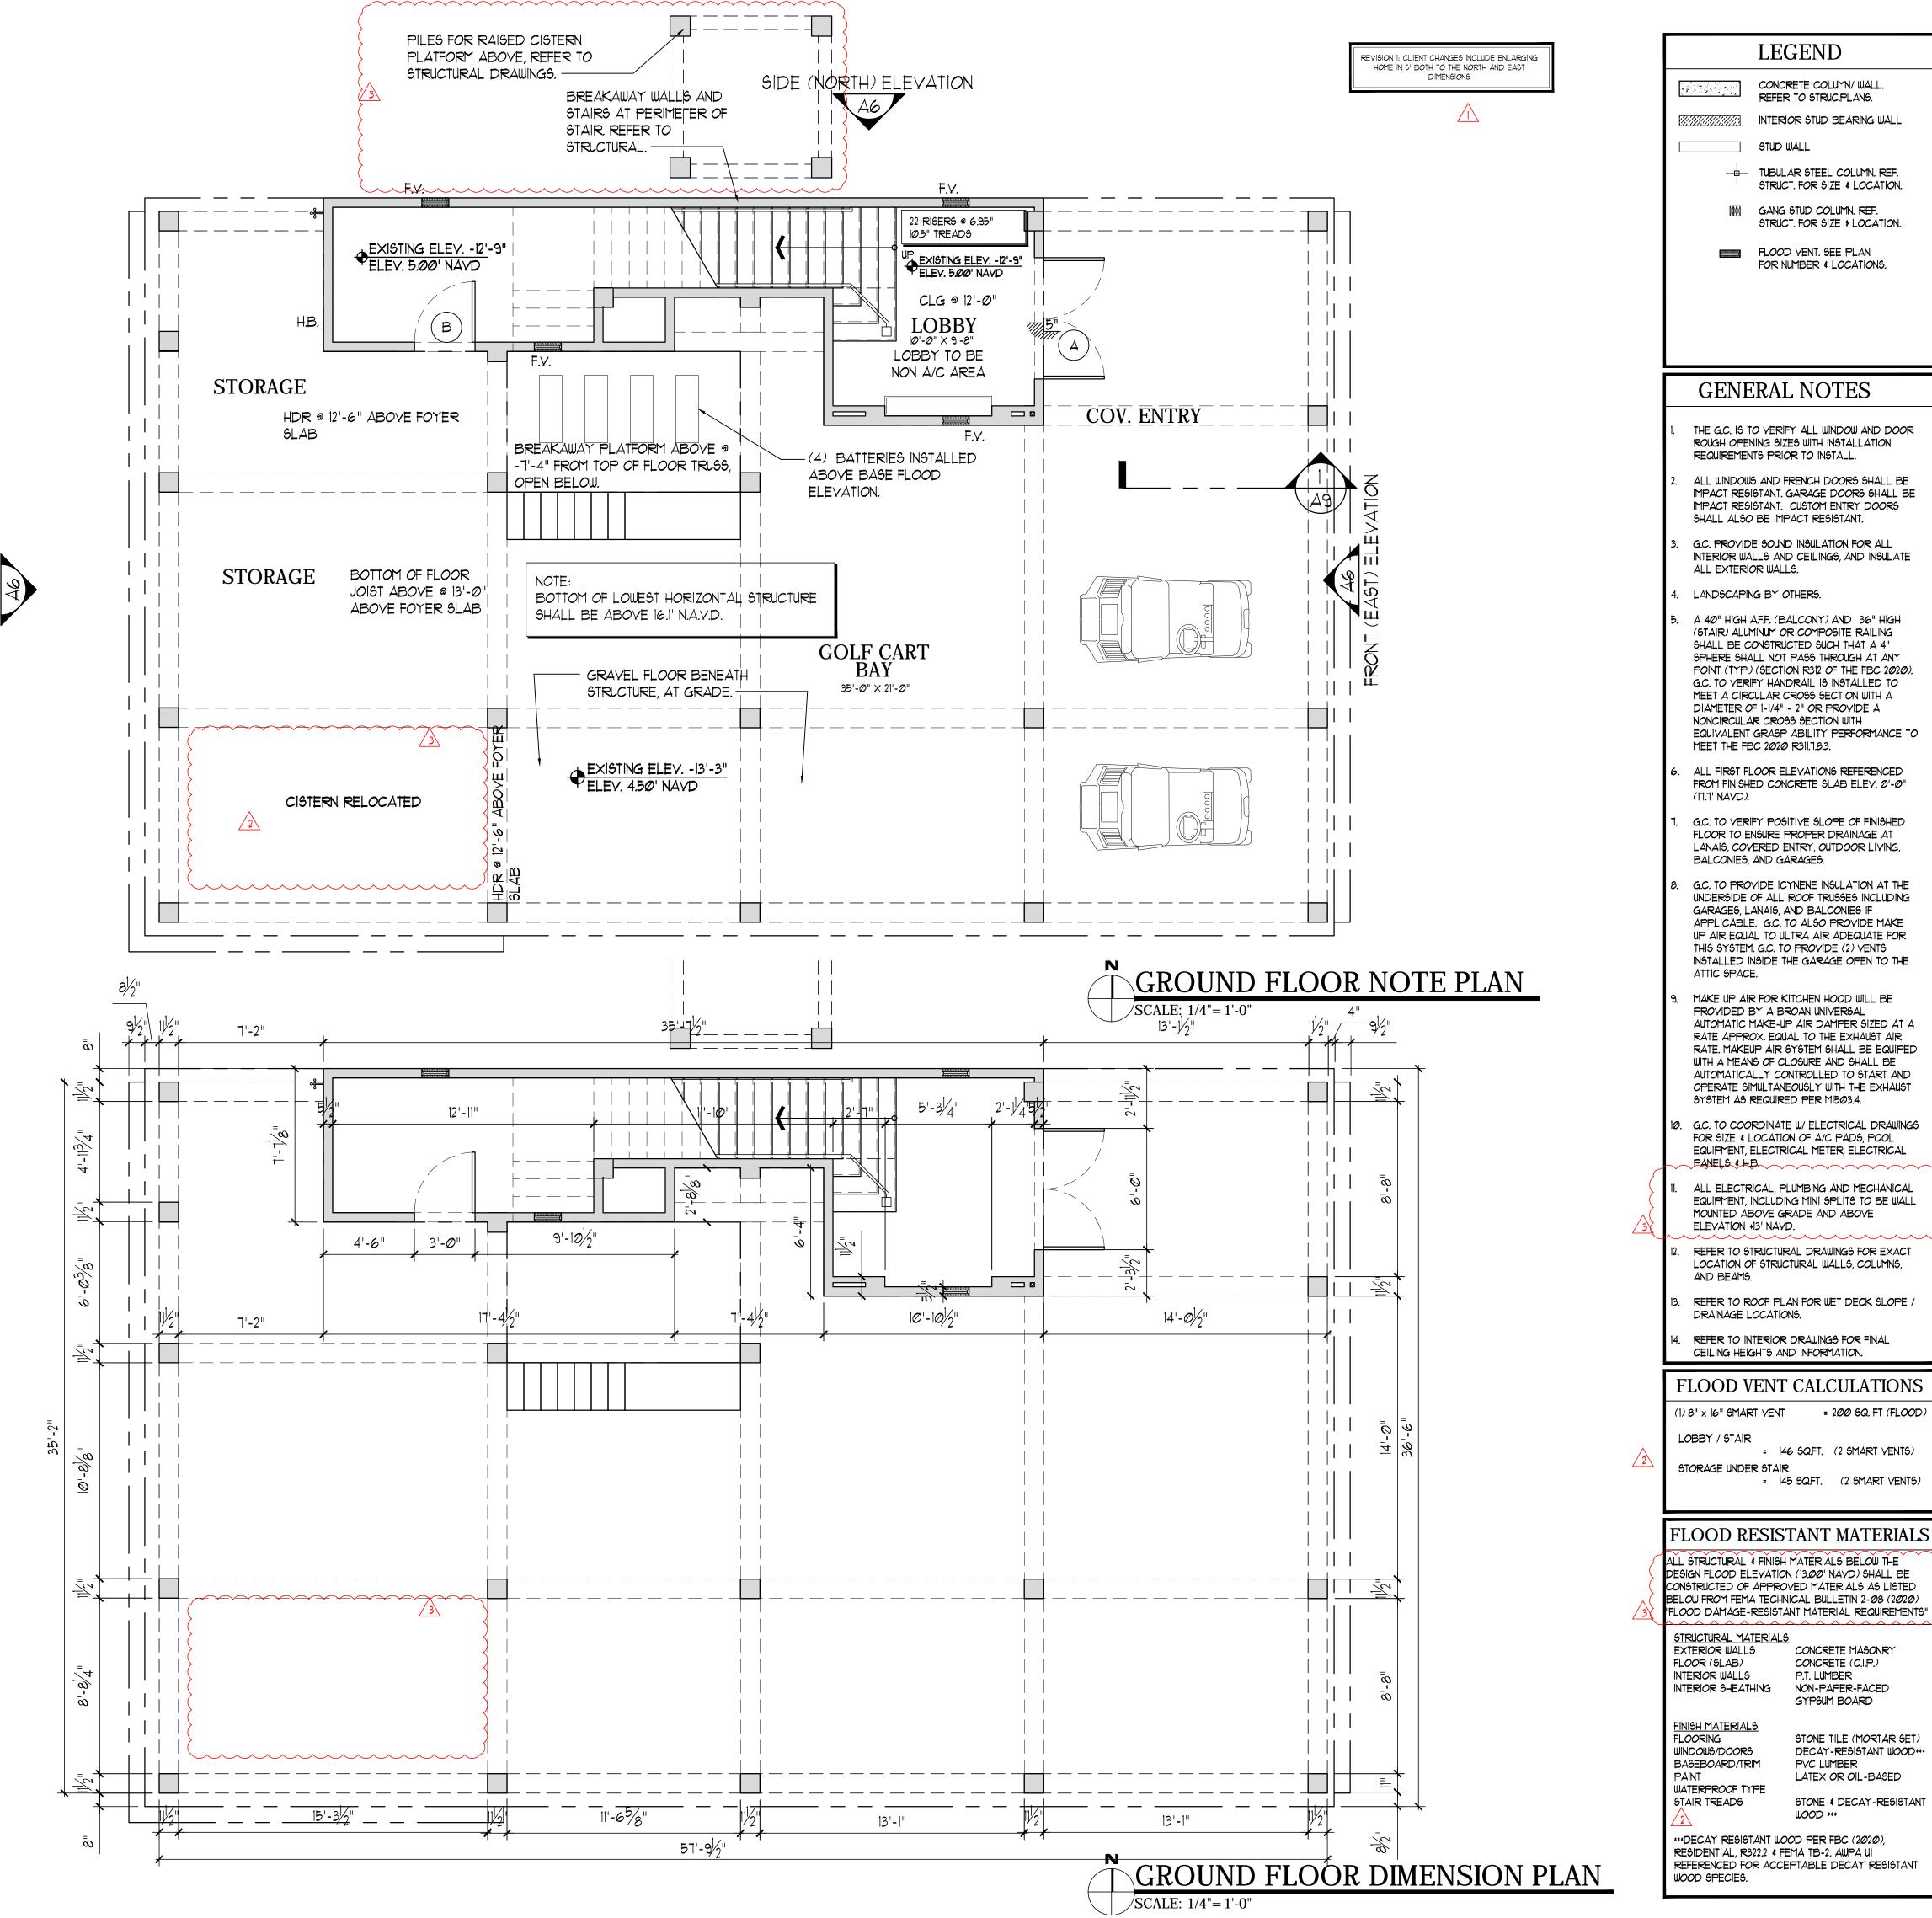TUBULAR STEEL COLUMN. REF. STRUCT. FOR SIZE & LOCATION.

M GANG STUD COLUMN. REF. STRUCT. FOR SIZE \$ LOCATION.

FOR NUMBER & LOCATIONS.

FLOOD VENT. SEE PLAN

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- LANDSCAPING BY OTHERS.
- A 40" HIGH AFF. (BALCONY) AND 36" HIGH (STAIR) ALUMINUM OR COMPOSITE RAILING SHALL BE CONSTRUCTED SUCH THAT A 4" SPHERE SHALL NOT PASS THROUGH AT ANY POINT (TYP.) (SECTION R312 OF THE FBC 2020). G.C. TO VERIFY HANDRAIL IS INSTALLED TO MEET A CIRCULAR CROSS SECTION WITH A DIAMETER OF 1-1/4" - 2" OR PROVIDE A NONCIRCULAR CROSS SECTION WITH EQUIVALENT GRASP ABILITY PERFORMANCE TO MEET THE FBC 2020 R311.7.8.3.
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- REFER TO ROOF PLAN FOR WET DECK SLOPE / DRAINAGE LOCATIONS.
- REFER TO INTERIOR DRAWINGS FOR FINAL CEILING HEIGHTS AND INFORMATION.

LOOD VENT	CALCULATIONS
3" x 16" SMART VENT	= 200 SQ. FT (FLOOD)

LOBBY / STAIR = 146 SQFT. (2 SMART VENTS) STORAGE UNDER STAIR

= 145 SQ.FT. (2 SMART VENTS)

FLOOD RESISTANT MATERIALS ALL ŠTRUCTURÁL & FINISH MATÉRIÁLS BÉLOW THE DESIGN FLOOD ELEVATION (13.00' NAVD) SHALL BE CONSTRUCTED OF APPROVED MATERIALS AS LISTED BELOW FROM FEMA TECHNICAL BULLETIN 2-08 (2020)

STRUCTURAL MATERIALS EXTERIOR WALLS FLOOR (SLAB) INTERIOR WALLS P.T. LUMBER NON-PAPER-FACED

INTERIOR SHEATHING FINISH MATERIALS FLOORING WINDOWS/DOORS

STONE TILE (MORTAR SET) DECAY-RESISTANT WOOD\*\*\* PVC LUMBER LATEX OR OIL-BASED


CONCRETE MASONRY

CONCRETE (C.I.P.)

GYPSUM BOARD

STONE & DECAY-RESISTANT WOOD \*\*\*

OD PER FBC (2020),
:MA TB-2. AWPA UI
PTABLE DECAY RESISTANT \*\*\*DECAY RESISTANT WOOD PER FBC (2020), RESIDENTIAL, R322.2 & FEMA TB-2. AWPA UI REFERENCED FOR ACCEPTABLE DECAY RESISTANT

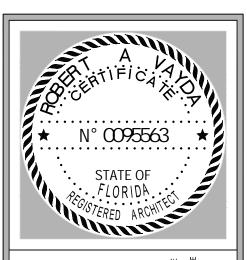



SIDEN KEEWAYDIN ISLAND ES, FLORIDA 34102 RE ~

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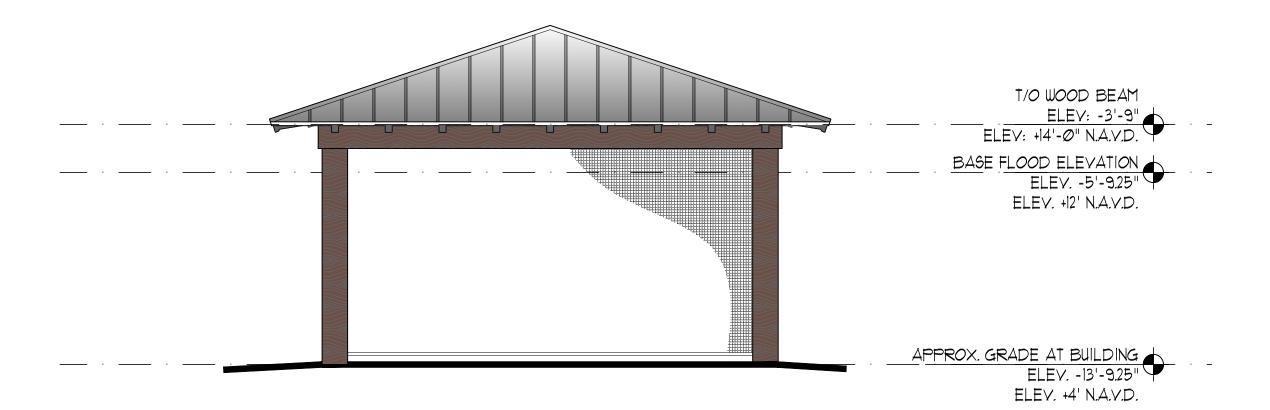


PROJ. #.: 2104-03 DATE: 3.1.22



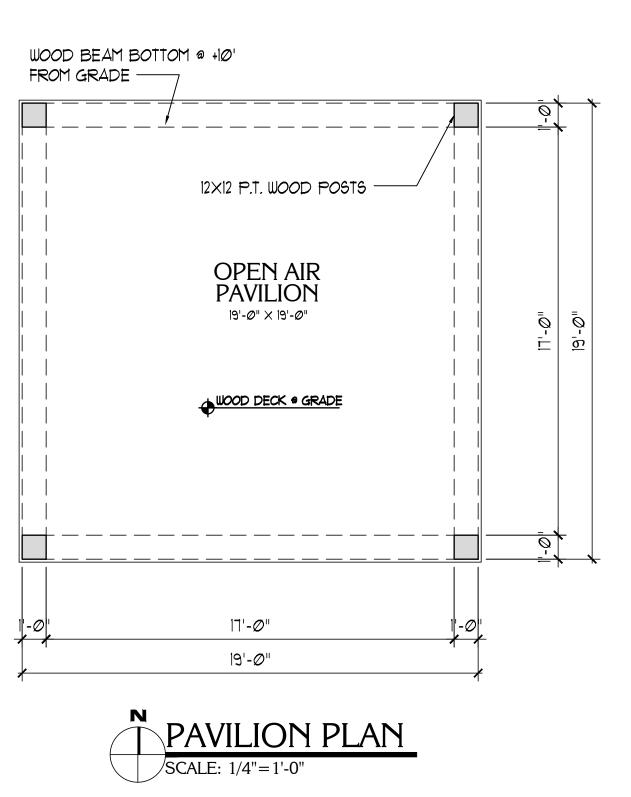

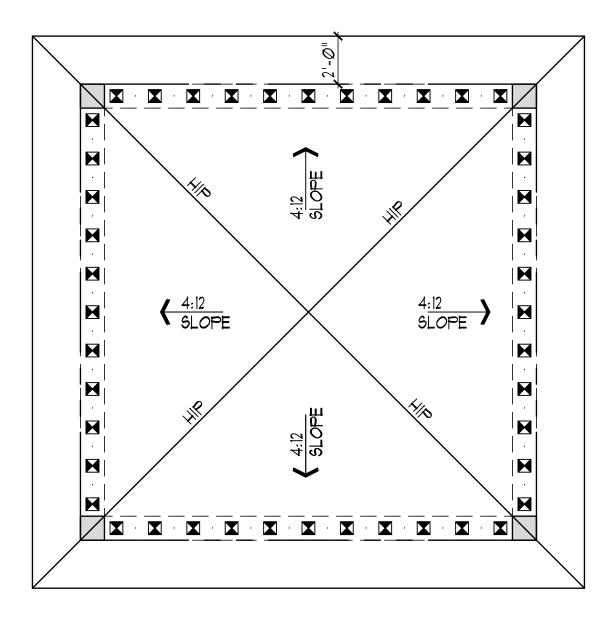



PAVILION ELEVATION (TYPICAL) SCALE: 1/4"=1'-0"

# LEGEND

CONCRETE COLUMN/ WALL. REFER TO STRUC.PLANS. INTERIOR STUD BEARING WALL

STUD WALL


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FLOOD VENT. SEE PLAN FOR NUMBER & LOCATIONS.

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SIDENCE

303 KEEWAYDIN ISLAND APLES, FLORIDA 34102 R 30LL ARF




PROJ. #.: 2104-03 DRAWN BY:

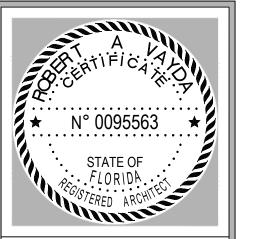DATE:

3.1.22

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**№** N° 0095563 LUKIDA ARCHITECT
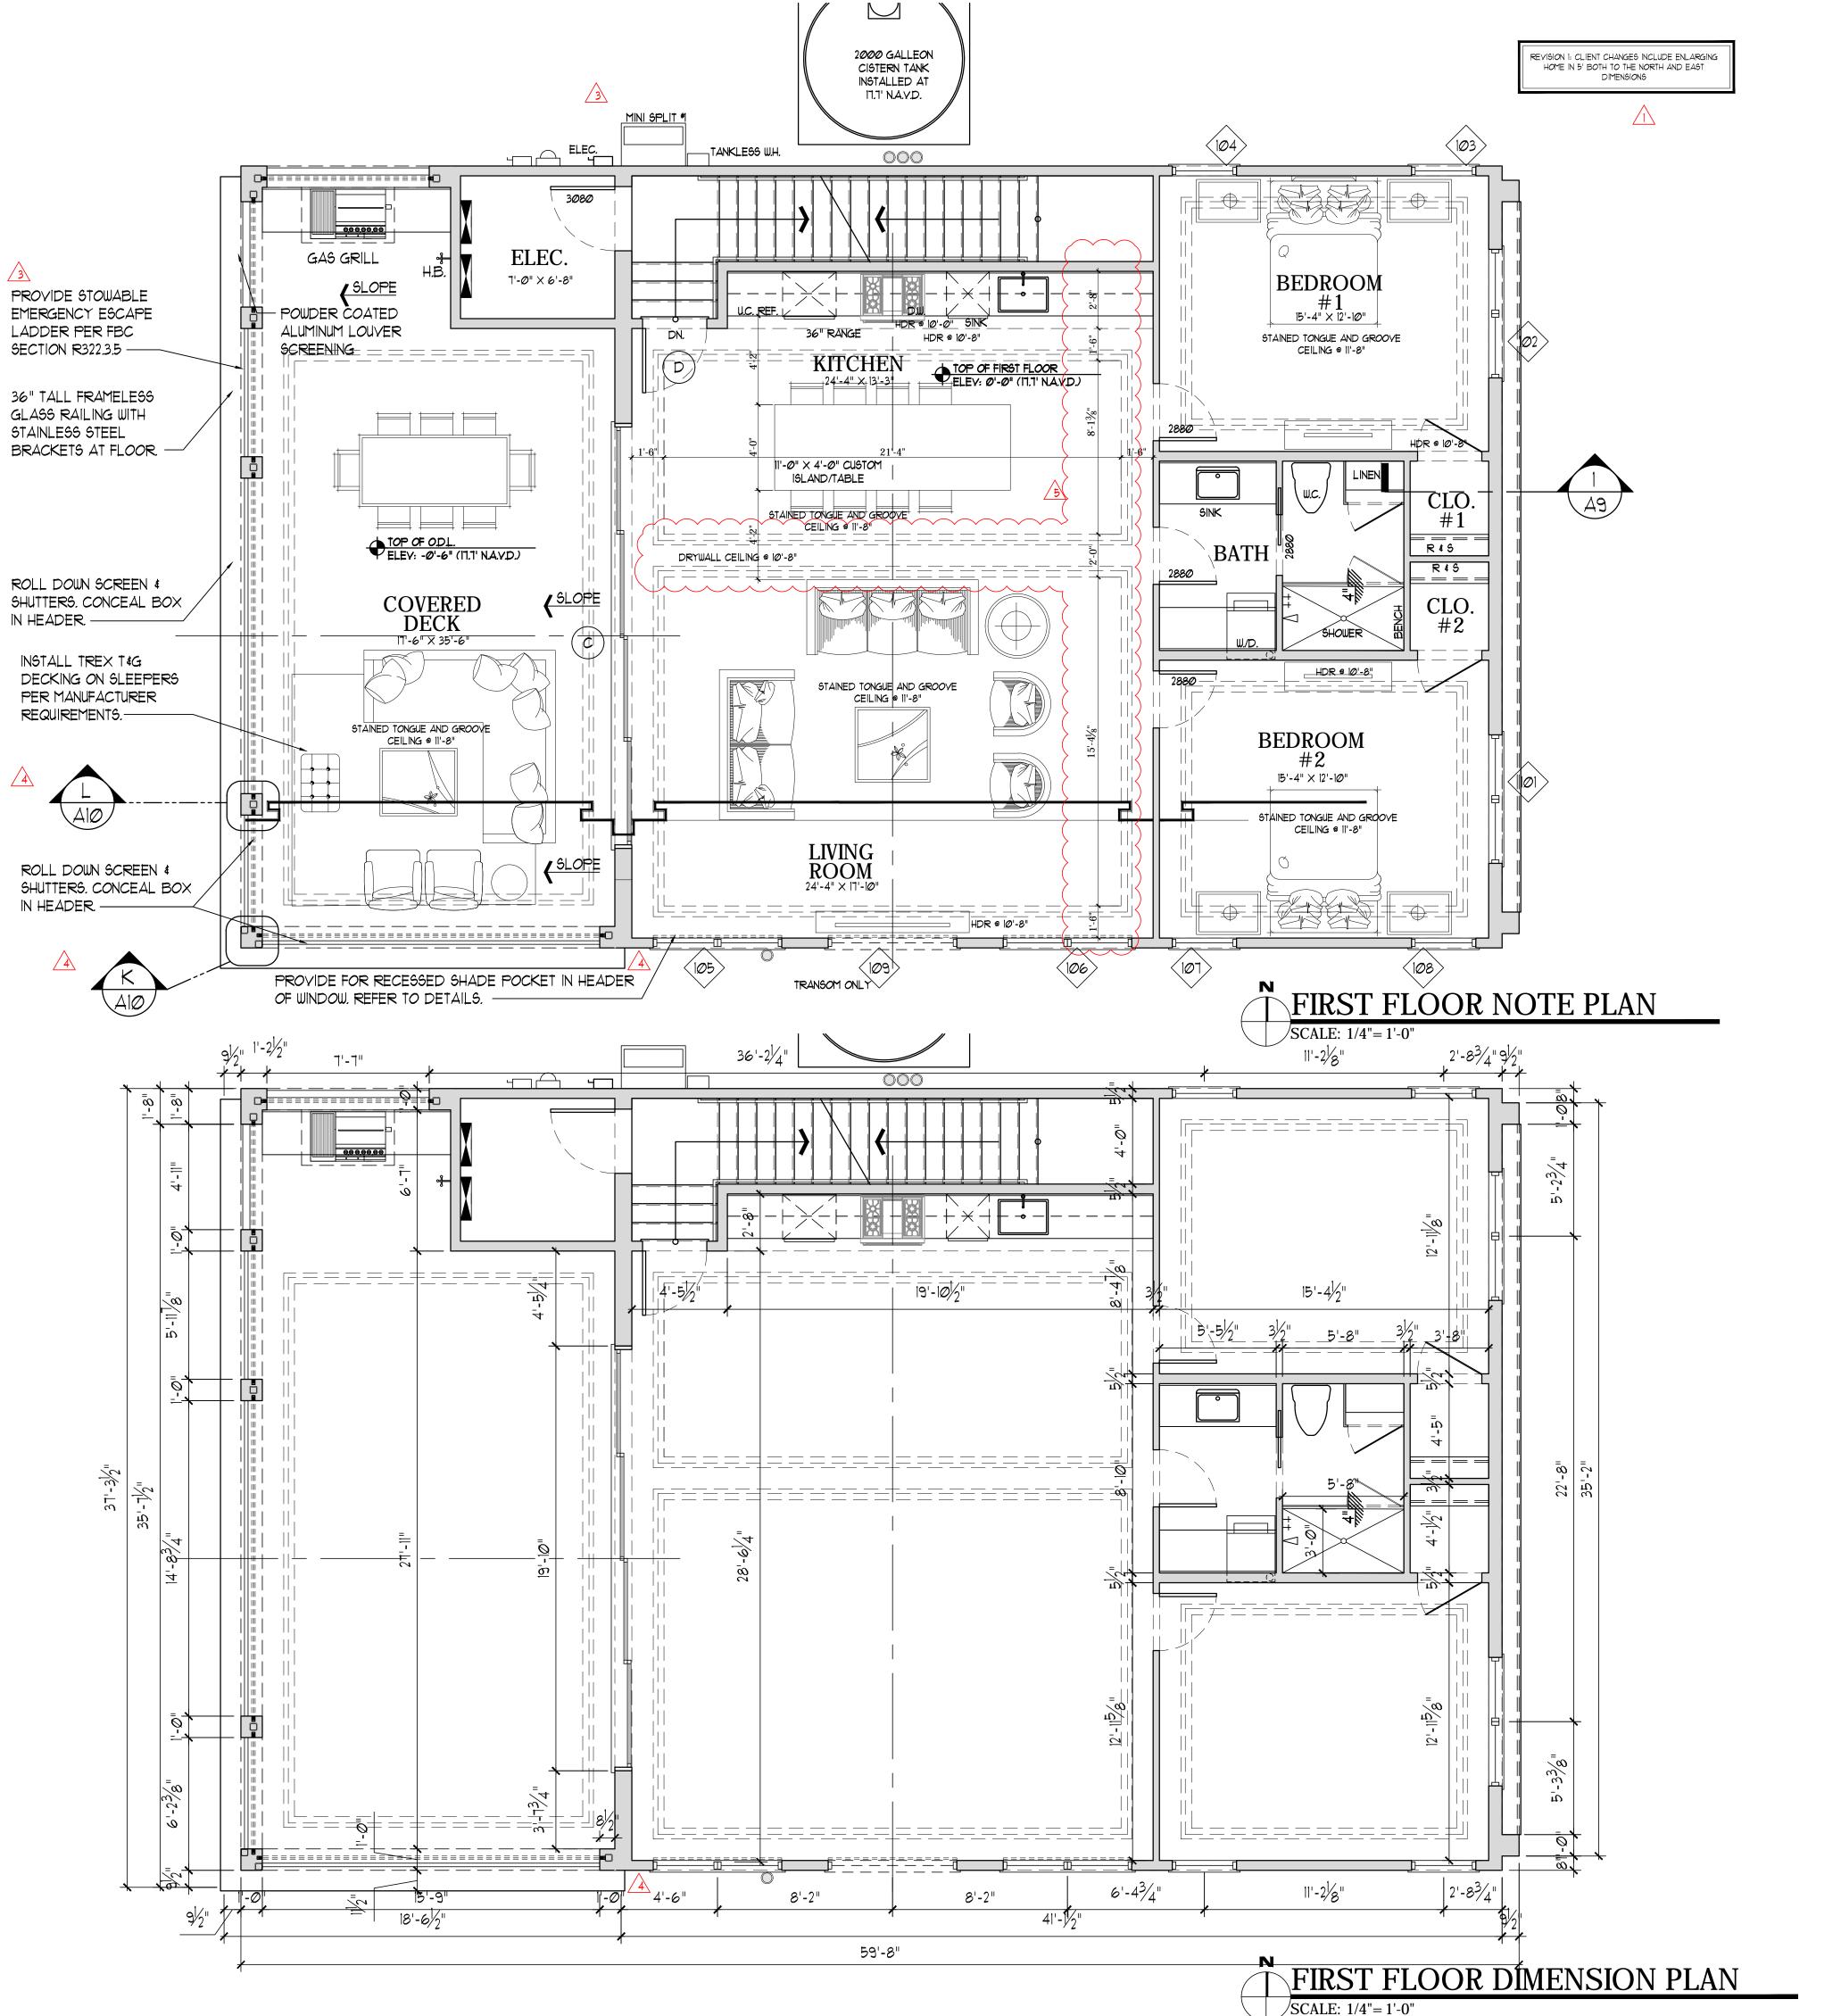
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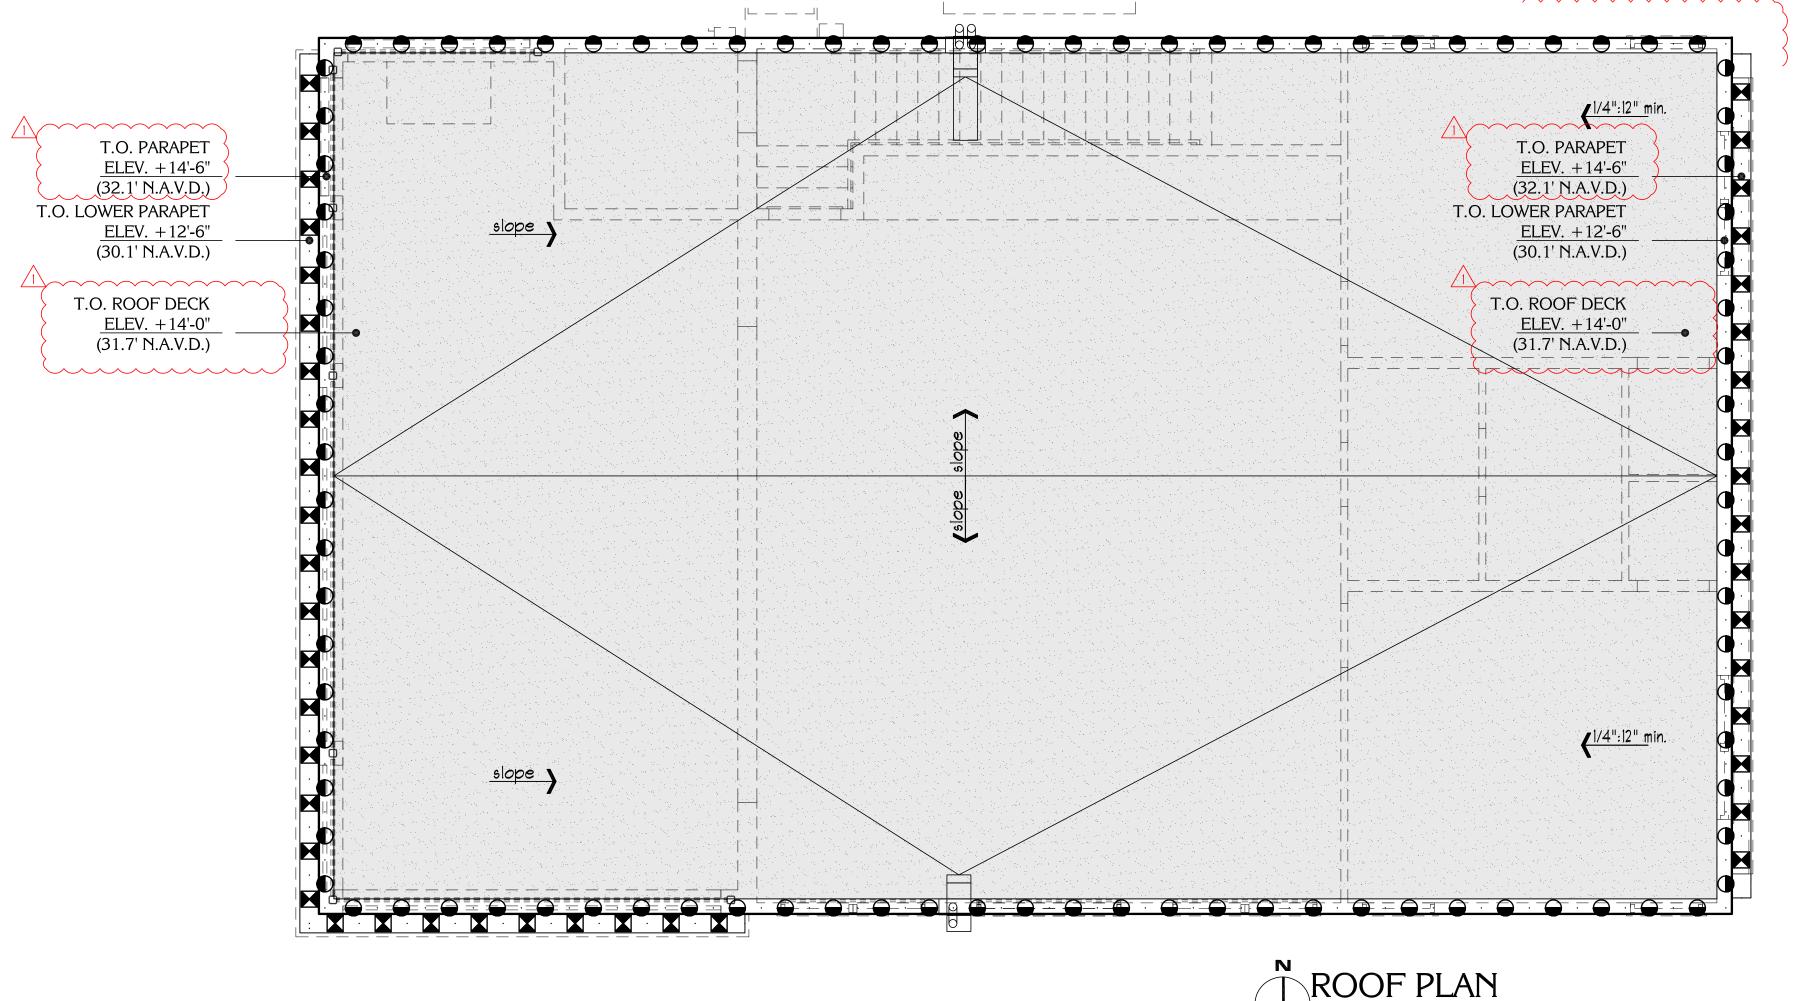
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KEEWAYDIN ISLAND ES, FLORIDA 34102 ~ ARF

ARCHITECTURAL GROUP

PROJ. #.: 2104-03 DATE: 3.1.22

**PERMIT** 



BEAM SCHEDULE

T.O. PARAPET @ (ELEV. +14'-6")

T.O. PARAPET @ ELEV. +12'-6"

LEGEND

CRICKETS, BY G.C.

FLAT ROOF, SLOPE 1/4" = 1'-0" MIN.

TYP. ROOF DRAIN

TYP. OVERFLOW ROOF DRAIN

TYP. ROOF SCUPPER W/ DOWNSPOUTS

TYP. ROOF SCUPPER W/ DOWNSPOUTS

# **ROOF NOTES**

- 1. SEE FLOOR PLAN FOR CEILINGS INFORMATION.
- 2. G.C. SHALL CONFIRM ALL STRUCTURAL COLUMNS
  AND BEAM SIZE, LOCATION AND REINFORCEMENT
  WITH STRUCTURAL ENGINEERS DRAWINGS PRIOR
  TO CONSTRUCTION.
- 3. G.C. TO VERIFY POSITIVE SLOPE AT FINISHED FLOOR TO ENSURE PROPER DRAINAGE AT LANAIS, COVERED ENTRY, OUTDOOR LIVING, BALCONIES, AND GARAGE.
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- REFER TO STRUCTURAL DRAWINGS FOR EXACT LOCATION OF STRUCTURAL COLUMNS.

# ROOF SPECIFICATION

FLAT ROOF DECKS

SCALE: 1/4"=1'-0"

ALL FLAT ROOF DECKS ARE TO HAVE ROOFING MEMBRANE (45 MIL MINIMUM) OVER ISOBOARD TAPERED INSULATION. THE TAPERED INSULATION SHALL PROVIDE POSITIVE DRAINAGE TO ROOF DRAINS WITH A MINIMUM 1/4"/1'-0" SLOPE. ROOFING MEMBRANE INSTALLED PER MANUFACTURER'S SPECIFICATIONS WITH A 20 YEAR WARRANTY

N° 0095563

STATE OF

FLORIDA

FLORIDA

ARCHITECT

ARC

COMIMENTS & OWNER REV. 5.6.22

SOMIMENTS & OWNER REV. 5.6.22

INS. AND PLANS INDICATED OR REPRESENTED BY THIS DRAWING ARE OWNED BY, AND THE PROPERTY FED, EVOLVED, AND DEVELOPED FOR USE ON AND IN CONNECTION WITH THE SPECIFIED PROJECT. NON SEMENTS OF PLANS SHALL BE USED BY, OR DISCLOSED TO ANY PERSON, FRAM, OR CORPORATION FOR

ALL IDEAS, DESIGNS, ARRANGEMENTS, AND PLANS INDICATED OR REPRESENTED BY THIS DRAWING ARE OF THIS OFFICE, AND WERE CREATED, EVOLVED, AND DEVELOPED FOR USE ON AND IN CONNECTION WITH OF SUCH DIEAS, DESIGNER, ARRANGEMENTS OR PLANS SMALLE BE USED. YOR DISCLOSED TO ANY PERSON OF SUCH DIEAS, DESIGNER, WITHOUT THE WAITTEN PERMISSION OF BECK ARCHITECTURAL GROUP ILL DRAWINGS SHALL HAVE PRECEDENCE OVER SCALED DIMENSIONS, CONTRACTORS SHALL VERIFY AND BE DIMENSIONS AND CONDITIONS SHOWING Y THESE DRAWINGS, SHOP DETAILS OF ADEQUATE SCALE MUST

ARROLL RESIDENCE
11303 KEEWAYDIN ISLAND
NAPLES, FLORIDA 34102



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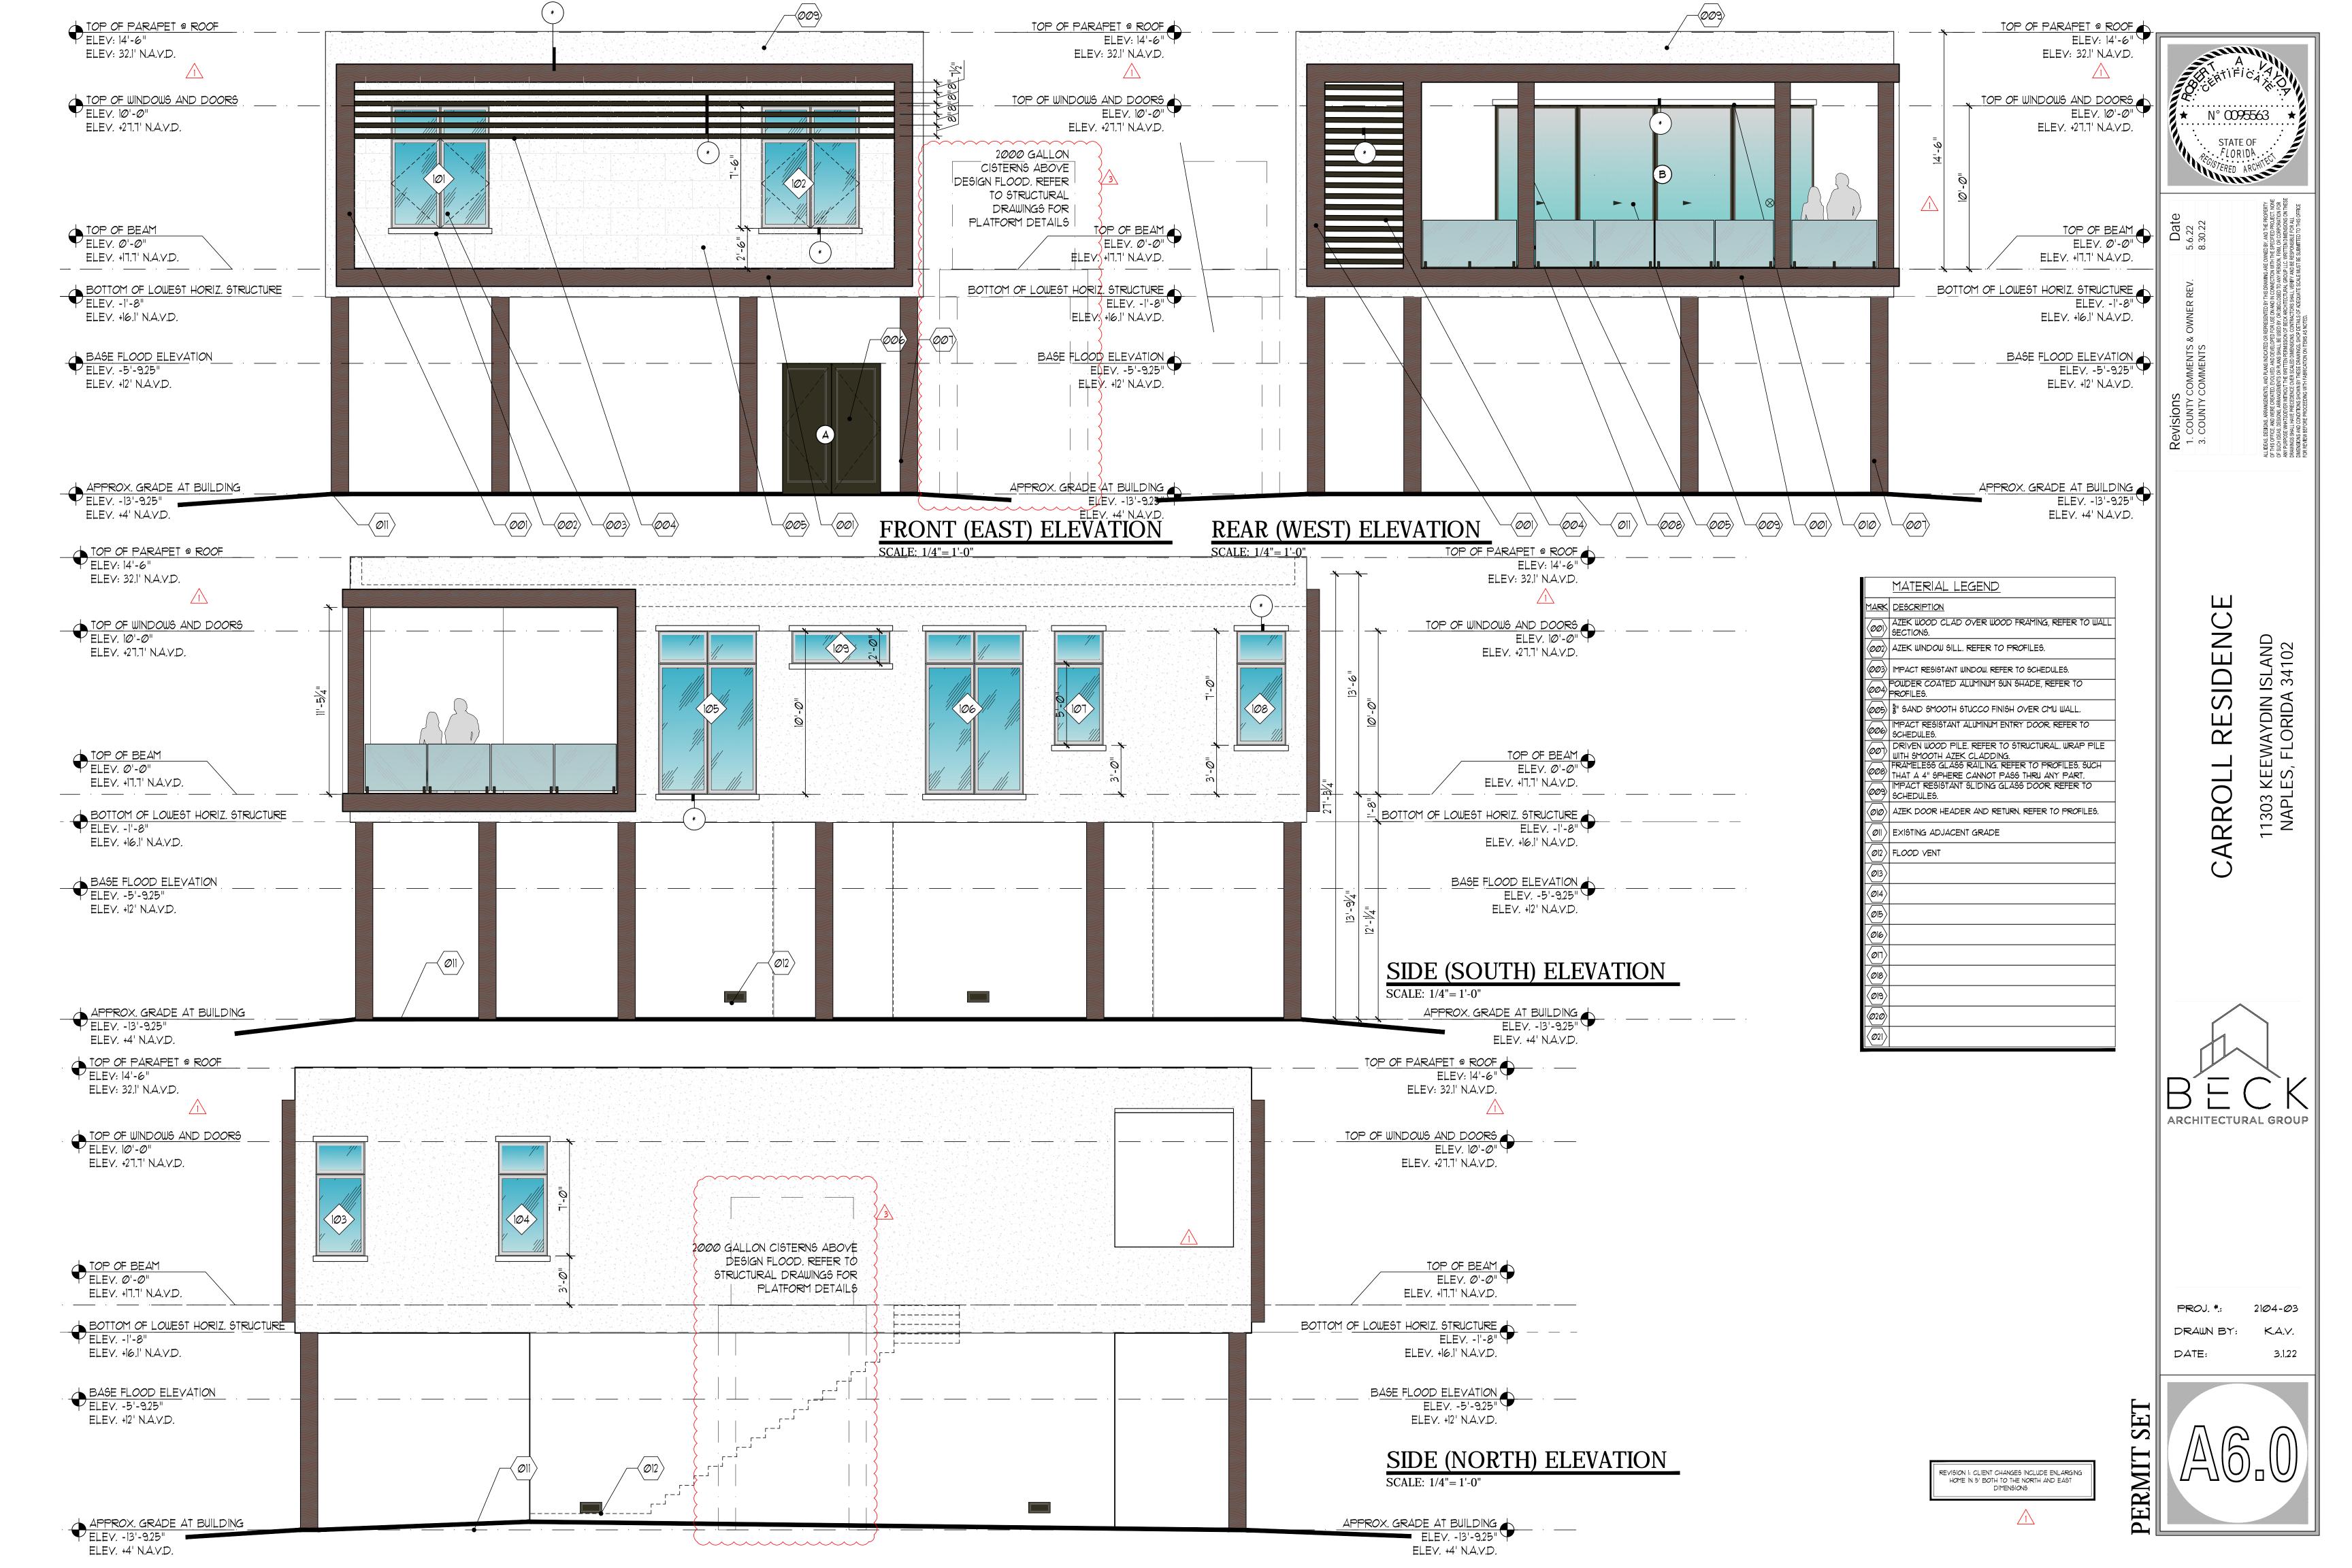
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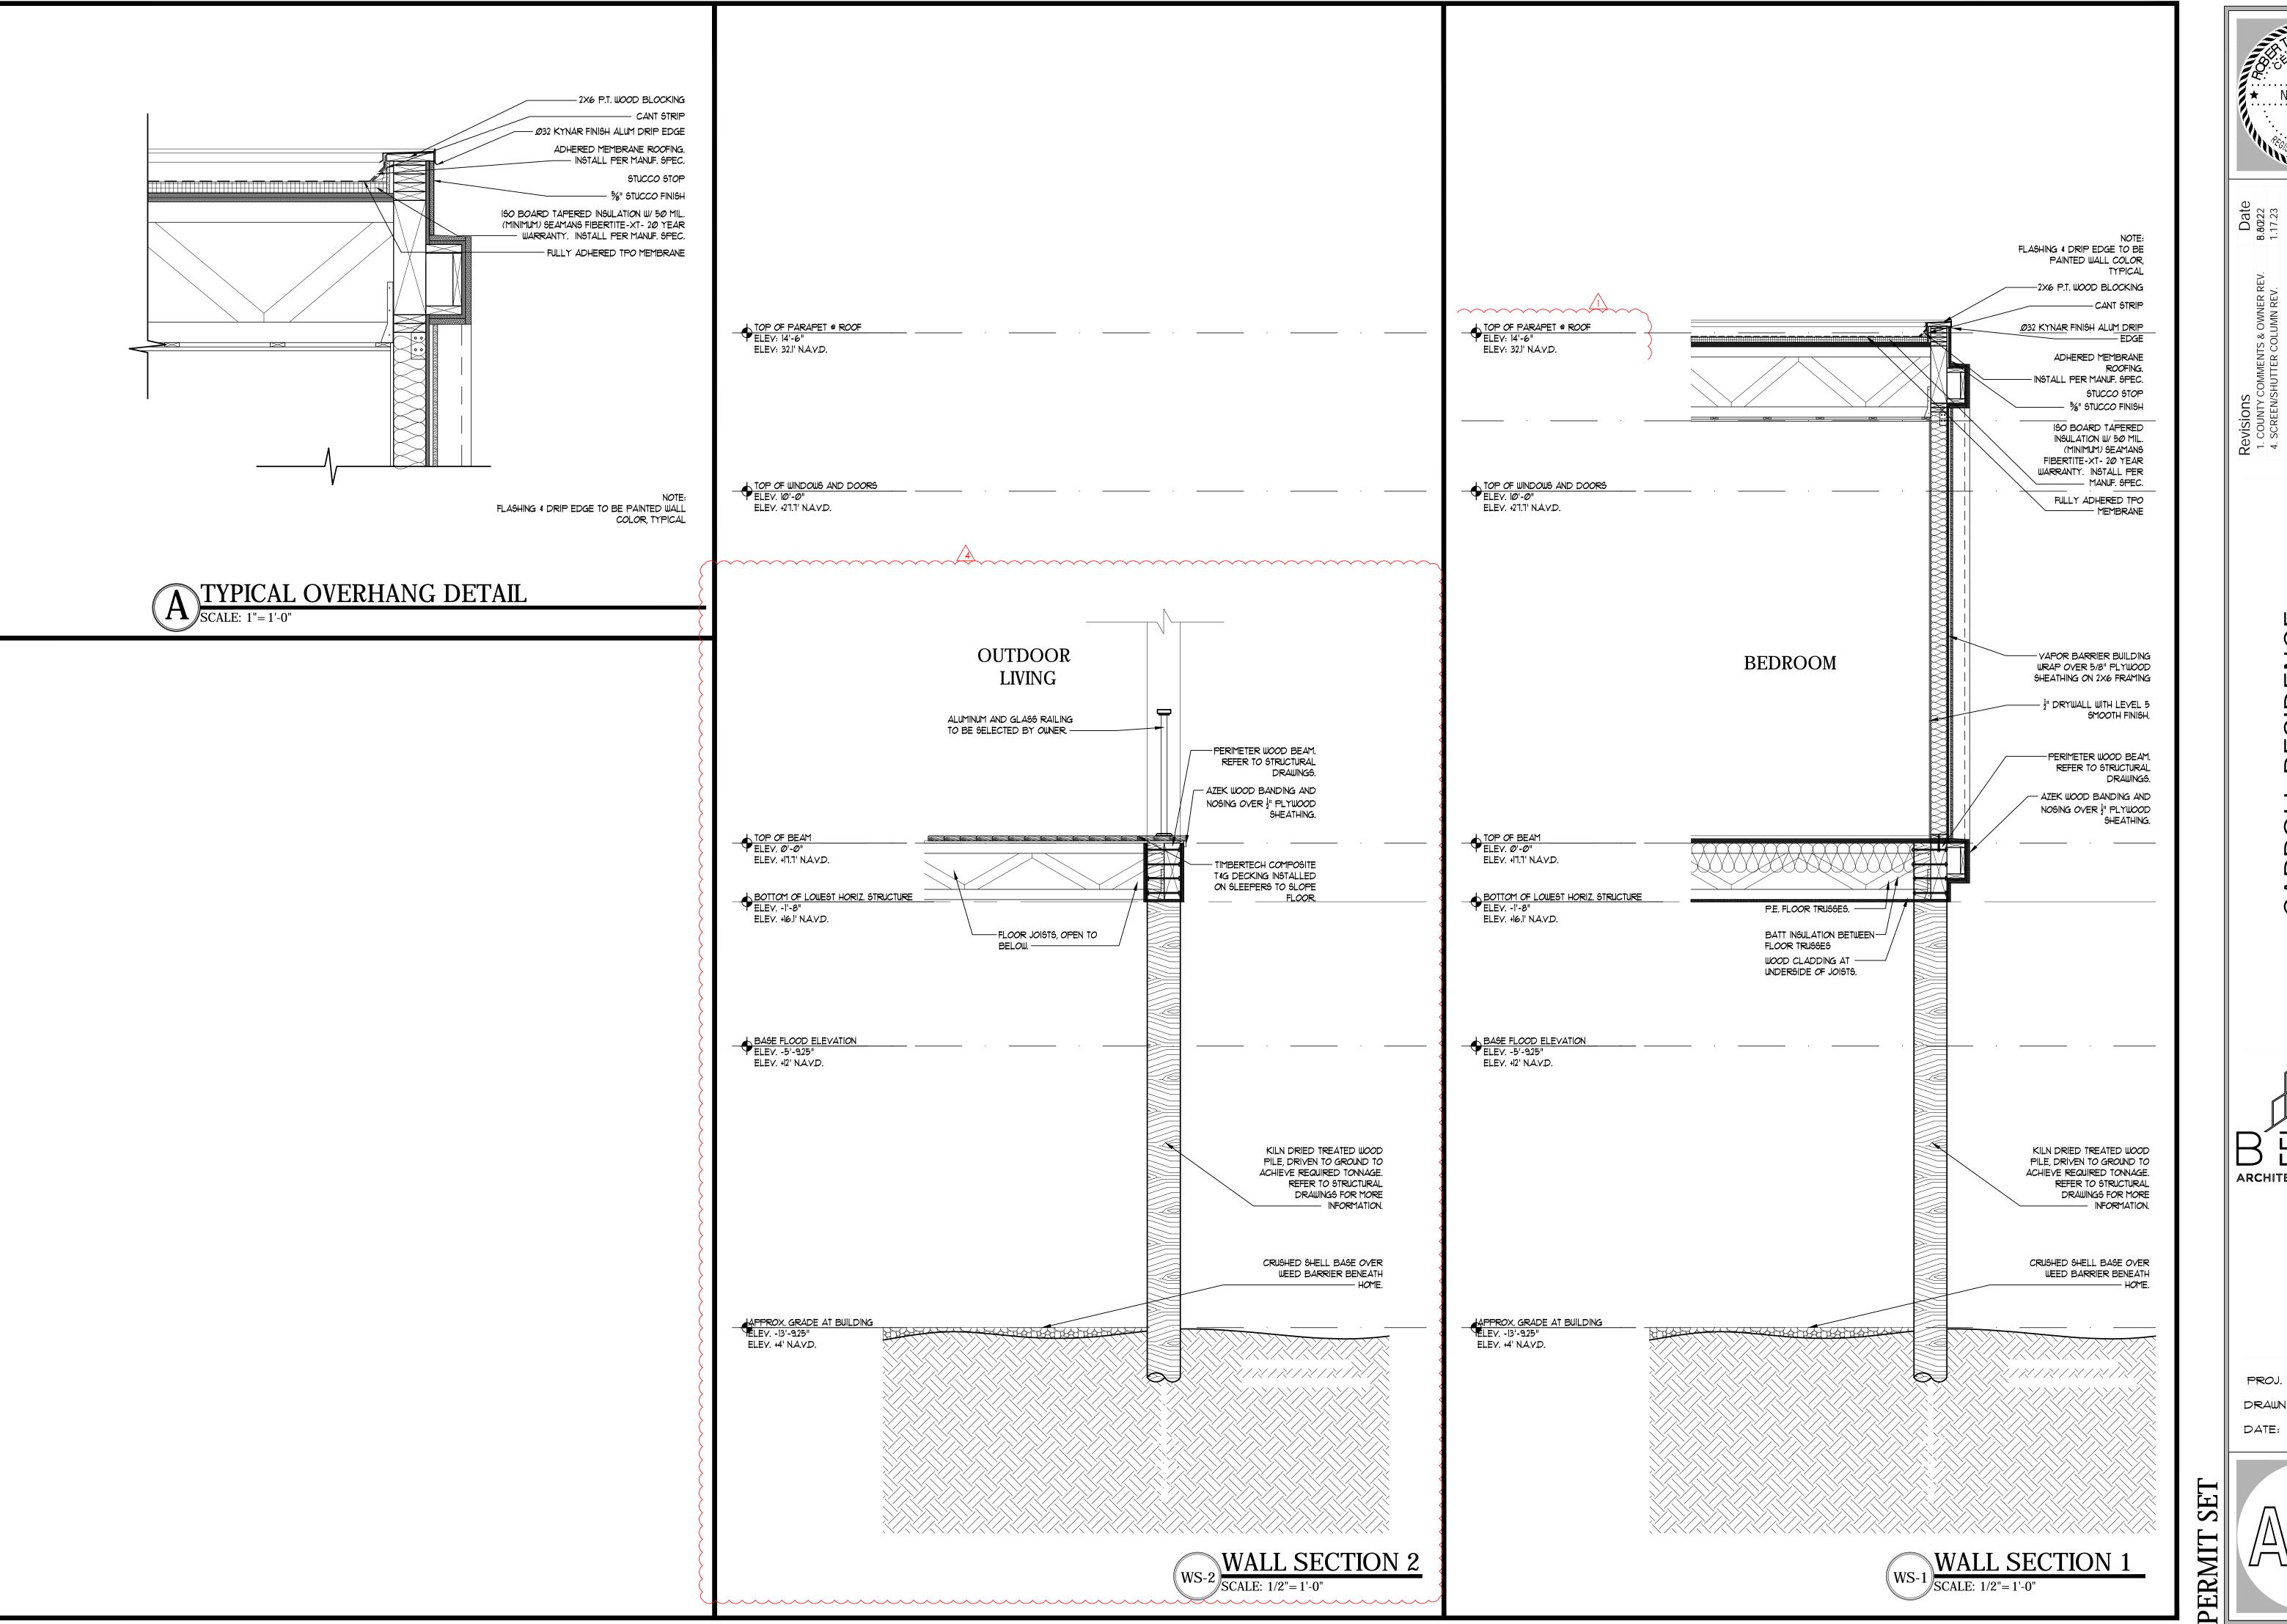
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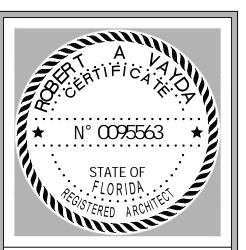
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EEN/SHUTTER COLUMN REV.

1.17.23

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ARROLL RESIDENCE
11303 KEEWAYDIN ISLAND
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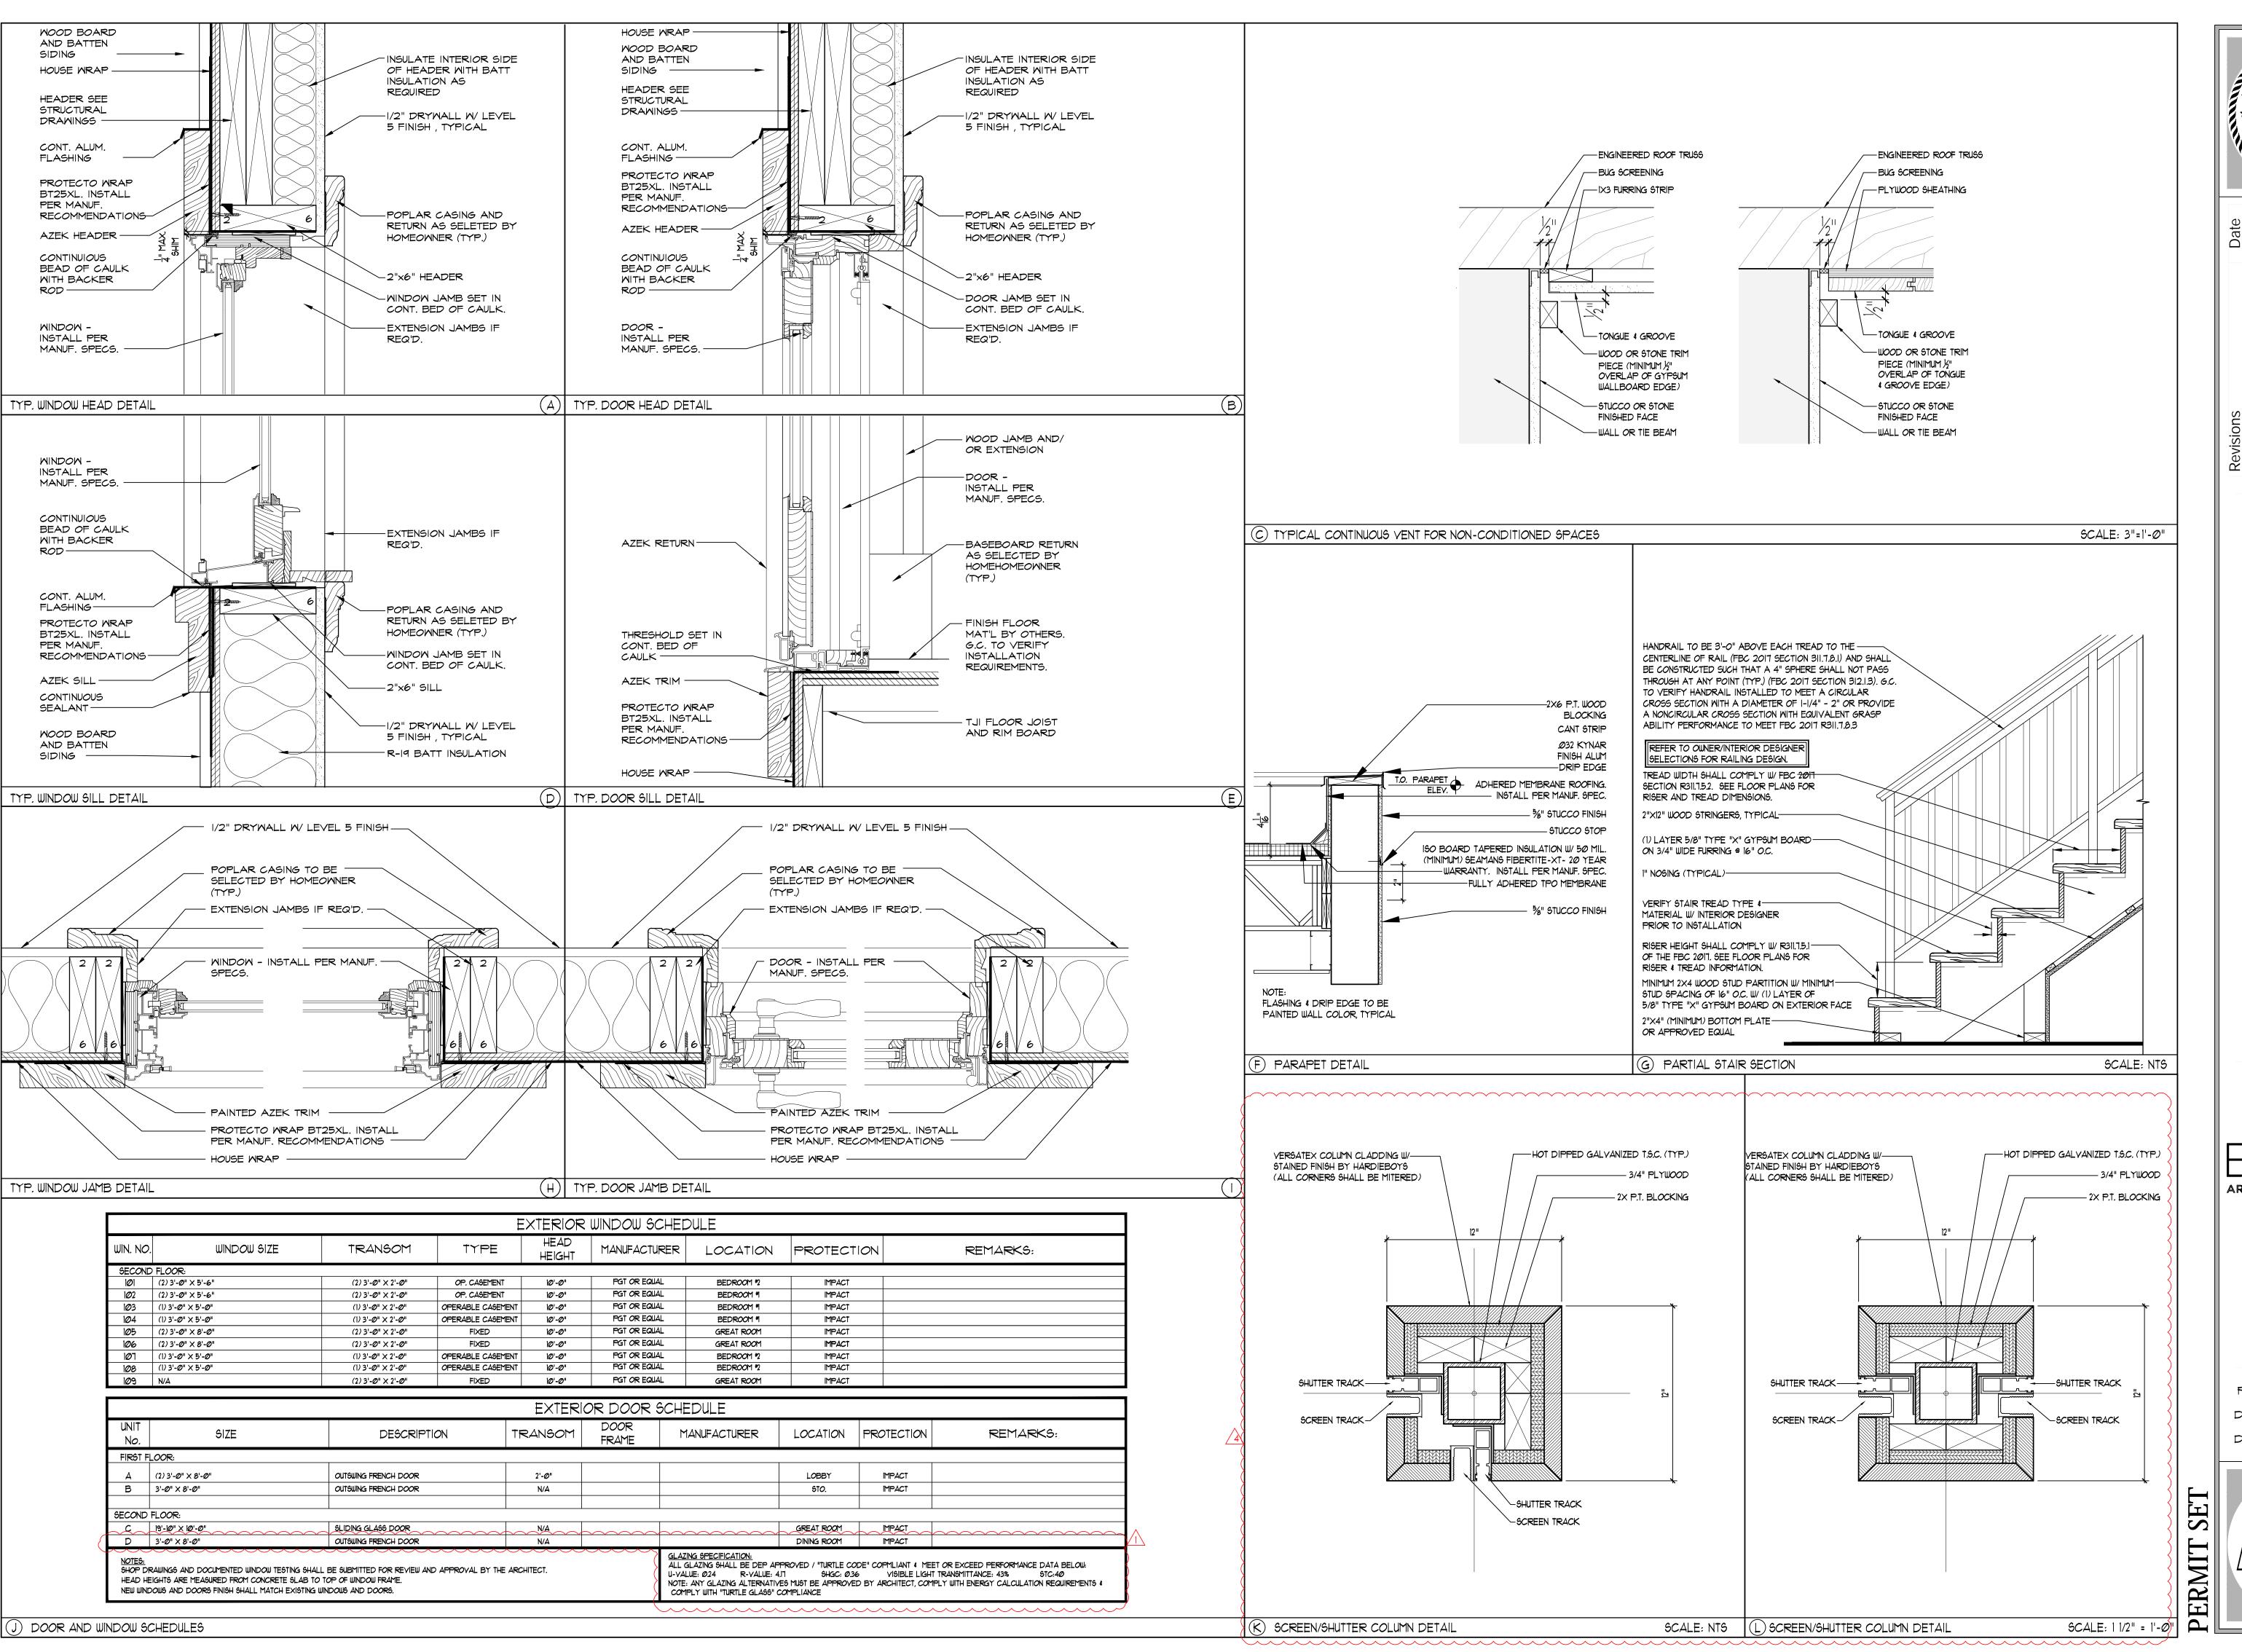
BECK ARCHITECTURAL GROUP

PROJ. #.: 2104-03 DRAWN BY: K.A.Y.

DRAWN BY: K.A.V.

DATE: 3.1.22

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FLORIDA

FLORIDA

ARCHITECT

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Aevisions

1. COUNTY COMMENTS & OWNER REV.

5.6.22

4. SCREEN/SHUTTER COLUMN REV.

1.17.23

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1.17.23

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S, FLORIDA 34102

BECK ARCHITECTURAL GROUP

PROJ. #: 2104-03

DRAWN BY: K.A.V.

DATE: 3.1.22

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### ELECTRICAL SPECS.

DRAWINGS ARE DIAGRAMMATIC AND SHALL NOT BE SCALED. REFER TO ARCHITECTURAL PLANS AND ELEVATIONS FOR EXACT LOCATION OF ALL EQUIPMENT. ELECTRICAL CONTRACTOR SHALL FURNISH AND INSTALL ALL ITEMS REQUIRED FOR COMPLETE AND ACCEPTABLE WORKING INSTALLATION. ALL WORK SHALL COMPLY WITH THE LATEST EDITION OF THE NATIONAL ELECTRICAL CODE AND SHALL COMPLY WITH ALL LOCAL RULES AND

### 3. MINIMUM WIRE SIZE SHALL BE #12 AWG. UNLESS OTHERWISE NOTED. ALL CONDUCTORS SHALL BE COPPER WITH THUN OR THHN INSULATION.

- 5. THE ELECTRICAL SYSTEM SHALL BE COMPLETELY AND EFFECTIVELY GROUNDED AS REQUIRED IN ARTICLE 250 OF THE NATIONAL ELECTRICAL CODE.
- 6. THE ELECTRICAL, TELEPHONE, AND CABLE TELEVISION INSTALLATIONS SHALL MEET ALL REQUIREMENTS BY THE LOCAL UTILITY COMPANIES. 1. ALL DISCONNECT SWITCHES SHALL BE RATED FOR 10/0/0/0 A.I.C. UNLESS OTHERWISE NOTED. ALL FUSES SHALL BE RATED FOR 10/0/0/0/0 A.I.C. AND SHALL 16. RECEPTACLES AND / OR JUNCTION BOXES SHALL NOT BE PLACED IN A BACK TO BACK CONFIGURATION.

### 8. OUTLET BOXES SHALL BE PRESSED STEEL IN DRY LOCATIONS, PLASTIC BOXES MAY BE USED IN LIEU OF THE STEEL BOX AS PERMITTED BY LOCAL CODES. IN DAMP OR WET LOCATIONS BOXES SHALL BE MADE FROM CAST ALLOY WITH THREADED HUBS. SPECIAL ENCLOSURES ARE REQUIRED FOR OTHER 18. ALL WORK SHALL BE PERFORMED BY A LICENSED ELECTRICAL CONTRACTOR IN A FIRST CLASS WORKMANLIKE MANNER.

9. SEPARATE WIRE AND CONDUIT SYSTEM MAY BE SUBSTITUTED WITH FACTORY FABRICATED ASSEMBLY ON INSULATED CONDUCTORS IN A FLEXIBLE

10. MOTOR STARTERS SHALL BE MANUAL OR MAGNETIC WITH OVERLOAD RELAYS IN EACH HOT LEG. IT SHALL BE THE RESPONSIBILITY OF THE ELECTRICAL REPLACEMENT OR REPAIR OF ANY OTHER PHASE OF THE INSTALLATION WHICH MAY HAVE BEEN DAMAGED THEREBY.

ELECTRICAL CONTRACTOR. 12. ALL EXTERIOR RECEPTACLES SHALL BE WEATHERPROOF AND G.F.I.

# 13. ALL EXTERIOR DISCONNECT SWITCHES SHALL BE WEATHERPROOF.

14. ALL 120V, 15 AND 20 AMP BRANCH CIRCUITS SUPPLYING OUTLETS INSTALLED IN DWELLING UNIT FAMILY ROOMS, DINING ROOMS, LIVING ROOMS, GREAT ROOMS, PARLORS, LIBRARIES, DENS, BEDROOMS, SUNROOMS, RECREATION ROOMS, CLOSETS, HALLWAYS OR SIMILAR ROOMS SHALL BE PROTECTED BY AFCI CIRCUIT BREAKERS AS REQUIRED BY NEC 210.12

II. ELECTRICAL CONTRACTOR 15 TO FURNISH AND INSTALL DISCONNECT SWITCHES, OVER CURRENT PROTECTION, AND WIRING FOR THE AIR CONDITIONING

SYSTEM AS PER MANUFACTURER RECOMMENDATIONS. CONTROLS ARE TO BE SUPPLIED BY THE AIR CONDITIONING CONTRACTOR AND CONNECTED BY THE


15. REFER TO DEVICE INSTALLATION DIAGRAM FOR SUGGESTED PLACEMENT OF DEVICES.


# 17. ALL RECESSED CANS MUST BE IC RATED FIXTURES WITH NO BULB LARGER THAN 15 WATTS.

19. ALL WORK SHALL BE COORDINATED WITH OTHER TRADES TO AVOID INTERFERENCE WITH THE PROGRESS OF CONSTRUCTION.

20. THE ELECTRICAL CONTRACTOR SHALL GUARANTEE ALL MATERIALS AND WORKMANSHIP FREE FROM DEFECTS FOR A PERIOD OF NOT LESS THAN (1) YEAR FROM THE DATE OF ACCEPTANCE. CORRECTION OF ANY DEFECTS SHALL BE COMPLETED WITHOUT ADDITIONAL CHARGE, AND SHALL INCLUDE

21. G.C. TO COORDINATE LOCATIONS OF ALL LIGHTS, SWITCHES & OUTLET LOCATIONS WITH HOMEOWNER.

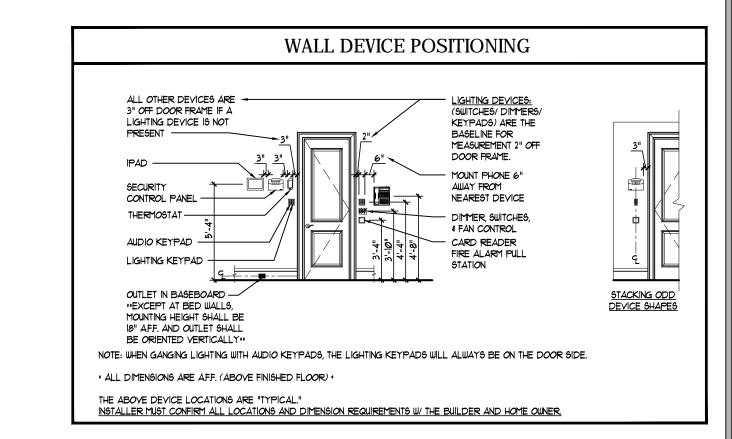

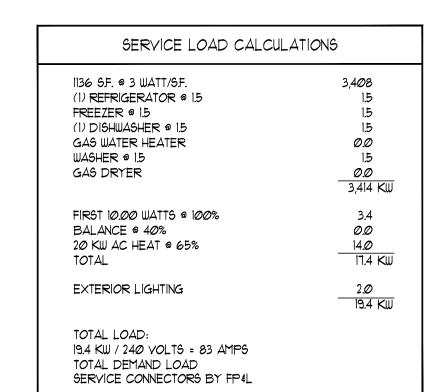



SIDEN


 $\Delta$ 

ARF

N° 0095563

FLORIDA.

CHED ARCHILL

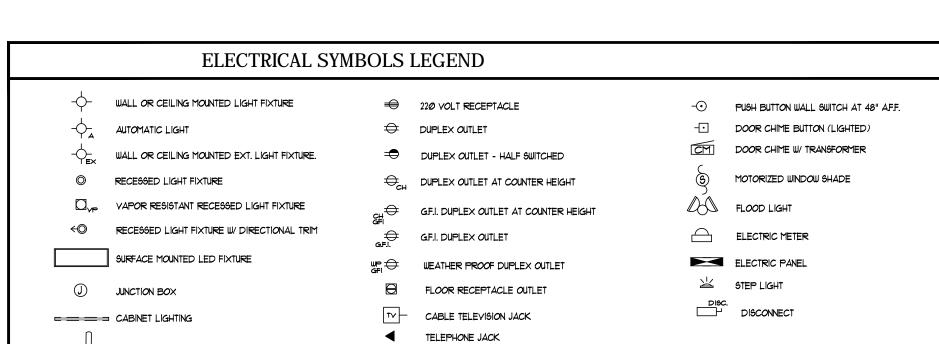

3-WAY WALL SWITCH AT 48" AFF.

DIMMER WALL SWITCH AT 48" AFF.

→ 3-WAY WALL SWITCH W/ DIMMER AT 48" AFF.

CEILING FAN WITH LIGHT

EXHAUST FAN VENTED TO EXTERIOR

SMOKE & CARBON MONOXIDE DETECTOR

PERMIT SET

PROJ. #.:

DATE:

2104-03

3.1.22