RENDERINGS ARE CONCEPTUAL AND NOT TO BE USED FOR CONSTRUCTION. THEY MAY SHOW COLORS, MATERIALS, FEATURES, AND DETAILS NOT SHOWN IN THE SPECIFICATIONS AND CONSTRUCTION PLANS.



STAPLE OR PRINT BUILDER'S 8.5 X 11 INCH SPECIFICATIONS HERE

REVISIONS

NO DATE BY DESCRIPTION



	PLAN INDEX
SHEET	TITLE
CVR1	COVER
P-1	PLOT (SITE) PLAN
F-1	DIMENSIONED FOUNDATION PLAN WITH UNDERGROUNI
	ELEC,WATER AND WASTE LOCATIONS
A-1	ARCHITECTURAL FLOOR PLAN
A-2	FRONT AND REAR ELEVATIONS
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FR-1	DIMENSIONED FRAMING PLANS
FR-2	FRAMING CROSS SECTIONS AND ELEVATIONS
A-4	ROOF PLAN
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A-6	NKBA CABINET FLOOR PLAN
A-7	NKBA ELEVATIONS

BDS IS A PROFESSIONAL



#1437200

Best of Houzz Service M houzz

nouzz

DO NOT USE PLANS UNTIL SIGNED

Best of

houzz

SERVICE

CERTIFICATE OF USE FOR SINGLE BUILD AT 504 WINDSOR LANE, NEW BRAUNFELS, TX



POWERED BY CHIEF ARCHITECT PREMIER

Chief Architect

PROFESSIONAL

MEMBER


AMERICAN INSTITUTE of

BUILDING DESIGN

B

B. MURRAY, MANAGER, INSERTION PROFESSIONALS LC DBA "ROBERT CRISWELL LUXURY HOMES AND BUILDER **DESIGN STUDIO"**

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Best of Houzz Service

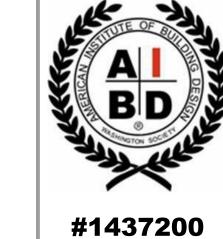BUILDER DESIGN STUDIO

BEST OF HOUZZ AWARD

WINNER FOR SERVICE FIVE YEARS IN A ROW

DRAWN BY: BILL M

DATE: 7/8/2022

SCALE: NONE

SHEET #: CVR1

ABBREVIATIONS

USING THIS CONVENTION)

DOOR SIZE--3' 0" WIDE 6'8" HIGH (DIFFERENT DOOR SIZES ARE DISPLAYED

#	NUMBER	
1R/1S	1 ROD 1 SHELF (ANY NUMBERS MAY BE USED)	
3060SH	WINDOW SIZE AND TYPE3'0" WIDE 6'0" HIGH WITH A SINGLE OPENING SASH (DIFFERENT WINDOW TYPES AND SIZES USE SAME CONVENTION; SEE AW, DC, SC, LS, RS	
AFCI	ARC FAULT CIRCUIT INTERRUPTER	
AFF	ABOVE FINISHED FLOOR	
APT	APARTMENT	
AW	AWNING SASH WINDOW	
BL	BUILDING LINE	
ВМ	BEAM	
ВОВ	BOTTOM OF BEAM	
CJ	CEILING JOIST	
CMU	CONCRETE MASONRY UNIT	
CO	CASED OPENING	
CONC	CONCRETE	
CS	CROSS SECTION	
СТ	CERAMIC TILE	
DC	DOUBLE CASEMENT SASH WINDOW	
DH	DOUBLE-HUNG SASH WINDOW	
DIM	DIMENSION	
DN	DOWN	
DW	DISHWASHER	
EA	EACH ELECTRON	
ELEV	ELEVATION	
=F = .	FINISHED FLOOR	
FJ 	FLOOR JOIST	
=L	FLOOR	
FX	FIXED (USUALLY A WINDOW WITH FIXED GLASS)	
GFCI	GROUND FAULT CIRCUIT INTERRUPTER	
GFI	GROUND FAULT CIRCUIT INTERRUPTER	
GYP	GYPSUM (SHEETROCK, WALLBOARD)	
HB	HOSE BIBB	
HC	HOLLOW CORE DOOR	
HDR	HEADER	
HVAC	HEATING VENTING AIR CONDITIONING	
HW LIN	WATER HEATER LINEN	
LIN	LEFT SLIDER WINDOW	
LVL	LAMINATED VENEER LUMBER	
MANF	MANUFACTURER	
MW	MICROWAVE	
NO	NUMBER	
NOM	NOMINAL	
NTS	NOT TO SCALE	
OC	ON CENTER	
PC	PRE-CUT (REFERS TO STUD LENGTH)	
PDR	POWDER	
PE	PROFESSIONAL ENGINEER	
PSF	POUNDS PER SQUARE FOOT	
PSI	PUNDS PER SQUARE INCH	
-31 PT	PRESSURE TREATED	
₹	RADIUS	
RA	RETURN AIR FOR HVAC	
 70	ROUGH OPENING	
RS	RIGHT SLIDER WINDOW	
SC	SINGLE CASEMENT SASH WINDOW	
SC	SOLID CORE DOOR	
SF	SQUARE FEET OR FOOTAGE	
SH	SINGLE-HUNG SASH WINDOW	
SPF	SPRUCE PINE FIR LUMBER	
SR	SHEETROCK (WALL BOARD)	
SWR	SHOWER	
SYP	SOUTHERN YELLOW PINE LUMBER	
TOB	TOP OF BEAM	
TOF	TOP OF FOUNDATION (USUALLY THE ZERO LEVEL)	
TYP	TYPICAL	
W/	WITH	
WB	WALLBOARD (GYPSUM)	
WH	WATER HEATER	
WIC	WALK-IN CLOSET	
WN	WALL NICHE	
	- · · · · · · · · · · ·	



FINAL 9:25:27 AM 7/8/2022 FINAL RELEASE SET

INFORMATION ABOUT THESE PLANS

BUILD TO THESE CODES AND AND MINIMUM LOADS OR BETTER AS REQUIRED

2018 IRC 2018 IBC 2018 IECC LOCAL

PREVAILING ELECTRICAL AND MECHANICAL

ROOF LOADS PSF - 20 LIVE 10 DEAD* FLOOR JOIST FOR WOOD FRAMED FLOORS - 40 LIVE 20 DEAD CEILING JOISTS - 20 LIVE 10 DEAD; 20 DEAD FOR STORAGE WIND CODE - 115 MPH EXPOSURE C *INCREASE FOR TILE ROOFING

IMPORTANT NOTES TO USERS:

- 1. **DESIGN RESPONSIBILITIES** THE BUILDER DESIGN STUDIO(BDS)DESIGN RESPONSIBILITY IS TO PROVIDE SCALED PLANS SUFFICIENT TO DISPLAY ARCHITECTURAL DESIGN ELEMENTS, SPACE ALLOTMENT, DIMENSIONS, CROSS-SECTIONS, ELEVATIONS, AND LOCATIONS OF DEVICES AND APPLIANCES. BDS OR ITS PARENT COMPANY IN NO WAY REPRESENTS ITSELF OR ITS EMPLOYEES AS QUALIFIED TO PROVIDE METHODS OR PROCESSES OF CONSTRUCTION, MECHANICAL, OR PLUMBING ON OUR PLANS EXCEPT THAT WE MAY DISPLAY ACCEPTED INDUSTRY STANDARDS OR CLIENT REQUESTED METHOD DETAILS ON OUR PLANS. MECHANICAL CONTRACTORS WILL PROVIDE HVAC PLANS AND MANUAL J CALCULATIONS, WHICH MAY BE ATTACHED TO THESE PLANS. ANY STRUCTURAL DESIGN
- REQUIREMENTS ARE ADDRESSED IN NOTE TWO. 2. ENGINEERING REQUIREMENTS.—THE SERVICES OF A REGISTERED PROFESSIONAL ENGINEER (PE) PRACTICING IN THE APPROPRIATE FIELD MAY BE NECESSARY FOR, BUT NOT LIMITED TO, THE FOLLOWING ITEMS: SOIL TESTING, FOUNDATION STRUCTURAL DESIGN, AND ANY OTHER SPECIALIZED STRUCTURAL ELEMENTS WHICH ARE BEYOND THE SCOPE OF IRC PRESCRIPTIVE METHODS AND WHICH ARE REQUIRED TO ACCOMPLISH STRUCTURALLY THE ARCHITECTURAL ELEMENTS SHOWN IN THESE PLANS. OTHER SITUATIONS WHICH MAY NEED THE SERVICES OF A STRUCTURAL PE INCLUDE BUT ARE NOT LIMITED TO WIND BRACING DRAWINGS, DETAILED FRAMING CUT SHEETS, SPECIAL REQUIREMENTS OF WIND AND SEISMIC CODES, AND THE REQUIREMENTS OF WARRANTY AND INSURANCE COMPANIES. THESE PLANS ARE NOT DRAWN TO ANY SEISMIC OR WINDSTORM CODE AND MAY NEED MODIFICATIONS TO THE
- ARCHITECTURE AND FENESTRATION IF THE BUILDING OR RESIDENCE IS TO BE BUILT IN A SEISMIC OR HURRICANE ZONE; NOR ARE THEY DRAWN TO ANY SPECIFIC WARRANTY OR INSURANCE COMPANY'S REQUIREMENTS. 3. CODE ADHERENCE AND PRECEDENCE—THE BUILDER AS WELL AS TRADE CONTRACTORS, VENDORS, AND SERVICES SHALL ADHERE TO AND BE RESPONSIBLE FOR KNOWLEDGE OF THE CURRENT PRESCRIPTIVE INTERNATIONAL RESIDENTIAL OR BUILDING CODE (IRC,
- IBC) (OR AS IT IS AMPLIFIED OR REPLACED BY LOCAL CODE JURISDICTIONS). THE BUILDER, AS WELL AS TRADE CONTRACTORS, VENDORS, AND SERVICES, SHALL ADHERE TO OTHER INDUSTRY APPLICABLE CODES SUCH AS ELECTRICAL, PLUMBING, AND MECHANICAL AS REQUIRED BY LOCAL CODE JURISDICTIONS. THESE CODES SHALL TAKE PRECEDENCE OVER ANY INSTRUCTION SPECIFICATION OR DESIGN IN THIS PLAN. 4. SPECIFICATIONS—BASIC DIMENSIONAL LUMBER FRAMING SPECIFICATIONS PROVIDED TO BDS BY THE BUILDER MAY APPEAR IN THIS
- DOCUMENT AS ANNOTATIONS. HOWEVER, THE BUILDER SHALL ATTACH THE COMPLETE SPECIFICATIONS DOCUMENT TO THIS PLAN. ALSO SHOWN IN THIS PLAN IS THE IDENTIFICATION OF THE LOCATION OF POSSIBLE SPECIAL BEAMS, POSTS, TRUSSES, OR OTHER STRUCTURAL ITEMS. THE SUPPLIER SHALL REVIEW THE PLACEMENT AND SIZING OF THESE ITEMS.
- 5. USER SKILL REQUIREMENT—ANY USER OF THIS PLAN MUST BE QUALIFIED AND HAVE THE SKILL AND ABILITY TO READ RESIDENTIAL CONSTRUCTION PLANS. 6. KNOWLEDGE OF INSTALLATION INSTRUCTIONS AND PRECEDENCE—CONTRACTORS, TRADESMEN, SERVICES, AND VENDORS ARE

RESPONSIBLE FOR KNOWLEDGE OF AND ABIDANCE TO MANUFACTURER'S INSTALLATION INSTRUCTIONS WHICH SHALL TAKE


PRECEDENCE OVER ANY INSTRUCTION OR DESIGN IN THIS PLAN. 7. REPORT ERRORS AND DISCREPANCIES—THE CLIENT, BUILDER, CONTRACTORS, TRADESMEN, AND VENDORS SHALL REPORT ANY PLAN, CODE, OR SPECIFICATION DISCREPANCIES TO THE DESIGNER FOR RESOLUTION BEFORE COMMITTING TO THE USE OF MATERIALS OR LABOR AT 210-563-5920 OR WRBILLMURRAY@GMAIL.COM.

10. REPORTED AREAS -- THIS BUILDING OR RESIDENCE REPORTED AREAS IN SQUARE FEET ARE APPROXIMATE AND ARE CALCULATED

9. SCALING—DO NOT USE PAPER PLANS, EVEN PRINTED TO SCALE, TO OBTAIN ACCURATE DIMENSIONS; CALL FOR MISSING OR

FROM EXTERIOR SURFACE TO EXTERIOR SURFACE AND MAY DIFFER FROM THE AS-BUILT BUILDING OR RESIDENCE.

8. ADA AND AGING-IN-PLACE—THESE PLANS ARE NOT FOR ADA COMPLIANCE OR AGING-IN-PLACE STANDARDS.

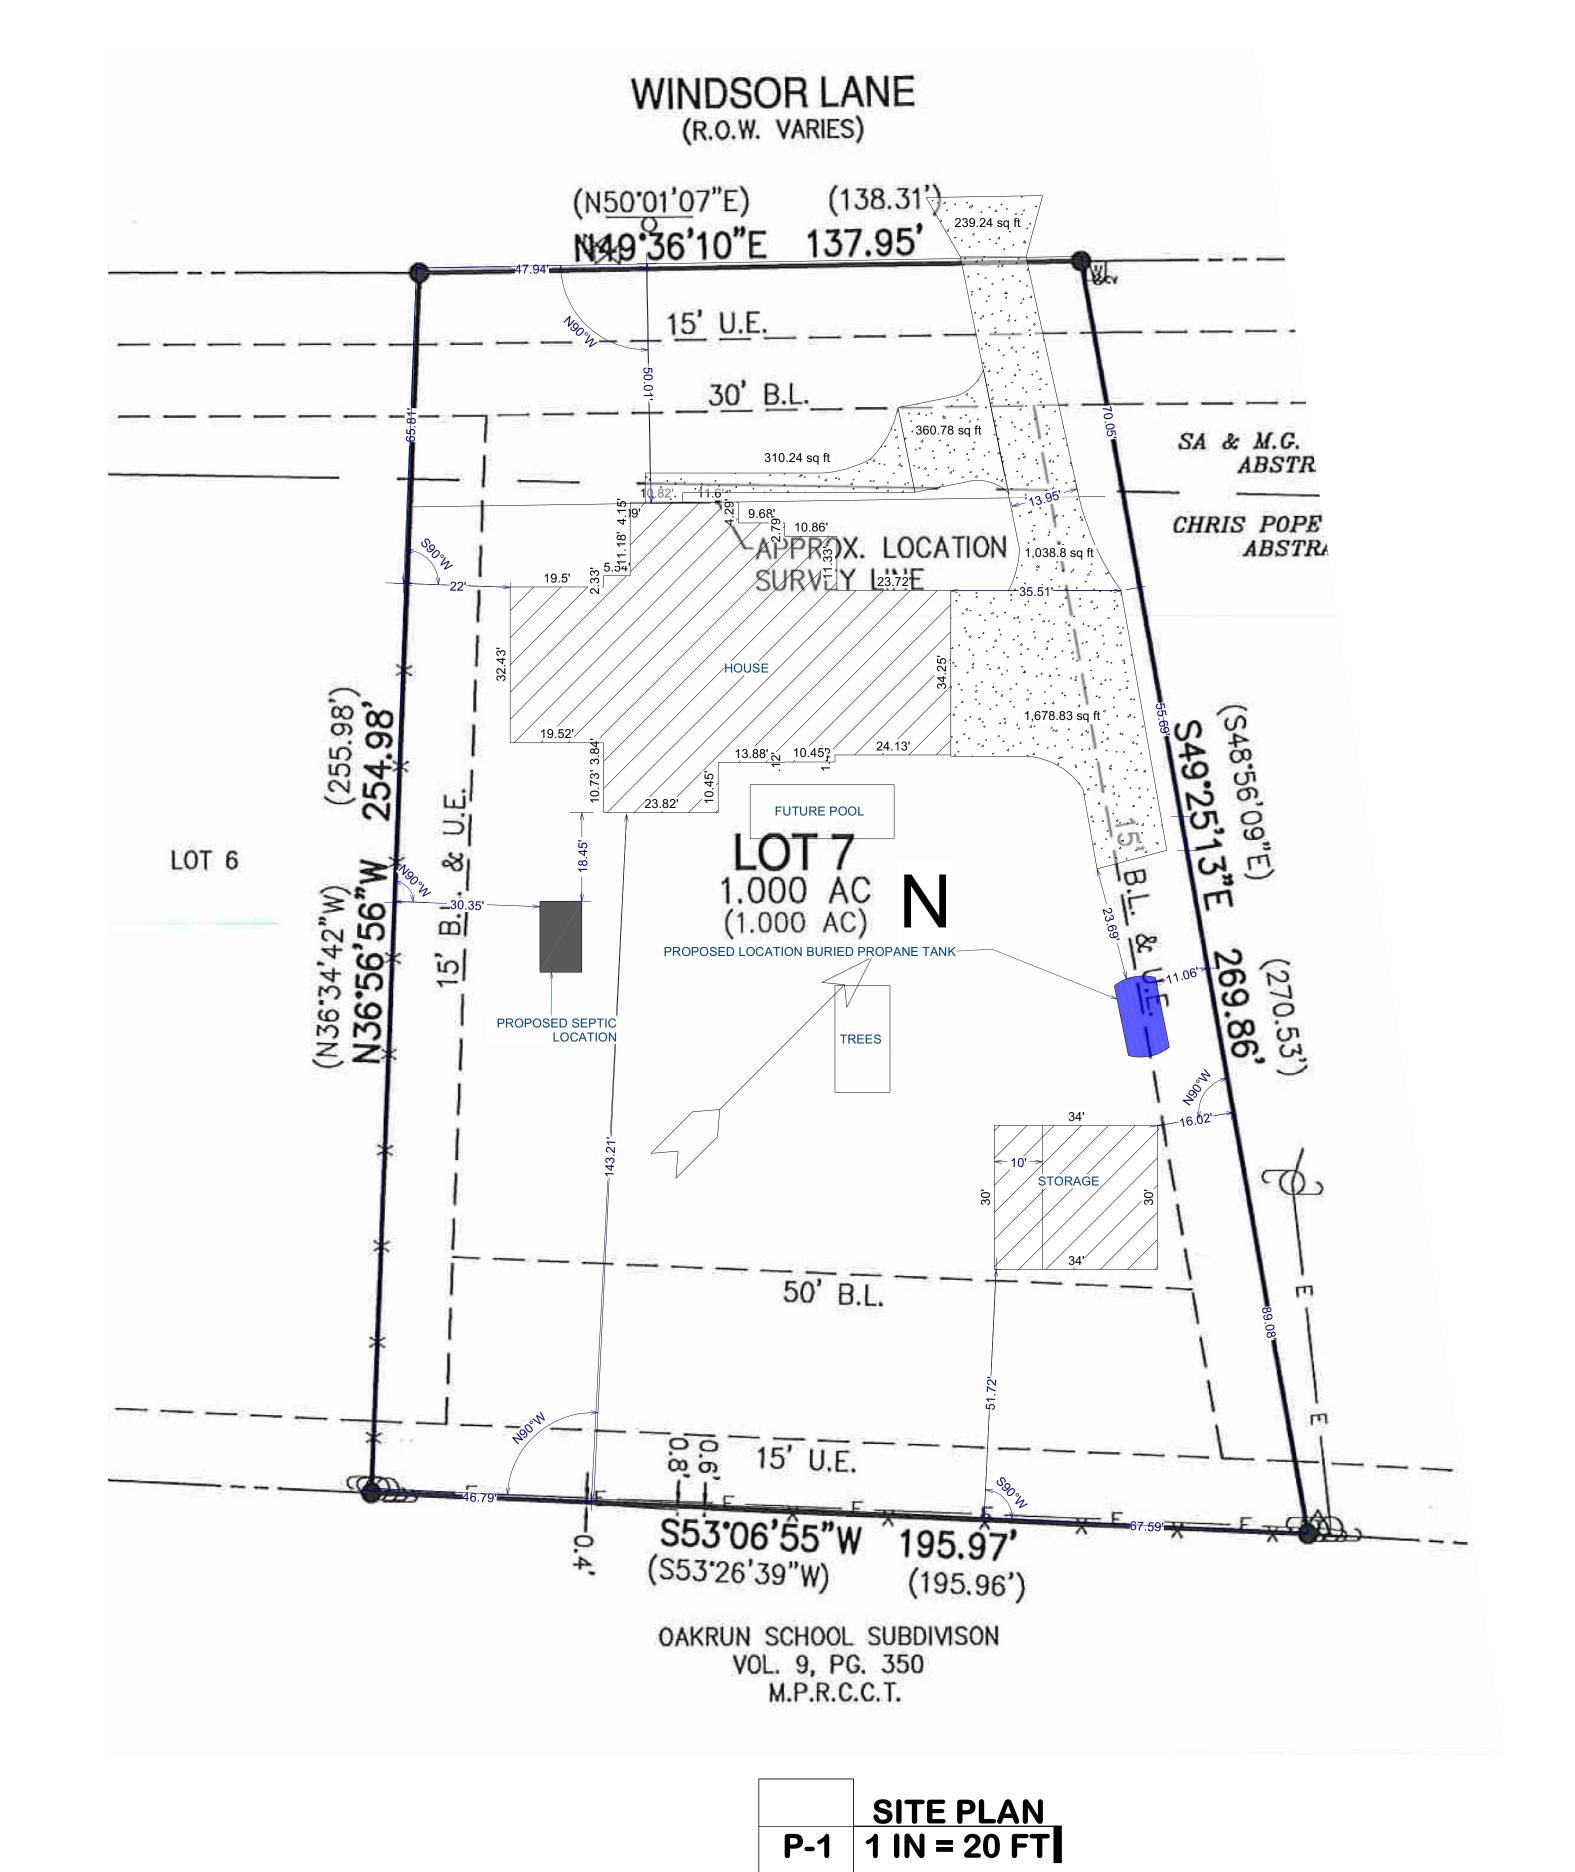

GREG CHAFIN
LIVE OAK HOMES, INC
830-609-0560

BILLMURRAY@GMX.COM
210-563-5920

MARY ANN AND MARC RHODES
CHITECTURAL PLANS FOR PROJECT LOCATED AT:
504 WINDSOR LANENEW
BRAUNFELS, TX 78132
JIENT EMAIL:

PLOT (SITE) PLAN

DRAWN BY:

BILL M.


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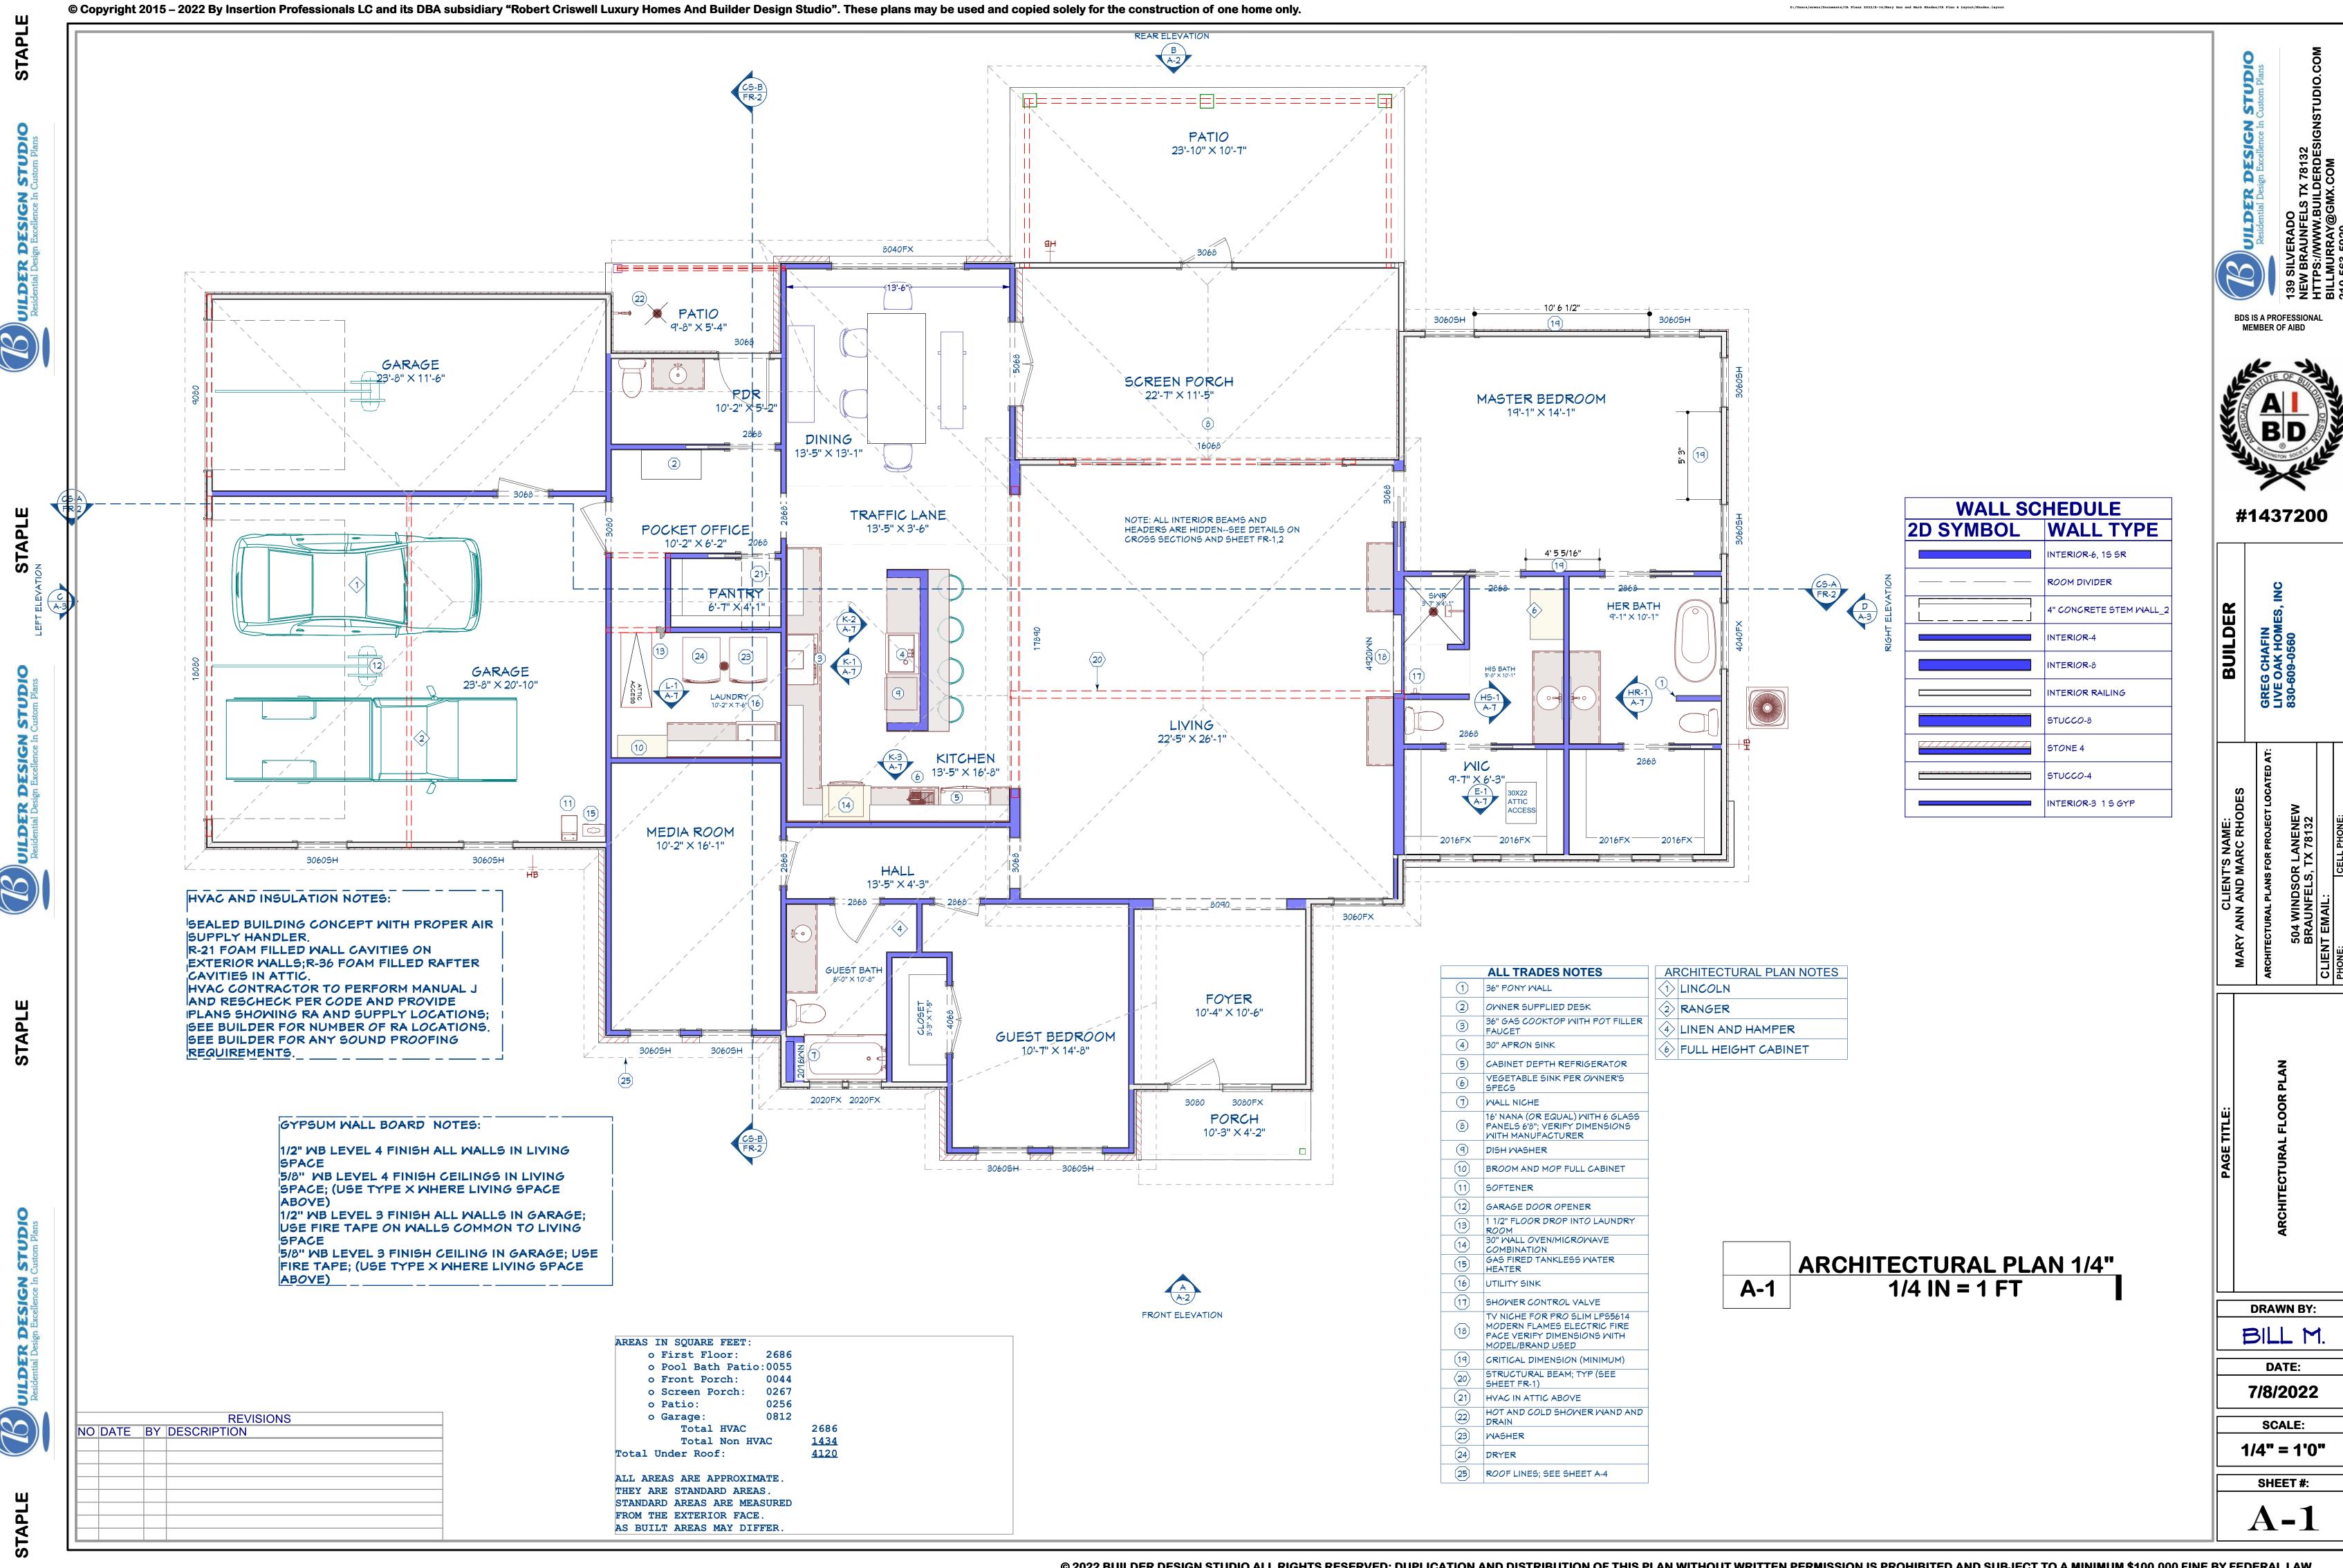
7/8/2022


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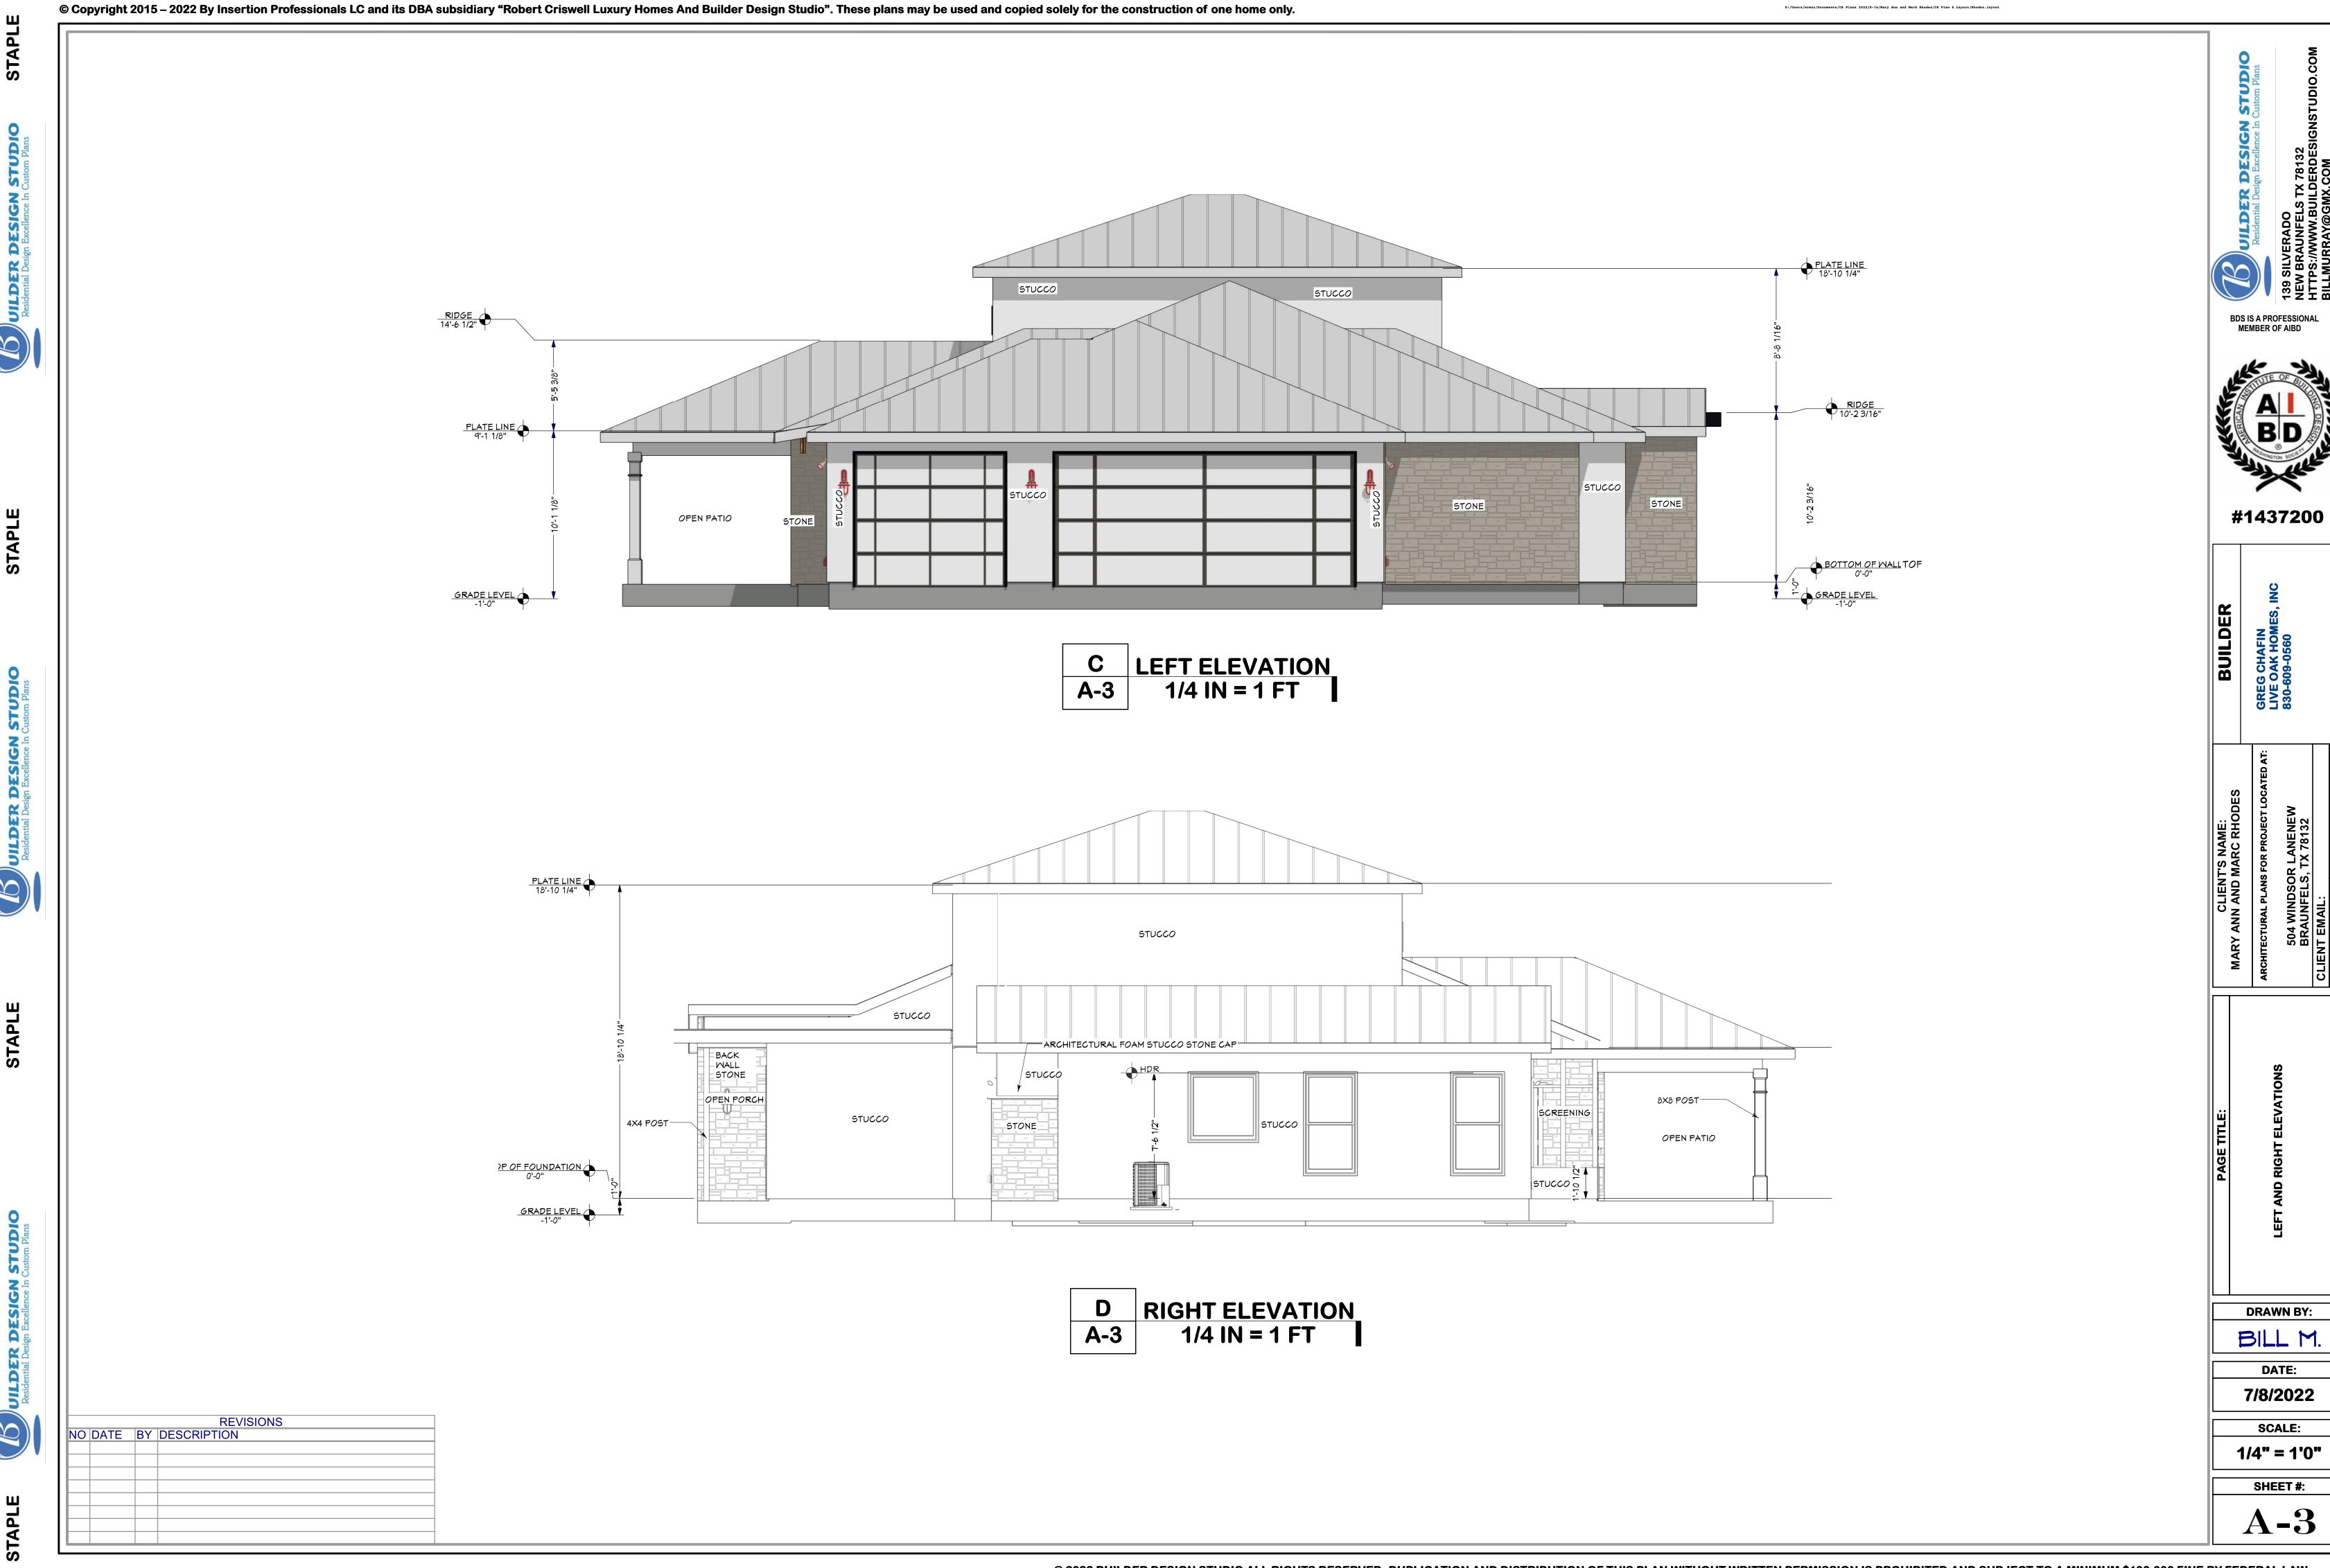
SHEET#:

REVISIONS
NO DATE BY DESCRIPTION





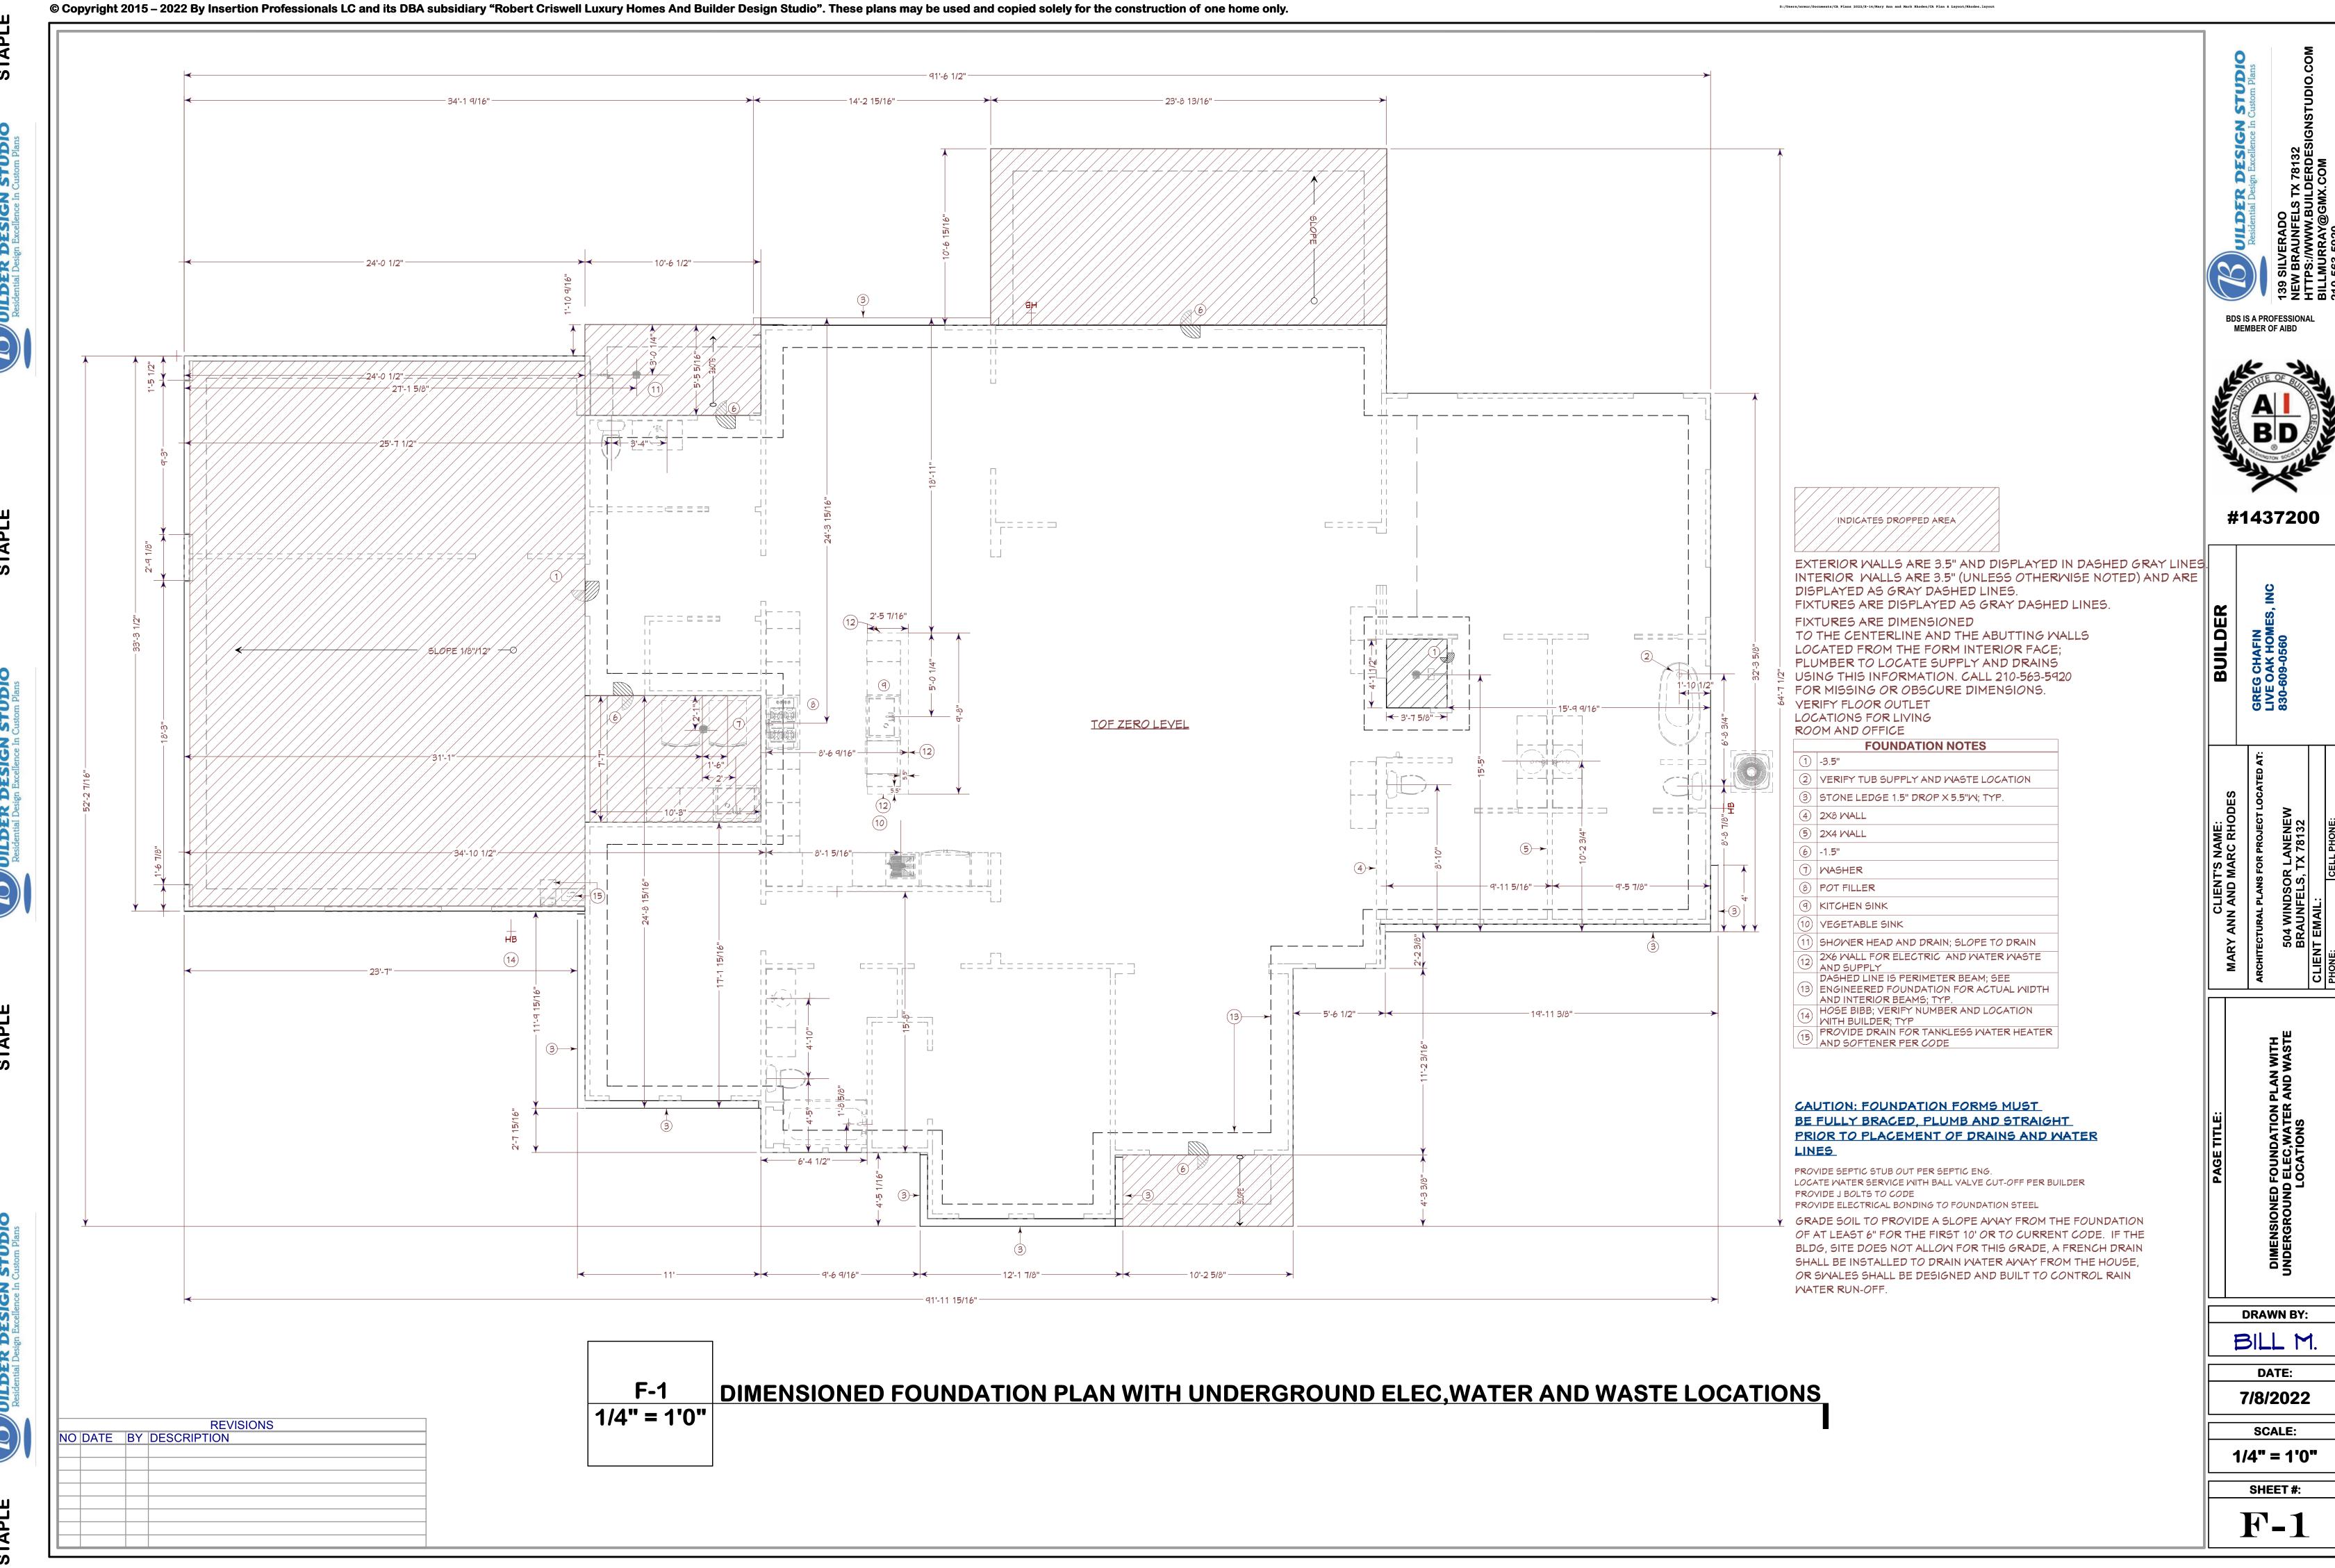


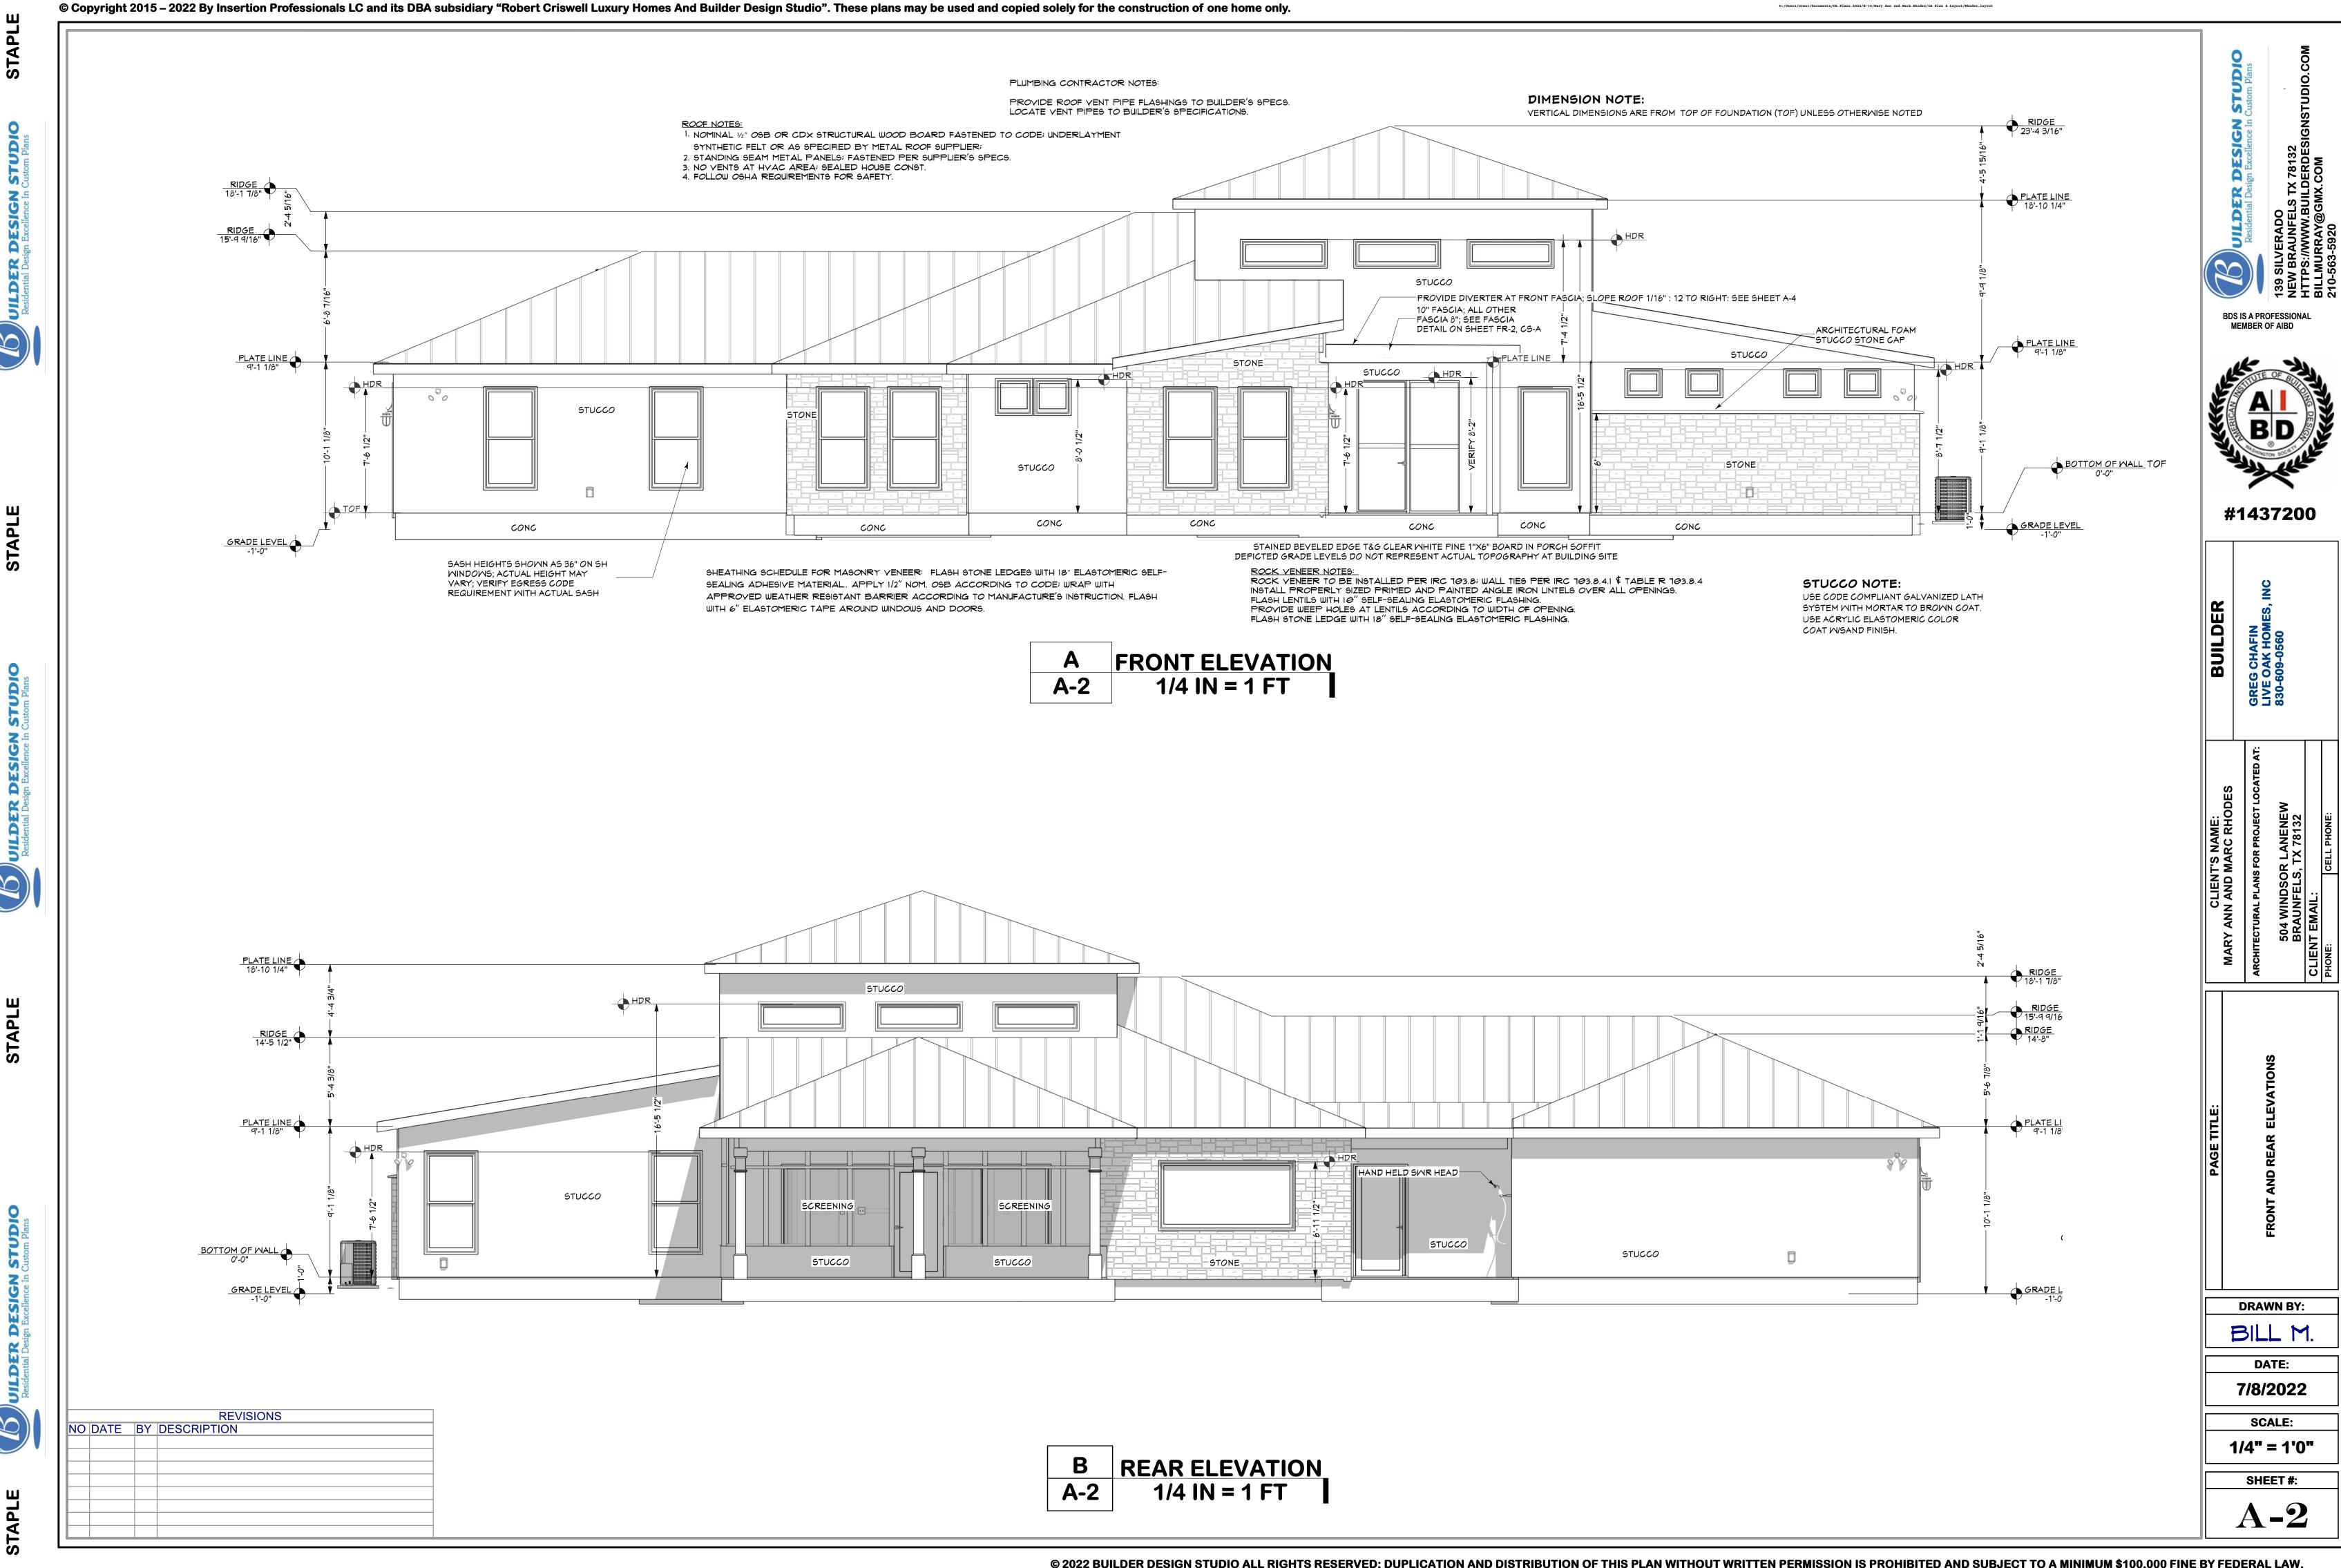



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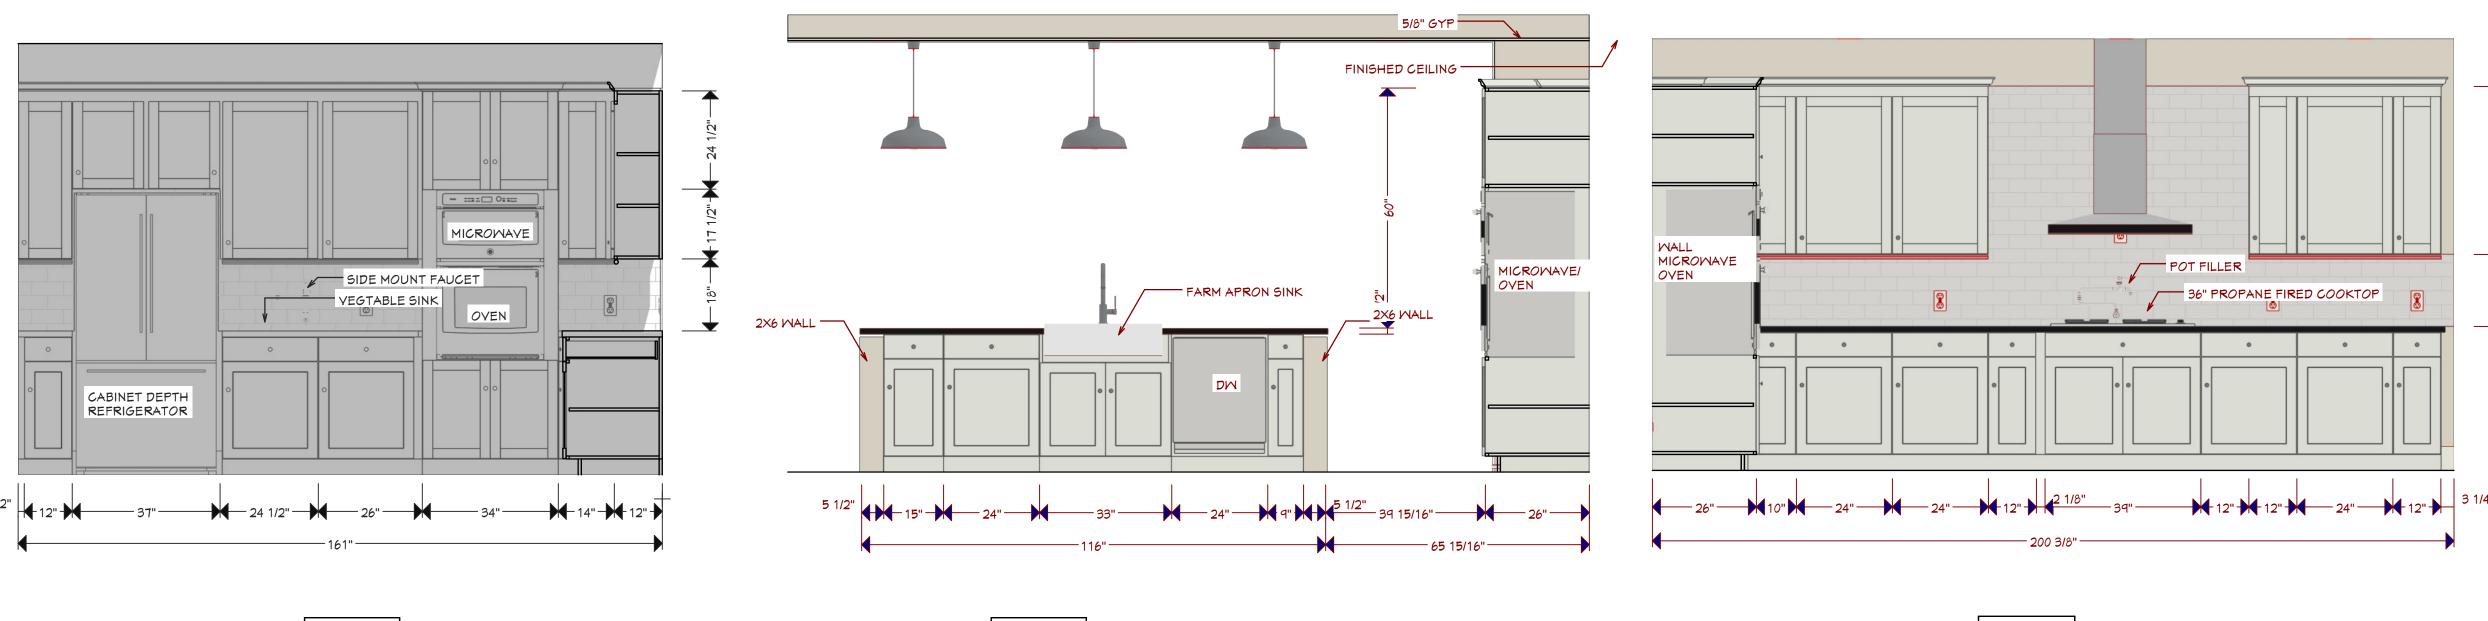
FR-2





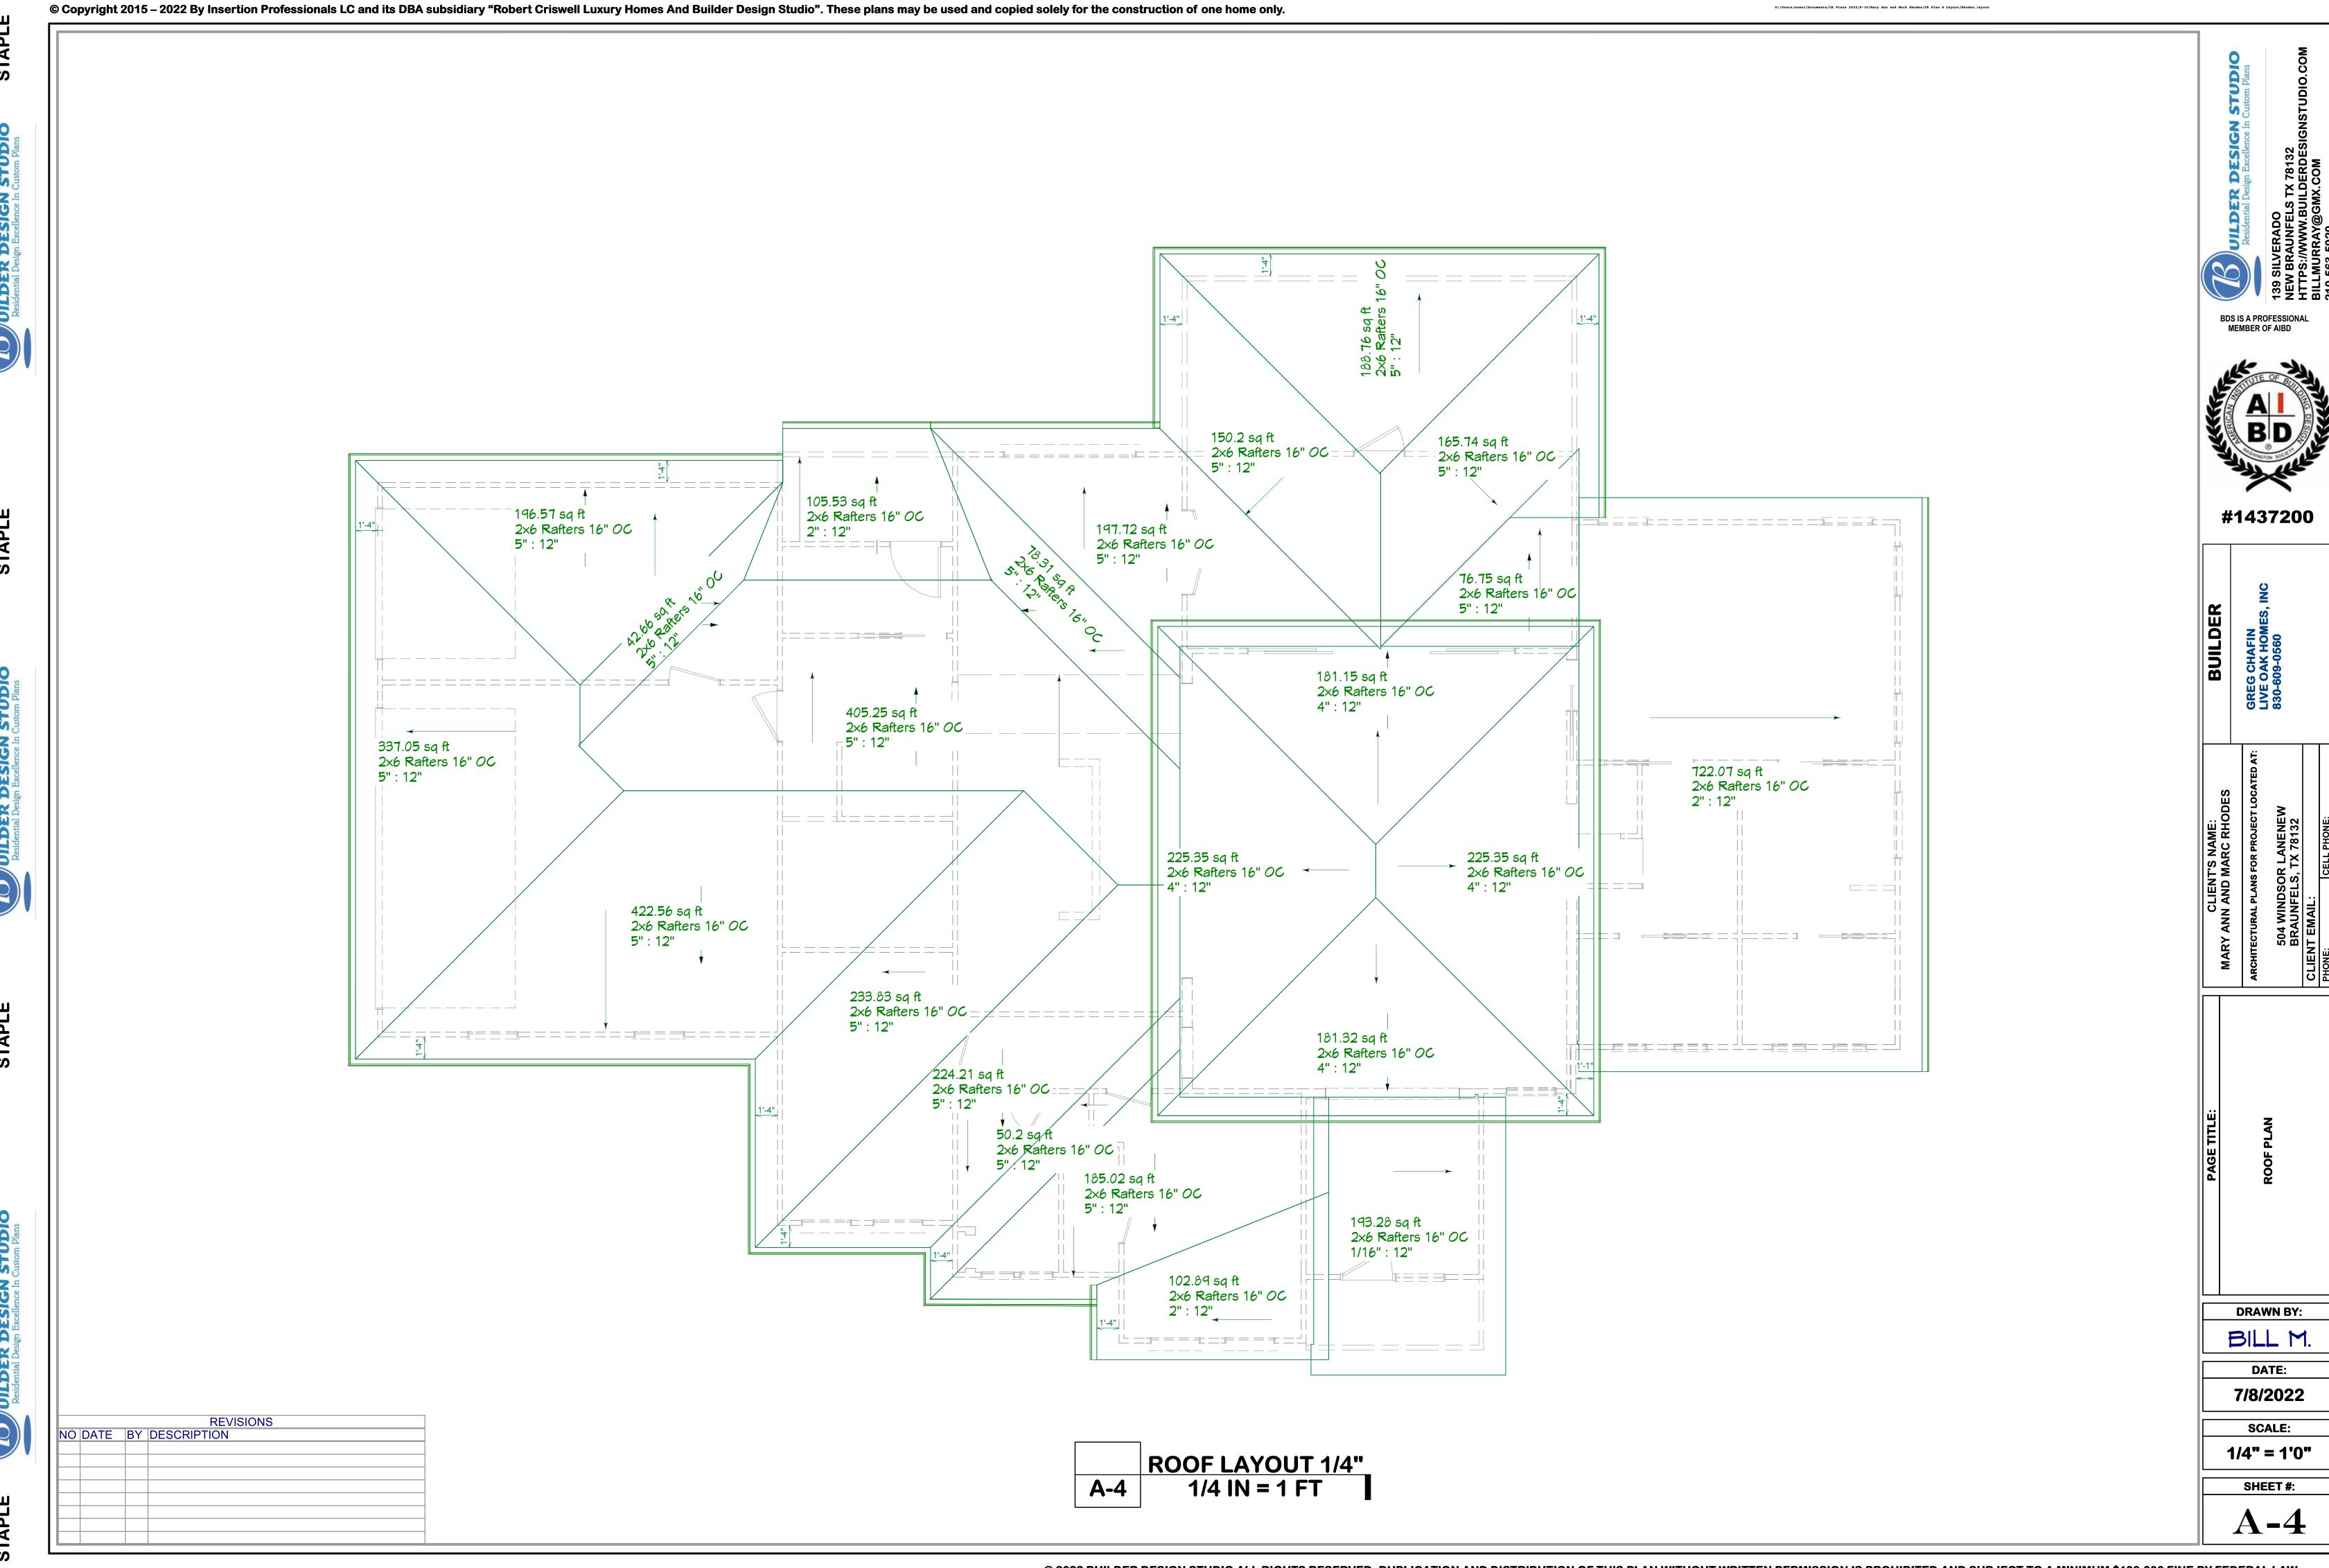

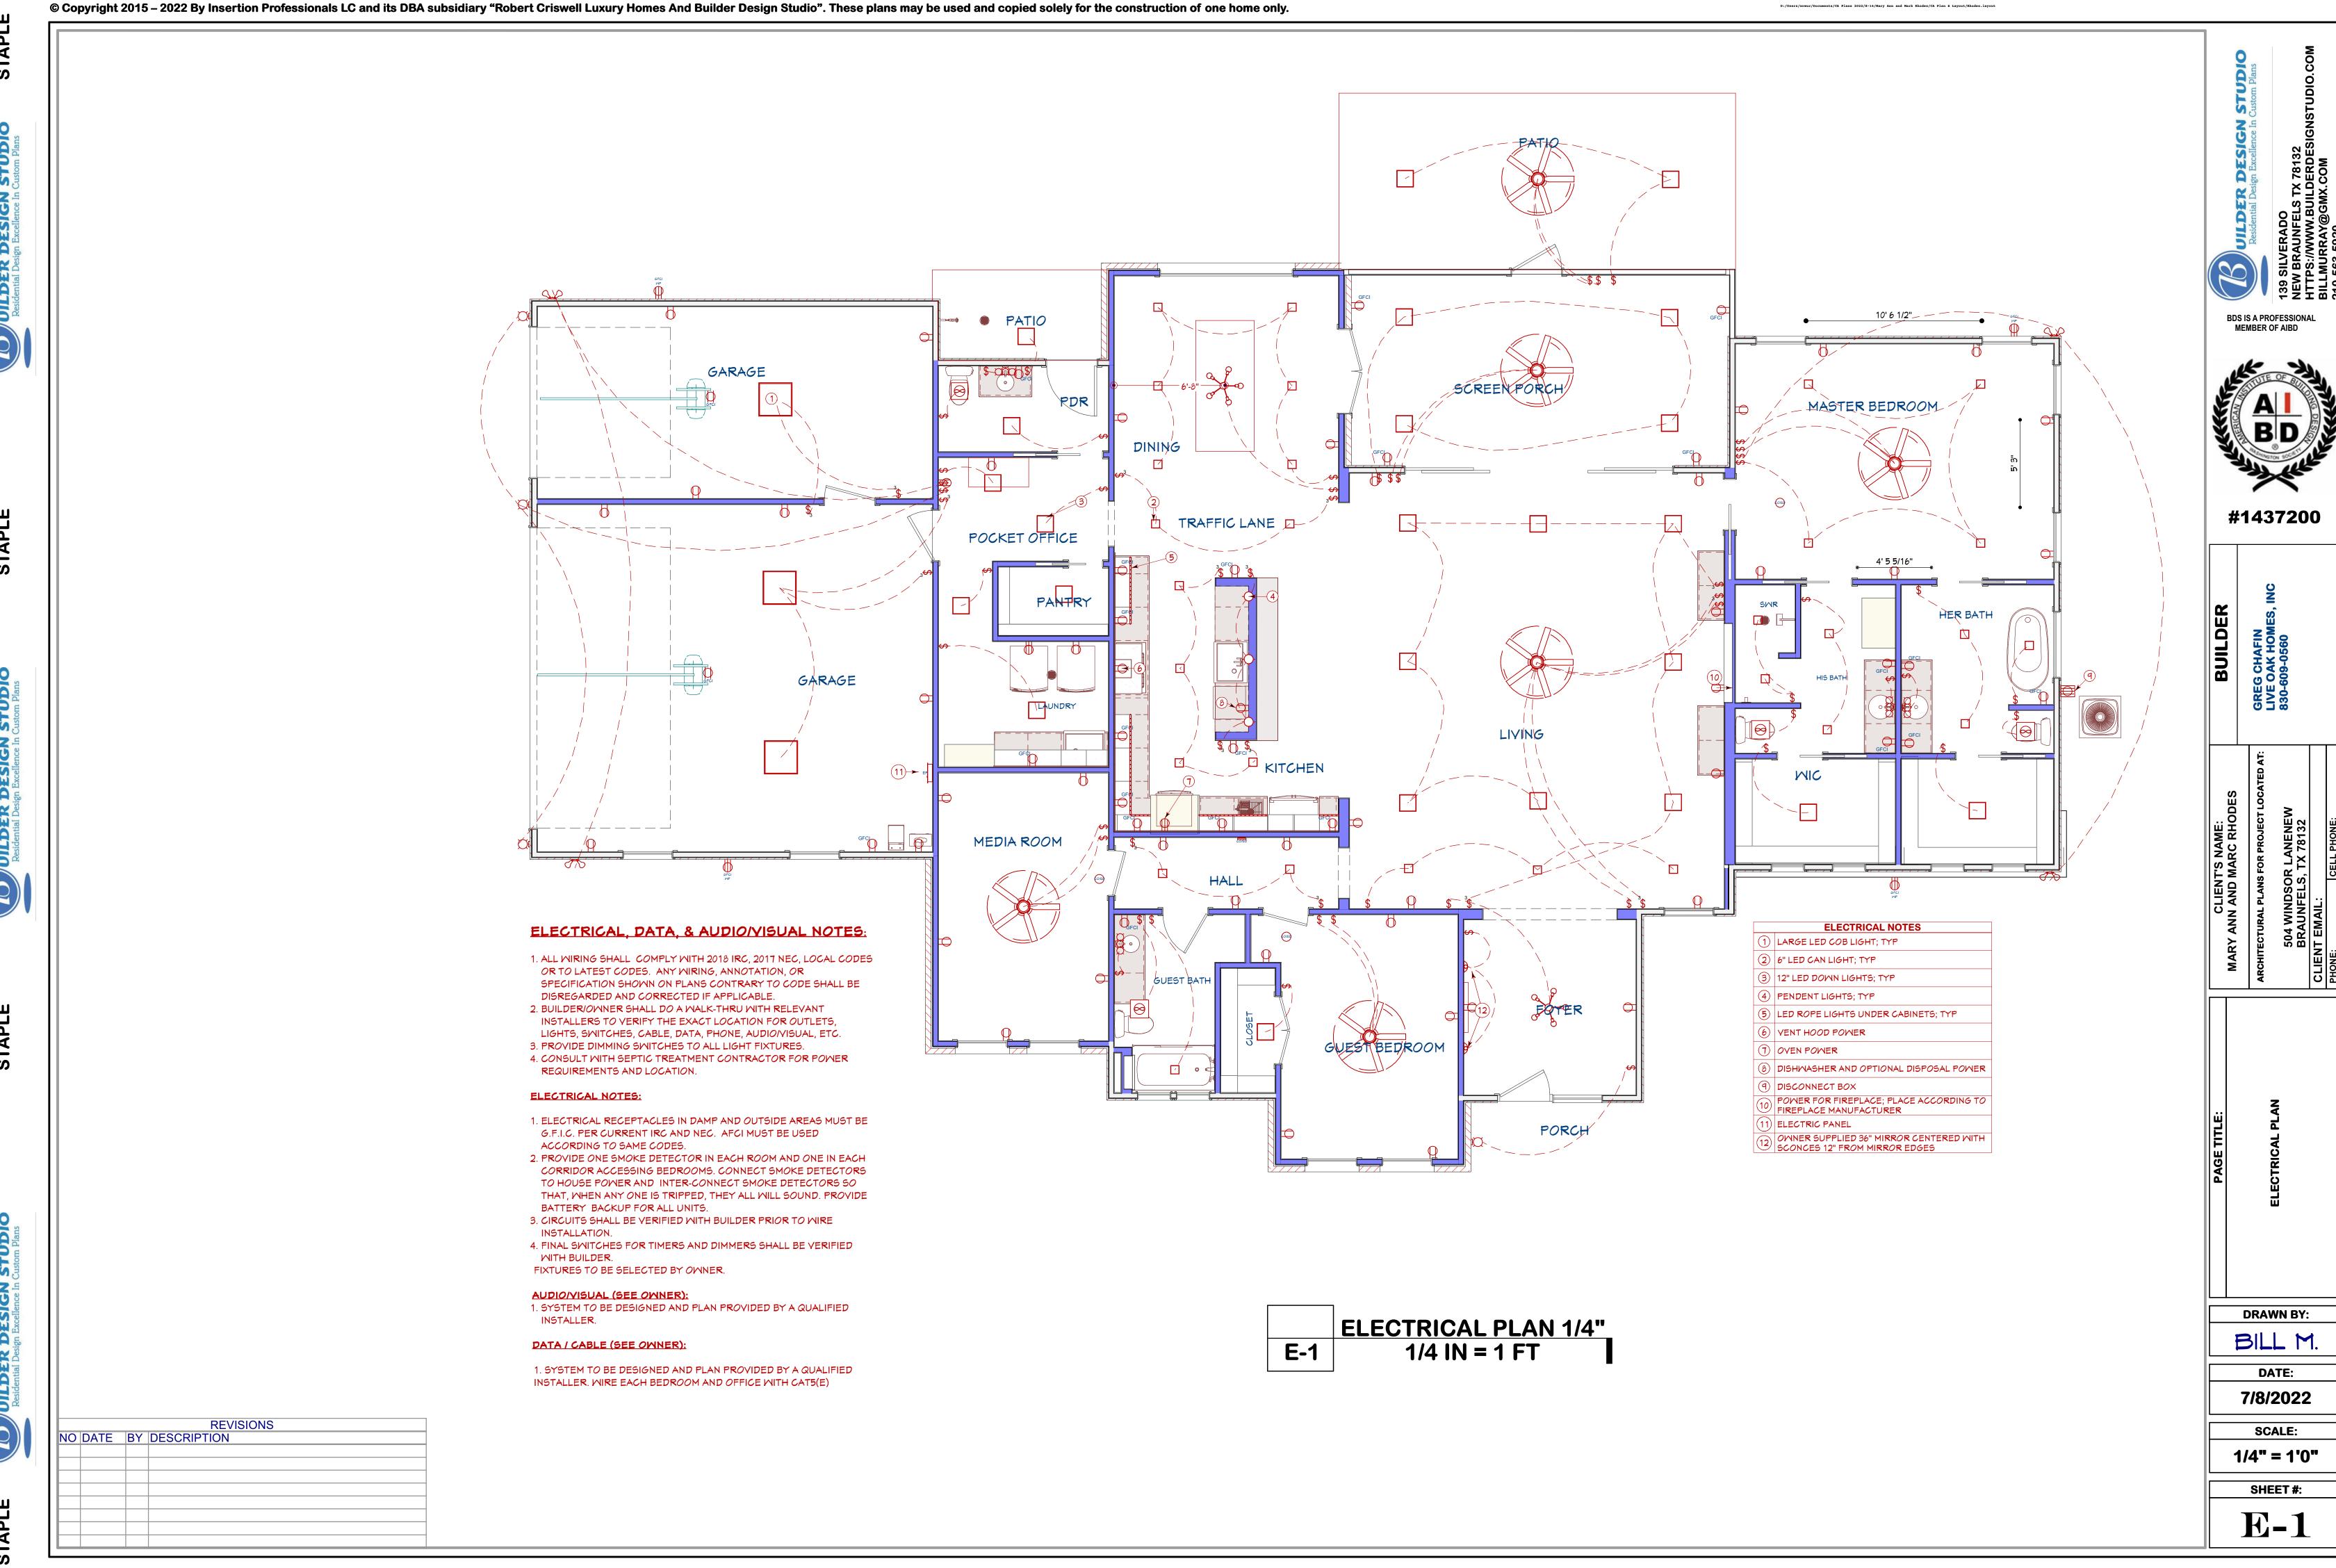
DIMENSIONS TO FINISHED FLOOR; CABINETS SHOWN FOR PLACE HOLDING; CLIENT TO CHOOSE STYLE WITH CABINET SUPPLIER

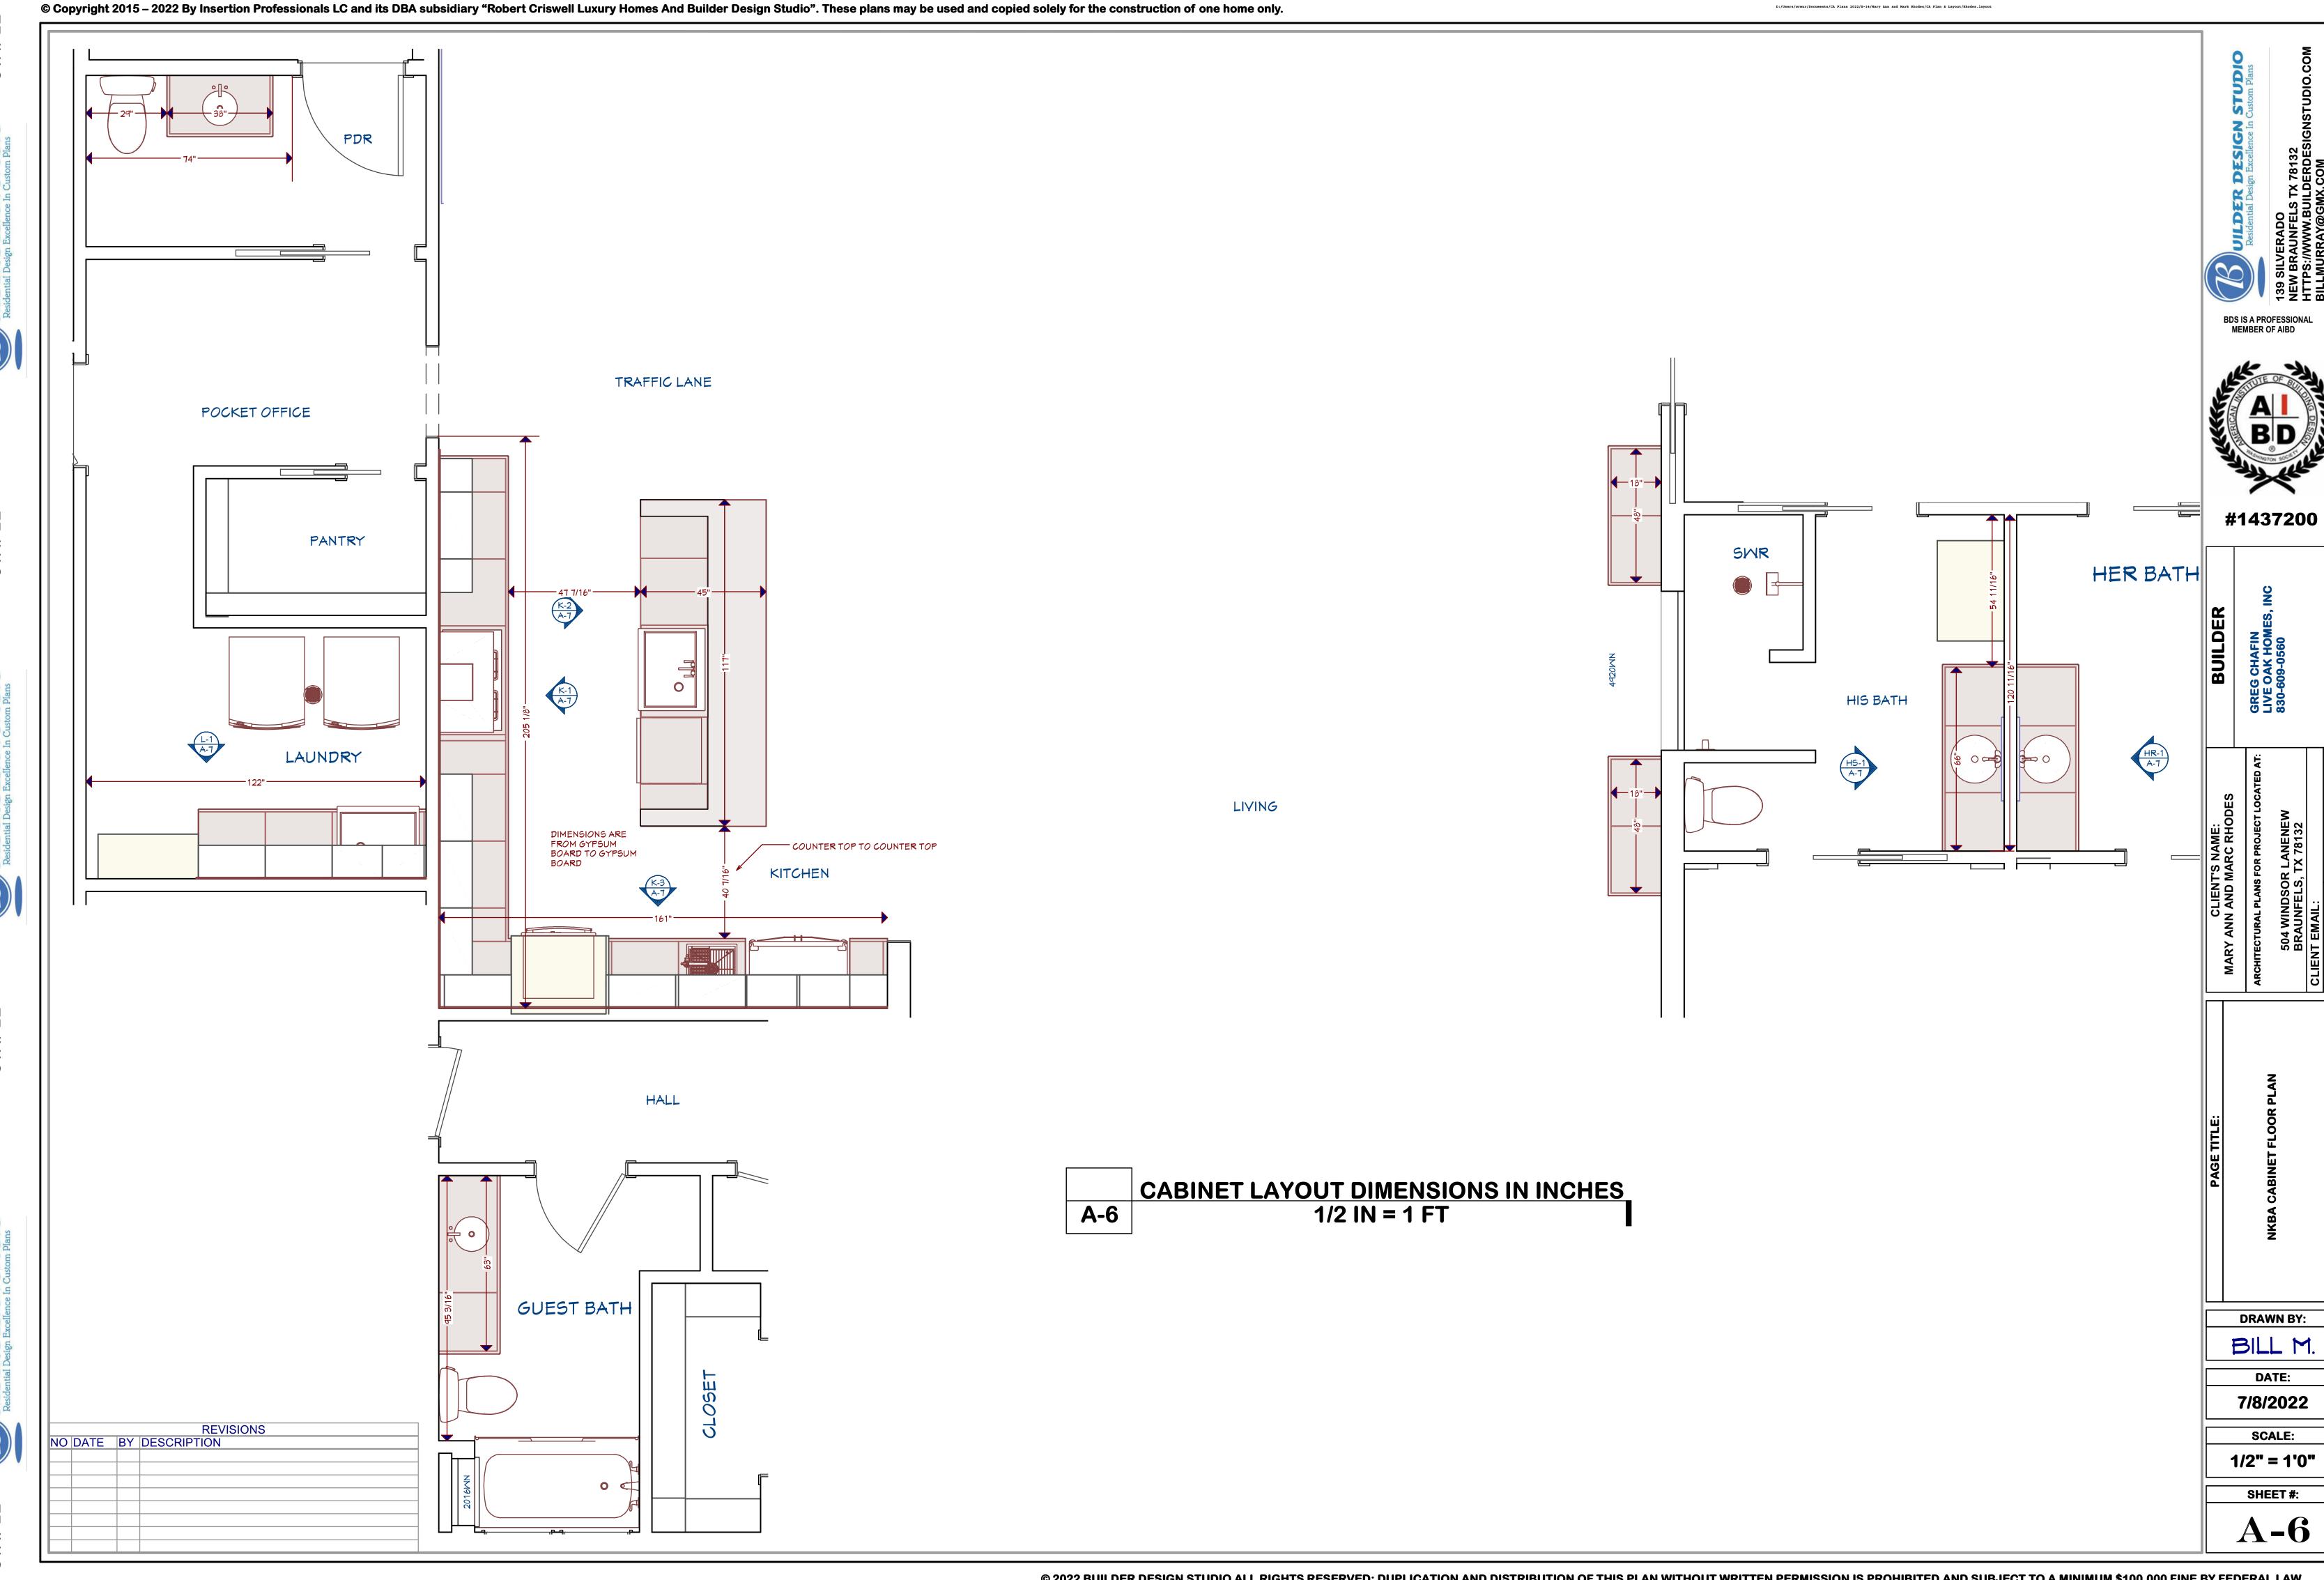

K-3 KITCHEN THREE
A-7 1/2 IN = 1 FT


K-2 KITCHEN TWO
A-7 1/2 IN = 1 FT


K-1 KITCHEN ONE A-7 1/2 in = 1 ft

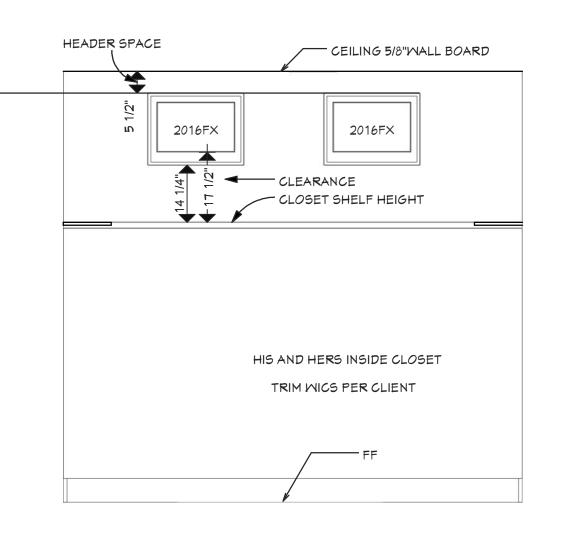


REVISIONS

NO DATE BY DESCRIPTION

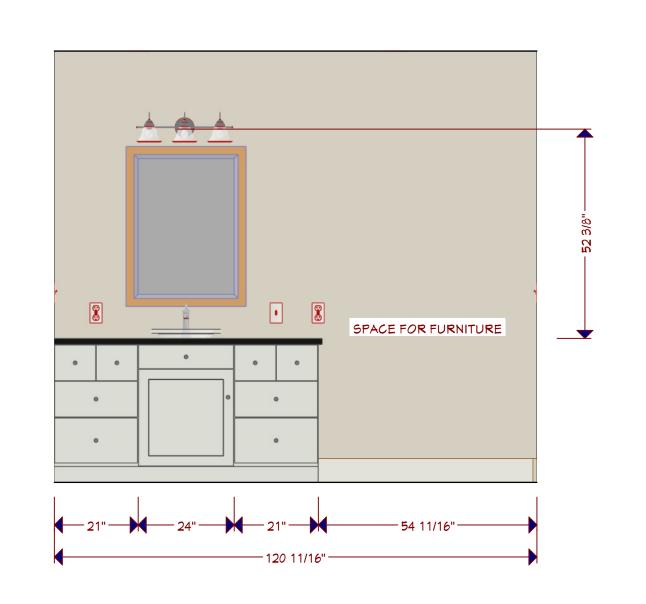

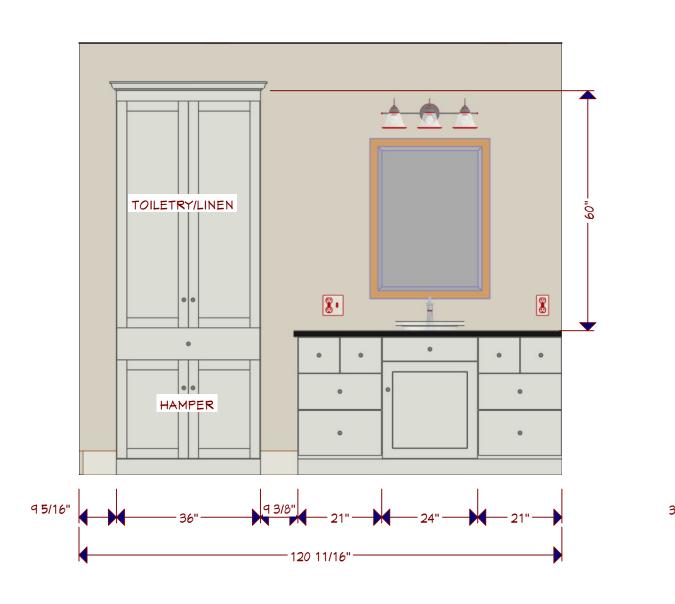

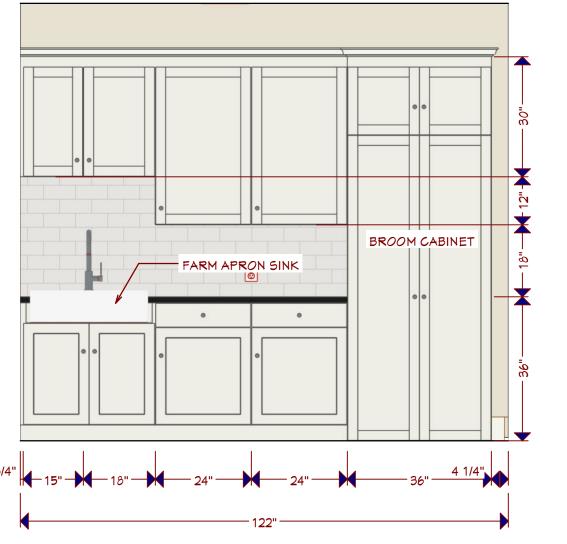

E-1 ELEVATION ONE TO SHOW SHELF/WINDOW CLEARANCE
A-7 1/2 IN = 1 FT

HR-1 HERS ONE A-7 1/2 IN = 1 FT

HS-1 HIS BATH ONE A-7 1/2 IN = 1 FT

L-1 LAUNDRY ONE A-7 1/2 IN = 1 FT DRAWN BY:

BILL M.

DATE:

7/8/2022

SCALE:

1/2" = 1'0"

SHEET #:

A - 7

FINE BY FEDERAL LAW.

BDS IS A PROFESSIONAL MEMBER OF AIBD

#1437200

GREG CHAFIN LIVE OAK HOME 830-609-0560