


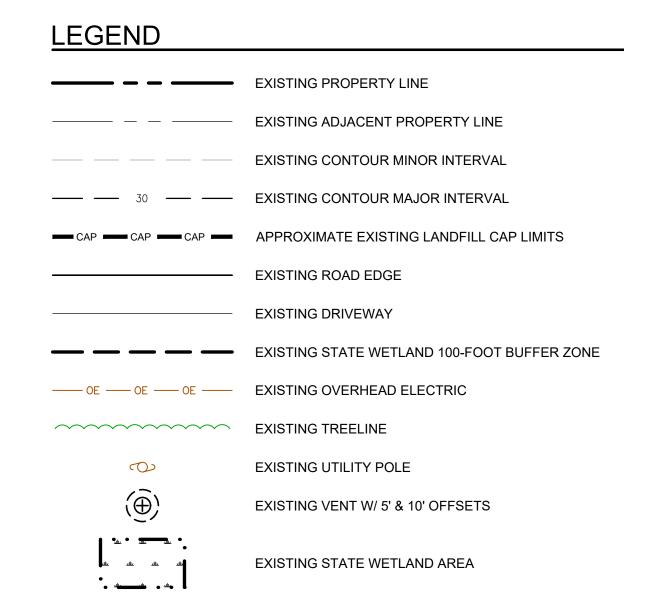


- DRAWING NOTES:

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  3. EXISTING FEATURES APPROXIMATED BASED ON ORTHOIMAGERY FROM NEW YORK STATE GIS
- 4. EXISTING WETLAND BOUNDARIES DOWNLOADED FROM FRESHWATER WETLAND POLYGON DATASET FROM
- SUFFOLK COUNTY GIS OPEN DATA, DATED 2020, ACCESSED AND DOWNLOADED 09/26/2024. 5. LANDFILL CAP LIMITS APPROXIMATED FROM EXISTING CONDITIONS SURVEY FOR FISHERS ISLAND PICKETT
- LANDFILL, PREPARED BY CME ASSOCIATES ENGINEERING & LAND SURVEYING, PLLC, DATED 9/17/2003.



REV # DESCRIPTION DATE BY FISHERS ISLAND SOLAR SUFFOLK COUNTY, NY TOWN OF SOUTHOLD SITE PLAN **EXISTING CONDITIONS** 

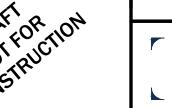






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AS SHOWN

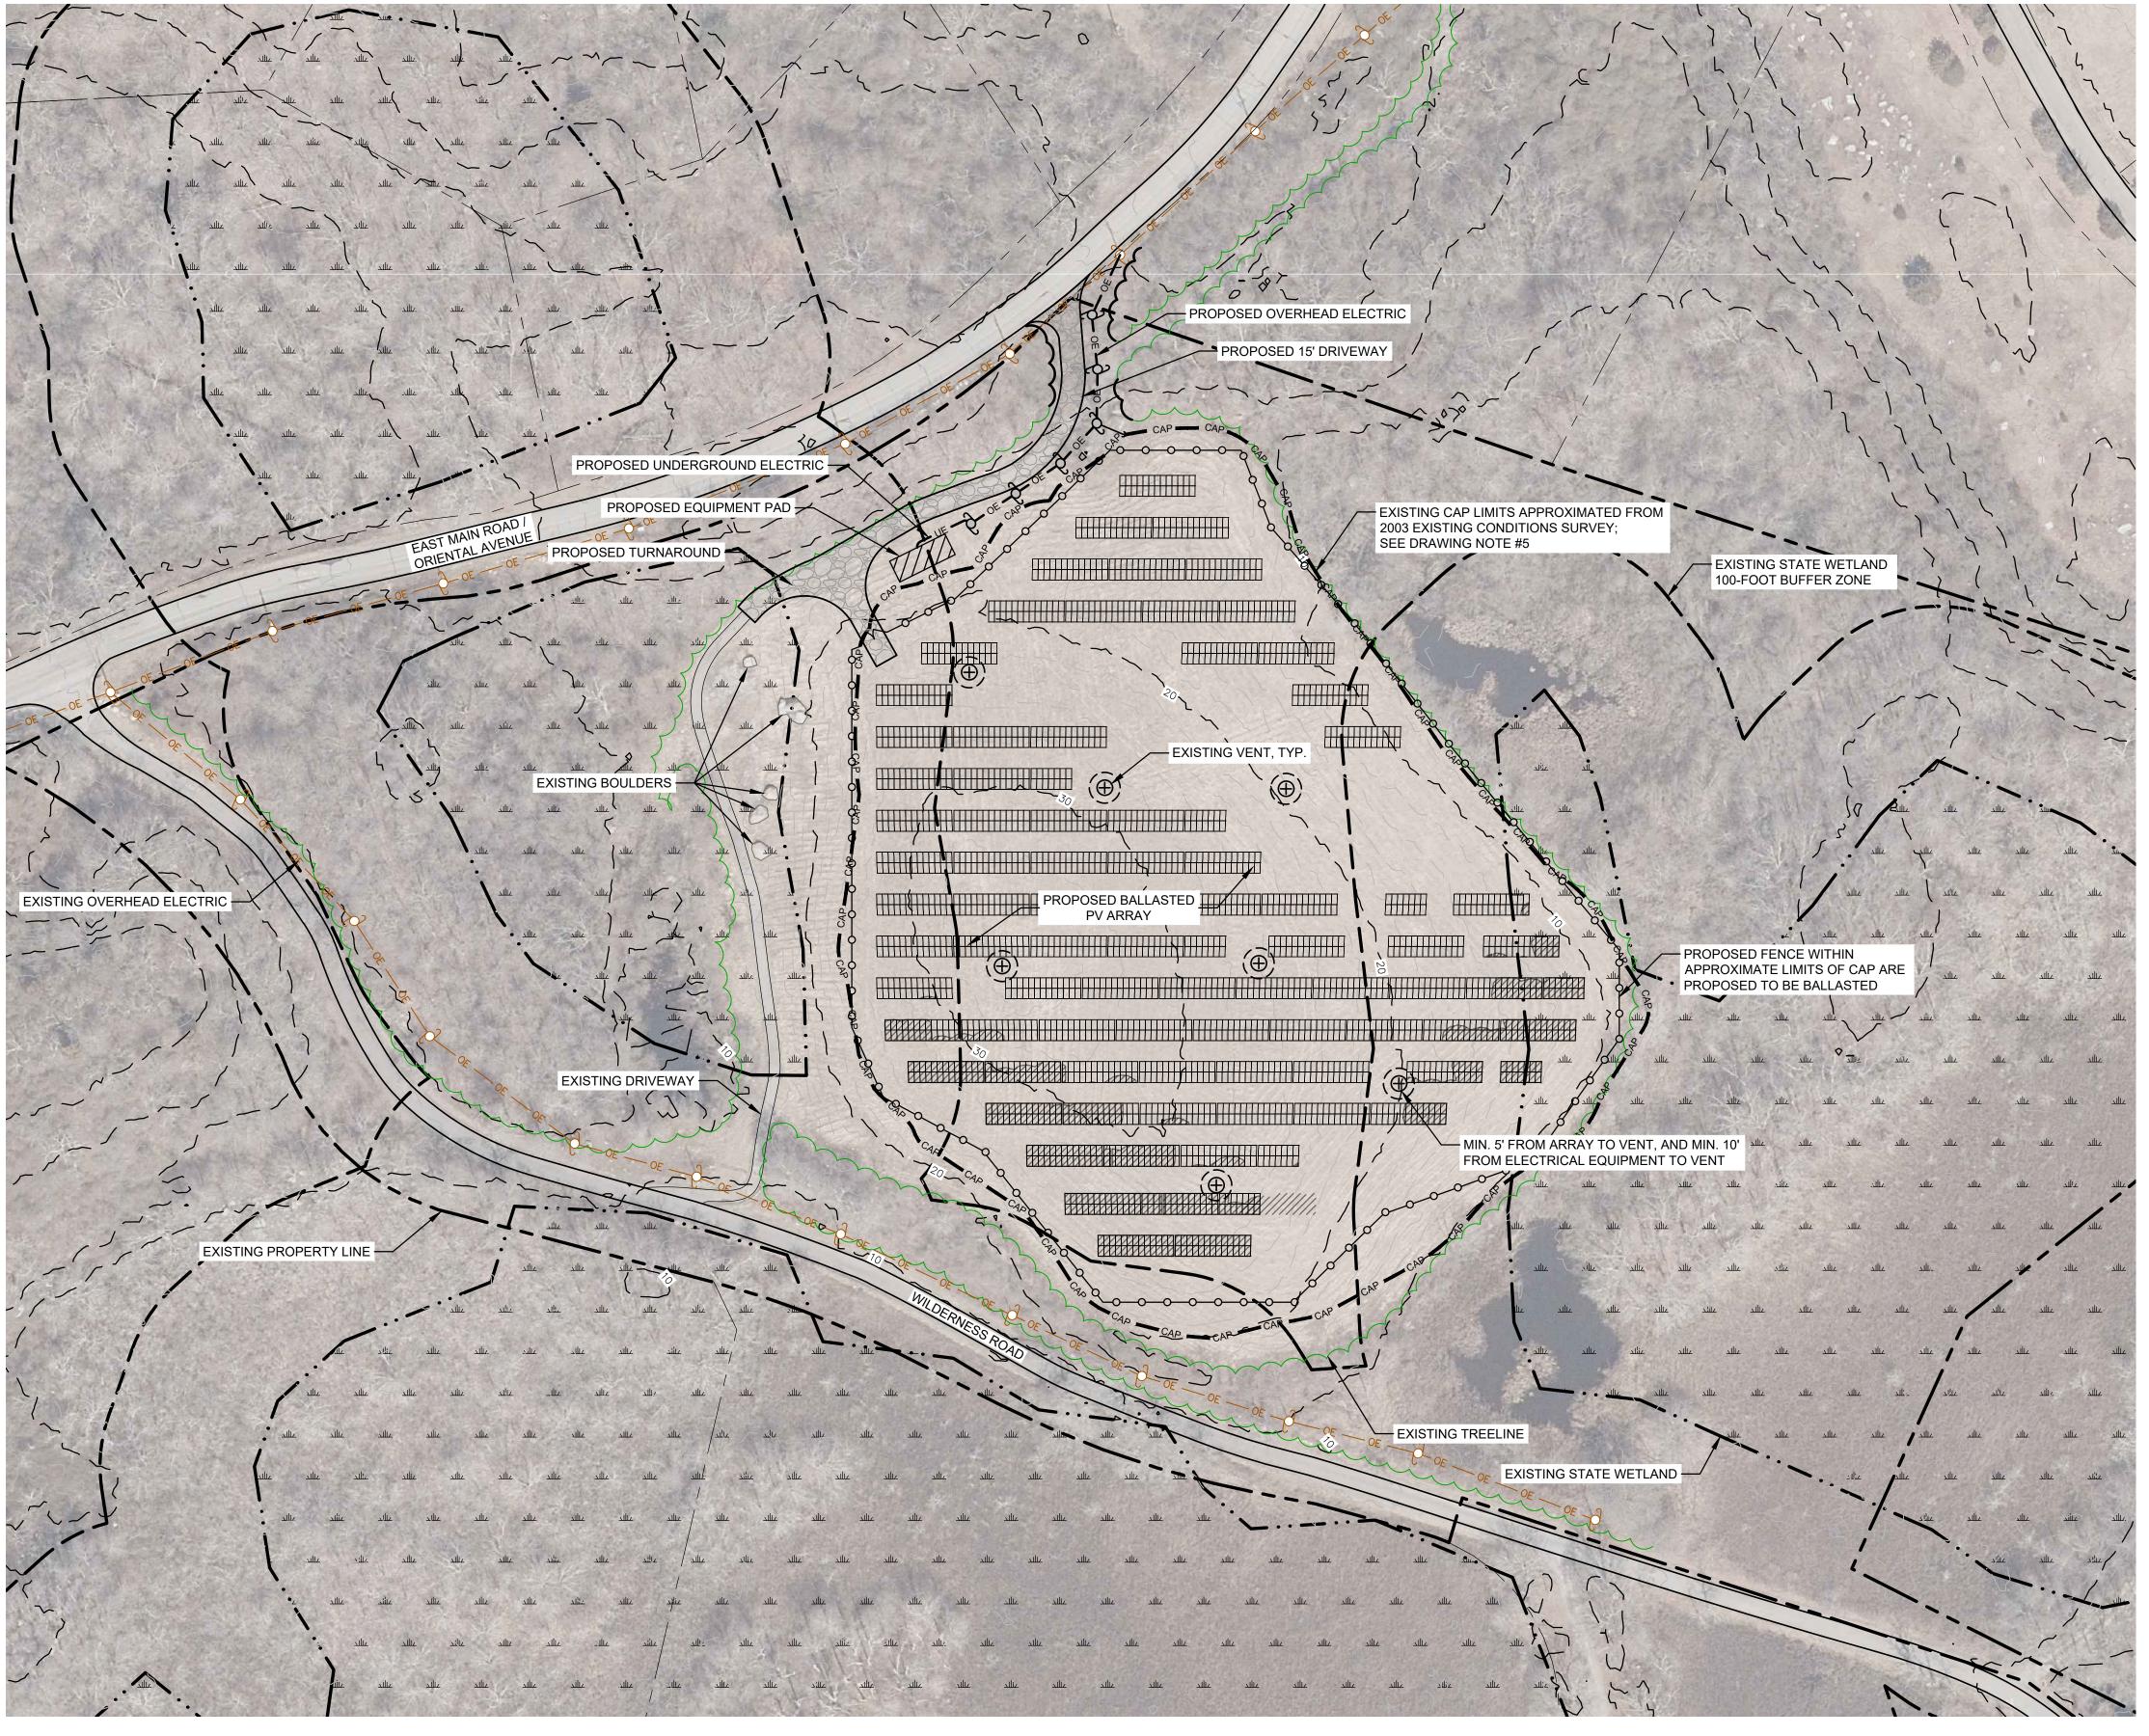


## PROPOSED OVERALL LAYOUT PLAN SCALE: 1"=60'

NOTES:

1. THE WETLAND BOUNDARIES SHOWN WERE DOWNLOADED FROM SUFFOLK COUNTY GIS OPEN DATA, AND ARE APPROXIMATE. A WETLAND DELINEATION MAY BE REQUIRED FOR MORE PRECISE WETLAND LOCATIONS.

- 2. DISTURBANCE WITHIN STATE REGULATED FRESHWATER WETLANDS OR ADJACENT AREAS MAY REQUIRE A NYSDEC PERMIT.
- 3. EXISTING CONDITIONS SURVEY FOR FISHERS ISLAND PICKETT LANDFILL REFERENCED IN DRAWING NOTE #3 SHOWS WETLANDS BOUNDARIES WHICH DIFFER FROM WHAT IS SHOWN.
- 4. APPROXIMATE EXISTING TREE HEIGHT OF 60' ESTIMATED USING PUBLICLY AVAILABLE LIDAR.

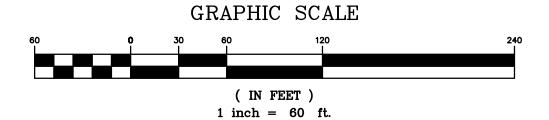



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LEGEND	
	EXISTING PROPERTY LINE
	EXISTING ADJACENT PROPERTY LINE
	EXISTING CONTOUR MINOR INTERVAL
	EXISTING CONTOUR MAJOR INTERVAL
—— CAP —— CAP ——	APPROXIMATE EXISTING LANDFILL CAP LIMITS
	EXISTING ROAD EDGE
	EXISTING DRIVEWAY
	EXISTING STATE WETLAND 100-FOOT BUFFER ZONE
	PROPOSED FENCE
—— OE ——— OE ———	EXISTING/PROPOSED OVERHEAD ELECTRIC
—— UE —— UE ——	PROPOSED UNDERGROUND ELECTRIC
~~~ <b>~~~~</b>	EXISTING/PROPOSED TREELINE
0 0	EXISTING/PROPOSED UTILITY POLE
$(\widehat{\oplus})$	EXISTING VENT W/ 5' & 10' OFFSETS
**************************************	EXISTING STATE WETLAND AREA
	SHADED MODULES HATCH (60' TREE HEIGHT FROM 10 AM - 2 PM ON WINTER SOLSTICE)
	PROPOSED DRIVEWAY
	PROPOSED EQUIPMENT PAD

SYSTEM SUMMARY					
DESCRIPTION	VALUE	UNITS			
MAXIMUM AC CAPACITY, NOMINAL	990	KW-AC			
MAXIMUM DC CAPACITY	1,271	KW-DC			
DC-AC RATIO	1.28	RATIO			
ROW SPACING	13.5	FEET			
GROUND COVER RATIO	0.50	RATIO			
INVERTER: SOLECTRIA XGI 1500-166/166					
INVERTER OUTPUT VOLTAGE	600	VOLTS			
INVERTER OUTPUT POWER, NOMINAL <sup>1</sup>	166	KW-AC			
TOTAL NUMBER OF INVERTERS	6	EACH			
NUMBER OF STRINGS PER INVERTER	14-15	EACH			
MODULE: VSUN575N-144BMH-DG 575W					
MODULE POWER RATING	575	WATTS-DC			
TOTAL NUMBER OF MODULES	2,210	EACH			
MODULES PER RACK, VERTICALLY	2	PORTRAIT			
MODULES PER STRING	26	EACH			
MAX DC SYSTEM VOLTAGE	1,500	VOLTS			
NUMBER OF STRINGS	85	EACH			
TILT ANGLE	25	DEGREES			
<sup>1</sup> INVERTERS TO BE DERATED BY MANUFACTOF 165KW-AC.	TURER TO A NOMINAL O	UTPUT POWER			

	REV #	DESCRIPTION	DATE	BY
		FISHERS ISLAND SOLAR		
	TOWN C	DF SOUTHOLD SUFFOLK	K COUNT	Y, NY
£0.4		SITE PLAN PROPOSED OVERALL LAYOU	JT	
DRAFTOR TION NOT FUCTION CONSTRUCTION				3-2700

12/9/2024

AS SHOWN

DRAWN BY: JAT

DESIGNED BY: JAT


CHECKED BY: JSC

APPROVED BY: JSC

H:\WORK\5843.0 Fisher Island Solar\DWG\5843.0 SITE.dwg

DRAWNG:

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## **LEGEND**

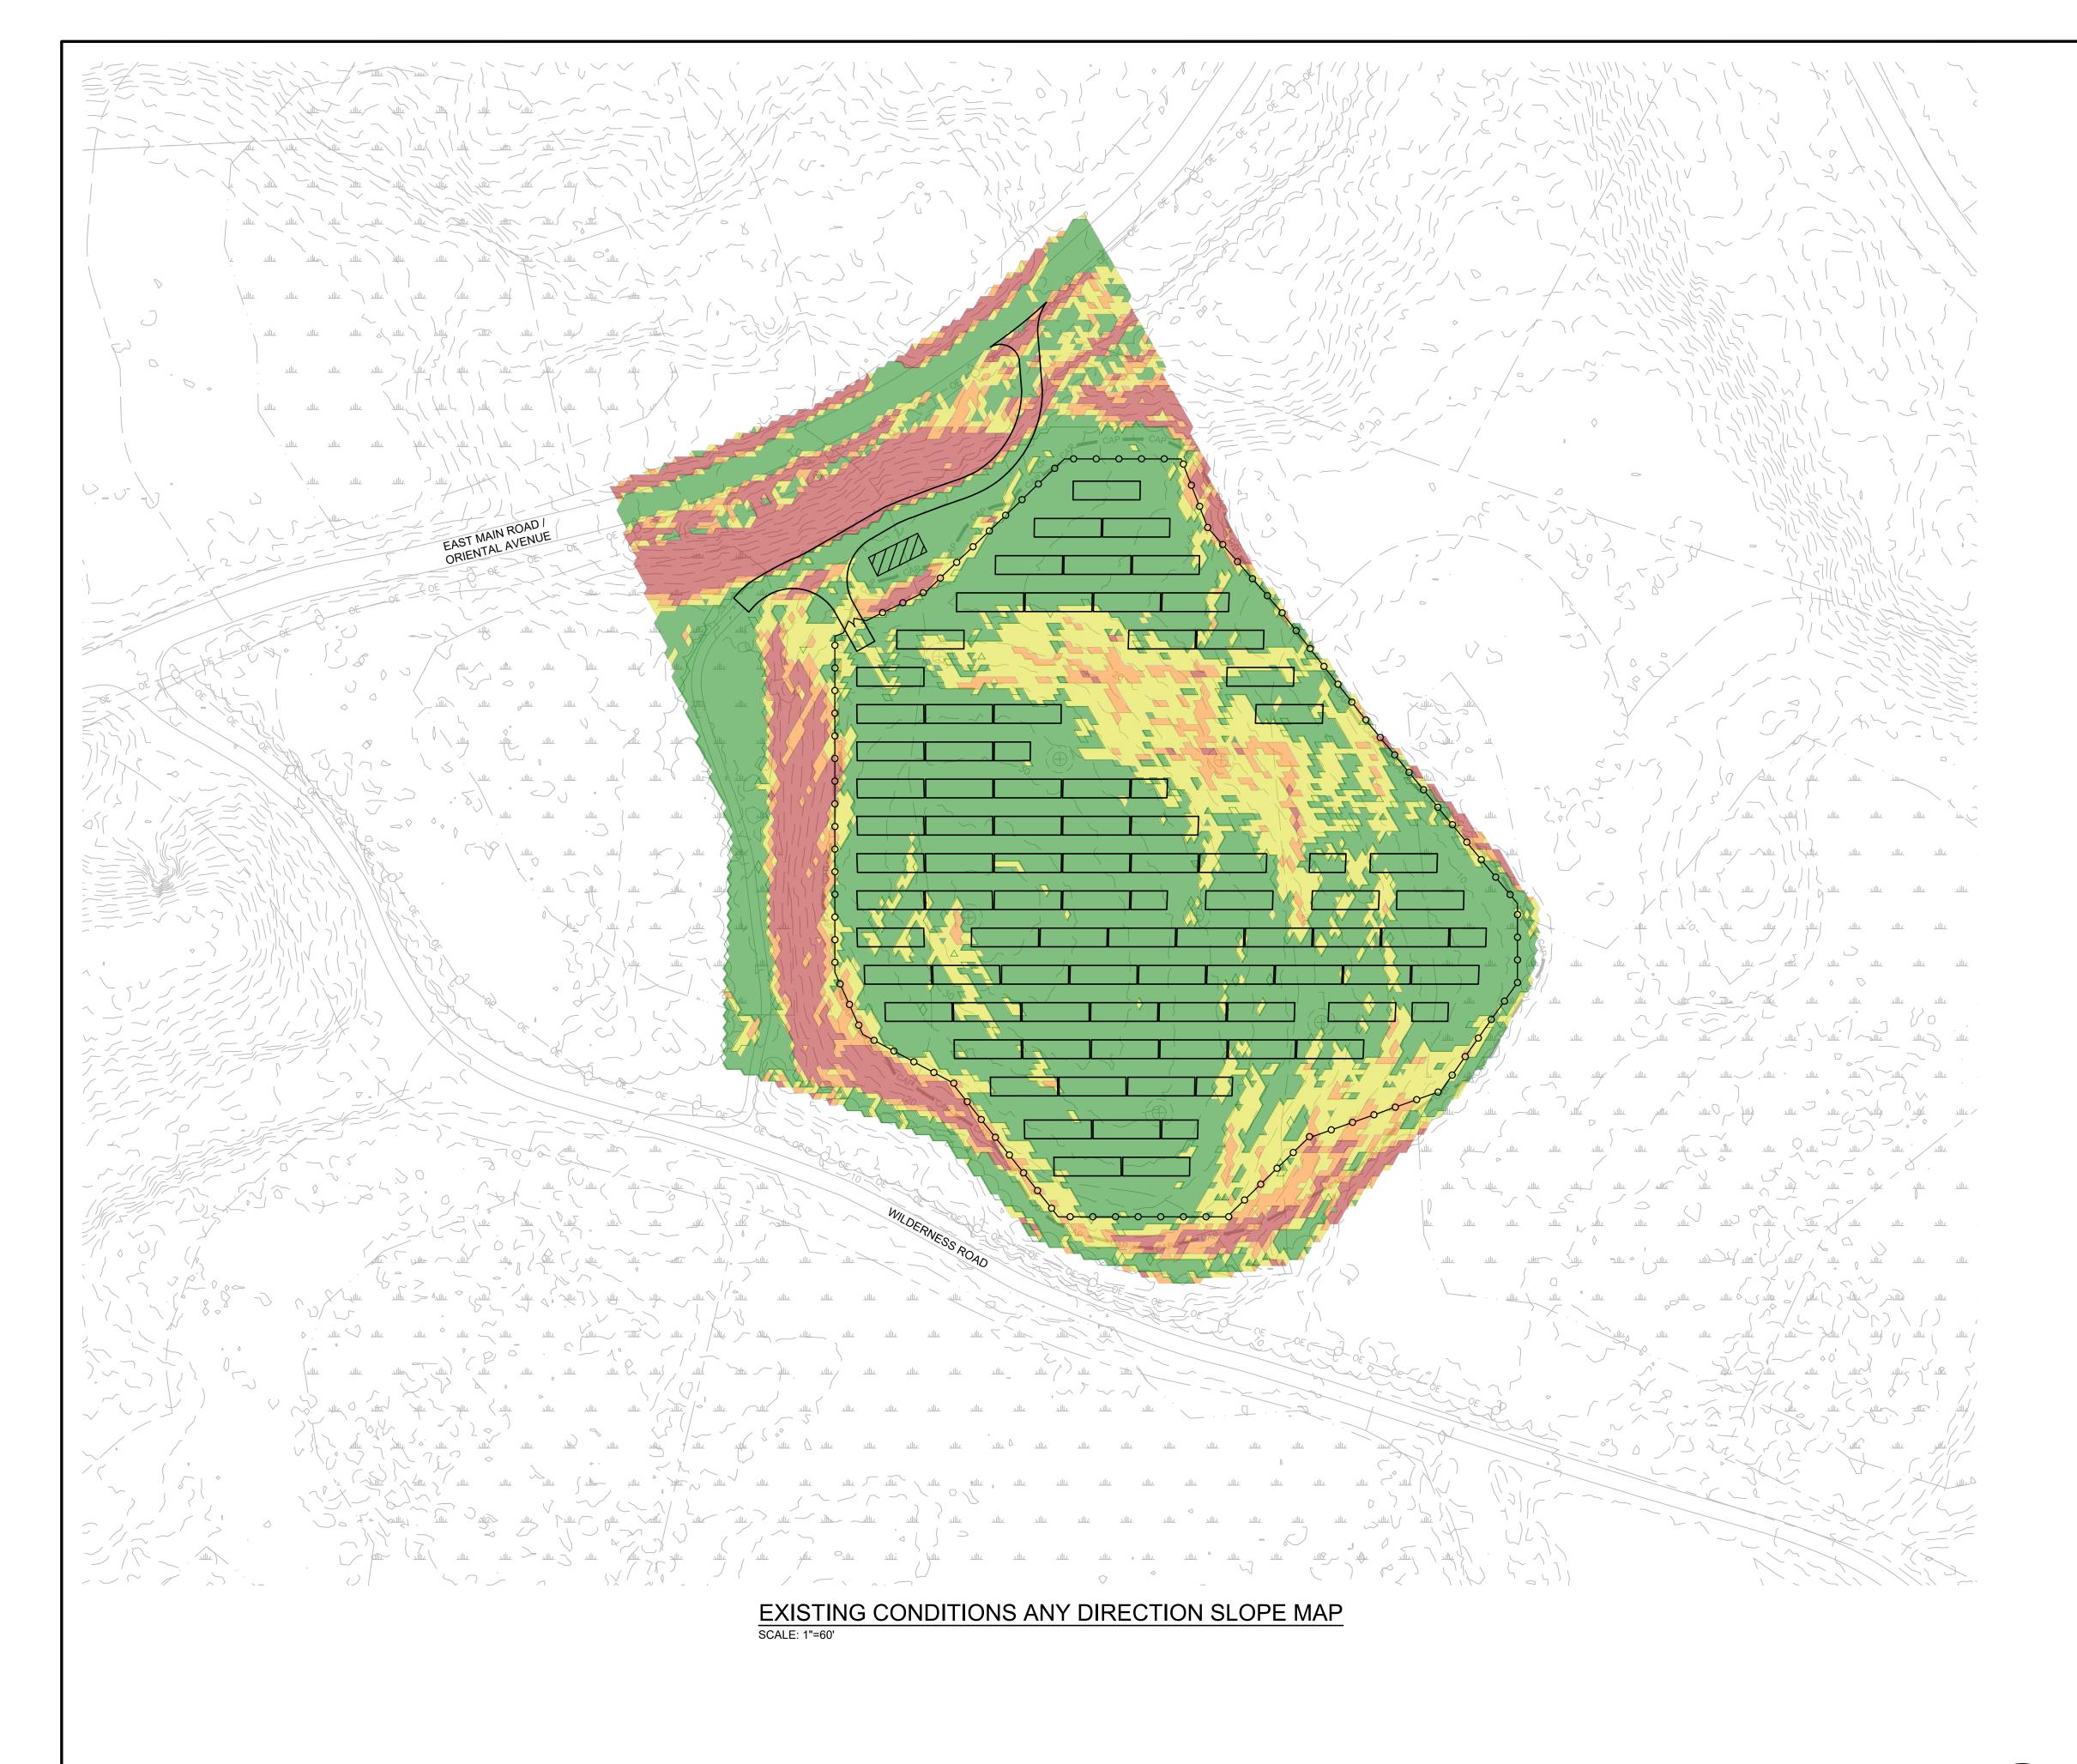--O-O-O-O-O-O-O-PROPOSED FENCE PROPOSED DRIVEWAY

PROPOSED EQUIPMENT PAD

15.00

20.00

MAX

)	ANY DIRECTION SLOPE LEGEND				
CC	SLOPE MAX., %	SLOPE MIN., %			
	10.00	0.00			

10.00

15.00

20.00

DATE BY REV # DESCRIPTION

FISHERS ISLAND SOLAR

SUFFOLK COUNTY, NY

**EXISTING CONDITIONS** ANY DIRECTION SLOPE MAP



AS SHOWN



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( IN FEET ) 1 inch = 60 ft.