


Y.E.S. Townhomes

142 University Ave. San Antonio Texas 78201



Dillard Architect Group 708 Rigsby Avenue San Antonio, Texas (210) 531-0050 office (210) 531-0074 fax dillarchgrp@att.net

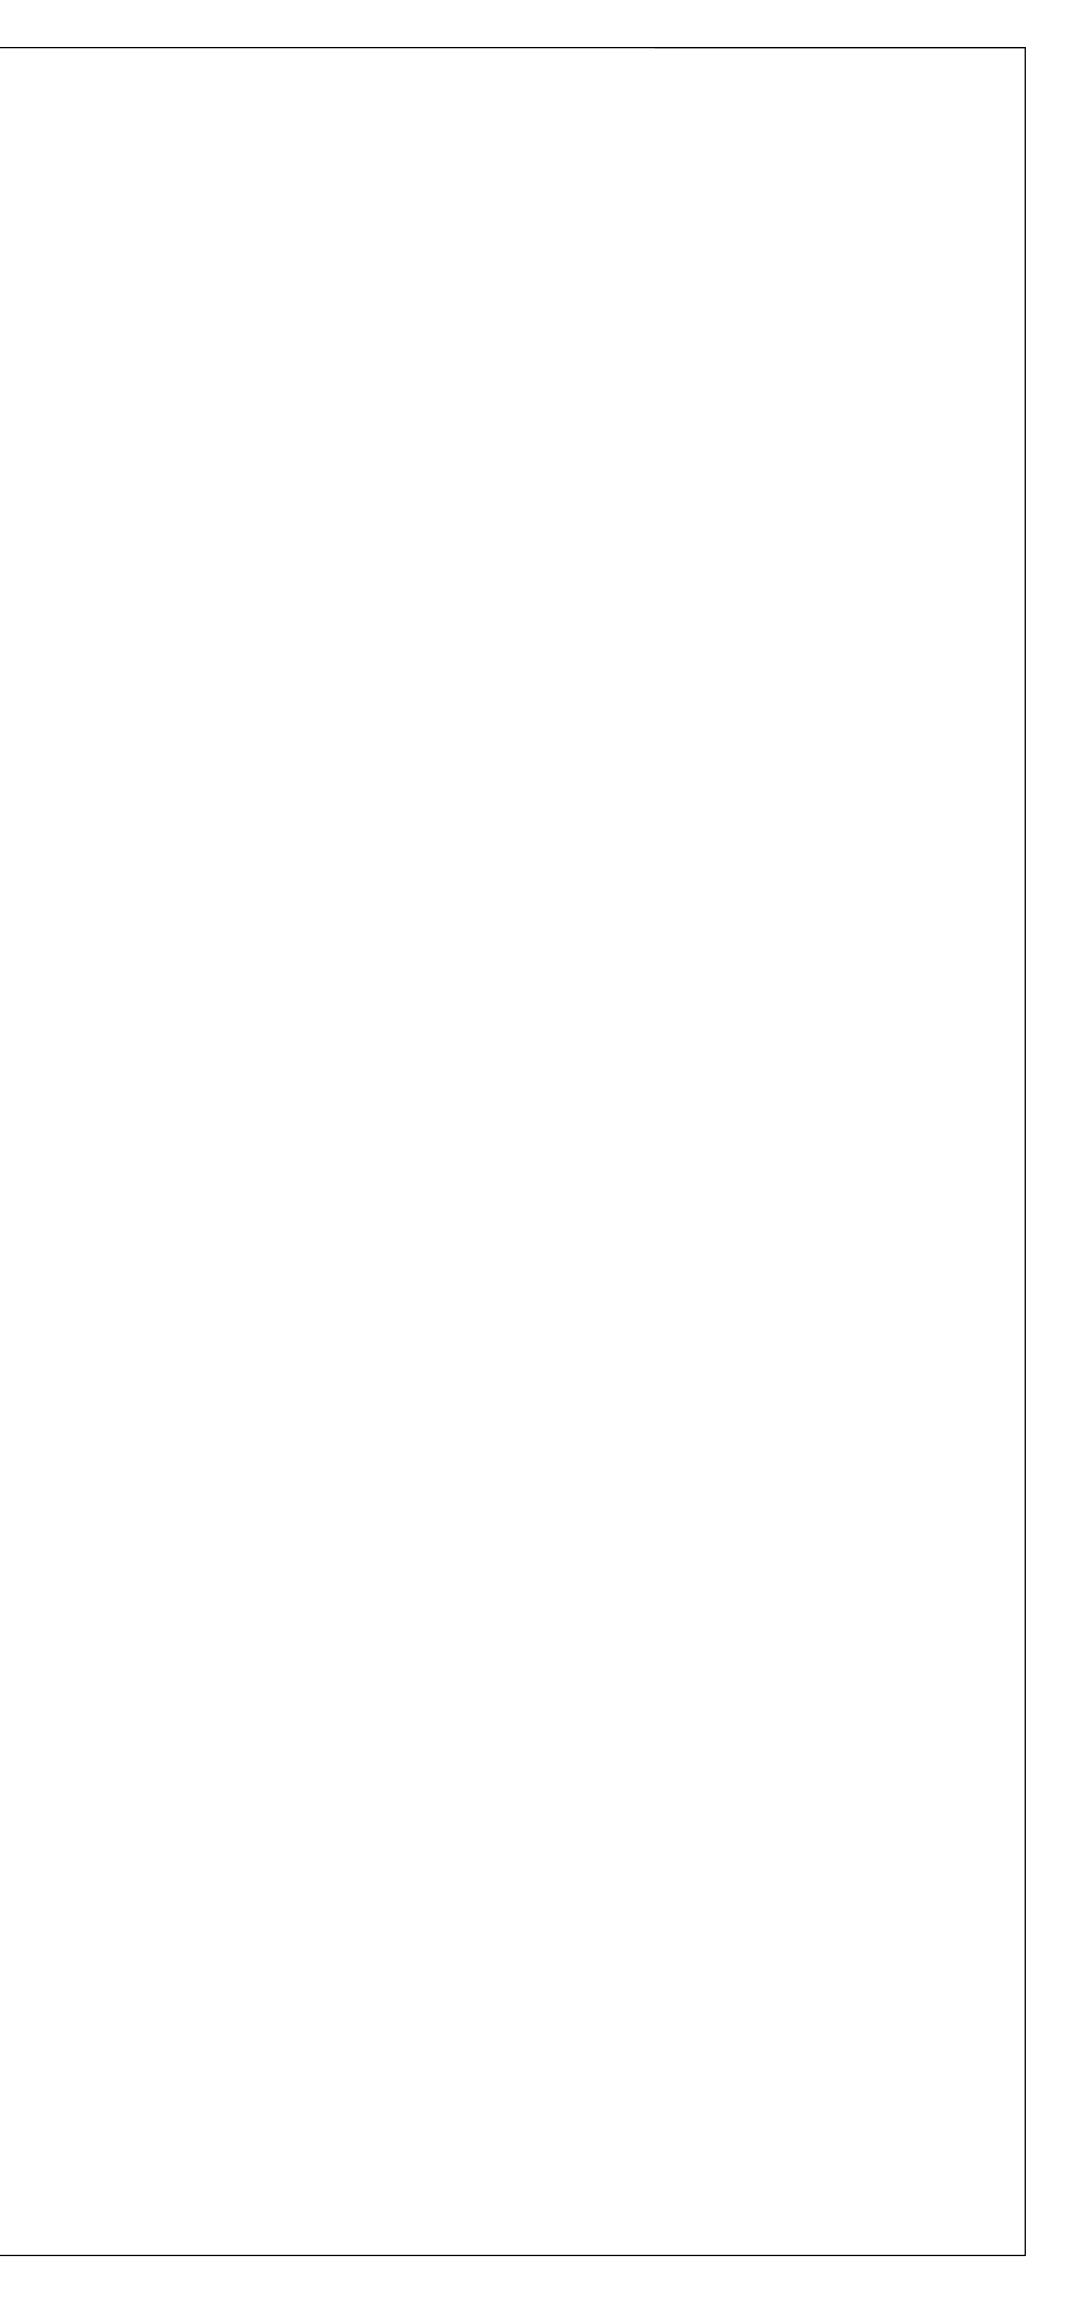

Drawing Index

G-1.0


COVER SHEET DRAWING INDEX-CODE REVIEW


STRUCTURAL DRAWINGS


ARCHITECTURAL DRAWINGS

A-0.0	SITE PLAN
A-1.0	FLOOR PLANS
A-1.1	FRAMNG PLANS
A-2.0	ENLARGED PLANS AND INTERIOR ELEVATIONS
A-3.0	ENLARGED PLANS AND INTERIOR ELEVATIONS
A-4.0	ROOF FRAMING AND ROOF PLAN
A-5.0	ELEVATIONS
A-6.0	SECTIONS DETAILS AND SCHEDULES
A-7.0	WALL SECTIONS
A-8.0	MECHANICAL LAYOUT
A-9.0	ELECTRICAL LAYOUT
A-10.0	PLUMBING LAYOUT

Drawing Conventions

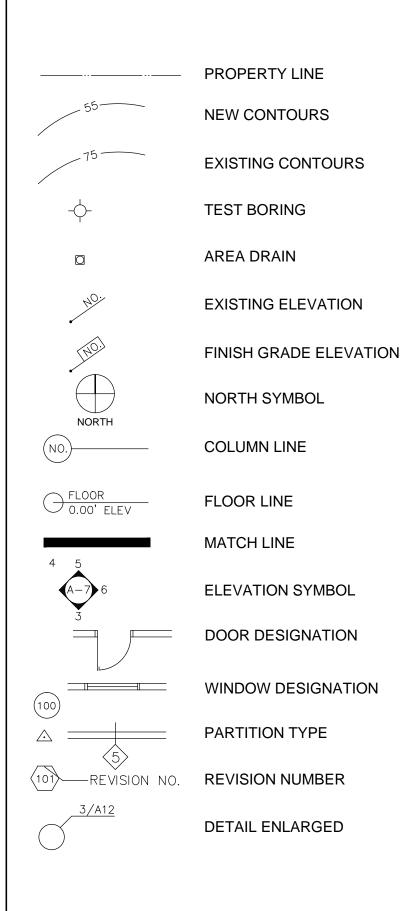

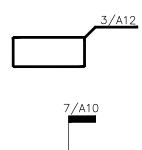

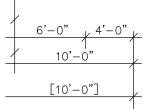

DIMENSIONS all dimensions to face of wall unless otherwise noted BRACKETS

indicate existing dimensions - contractor to field verify.

PLAN OR DETAIL

VERTICAL SECTIONS

ENLARGED

DETAIL AND

Abbreviations

A/C ACP. ACT. A.D. A.D.A.	AIR CONDITIONING ACOUSTICAL PANEL ACOUSTICAL TILE AREA DRAIN AMERICANS WITH DISABILITIES ACT (1990)
ADJ. A.F.F. A.F.G. ALUM ALT. ∠ ASPH.	ADJUSTABLE ABOVE FINISH FLOOR ABOVE FINISH GRADE ALUMINUM ALTERNATE ANGLE ASPHALT
BD. BLDG. BLK. BM. B.U.R.	BOARD BUILDING BLOCK BEAM BUILT-UP ROOF
C CAB, CABT CFMF C.J. Q CLG. C.M.U. COL. COMP. CONC. COND. CONT. CONT. CORR. CPT. CT. CTSK. C.W.	CHANNEL CABINET COLD FORMED METAL FRAMING CONTROL JOINT CENTER LINE CEILING CONCRETE MASONRY UNI COLUMN
D.F. DIA. DIM. D.P. DTL D.S. DWG. EA. EDF	DRINKING FOUNTAIN DIAMETER DIMENSION DAMPPROOFING DETAIL DOWNSPOUT DRAWING EACH ELECTRIC DRINKING FOUNTAIN ELEVATION (HEIGHT)

Code Information

PURPOSE:

CODE:

FLOOR AREA:


BUILDING USE:

FIRE SUPPRESSION:

ACTUAL HEIGHT:

STORIES:

DESIGN LOADS:

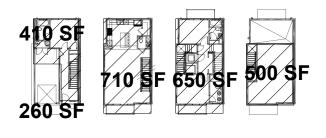

RESIDENTIAL

INTERNATIONAL RESIDENTIAL CODE 2018

410 GAR FLR SF 710 1ST FLR SF 650 2ND FLR SF 1,770 SF TOTAL RESIDENTIAL

NO

34'-0"

3½

SLEEPING ROOMS 30 PSF ROOMS OTHER THAN SLEEPING 40 PSF ATTICS W/STORAGE 20 PSF DECKS 40 PSF

1,770 LIVINNG SF 260 GARAGE 500 ROOF TOP DECK TOTAL 2,770 SF

G NEL E 990) R	ELEC., ELECT. ELEV. E.J. EQ. EQUIP EXIST. EXP. EXT.	ELECTRICAL ELEVATION (DRAWING) EXPANSION JOINT EQUAL EQUIPMENT EXISTING EXPANSION EXTERIOR	GR. GTP GYP. HC HGT. HORIZ. HM H.W.
E	FB. FD. F.E. F.E.C. F.H.C. FIN. FIXT.	FACE BRICK FLOOR DRAIN FIRE EXTINGUISHER FIRE EXTINGUISHER CAB. FIRE HOSE CAB. FINISH FIXTURE	I.D. INSUL. INT. I.P.S. HC HGT.
	FLR. FLSHG. FLUOR	FLOOR FLASHING FLUORESCENT	HORIZ. HM H.W.
	GA. GALV. G.B. GCMU	GAUGE GALVANIZED GRAB BAR GLAZED CONCRETE MASONRY UNIT(S)	I.D. INSUL. INT. I.P.S. JT.
(UNIT	GEN. G.I. GL. GR. GTP. GYP.	GENERAL GALVANIZED IRON GLASS GRADE GLAZED TILE PAVER(S) GYPSUM	LAM. LAV. L.P. LT LT. WT.
	FB FD F.E. F.E.C. F.H.C. FIN. FIN. FLR. FLSHG.	FACE BRICK FLOOR DRAIN FIRE EXTINGUISHER FIRE EXTINGUISHER CAB. FIRE HOSE CAB. FINISH FIXTURE FLOOR FLASHING	MANUF., MFF MAS. MATL. MAX. MB MECH. MEM. W.P MEP MEZZ.
	FLUOR GA. GALV. G.B. GCMU GEN. G.I. GL.	FLUORESCENT GAUGE GALVANIZED GRAB BAR GLAZED CONCRETE MASONRY UNIT(S) GENERAL GALVANIZED IRON GLASS	MLZZ. M.H. MIN. MISC. M.O. MOD. MTL. MTP.

	GRADE GLAZED TILE PAVER(S) GYPSUM HANDICAPPED ACCESSIBLE HEIGHT HORIZONTAL HOLLOW METAL FRAME HOT WATER
	INSIDE DIAMETER INSULATION INTERIOR IRON PIPE SIZE
	HANDICAPPED ACCESSIBLE HEIGHT HORIZONTAL HOLLOW METAL FRAME HOT WATER
	INSIDE DIAMETER INSULATION INTERIOR IRON PIPE SIZE
	JOINT
	LAMINATE LAVATORY LIGHTPOLE LIGHT WEIGHT
IFR.	MANUFACTURER MASONRY MATERIAL MAXIMUM MARKER BOARD MECHANICAL
Ρ.	MEMBRANE WATERPROOFING MECHANICAL, ELECTRICAL & PLUMBING MEZZANINE MANHOLE MINIMUM MISCELLANEOUS MASONRY OPENING MODULE METAL METAL TOILET PARTITIONS

	NAPKIN DISPOSAL NOT IN CONTRACT NUMBER NOT TO SCALE NAPKIN VENDOR
0.C. 0.D. 0.F.C.I. 0H. 0PNG. 0PP.	ON CENTER OUTSIDE DIAMETER OWNER FURNISHED CONTRACTOR INSTALLED OPPOSITE HAND OPENING OPPOSITE
PLUMB.	PRECAST PAPER HOLDER PLATE PROPERTY LINE PLASTIC LAMINATE PLUMBING PLYWOOD POLISHED POWER POLE PAIR POINT PAINTED PREFINISHED WALL BOARD
QT.	QUARRY TILE
R RD. RECP. RECP. REINF. RES. REQ., REQD. REV. RF	RADIUS ROOF DRAIN REFERENCE RECEPTACLE REINFORCE RESILIENT REQUIRED REVISED RECREATIONAL RESILIENT FLOORING
RPG. RSS.	RELOCATABLE PAINTED GYPSUM BOARD ROD STOCK AND SEALANT
SC.	SEALED CONCRETE SCHEDULE(D) SOLID CORE PLASTIC LAMINATE SOAP DISPENSER SECTION SHEET


SQ. SS. SS, ST. STL. STL. STR., STRUCT.	SIMILAR SPECIAL COATING SYSTEM SPECIFICATIONS SQUARE SOUND STRIP STAINLESS STEEL STEEL STRUCTURAL STRUCTURAL SUSPENDED SHEET VINYL FLOORING SHEET VINYL FLOORING SHEET VINYL FLOORING SHEET VINYL DANCE FLOORING TACK BOARD TELEPHONE TERRAZZO THICK TOP OF TOP OF WOOD BLOCKING TOP OF STEEL TOILET TISSUE DISPENSER TYPICAL
U.N.O. UR. V V.C.T. VENT. VER. VERT.	UNLESS NOTED OTHERWISE URINAL VENT VINYL COMPOSITION TILE VENTILATING VERIFY VERTICAL
V.I.F. VWC W/ W.C. WD. WDW. W.P. W.S. WT. W.W. W.W.F.	VERIFY IN FIELD VINYL WALL COVERING WITH WATER CLOSET WOOD WINDOW WATERPROOFING WEATHERSTRIP WEIGHT WATER WELL WELDED WIRE FABRIC







Site Location Map

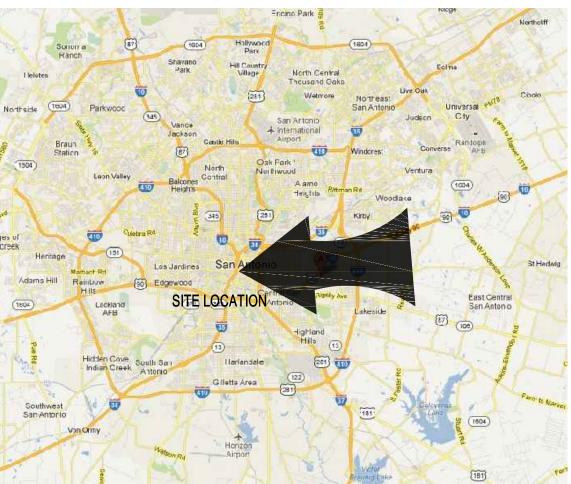


LOCATION MAP

NOT TO SCALE ADDRESS: 140 UNIVERSITY AVE SAN ANTONIO, TX. 78201 **LEGAL DESCRIPTION:** N.C.B. 2045 BLOCK 7 LOTS 15 8736 SF 0.2006 ACRES

Material Conventions

EARTH FILL
BRICK
CONCRETE MASONRY UNIT
CAST-IN-PLACE CONCRETE
STEEL
CERAMIC TILE
GYPSUM BOARD
PLASTER
PLYWOOD
FINISHED WOOD
ACOUSTICAL TILE
RIGID INSULATION
BATT INSULATION
WOOD BLOCKING
WOOD FRAMING

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Y.E.S TOWNHOMES 142 UNIVERSITY SAN ANTONIO, TX 78201
No.: Revision/Issue: Date:
Sheet Name: DRAWING INDEX Drawn By: JS Date: 03/20/20 Checked By: G-1.0 Sheet Date: Project No.: Project No.: Sheet:

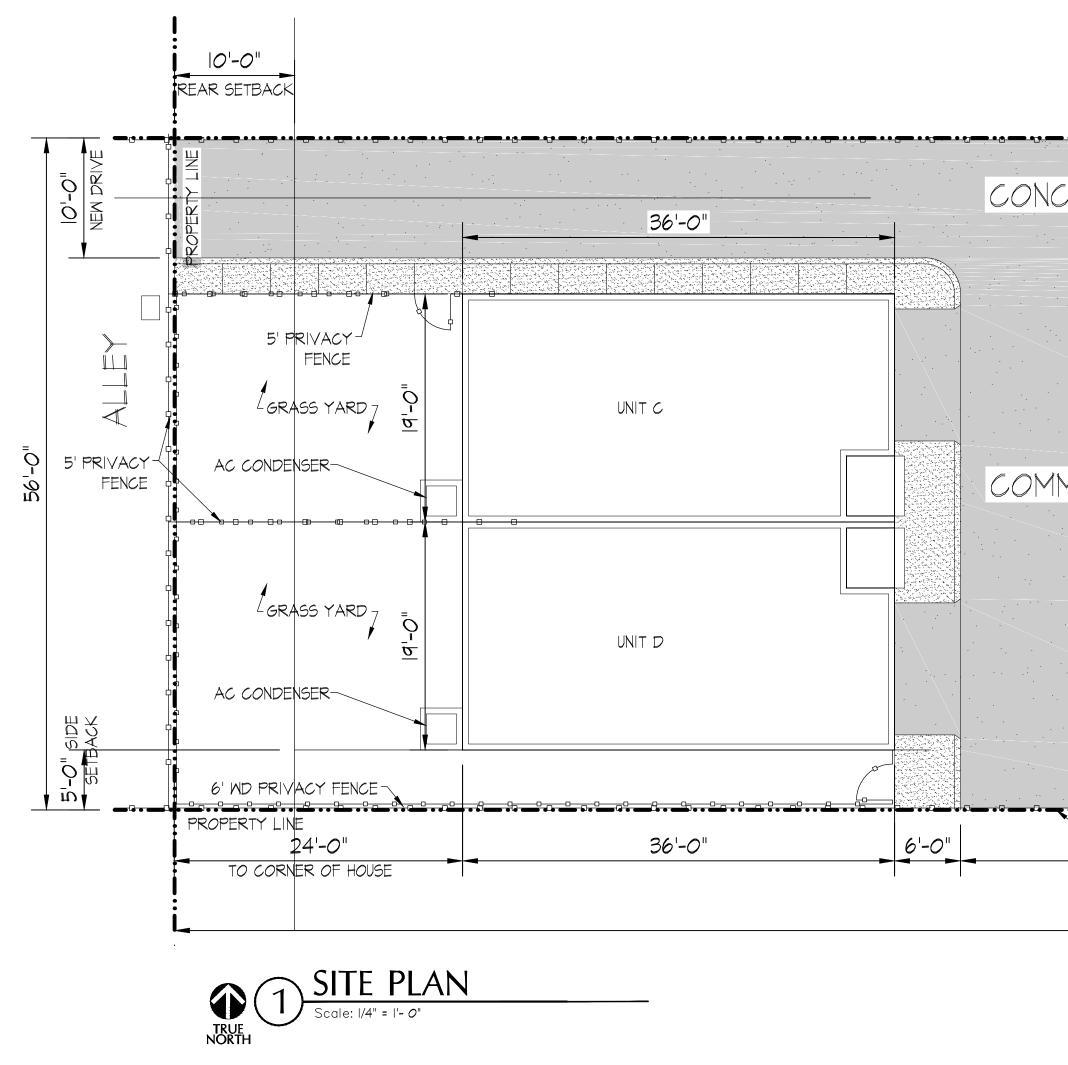

-6' WD PRIVACY FENCE		24'-0" TO CORNER OF HOUSE IO'-O" FRONT SETBACK PROPERTY LINE	-60" TALL VEHICLE GATE
CRETE DRIVE	NEW SIDEWALK -	5ETBACK	100 13'-0
IMON DRIVE	UNIT A	5' PRIVACY FENCE GRASS TARD AC CONDENSER	AUTOMATIC GATE OPERATOR EXISTING SIDEWALK 5' PRIVACY
	UNIT B	GRASS YARD GRASS YARD AC CONDENSER	
6' MD PRIVACY FENCE 24'-0" 156'-0"	<u></u>	24'-0" TO CORNER OF HOUSE	

- I. DO NOT SCALE DRAWINGS. IF DIMENSIONS ARE IN QUESTION, OBTAIN CLARIFICATION FROM THE ARCHITECT BEFORE CONTINUING THE WORK.
- 2. CONTRACTOR SHALL VISIT PROJECT SITE TO FAMILIARIZE THEMSELVES WITH THE SCOPE OF WORK, AND TO FIELD VERIFY EXISTING CONDITIONS PRIOR TO BIDDING. ANY AMBIGUOUS ITEMS OR DISCREPANCIES SHALL BE BROUGHT TO THE ATTENTION OF THE ARCHITECT IN WRITING PRIOR TO BIDDING.
- 3. VERIFY DIMENSIONS WITH ARCHITECT.
- 4. FLOOR PLAN INTERIOR DIMENSIONS ARE TO THE FACE OF WOOD STUD.
- 5. PROVIDE BLOCKING AS REQUIRED FOR PROPER SUPPORT OF WALL AND CEILING MOUNTED EQUIPMENT.
- 6. WHERE WALL TYPES OF DIFFERENT THICKNESS ADJOIN IN THE SAME LOCATIONS, ALIGN THE FACE OF EXPOSED GYPSUM BOARD FLUSH.
- 7. ALL DOOR JAMB ROUGH OPENINGS TO BE 4" FROM ADJACENT WALL HINGE SIDE, U.N.O.
- 8. UTILIZE MOISTURE RESISTANT G.W.B. IN KITCHENS AND BATHROOMS.
- 9. BATHROOM FANS TO BE VENTED TO EXTERIOR.
- IO. ALL INTERIOR WALLS TO HAVE I/2" G.W.B AND ALL CEILINGS TO HAVE I/2" NON SAG G.W.B U.N.O.

GENERAL NOTES:

OTHERWISE.

I. ALL CASED OPENINGS SHALL HAVE SAME CASING HEIGHTS AS OPENINGS WITH DOORS.

2. ALL WALLS SHALL BE 2X4 UNLESS NOTED

3. ALL WINDOWS HEADERS TO BE @ 87 % "A.F.F. UNLESS NOTED OTHERWISE.

5. THIN SET ALL CERAMIC TILE OVER 5 PLY BC $\frac{5}{6}$ " UNDER-LAYMENT.

7. PROVIDE MINIMUM 4" RETURNS AT ALL OPENINGS.

8. ALL ANGLED WALLS TO BE 45 DEGREES UNLESS

9. ALL HANDRAILS SHALL HAVE A CROSS SECTION OF

IO. ALL GUARDRAILS AND HANDRAILS AT THE SIDE OF STAIRS TO BE AT 34" ABOVE NOSING.

II. ALL GUARDRAILS AT THE SIDE OF OPENINGS TO BE A MINIMUM OF 37" A.F.F.

4. ALL WINDOWS SHALL BE TRIMMED PER SPECIFICATION ON INTERIOR ELEVATIONS.

6. SET ALL TUBS ON 90# FELT.


1 1/4" MINIMUM TO 2" MAXIMUM.

NOTED OTHERWISE.

Dillard Architect Group Dillard Architect Group San Antonio, Texas (10) 531-0050 office (210) 531-0074 fax dillarchgrp@att.net
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No.: Revision/Issue: Date:
Sheet Name:
Drawn By: JS Date: 03/31/20 Sheet No.: Checked By:


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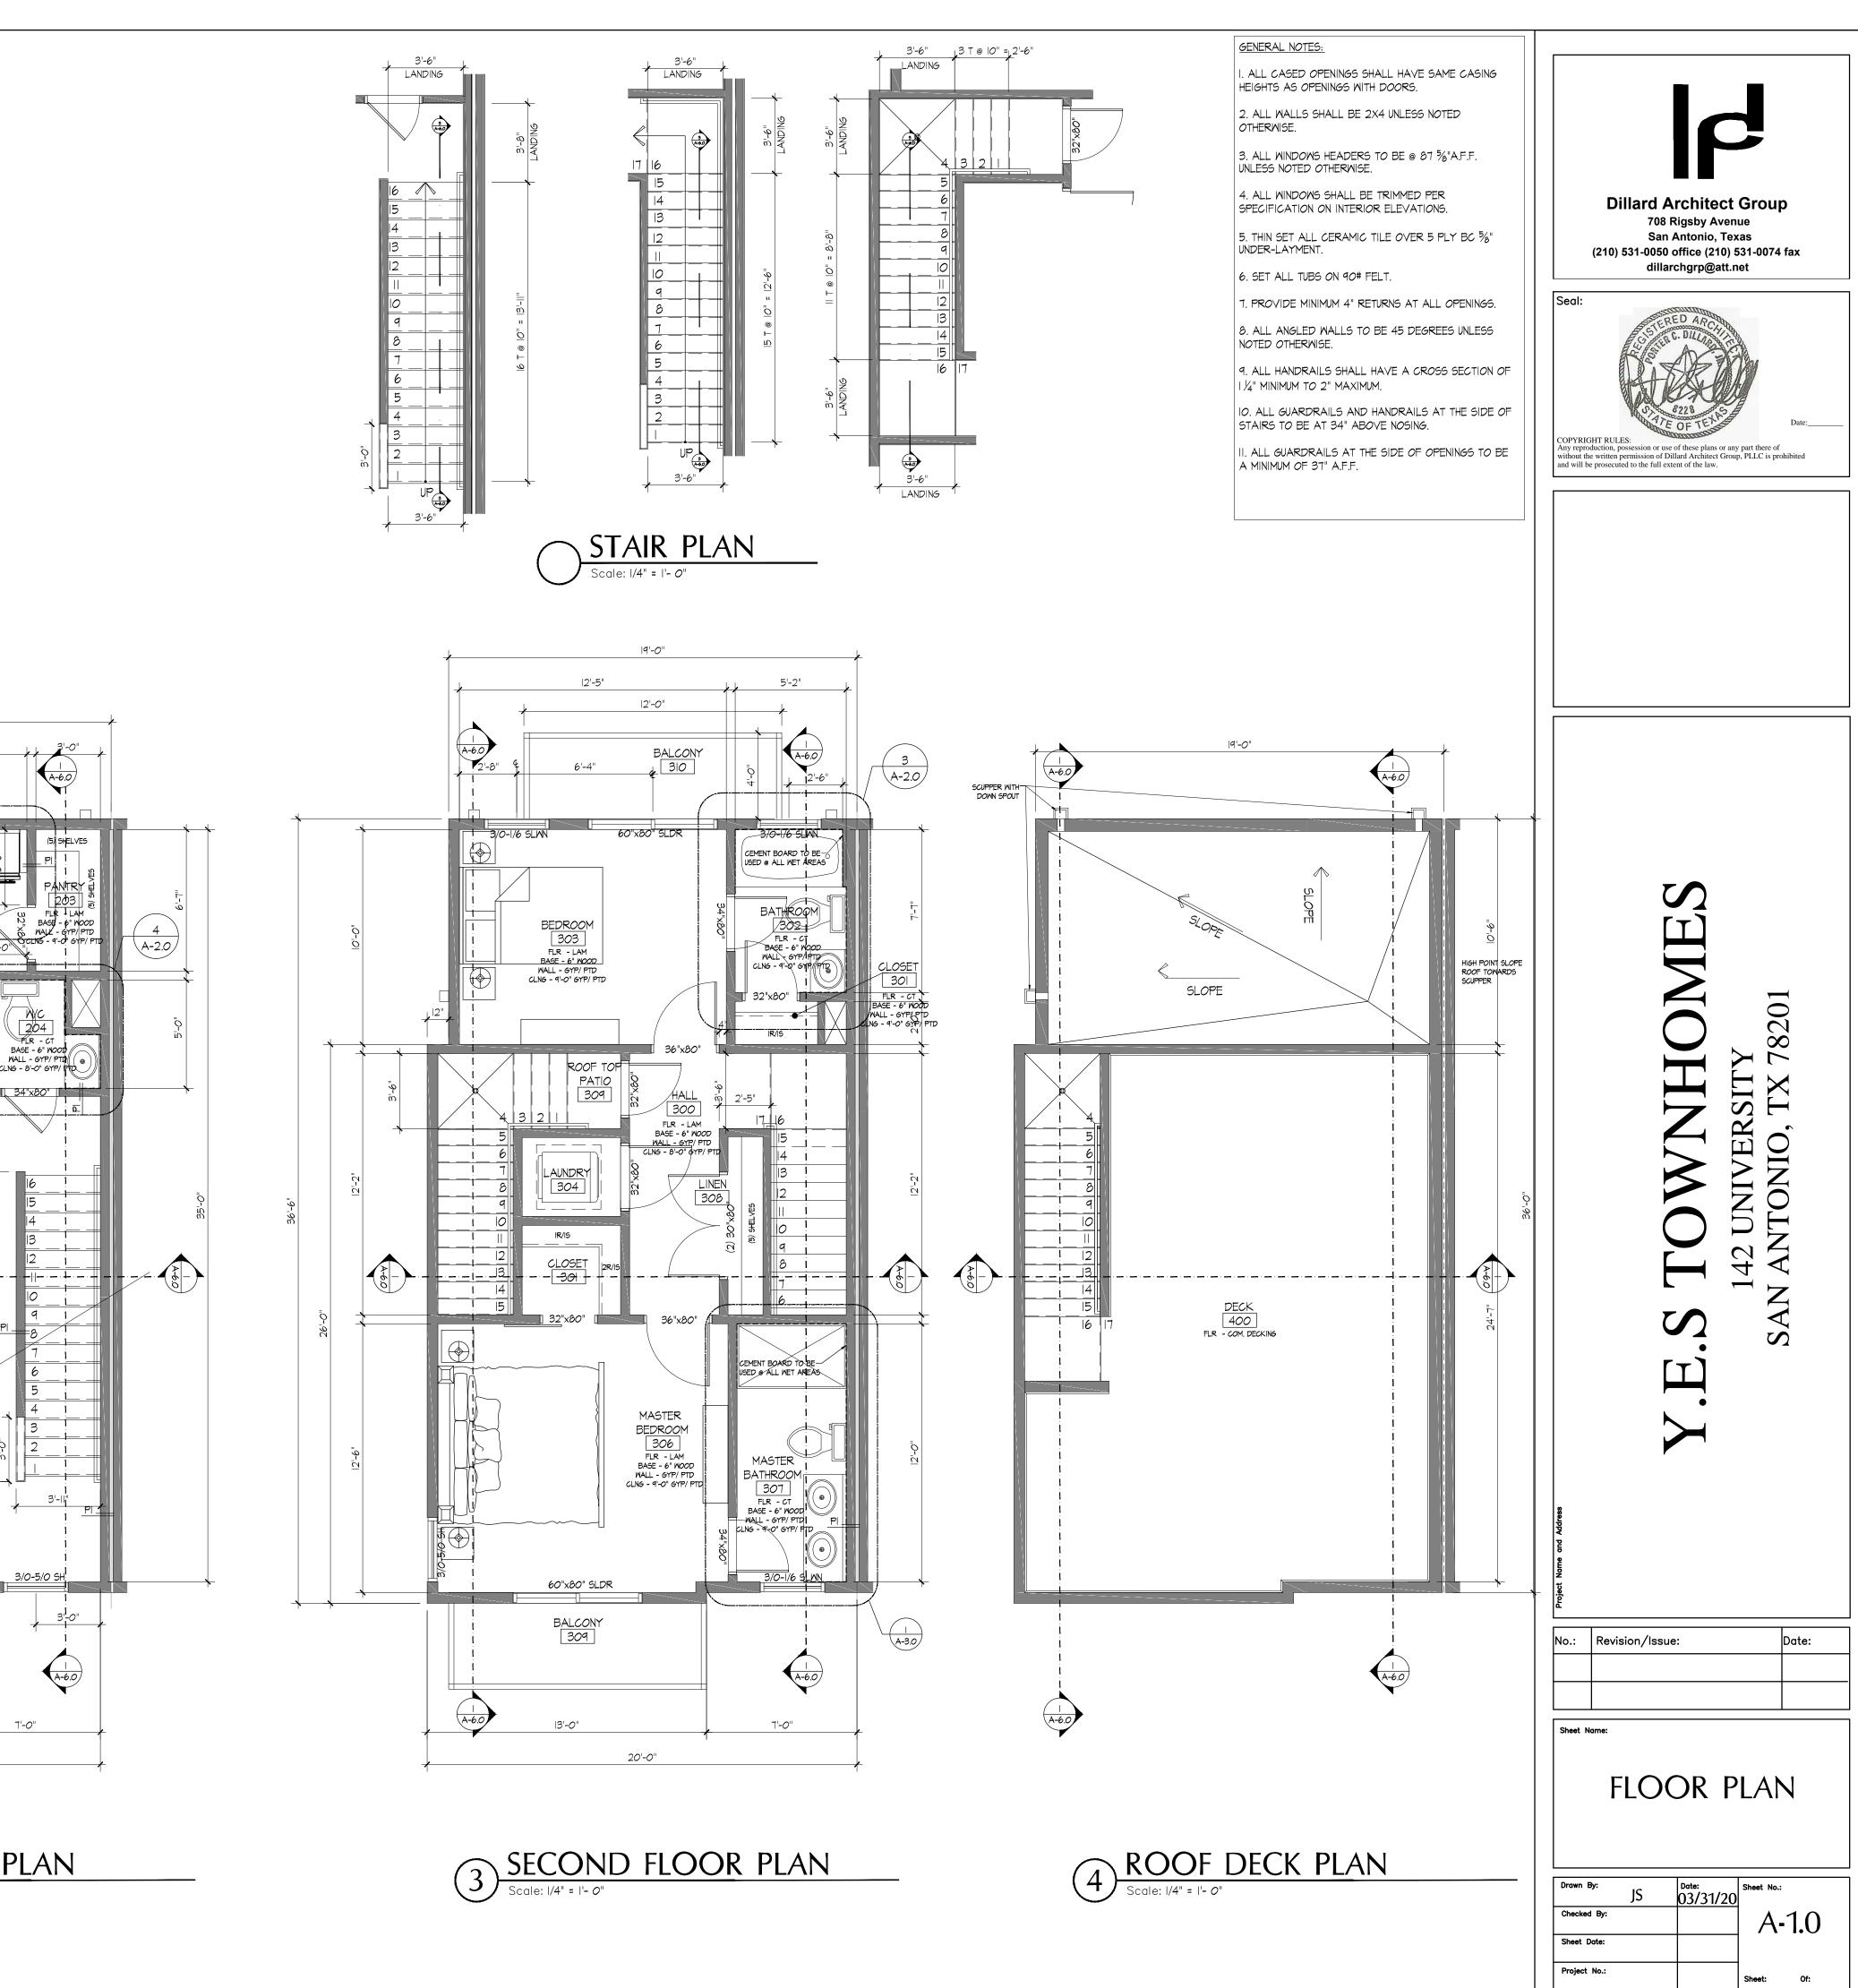


GARAGE LEVEL PLAN Scale: I/4" = I'- 0"

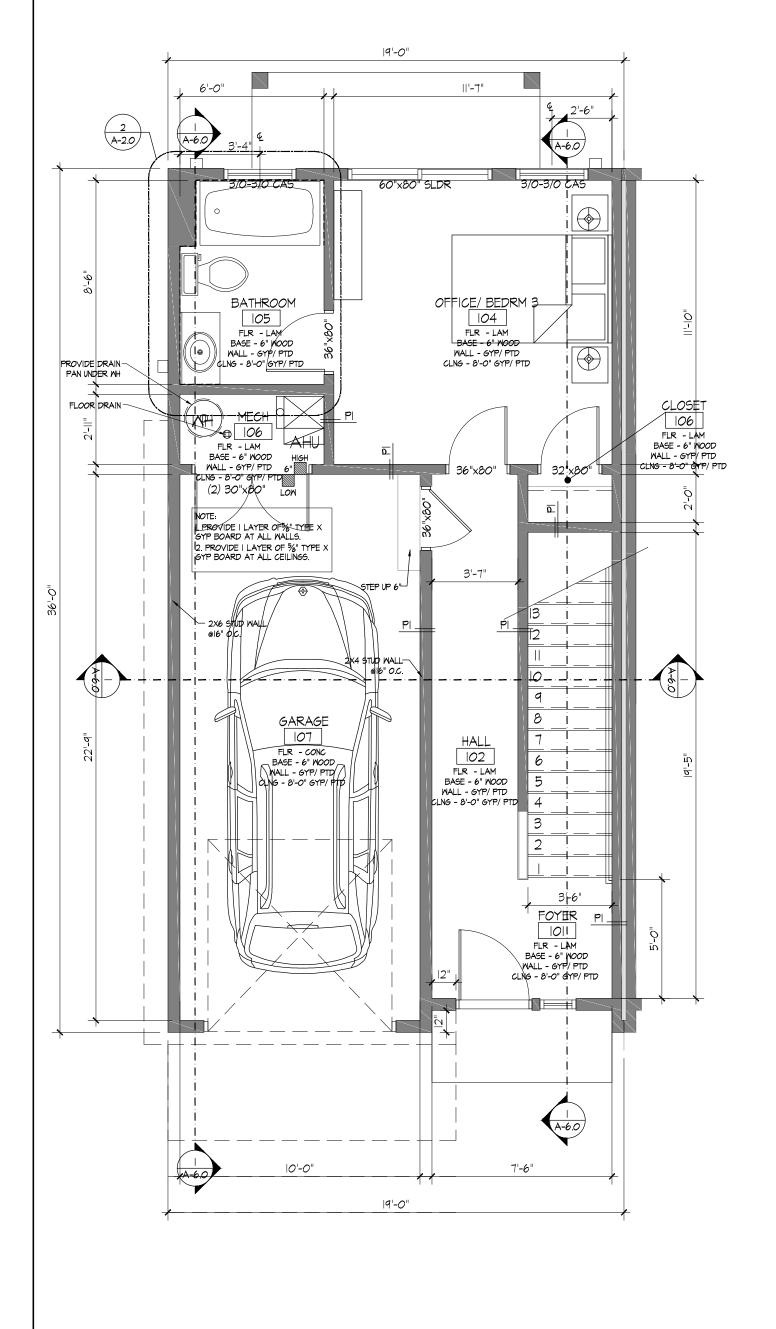 $\widehat{1}$






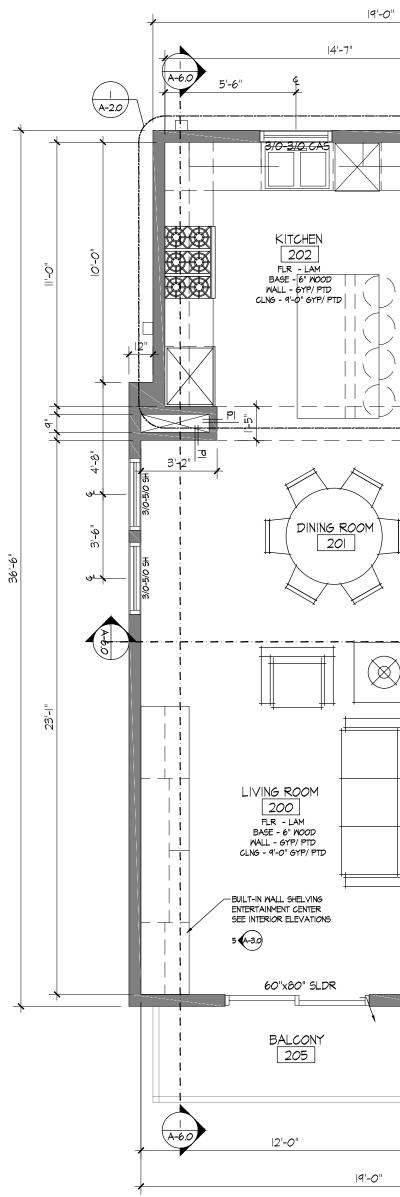

7'-0"

 \bigotimes

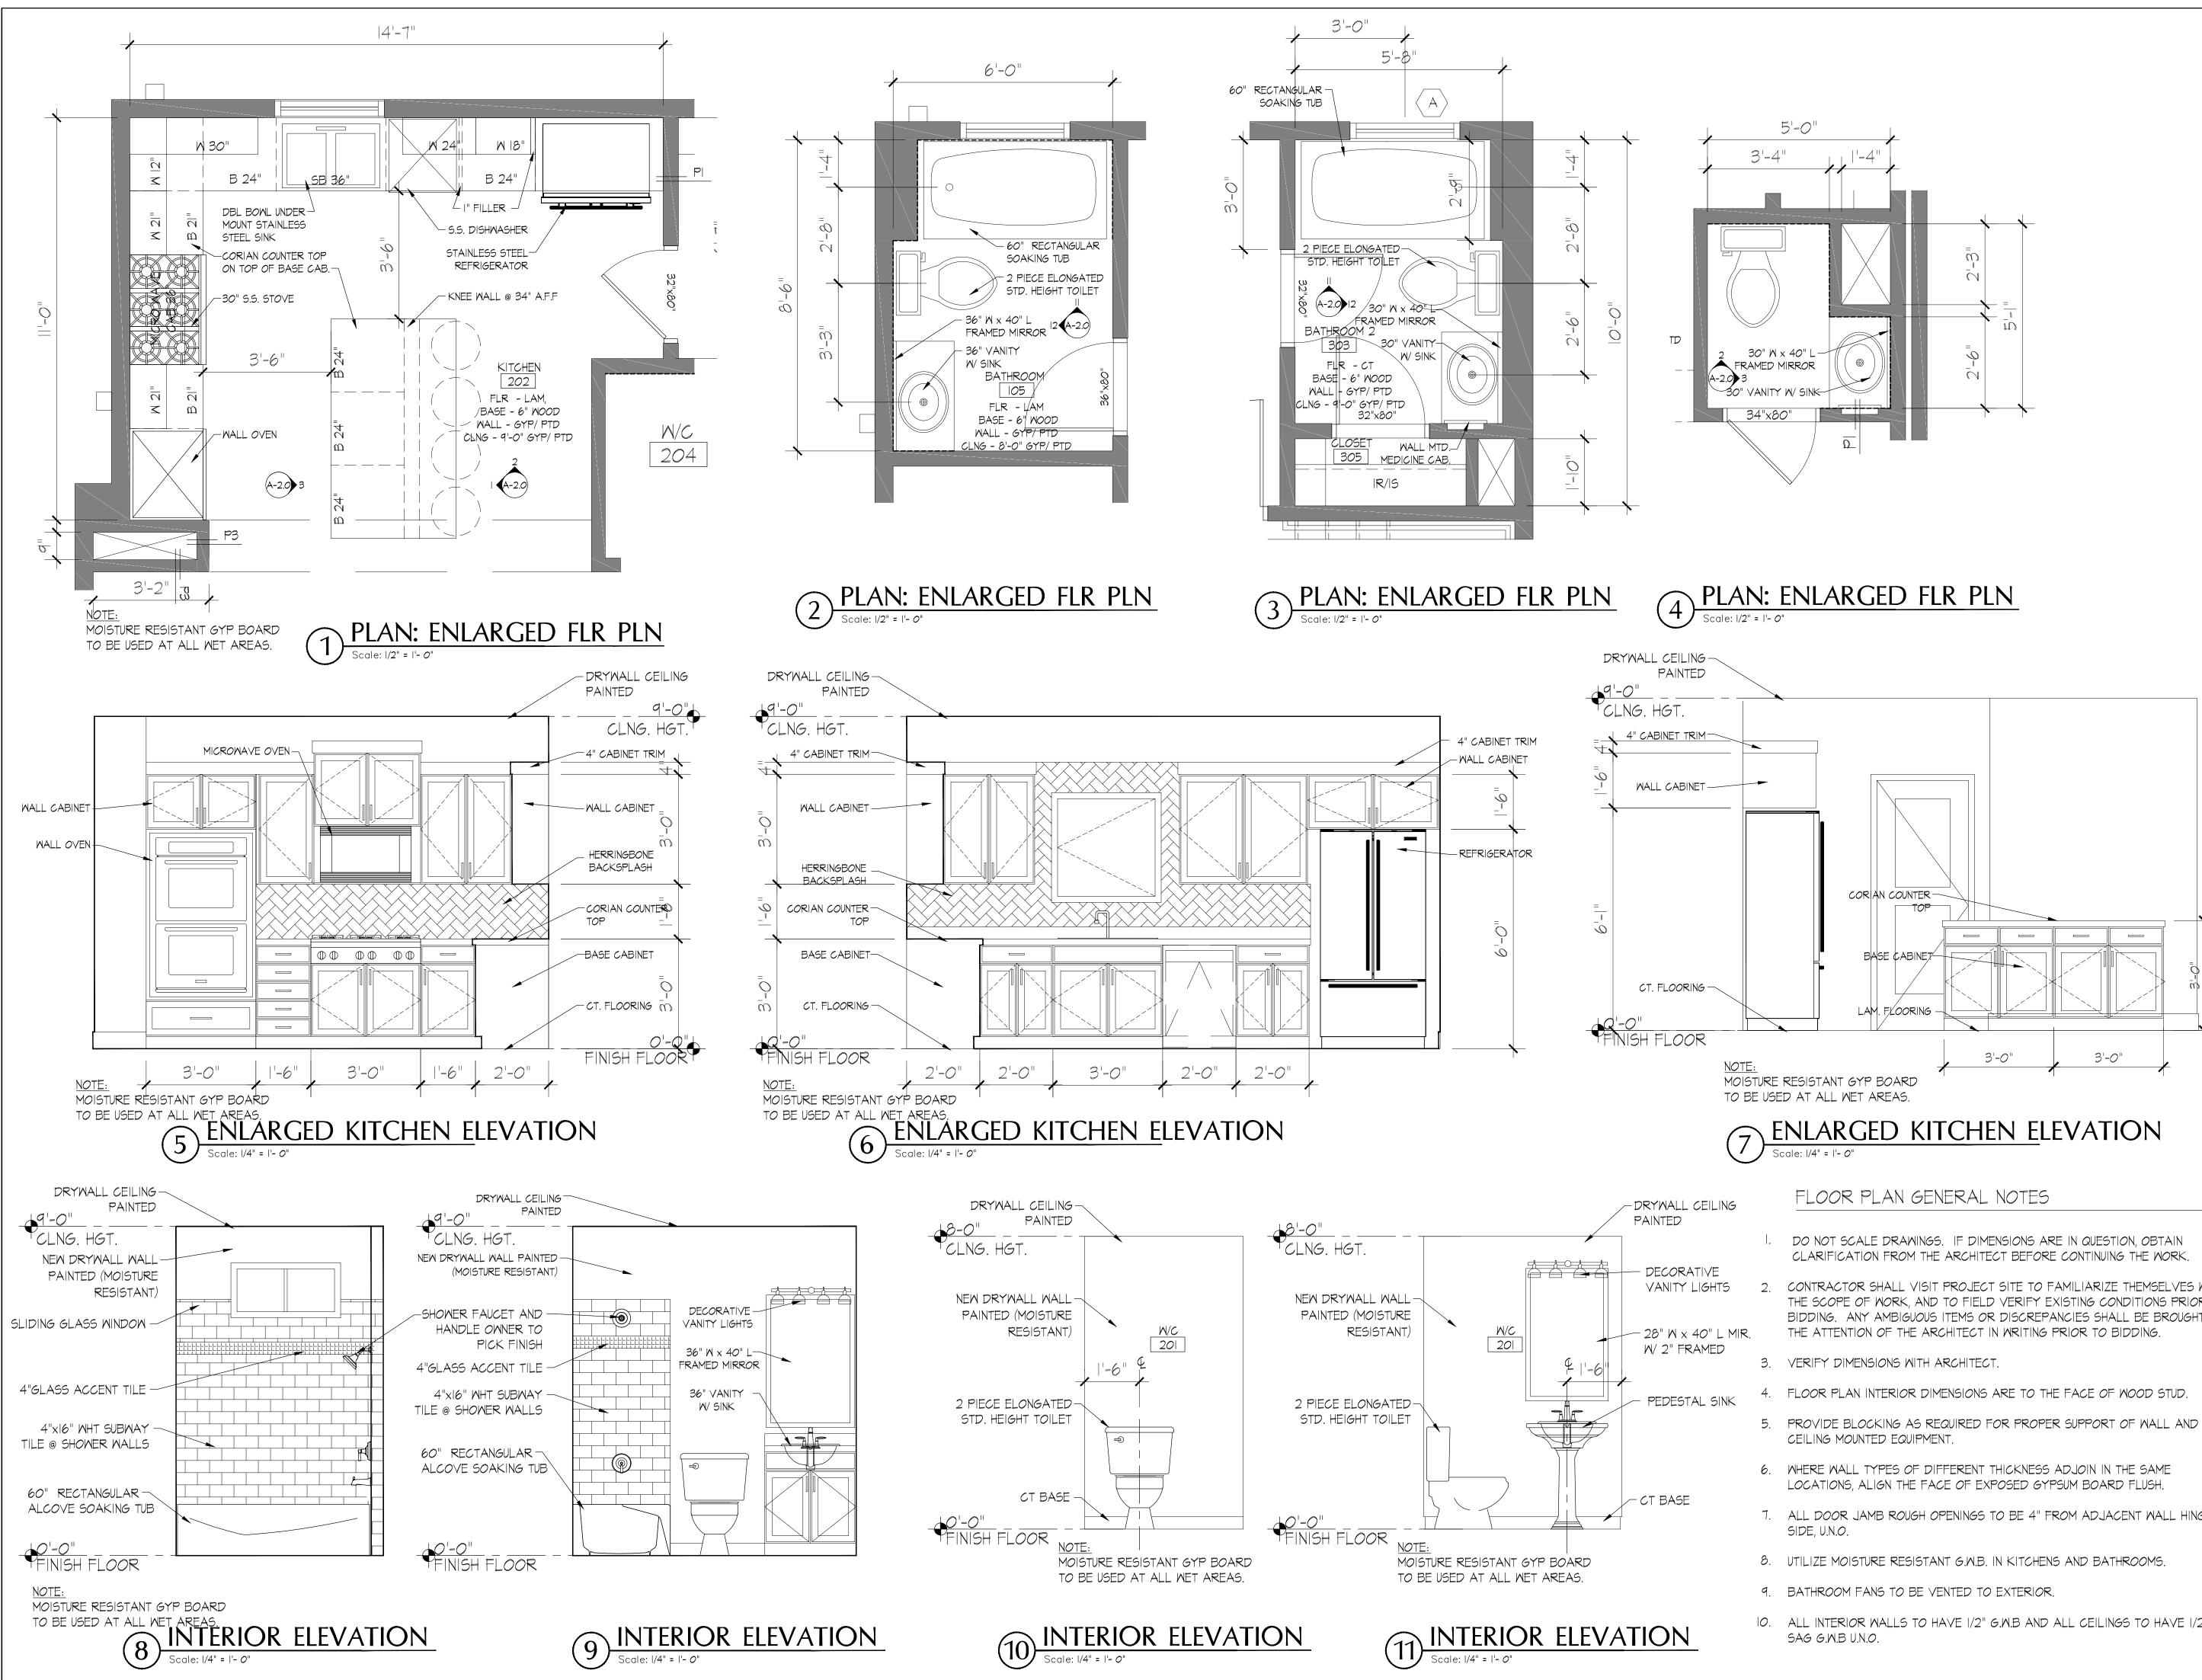



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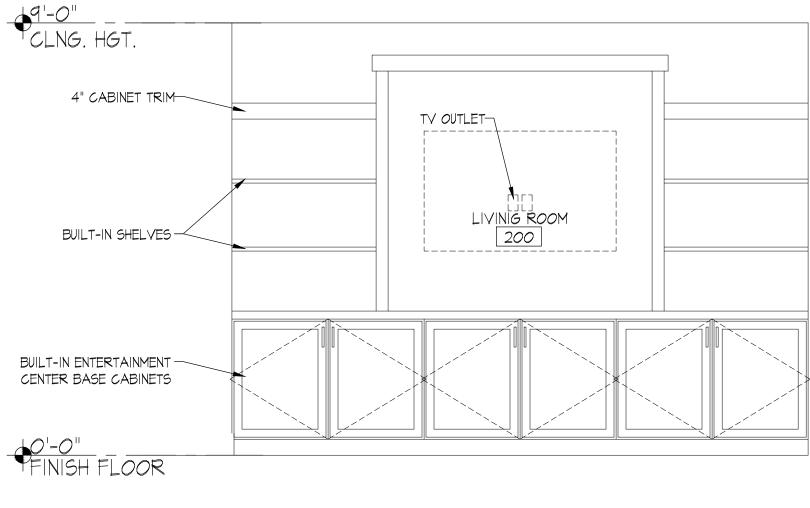
- 7. ALL DOOR JAMB ROUGH OPENINGS TO BE 4" FROM ADJACENT WALL HINGE

- 10. ALL INTERIOR WALLS TO HAVE 1/2" G.W.B AND ALL CEILINGS TO HAVE 1/2" NON

<image/>
Poict from and Address TOWNHOMES 142 UNIVERSITY SAN ANTONIO, TX 78201
No.: Revision/Issue: Date:
Sheet Name: ENLARGED PLAN & INTERIOR ELEVATIONS
Drawn By: JS Date: 03/30/20 Sheet No.: Checked By: A-2.0 Sheet Date: Sheet: Of:




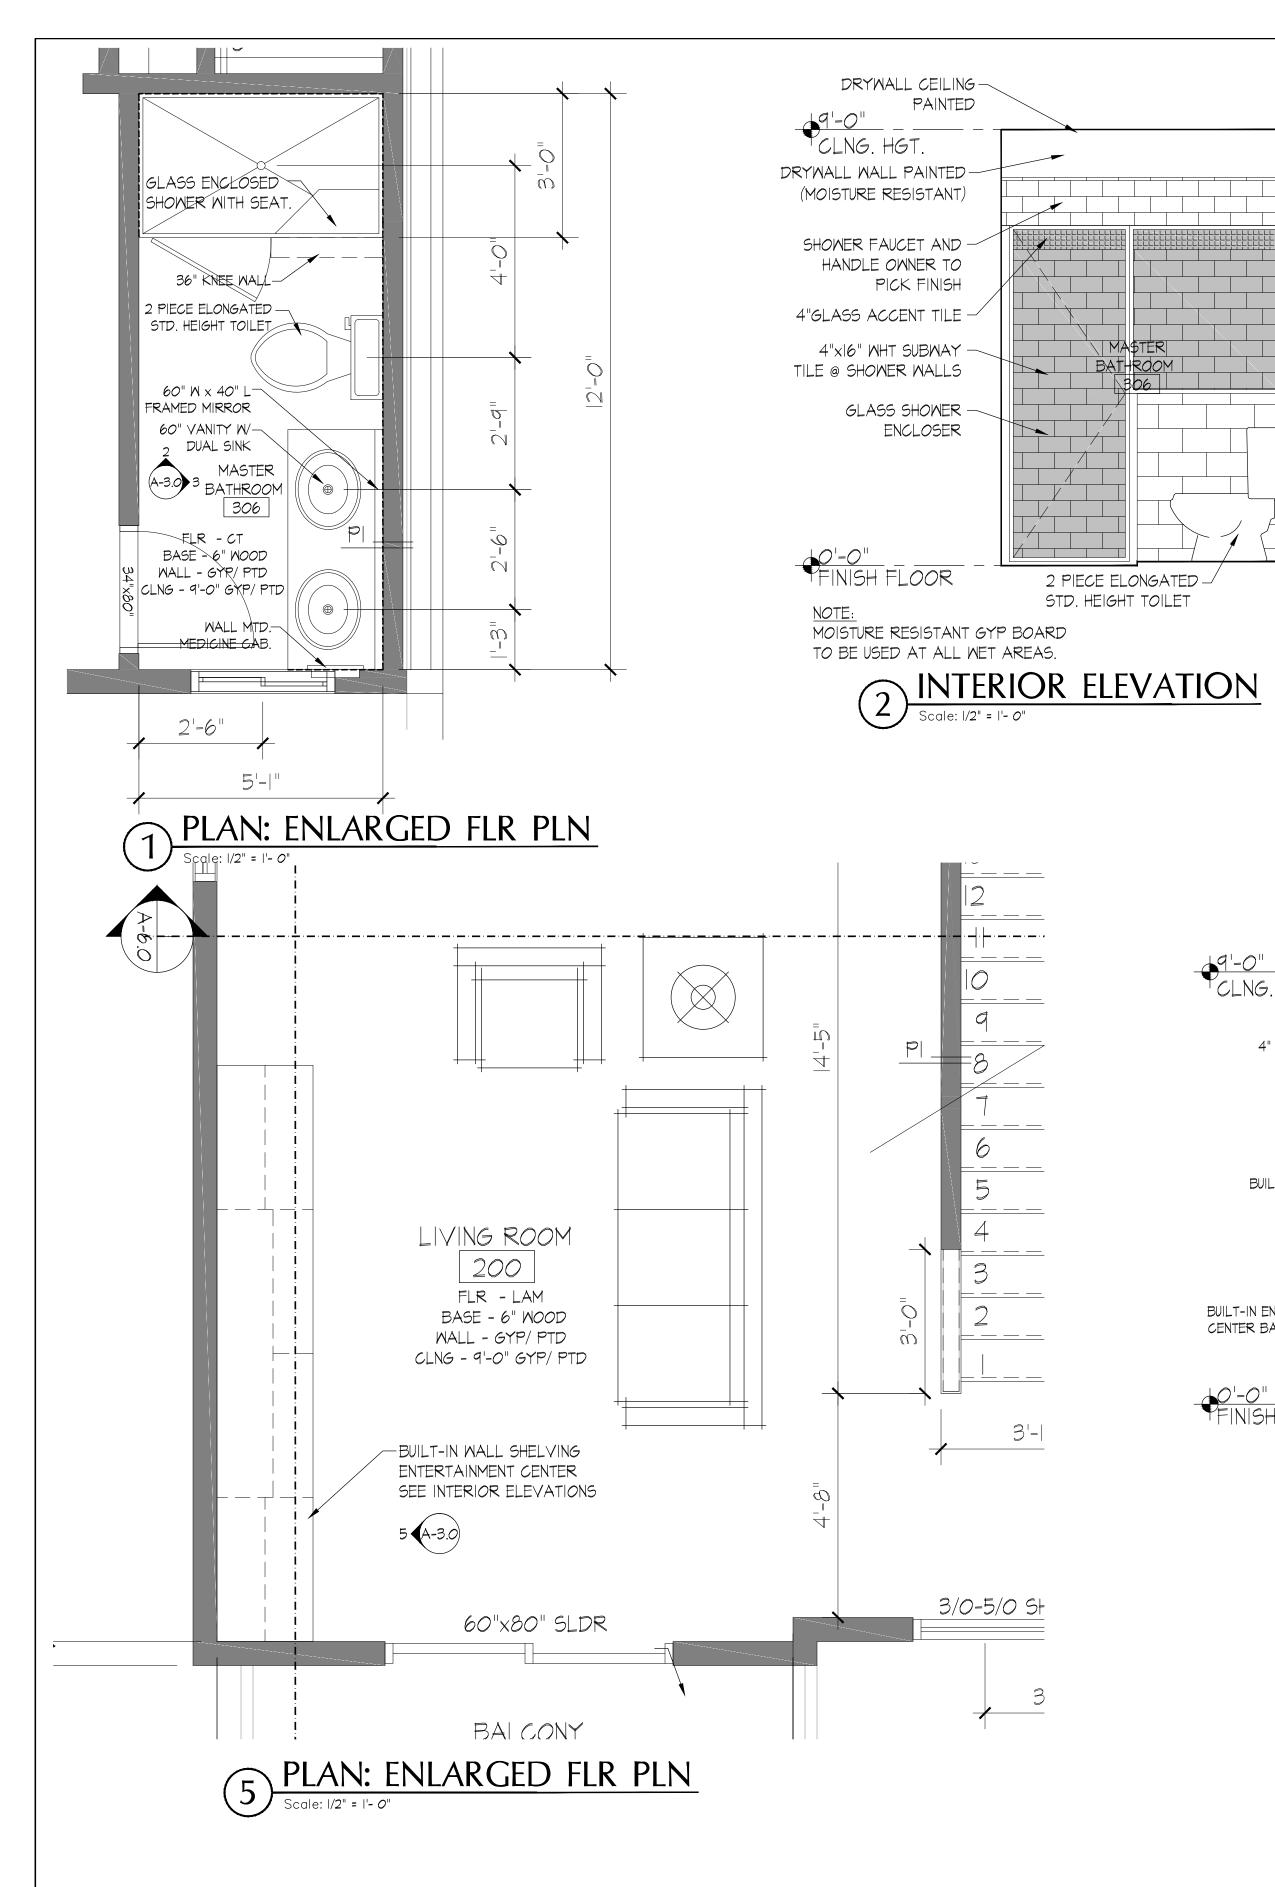

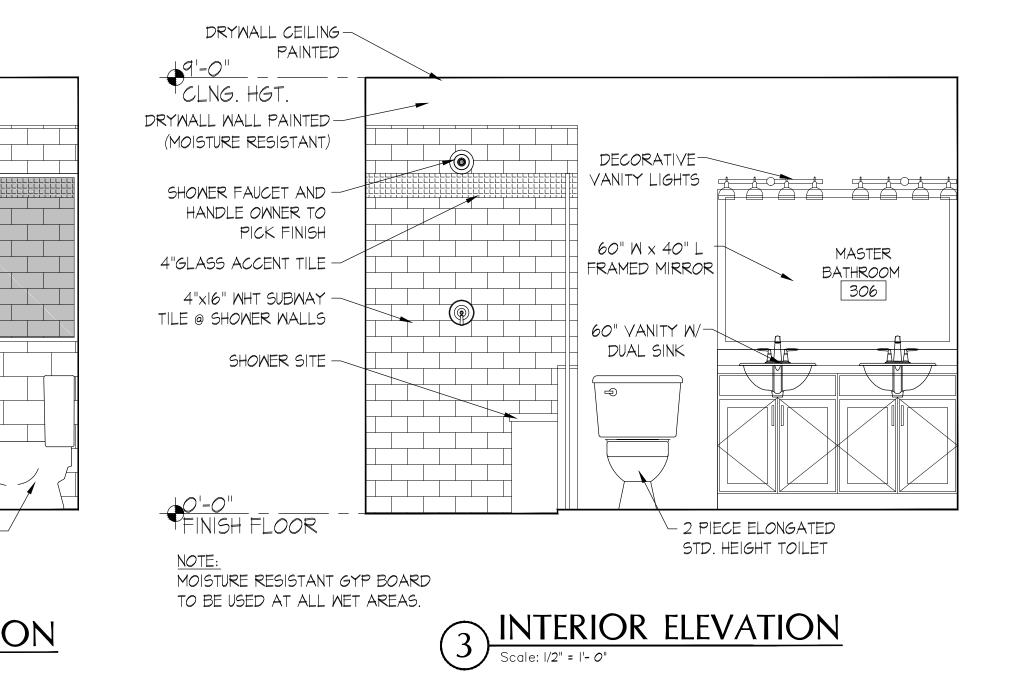




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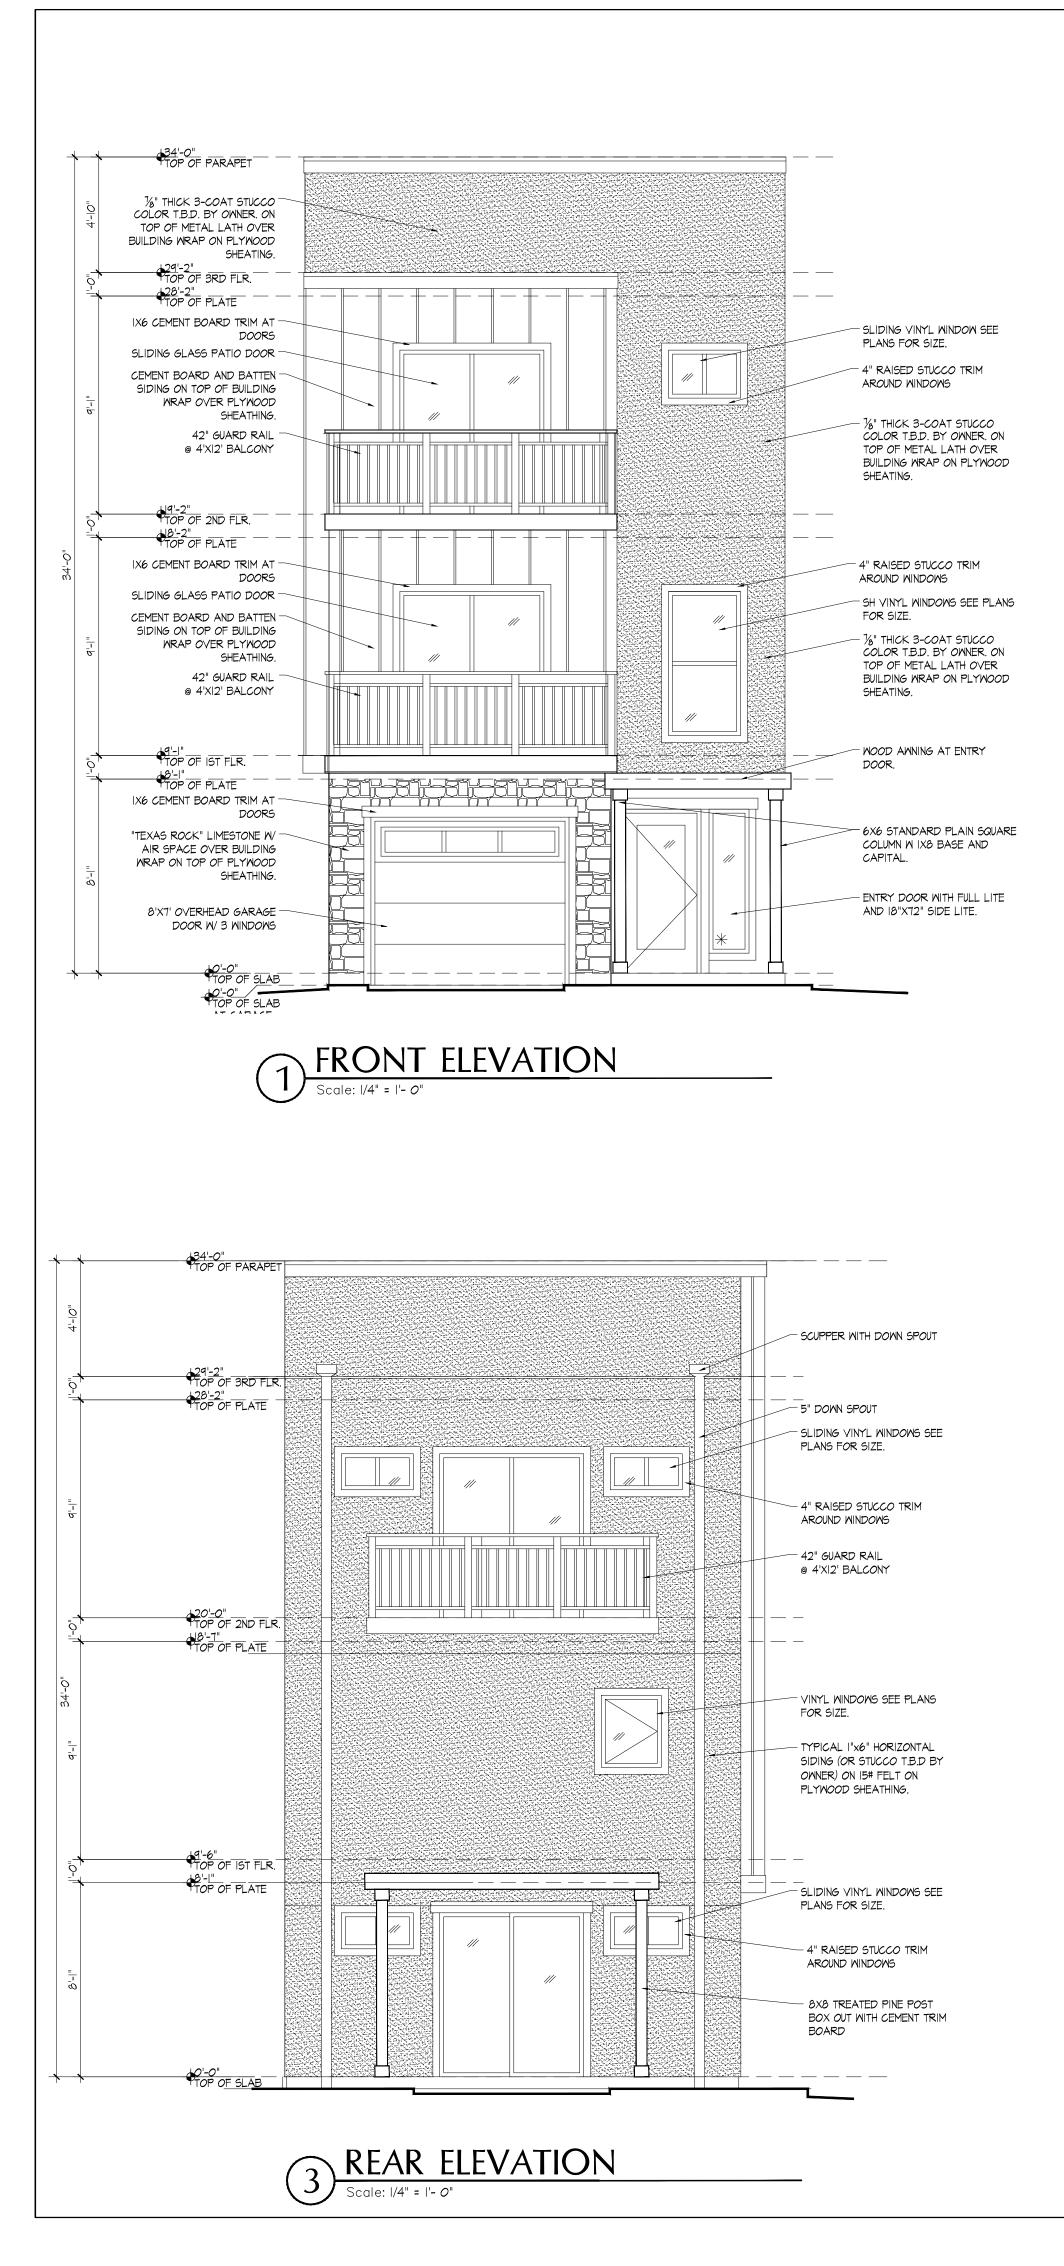


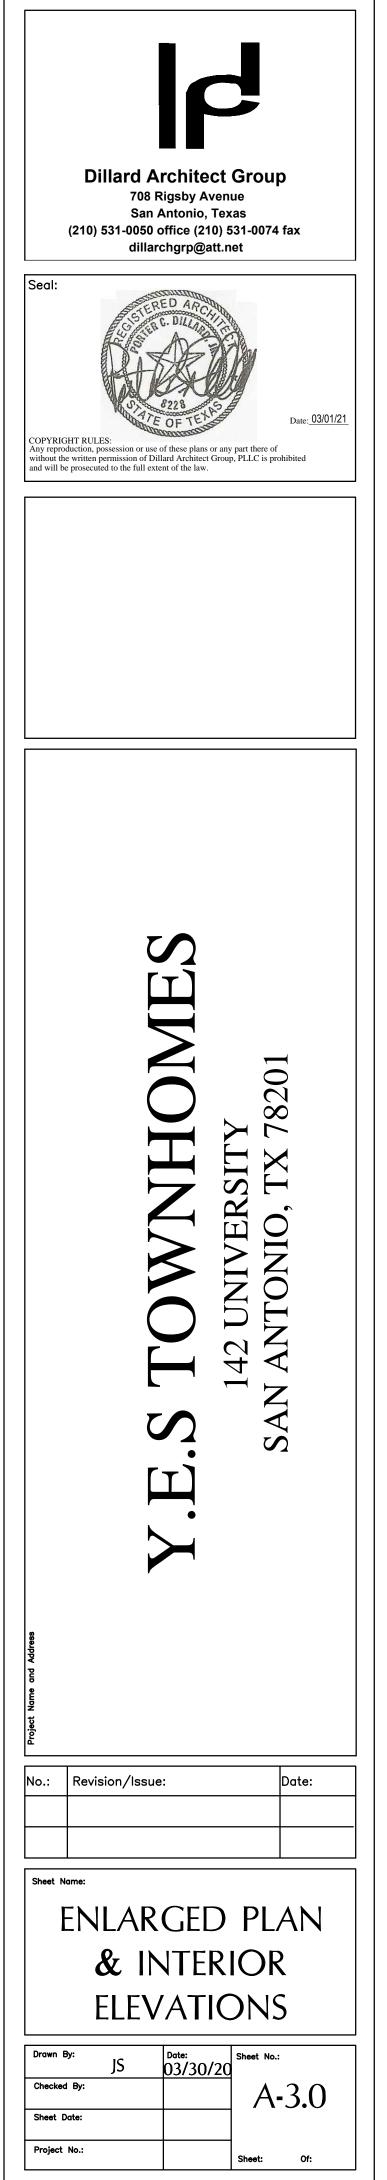
- THE ATTENTION OF THE ARCHITECT IN WRITING PRIOR TO BIDDING.

- CEILING MOUNTED EQUIPMENT.
- LOCATIONS, ALIGN THE FACE OF EXPOSED GYPSUM BOARD FLUSH.
- SIDE, U.N.O.


- SAG G.W.B U.N.O.




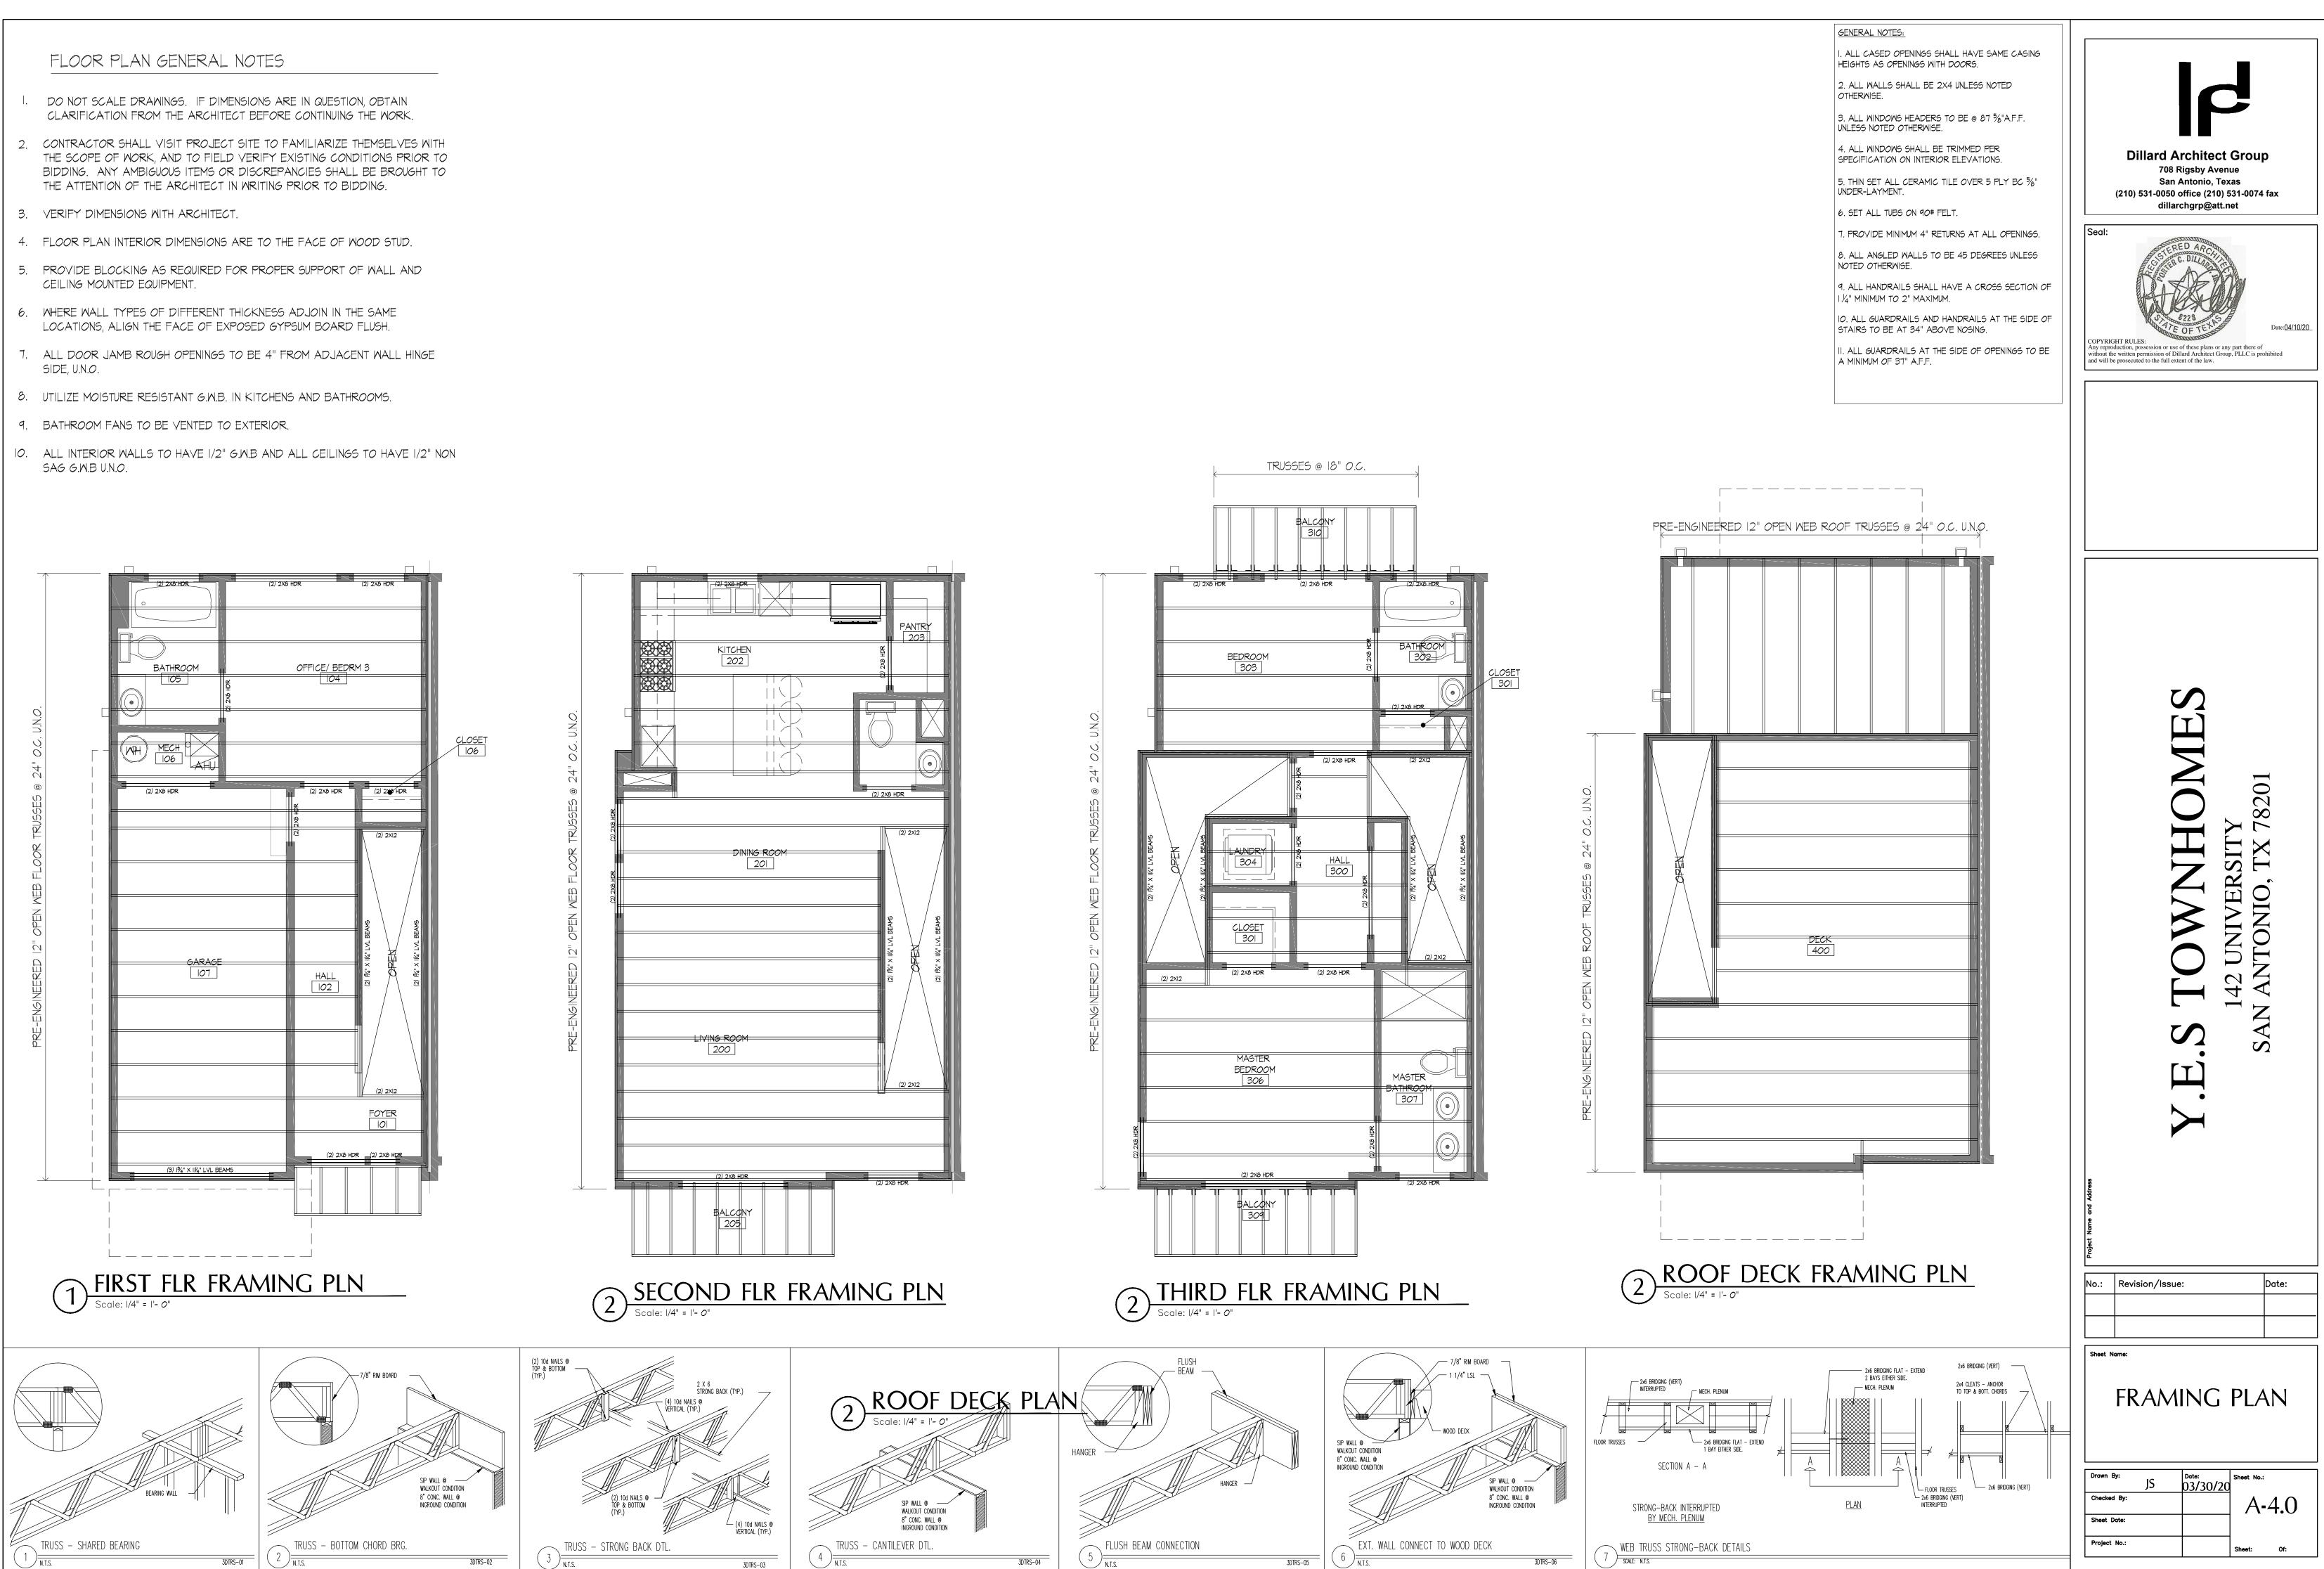

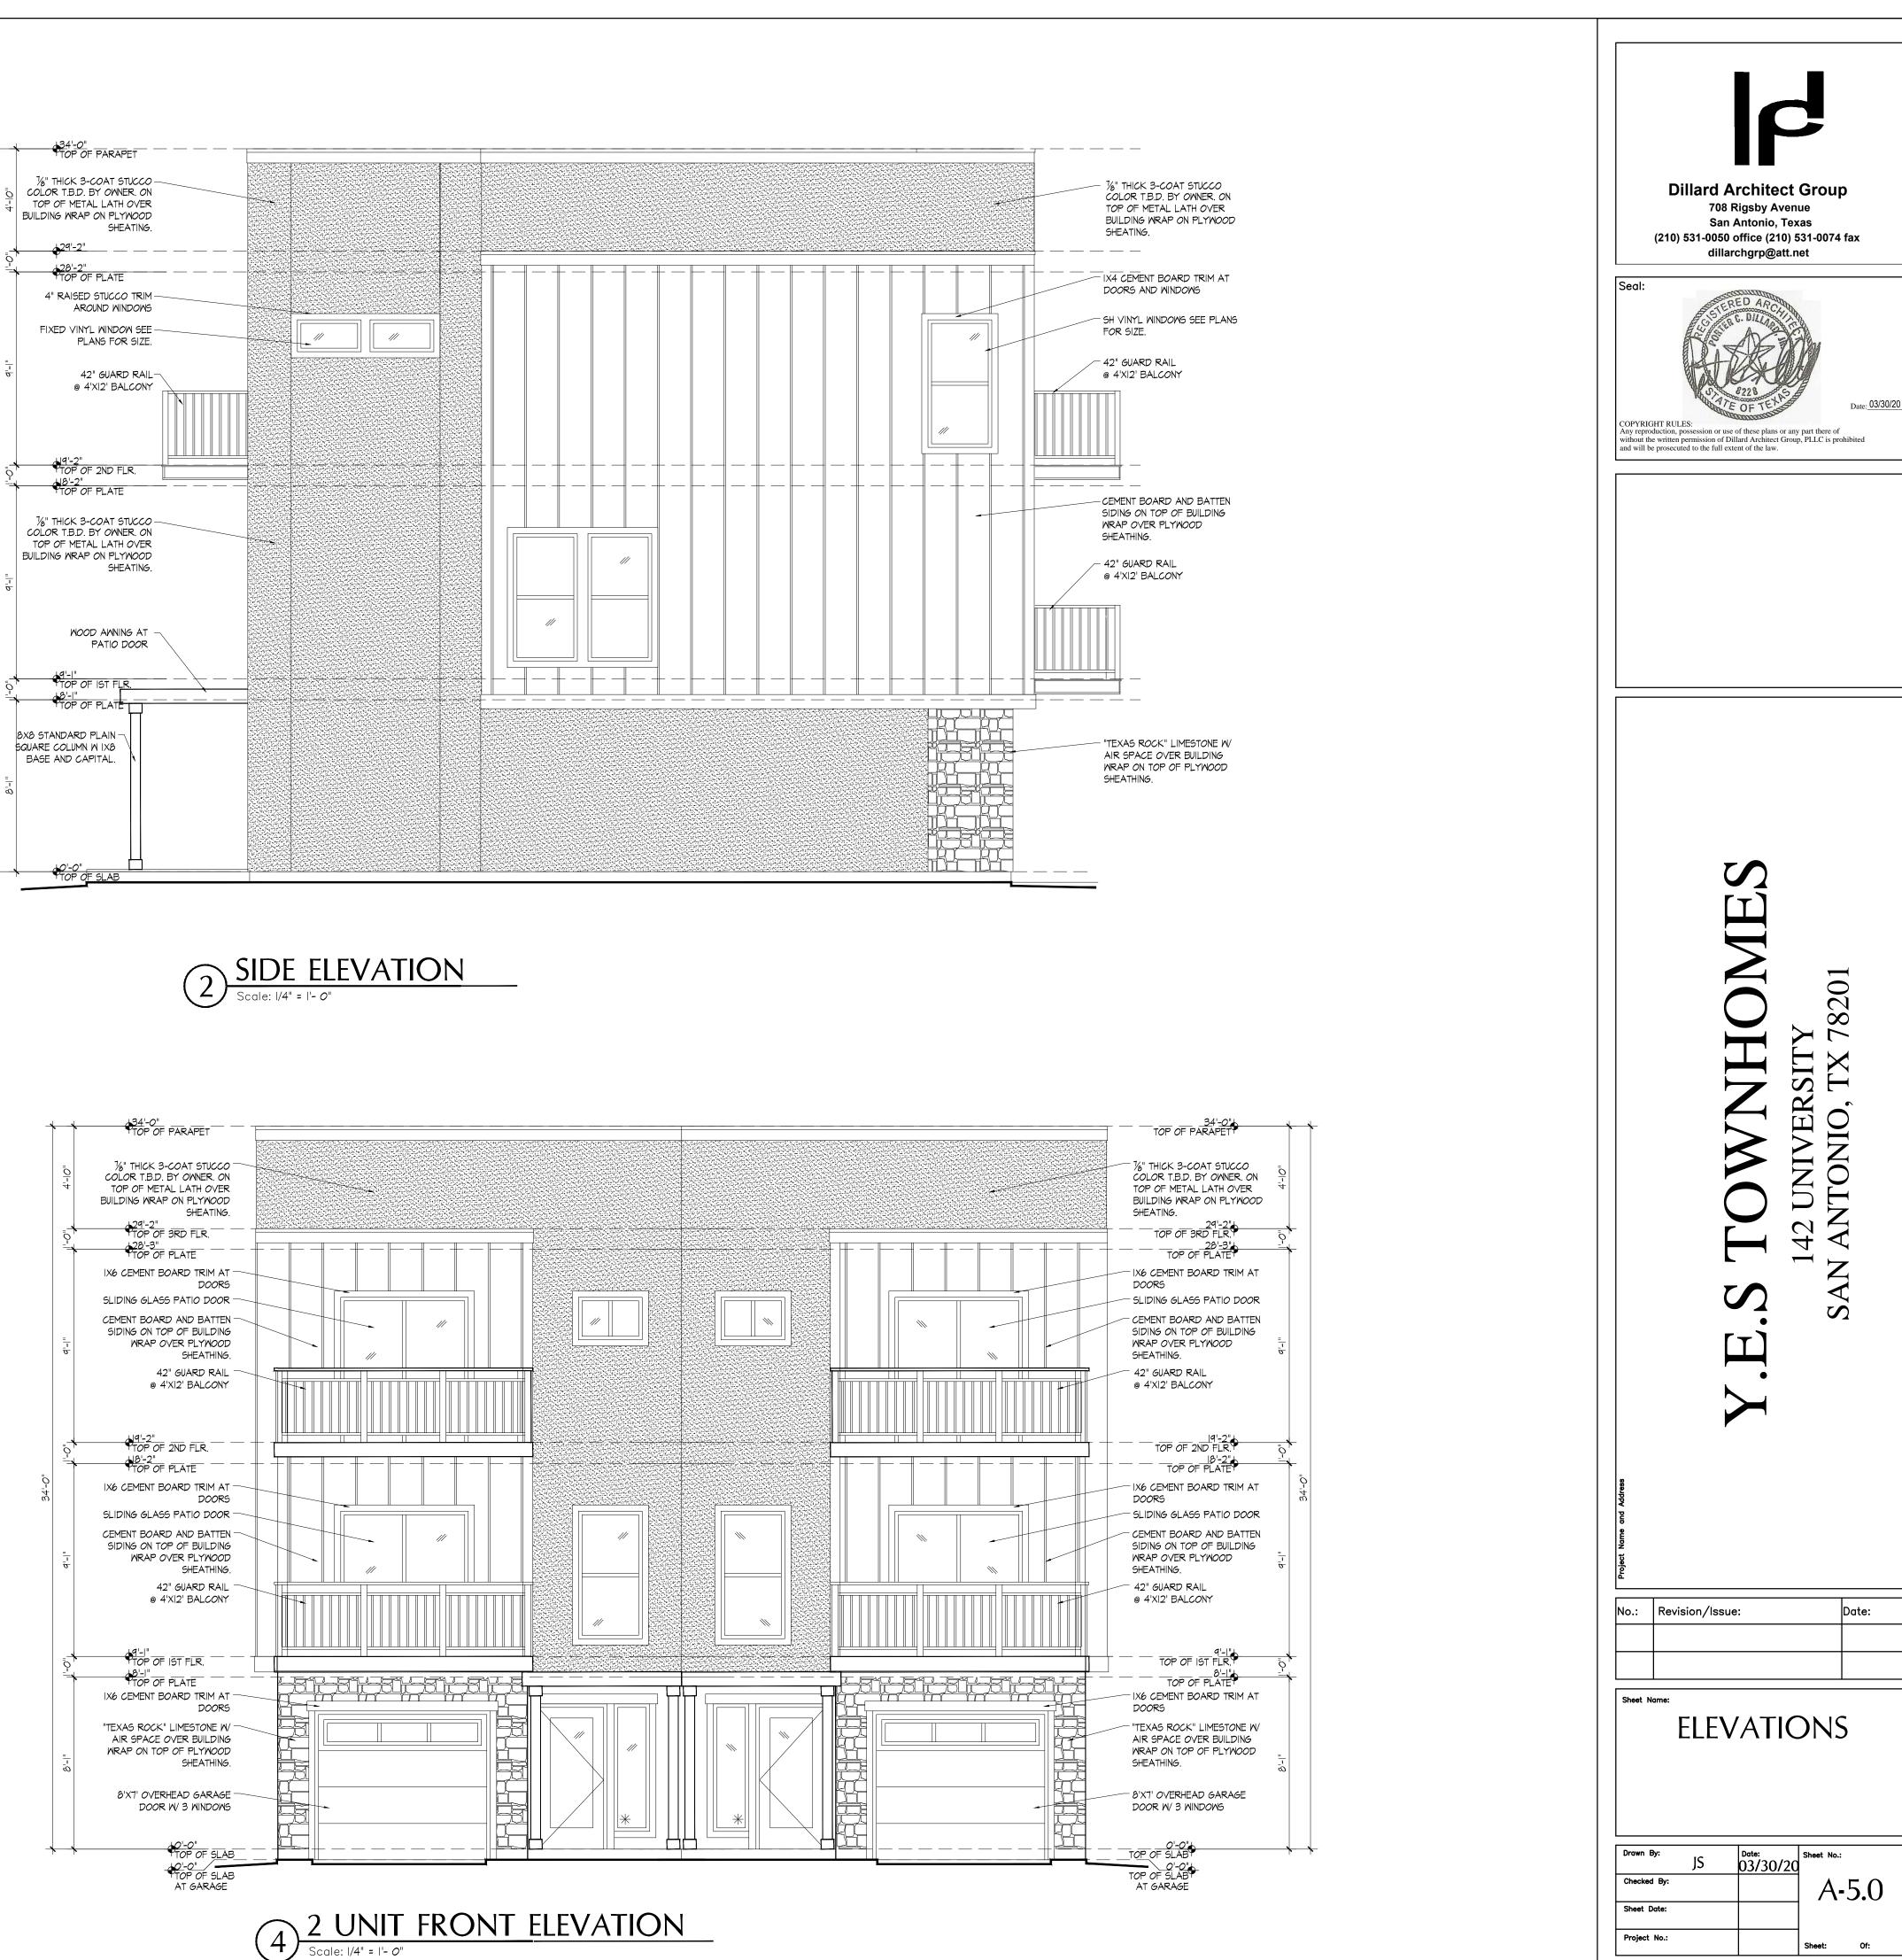




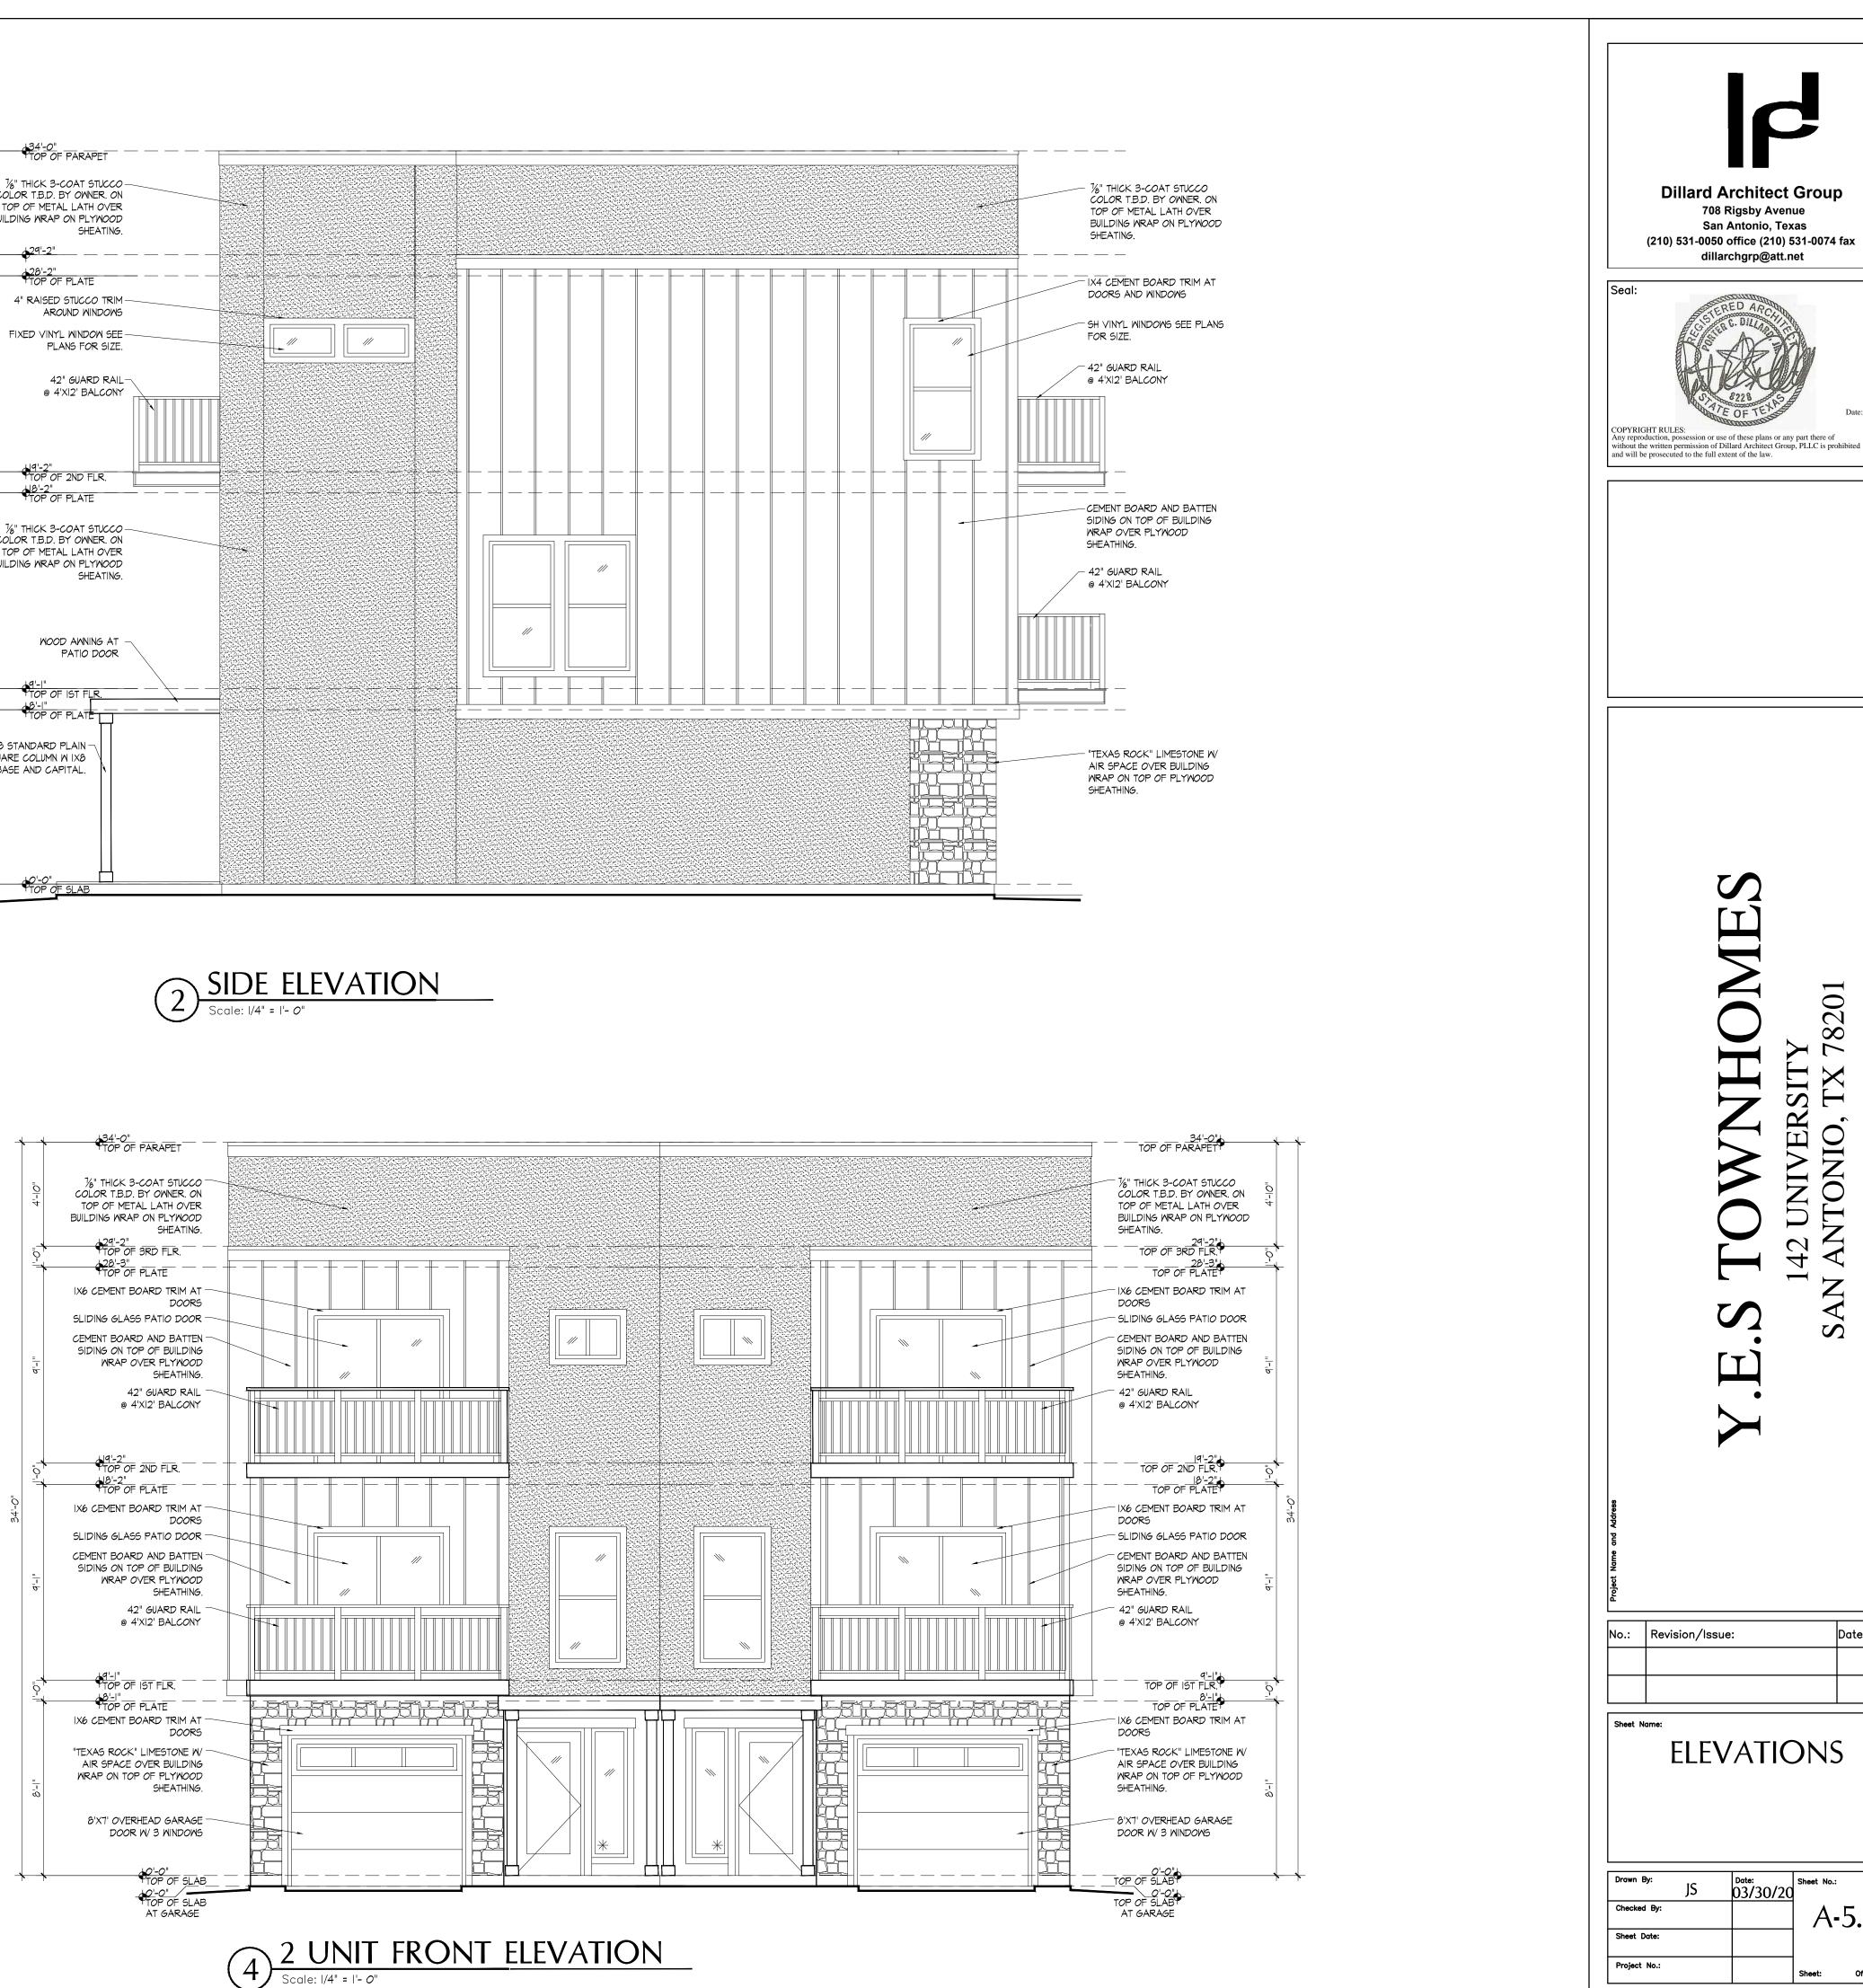

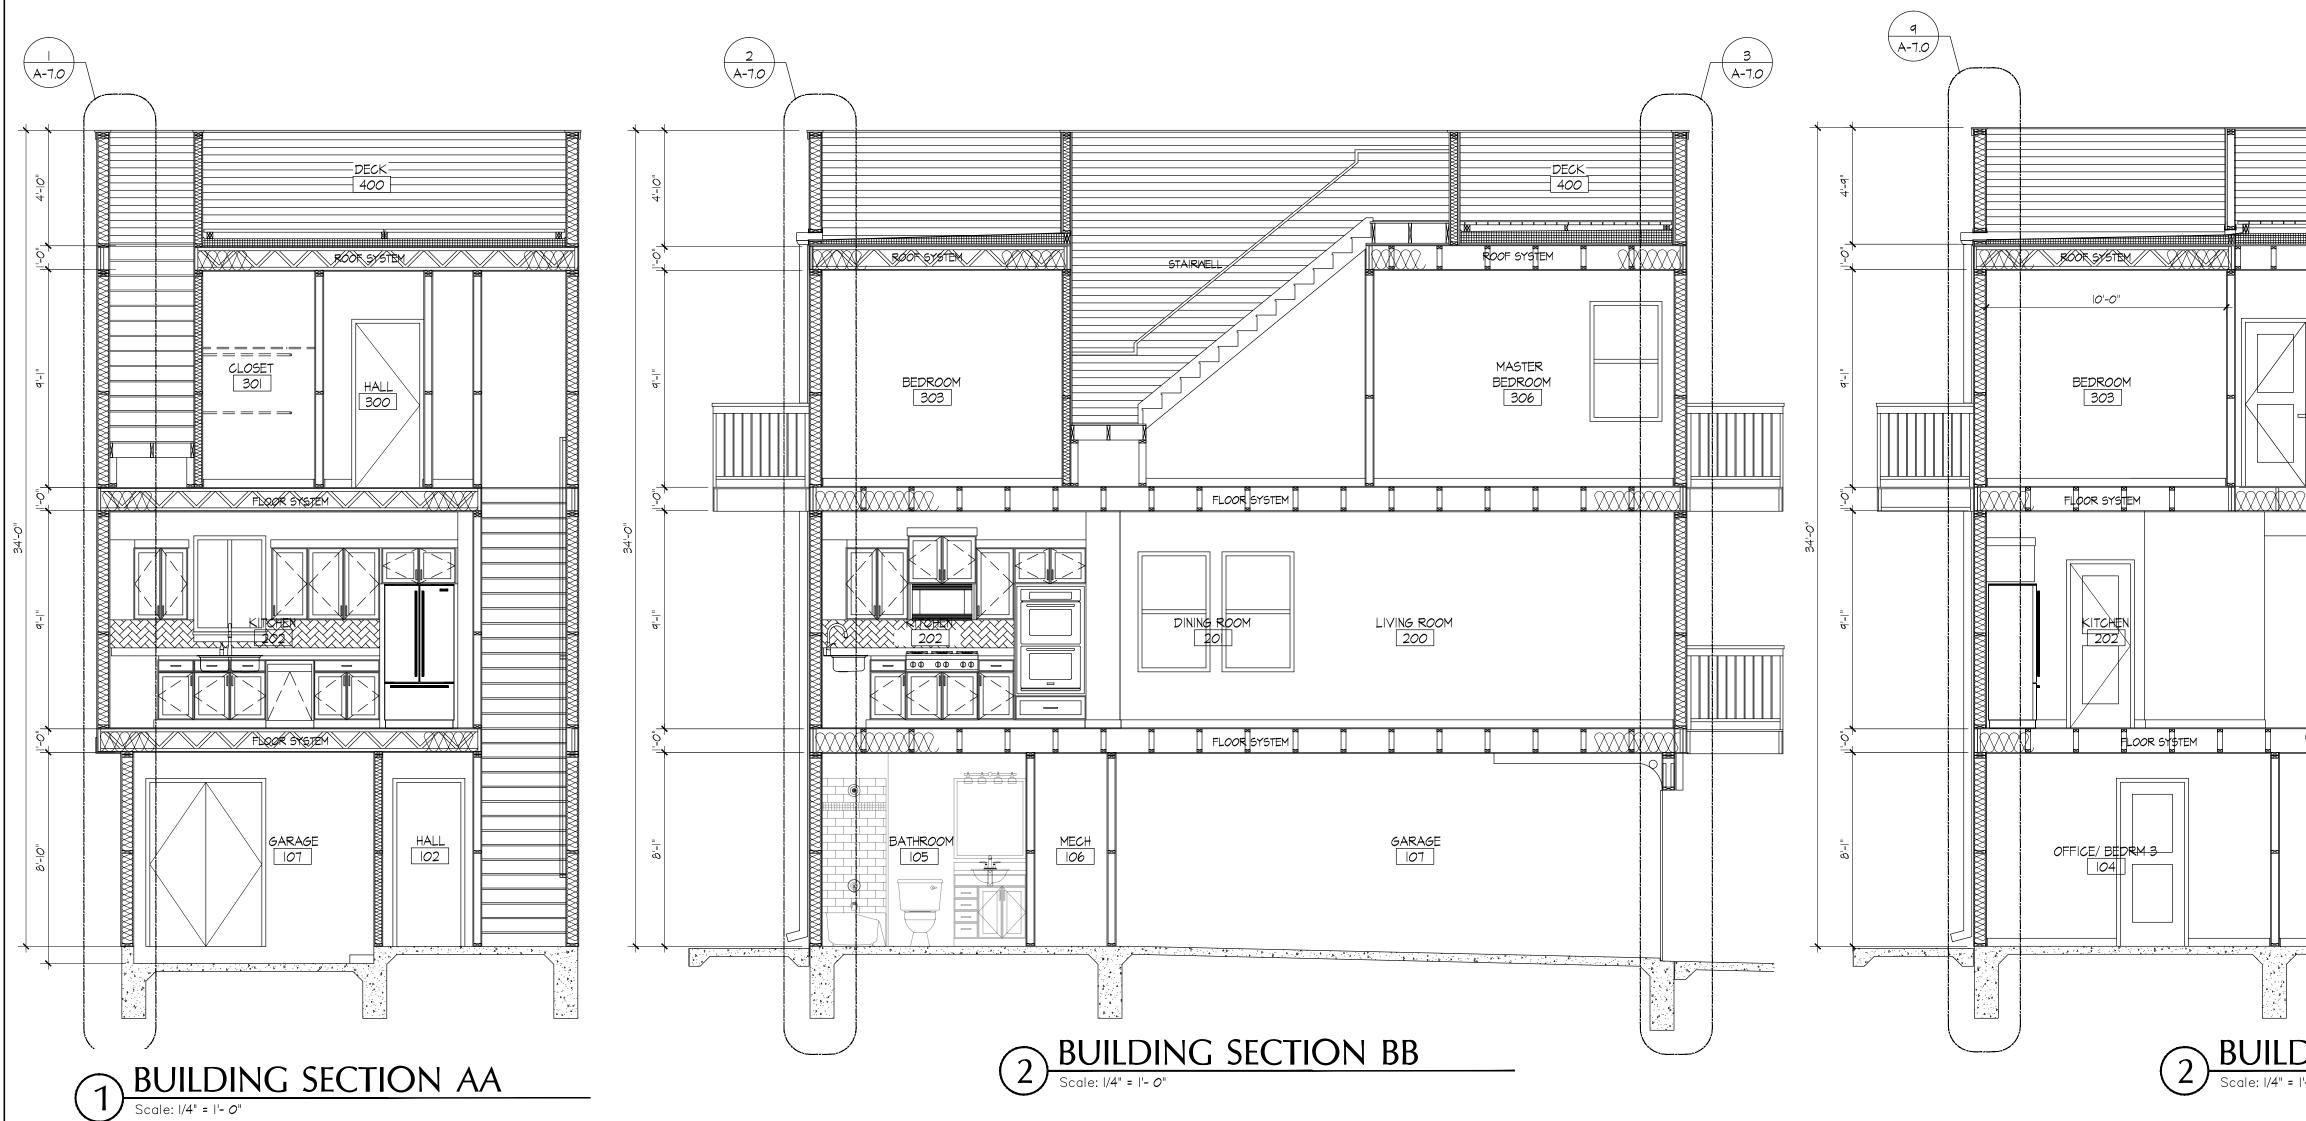



DOOR SCHEDULE

	D00	R		· · · · · · · · · · · · · · · · · · ·					<u> </u>	FRAME		COMMENTS
NO.	ROOM NAME	SIZE	TYPE	MATERIAL	RATING	GLASS	TYPE	HEAD	JAMB	THRESH		
100	PORCH	3'-0" x6'-8"	A	WOOD/ GLASS	-	-	-	10 / A-10	II / A-IO	-		
102	ELEVATOR	3'-0" x6'-8"	В	WOOD	-	-	-	10 / A-10	II / A-IO	-		
103	MECHANICAL ROOM	3'-0" x6'-8"	В	WOOD	-	-	-	8 / A-IO	9 / A-3	-		
104	CLOSET	2'-8" ×6'-8"	В	WOOD	-	-	-	10 / A-10	II / A-IO	-		
105	OFFICE/ BEDROOM 3	3'-0" x6'-8"	В	WOOD	-	-	-	10 / A-10	II / A-IO	-		
105	OFFICE/ BEDROOM 3 (PATIO)	5'-0" ×6'-8" SLIDER	E	WOOD/ GLASS	-	-	-	10 / A-10	II / A-IO	-		
106	BATHROOM	2'-8" ×6'-8"	В	WOOD	-	-	-	10 / A-10	II / A-IO	-		
107	CLOSET	2'-8" ×6'-8"	В	WOOD	-	-	-	10 / A-10	II / A-IO	-		
108	GARAGE	8'-0" x7'-0"	-		-	-	-	-	-	-		
109	HALL	3'-0" ×6'-8"	В	WOOD	-	-	-	10 / A-10	II / A-IO	-		
200	LIVING ROOM	5'-0" x6'-8" SLIDER	E	WOOD/ GLASS	-	-	-	10 / A-10	II / A-IO	-		
202	ELEVATOR	3'-0" ×6'-8"	в	WOOD	-	-	-	10 / A-10	II / A-IO	-		
2 <i>0</i> 3	WATER CLOSET	2'-8" ×6'-8"	В	WOOD	-	-	-	10 / A-10	II / A-IO	-		
204	KITCHEN	3'-0" ×6'-8"	A	WOOD/ GLASS	-	-	-	10 / A-10	II / A-IO	-		
205	PANTRY	2'-6" ×6'-8"	В	WOOD	-	-	-	10 / A-10	II / A-IO	-		
301	LAUNDRY	2'-6" ×6'-8" PR	D	WOOD/ GLASS	-	-	-	10 / A-10	II / A-IO	-		
302	ELEVATOR	3'-0" ×6'-8"	в	WOOD	-	-	-	10 / A-10	II / A-IO	-		
303	BEDROOM 2	3'-0" ×6'-8"	В	WOOD	-	-	-	10 / A-10	II / A-IO	-		
304	BATHROOM 2	2'-8" ×6'-8"	в	WOOD	-	-	-	10 / A-10	II / A-IO	-		
304	BATHROOM 2 (BALCONY)	5'-0" x6'-8" SLIDER	E	WOOD/ GLASS	-	-	-	10 / A-10	II / A-IO	-		
305	CLOSET	2'-8" ×6'-8"	В	WOOD	-	-	-	10 / A-10	II / A-IO	-		
306	MASTER BATHROOM	3'-0" ×6'-8"	в	WOOD	-	-	-	10 / A-10	II / A-IO	-		
307	MASTER BEDROOM	3'-0" ×6'-8"	В	WOOD	-	-	-	10 / A-10	II / A-IO	-		
307	MASTER BEDROOM (BALCONY)	5'-0" x6'-8" SLIDER	E	WOOD/ GLASS	-	-	-	10 / A-10	II / A-IO	-		
308	MASTER CLOSET	2'-8" ×6'-8"	в	WOOD	-	-	-	10 / A-10	II / A-IO	-		
401	DEN	2'-6" x6'-8" PR	C	WOOD/ GLASS	-	-	-	10 / A-10	II / A-IO	-		
402	ELEVATOR	3'-0" ×6'-8"	в	WOOD	-	-	-	10 / A-10	II / A-IO	-		
403	ELEVATOR MACHINE ROOM	2'-8" ×6'-8"	В	WOOD	-	-	-	10 / A-10	II / A-IO	-		
404	WATER CLOSET	2'-8" ×6'-8"	В	WOOD	-	-	-	10 / A-10	II / A-IO	-		
405	ATTIC	3'-0" x6'-8"	В	WOOD	-	_	-	10 / A-10	II / A-IO	-		

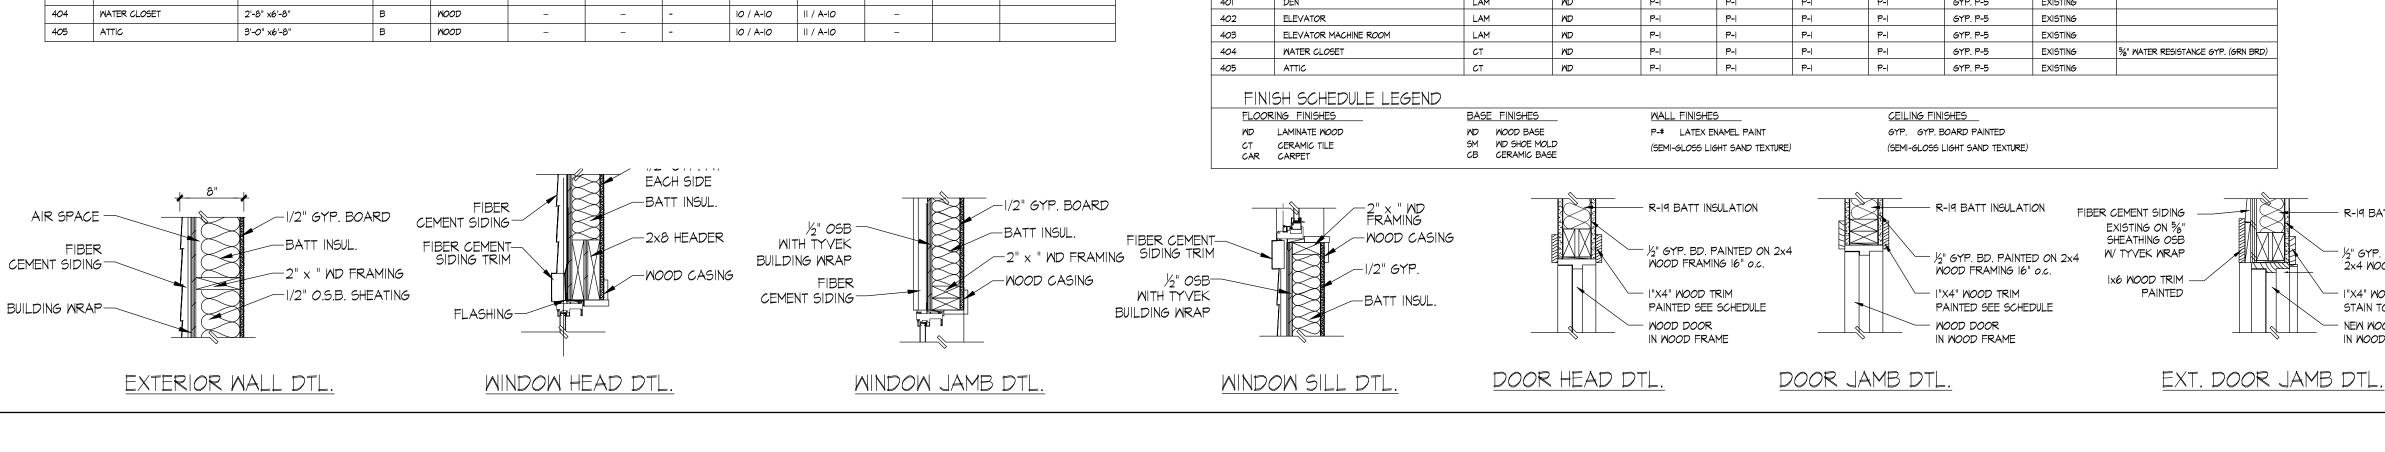



	ROOM NAME	FLOOR	BASE	WALLS				CEIL'G.	CLG. HT.	COMMENTS
				NORTH	EAST	SOUTH	WEST			
00	PORCH	CONC	WD	P-1	P-1	P-1	P-1	GYP. P-5	EXISTING	
0	FOYER	LAM	ND	P-1	P-1	P-1	P-1	GYP. P-5	EXISTING	
02	ELEVATOR	LAM	ND	P-1	P-1	P-1	P-1	GYP. P-5	EXISTING	
03	MECHANICAL ROOM	CONC	ND	P-1	P-1	P-1	P-1	GYP. P-5	EXISTING	5%" WATER RESISTANCE GYP. (GRN BRD
04	CLOSET	LAM	ND	P-1	P-I	P-1	P-1	GYP. P-5	8'-0"	
05	OFFICE/ BEDROOM 3	LAM	ND	P-1	P-I	P-1	P-1	GYP. P-5	EXISTING	
06	BATHROOM	СТ	ND	P-1	P-1	P-1	P-1	GYP. P-5	EXISTING	5%" WATER RESISTANCE GYP. (GRN BRD
от	CLOSET	ст		P-1	P-1	P-1	P-1	GYP. P-5	EXISTING	
08	GARAGE	CONC	ND	P-1	P-1	P-1	P-1	GYP. P-5	EXISTING	
09	HALL	LAM	ND	P-1	P-1	P-1	P-1	GYP. P-5	EXISTING	
10	PATIO	CONC	ND	P-I	P-I	P-I	P-1	GYP. P-5	EXISTING	
200	LIVING ROOM	LAM	ND	P-1	P-I	P-1	P-1	GYP. P-5	EXISTING	
201	DINING ROOM	LAM	ND	P-1	P-I	P-1	P-1	GYP. P-5	EXISTING	
202	ELEVATOR	СТ	ND	P-1	P-1	P-1	P-1	GYP. P-5	EXISTING	
203	WATER CLOSET	СТ	ND	P-1	P-1	P-1	P-1	GYP. P-5	EXISTING	%" WATER RESISTANCE GYP. (GRN BRD
204	KITCHEN	СТ	ND	P-1	P-1	P-1	P-1	GYP. P-5	EXISTING	5%" WATER RESISTANCE GYP. (GRN BRD
205	PANTRY	СТ	ND	P-1	P-I	P-1	P-1	GYP. P-5	EXISTING	
206	BALCONY	СТ	ND	P-1	P-I	P-1	P-1	GYP. P-5	EXISTING	
207	BALCONY	ст	ND	P-1	P-I	P-I	P-1	GYP. P-5	EXISTING	
300	HALL	LAM	ND	P-1	P-1	P-1	P-1	GYP. P-5	EXISTING	
301	LAUNDRY	СТ	ND	P-1	P-1	P-1	P-1	GYP. P-5	EXISTING	%" WATER RESISTANCE GYP. (GRN BRD
302	ELEVATOR	LAM	ND	P-1	P-1	P-1	P-1	GYP. P-5	EXISTING	
303	BEDROOM 2	LAM	ND	P-1	P-I	P-1	P-1	GYP. P-5	EXISTING	
304	BATHROOM 2	ст	ND	P-1	P-1	P-1	P-1	GYP. P-5	EXISTING	5%" WATER RESISTANCE GYP. (GRN BRD
305	CLOSET	ст	WD	P-1	P-1	P-1	P-1	GYP. P-5	EXISTING	
306	MASTER BATHROOM	ст	WD	P-1	P-1	P-1	P-1	GYP. P-5	EXISTING	%" WATER RESISTANCE GYP. (GRN BRD
307	MASTER BEDROOM	LAM	WD	P-1	P-1	P-1	P-1	GYP. P-5	EXISTING	
308	MASTER CLOSET	LAM	WD	P-1	P-1	P-1	P-1	GYP. P-5	EXISTING	
400	DECK	COM DECK	WD	P-I	P-1	P-1	P-1	GYP. P-5	EXISTING	
401	DEN	LAM	WD	P-1	P-1	P-1	P-1	GYP. P-5	EXISTING	
402	ELEVATOR	LAM	WD	P-1	P-I	P-1	P-1	GYP. P-5	EXISTING	
403	ELEVATOR MACHINE ROOM	LAM	WD	P-1	P-I	P-1	P-1	GYP. P-5	EXISTING	
404	WATER CLOSET	СТ	WD	P-1	P-I	P-1	P-1	GYP. P-5	EXISTING	%" WATER RESISTANCE GYP. (GRN BRD
	ATTIC	СТ	WD	P-1	P-1	P-1	P-1	GYP. P-5	EXISTING	

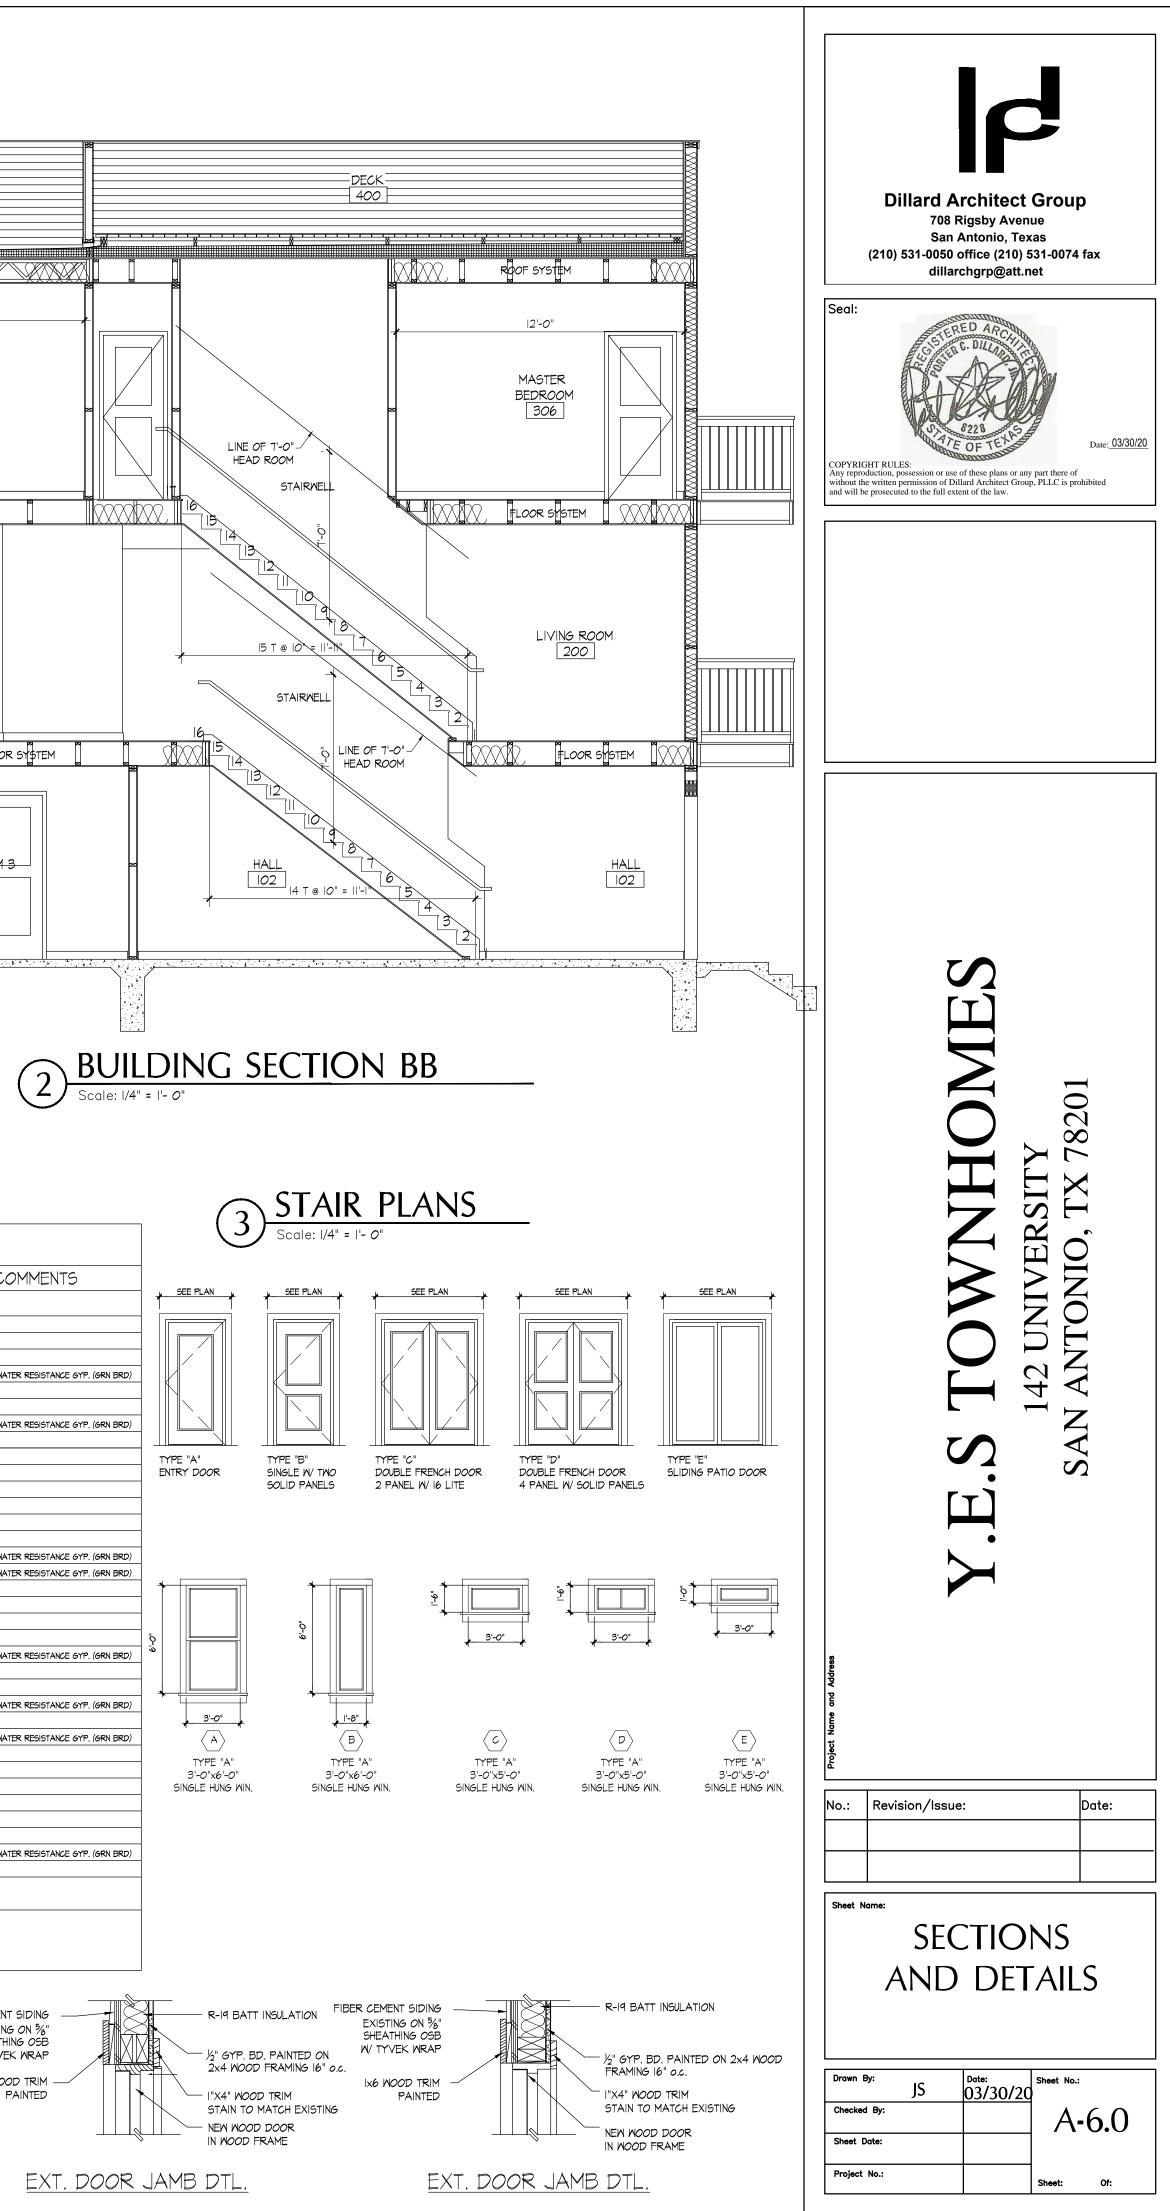

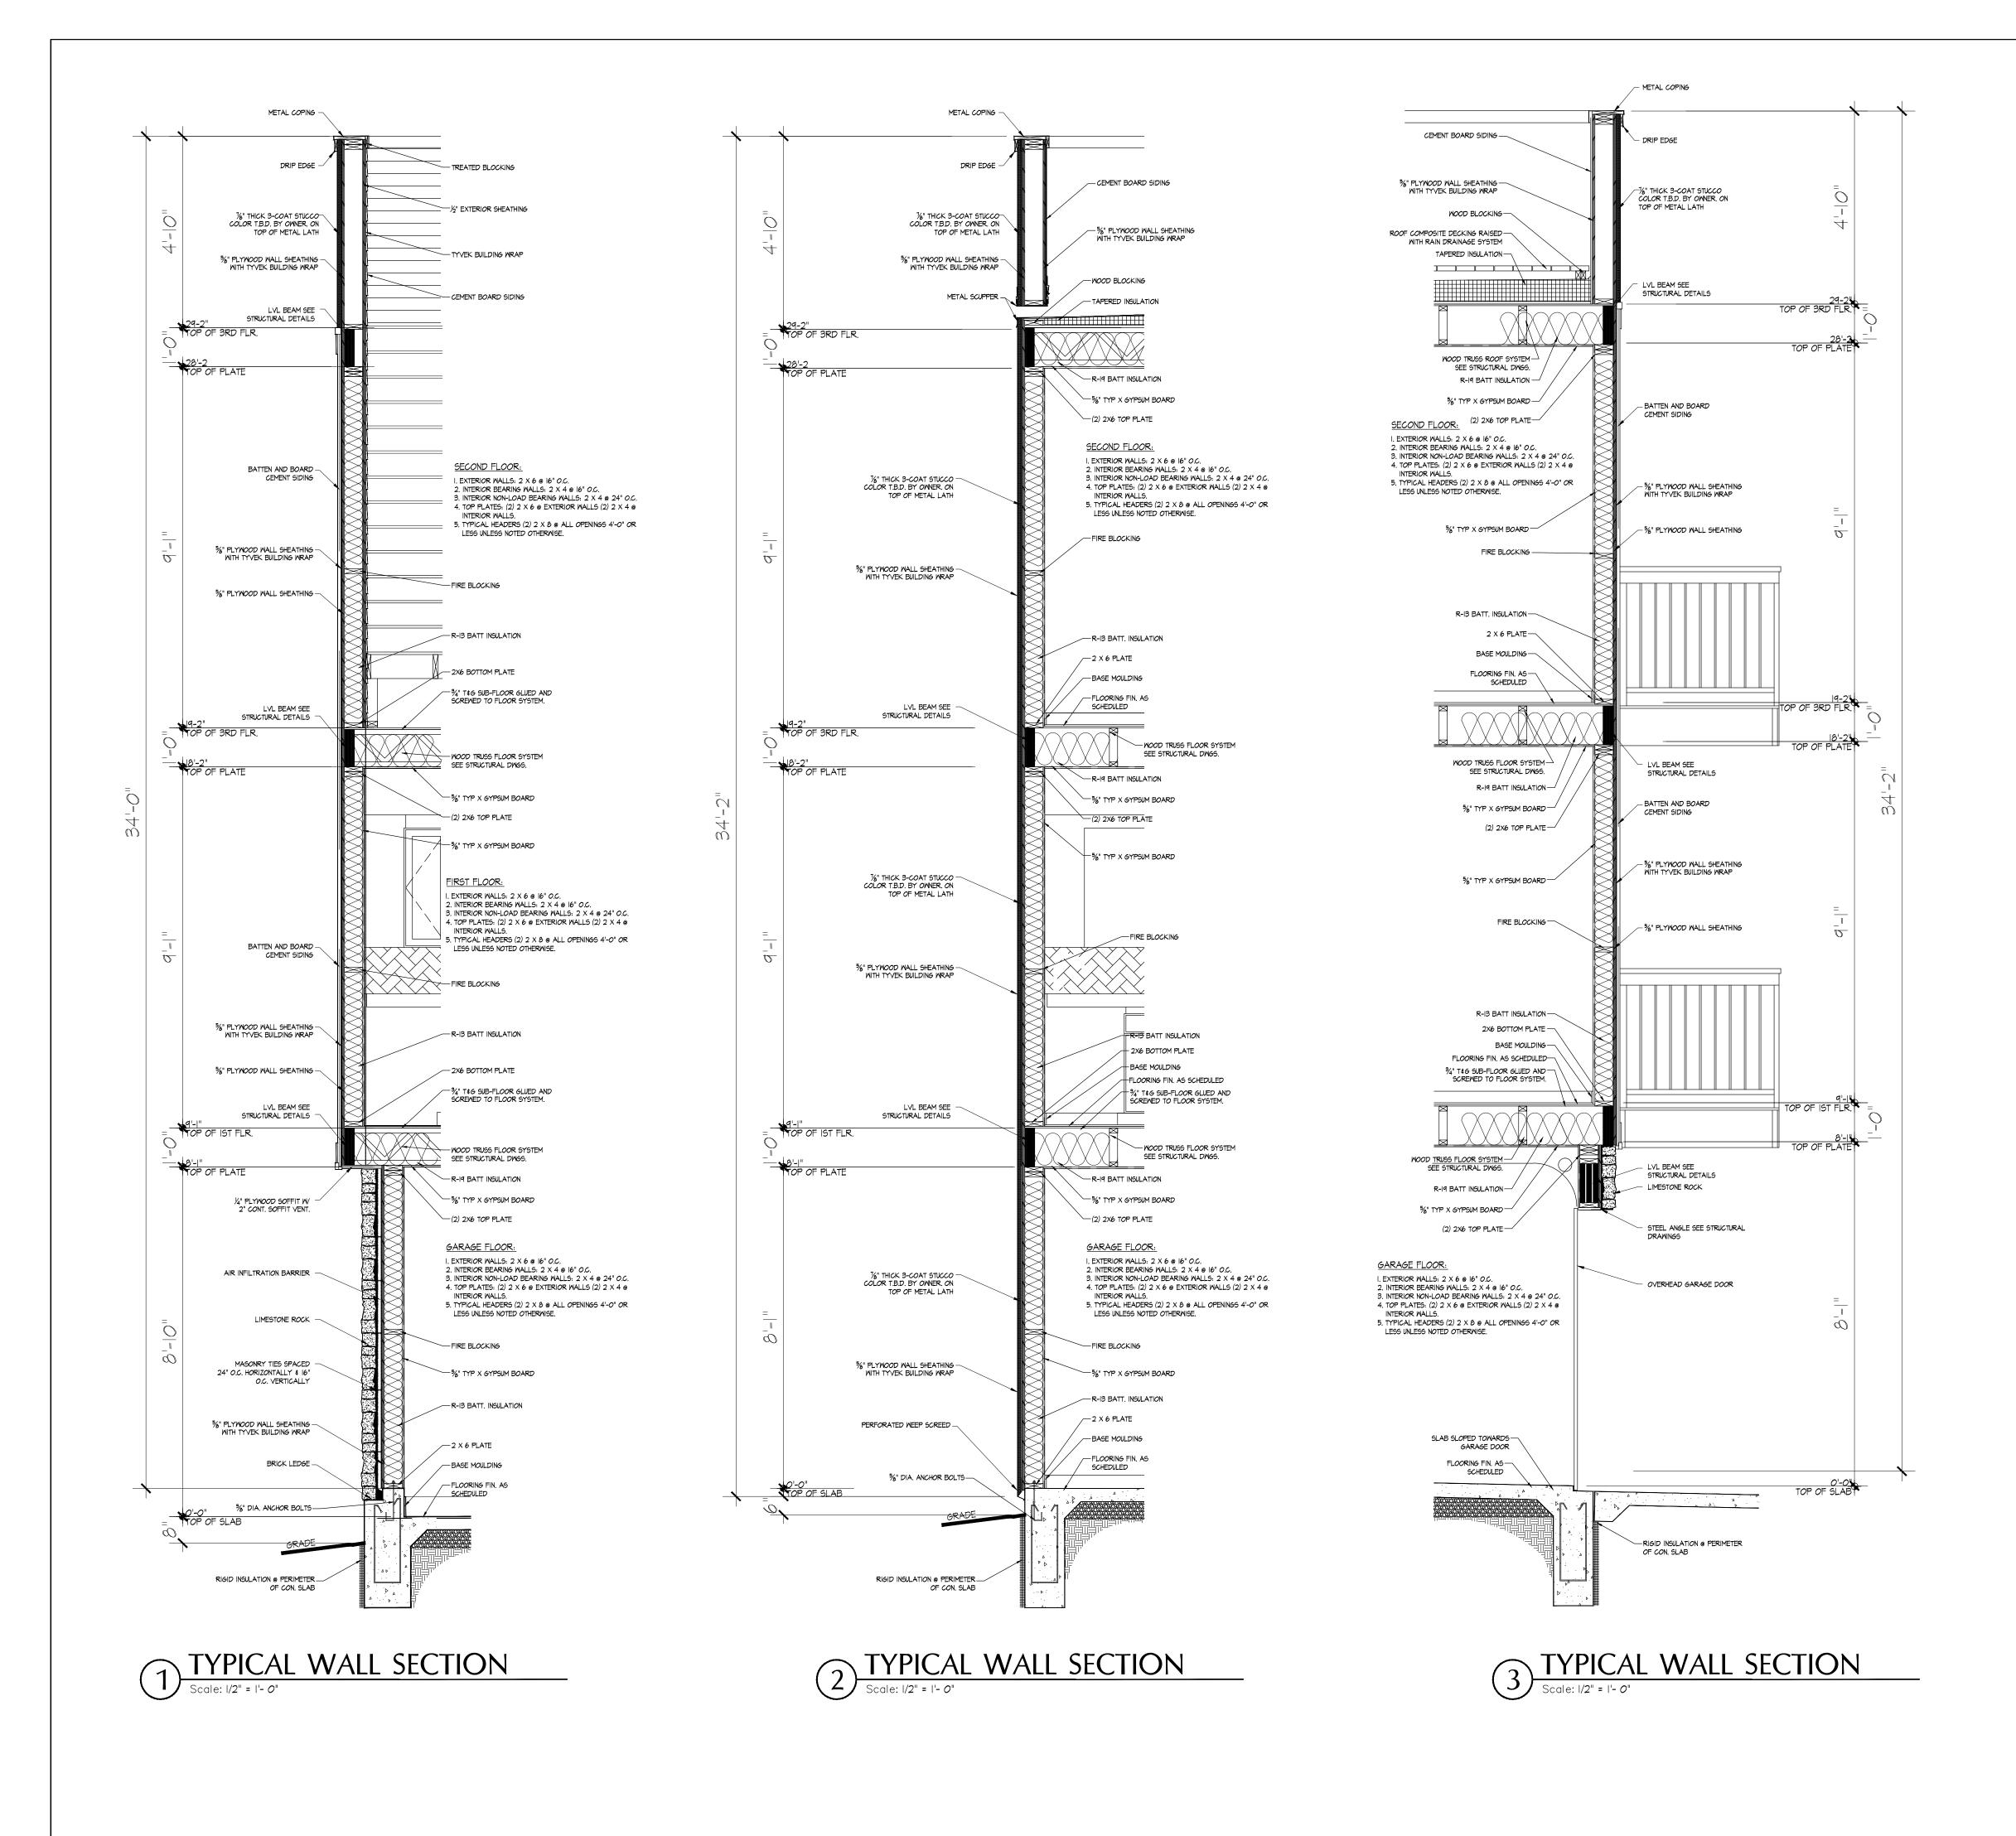


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Drawn By: JS Date: Sheet No.: Checked By:

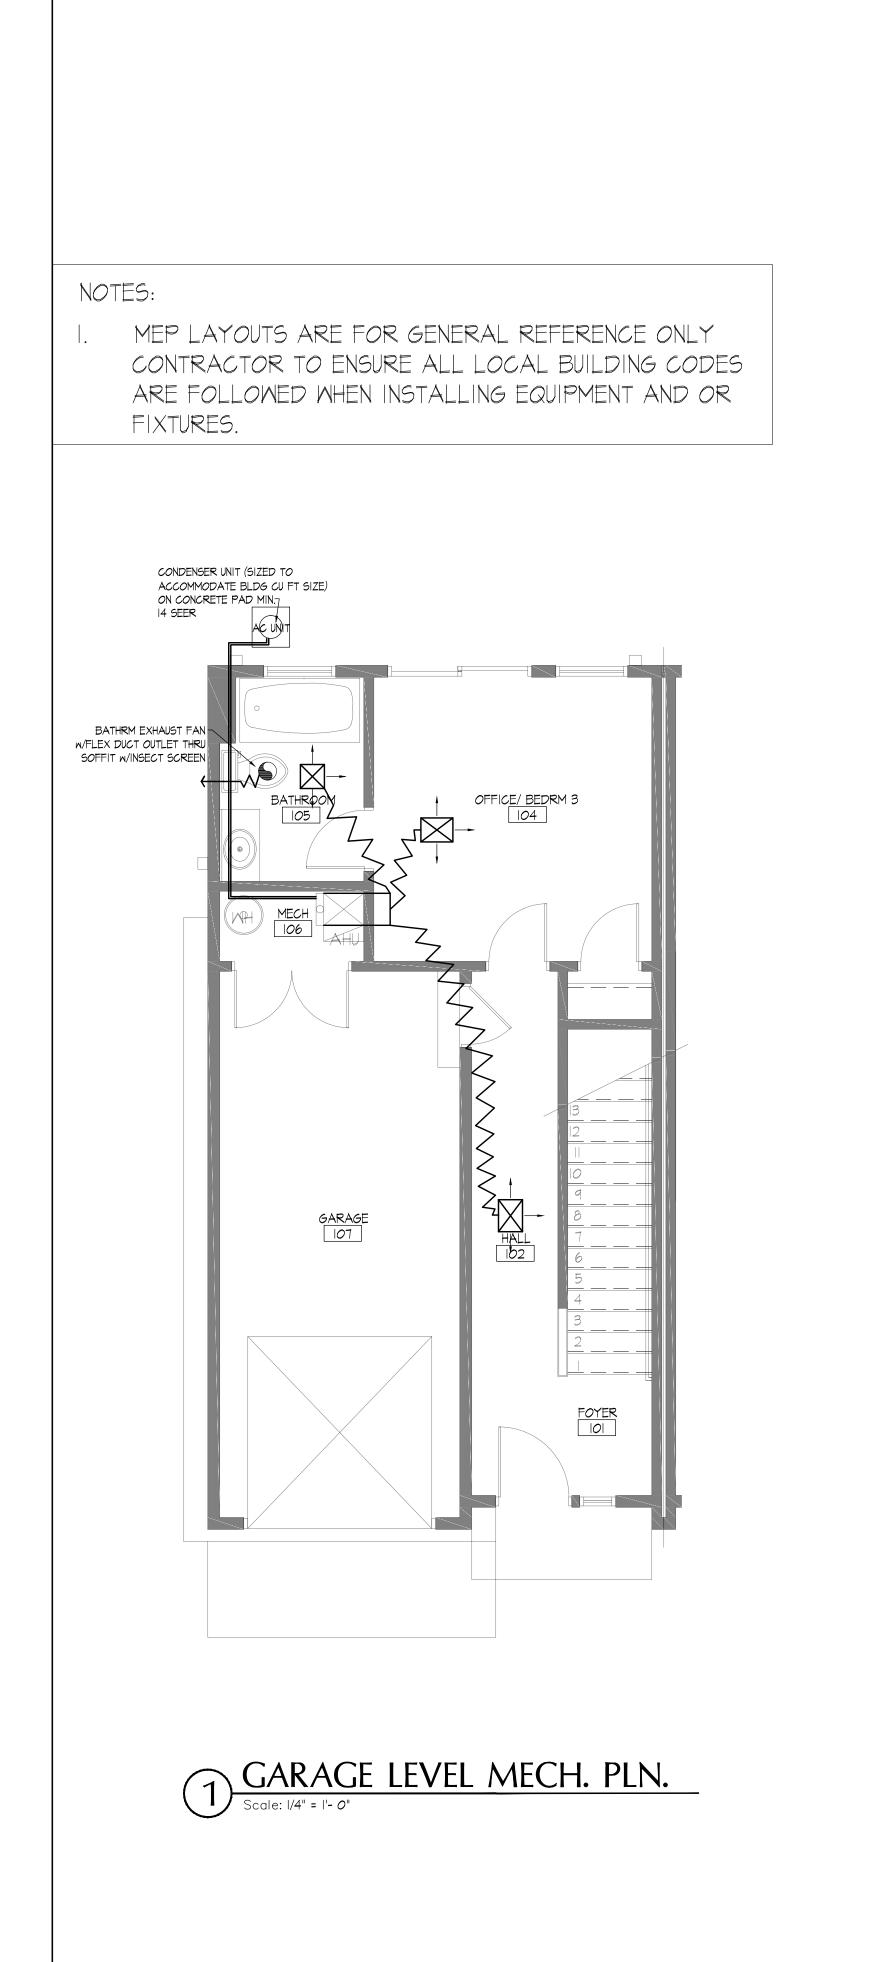

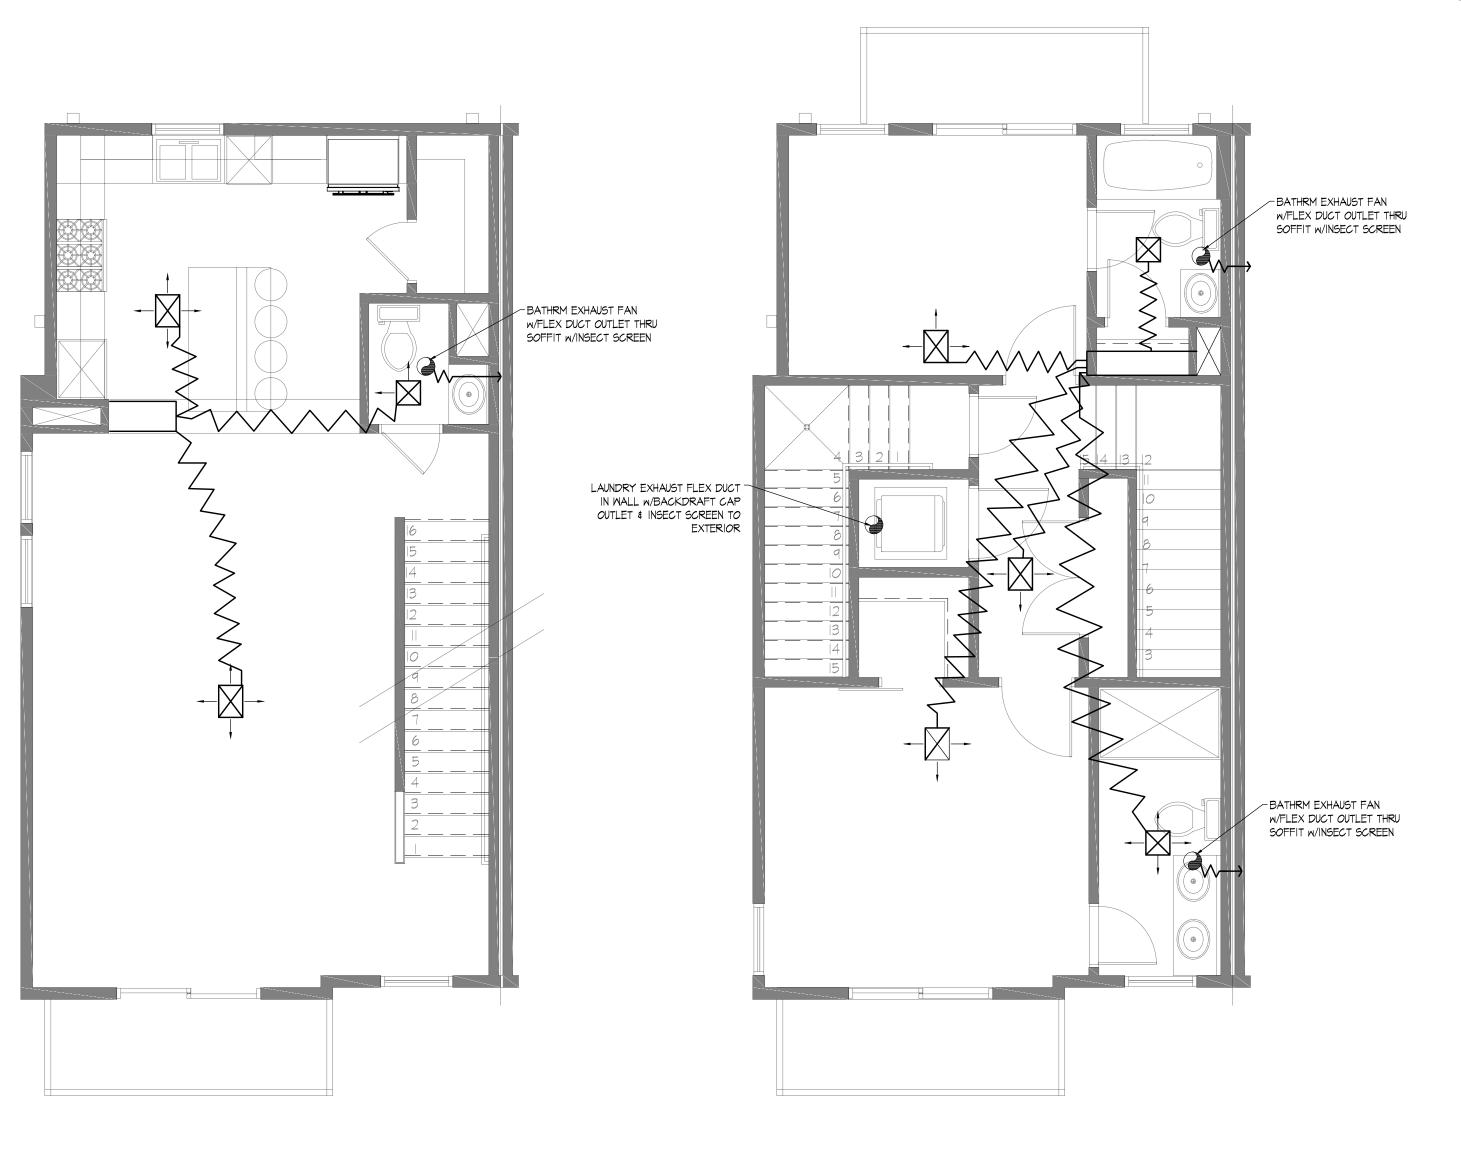



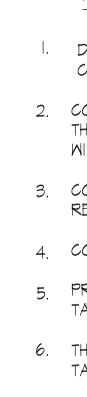





I. DO NOT SCALE DRAWINGS. IF DIMENSIONS ARE IN QUESTION, OBTAIN CLARIFICATION FROM THE ARCHITECT BEFORE CONTINUING THE WORK.

2. CONTRACTOR SHALL VISIT PROJECT SITE TO FAMILIARIZE THEMSELVES WITH THE SCOPE OF WORK, BEFORE STARTING WORK TO ENSURE COORDINATION WITH OTHER TRADES.

3. CONTRACTOR SHALL OBTAIN AND PAY FOR ALL PERMITS AND INSPECTIONS REQUIRED BY LOCAL ADMINISTRATIVE AUTHORITY


4. COORDINATE THE LOCATIONS OF AIR DEVICES WITH OWNER,


5 PROVIDE AIR BALANCE TEST PROVIDE MANUAL DAMPER AT EACH BRACH TAKE OFF & AIR DEVICE.

6. THERMOSTATS AND CONTROLS TO BE AT 48" A.F.F. AND COMPLY WITH ADA/ TAS REQUIREMENTS.


KEY NOTES

415	SHEET ONLY
\bowtie	AIR DIFFUSER
	AIR RETURN
\mathbb{X}^{A}	SIDE WALL SUPPLY GRILLE OR REGISTER
	AIR HANDLING UNIT
(SUPPLY AIR DEVICE WITH FLEX DUCT
\bowtie	

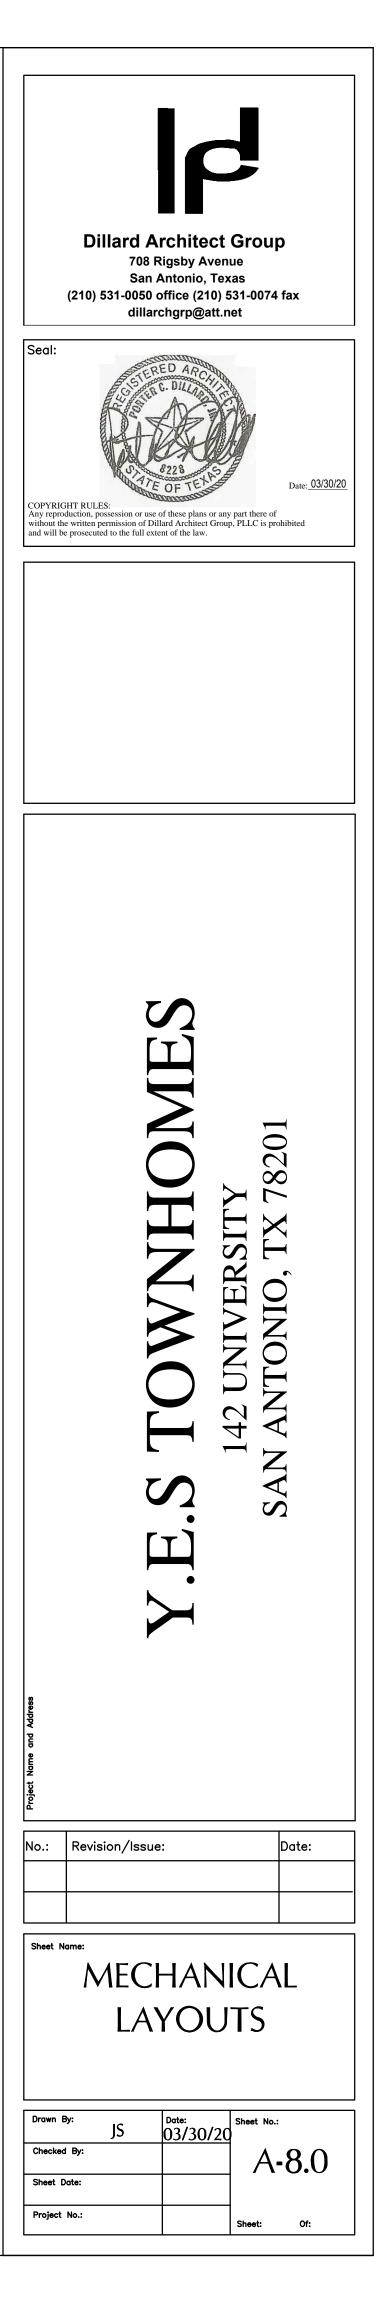

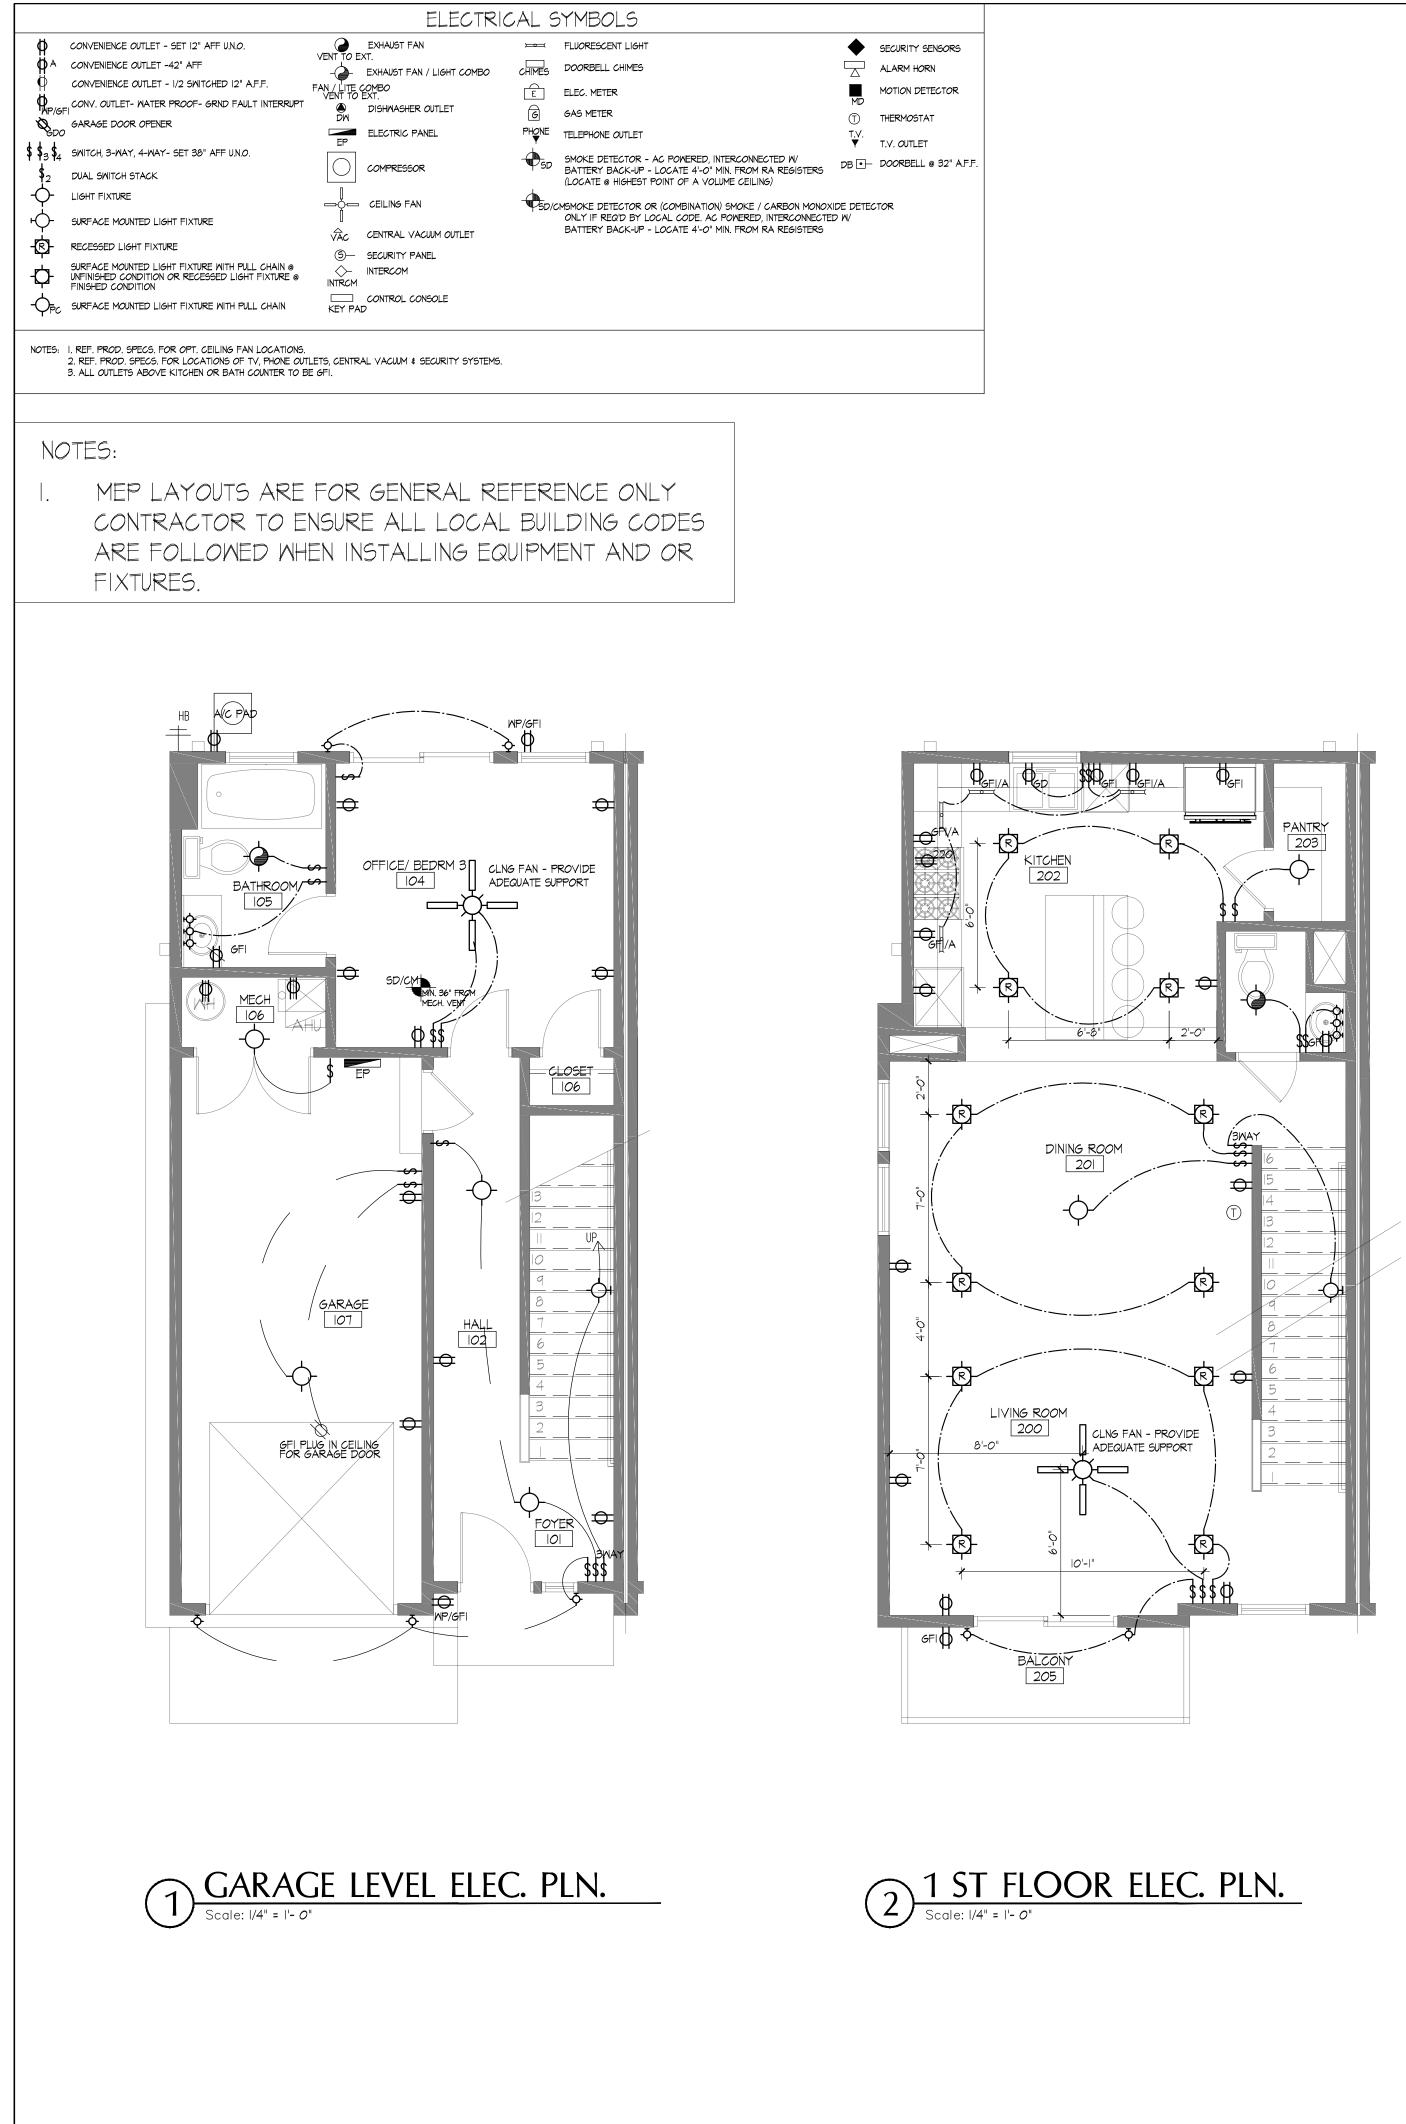

- I. BREAKER BOX TO BE LOCATED PER PLAN.
- 2. ALL PLUGS AND SMOKE DETECTORS PER IRC CODES AND WHERE LOCATED ON PLAN. ALL SMOKE DETECTORS SHOULD BE IN AN AREA ACCESSIBLY BY 16'-0" EXTENSION LADDER OR 6'-O" STEP LADDER, SMOKE DETECTORS MUST BE MINIMUM OF 30" FROM RETURN AIR GRILL INCLUDING ADJACENT ROOMS. DETECTORS SHALL BE INSTALLED INTERCONNECTED SO THAT THE ACTIVATION OF I WILL ACTIVATE ALL OTHERS.
- 3. SWITCHES TO BE LOCATED 54" A.F.F. (TOP OF BOX)
- 4. PRE-WIRE LOW VOLTAGE FOR O.H. DOOR OPENER- LOW VOLTAGE AT 8" A.F.F. ON EACH SIDE OF O.H. DOOR OPENER BUTTONS TO BE 5'-O" A.F.F.
- 5. MICROWAVE/ VENT-HOOD PLUG TO BE AT 76" A.F.F. (IF OVER COOK-TOP WHEN APPLICABLE) MICROWAVE AND REFRIGERATOR FREEZER OUTLETS TO BE DEDICATED 20 AMP.
- 6. INSTALL GFI PLUGS AT ALL SINK VANITIES AND AT KITCHEN COUNTERTOPS.
- 7. VANITY LIGHT BOXES TO BE AT 86" A.F.F.(TO BOTTOM OF BOX)
- 8. GARBAGE DISPOSAL TO HAVE PLUG.
- 9. SECURITY KEYPADS TO BE LOCATED ABOVE SWITCHES PER PLAN SECURITY PANEL AT 67" A.F.F. (TOP OF BOX). STRUCTURED WIRING PANEL AT 53" A.F.F.

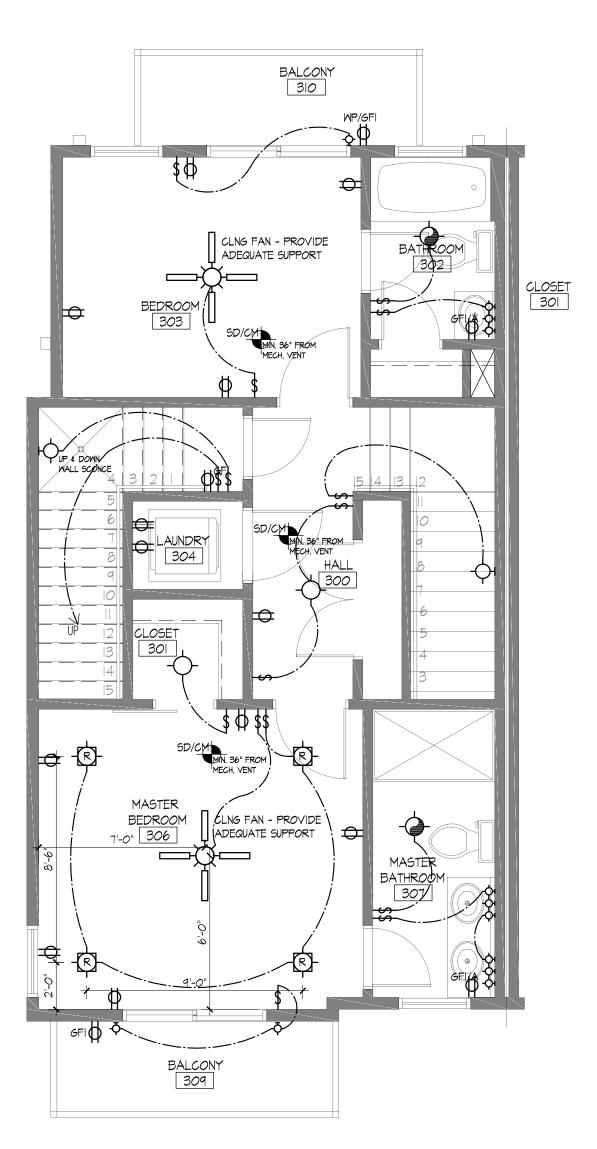

3 2 ND FLOOR ELEC. PLN. Scale: 1/4" = 1'- 0"

II. LIGHT IN ATTIC TO BE SWITCHED.

12. BLOCK AND WIRE PER PLAN.

13. HVAC CONTRACTOR TO SUPPLY AND INSTALL ALL EXHAUST FANS ELECTRICIAN TO WIRE AND INSTALL 16" FROM BACK OF BOX TO WALL WHEN POSSIBLE AND CENTER OVER DRYER AND TOILET.


14. THERMOSTAT TO BE LOCATED 60" A.F.F. (CENTER OF BOX) LOCATION(S) PER PLAN.


15. CEILING FANS ARE TO BE INSTALLED AND BALANCED PER MANUFACTURER'S SPECS.

16. EXTERIOR GFI AT A/C COMPRESSOR SHOULD BE LOCATED NEXT TO AND AT SAME HEIGHT AS THE DISCONNECT.

17. INSTALL DRYER VENT BOX CENTER OF DRYER LOCATION IN PLAN WHEN APPLICABLE.

18. SECURITY MOTION DETECTOR PER PLAN. TO BE MOUNTED AT 7'-6" A.F.F.

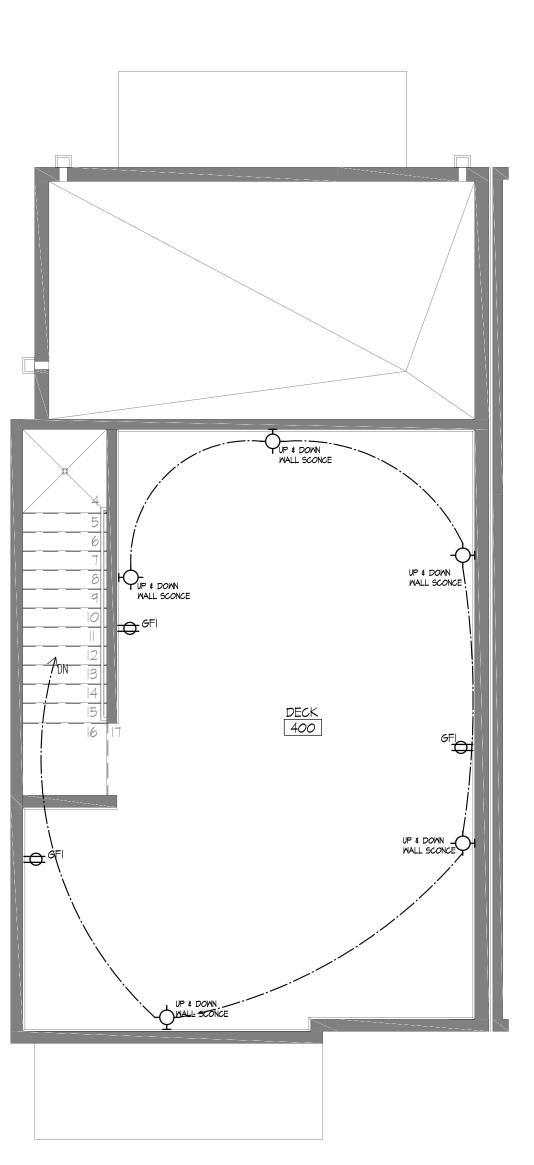

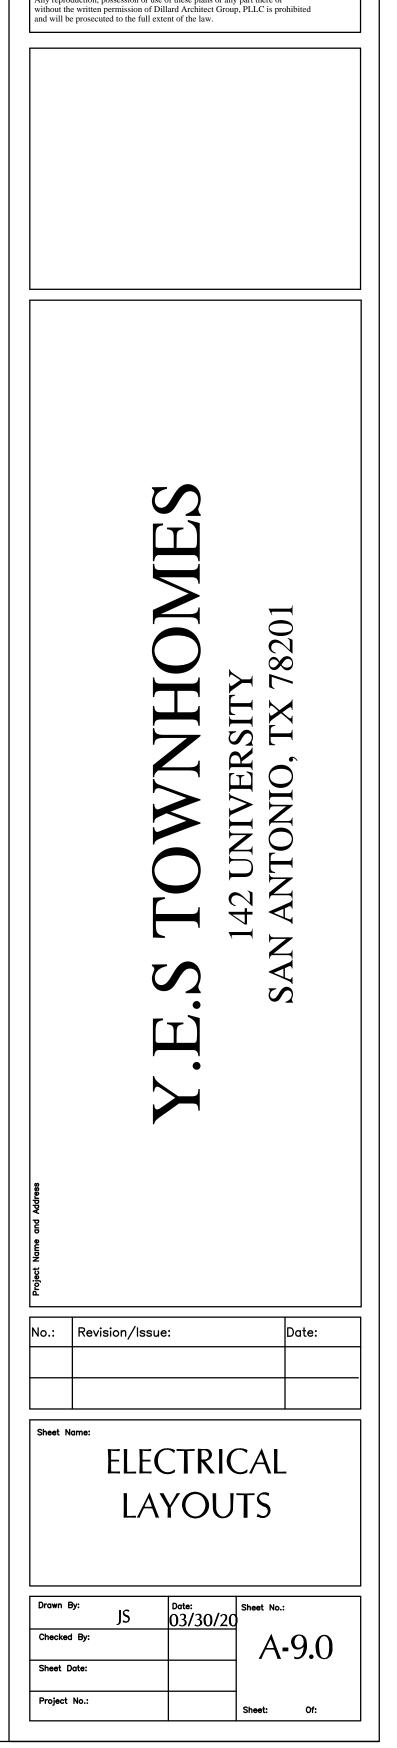

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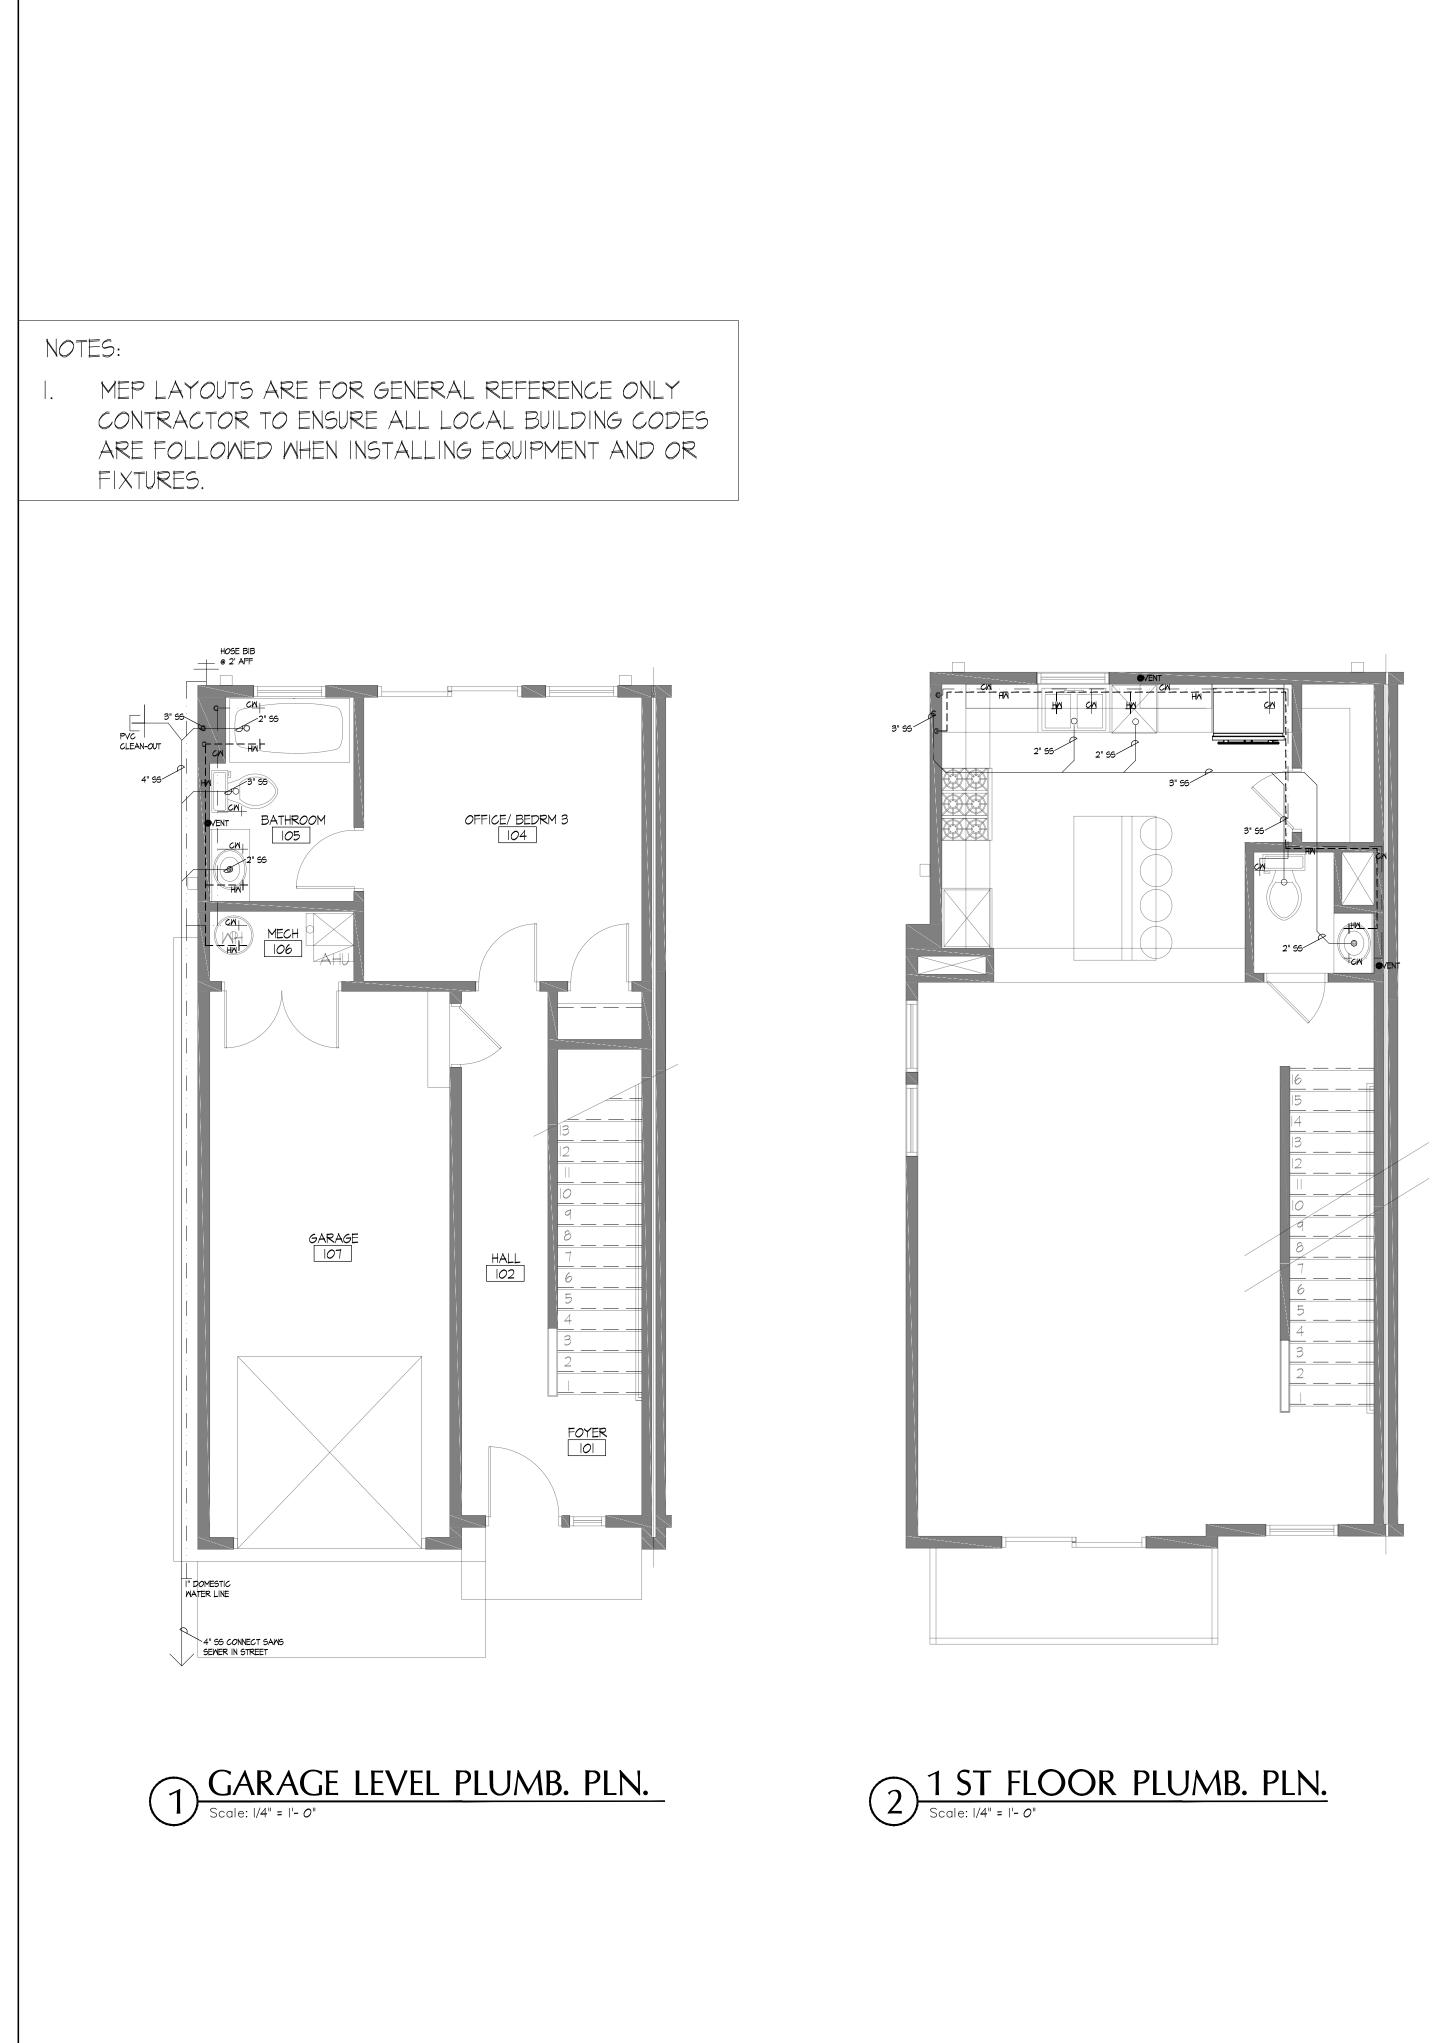
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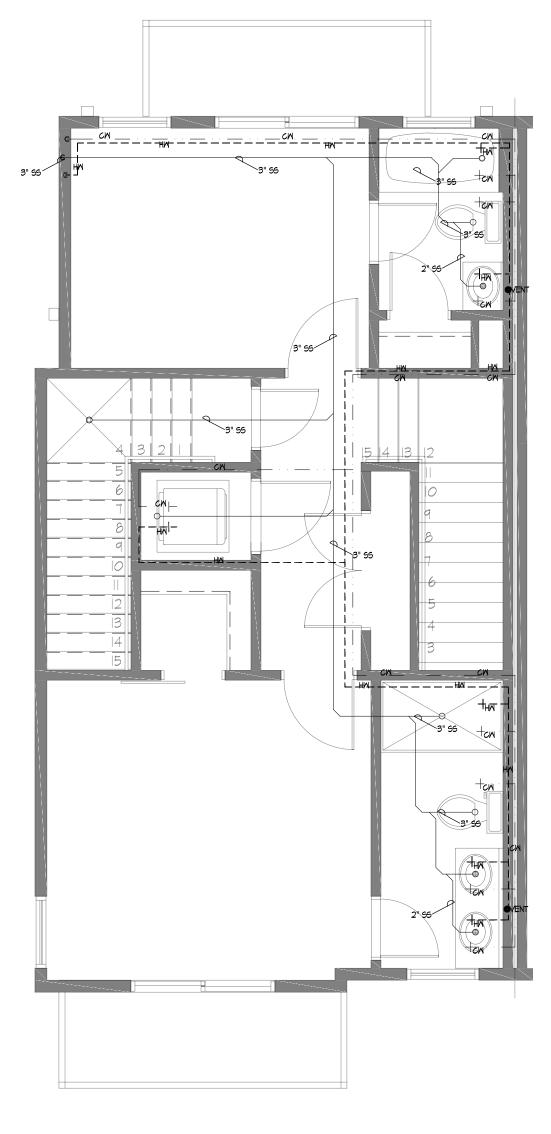
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4 3 RD FLOOR ELEC. PLN. Scale: 1/4" = 1'- 0"





3 2 ND FLOOR PLUMB. PLN. Scale: 1/4" = 1'- 0"

FLOOR PLAN GENERAL NOTES

I. SCOPE OF PLUMBING WORK IS TO FURNISH AND INSTALL ALL FIXTURES EQUIPMENT AND PLUMBING AND PIPING/ MISC. ON SITE.

2. THESE DRAWINGS INDICATE THE GENERAL EXTENT OF WORK AND ARE NOT INTENDED TO INDICATE OR DESCRIBE ALL WORK REQUIRED FOR THE FULL COMPETITION OF THIS PROJECT.

3. WHENEVER HOT AND COLD WATER CONTROLS, FAUCETS VALES OR STOPS ARE INSTALL TOGETHER, HOT SHALL BE ON THE LEFT AND COLD ON THE RIGHT AS SEEN BY THE USER.


4. CONTRACTOR TO FIELD VERIFY LOCATIONS AND ELEVATIONS OF UTILITIES BEFORE BEGINNING INSTALLATIONS.

5. WASTE PIPE IS GENERALLY UNDERGROUND ALL OTHER PIPING IS GENERALLY ABOVE THE CEILING AND IN WALLS UNLESS NOTED OTHERWISE.

6. ALL PIPING SHALL BE ROUTED AND HIDDEN FROM VIEW. WHERE PIPING CANNOT BE HIDDEN FROM VIEW OBTAIN ARCHITECTS APPROVAL FOR PLACEMENT.

KEY NOTES

THIS SHEET ONLY	
COLD WATER LINE	
HOT WATER LINE	
SANITARY SEWER LINE	
+- HOSE BIB	
∃∞ CLEAN OUT	

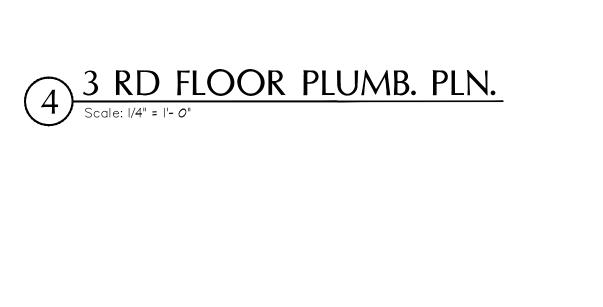

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