PROJECT OWNER:

## TOWN OF BELLMONT P.O. BOX 35 BRAINARDSVILLE, NY 12915

DAM:

MOUNTAIN VIEW LAKE DAM NEW YORK STATE I.D. NO. 182-0276

PROJECT TITLE:

## MOUNTAIN VIEW LAKE DAM RECONSTRUCTION

PROJECT ENGINEER:



SCALE:1"=100'-0"

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ATTACHMENT 1	EXISTING TOPOGRAPHY AND BATHYMETRY BY THEW ASSOCIATES					



### 60% DESIGN NOT FOR CONSTRUCTION

4/27/18 0 ISSUED FOR APPROVAL

PROJ. NO.: 1937

DRAWN BY: JND/JSC

DATE # ISSUE/REVISION DESCRIPTION

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TOWN OF BELLMONT

MOUNTAIN VIEW LAKE DAM RECONSTRUCTION



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DWG NO.:

DRAWINGS

G-0

JND/EAW | WJF COVER SHEET AND LIST OF CHECKED BY: EAW SCALE: AS NOTED | ISSUE DATE: 4/27/2018 APPROVED BY: WJF

- 2. ALL WORK SHALL BE PERFORMED IN ACCORDANCE WITH THESE PLANS AND SPECIFICATIONS AND THE REQUIREMENTS AND STANDARDS OF ALL GOVERNING AUTHORITIES.
- 3. PRIOR TO STARTING CONSTRUCTION, THE CONTRACTOR SHALL BE RESPONSIBLE TO CONFIRM THAT ALL REQUIRED PERMITS AND APPROVALS HAVE BEEN OBTAINED. NO CONSTRUCTION OR FABRICATION SHALL BEGIN UNTIL THE CONTRACTOR HAS RECEIVED AND THOROUGHLY REVIEWED ALL PLANS AND OTHER DOCUMENTS APPROVED BY ALL OF THE PERMITTING AUTHORITIES AND UNTIL THE MANDATORY PRE—CONSTRUCTION MEETING HAS BEEN CONDUCTED. CONTRACTOR SHALL BE RESPONSIBLE FOR ALL DEMOLITION AND BUILDING PERMITS.
- 4. IF CONTRACTOR OBSERVES ANY FIELD CONDITIONS WHICH VARY SIGNIFICANTLY FROM WHAT IS SHOWN ON THESE PLANS, THE CONTRACTOR SHALL IMMEDIATELY NOTIFY THE OWNER AND THE OWNER'S REPRESENTATIVE FOR RESOLUTION OF THE CONFLICTING INFORMATION.
- 5. THE CONTRACTOR SHALL CALL NEW YORK STATE "DIG SAFELY" BY DIALING "811" OR 1-800-962-7962 A MINIMUM OF (2) TWO WORKING DAYS PRIOR TO START OF ANY WORK.
- 6. THE CONTRACTOR SHALL IMMEDIATELY REPORT ANY DAMAGE TO EXISTING PIPES, UTILITIES, OR STRUCTURES TO THE OWNER AND THE OWNER'S REPRESENTATIVE, AND OBTAIN DIRECTIONS AS TO REPAIR, REPLACEMENT OR ABANDONMENT.
- 7. THE LOCATIONS AND INFORMATION ABOUT UNDERGROUND PIPES, UTILITIES OR OTHER STRUCTURES ARE COMPILED FROM AVAILABLE RECORD DATA AND VISIBLE FIELD EVIDENCE AND ARE NOT REPRESENTED AS BEING EXACT OR COMPLETE.
- 8. THE CONTRACTOR SHALL COORDINATE WITH RESPONSIBLE UTILITY FOR WORK NEAR/AROUND EXISTING OVERHEAD POWER LINES AND ANY UNDERGROUND LINES.
- 9. THE CONTRACTOR SHALL UNDERTAKE MEASURES TO PROTECT AND MAINTAIN THE CONDITION OF EXISTING BENCHMARKS.
- 10. THE CONTRACTOR SHALL MAINTAIN RECORD DRAWINGS DURING CONSTRUCTION WHICH SHOW "AS BUILT" CONDITION OF ALL WORK INCLUDING ALL FRAMING, RAILINGS, TOPOGRAPHY OF RESERVOIR, OUTLET STRUCTURE DIMENSIONS, ELEVATIONS, GRADING, ETC. RECORD DRAWINGS SHALL BE PROVIDED TO THE ENGINEER OF RECORD PRIOR TO REQUESTING FINAL INSPECTION.
- 11. DO NOT CHANGE SPACING OF STRUCTURAL ELEMENTS.
- 12. DETAILS SHOWN ARE TYPICAL; SIMILAR DETAILS APPLY TO SIMILAR CONDITIONS UNLESS OTHERWISE INDICATED.
- 13. THE CONTRACTOR SHALL NOTIFY THE OWNER'S REPRESENTATIVE IN WRITING OF PROPOSED DEVIATIONS OR SUBSTITUTIONS OF DIMENSIONS, MATERIALS, OR EQUIPMENT SHOWN ON THE DRAWINGS AND MAKE ONLY THOSE DEVIATIONS OR SUBSTITUTIONS THAT ARE ACCEPTED BY OWNER'S REPRESENTATIVE.
- 14. THESE DRAWINGS DO NOT INCLUDE NECESSARY COMPONENTS FOR CONSTRUCTION SAFETY. THE CONTRACTOR SHALL BE SOLELY RESPONSIBLE FOR CONSTRUCTION SAFETY AND FOR COMPLIANCE WITH ALL OSHA REGULATIONS DURING CONSTRUCTION.
- 15. THE CONTRACTOR SHALL INSTALL EROSION CONTROL DEVICES PRIOR TO CONSTRUCTION ACTIVITY AND SHALL BE RESPONSIBLE FOR THEIR MAINTENANCE, REPOSITIONING AND REMOVAL. THE CONTRACTOR SHALL ENSURE PROPER EROSION AND SEDIMENT CONTROL IS MAINTAINED THROUGHOUT CONSTRUCTION.
- 16. THE CONTRACTOR SHALL TAKE PRECAUTIONS TO PREVENT DAMAGE TO WORK OR EQUIPMENT BY HIGH WATER OR BY STORMS.
- 17. THE CONTRACTOR SHALL BRACE, SUPPORT, AND SHORE THE EXISTING STRUCTURES AS REQUIRED FOR REMOVALS AND SHALL MAINTAIN ALL SUPPORT MEASURES UNTIL ALL CONCRETE REPAIRS HAVE CURED A MINIMUM OF 7 DAYS.
- 18. THE CONTRACTOR SHALL NOT BEGIN ANY DEMOLITION UNTIL AFTER RECEIVING WRITTEN AUTHORIZATION FROM THE OWNER TO BEGIN DEMOLITION.
- 19. ALL CONSTRUCTION DEBRIS AND EXCESS MATERIAL SHALL BE HAULED AWAY AND DISPOSED OF APPROPRIATELY AT THE CONTRACTOR'S EXPENSE.
- 20. THE CONTRACTOR SHALL VISIT THE SITE TO FAMILIARIZE HIMSELF OR HERSELF WITH EXISTING CONDITIONS AND THE EXTENT OF DEMOLITION REQUIRED, PRIOR TO THE BID SUBMISSION.
- 21. FAILURE BY THE CONTRACTOR TO NOTIFY THE OWNER'S REPRESENTATIVE OF ERRORS OR OMISSIONS SHALL CONSTITUTE ACCEPTANCE OF FULL RESPONSIBILITY BY THE CONTRACTOR TO COMPLETE THE SCOPE OF WORK AS DEFINED BY THE DRAWINGS AND SPECIFICATIONS.
- 22. THE CONTRACTOR SHALL ENSURE THAT THE ESTABLISHMENT AND MAINTENANCE OF TWO BENCHMARKS BE PERFORMED BY A LICENSED LAND SURVEYOR THROUGHOUT CONSTRUCTION.

- SOIL EROSION AND SEDIMENT CONTROL NOTES:
- 1. ALL APPLICABLE SOIL EROSION AND SEDIMENT CONTROL PRACTICES SHALL BE INSTALLED PRIOR TO ANY MAJOR SOIL OR STREAM DISTURBANCE, IN THEIR PROPER SEQUENCE, AND MAINTAINED UNTIL PERMANENT PROTECTION IS ESTABLISHED.
- 2. THE CONTRACTOR SHALL NOT DISTURB SOIL (CLEAR, GRUB, GRADE, EXCAVATE OR DEWATER) IN AREAS OUTSIDE OF THOSE SPECIFIED ON THE PLAN AND AS APPROVED.
- 3. ALL DISTURBED AREAS OUTSIDE OF THE RIVER CHANNEL THAT ARE NOT STABILIZED BY A TEMPORARY CONSTRUCTION ROAD SHALL RECEIVE A TEMPORARY SEEDING. MULCH, WATER AND ANCHOR AS NECESSARY TO ESTABLISH GRASS AND PREVENT LOSS TO WIND OR EROSION WITHIN 7 DAYS OF DISTURBANCE UNLESS OTHERWISE APPROVED BY THE OWNER. IF THE SEASON PREVENTS THE ESTABLISHMENT OF A TEMPORARY COVER, THE DISTURBED AREAS SHALL BE MULCHED WITH SMALL GRAIN STRAW AT A RATE OF TWO (2) TONS PER ACRE, AND ANCHORED IN ACCORDANCE WITH NEW YORK STATE STANDARDS.
- 4. PERMANENT VEGETATION SHALL BE SEEDED OR SODDED ON ALL EXPOSED SOIL AREAS IMMEDIATELY AFTER FINAL GRADING. TOPSOIL SHALL BE PROVIDED TO A MINIMUM DEPTH OF 4 INCHES. MULCH TO BE USED AS NECESSARY FOR PROTECTION UNTIL TURF IS ESTABLISHED.
- 5. ALL CRITICAL AREAS SUBJECT TO EROSION (I.E. SLOPES, STREAM BANKS AND ROADWAY EMBANKMENTS) SHALL RECEIVE STABILIZATION PER THE DETAILS AND SPECIFICATIONS. IF NOT OTHERWISE SPECIFIED, JUTE MESH (MIN. 700 GRAM/SQUARE YARD) AND SEED SHALL BE PLACED OVER DISTURBED EARTH IN ACCORDANCE WITH MANUFACTURER'S INSTALLATION REQUIREMENTS.
- 6. SHOULD THE CONTROL OF DUST AT THE SITE BE NECESSARY, THE SITE SHALL BE SPRINKLED WITH WATER UNTIL THE SURFACE IS WET, TEMPORARY VEGETATIVE COVER SHALL BE ESTABLISHED OR MULCH SHALL BE APPLIED IN ACCORDANCE WITH STATE STANDARDS FOR EROSION CONTROL.
- 7. AT THE COMPLETION OF CONSTRUCTION, ALL DISTURBED AREAS SHALL RECEIVE PERMANENT SEEDING AND MULCH PER NEW YORK STATE STANDARDS AND SPECIFICATIONS FOR EROSION AND SEDIMENT CONTROL, UNLESS OTHERWISE NOTED.
- 8. ALL SOIL WASHED, DROPPED, SPILLED, OR TRACKED OUTSIDE THE LIMIT OF DISTURBANCE OR ONTO PUBLIC RIGHTS—OF—WAY SHALL BE REMOVED IMMEDIATELY.
- 9. STOCKPILE AND STAGING LOCATIONS DETERMINED IN THE FIELD SHALL BE PLACED WITHIN THE LIMIT OF DISTURBANCE. ALL SOIL STOCKPILES SHALL BE TEMPORARILY COVERED WITH AN IMPERMEABLE MEMBRANE OR TEMPORARY VEGETATION AND PROTECTED BY A SILT FENCE PER STATE STANDARDS AROUND THE PERIMETER OF THE STOCKPILE AT THE TOE OF THE SLOPE.
- 10. ALL WORK SHALL BE DONE IN ACCORDANCE WITH THE NEW YORK STATE STANDARDS AND SPECIFICATIONS FOR EROSION AND SEDIMENT CONTROL AND APPLICABLE STATE POLLUTANT DISCHARGE ELIMINATION SYSTEM (SPDES) STANDARDS.
- 11. THE CONTRACTOR SHALL INSPECT DISTURBED AREAS OF THE CONSTRUCTION SITE, AREAS USED FOR STORAGE OF MATERIALS THAT ARE EXPOSED TO PRECIPITATION THAT HAVE NOT BEEN FINALLY STABILIZED, STABILIZATION PRACTICES, STRUCTURAL PRACTICES, AND OTHER CONTROLS AT LEAST ONCE EVERY SEVEN (7) CALENDAR DAYS AND WITHIN 24 HOURS OF THE END OF ANY STORM THAT PRODUCES 0.5 INCH OR MORE RAINFALL AT THE SITE. WHERE SITES HAVE BEEN FINALLY STABILIZED, SUCH INSPECTION SHALL BE CONDUCTED AT LEAST ONCE EVERY MONTH UNTIL FINAL COMPLETION. CRITICAL AREAS AND AREAS WHERE VEHICLES EXIT THE SITE SHALL BE INSPECTED DAILY.
- 12. THE CONTRACTOR SHALL SUBMIT A SCHEDULE WHICH INCLUDES ANTICIPATED DATES FOR IMPLEMENTATION AND REMOVAL OF EROSION AND SEDIMENT CONTROLS AND ANY PHASING REQUIRED PRIOR TO THE START OF CONSTRUCTION FOR REVIEW AND APPROVAL.

#### WATER POLLUTION CONTROL NOTES


- 1. CARE SHALL BE TAKEN TO PROTECT THE MOUNTAIN VIEW LAKE AND SALMON RIVER.
- 2. NO SEDIMENTATION, CONCRETE, OR OTHER MATERIALS (DEBRIS) SHALL BE ALLOWED TO ENTER THE LAKE OR OTHER WATERWAYS.
- 3. ALL NECESSARY PRECAUTIONS SHALL BE TAKEN BY THE CONTRACTOR TO PREVENT THE ENTRANCE OF PETROLEUM PRODUCTS, FRESH CONCRETE, FRESH MORTAR, CONSTRUCTION DEBRIS AND SUSPENDED SEDIMENT INTO THE WATERWAY.
- 4. EQUIPMENT, TOOLS, AND TRUCKS USED FOR THIS PROJECT SHALL BE CLEANED IN SUCH A MANNER AS TO PREVENT WASH WATER OR DEBRIS FROM ENTERING ANY WATER BODY.
- 5. SPILLAGE OF HAZARDOUS SUBSTANCES INTO THE WATERWAY IS PROHIBITED BY THE CLEAN WATER ACT OF 1977. MEASURES INCLUDING PROPER MAINTENANCE OF CONSTRUCTION EQUIPMENT, DESIGNATING FUEL/HAZARDOUS SUBSTANCES HANDLING AREAS TO ALLOW SPILLS TO BE CONTAINED BEFORE REACHING THE WATERWAY, INSTRUCTING PERSONNEL NOT TO DISPOSE OF OIL AND OTHER SUCH MATERIALS INTO DRAINS OR INTO THE WATERWAY DIRECTLY, AND OTHER NECESSARY PROCEDURES SHALL BE IMPLEMENTED PRIOR TO ANY CONSTRUCTION ACTIVITIES.
- 6. ABSORBENT MATERIALS SHALL BE RETAINED ON-SITE IN THE EVENT A SPILL OCCURS.
- 7. MATERIALS PLACED IN OR ENTERING THE WATERBODY WHICH ARE NOT PART OF THE PERMANENT WORK SHALL BE REMOVED AND DISPOSED OF PROPERLY PRIOR TO PROJECT COMPLETION. THIS INCLUDES TEMPORARY COFFERDAMS AND ACCESS ROAD MATERIALS, SILT FENCE, HAY BALES AND OTHER SEDIMENT CONTROL DEVICES.

#### CONSTRUCTION WASTE MANAGEMENT PLAN

- 1. THE CONTRACTOR SHALL KEEP THE PREMISES FREE FROM ACCUMULATION OF WASTE MATERIALS OR RUBBISH CAUSED BY THEIR OPERATION. GOOD HOUSEKEEPING PRACTICES SHALL BE MAINTAINED ON A CONTINUOUS BASIS AT THE WORK SITE. DISPOSAL OF ANY WASTE MATERIALS ON THE CONSTRUCTION SITE IS PROHIBITED.
- 2. THE CONTRACTOR SHALL PROVIDE EMPLOYEE FACILITIES, WASTE DISPOSAL, AND SANITARY FACILITIES.
- 3. ALL WATER RESOURCES (I.E. GROUND AND SURFACE WATERS), INCLUDING ALL DRAINS AND CATCH BASINS, SHALL BE PROTECTED FROM LEACHING AND/OR RUN-OFF OF CHEMICAL POLLUTANTS, CONCRETE WASH WATER, SOLID WASTES AND CONSTRUCTION SITE DEBRIS. ALL CATCH BASINS SHALL BE MAINTAINED FREE FLOWING.
- 4. ALL TOXIC AND COMBUSTIBLE WASTE MATERIALS SHALL BE PLACED IN COVERED METAL CONTAINERS AND PROMPTLY DISPOSED OF IN AN APPROVED MANNER AT AN APPROVED WASTE DISPOSAL FACILITY.
- 5. DEMOLITION, REMOVAL, ALTERATION OR REPAIR, TRANSPORTATION, DISPOSAL, STORAGE, AND CONTAINMENT OF LEAD-BASED PAINT (LBP) MATERIALS SHALL BE IN ACCORDANCE WITH OCCUPATIONAL SAFETY AND HEALTH ADMINISTRATION (OSHA) REGULATION 29 CFR PART 1926 SUBPART D STANDARD 1926.62 LEAD.
- 6. STORAGE AND/OR USE OF LEAD-BASED MATERIALS, CHEMICALS, FUELS, OILS, GREASES, BITUMINOUS MATERIALS, SOLIDS, WASTE WASHINGS, AND CEMENT SHALL BE HANDLED APPROPRIATELY AS TO PREVENT LEACHING OR SURFACE RUN-OFF INTO PUBLIC WATERS OR DRAINS. ALL OWNER APPROVED STORAGE AREAS FOR THESE MATERIALS MUST BE DIKED.
- 7. ALL ROADWAYS SHALL BE MAINTAINED FREE OF DEBRIS. STABILIZED CONSTRUCTION ENTRANCES SHALL BE CONSTRUCTED TO CAPTURE DEBRIS FROM WHEELS OF CONSTRUCTION VEHICLES. VEHICLES SHALL BE INSPECTED AT ENTRANCES BEFORE TURNING ONTO THE ROADWAY AND EXCESS DEBRIS SHALL BE REMOVED.
- 8. CONCRETE WASHOUTS SHALL BE PROVIDED TO CONTAIN CONCRETE AND LIQUIDS WHEN THE CHUTES OF CONCRETE MIXERS AND HOPPERS OF CONCRETE PUMPS ARE RINSED OUT AFTER DELIVERY. THE WASHOUT FACILITIES CONSOLIDATE SOLIDS FOR EASIER DISPOSAL AND PREVENT RUNOFF OF LIQUIDS.
- 8. PROVIDE SELF-INSTALLED OR PREFABRICATED CONCRETE WASHOUT FACILITIES AT LOCATIONS ACCESSIBLE BY CONCRETE TRUCKS. DO NOT PLACE CONCRETE WASHOUT FACILITIES WITHIN 50 FEET OF STORM DRAINS, OPEN DITCHES, OR WATERBODIES.
- 9. REMOVE HARDENED SOLIDS IN CONCRETE WASHOUT FACILITIES AND DISPOSE OF OFFSITE.

#### CARE AND DIVERSION OF WATER NOTES

- 1. THE CONTRACTOR SHALL PROVIDE, INSTALL, MAINTAIN, AND REMOVE ALL WATER DIVERSION SYSTEMS, COFFERDAMS, STOPLOGS, PIPING AND PUMPS, ETC. AS REQUIRED TO PERFORM THE WORK AND BYPASS THE WATERBODY FLOWS AROUND THE WORK SITE DURING CONSTRUCTION. ALL SUCH FEATURES SHALL BE DESIGNED TO WITHSTAND, AT A MINIMUM, THE 10-YEAR STORM WITH 1 FOOT OF FREEBOARD.
- 2. THE CONTRACTOR SHALL PROVIDE SUFFICIENT PUMPING CAPACITY TO DEWATER THE WORK AREA AND ACCOUNT FOR LEAKAGE.
- 3. ALL WATER DIVERSION SYSTEMS, COFFERDAM, STOPLOGS, PIPING AND PUMPS SHALL BE DESIGNED BY A LICENSED PROFESSIONAL ENGINEER REGISTERED TO PRACTICE IN NEW YORK STATE PROCURED BY THE CONTRACTOR AND SUBMITTED TO THE OWNER AND ENGINEER FOR REVIEW AND APPROVAL PRIOR TO USE. SUGGESTED DETAILS ARE INCLUDED WITH THIS SET OF DRAWINGS.
- 4. COORDINATE INSTALLATION OF ALL DIVERSIONS AND COFFERDAM WITH THE OWNER AND IN ACCORDANCE WITH ALL REGULATORY REQUIREMENTS.
- 5. CONTRACTOR SHALL DEVELOP A PLAN TO SECURE THE WORK SITE AND BREACH THE DIVERSION AND/OR COFFERDAM WITH MINIMAL RELEASE OF SEDIMENT IN THE EVENT OF A STORM EVENT THAT WILL OVERTOP THE COFFERDAM. THE PLAN MUST BE BE SUBMITTED TO THE OWNER AND THE OWNER'S REPRESENTATIVE FOR APPROVAL PRIOR TO THE START OF CONSTRUCTION.

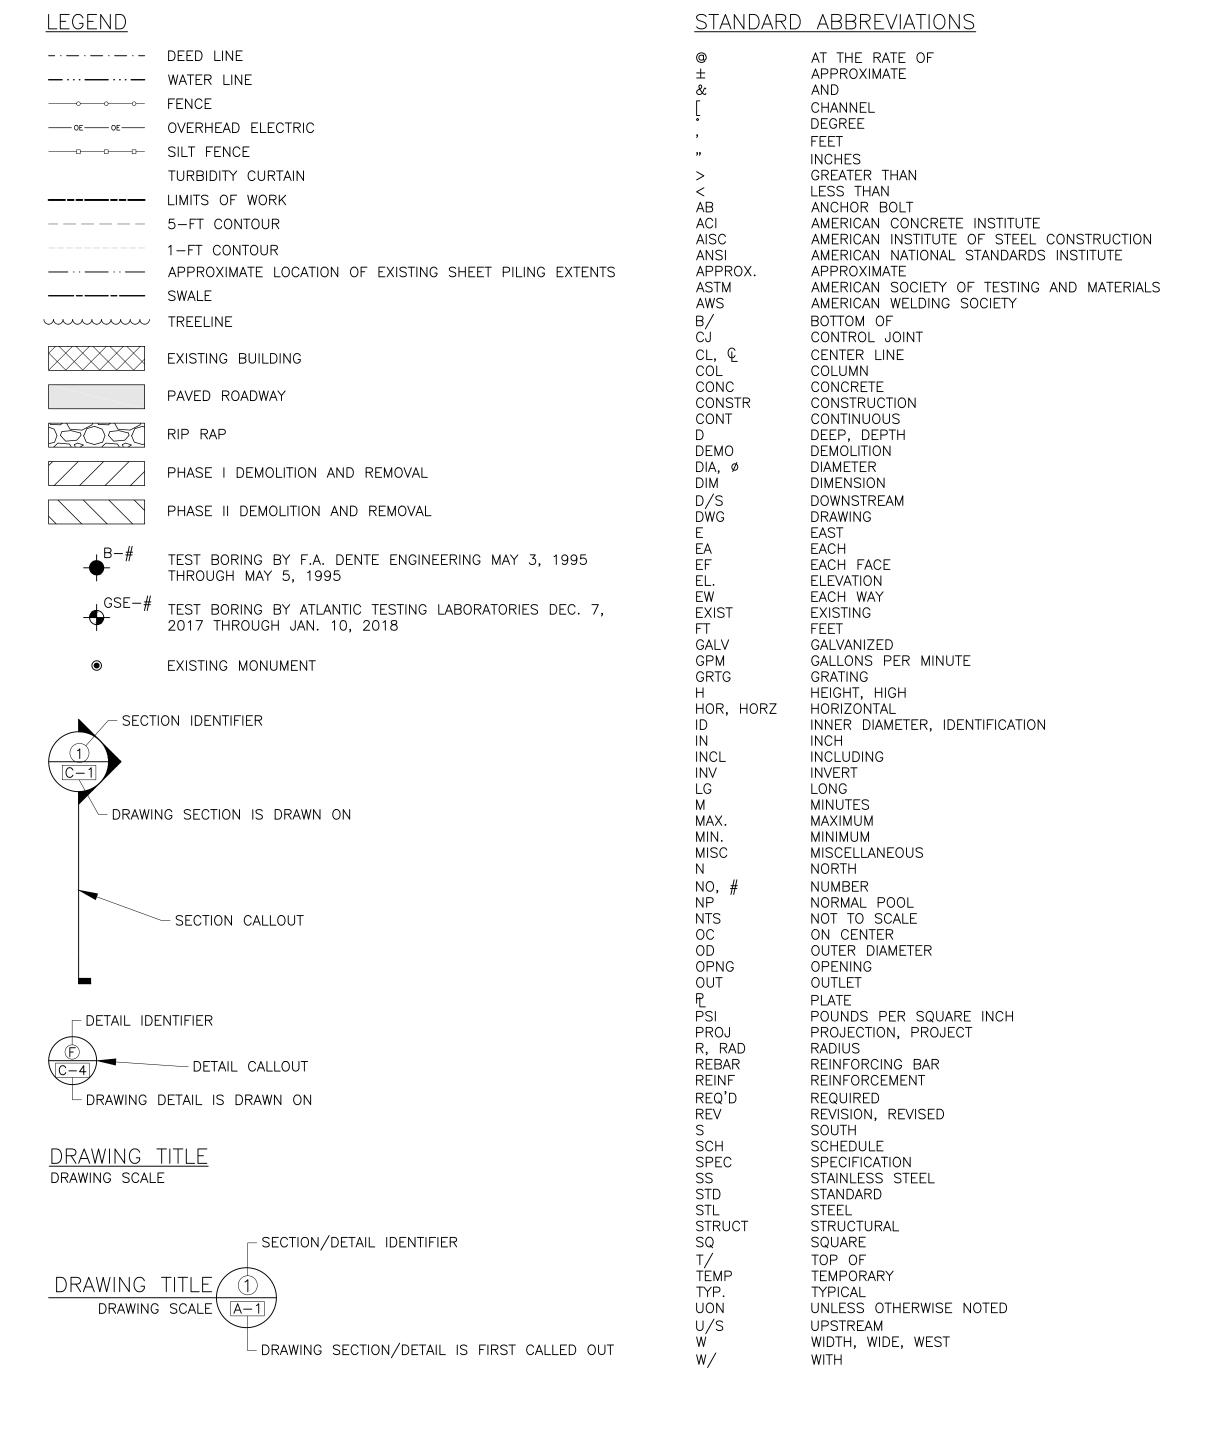

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MOUNTAIN VIEW LAKE DAM RECONSTRUCTION



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GENERAL NOTES, LEGEND, AND ABBREVIATIONS

JND/EAW | WJF

CHECKED BY: EAW

APPROVED BY: WJF

BY APP


ABBREVIATIONS


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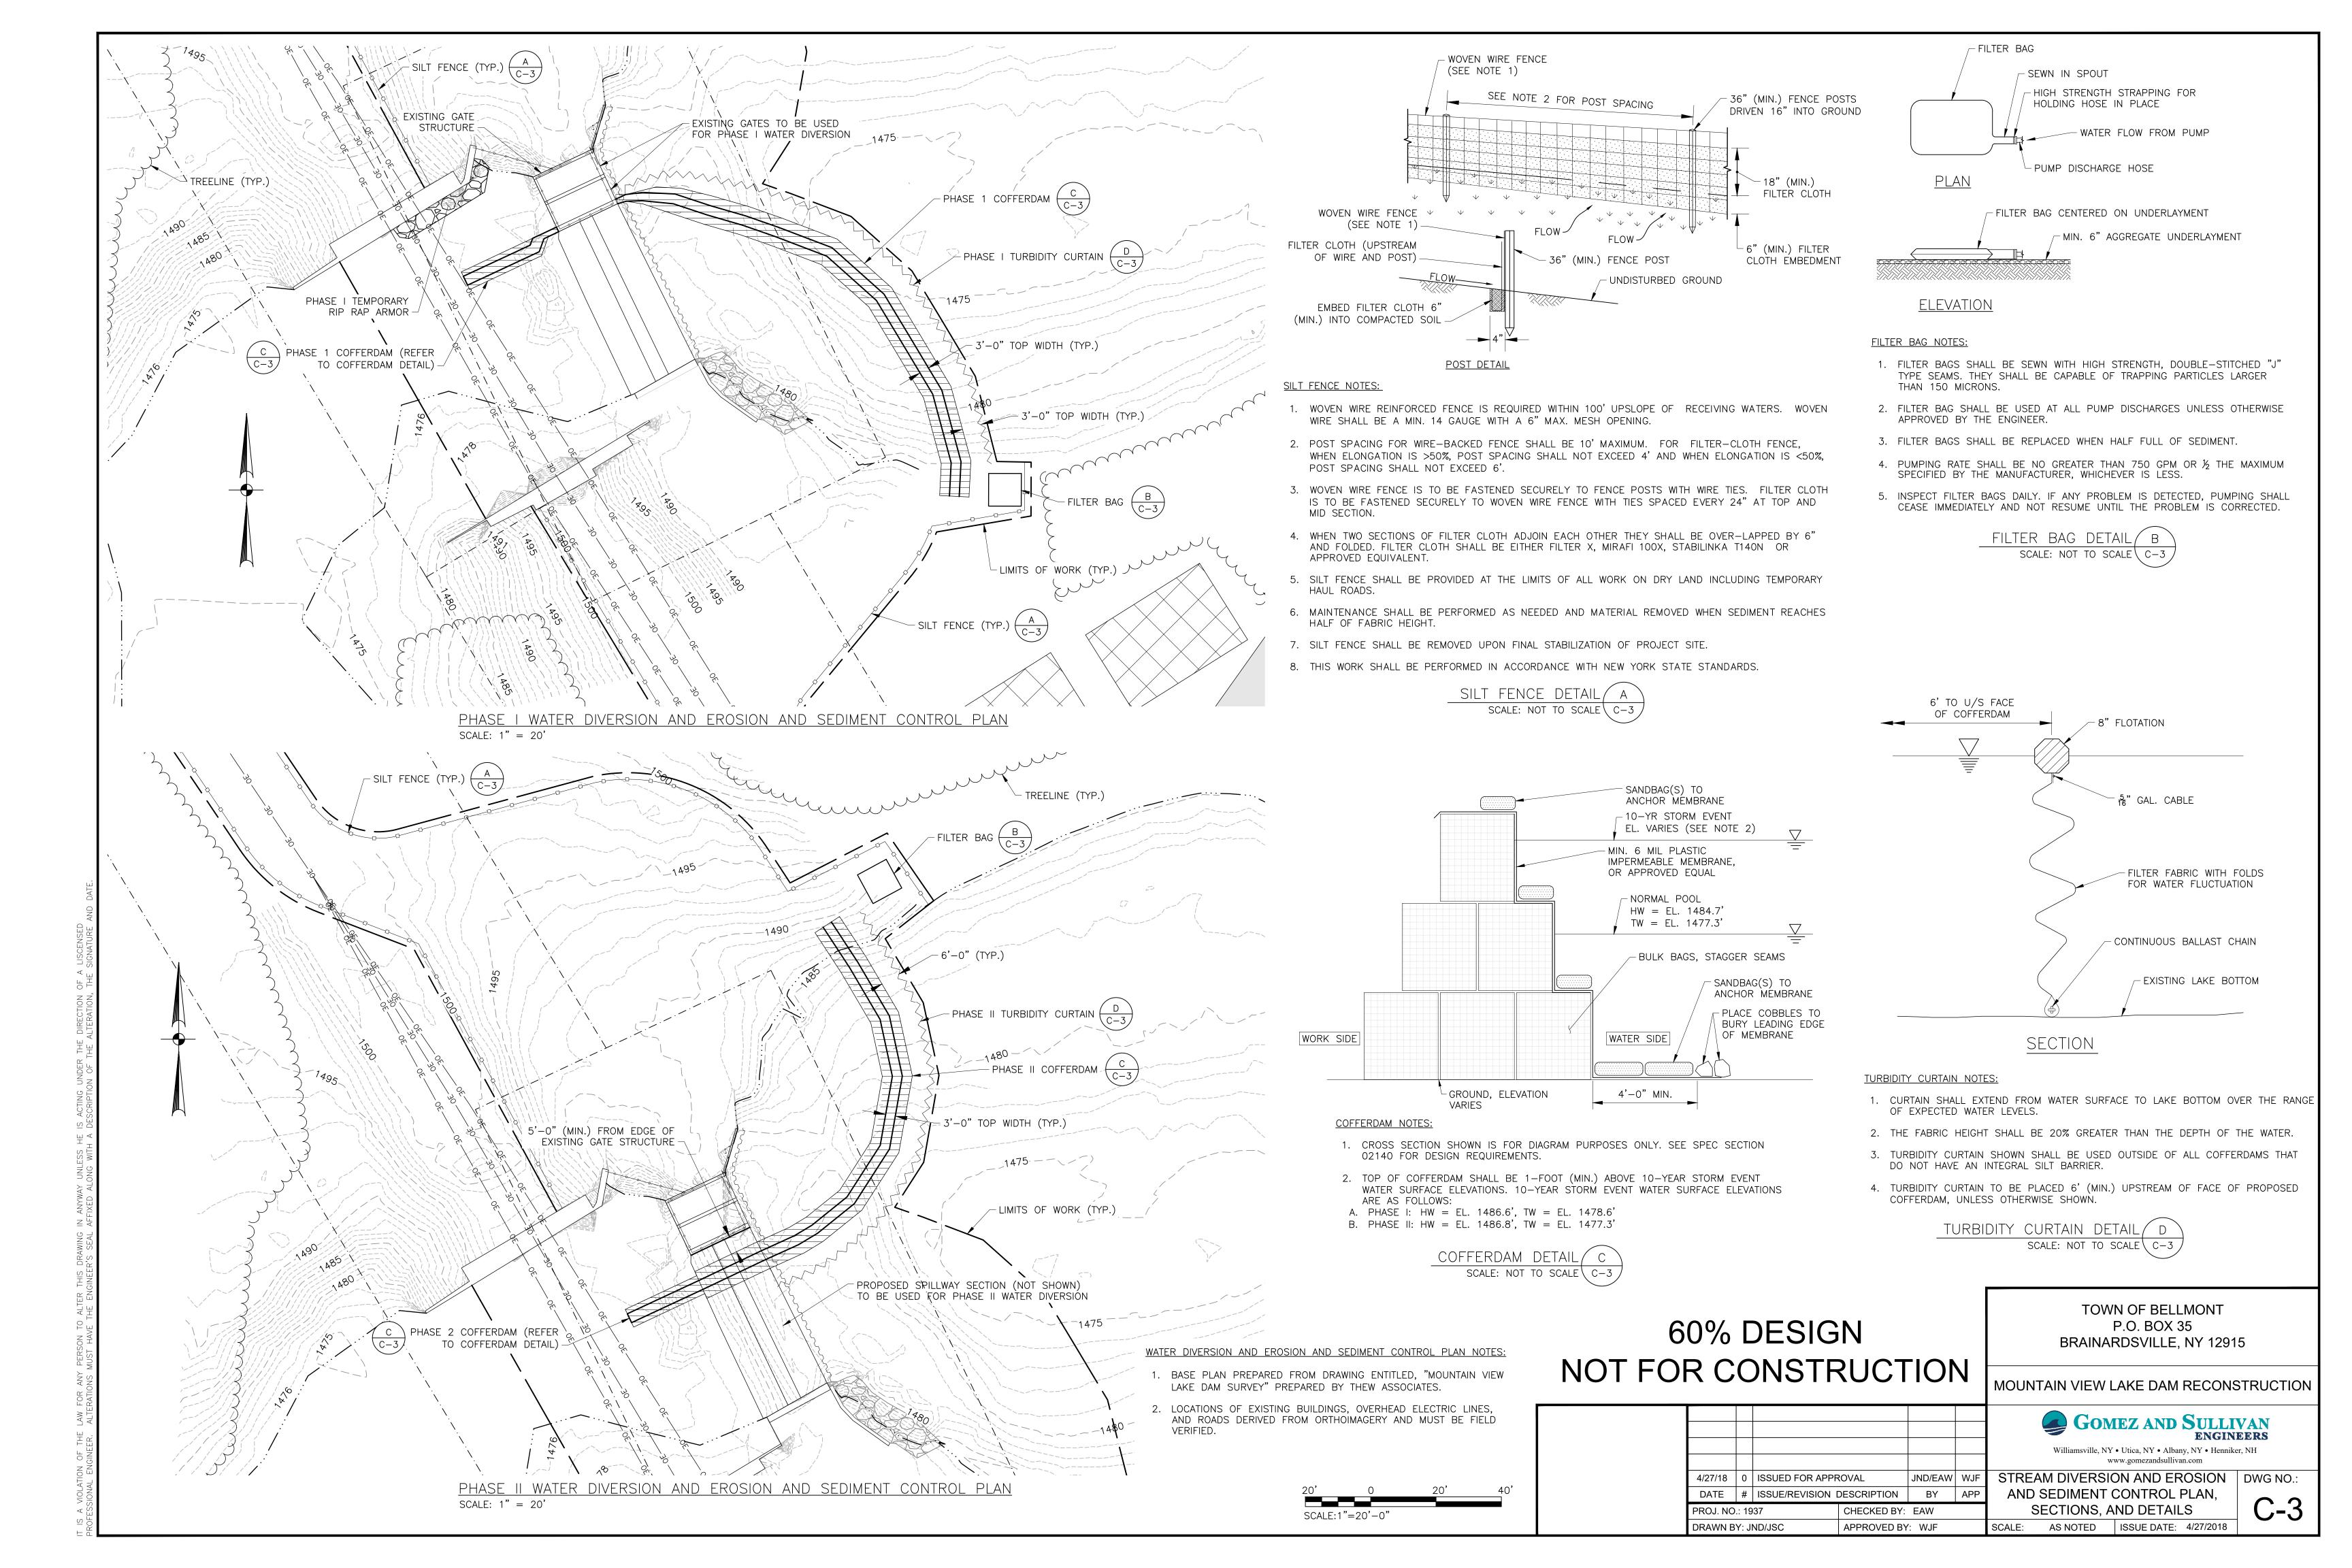
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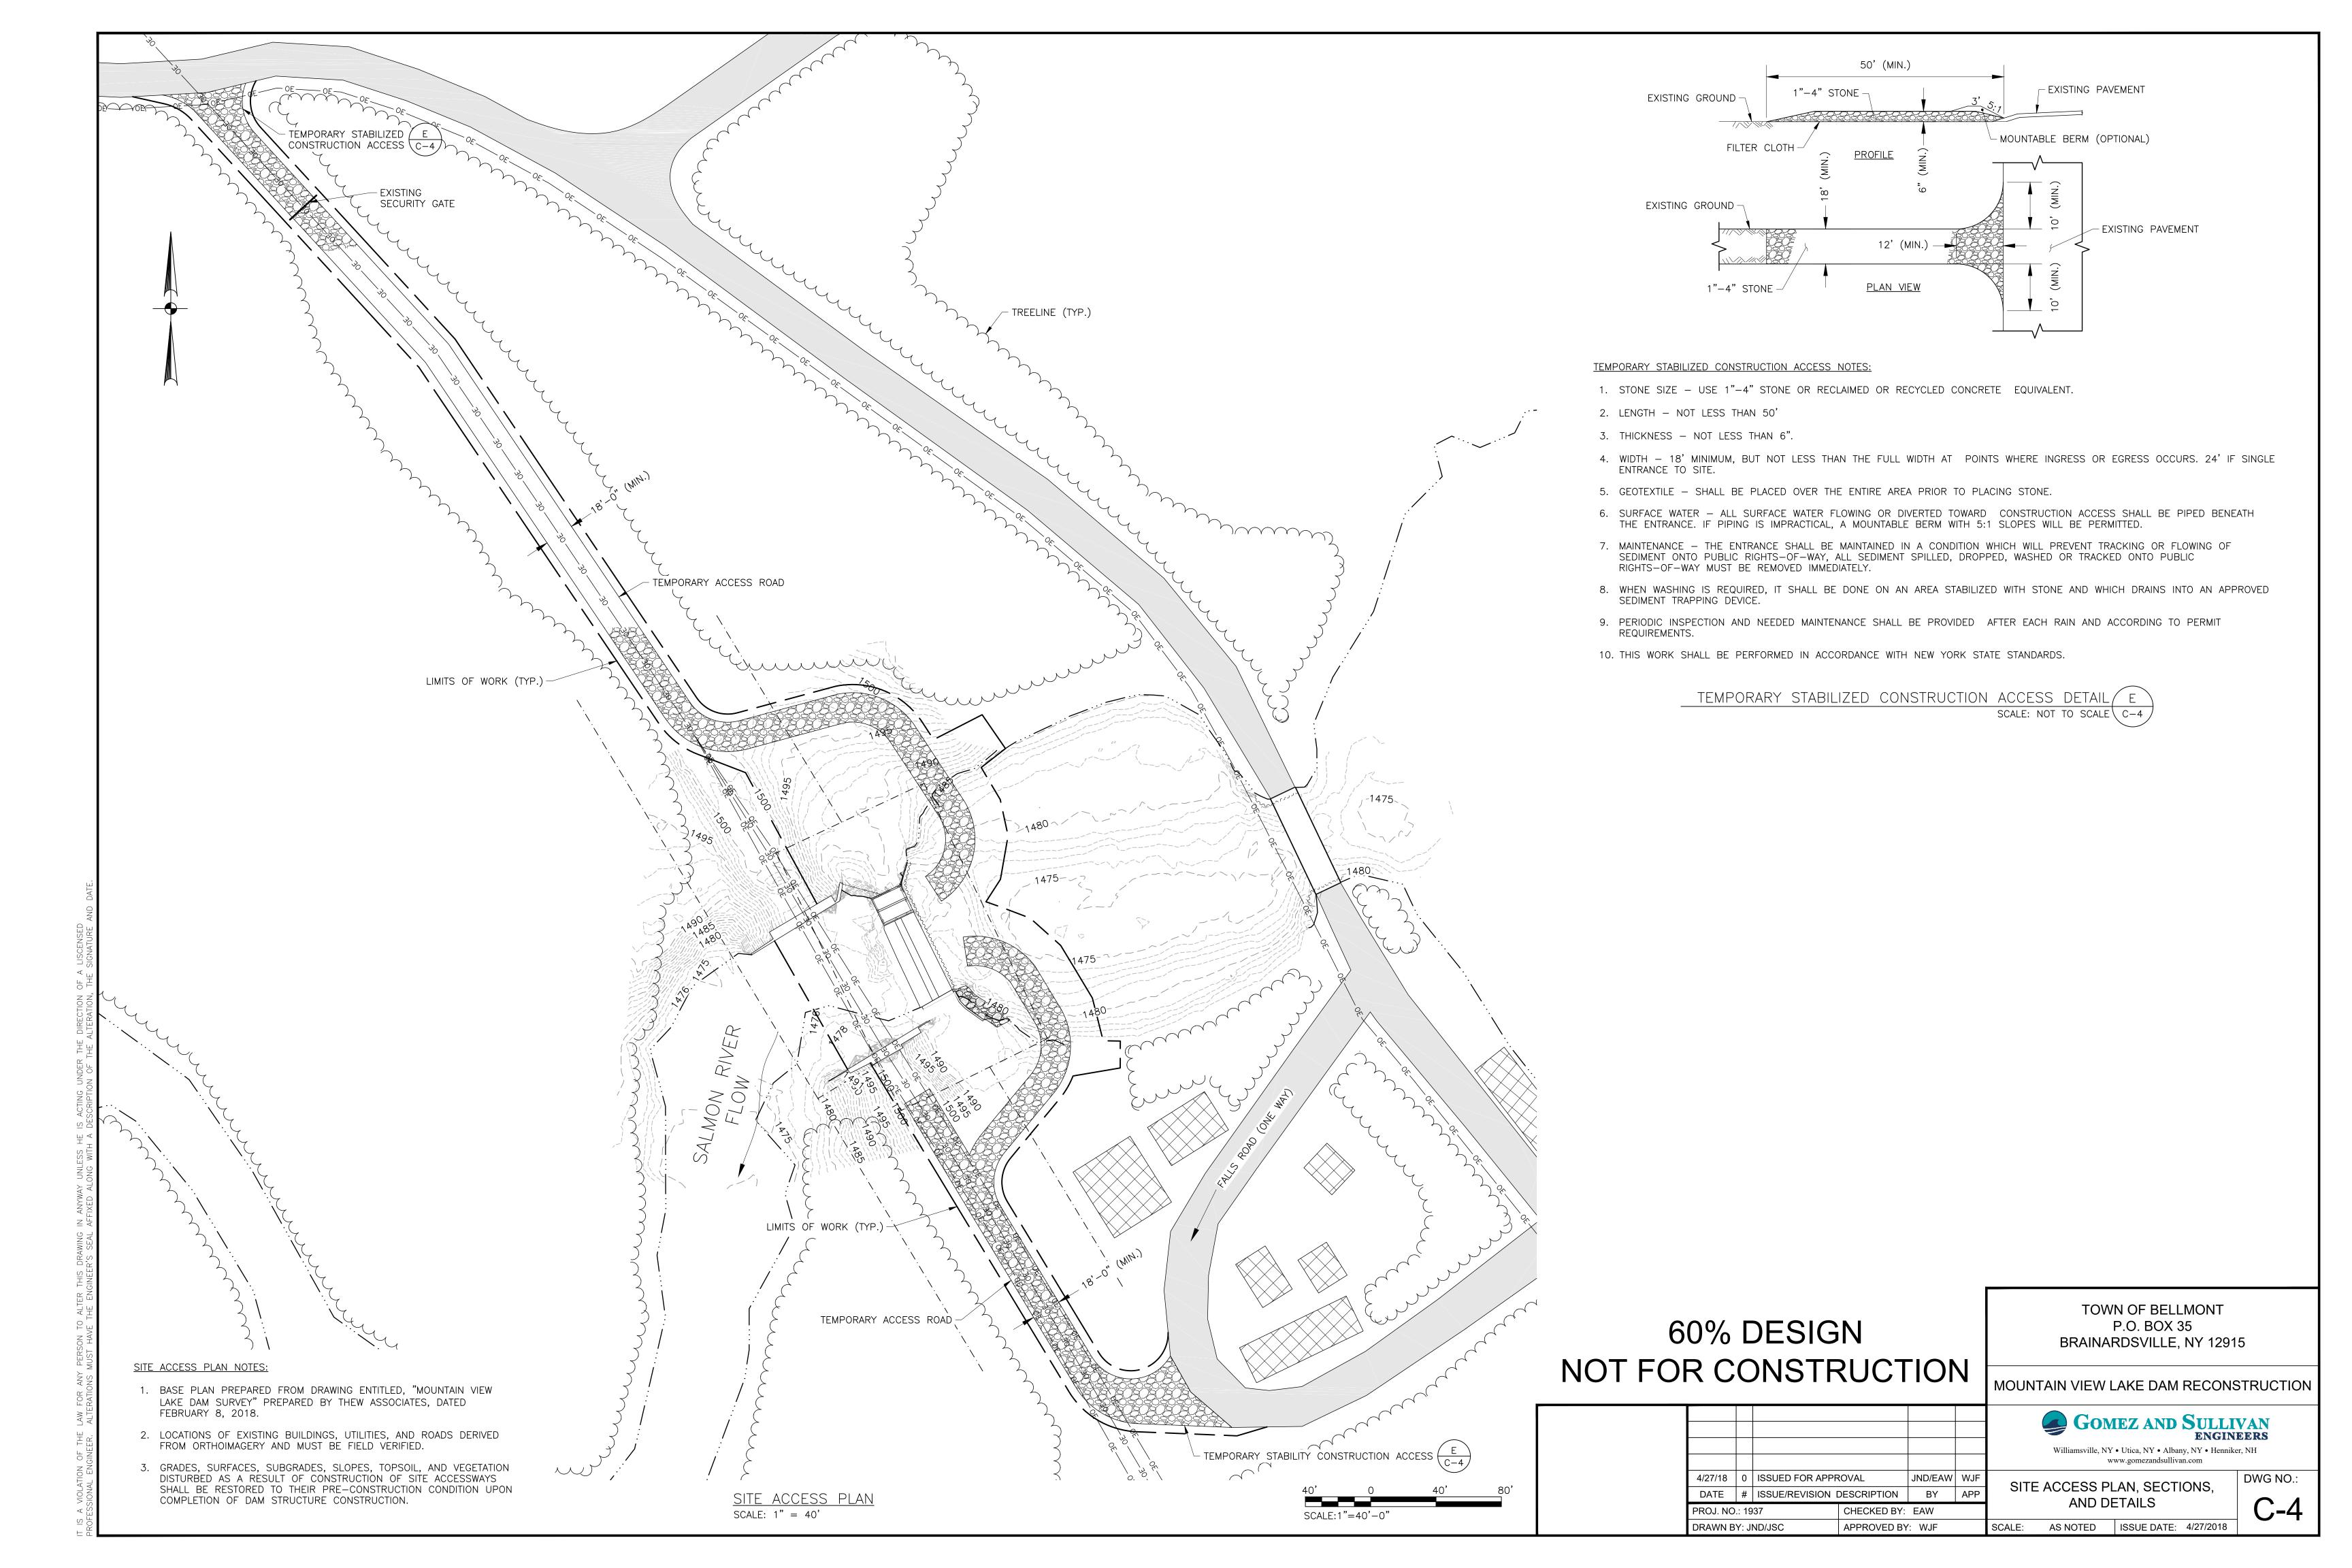
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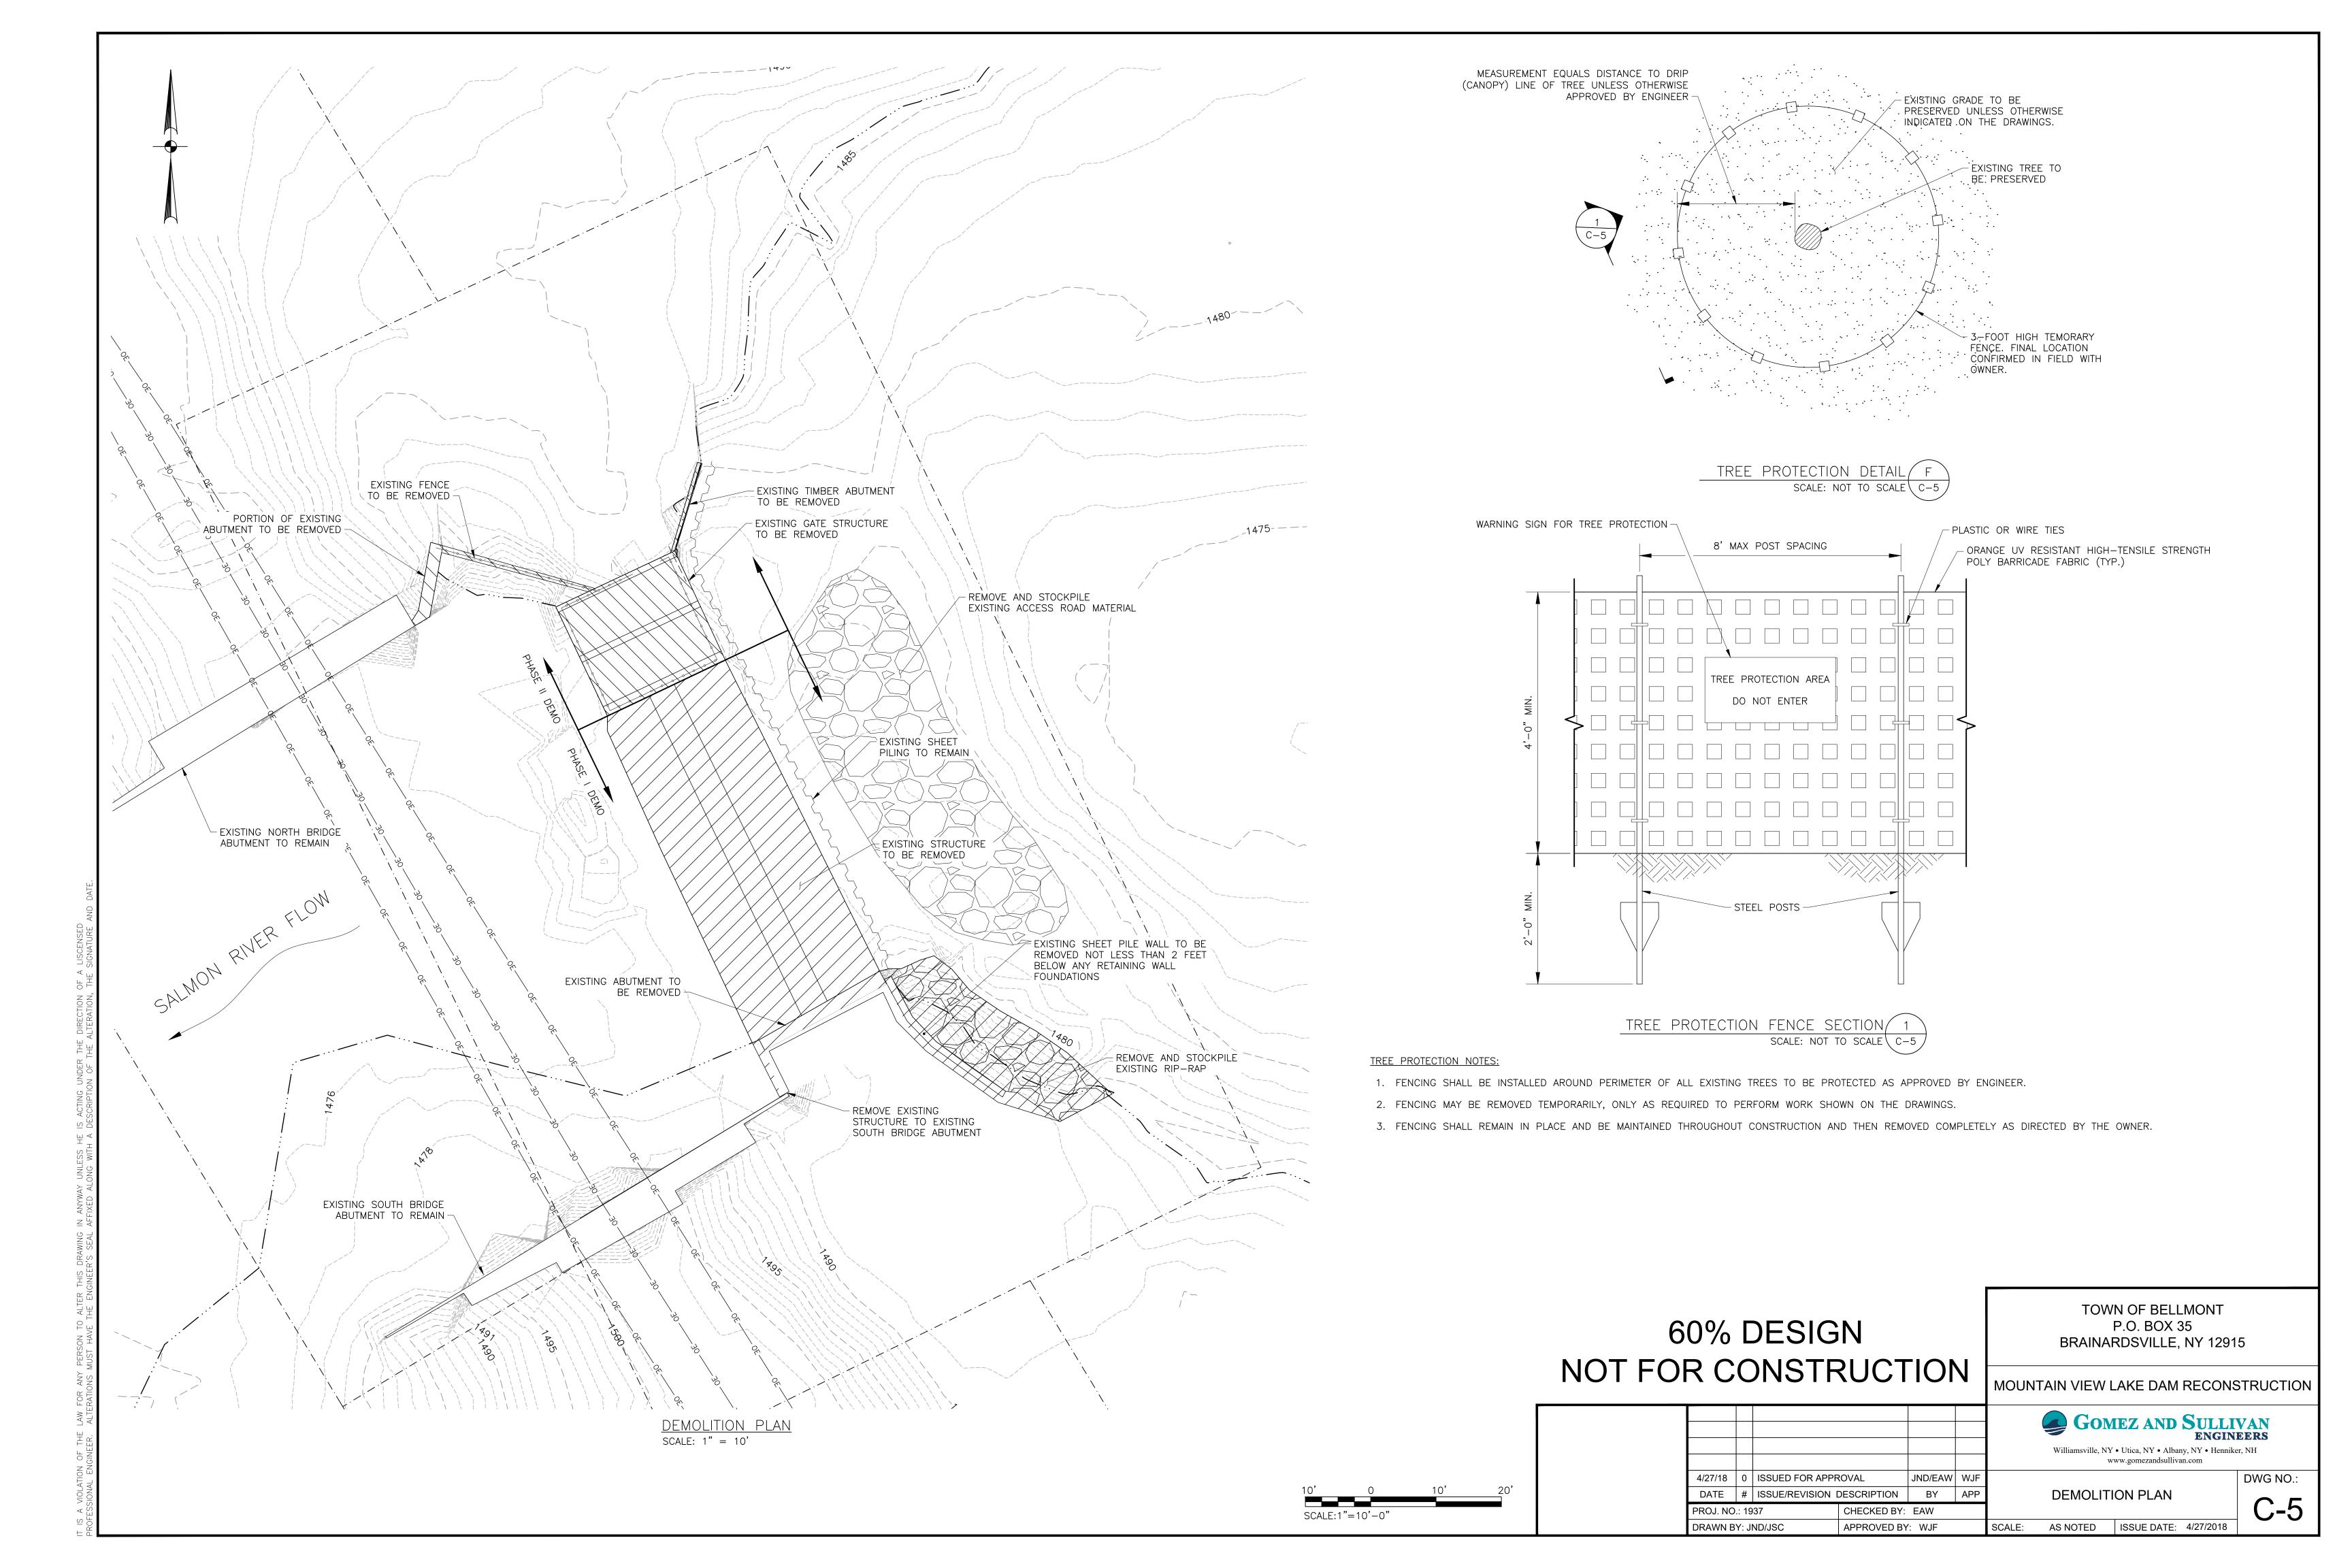
IT IS A VIOLATION OF THE LAW FOR ANY PERSON TO ALTER THIS DRAWING IN ANYWAY UNLESS HE IS ACTING UNDER THE DIRECTION OF A LISCENSE PROFESSIONAL ENGINEER. ALTERATIONS MUST HAVE THE ENGINEER'S SEAL AFFIXED ALONG WITH A DESCRIPTION OF THE ALTERATION, THE SIGNATURI










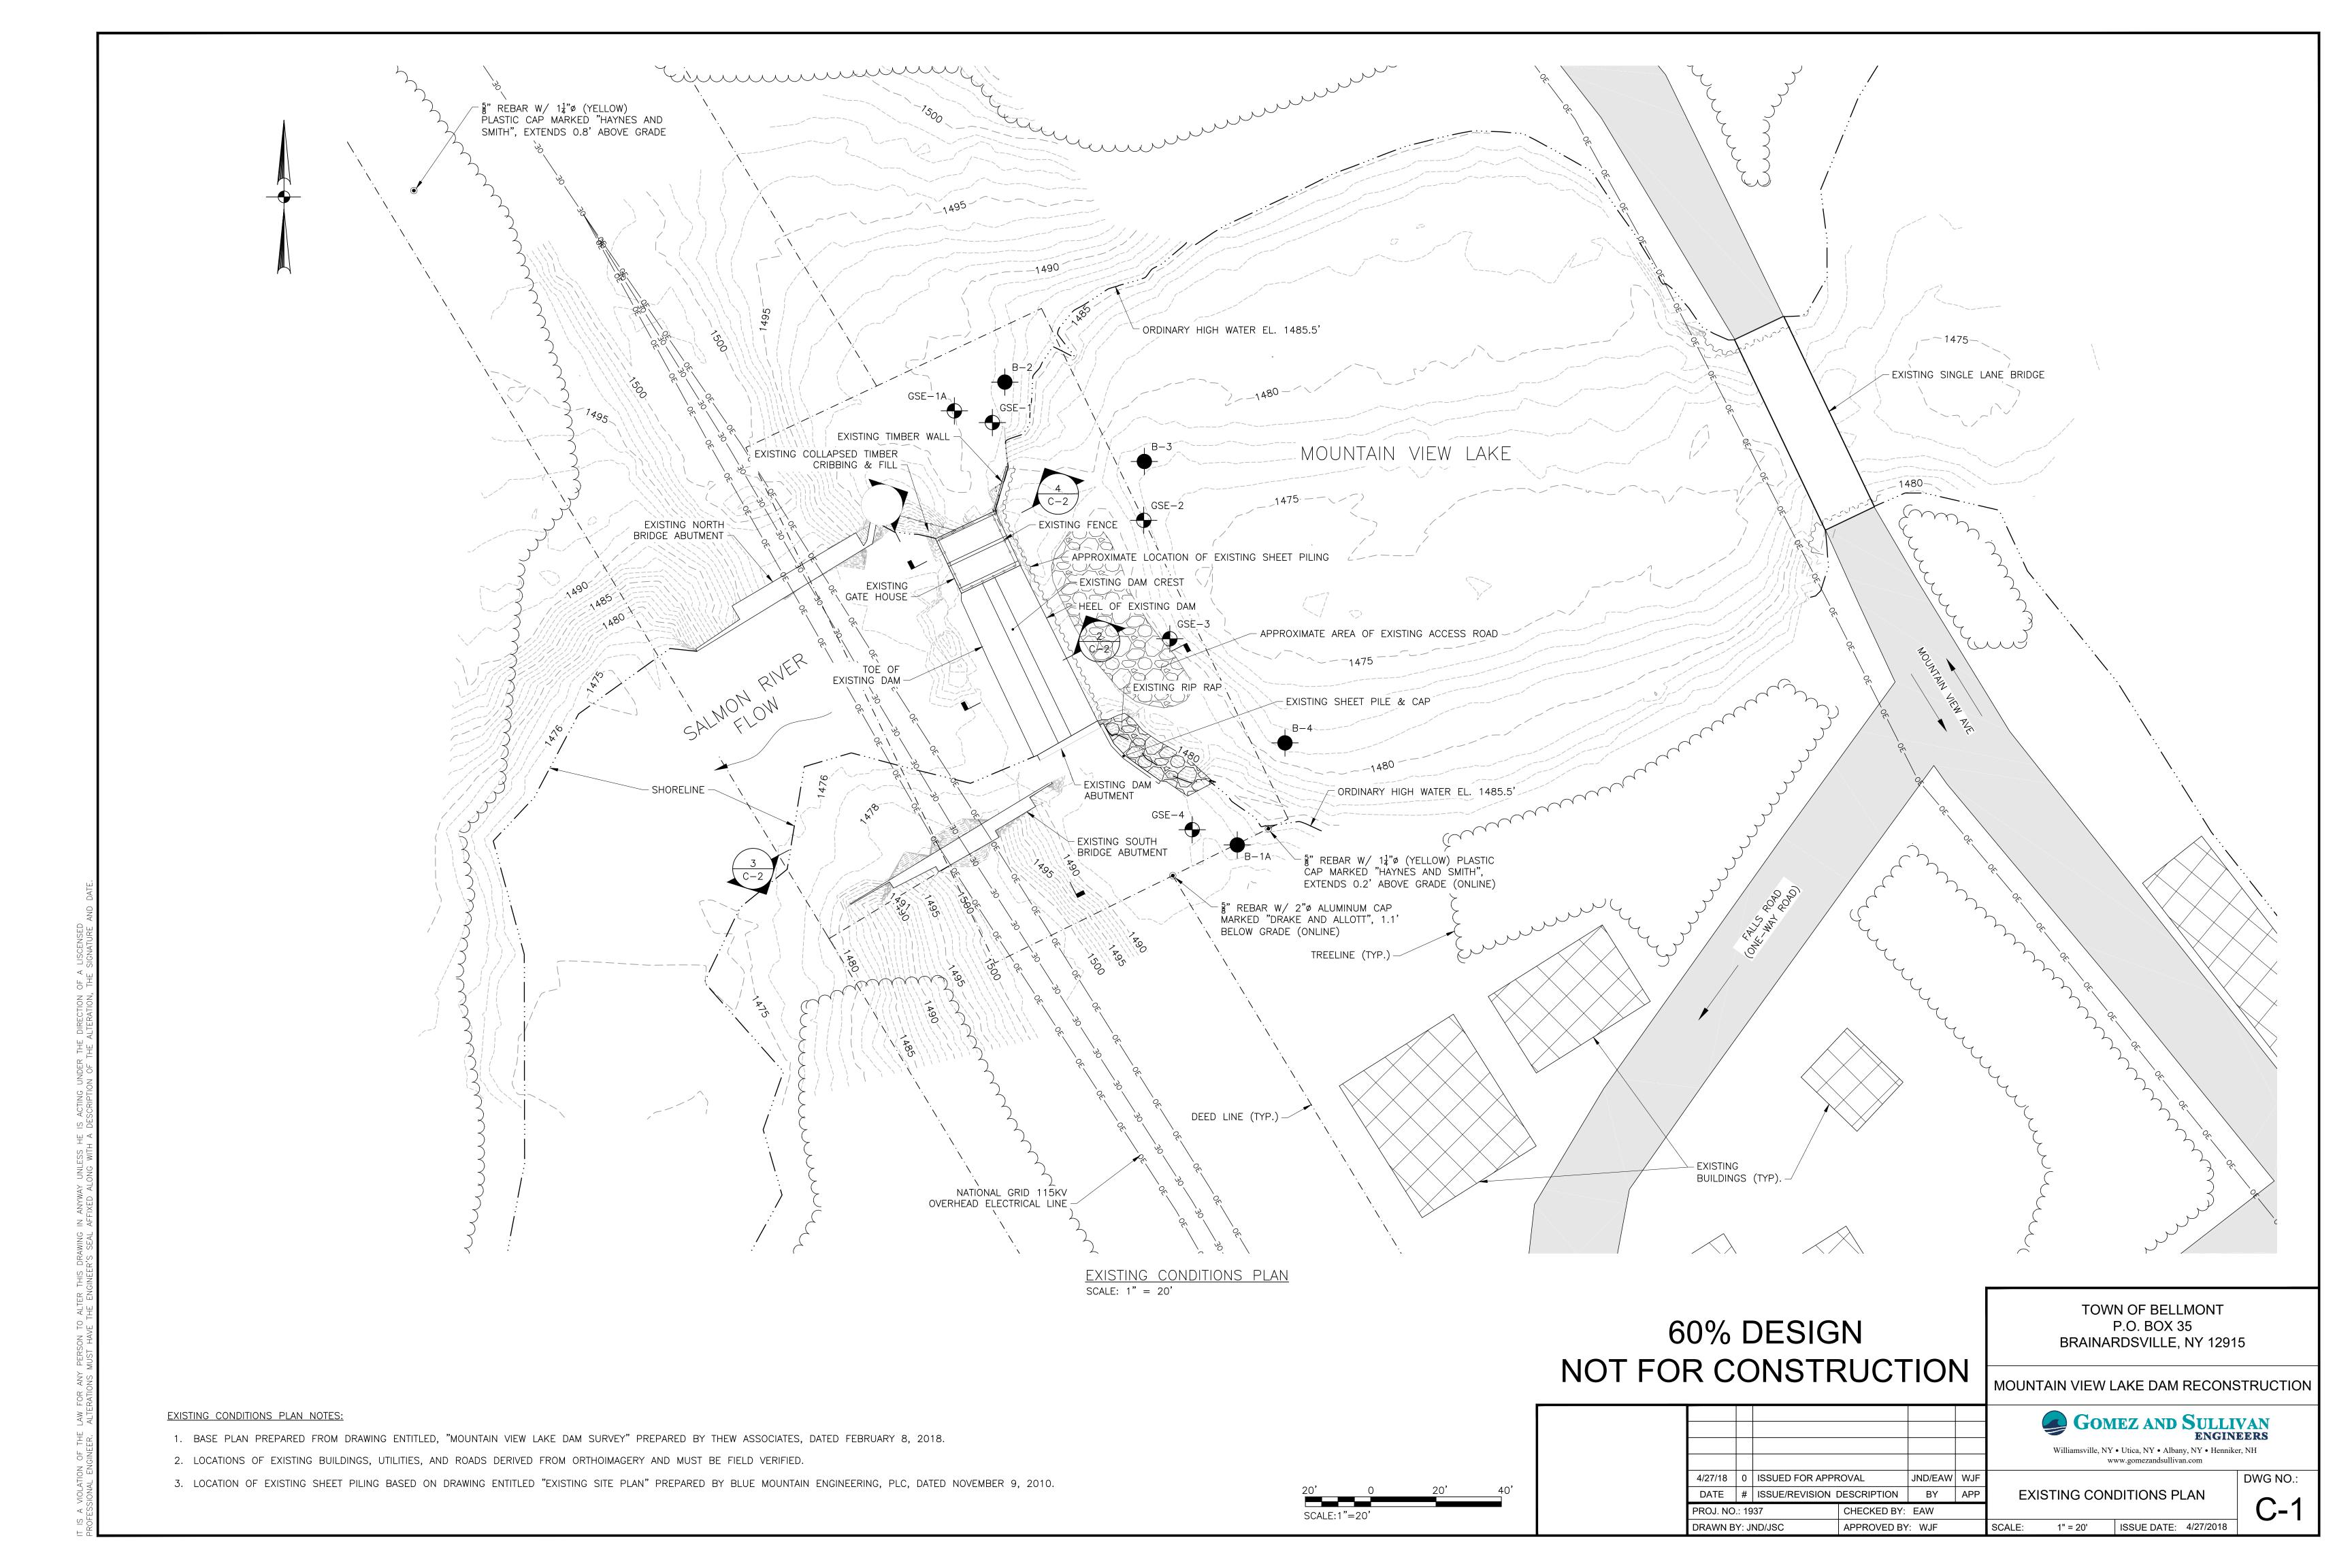

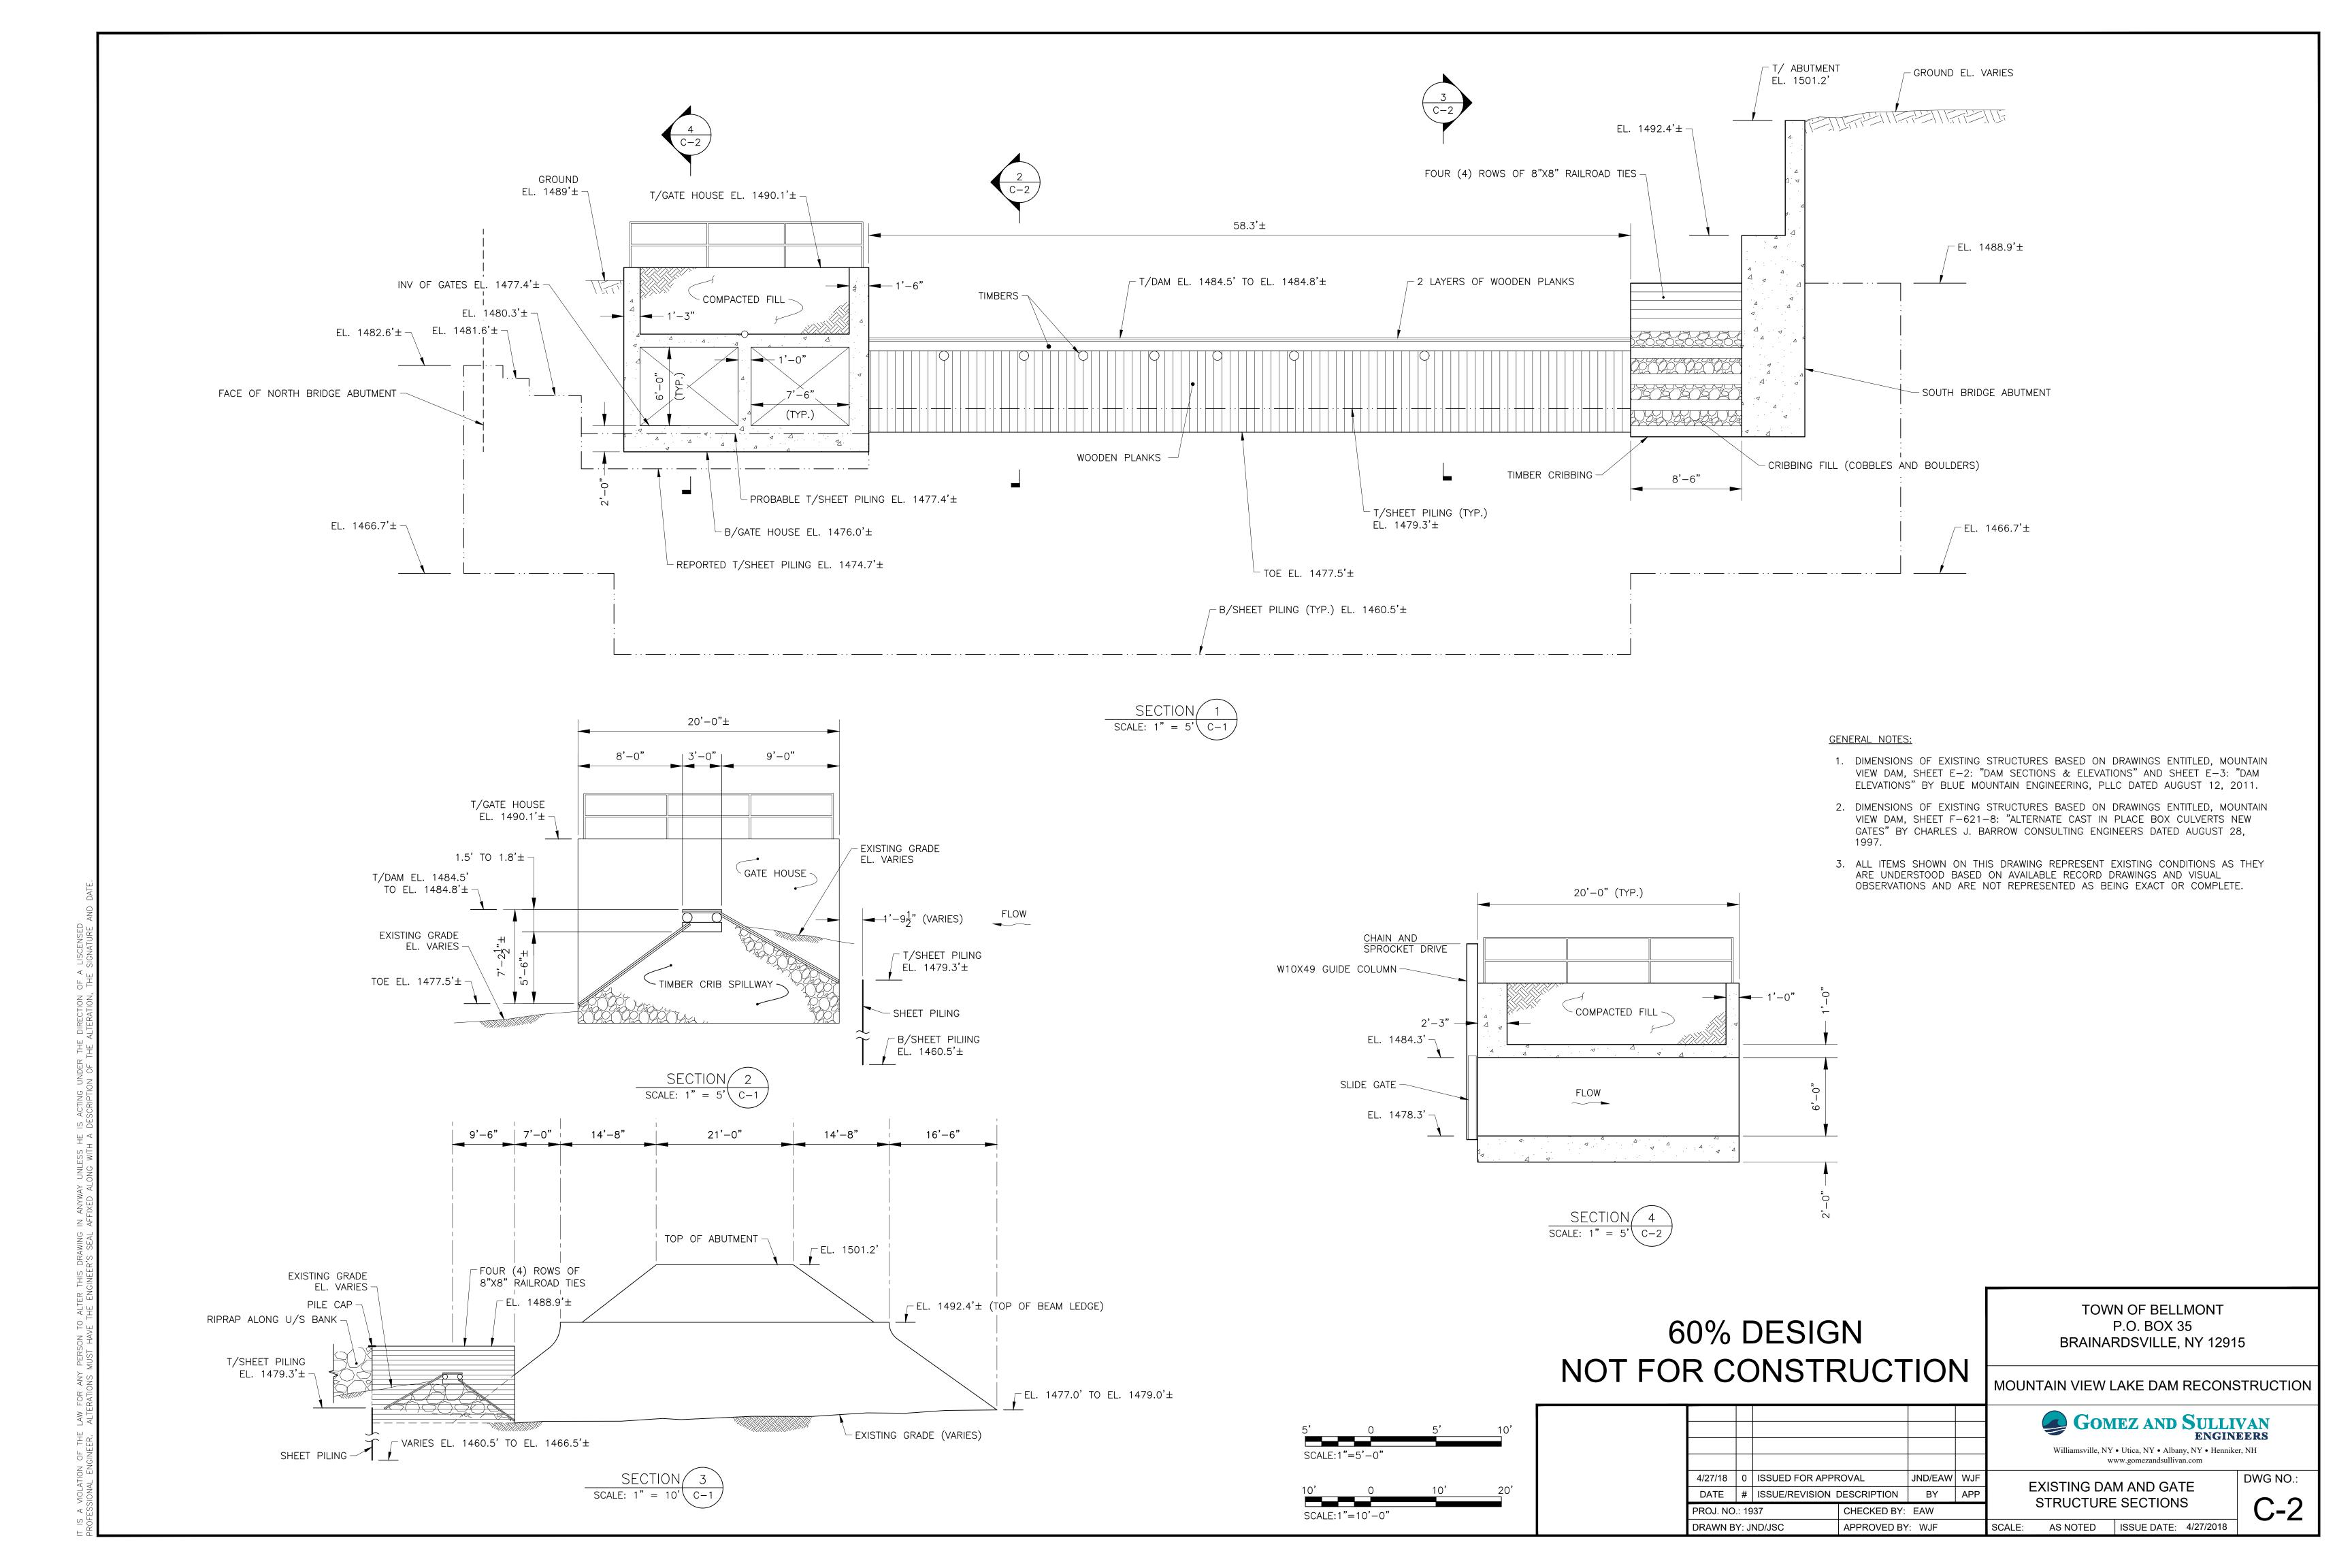


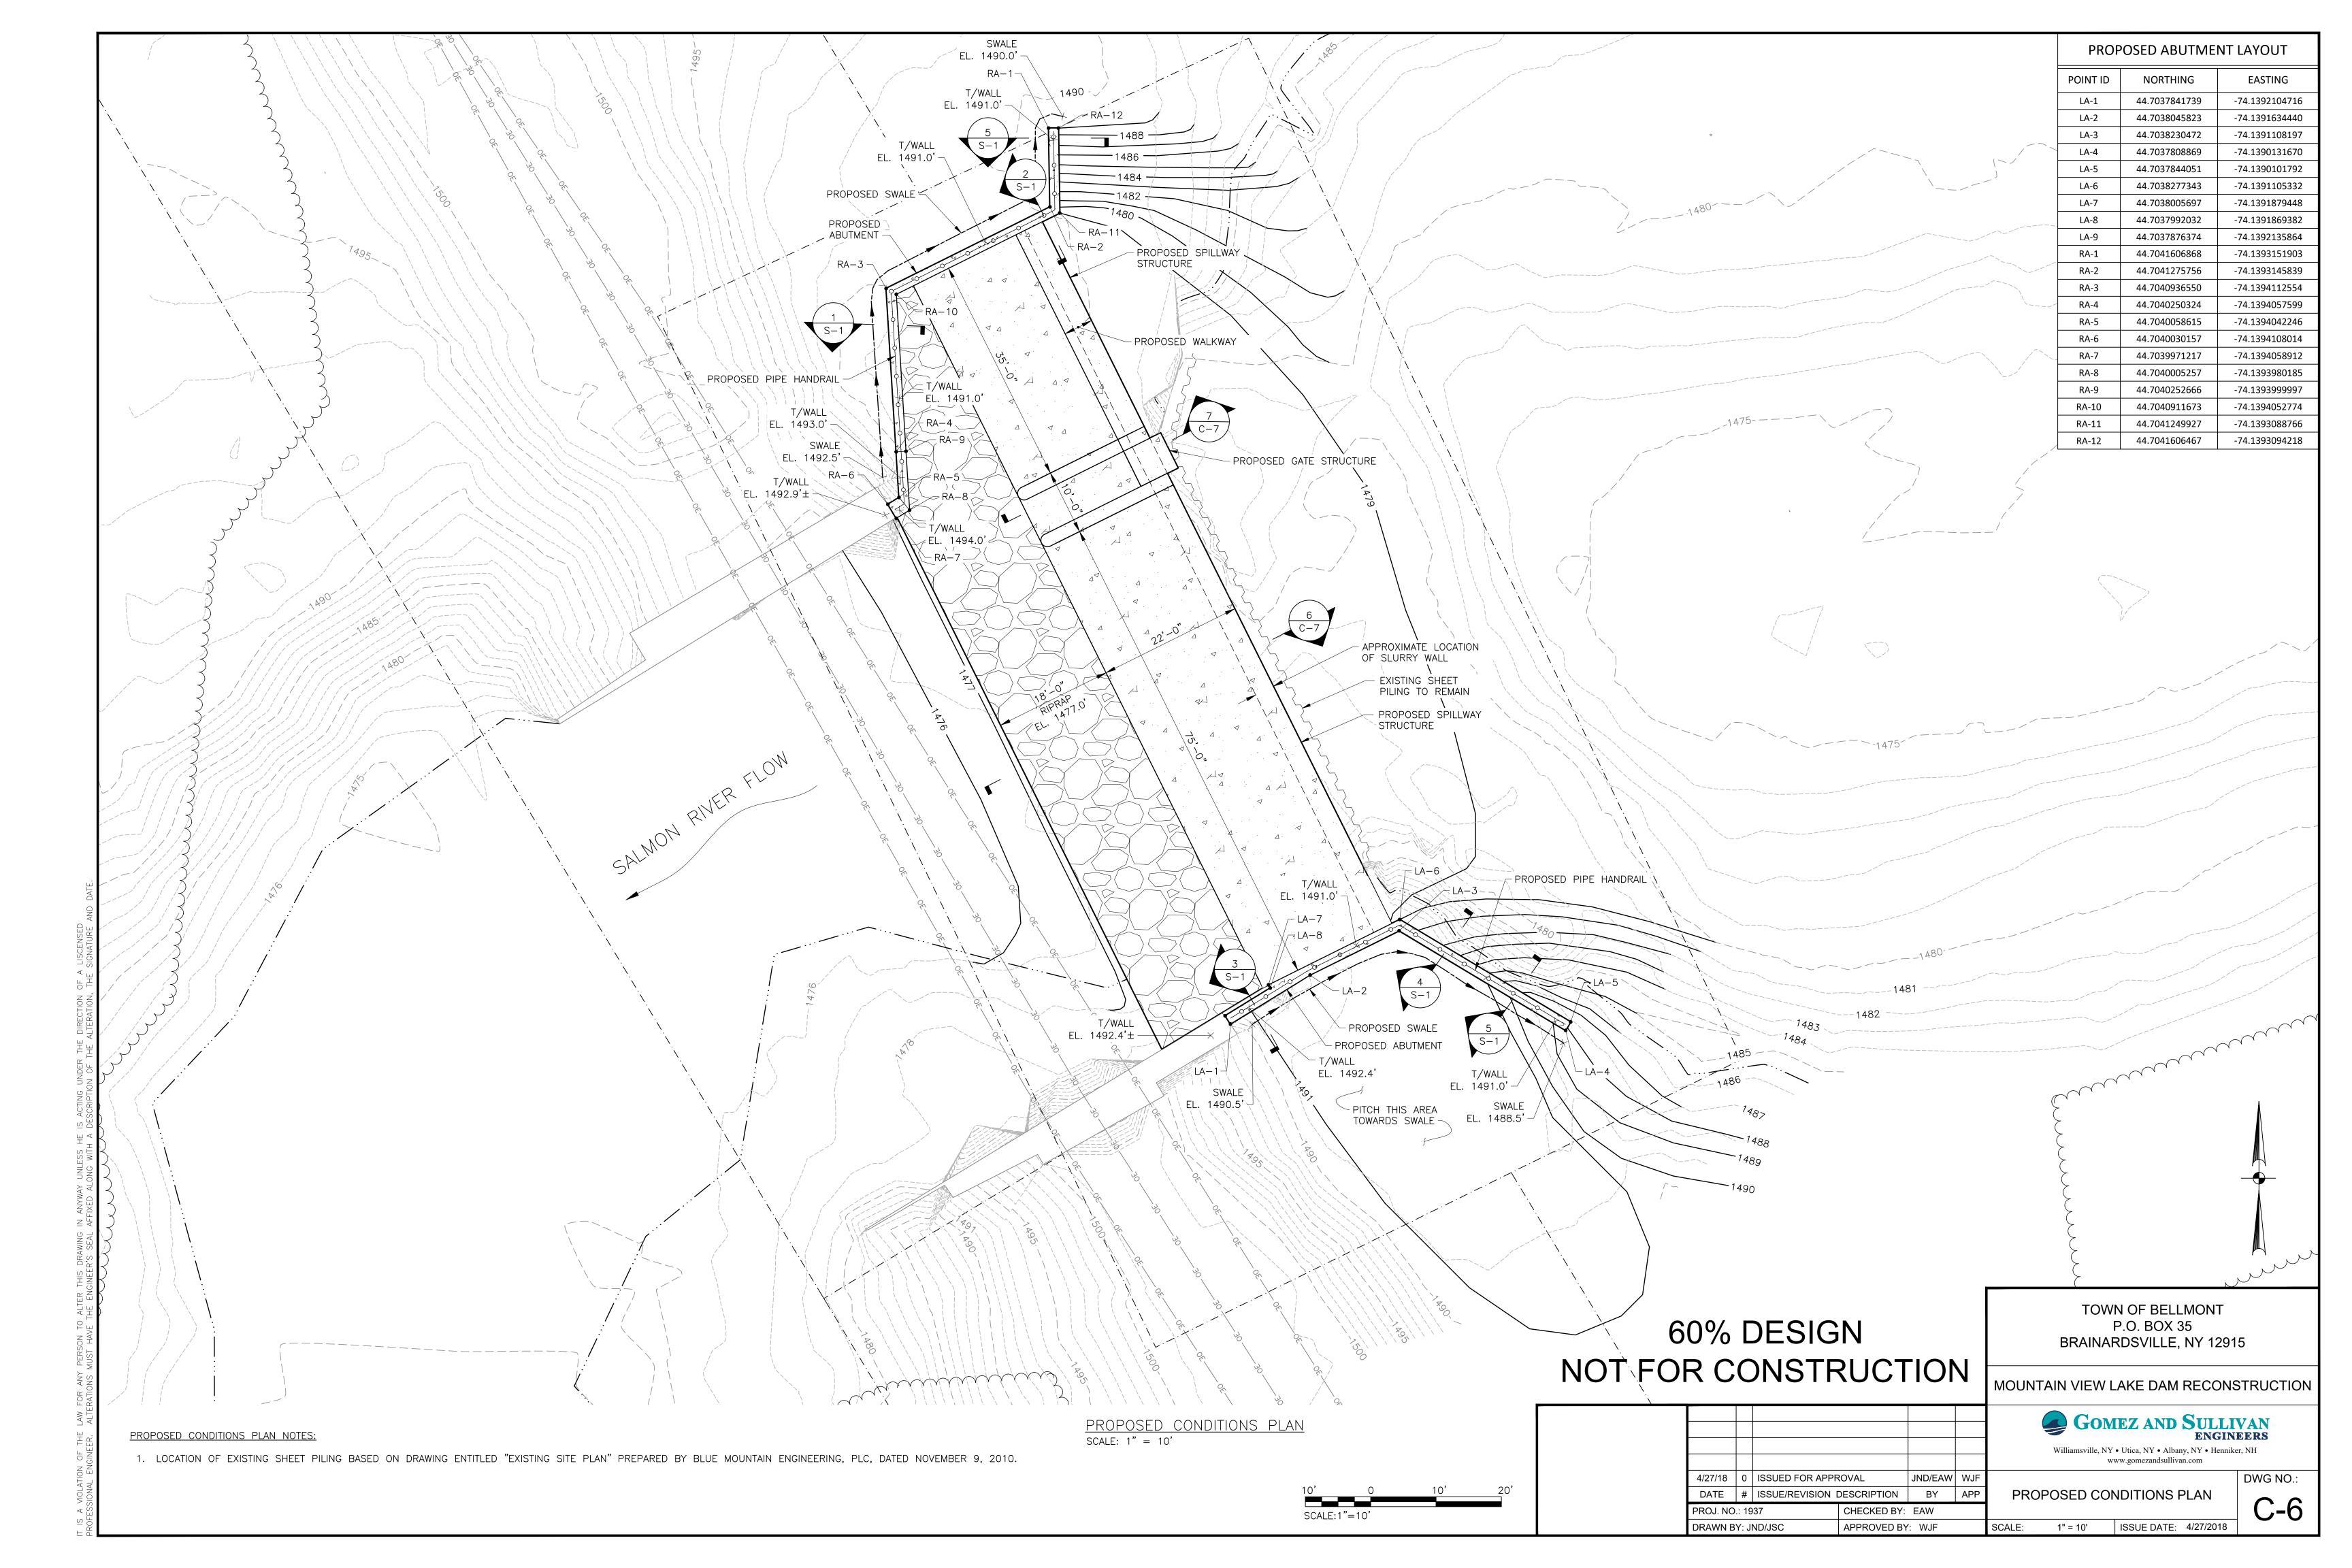

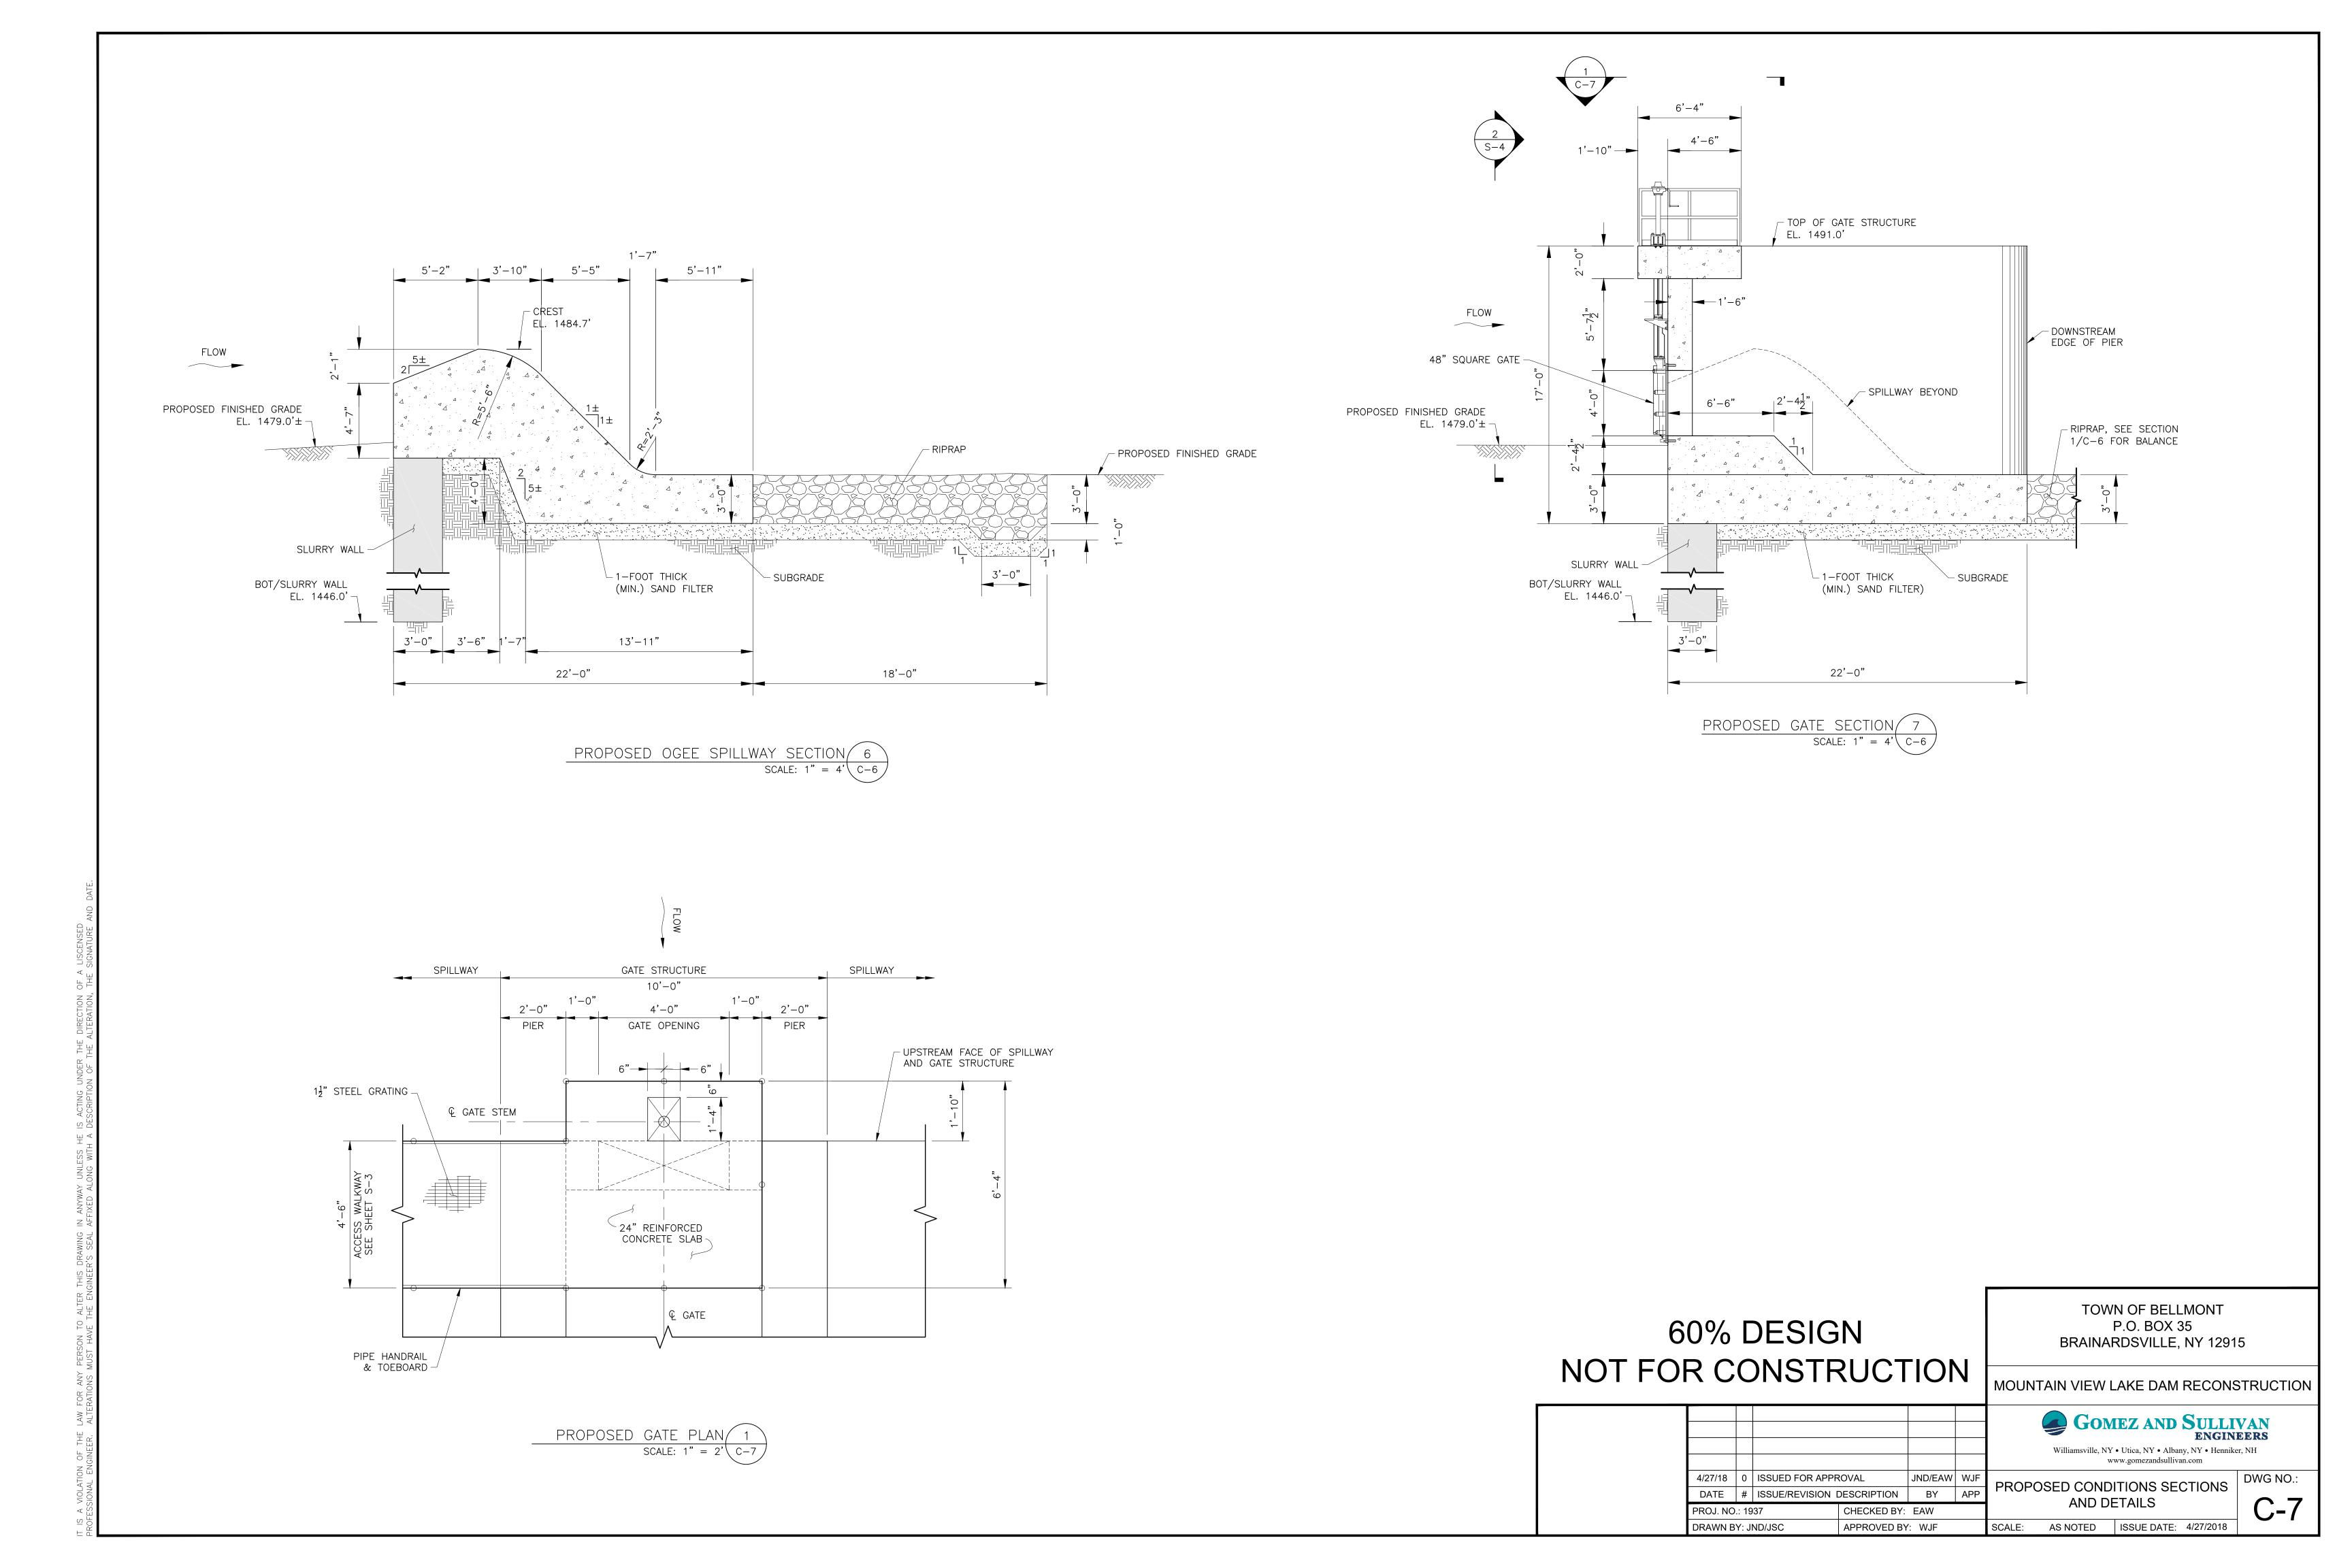

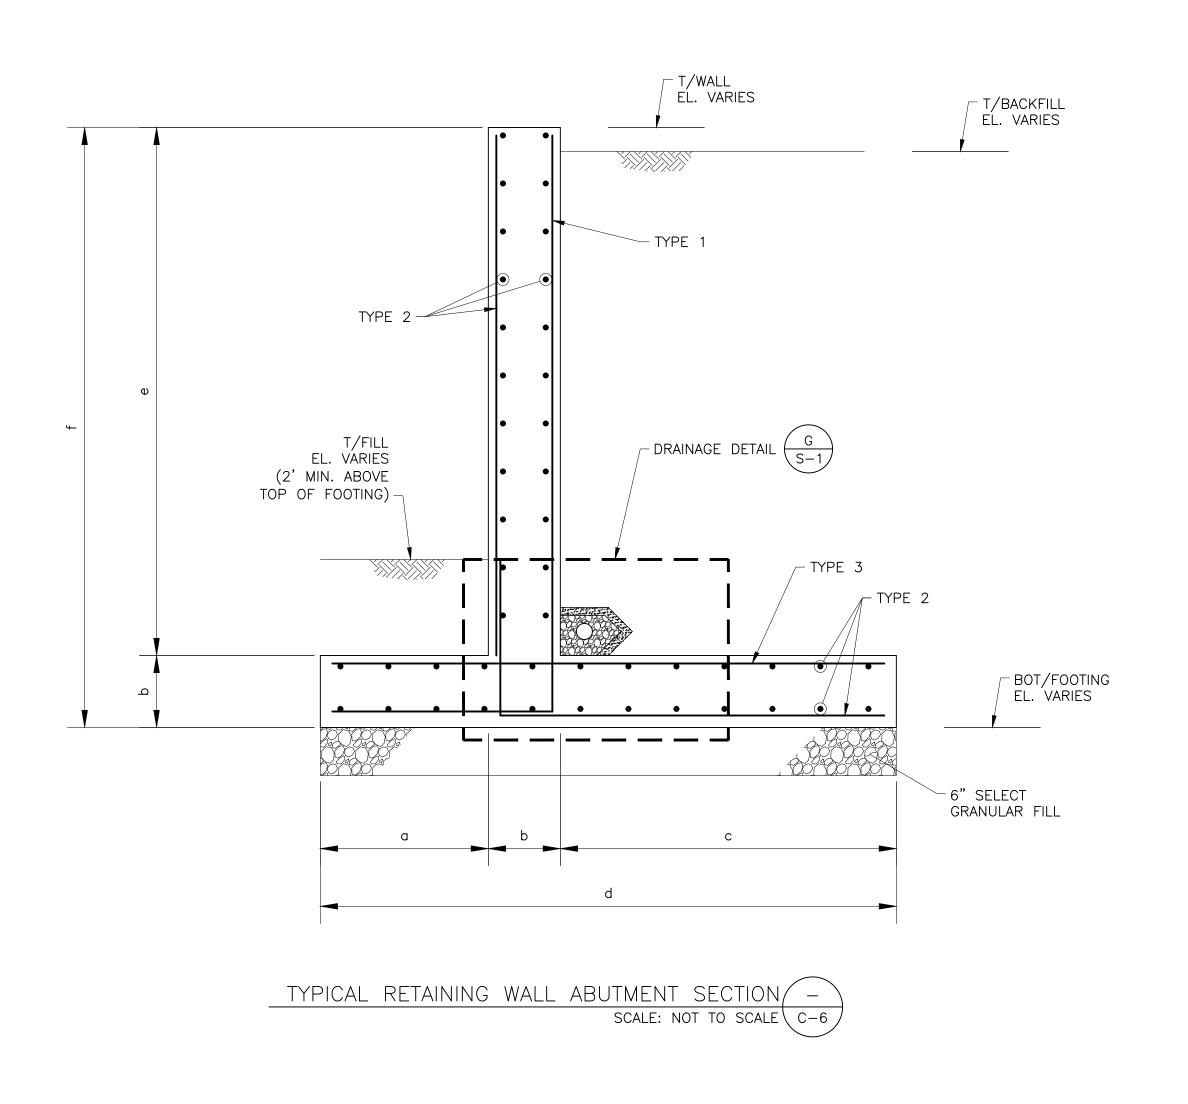

RETAINING WALL ABUTMENTS INFORMATION									
SECTION	ABUTMENT DIMENSION								
	а	b	С	d	е	f	TYPE 1	TYPE 2	TYPE 3
1	3'-6"	1'-6"	7'-0"	12'-0"	16'-6"	18'-0"	#8'S@9"	#6'S@12"	#8'S@9"
2	3'-6"	1'-6"	6'-6"	11'-6"	15'-6"	17'-0"	#7'S@10"	#6'S@12"	#7'S@10"
3	3'-6"	1'-6"	7'-0"	12'-0"	16'-6"	18'-0"	#8'S@9"	#6'S@12"	#8'S@9"
4	3'-6"	1'-6"	6'-6"	11'-6"	15'-6"	17'-0"	#7'S@10"	#6'S@12"	#7'S@10"
5	3'-0"	1'-6"	5'-0"	9'-6"	12'-6"	14'-0"	#6'S@10"	#6'S@12"	#6'S@10"

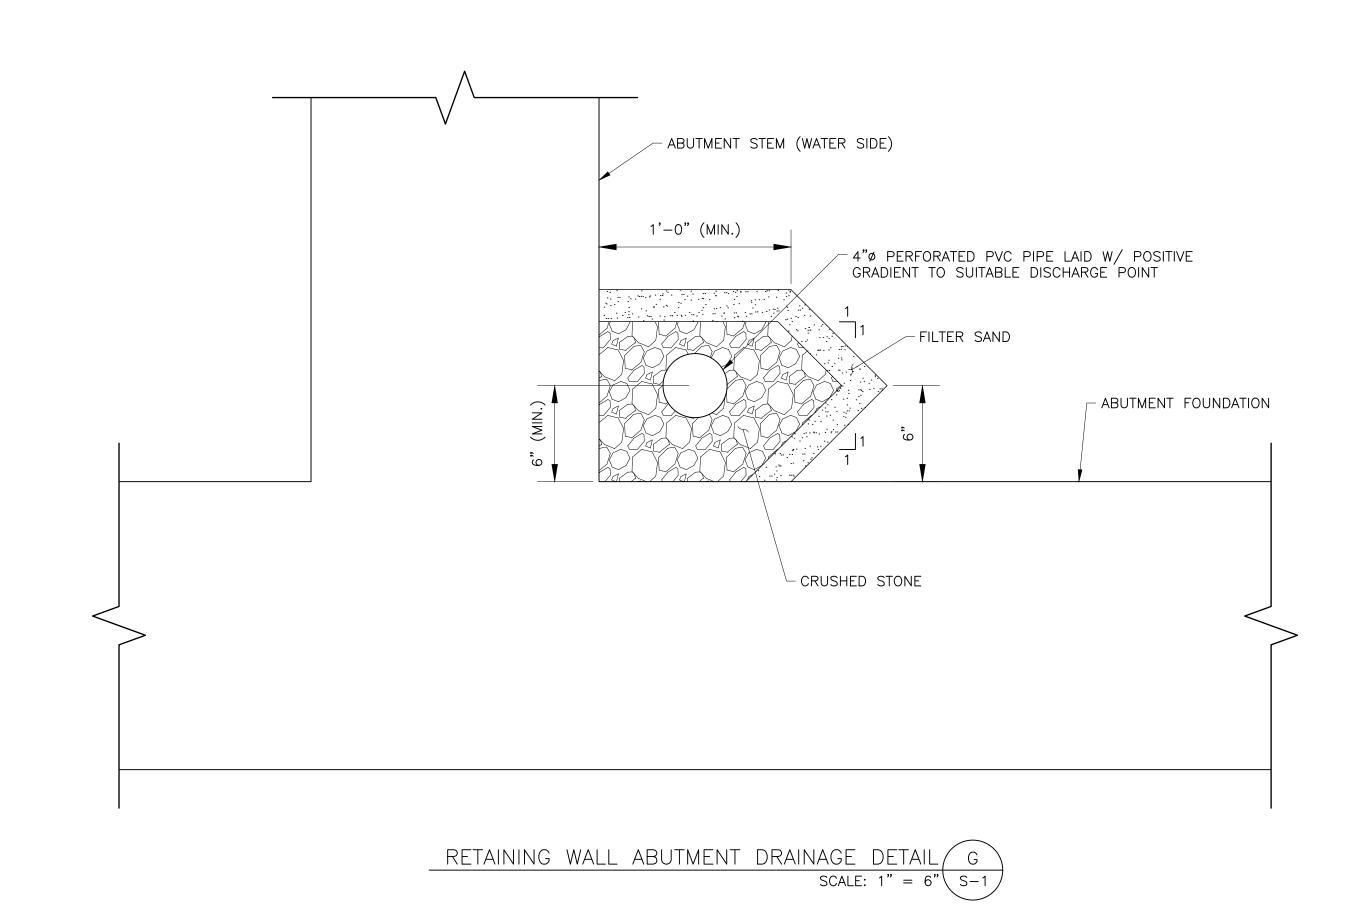

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SPILLWAY PLAN, SECTIONS, AND **DETAILS** 


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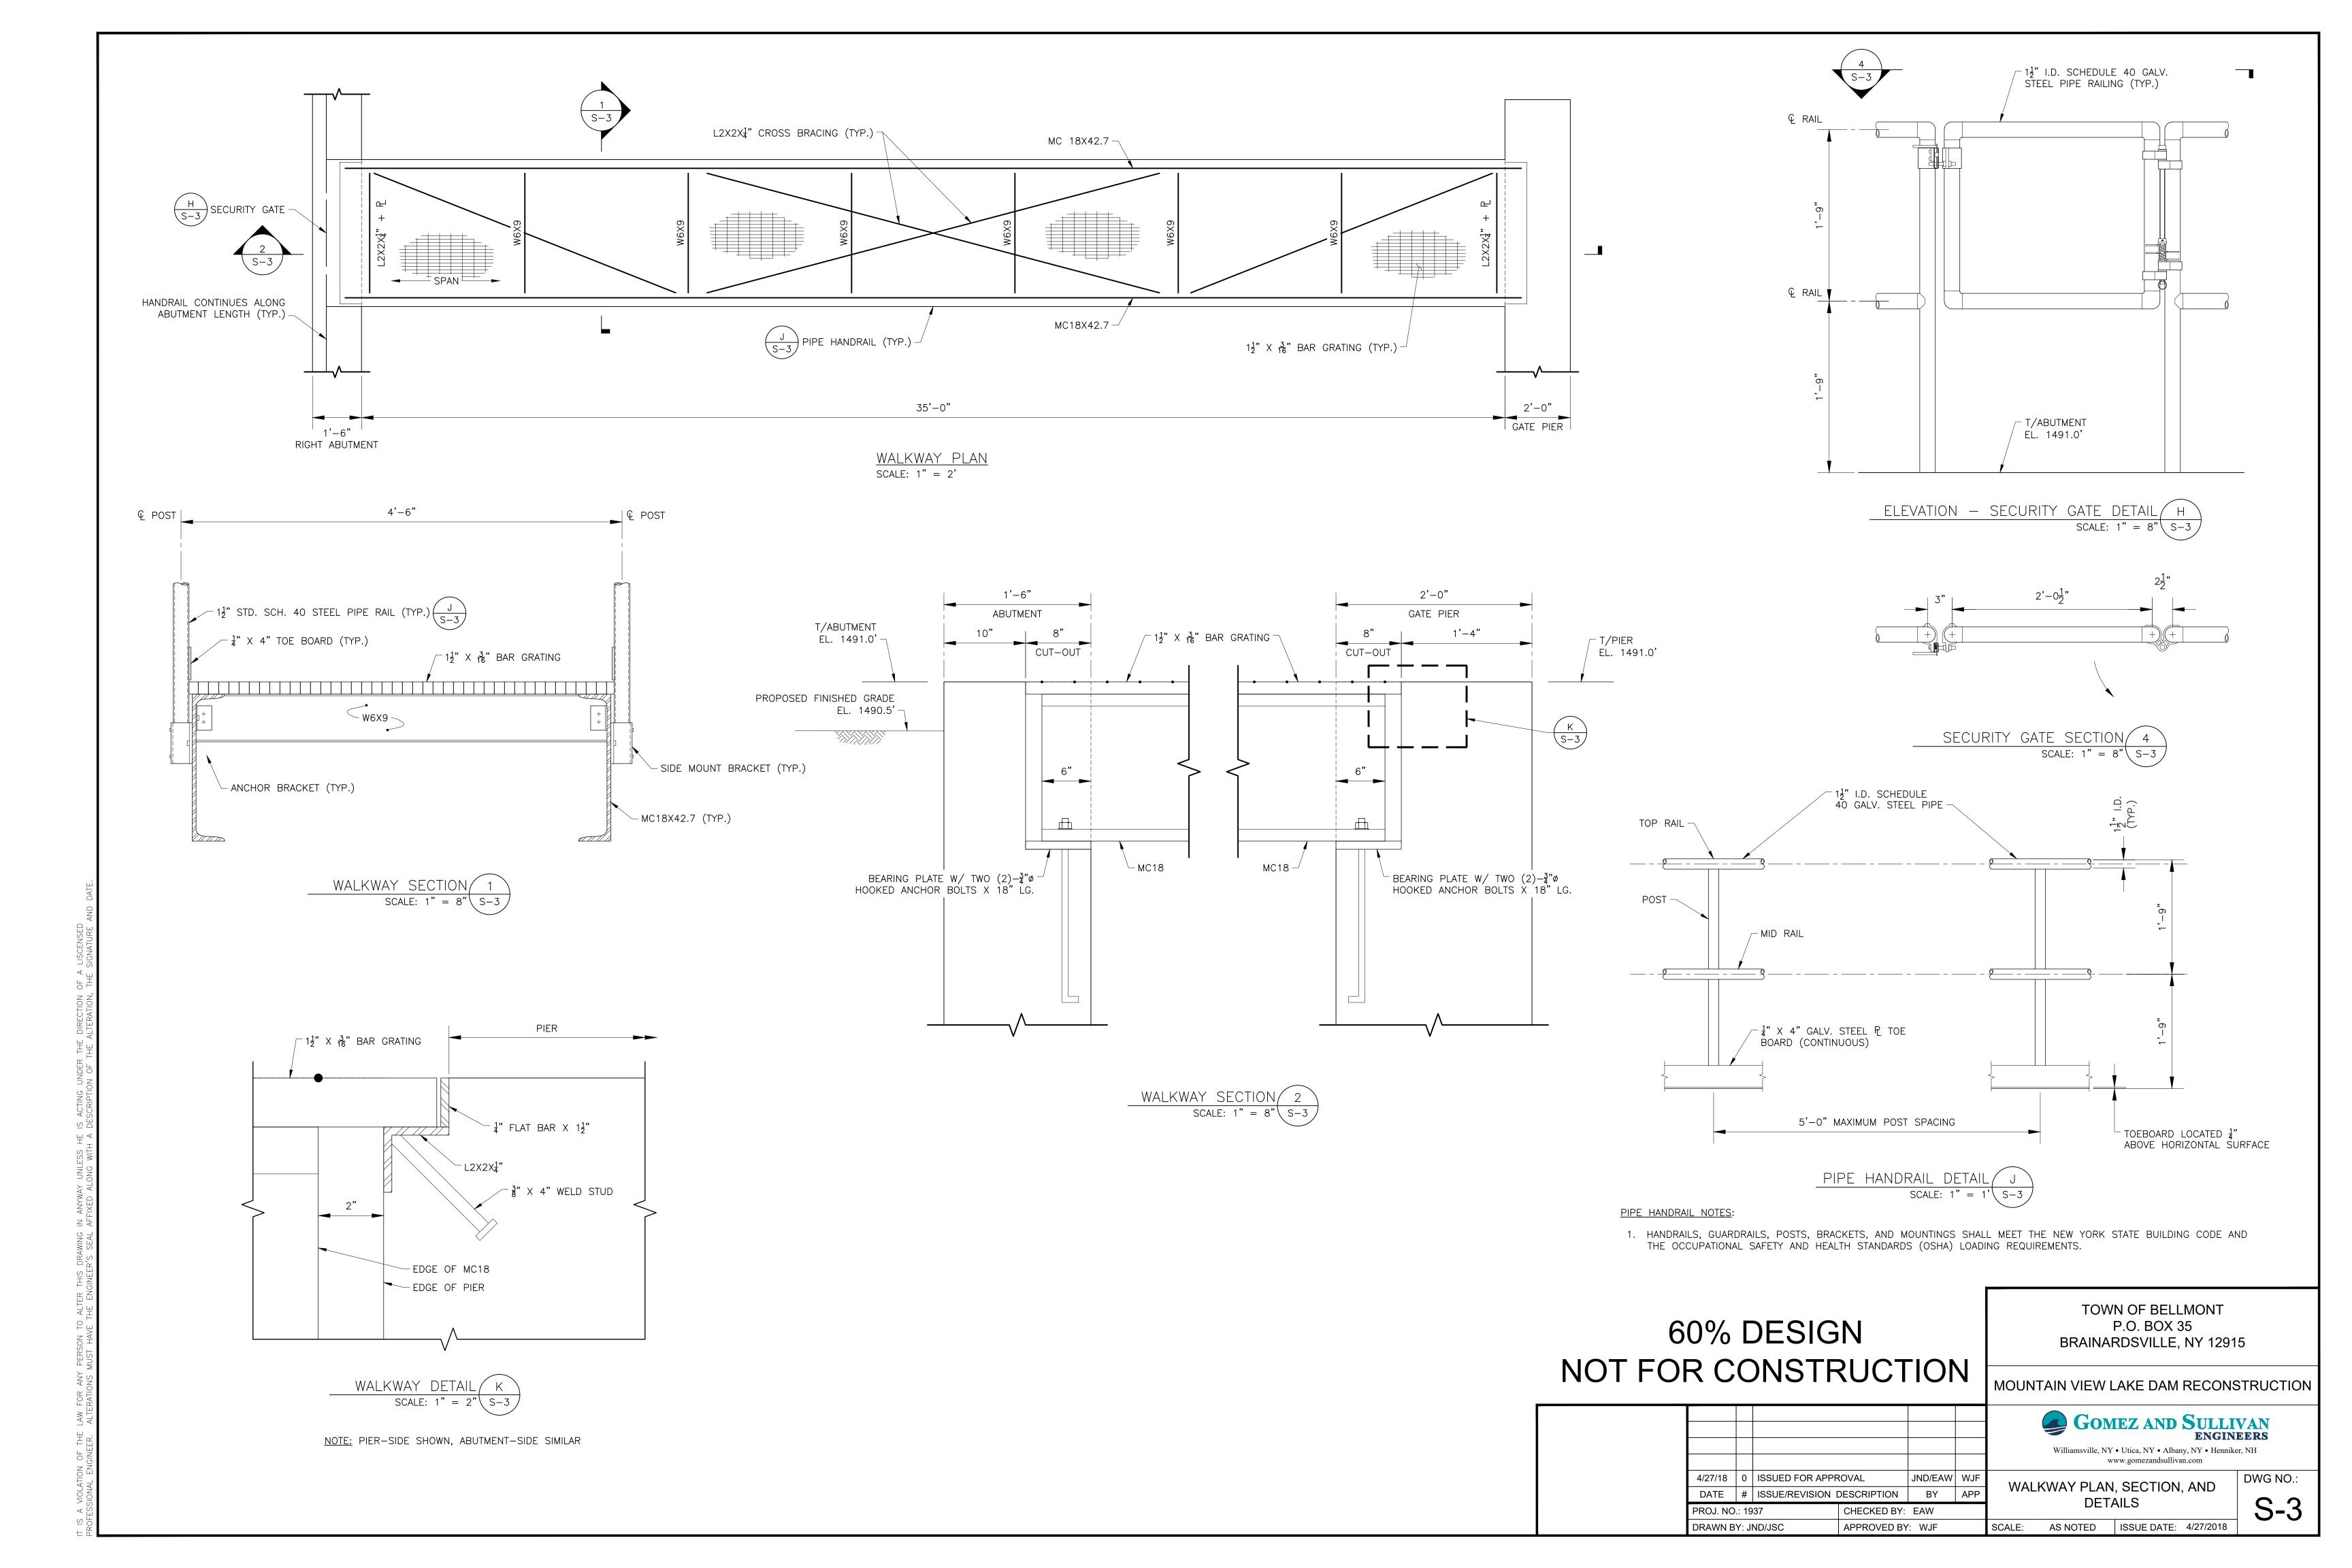
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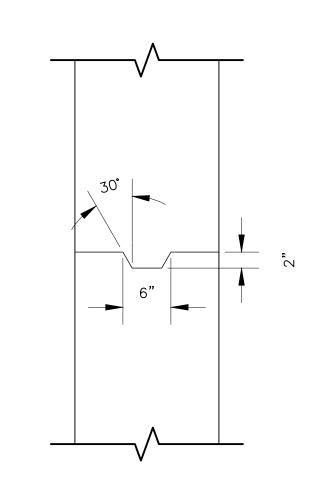
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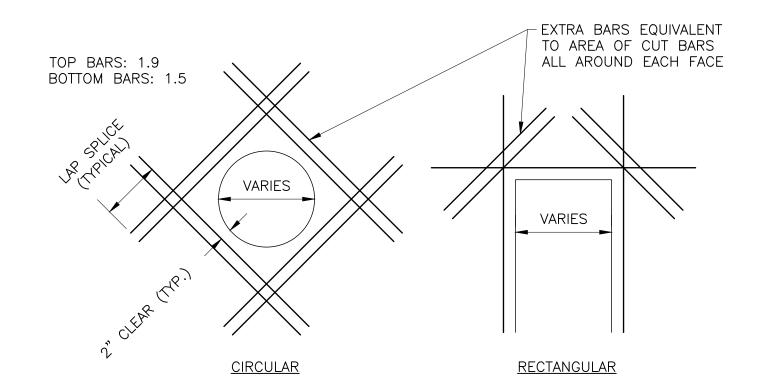
DWG NO.: S-1 SCALE: AS NOTED ISSUE DATE: 4/27/2018








TYPICAL SHEAR KEY DETAIL SCALE:  $1" = 1' \setminus S-4$ 

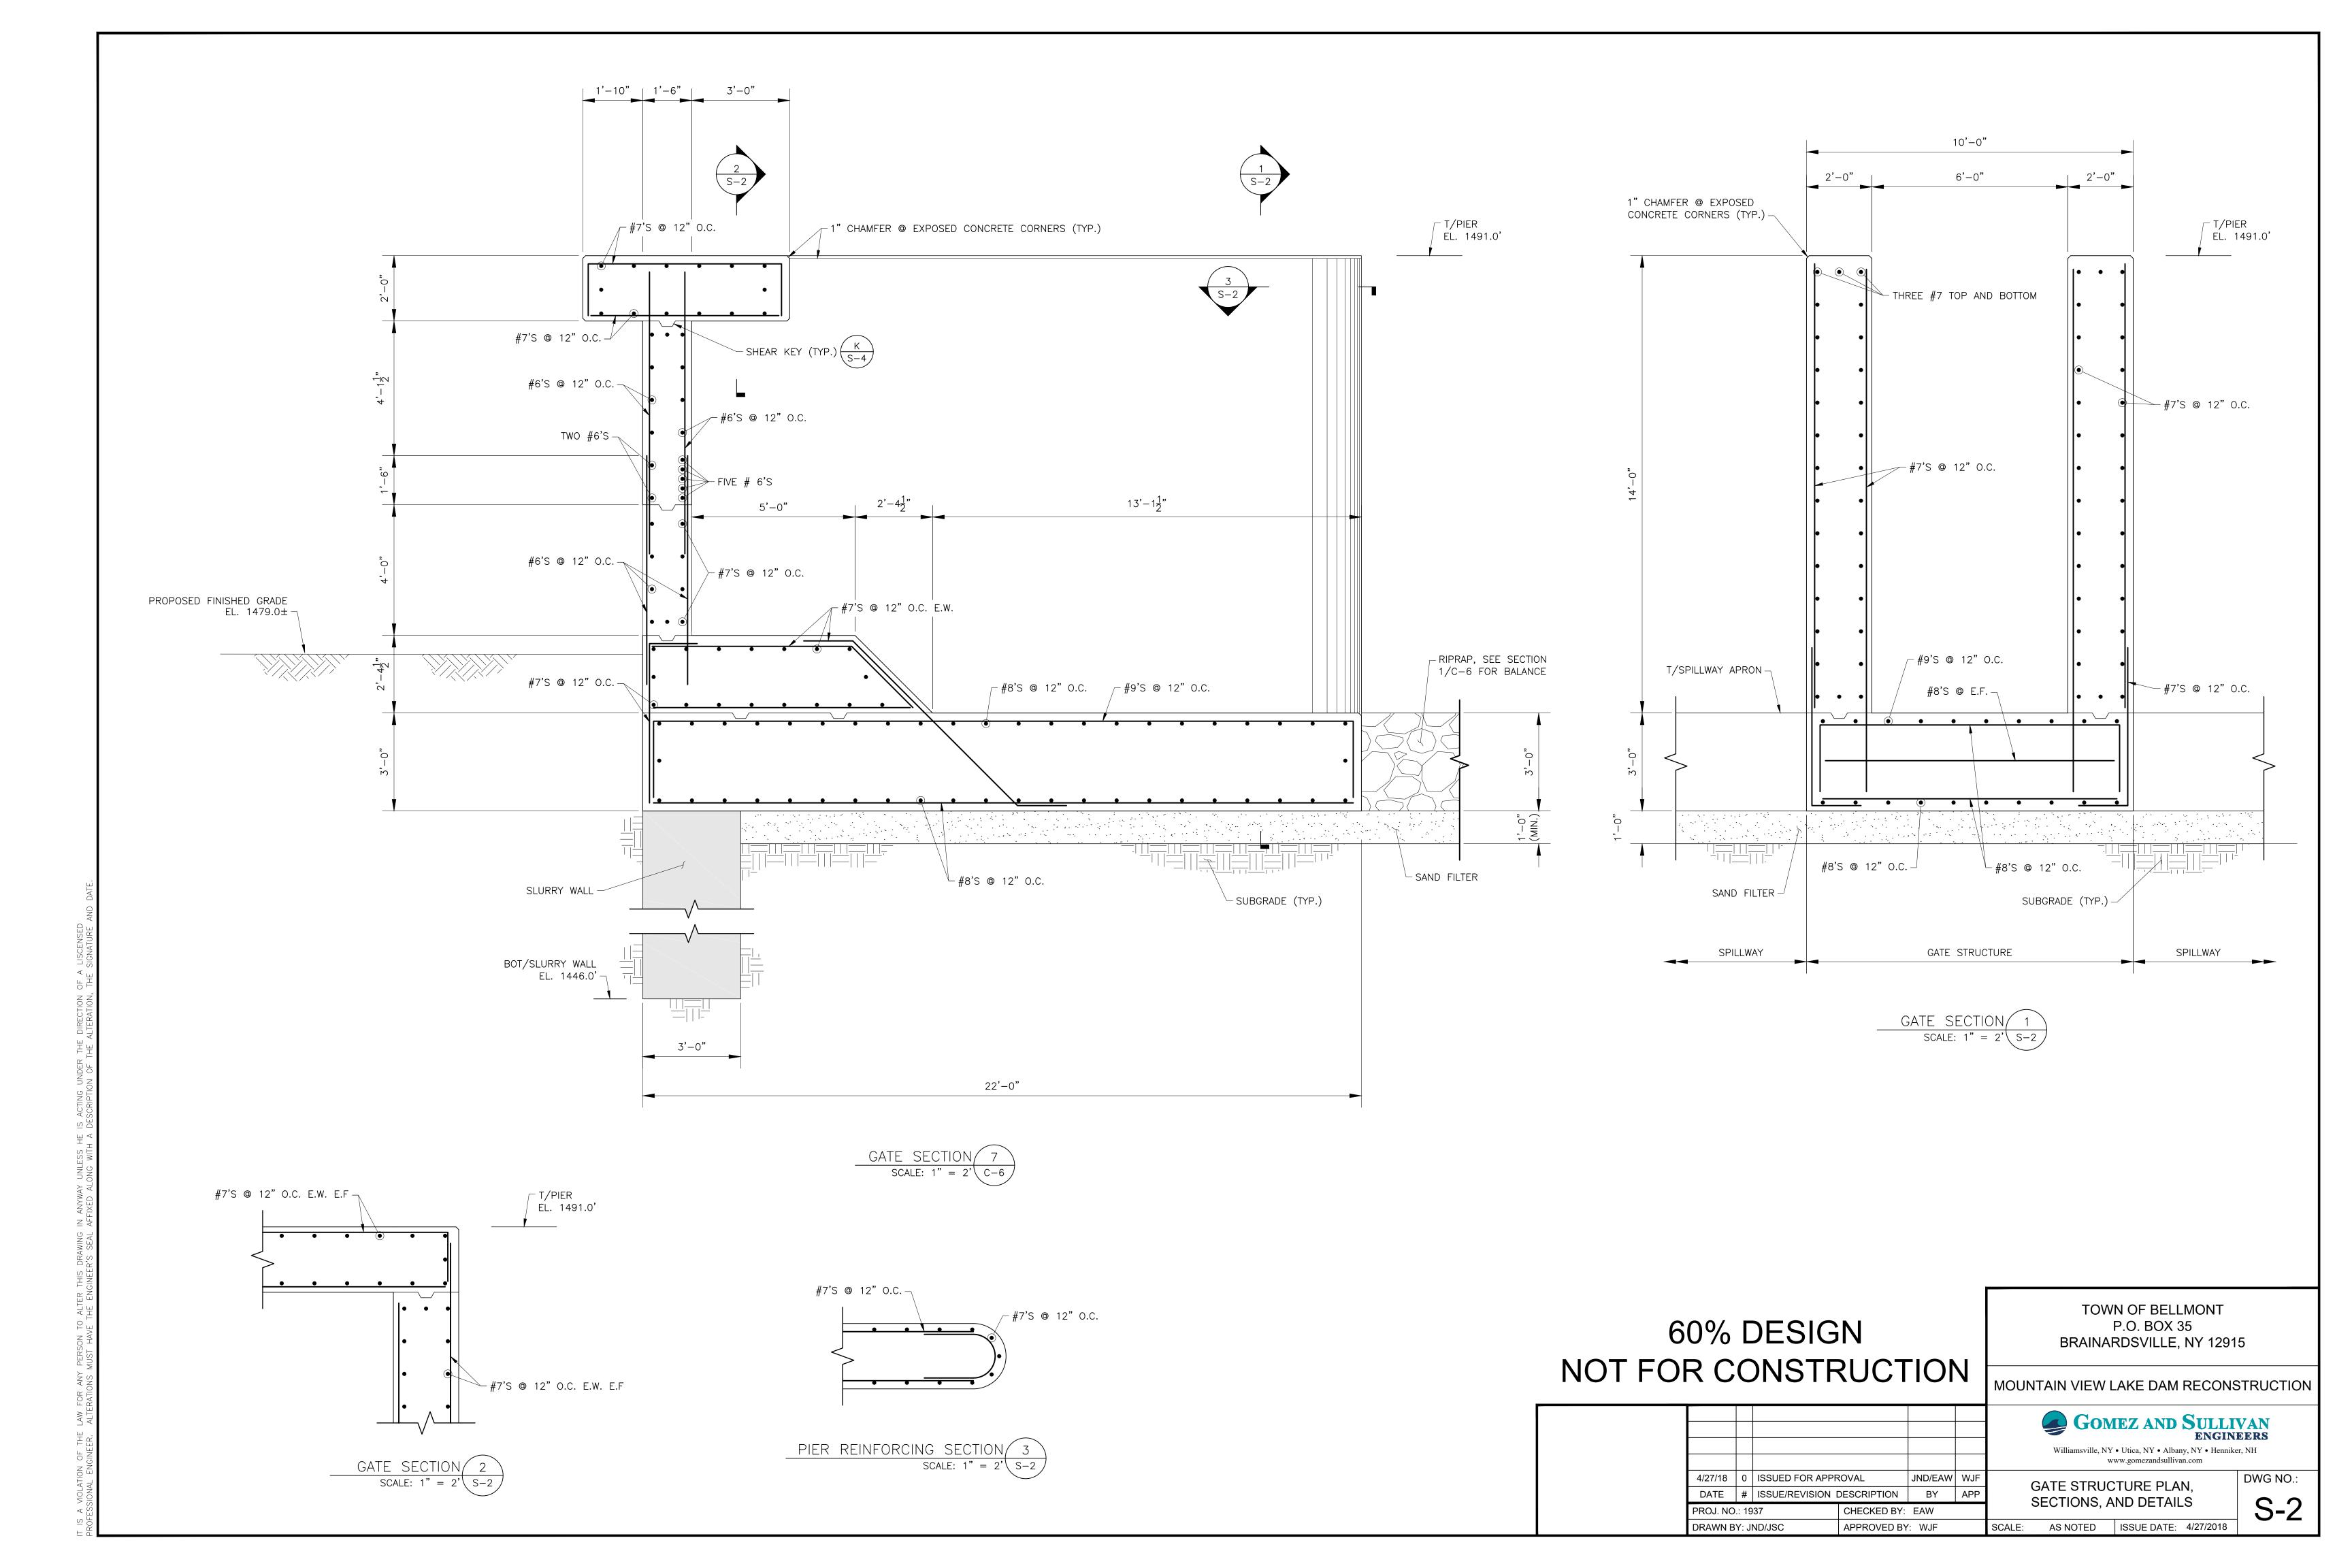

TYPICAL OPENING REINFORCEMENT DETAIL ( M )

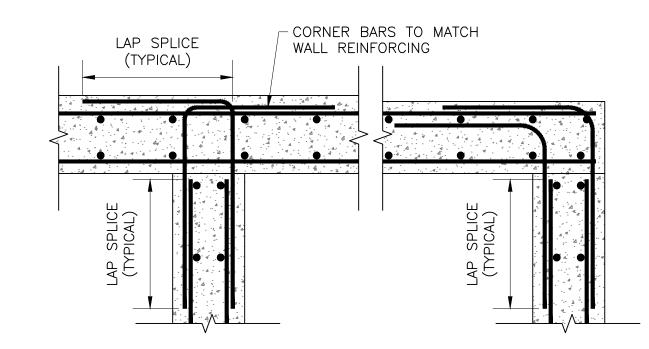

TYPICAL INTERSECTION REINFORCEMENT DETAIL ( N SCALE: NOT TO SCALE \ S-4

	PROVIDE #3 MIN. CROSS BARS AS REQUIRED FOR WATERSTOP SUPPORT
JOINT SEALANT, SIKA-FLEX 2C-NS OR APPROVED	
**************************************	SECURE WATERSTOP WITH TIES AT 12" O.C.
	BULB-TYPE WATERSTOP, GREENSTREAK 732, MIN. 3/8" THICK OR APPROVED
	SEE SECTIONS FOR REINFORCING
WATERSIDE OF JOINT	DRY SIDE OF JOINT


NOTE: DETAIL FOR THE INSTALLATION OF ONE (1) WATERSTOP IS SHOWN. ON WALLS GREATER THAN 24" THICK, PROVIDE TWO (2) WATERSTOPS. PLACE EACH WATERSTOP APPROXIMATELY 8" FROM THE OUTSIDE EDGE OF THE WALL ON BOTH FACES.

WATERSTOP DETAIL AT CONSTRUCTION JOINT ( 0 )

BAR SIZE	CLAS	SS A	CLASS B		
	BOTTOM BARS	TOP BARS	BOTTOM BARS	TOP BARS	
3	23"	25"	29"	33"	
4	29"	33"	38"	43"	
5	36"	41"	47"	54"	
6	44"	50"	57"	64"	
7	63"	71"	81"	91"	
8	71"	81"	93"	104"	

#### LAP SPLICE NOTES:

- 1. USE CLASS B SPLICES UNLESS OTHERWISE NOTED.
- 2. FOR WALL AND SLAB TEMPERATURE AND SHRINKAGE REINFORCEMENT LAPS, USE CLASS A SPLICES UNLESS OTHERWISE NOTED.
- 3. DEVELOPMENT LENGTHS SHOWN ABOVE ARE ONLY VALID WHEN THE FOLLOWING CONDITIONS ARE MET:
- GRADE 60, EPOXY COATED, REBAR
- NORMALWEIGHT CONCRETE WITH MIN f'c = 4,000 PSI
   CLEAR SPACING OF BARS NOT LESS THAN 2db
- CLEAR COVER NOT LESS THAN db
- 4. TOP BARS ARE HORIZONTAL BARS WITH MORE THAN 12 INCHES OF CONCRETE CAST BELOW THE BARS.

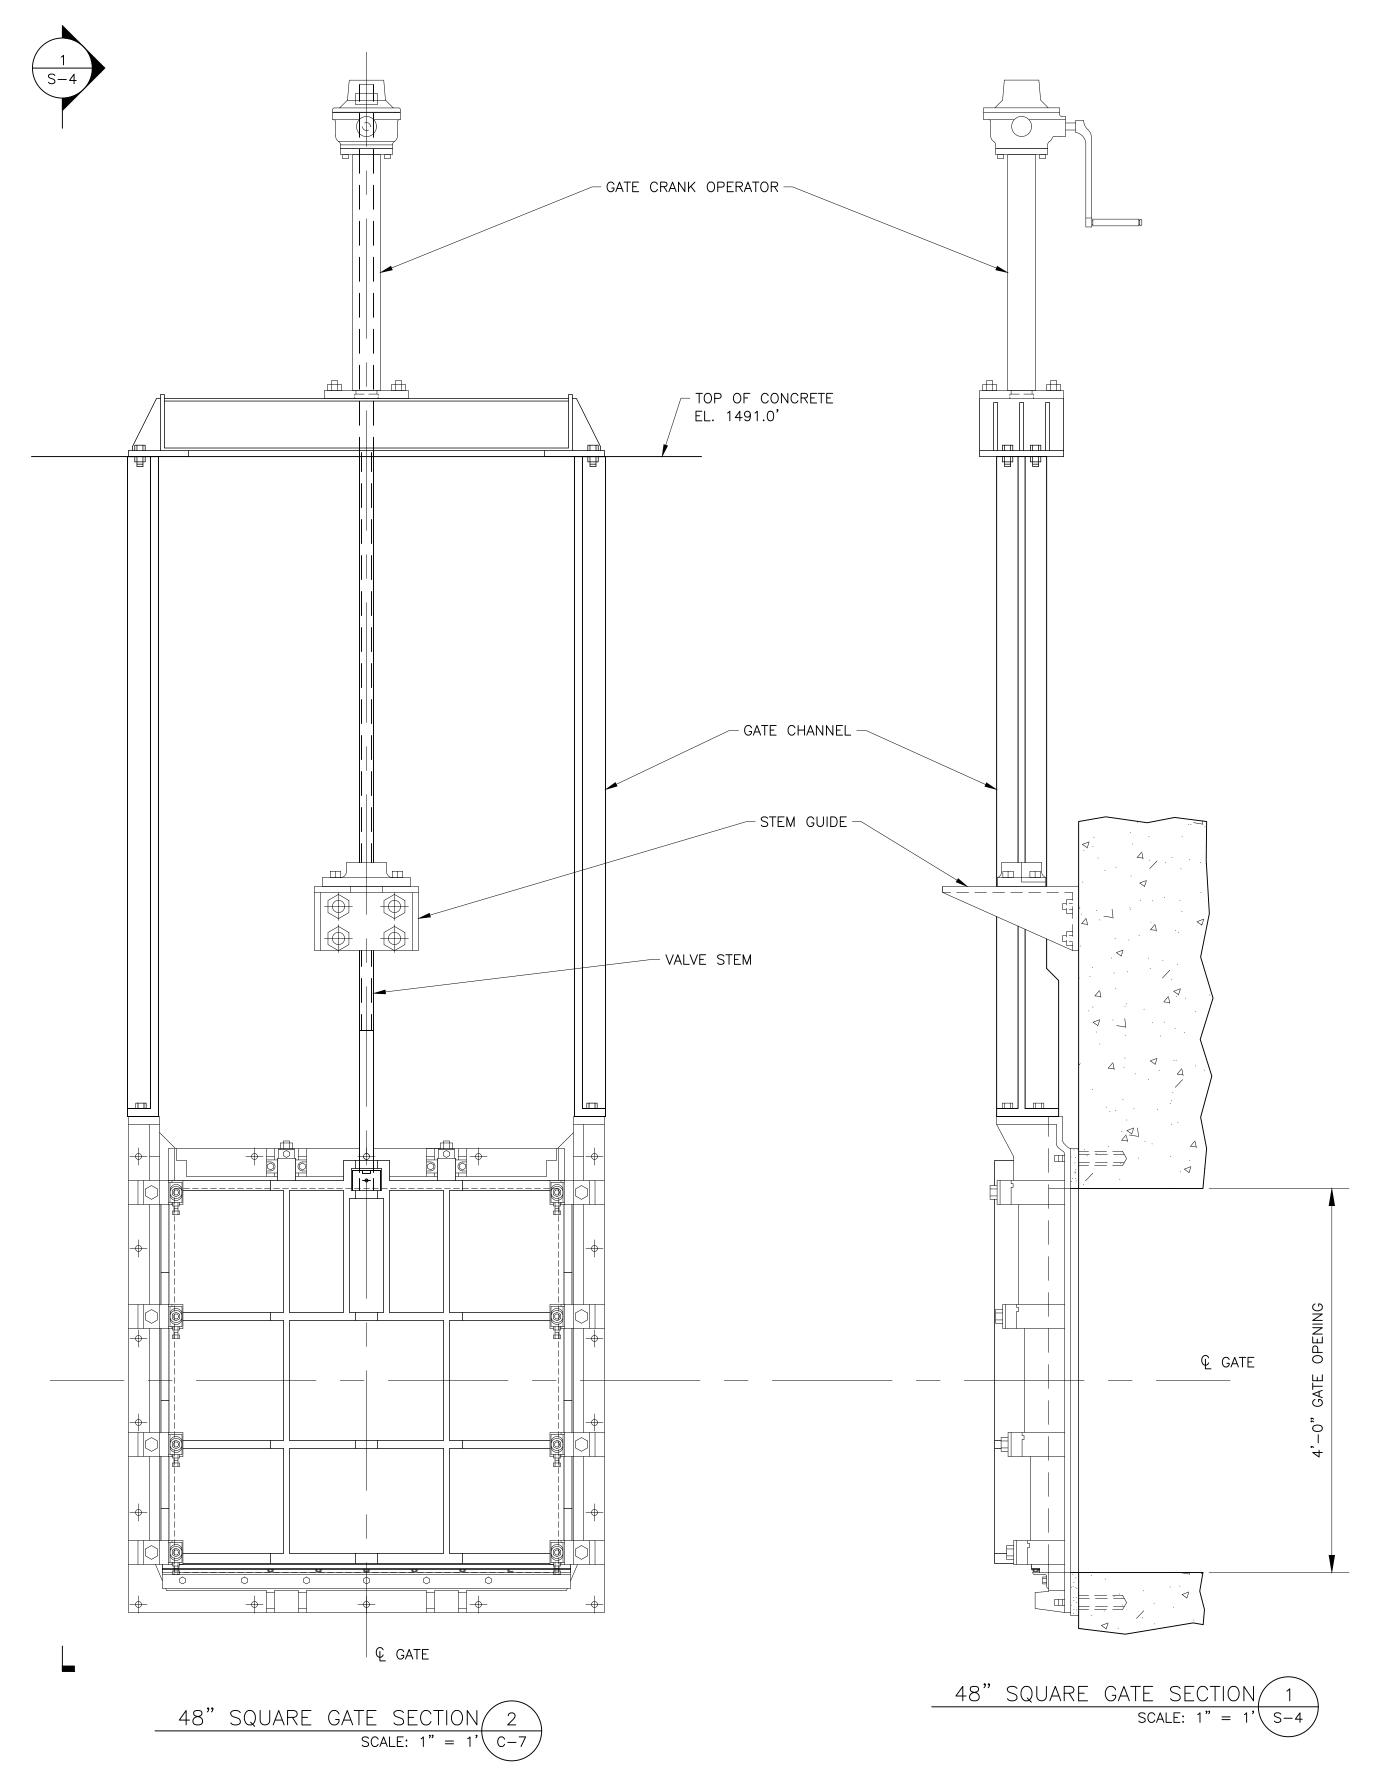

NOTE: GATE IS TO BE STANDARD MANUFACTURER PRODUCT. REFER TO THE PROJECT SPECIFICATIONS FOR ADDITIONAL GATE SPECIFICATION INFORMATION.



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MISCELLANEOUS STRUCTURAL

DWG NO.: **DETAILS** 

S-4

SCALE: AS NOTED | ISSUE DATE: 4/27/2018