Renovations for Five (5) Pre-K Classrooms at

Clayton J. Davenport Elementary School

2501 Spruce Avenue Egg Harbor Township, NJ 08234

Egg Harbor Township School District

13 Swift Dr, Egg Harbor Township, NJ 08234



Gillan and Hartmann, Inc.

CONSULTING M / E / P ENGINEERS

DRAWING SYMBOLS **IDENTIFICATION** DRAWING NO. — A1.1 BUILDING SECTION NO. — SECTION DRAWING NO. IDENTIFICATION CLOSED HEAD SIM WALL SECTION **IDENTIFICATION** DRAWING NO. ROOM NUMBER — 101 OCCUPANTS ----COLUMN NUMBER REVISION NUMBER

REFERENCE CODE — XXXX

ELEVATION -

DOOR NUMBER

PARTITION TYPE

CURTAIN WALL or


STOREFRONT TAG


DATUM or

ELEVATION


CENTERLINE

TOILET ACCESSORY TAG

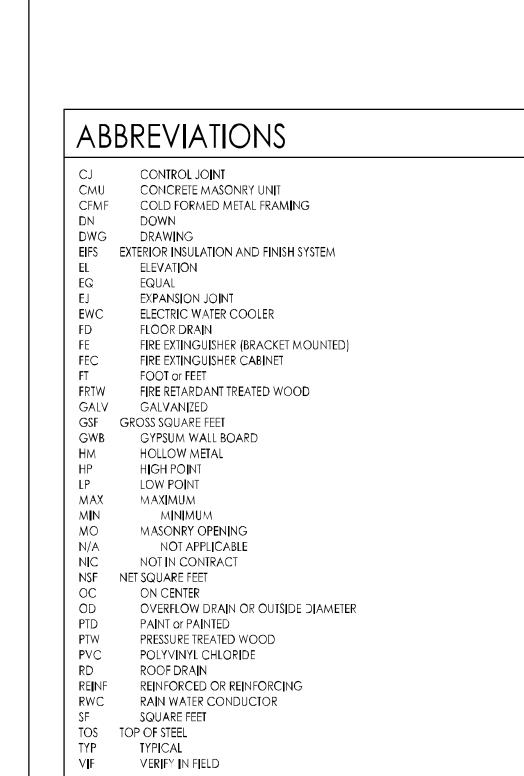

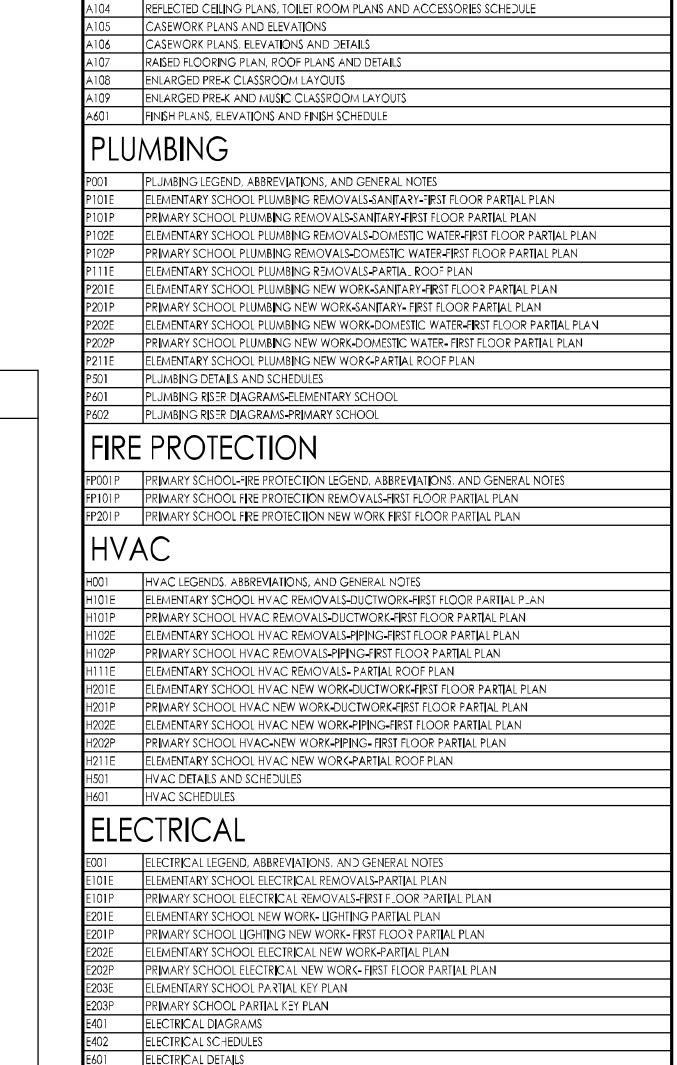

DRAWING INDEX

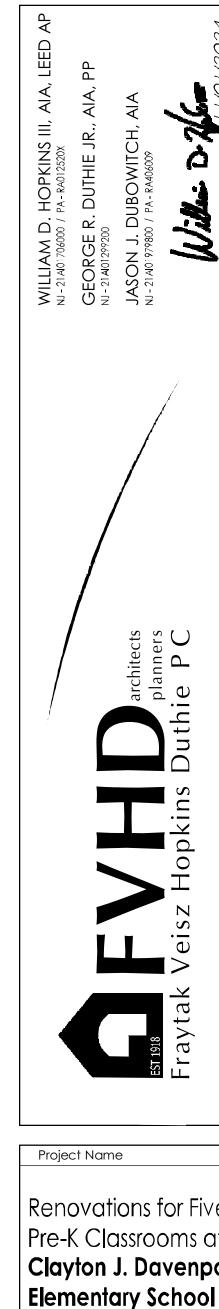

Renovations for Five (5 Pre-K Classrooms at Clayton J. Davenport

Project Owner Name

Egg Harbor Township School District

Project Location

2501 Spruce Avenue Egg Harbor Township NJ 08234

Project Number Project Date 11/01/2024 Checked By SWS, WDH Drawn By


Drawing Name

TITLE SHEET

No. Date Description 1 11/26/2024 Addendum

Drawing Number:


OWNER APPROVAL:

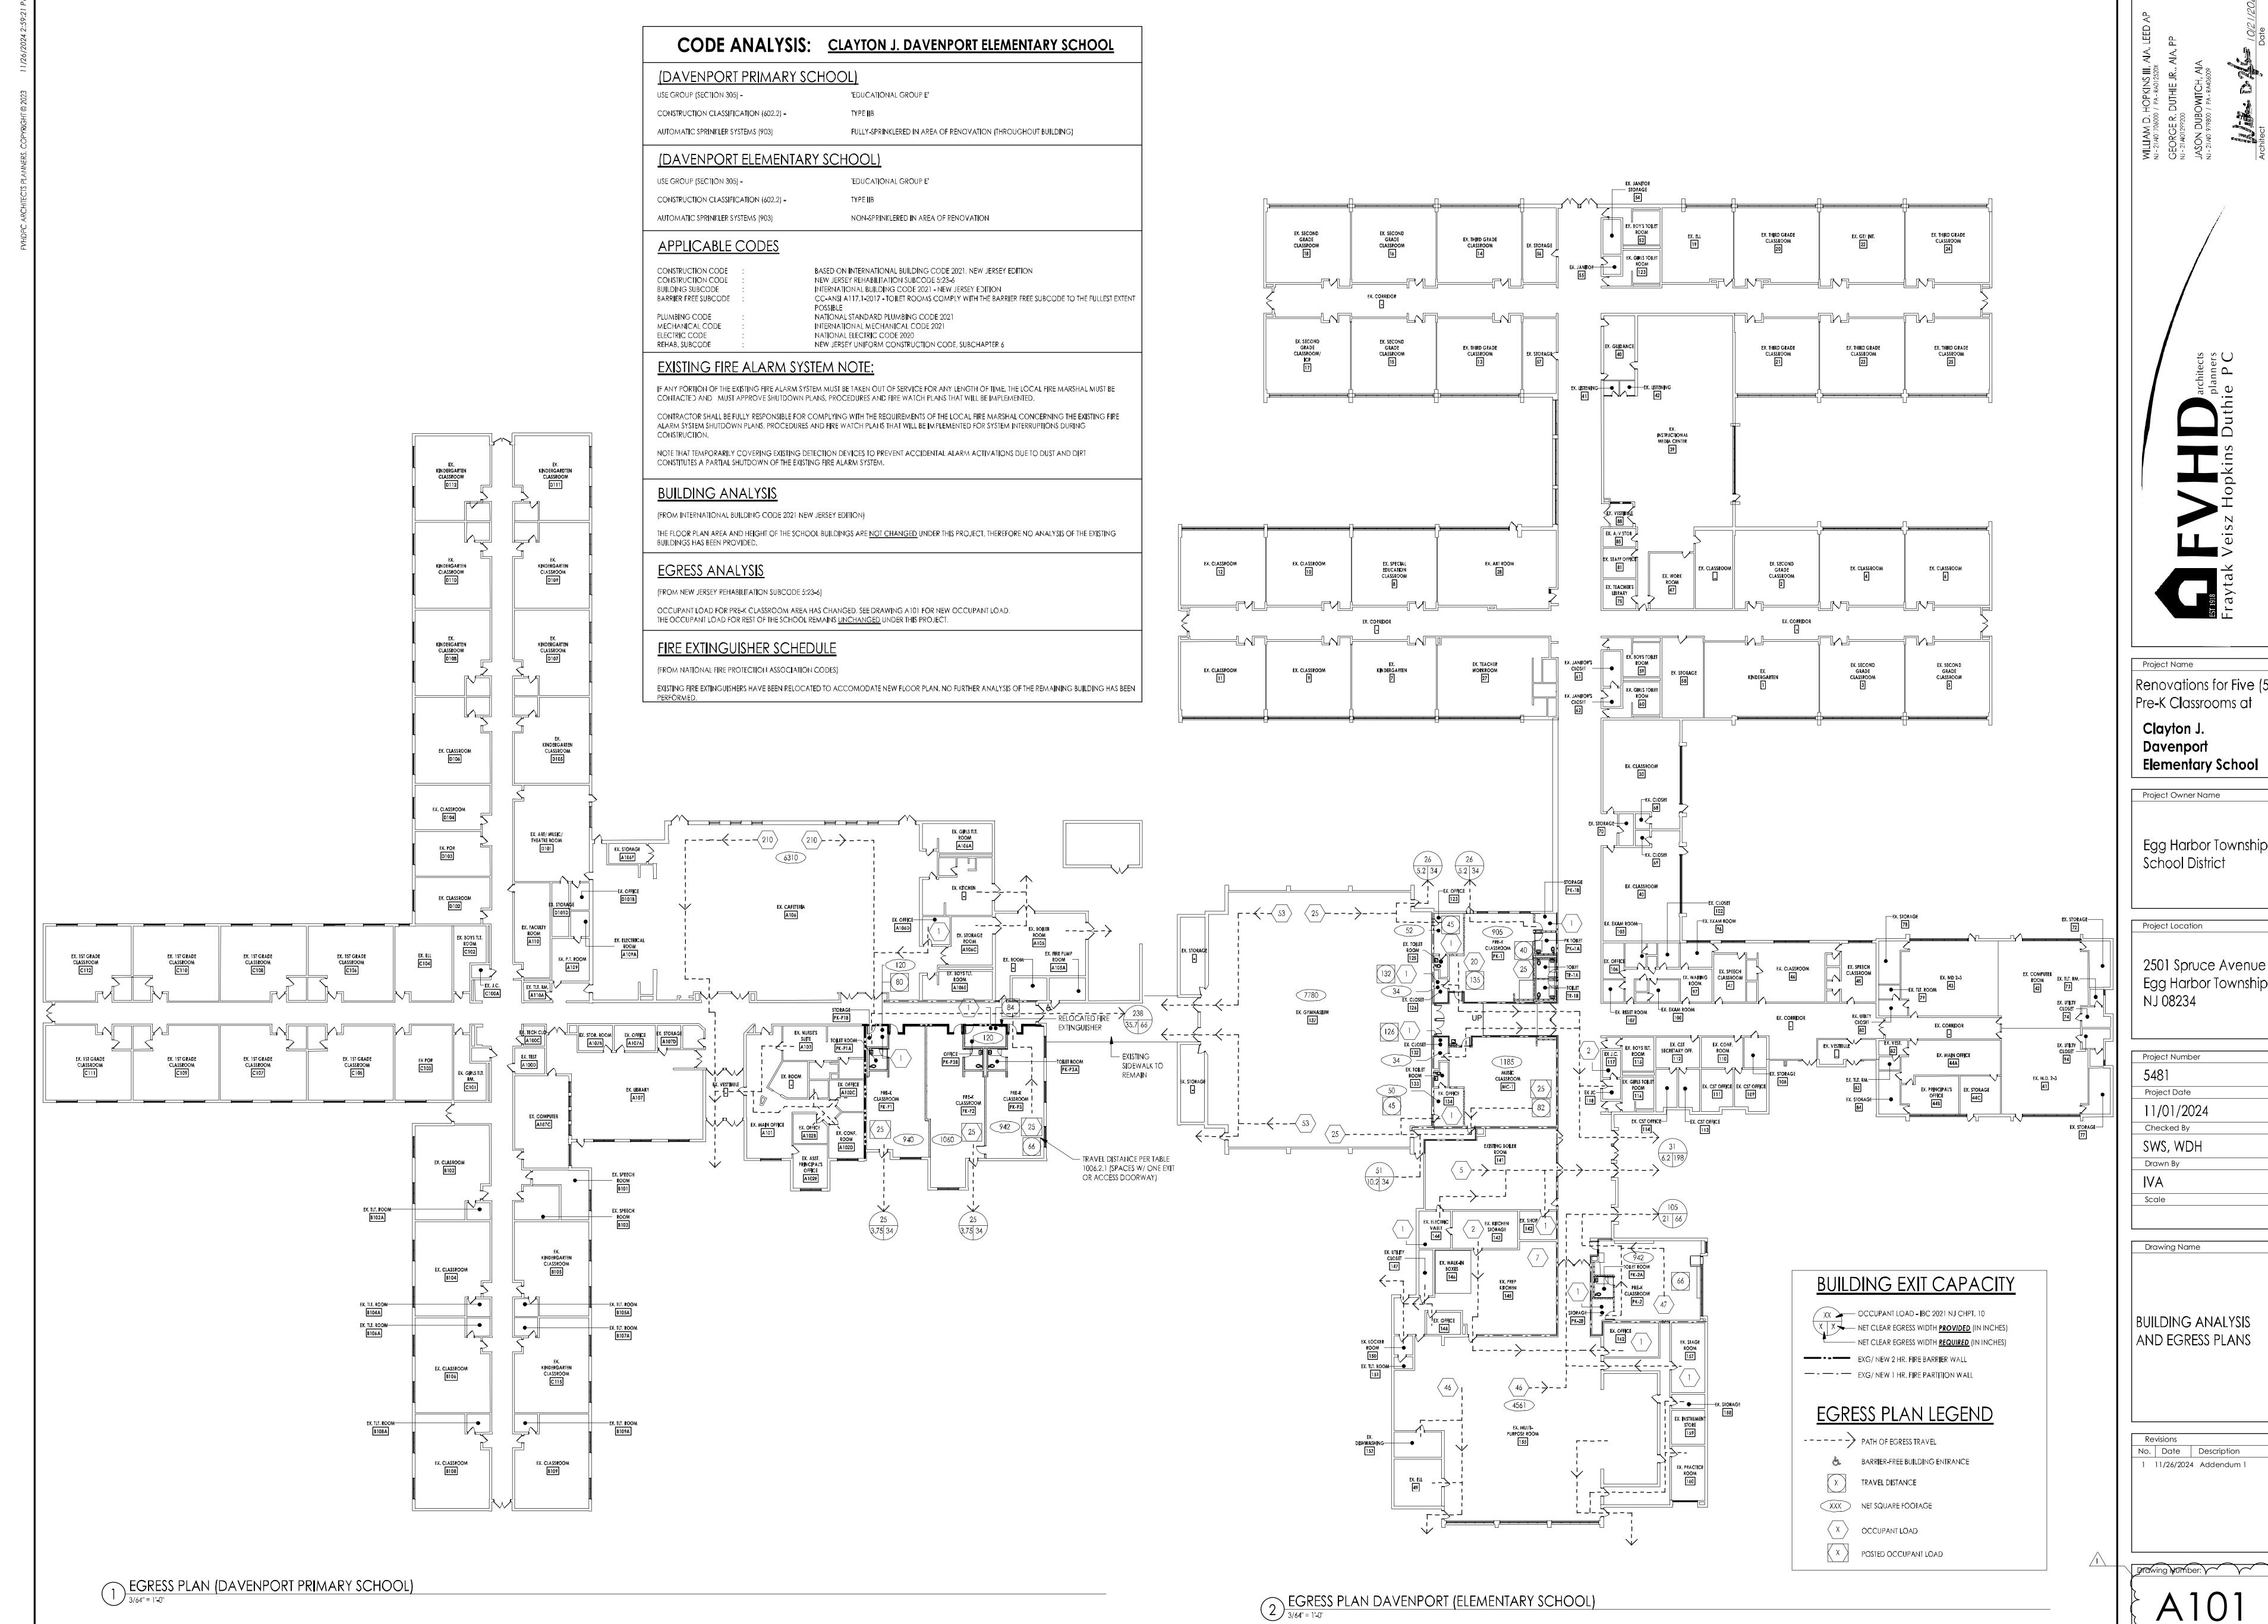

Renovations for Five (5) Pre-K Classrooms at

Egg Harbor Township

Egg Harbor Township,

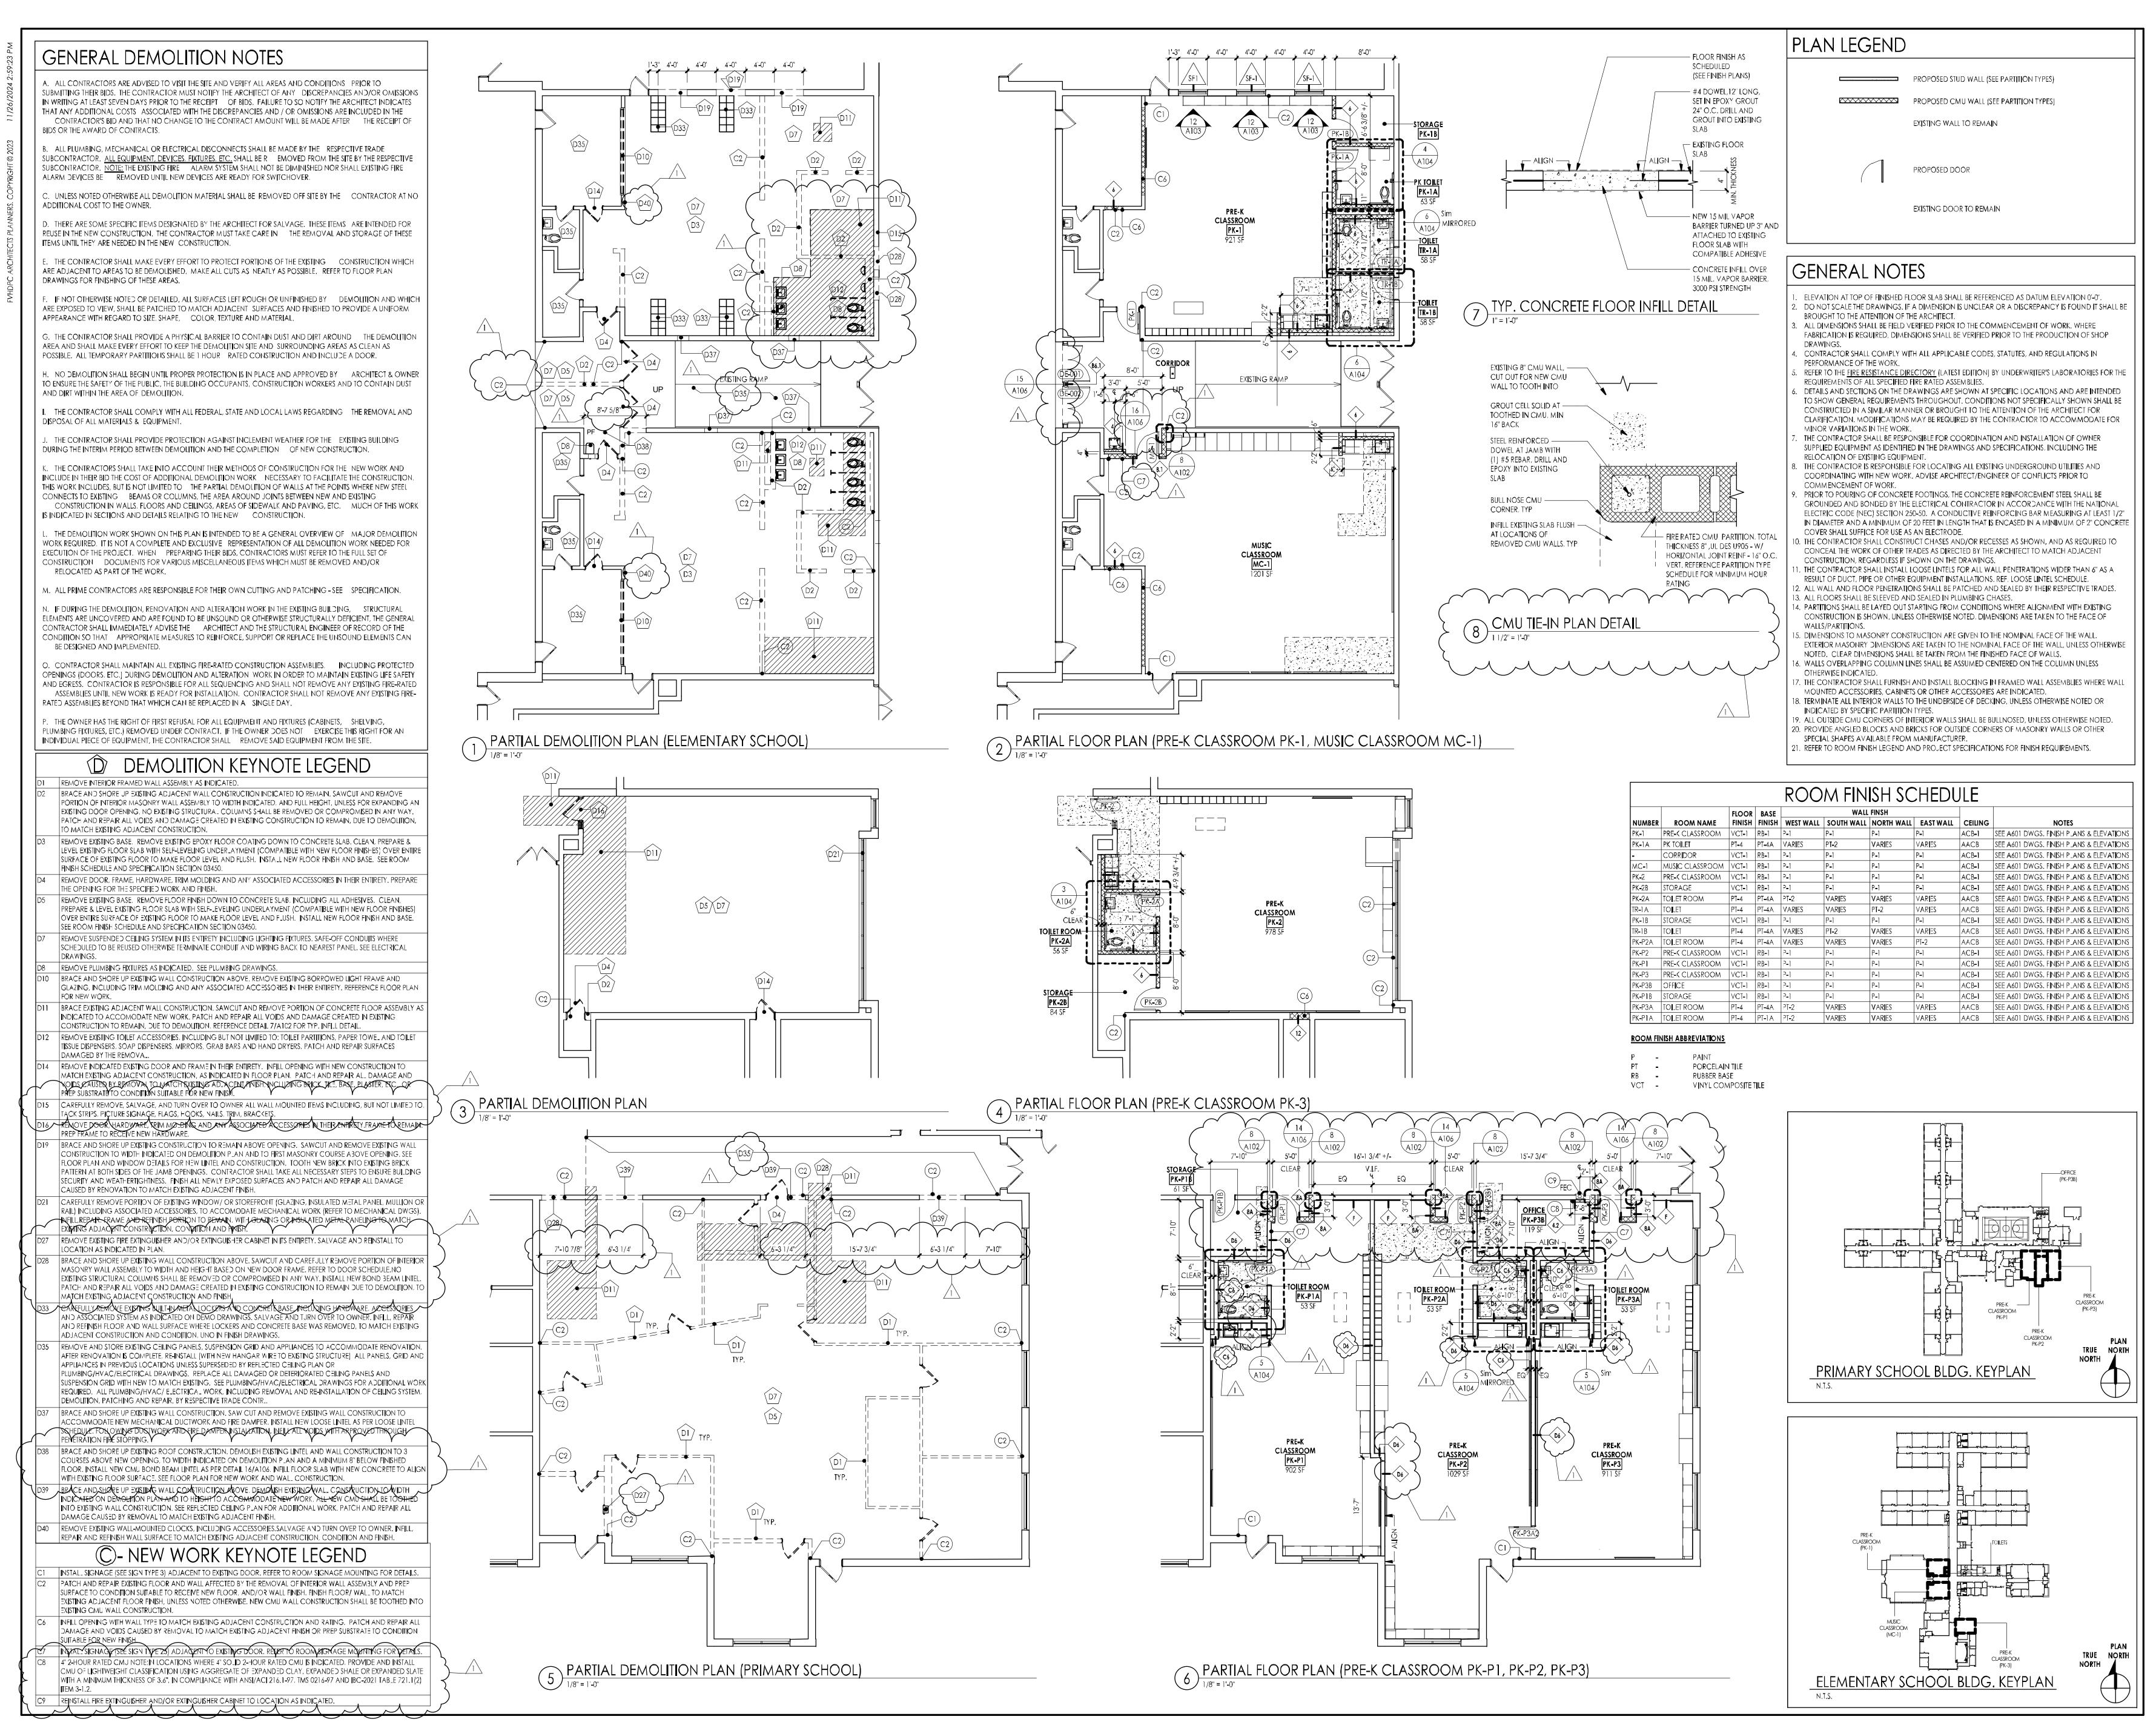

WILLIAM D. HOPKINS III, AIA, LEED AP
NJ-21A01706000 / PA-RA012520X
GEORGE R. DUTHIE JR., AIA, PP
NJ-21A01299200
JASON DUBOWITCH, AIA
NJ-21A01979800 / PA-RA406009

architects planners opkins Duthie P C

Project Name

Renovations for Five (5)

Pre-K Classrooms at

Clayton J.

Davenport

Elementary School

Project Owner Name

Egg Harbor Township School District

Project Location

2501 Spruce Avenue | Egg Harbor Township,

NJ 08234

Project Number

5481

Project Date

11/01/2024
Checked By
SWS WDH

SWS, WDH

Drawn By

Drawing Name


EMOLITION PLANS


DEMOLITION PLANS, FLOOR PLANS, AND NOTES

Revisions

No. Date Description

1 11/26/2024 Addendum 1

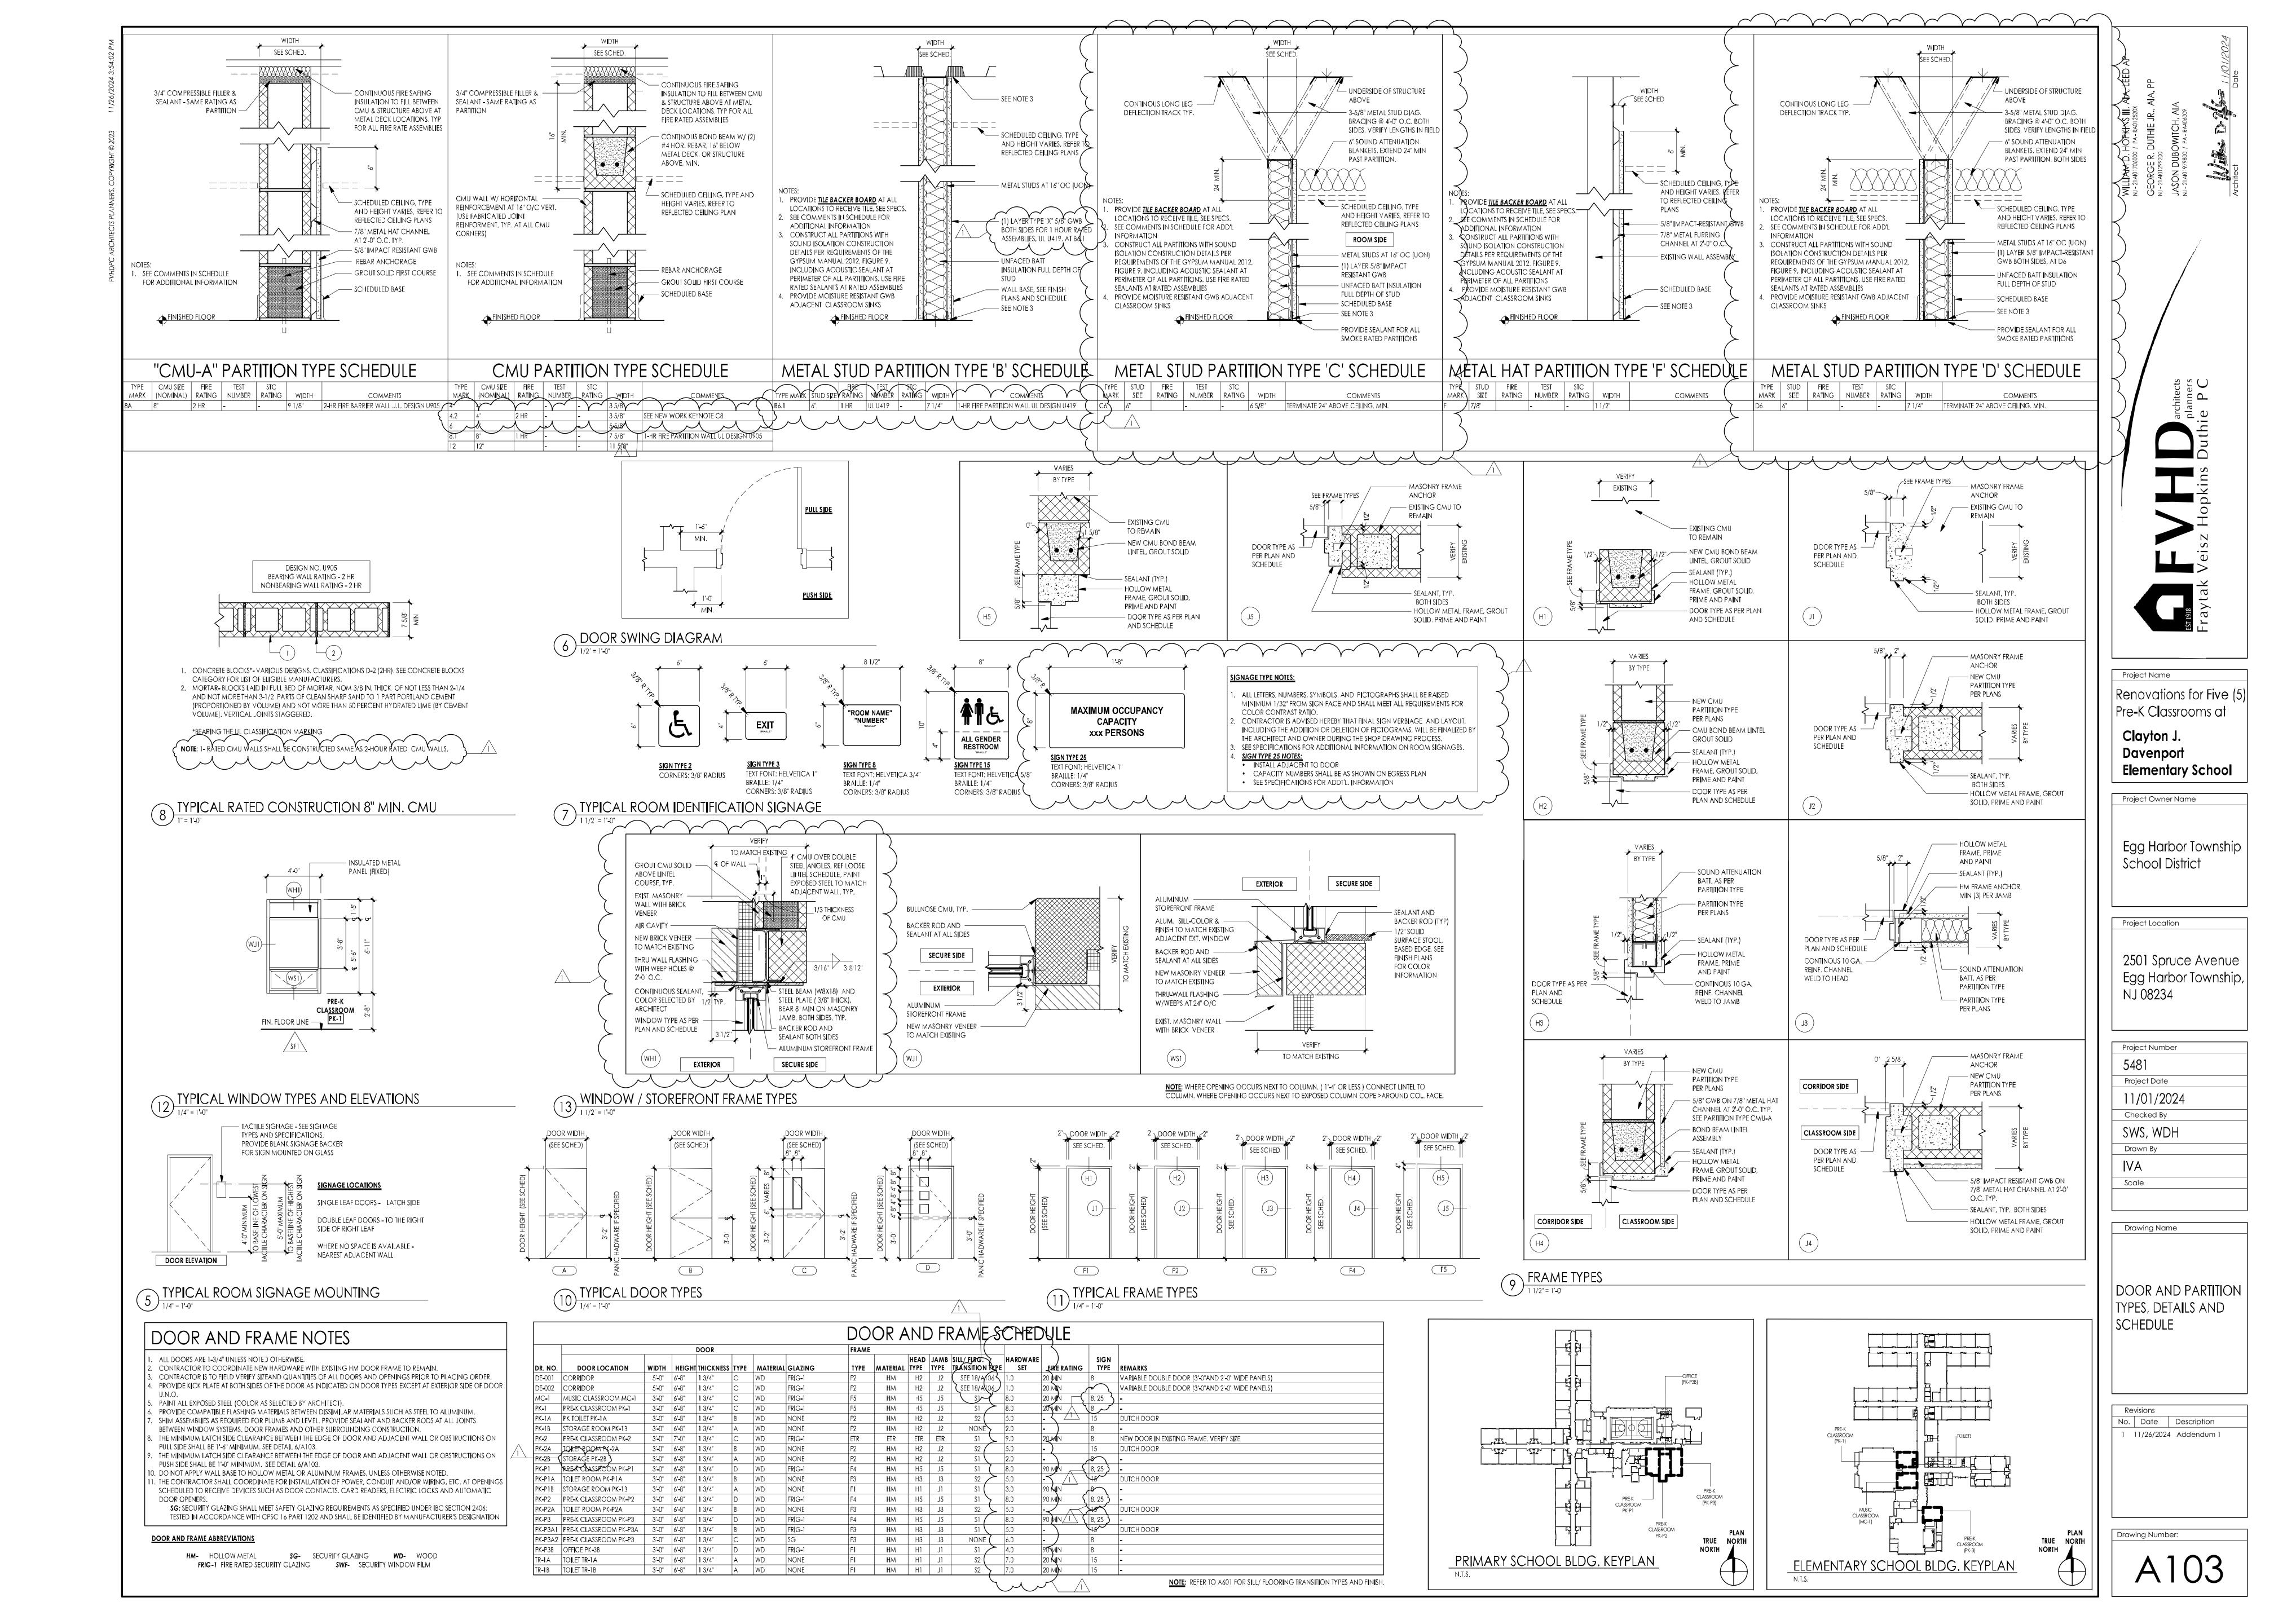

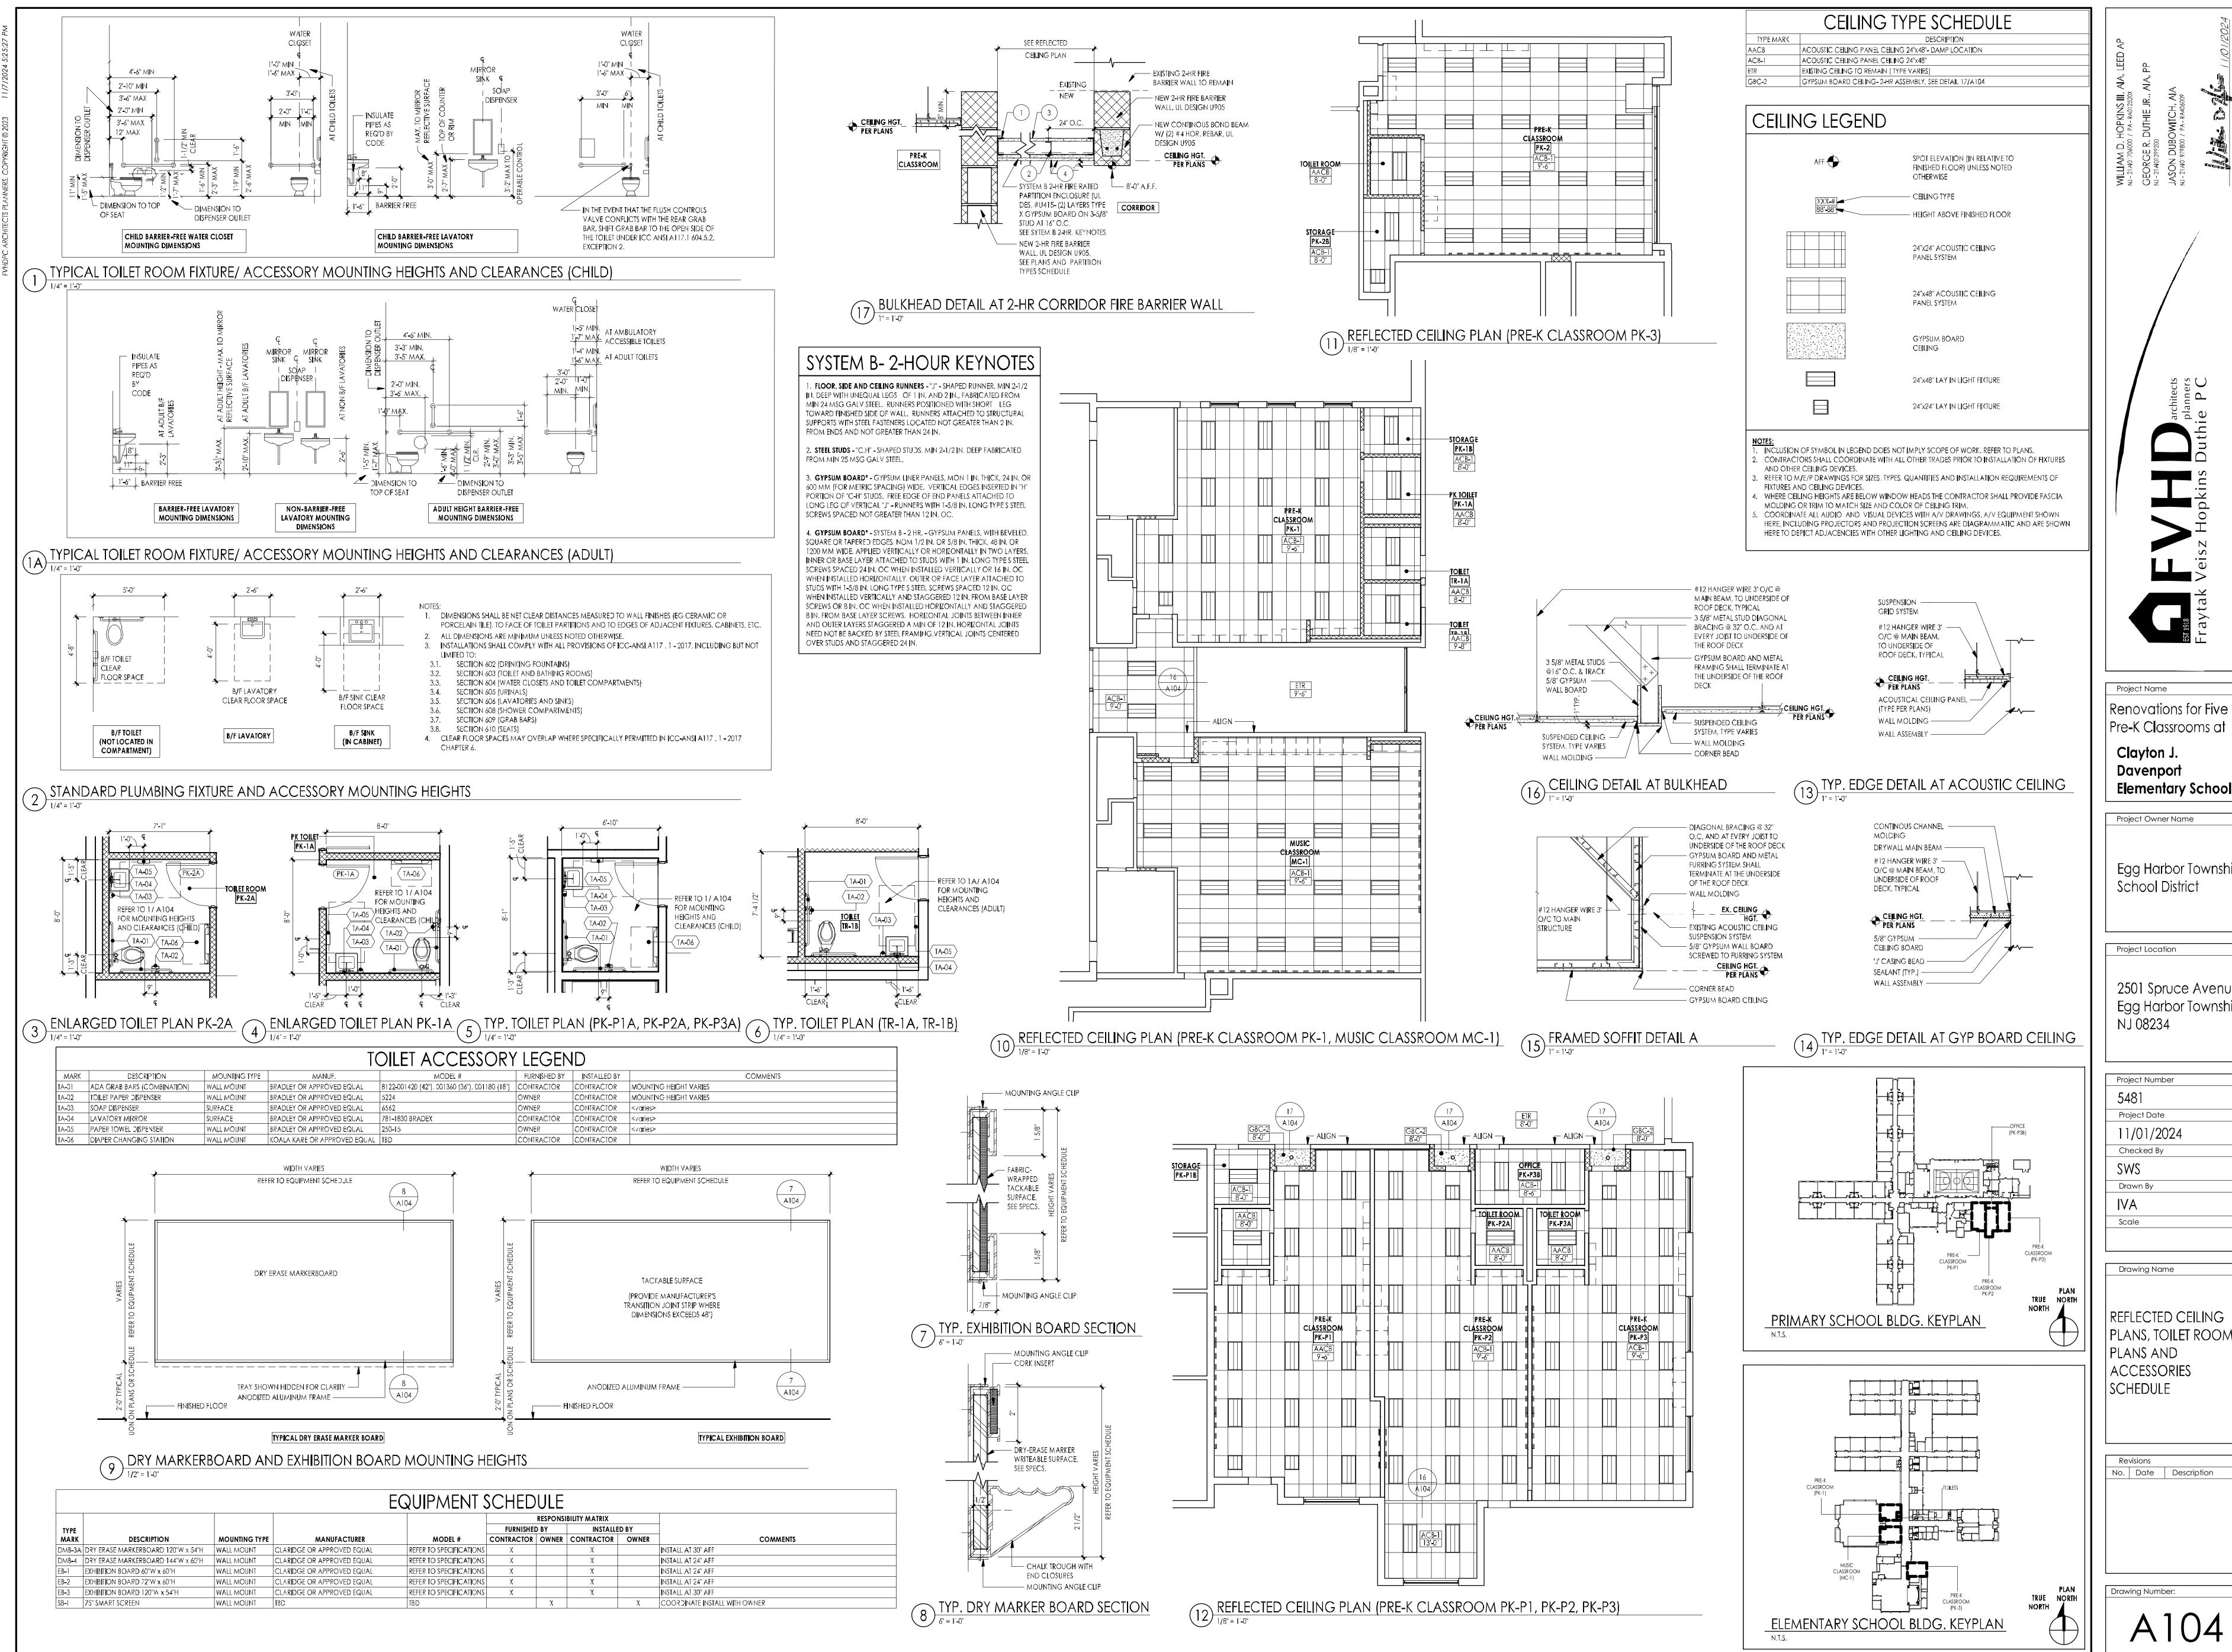

Renovations for Five (5) Pre-K Classrooms at Clayton J. Davenport

Egg Harbor Township

School District

2501 Spruce Avenue

Egg Harbor Township, NJ 08234


Project Number Project Date 11/01/2024 Checked By

Drawn By

Drawing Name

REFLECTED CEILING PLANS, TOILET ROOM PLANS AND **ACCESSORIES** SCHEDULE

No. Date Description

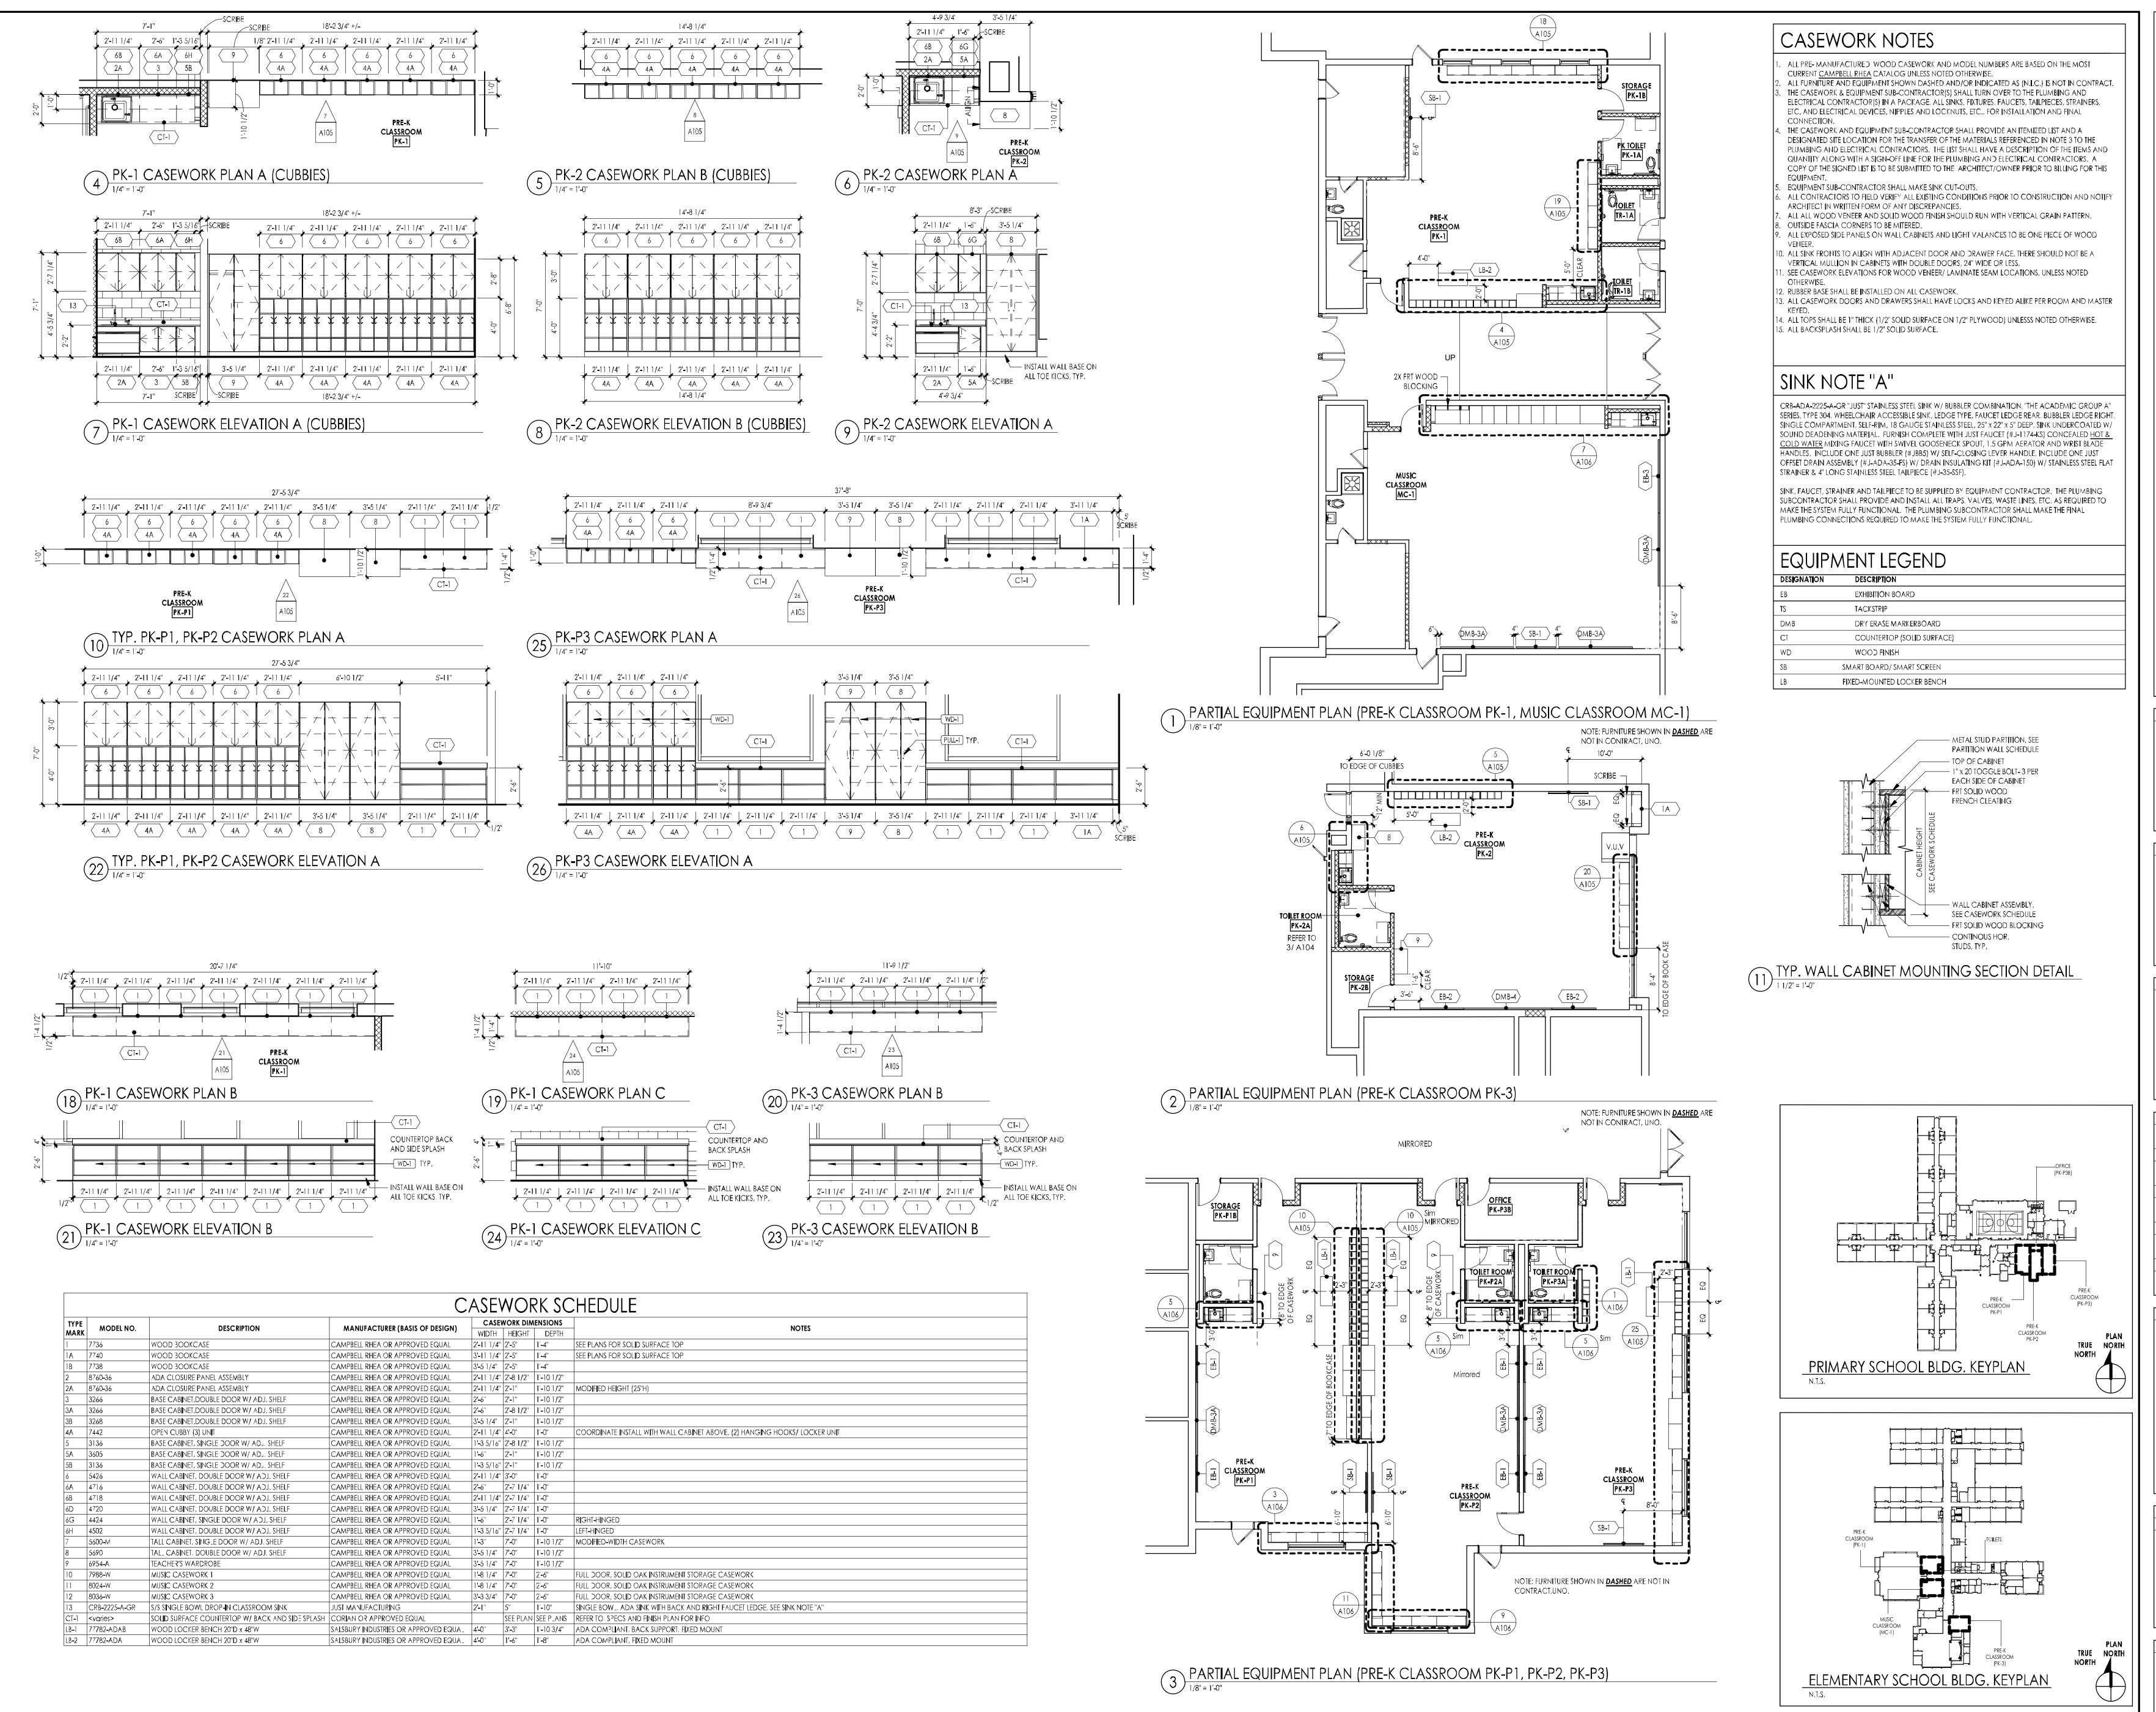

GEORGE R. DUTHIE JR., AIA, PP
NJ-21401299200
JASON DUBOWITCH, AIA
NJ-21401979800 / PA-RA406009

FWH Duthie PC

Project Name

Renovations for Five (5)

Pre-K Classrooms at

Clayton J.

Davenport

Elementary School

Project Owner Name

Egg Harbor Township School District

Project Location

2501 Spruce Avenue Egg Harbor Township, NJ 08234

Project Number

Project Date
11/01/2024
Checked By

IVA

Drawing Name

Checked By

SWS


Drawn By

Scale

CASEWORK PLANS AND ELEVATIONS

Revisions

No. Date Description

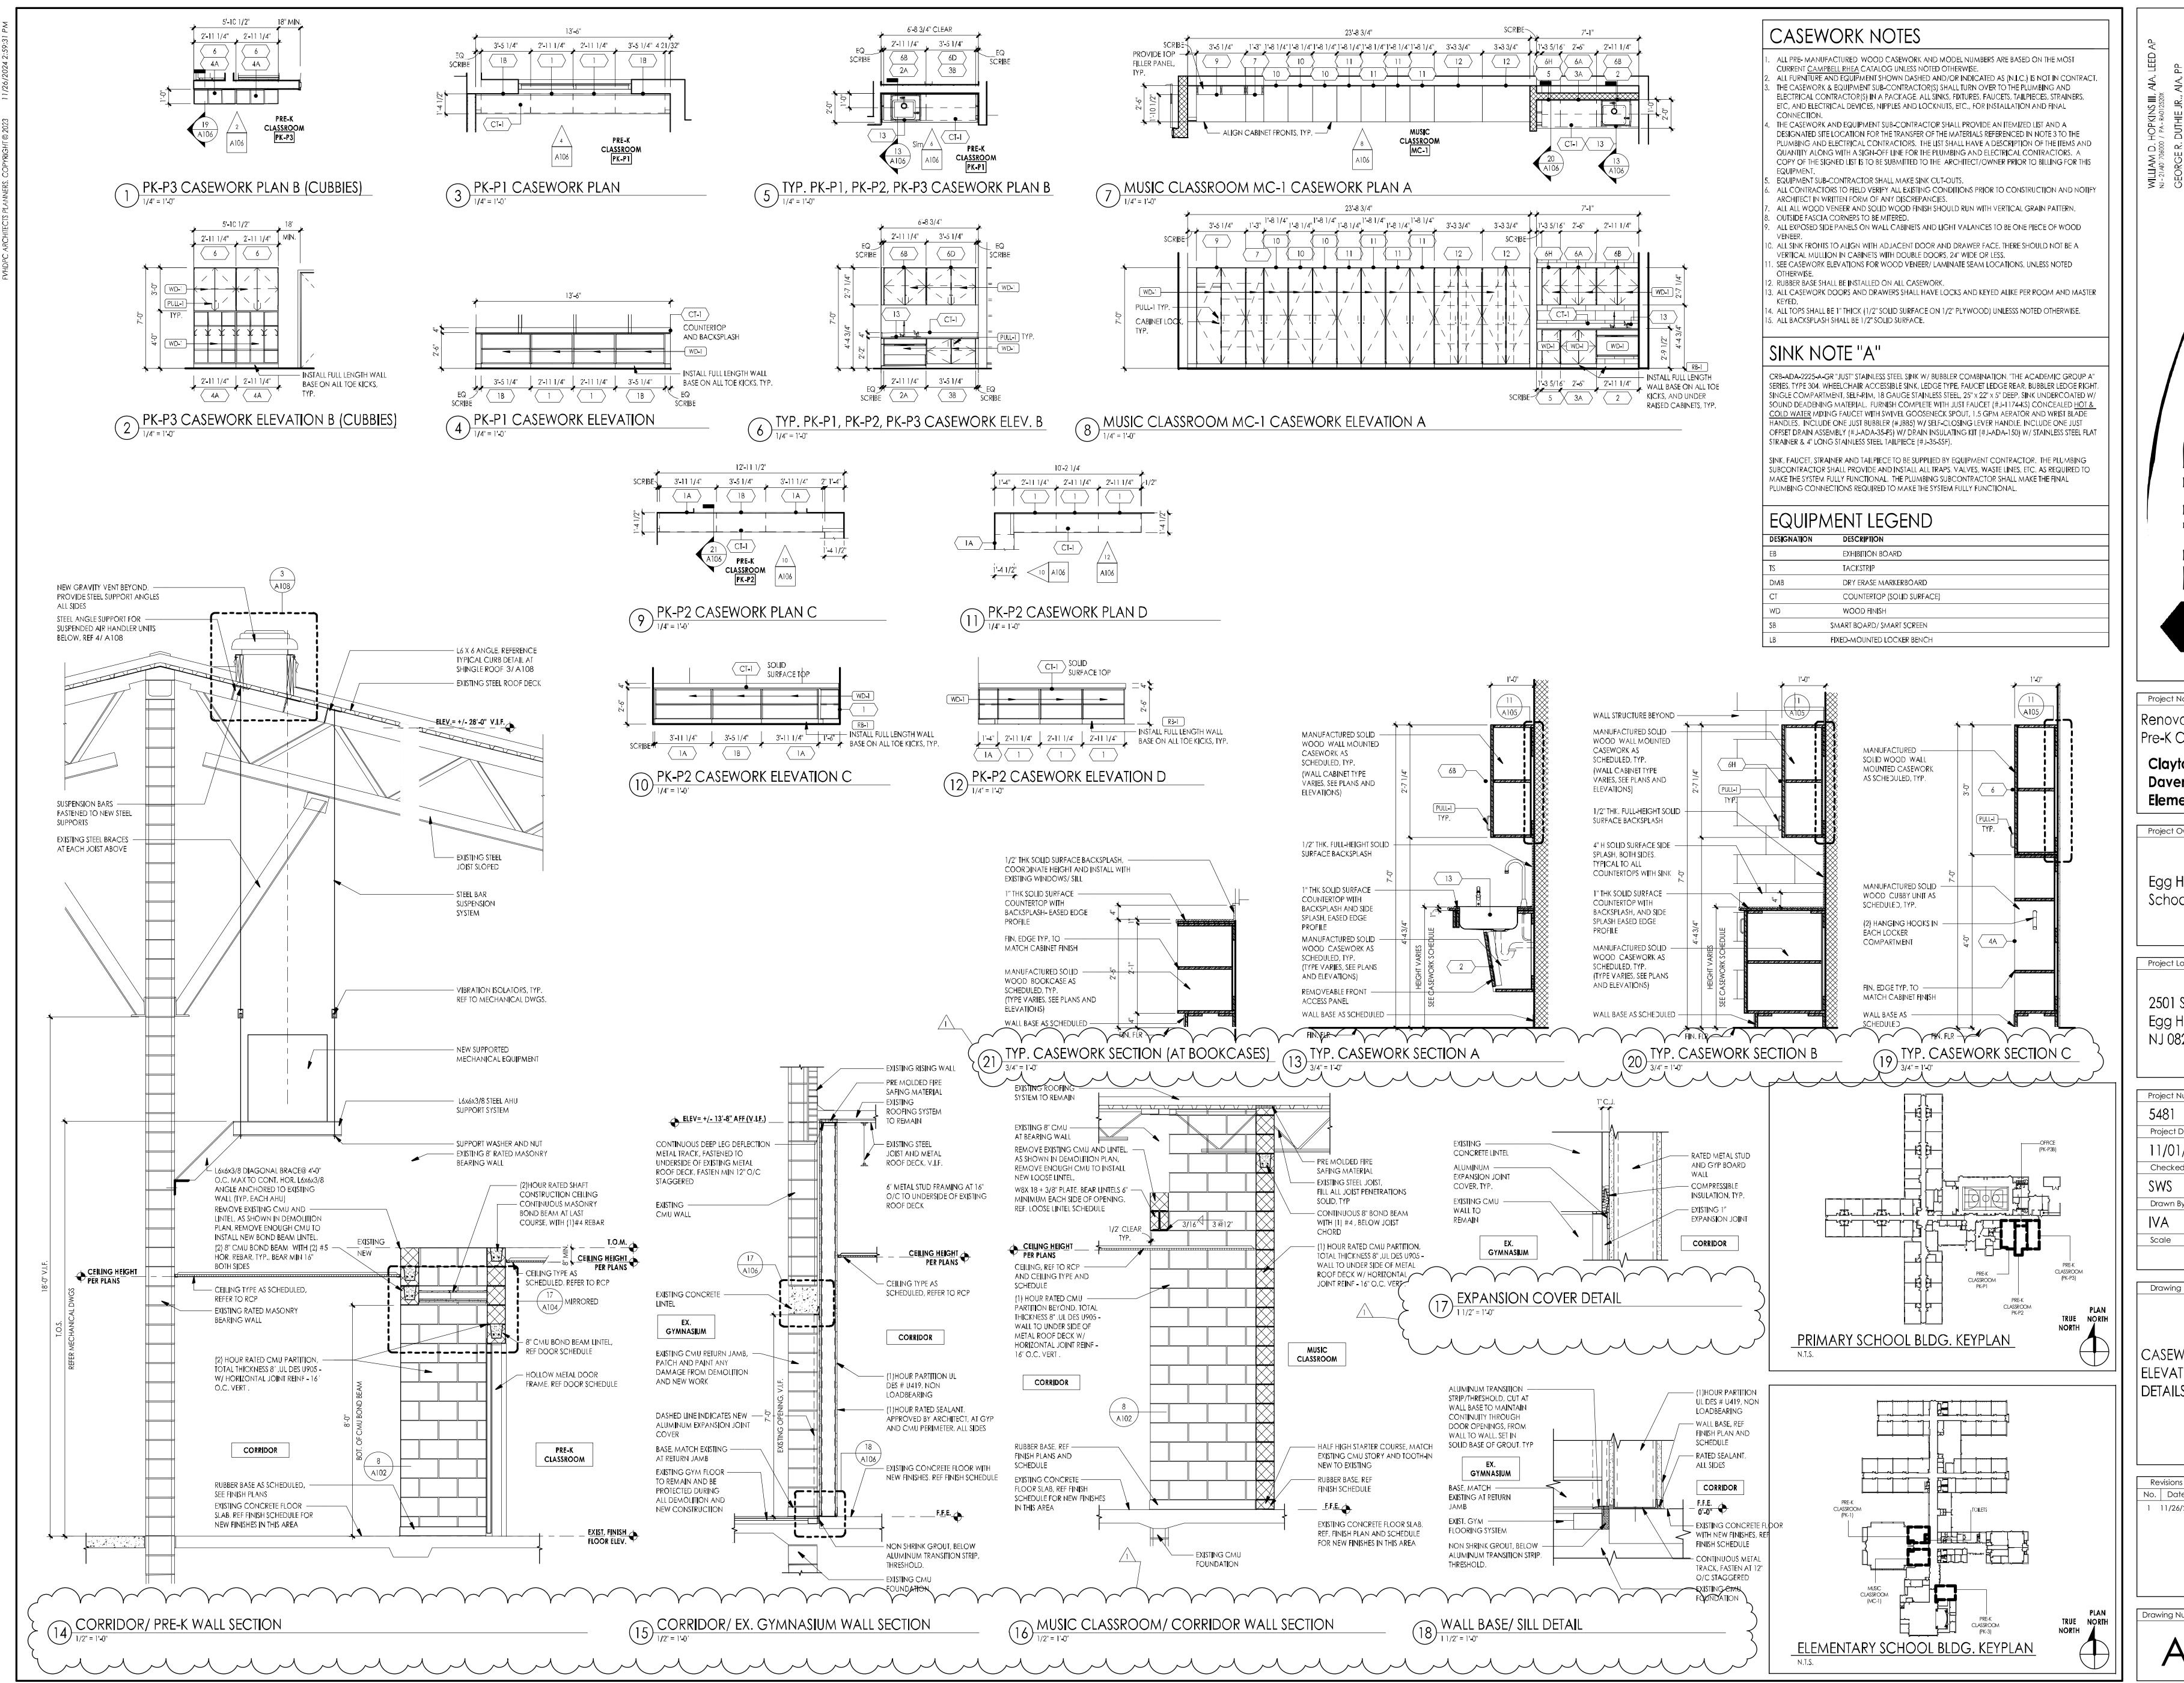

WILLIAM D. FORNINS III, AIA, LEED AF
NJ-21A01706000 / PA-RA012520X

GEORGE R. DUTHIE JR., AIA, PP
NJ-21A01299200

JASON DUBOWITCH, AIA
NJ-21A01979800 / PA-RA406009

Architect

Architect

Date

Existing | F | F | F | Fraytak Veisz Hopkins Duthie PC

Renovations for Five (5)
Pre-K Classrooms at
Clayton J.
Davenport
Elementary School

Egg Harbor Township School District


2501 Spruce Avenue Egg Harbor Township, NJ 08234

Project Number
5481
Project Date
11/01/2024
Checked By
SWS

Drawing Name

CASEWORK PLANS, ELEVATIONS AND DETAILS

Revisions
No. Date Description
1 11/26/2024 Addendum 1

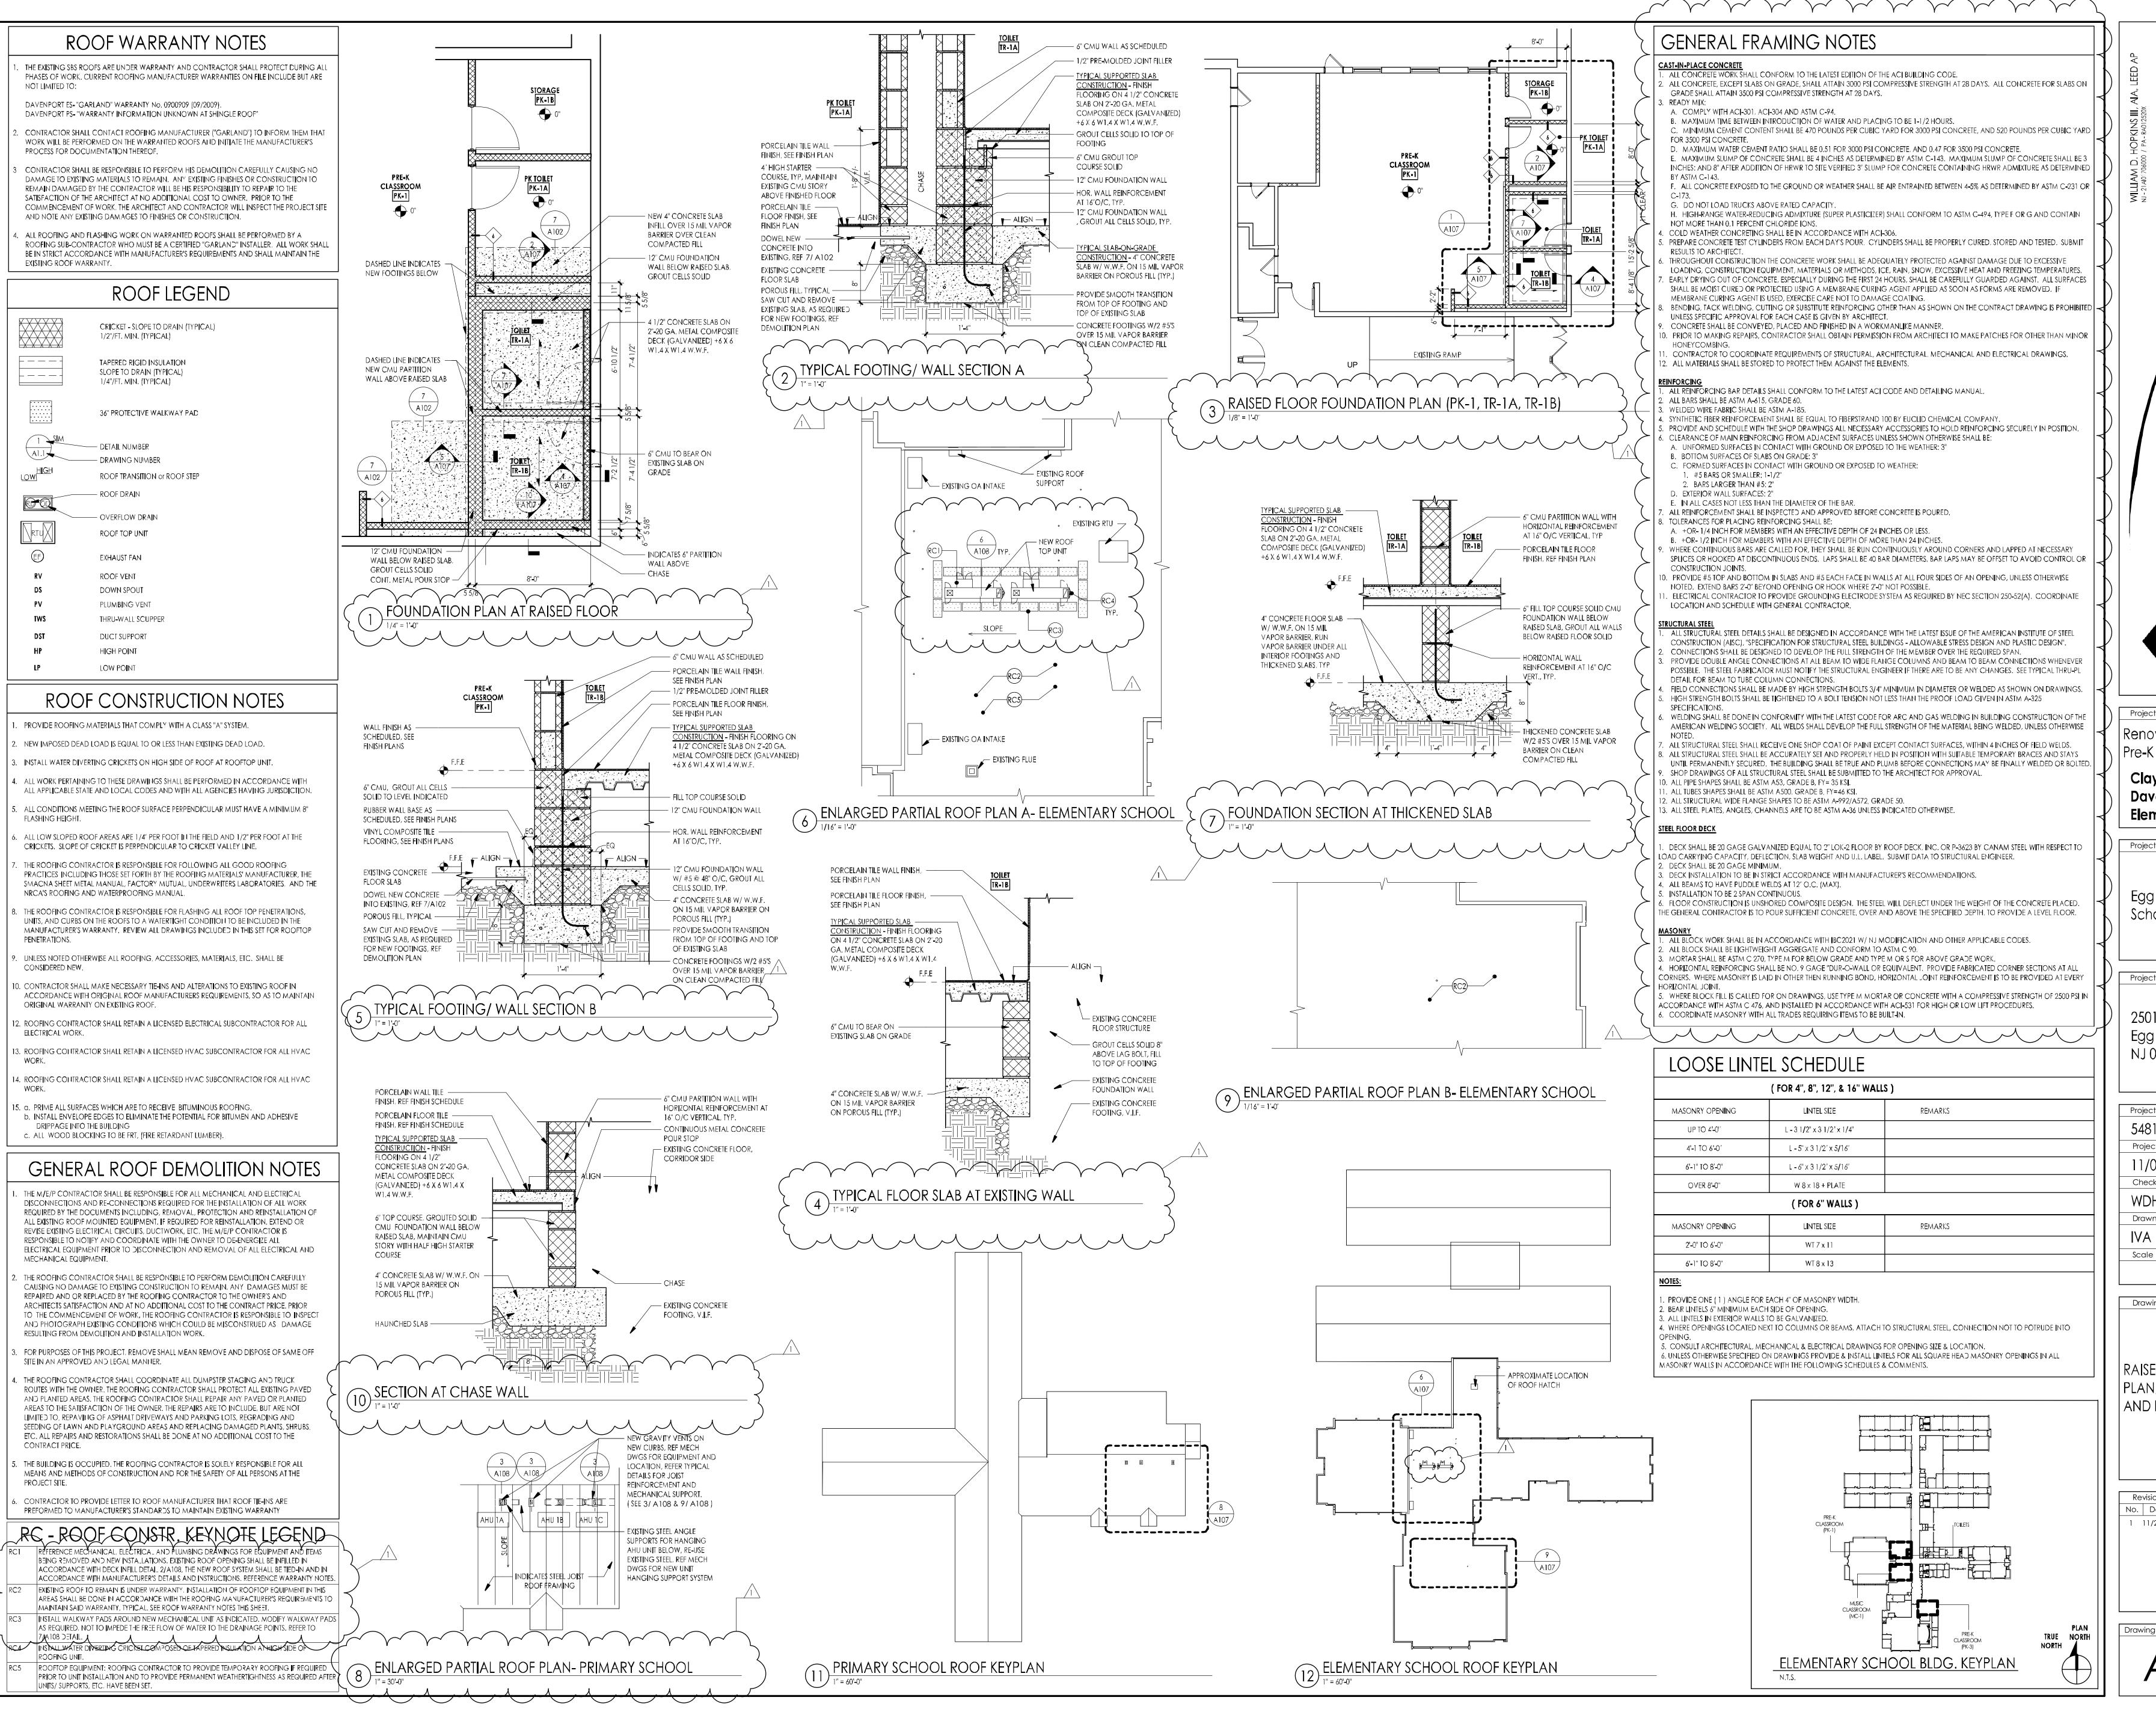

GEORGE R. DUTHIE JR., AIA, PP NJ-21A01299200
JASON DUBOWITCH, AIA

NJ-21A01979800 / PA-RA406009

FVeisz Hopkins Duthie PC

Renovations for Five (5)
Pre-K Classrooms at

Clayton J. Davenport Elementary School

Project Owner Name

Egg Harbor Township School District

2501 Spruce Avenue

2501 Spruce Avenue Egg Harbor Township, NJ 08234

Project Number

Project Date

11/01/2024

Checked By

Checked By
WDH, SWS

Drawn By

Drawing Name

RAISED FLOORING PLAN, ROOF PLANS AND DETAILS


Revisions

No. Date Description

1 11/26/2024 Addendum 1

Drawing Number:

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Renovations for Five (5) Pre-K Classrooms at

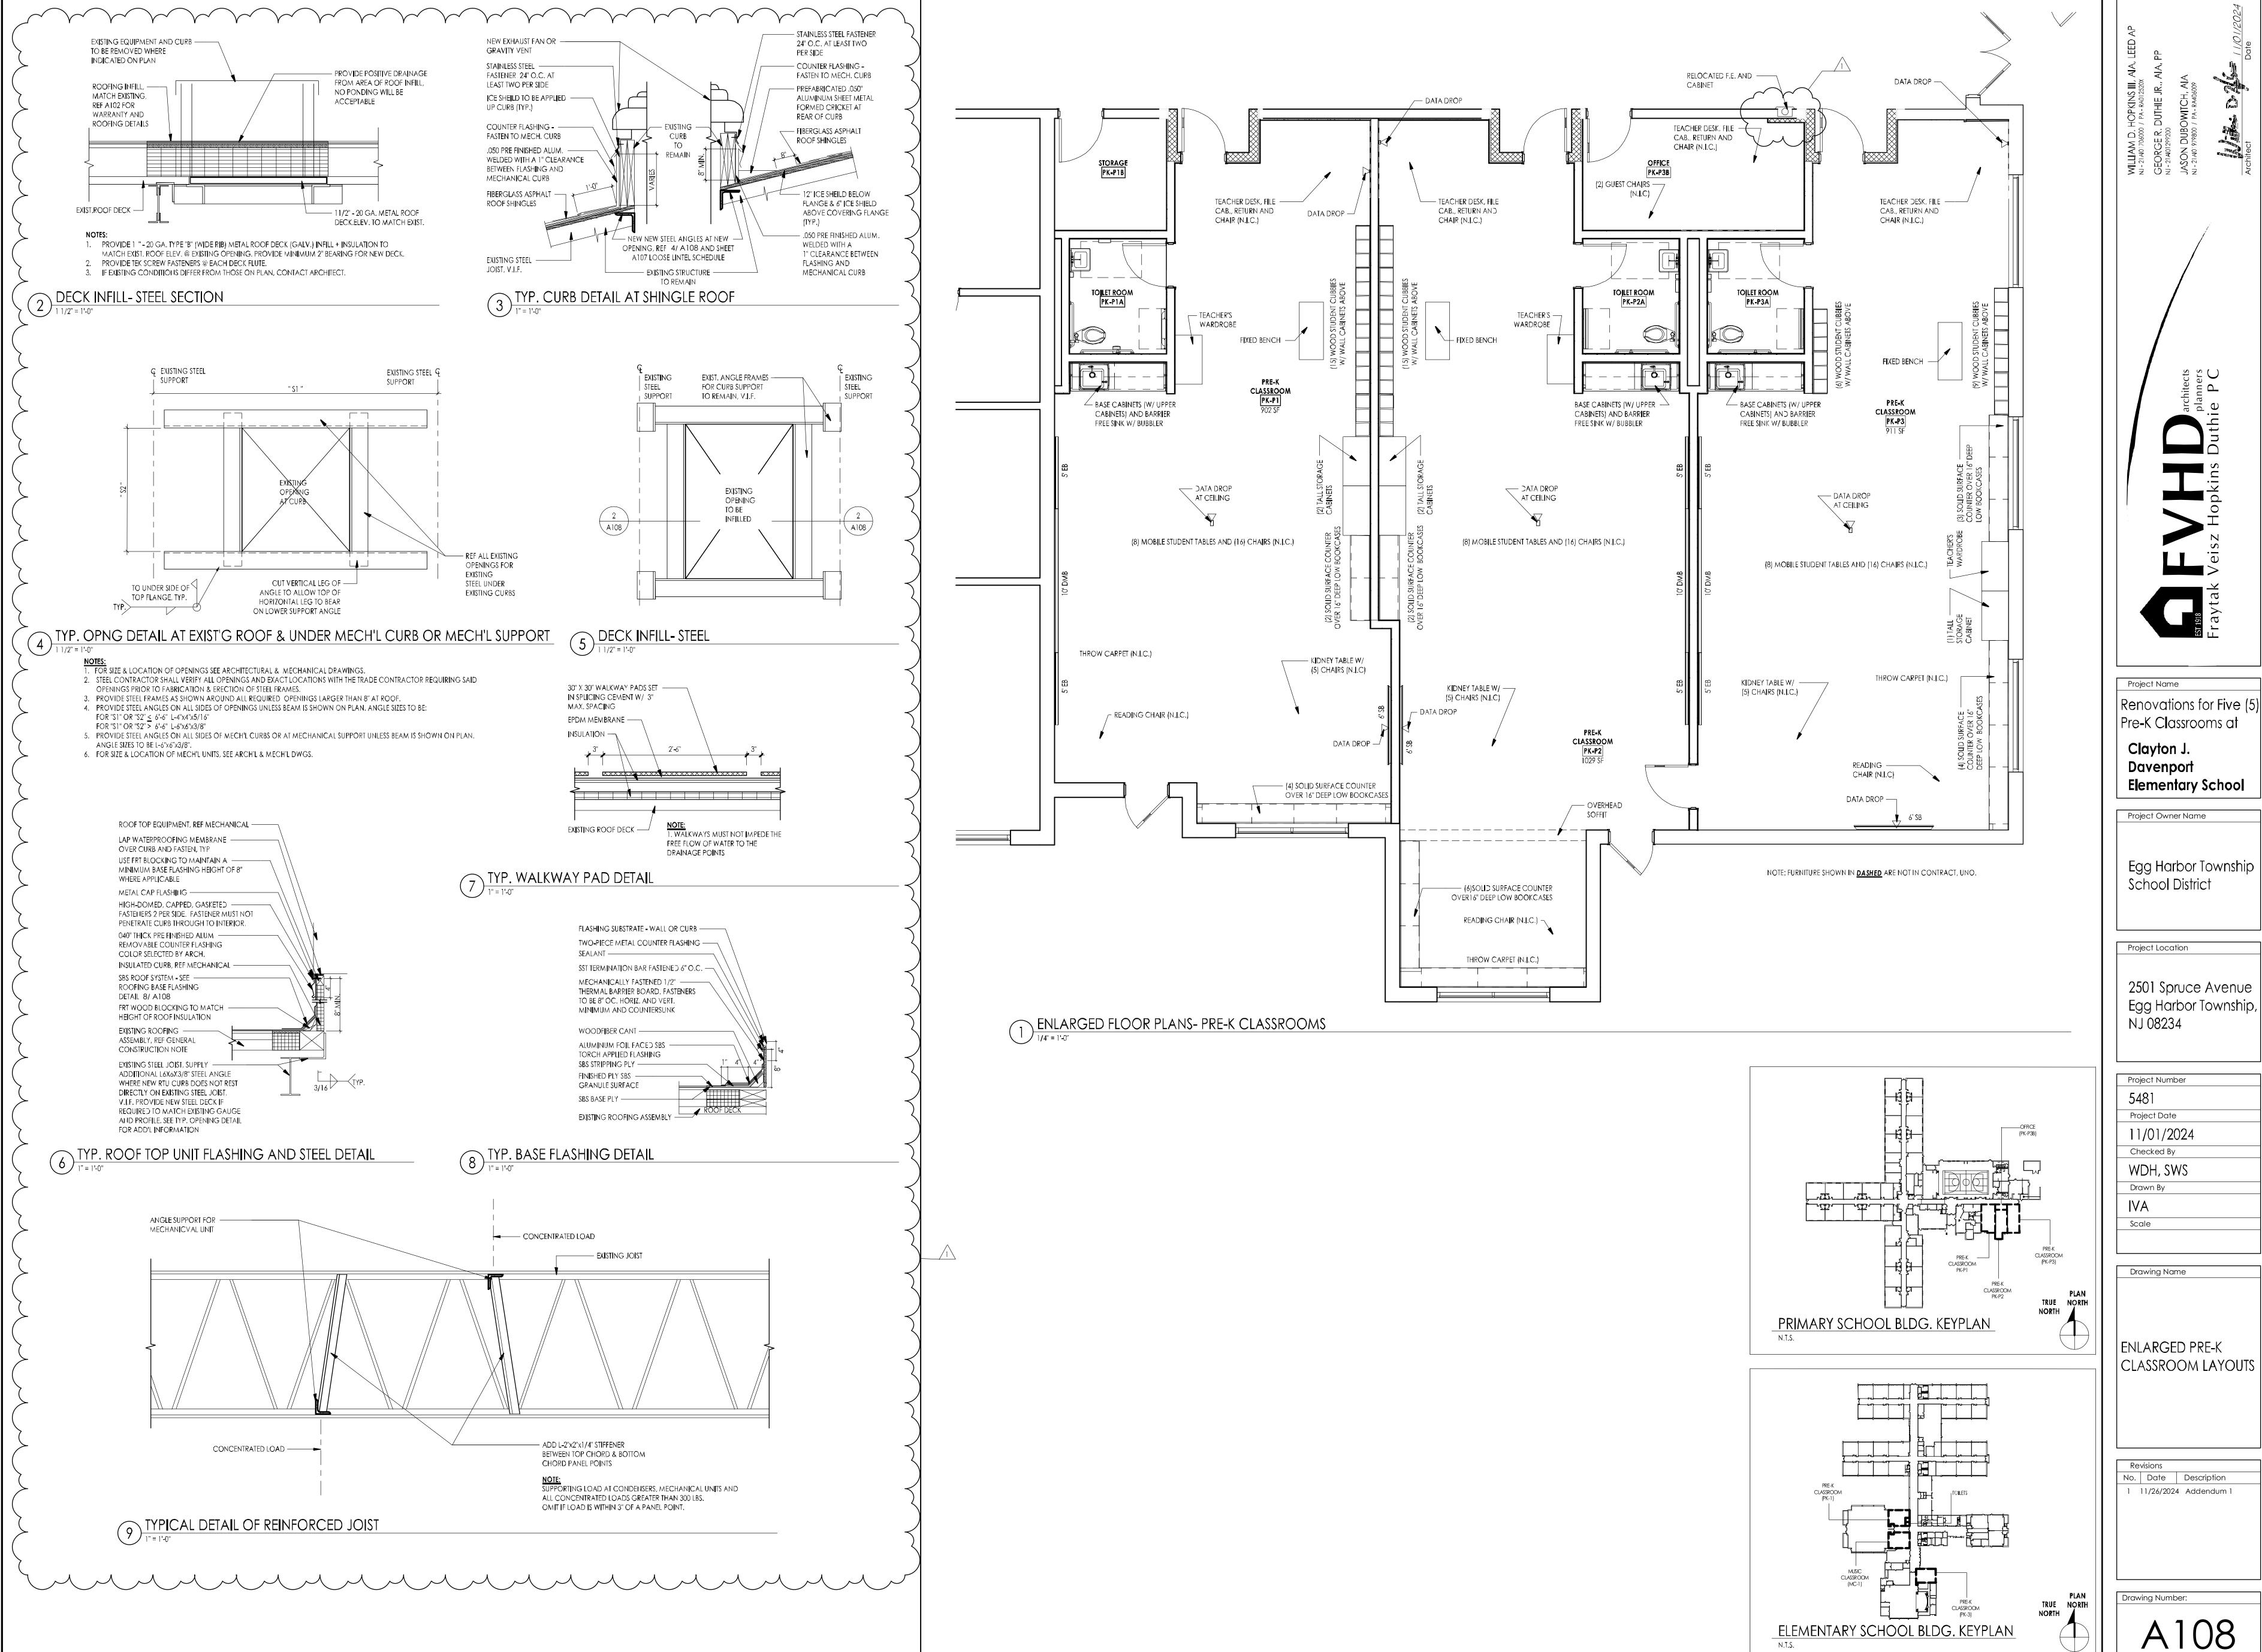
Project Owner Name


Egg Harbor Township |


2501 Spruce Avenue

ENLARGED PRE-K

No. Date Description

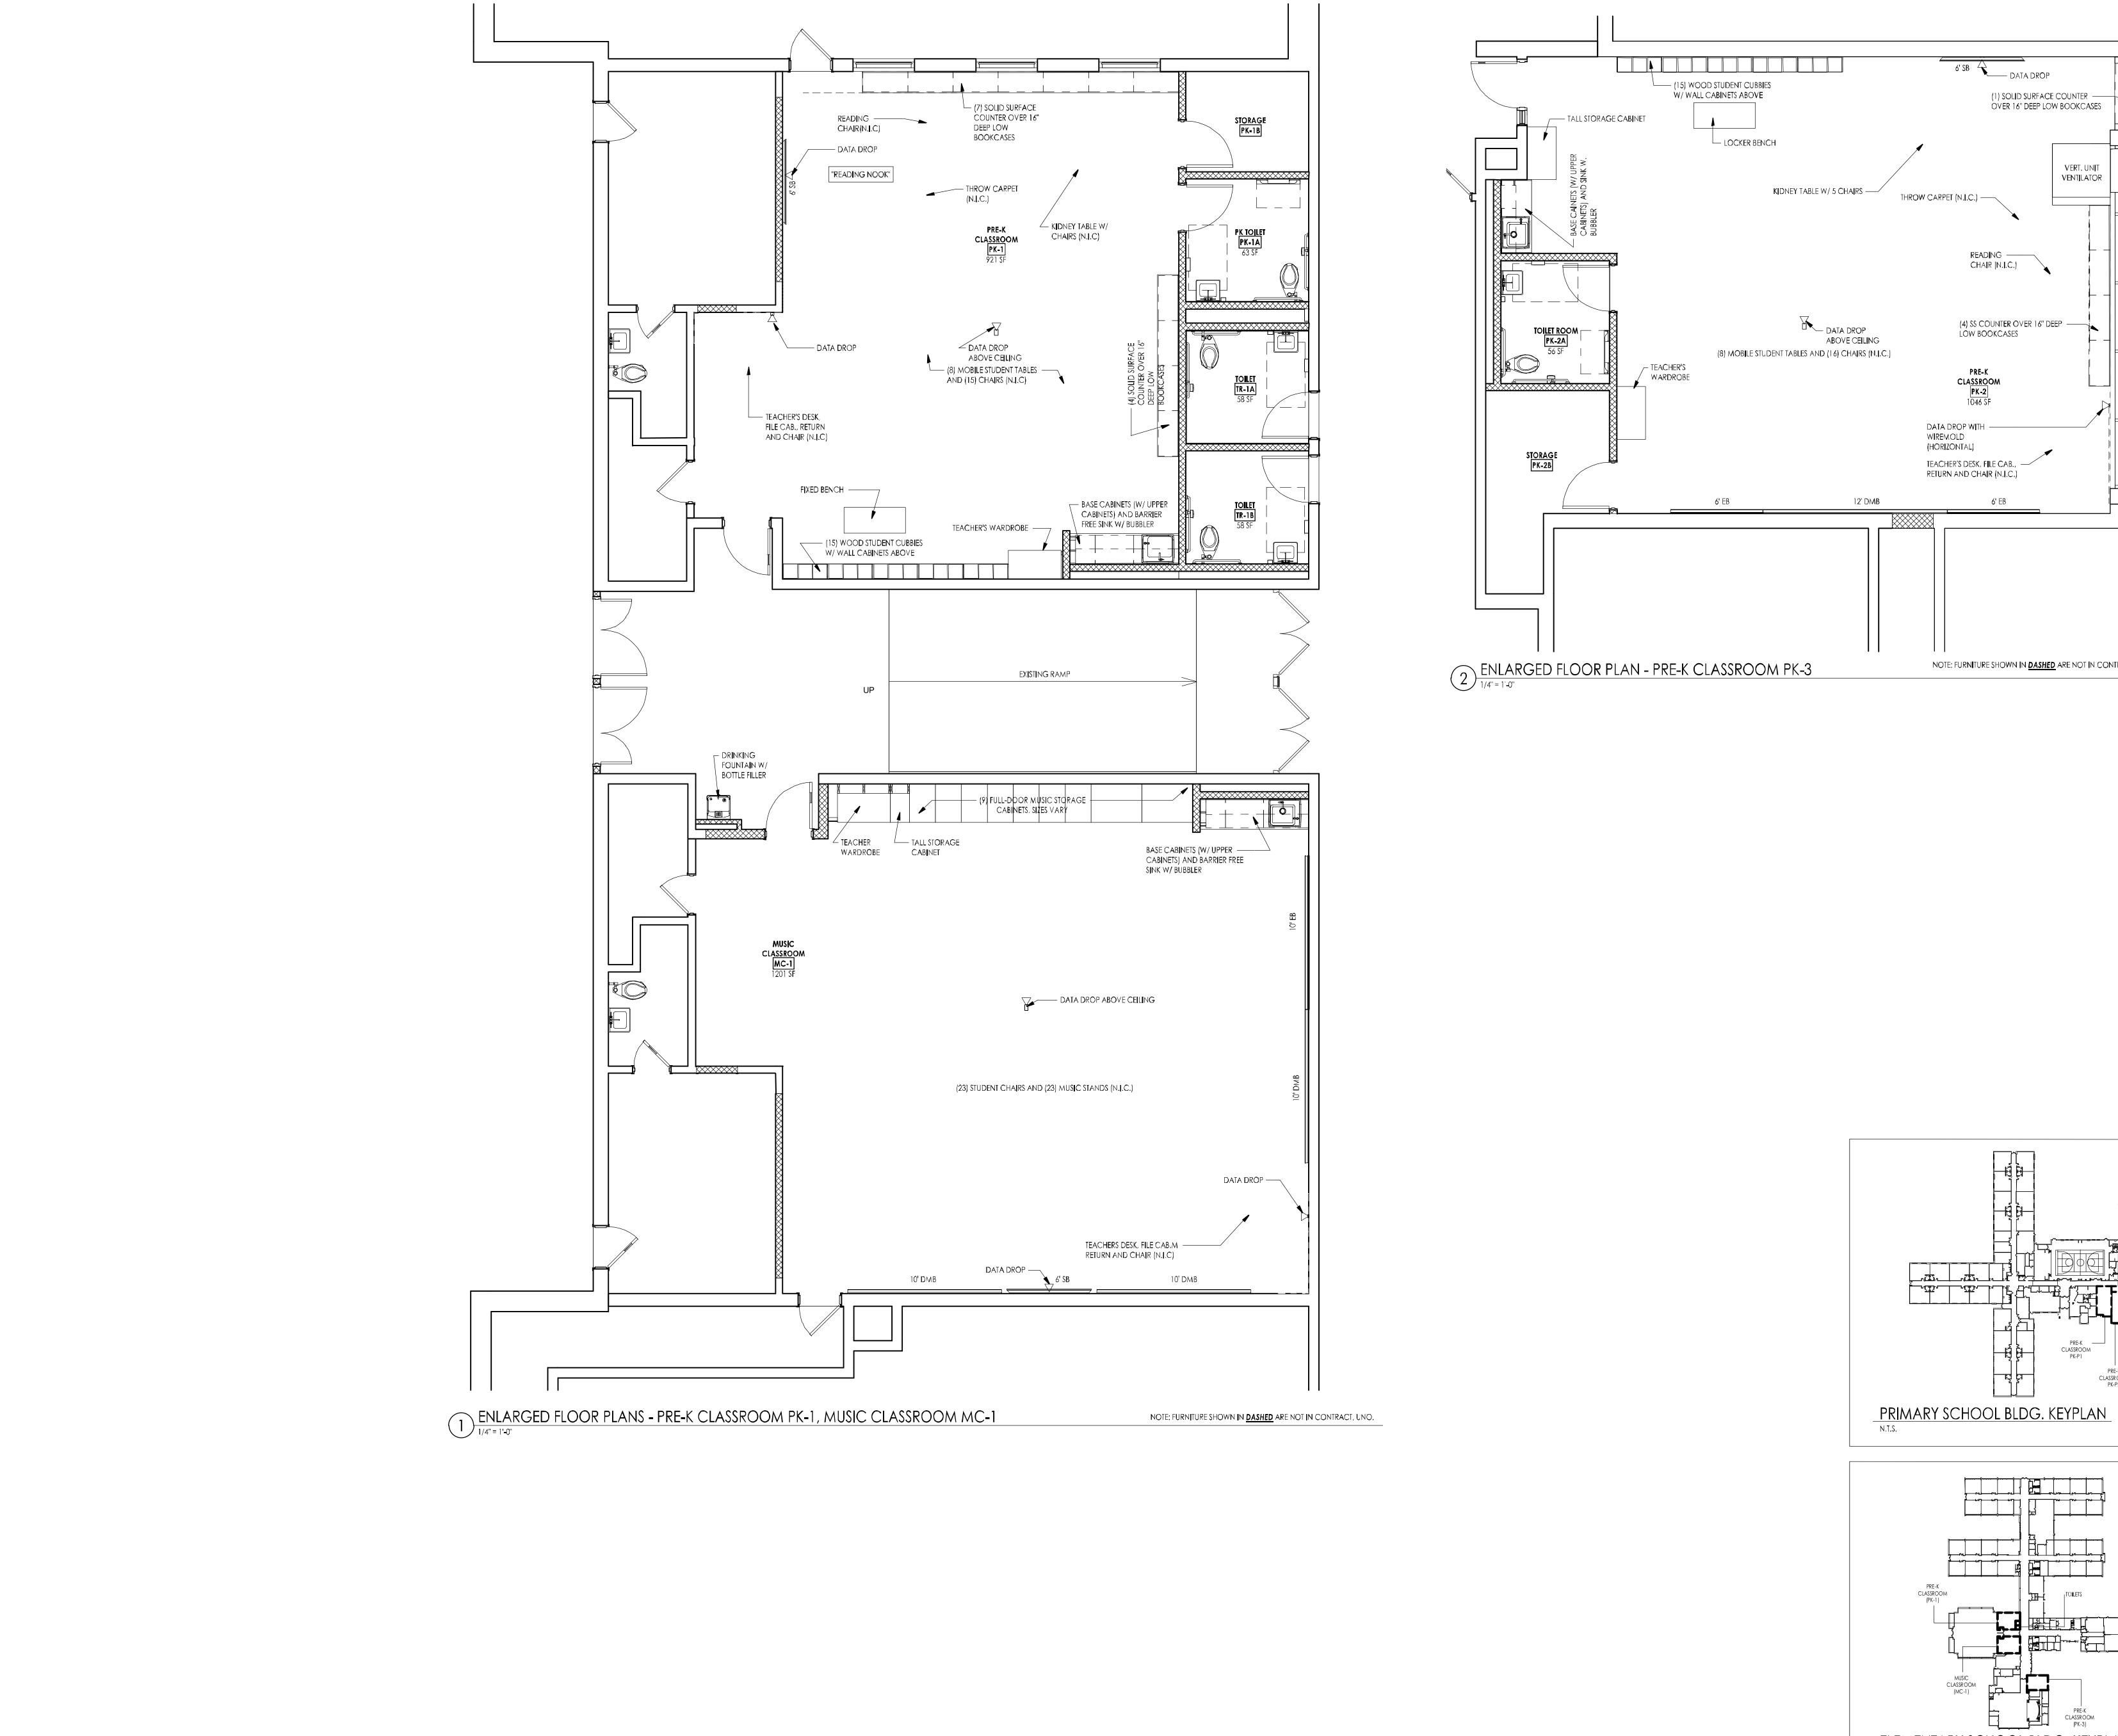

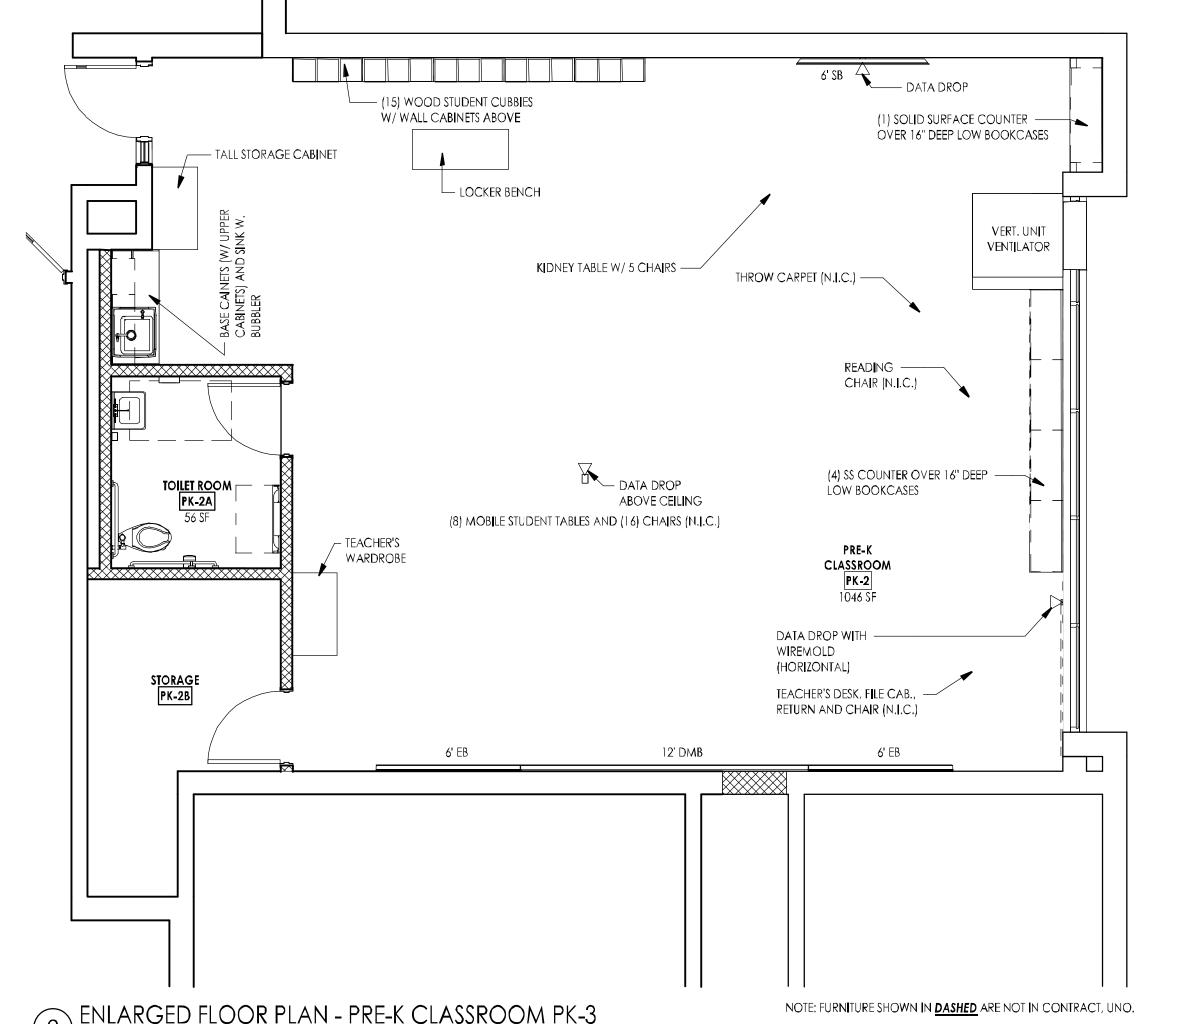

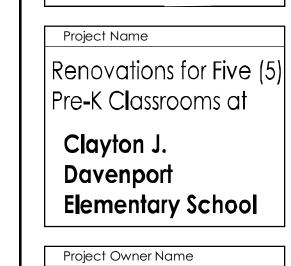

Egg Harbor Township School District

Project Location 2501 Spruce Avenue Egg Harbor Township, NJ 08234

Project Number Project Date 11/01/2024 Checked By WDH, SWS Drawn By Scale

OFFICE (PK-P3B)

CLASSROOM (PK-P3)


PLAN TRUE NORTH NORTH

TRUE NORTH NORTH

Drawing Name

ENLARGED PRE-K AND MUSIC CLASSROOM LAYOUTS

No. Date Description

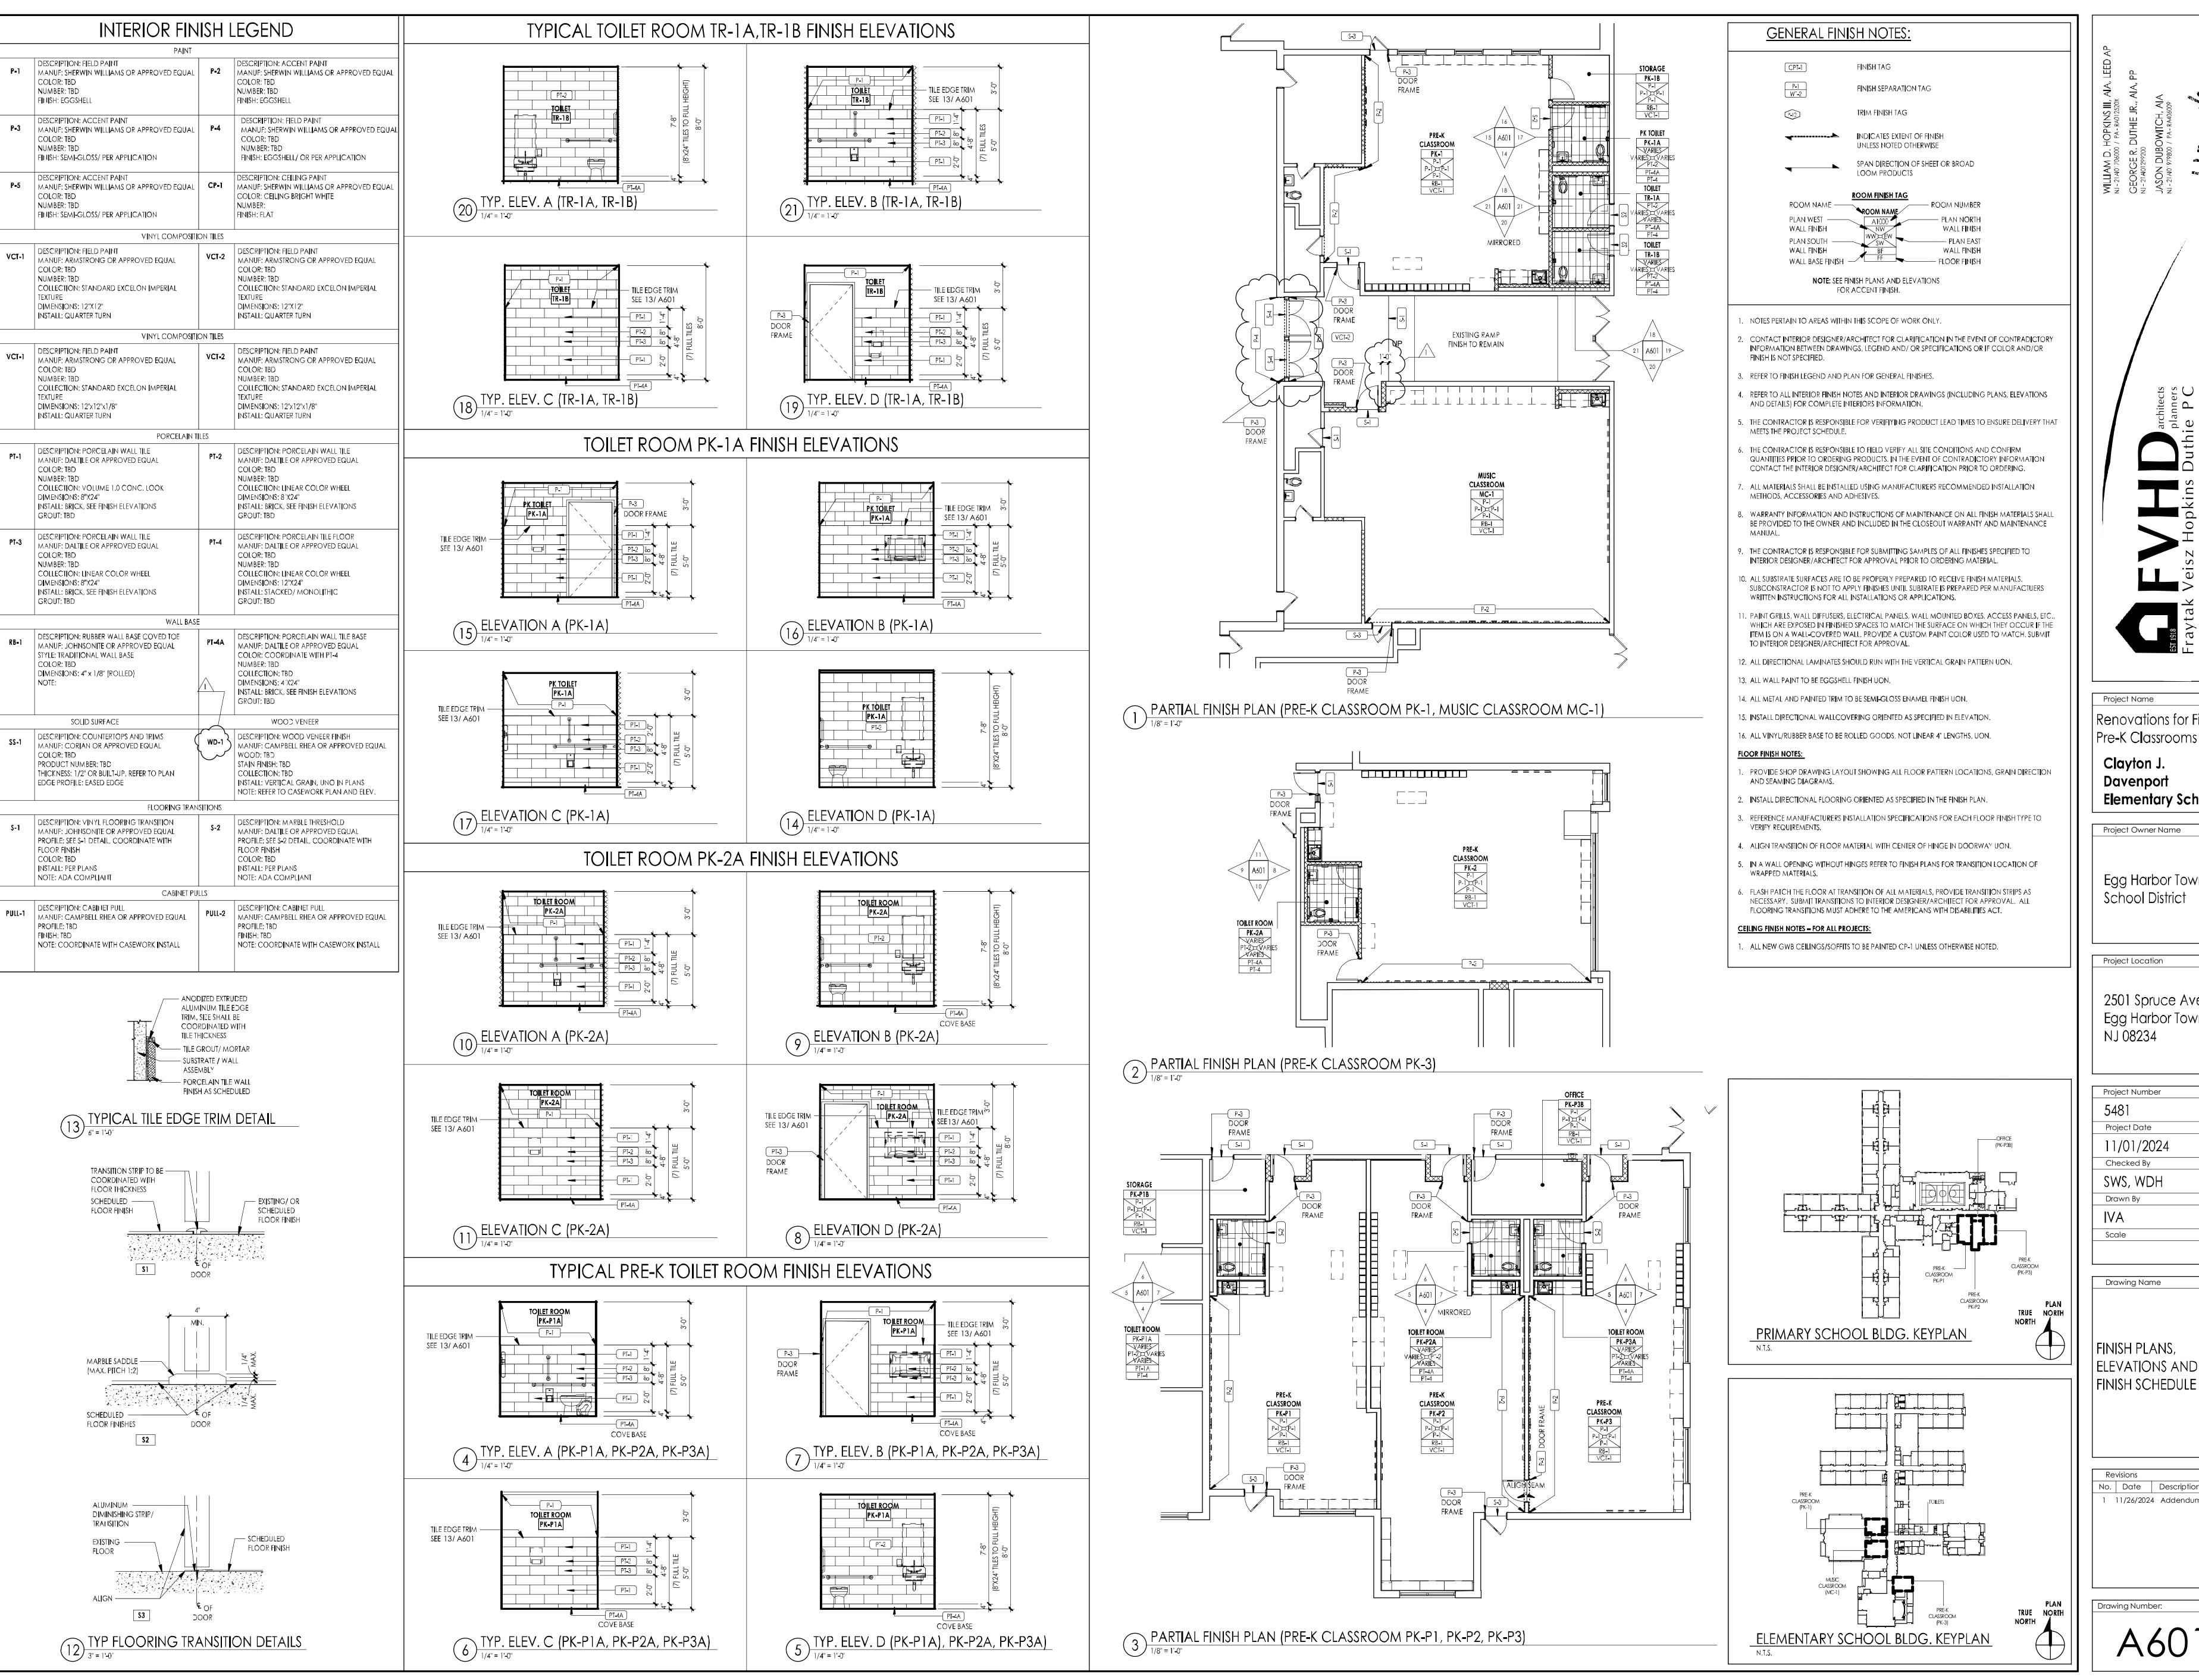

Renovations for Five (5) Pre-K Classrooms at

Davenport Elementary School

Project Owner Name

Egg Harbor Township School District

Project Location

2501 Spruce Avenue

Egg Harbor Township, NJ 08234

Project Number

Project Date

11/01/2024 Checked By

Scale

SWS, WDH

Drawn By

Drawing Name

FINISH PLANS, ELEVATIONS AND

No. Date Description

11/26/2024 Addendum

	PLUMBING LEGEND		
		Į.	
← — — →	REMOVAL WORK (REFER TO PLAN)	} 	THERMOMETER
.	EXISTING	Ø	PRESSURE GAUGE W/ COCK
$G \longrightarrow G$	GAS STORM DRAIN		TRESSURE GAUGE W/ COCK
	SOIL OR WASTE PIPING	کے کے	AIR VENT W/ COCK
<u> </u>	VENT	P	
	ACID WASTE	} 	AUTOMATIC AIR VENT
├ ∨ ∨ ∧ · · · · · · · · · · · · · · · · ·	ACID VENT	بـــــــــــ	AQUASTAT
	DOMESTIC COLD WATER	7	
	DOMESTIC HOT WATER		WATER HAMMER ARRESTOR
	DOMESTIC HOT WATER RETURN	FS T ,	- 1 0.11 0.11 - 0.1
> DW — >	DISTILLED WATER		FLOW SWITCH
140°	DOMESTIC HOT WATER (140°)	Ps T	PDF00UDF 0WITOU
2—— 140° ——— 2	DOMESTIC HOT WATER RETURN (140°)		PRESSURE SWITCH DIAPHRAGM
2 180°	DOMESTIC HOT WATER (180°)	- M−O−M−3	METER
2—— 180° —— 2	DOMESTIC HOT WATER RETURN (180°) SANITARY FORCED MAIN		PIPE TURNING DOWN
FOS	FUEL OIL SUPPLY	~	PIPE TURNING UP
FOR ——	FUEL OIL RETURN	├	TEE UP
FOV ——	FUEL OIL VENT	} 	TEE DOWN
← RG ←	REGULAR UNLEADED GASOLINE		DROP AND RUN
├ ── PG ──	PREMIUM GASOLINE	<u>, </u>	DDOD AND TUDN
← DF ←	DIESEL FUEL	~ ↑	DROP AND TURN
← GV 	GASOLINE VENT	ک ل	TEE OFF TOP
├ ── LO ──	LUBRICATING OIL		BACK FLOW PREVENTER
LOV	LUBRICATING OIL VENT	2\\\\\\\\\\\\\\\\\\\\\\\\\\\\\\\\\\\\	HEAT TRACE
₩ • • • • • • • • • • • • • • • • • • •	WASTE OIL	رح)	PUMP
₩OV ——	WASTE OIL VENT		INLINE PUMP
← CA ← → MA ← →	COMPRESSED AIR		
LA ——	MEDICAL COMPRESSED AIR LABORATORY COMPRESSED AIR	0	ROOF DRAIN
ک _ ر ک ح	VACUUM		PLAIN COMBO FLOOR DRAIN
 LW 	LABORATORY WASTE	₫ [™]	PLAIN ROUND FLOOR DRAIN
<u> </u>	MEDICAL VACUUM	Ē.	PLAIN SQUARE FLOOR DRAIN
├ LV ├	LABORATORY VACUUM	ıT	LLOOF PIP
├ ∨C	VACUUM CLEANING	<u> </u>	HOSE BIB
├ ── ○ ───	OXYGEN	∇	SHOWER HEAD
\longrightarrow LOX \longrightarrow	LIQUID OXYGEN	Ŷ	SIAMESE CONNECTION
HPS -	HIGH PRESSURE STEAM (100-70 PSI)		
HPC	HIGH PRESSURE CONDENSATE		
NO ——	NITROUS OXIDE		
N ————————————————————————————————————	NITROGEN		
	TEMPERED WATER INDIRECT WASTE PIPING	STAN	DARD SYMBOLS
€——LS ——→	LAWN SPRINKLER SUPPLY		
د کا ح	PIPE SLOPE - IN DIRECTION OF ARROW	◆	DATUM POINT
		<u>_</u> #	REVISION
	FLOW - IN DIRECTION OF ARROW	(# >	NEW WORK NOTE DESIGNATION
	GATE VALVE	# >	REMOVAL WORK NOTE DESIGNATION
	GLOBE VALVE CHECK VALVE		
₹	BALANCING VALVE		CONNECT TO EXISTING
~ ~ ~ ~ ~ ~ ~ ~ ~ ~ ~ ~ ~ ~ ~ ~ ~ ~ ~	BALL VALVE		EXTENT OF REMOVAL
-	BUTTERFLY VALVE		EQUIPMENT ABBREVIATION
- >→	VALVE ON RISE		TAG NUMBER
حـــا∳ـــــخ	GAS COCK, GAS STOP	NUMBER — X F	PLAN, SECTION, OR DETAIL
<u>=</u>	SOLENOID VALVE		CALE: 1/4" = 1'-0"
⊱	TWO-WAY CONTROL VALVE	NUMBER X SHEET NUMBER X-X	SECTION OR DETAIL
کسک	THREE-WAY CONTROL VALVE	STIEET INUIVIDER X-X	

NUMBER X ET NUMBER X-X

SHEET NUMBER

ELEVATION

NORTH ARROW

THREE-WAY CONTROL VALVE

PRESSURE REDUCING VALVE

RELIEF OR SAFETY VALVE

STRAINER W/ BLOW-DOWN VALVE

PIPE SLEEVE/GUIDE

FLEXIBLE CONNECTION

ANGLE GATE VALVE

PIPE ANCHOR

₹

PLUMBING ABBREVIATIONS:


	I LOWBING ABBILL VIA	<u> </u>	
ABV	ABOVE	IN.	INCH
AD	AREA DRAIN	INV.	INVERT ELEVATION
AFF	ABOVE FINISHED FLOOR	I.W.	INDIRECT WASTE
A.P.	ACCESS PANEL	KS	KITCHEN SINK
BT B	BATHTUB BIDET	LAV	LAVATORY
BACNET	BUILDING AUTOMATION & CONTROL NETWORK	LT	LAUNDRY TUB
BFF	BELOW FINISHED FLOOR	MAX	MAXIMUM
BFP	BACKFLOW PREVENTER	M.C.	MECHANICAL CONTRACTOR
BLW	BELOW	MIN	MINIMUM
BMS	BUILDING MANAGEMENT SYSTEM	MR	MOP RECEPTOR
ВОВ	BOTTOM OF BEAM	N	NITROUS OXIDE
BOD	BOTTOM OF DECK	(N)	NEW
BS	BAR SINK	N/A	NOT APPLICABLE
BV	BALANCING VALVE	N.C.	NORMALLY CLOSED
CCC	COOLING COIL CONDENSATE	N.I.C.	NOT IN CONTRACT
CS	CLINICAL SERVICE SINK	N.O.	NORMALLY OPEN
СР	CONCRETE PIPING	0	OXYGEN OUTLET
СО	CLEAN OUT	P.C.	PLUMBING CONTRACTOR
CONT.	CONTINUATION	PD PVC	PLANTER DRAIN
C.I.	CAST IRON	PVC	POLY VINYL CHLORIDE
СВ	CATCH BASIN	P.I.C.	POST INDICATOR VALVE
CLG	CEILING	PRV	PRESSURE REGULATING VALV
CSK	CUP SINK	Q.Z.V.	QUADRUPLE ZONE VALVE BOX
DW	DISHWASHER	Q.A.P.	QUADRUPLE ALARM PANEL
DN	DOWN	(R)	REMOVE
DD	DECK DRAIN	RD	ROOF DRAIN
D.A.P.	DUPLEX ALARM PANEL	RWC	RAIN WATER CONDUCTOR
D.Z.V.	DUPLEX ZONE VALVE BOX	R.C.P.	REINFORCED CONCRETE PIPE
D.Z.P.	DUCTILE IRON PIPE	SH	SHOWER
DF	DRINKING FOUNTAIN	S	SANITARY
ES	EMERGENCY SHOWER	SW	SAFE WASTE
EWC	ELECTRIC WATER COOLER	SMH	SANITARY MANHOLE
(E)	EXISTING	STMH	STORM MANHOLE
E.C.	ELECTRICAL CONTRACTOR	SS	SERVICE SINK
EW	EYEWASH	SK	SINK
FB	FROM BELOW	SL	SURGEONS LAVATORY
FCO	FLOOR CLEAN OUT	TC	TERRACOTTA
F.S.E.C.	FOOD SERVICE EQUIPMENT CONTRACTOR	T.C.P.	TRIPLE ALARM PANEL
FH	FIRE HYDRANT	T.Z.V.	TRIPLE ONE VALVE BOX
FSW	FLOW SWITCH	ТВ	THRUST BLOCK
FS	FLOOR SINK	TS	TAMPER SWITCH
FE	FIRE EXTINGUISHER	TYP.	TYPICAL
F.A.V.	FRESH AIR INTAKE	UR	URINAL
F.A.V.	FLOW CONTROL VALVE	V	VACUUM
FD	FLOOR DRAIN	V	VENT
FM	FORCED MAIN	VTR	VENT THROUGH ROOF
FLR	FLOOR	VB	VACUUM BREAKER
G	NATURAL GAS	YH	YARD HYDRANT
G.C.	GENERAL CONTRACTOR	W	WASTE
GD	GARAGE DRAIN	WB	WASHER BOX
GT	GREESE TRAP	WC	WATER CLOSET
GWH	GAS WATER HEATER	WCO	WALL CLEAN OUT
НВ	HOSE BIBB	WF	WATER FILTER
HC	HOSE CABINET	WH	WATER HEATER
HS	HAND SINK	WOAC	WALL OPENING ABOVE CEILING
	LIEAT TRACE	WOBC	WALL OPENING BELOW CEILIN

HEAT TRACE

WALL OPENING BELOW CEILING

PLUMBING GENERAL NOTES:

- GENERAL NOTES APPLY TO ALL PLUMBING DRAWINGS.
- 2. THE DRAWINGS SHOW A GENERAL REPRESENTATION OF QUANTITIES AND LOCATIONS OF EXISTING PLUMBING COMPONENTS AND SYSTEMS, AND ARE NOT ALL INCLUSIVE. IT IS THE CONTRACTOR'S RESPONSIBILITY TO PROVIDE REMOVAL OF THE PLUMBING BUILDING SYSTEMS TO FULFILL THE INTENT OF THE DESIGN INDICATED BY THE CONTRACT DOCUMENTS, UNLESS OTHERWISE NOTED. REMOVAL WORK IS TO INCLUDE, BUT NOT LIMITED TO REMOVAL OF EQUIPMENT, APPARATUS, SYSTEM ACCESSORIES, PIPING, INSULATION, DOMESTIC WATER HEATERS, VALVES, DROPS, RISERS, AUXILIARY SYSTEMS, PIPING ACCESSORIES, CONTROLS, CONTROL WIRING/TUBING, CONDUITS, BASES, SUPPORTS, HANGERS AND SYSTEM APPURTENANCES.
- 3. PLUMBING PIPING LAYOUTS ARE SCHEMATIC IN NATURE. PROVIDE OFFSETS AND FITTINGS AS REQUIRED TO ACCOMMODATE FIELD CONDITIONS AT NO ADDITIONAL COST TO THE OWNER.
- 4. ENSURE ALL WORK IS IN CONFORMANCE WITH ALL APPLICABLE BUILDING CODES. WORK SHALL BE COMPLETED IN STRICT ACCORDANCE WITH THE LATEST EDITIONS OF THE APPLICABLE CONSTRUCTION CODE, AND ALL OTHER FEDERAL, STATE, AND LOCAL AGENCY REGULATIONS HAVING JURISDICTION OVER THIS PROJECT. IN THE EVENT OF ANY DISCREPANCIES BETWEEN AGENCY REQUIREMENTS, OBSERVE THE MORE STRINGENT OF REQUIREMENTS.
- IDENTIFICATION LABELS TO BE USED/MADE FOR ALL SYSTEMS MUST USE THE OWNER'S ROOM NUMBERS AND ROOM NAMES, NOT THE NUMBERS OR NAMES ON THE CONSTRUCTION DOCUMENTS. MEET WITH THE OWNER TO REVIEW AND CONFIRM ROOM NUMBERS AND NAMES PRIOR TO LABELING SYSTEMS.
- 6. TEMPORARILY REMOVE AND REINSTALL ALL CEILINGS IN WORK AREAS AS REQUIRED. CEILING SYSTEMS SHALL BE REINSTALLED AFTER REMOVAL AND NEW WORK ABOVE CEILING HAS BEEN COMPLETED. PROVIDE TEMPORARY SUPPORT ONCE CEILING IS REMOVED FOR ALL CEILING MOUNTED EQUIPMENT AND DEVICES TO REMAIN EXISTING AS-IS.
- 7. COORDINATE ALL SAW-CUTTING, HOLE CORING, PATCHING, AND PAINTING WITH ALL OTHER TRADES PRIOR TO ROUGH IN. PERFORM ALL SAW CUTTING, EXCAVATION, AND BACKFILL AS NECESSARY FOR ALL BELOW SLAB PIPING IN EXISTING BUILDING. PERFORM ALL SAW CUTTING AND PATCHING AS NECESSARY TO PERFORM ABOVE SLAB WORK. MATCH EXISTING MATERIALS, FINISHES, FIRE RATINGS, PAINT COLORS, ETC. IN
- 8. COORDINATE AND FIELD VERIFY ALL DIMENSIONS, SIZES, CLEARANCES, AND FINAL PLACEMENT OF ALL HVAC, PLUMBING, AND ELECTRICAL: EQUIPMENT, FIXTURES AND ACCESSORIES WITH THE RESPECTIVE TRADE CONTRACTORS PRIOR TO ROUGH IN. WHEN CONFLICT ARISES, MAKE ANY NECESSARY CHANGES TO ROUTING OF PIPING WITHOUT COMPROMISING THE INTEGRITY AND PERFORMANCE OF THE SYSTEM, AND AT NO ADDITIONAL COST TO THE OWNER.
- 9. INSTALL ALL EQUIPMENT TO MAINTAIN ADEQUATE CLEARANCES PER MANUFACTURER'S REQUIREMENTS. PROVIDE OFFSETS AS NECESSARY TO
- 10. ALL EQUIPMENT AND OR MATERIAL BEING REMOVED IS THE RESPONSIBILITY OF THE CONTRACTOR AND WILL BE RETAINED, DISPOSED OF, AND
- REMOVED FROM THE SITE AT THE DIRECTION OF THE OWNER. 11. ALL PIPING TO BE CONCEALED UNLESS OTHERWISE INDICATED.
- 12. EQUIPMENT INSULATION SHALL BE INSTALLED AS NOT TO CONCEAL THE EQUIPMENT NAME PLATE.
- 13. PROVIDE HANGERS AND SUPPORTS PER THE SPECIFICATIONS FOR ALL PIPING AND PLUMBING EQUIPMENT TO FACILITATE INSTALLATION OF THE WORK.
- 14. SCHEDULE AND OBTAIN APPROVAL FOR ALL SYSTEM SHUTDOWNS WITH THE OWNER PRIOR TO COMMENCING WITH REMOVAL AND NEW WORK.

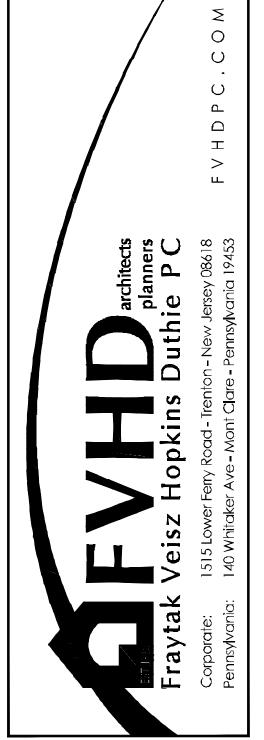

Renovations for Five (5) Pre-K Classrooms at Clayton J. Davenport School

Project Owner Name

Egg Harbor Township School District

Project Location

2501 Spruce Ave, Egg Harbor Township, NJ 08234

Project Number

11.01.2024

Drawn **B**y

AS NOTED

Drawing Name PLUMB**I**NG LEGEND, ABBREVIATIONS, AND GENERAL NOTES

No. Date Description

REFERENCE DIMENSION

INDICATED DIMENSION IS MEASURED AT ONE (1) INCH IN LENGTH AND PROVIDED FOR REFERENCE/VERIFICATION ONLY.

Gillan & Hartmann, Inc.

MECHANICAL AND ELECTRICAL

CONSULTING ENGINEERS 610-935-0101 FAX: 610-935-7520 215-238-9510 609-347-1593 302-654-5959 gillan-hartmann.com ghmail@gillan-hartmann.com G&H Project No. 2024-147


Drawing Number

NO. 24GE04470000

11/01/2024 ISSUE FOR BID

ENGINEER

MICHAEL S. GILLAN, PE

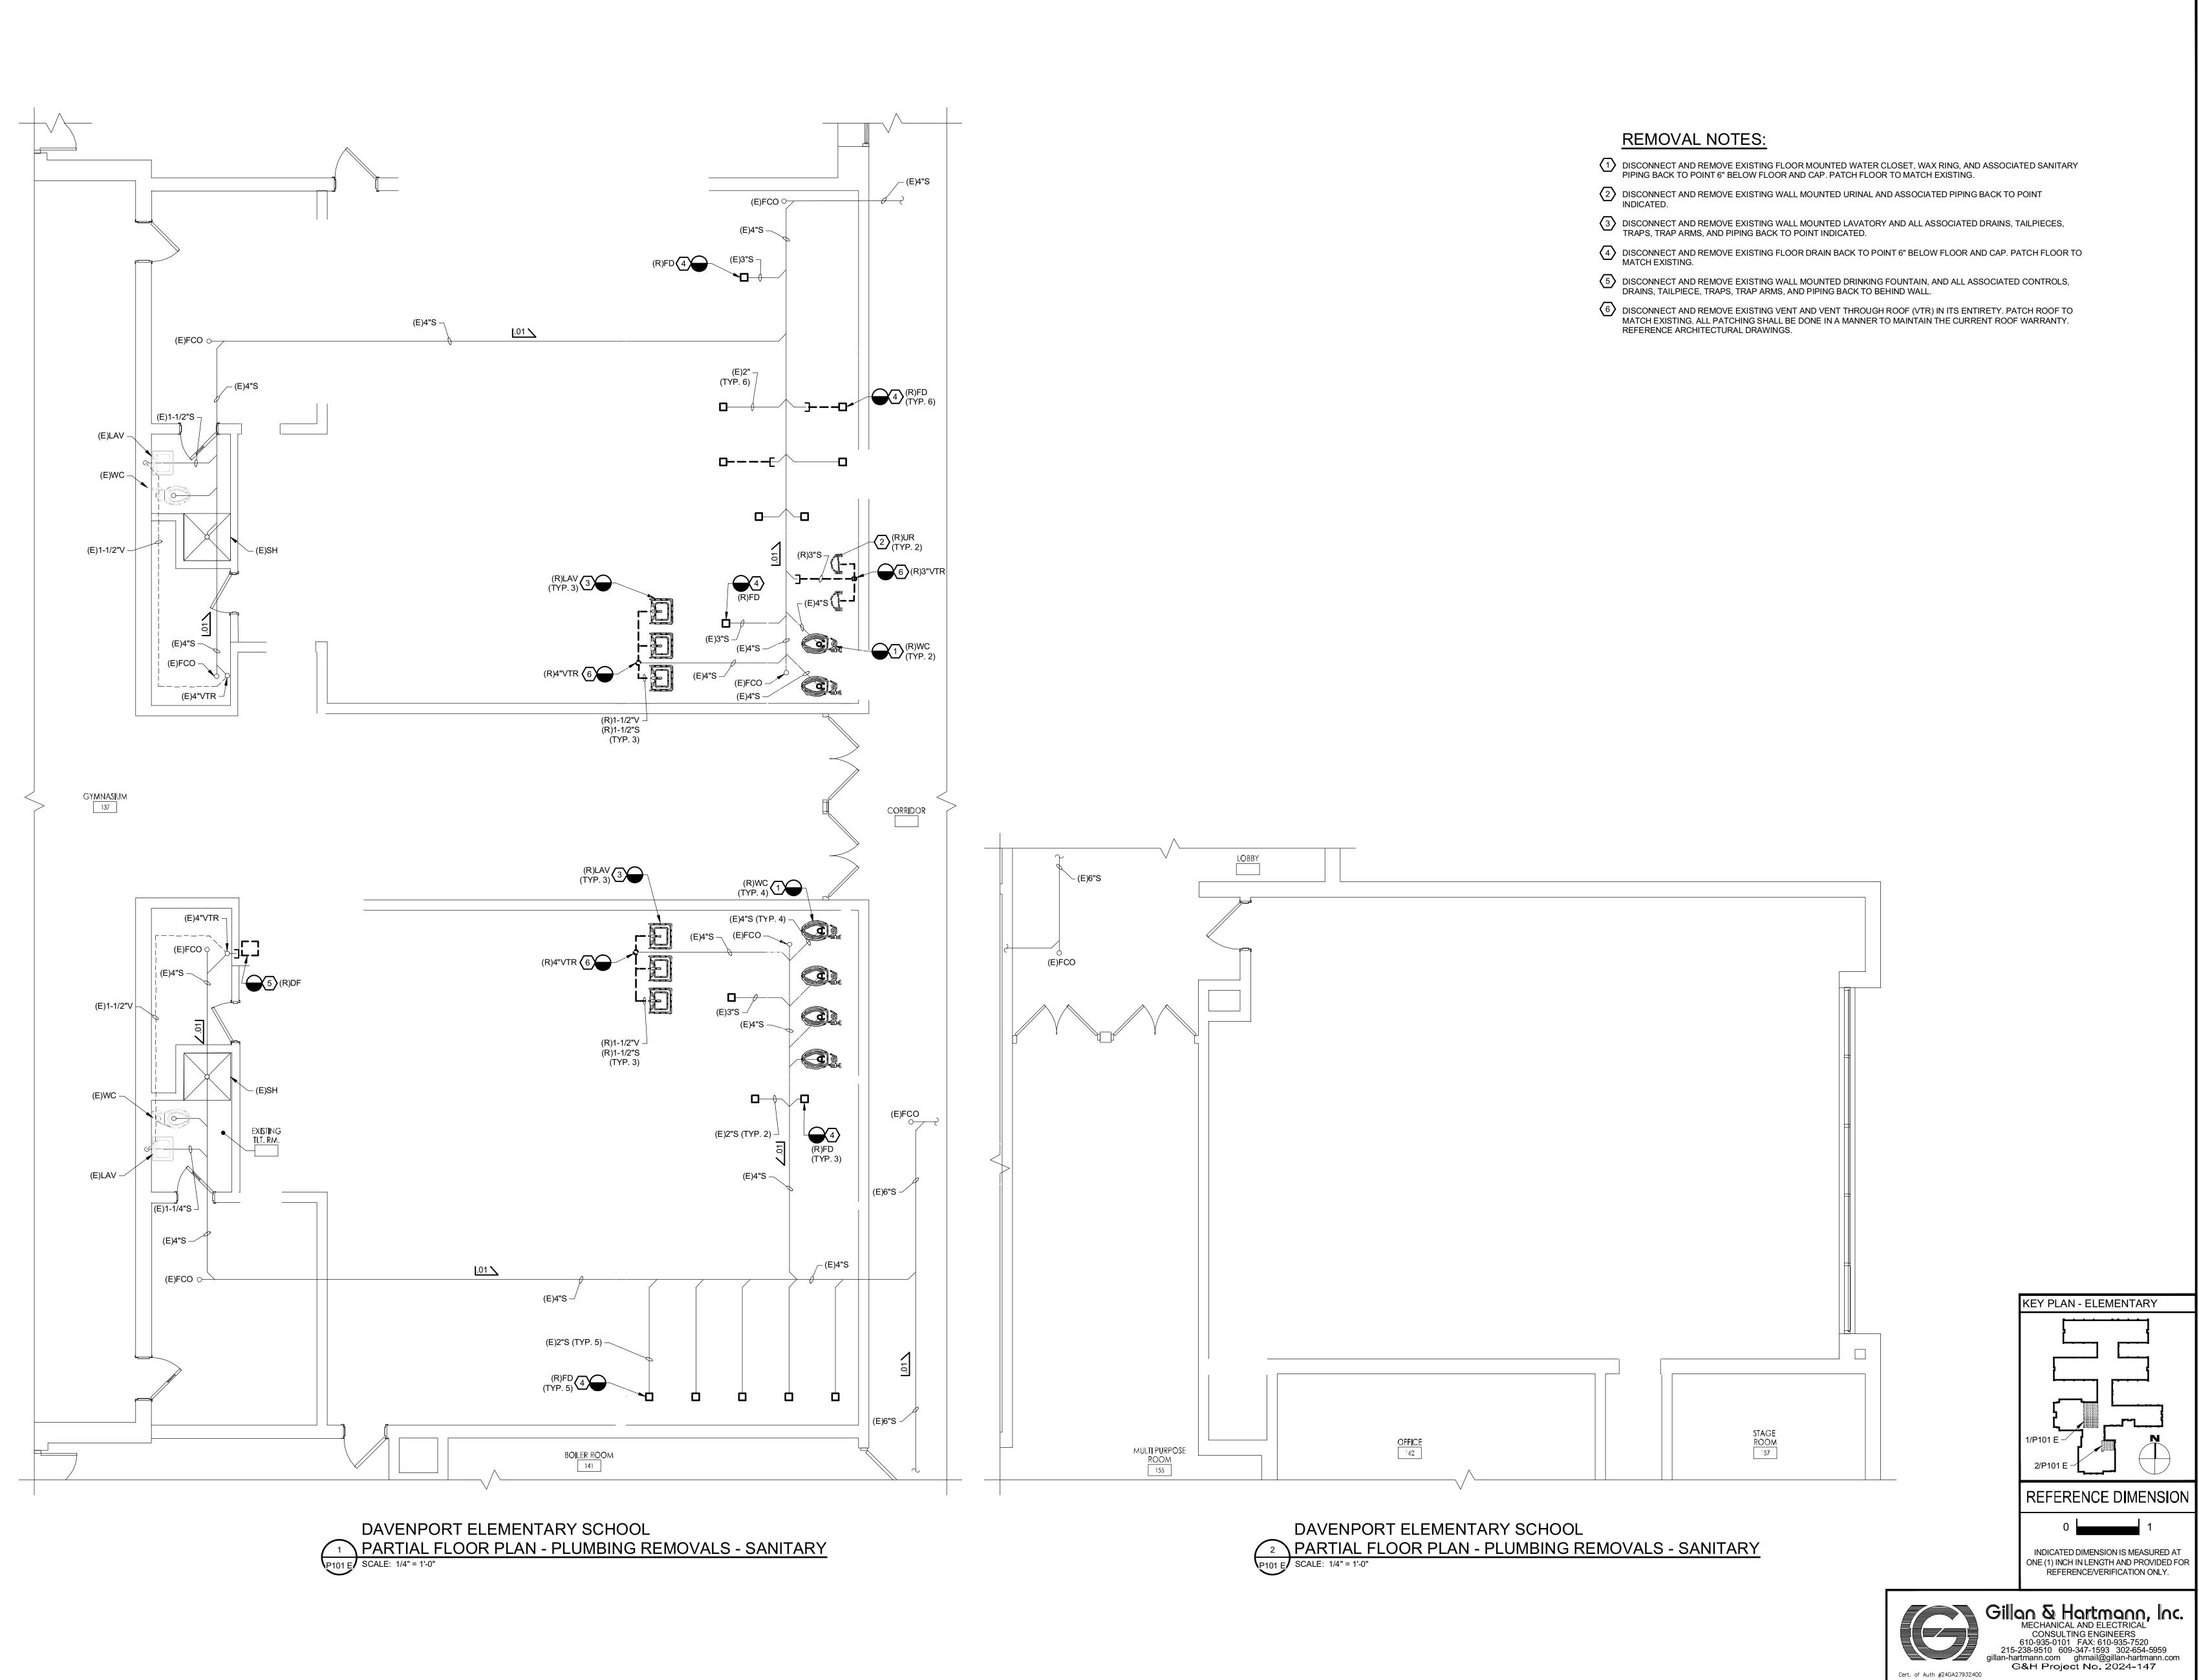

- DISCONNECT AND REMOVE EXISTING WALL MOUNTED URINAL AND ASSOCIATED PIPING BACK TO POINT
- DISCONNECT AND REMOVE EXISTING FLOOR DRAIN BACK TO POINT 6" BELOW FLOOR AND CAP. PATCH FLOOR TO

Renovations for Five

(5) Pre-K Classrooms at Clayton J. Davenport School

Project Owner Name

Egg Harbor Township School District

Project Location

2501 Spruce Ave, Egg Harbor Township, NJ 08234

11.01.2024

AS NOTED

Drawing Name ELEMENTARY SCHOOL PLUMB**I**NG REMOVALS -SANITARY - FIRST FLOOR PARTIAL PLAN


No. Date Description

Drawing Number

DATE NO. 24GE04470000

11/01/2024 ENGINEER ISSUE FOR BID

MICHAEL S. GILLAN, PE

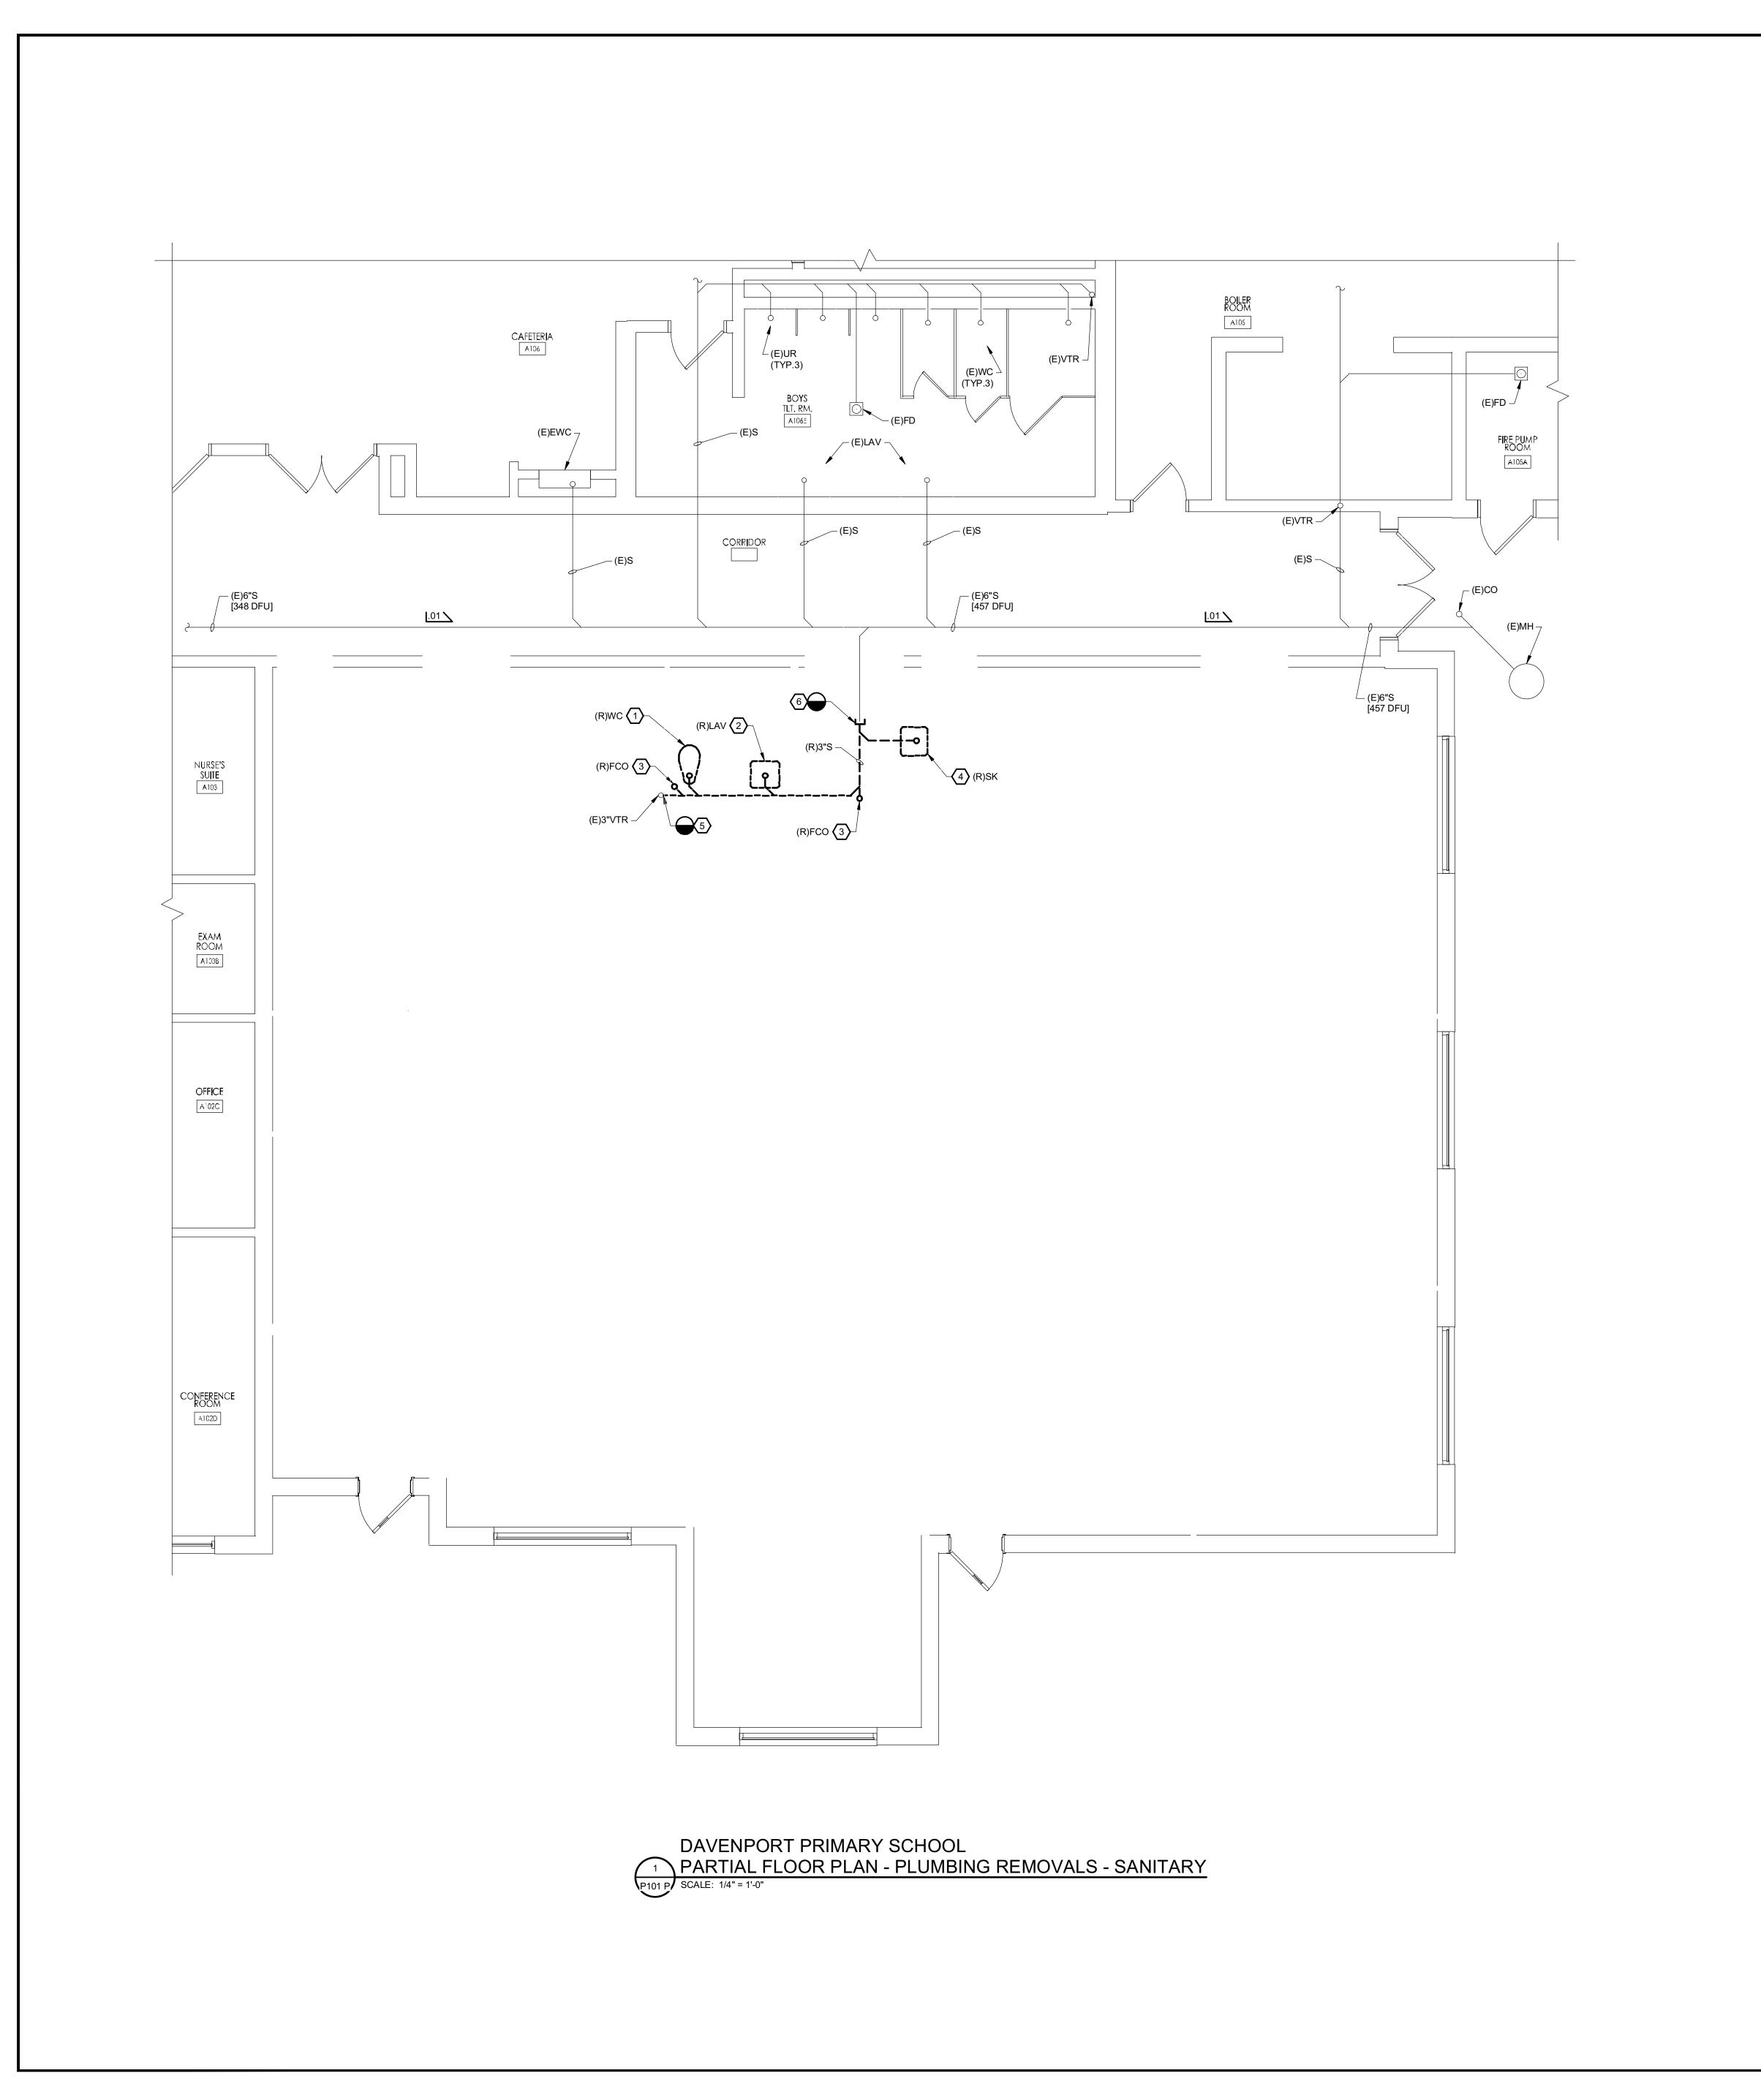

REMOVAL NOTES:

- DISCONNECT AND REMOVE EXISTING FLOOR MOUNTED WATER CLOSET, WAX RING, AND ASSOCIATED SANITARY PIPING BACK TO POINT INDICATED.
- DISCONNECT AND REMOVE EXISTING WALL MOUNTED LAVATORY AND ALL ASSOCIATED DRAINS, TAILPIECES, TRAPS, TRAP ARMS, AND PIPING BACK TO POINT INDICATED.
- DISCONNECT AND REMOVE EXISTING FLOOR CLEAN OUT NEAR AREA INDICATED AND PATCH FLOOR TO MATCH EXISTING.
- DISCONNECT AND REMOVE EXISTING COUNTER MOUNTED SINK BASIN, AND ALL ASSOCIATED DRAINS, TAILPIECES, TRAPS, TRAP ARMS, AND PIPING BACK TO POINT INDICATED.
- DISCONNECT AND REMOVE EXISTING VENT PIPING BACK TO ABOVE CEILING. RETAIN VENT FOR RECONNECTION UNDER NEW WORK.

6 DISCONNECT AND REMOVE EXISTING SANITARY PIPING BELOW SLAB FLOOR AND CAP NEAR AREA INDICATED.

(5) Pre-K Classrooms at Clayton J.
Davenport School

Renovations for Five

Project Owner Name

Egg Harbor Township School District

Project Location

2501 Spruce Ave, Egg Harbor Township, NJ 08234

Project Number 5481 Project Date

11.01.2024

AS NOTED Drawing Name PRIMARY SCHOOL PLUMBING REMOVALS -SANITARY - FIRST

REFERENCE DIMENSION

INDICATED DIMENSION IS MEASURED AT ONE (1) INCH IN LENGTH AND PROVIDED FOR REFERENCE/VERIFICATION ONLY.

KEY PLAN - PRIMARY

No. Date Description

FLOOR PARTIAL PLAN

Gillan & Hartmann, Inc.

MECHANICAL AND ELECTRICAL

CONSULTING ENGINEERS

610-935-0101 FAX: 610-935-7520

215-238-9510 609-347-1593 302-654-5959

gillan-hartmann.com ghmail@gillan-hartmann.com

G&H Project No. 2024-147 Drawing Number

ENGINEER


MICHAEL S. GILLAN, PE

11/01/2024

ISSUE FOR BID

2024 GILLAN & HARTMANN, Inc.

NO. 24GE04470000

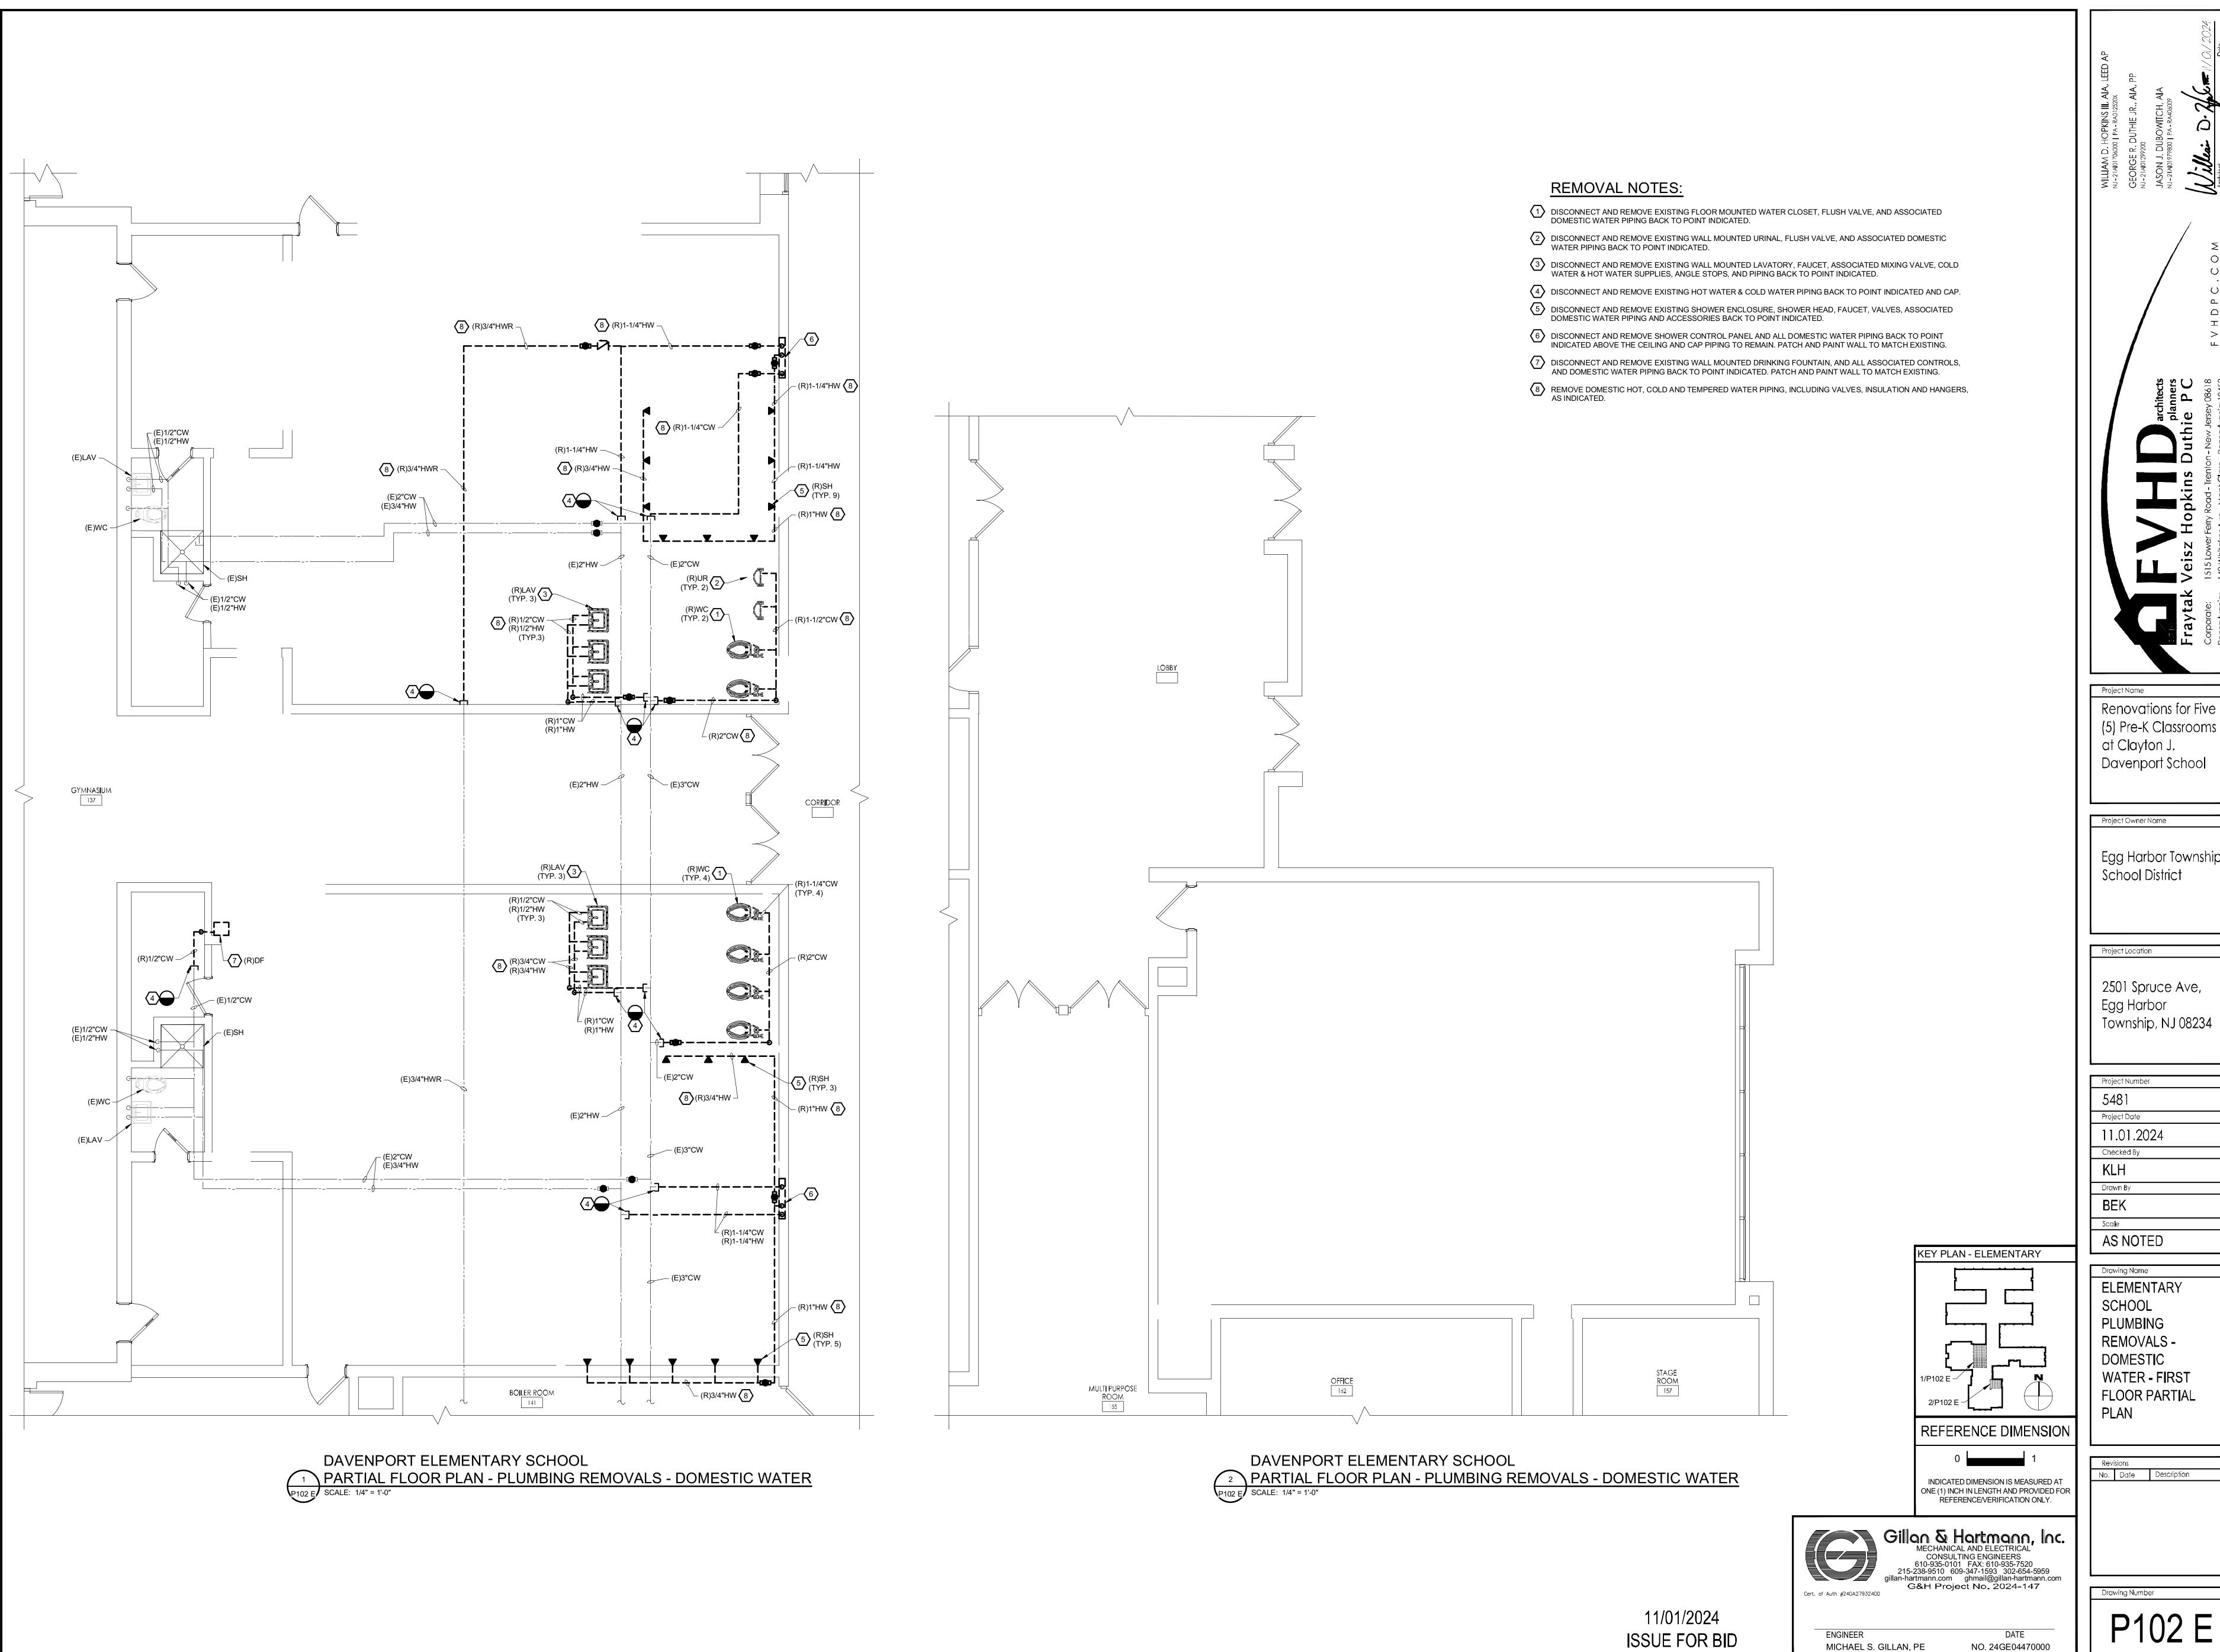

Renovations for Five (5) Pre-K Classrooms at Clayton J. Davenport School


Project Owner Name

Egg Harbor Township School District

2501 Spruce Ave, Egg Harbor Township, NJ 08234

ELEMENTARY REMOVALS -DOMESTIC WATER - FIRST FLOOR PARTIAL

No. Date Description

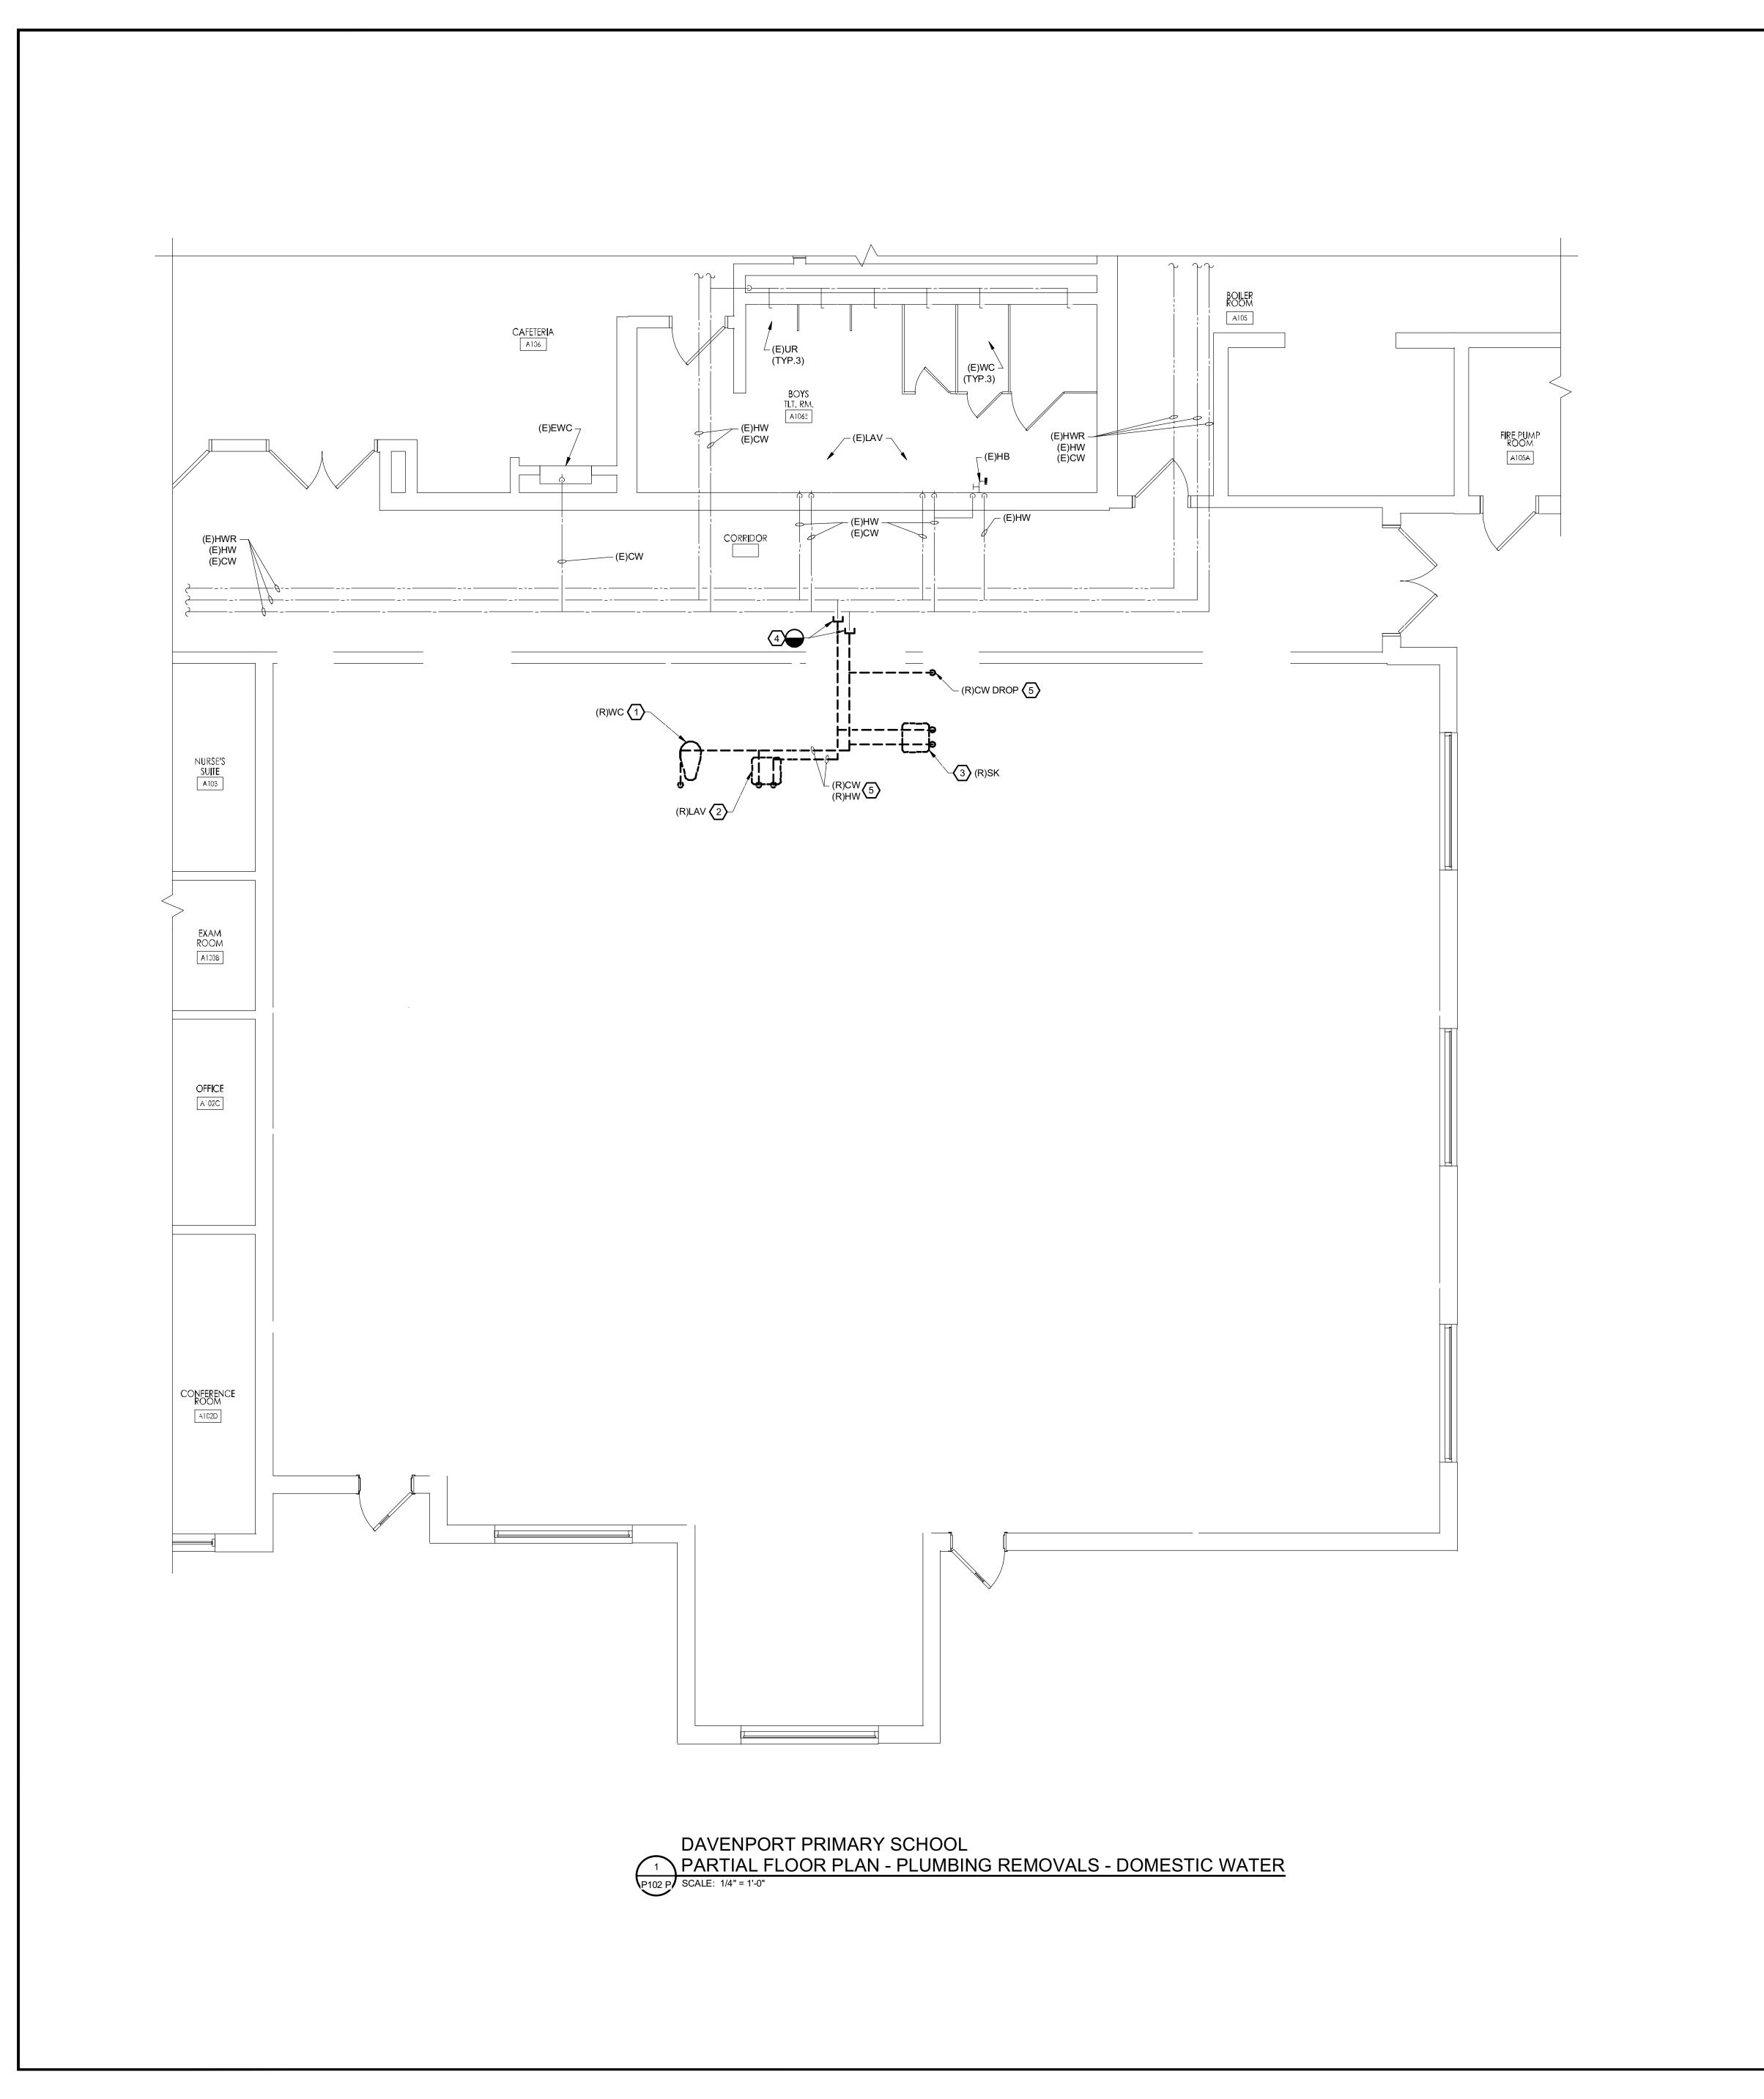

REMOVAL NOTES:

- DISCONNECT AND REMOVE EXISTING FLOOR MOUNTED WATER CLOSET, FLUSH VALVE, AND ASSOCIATED DOMESTIC WATER PIPING BACK TO POINT INDICATED.
- DISCONNECT AND REMOVE EXISTING WALL MOUNTED LAVATORY, FAUCET, ASSOCIATED MIXING VALVE, COLD WATER & HOT WATER SUPPLIES, ANGLE STOPS, AND PIPING BACK TO POINT INDICATED.
- DISCONNECT AND REMOVE EXISTING COUNTER MOUNTED SINK BASIN, FAUCET, DRINKING BUBBLER, ASSOCIATED MIXING VALVE, COLD WATER & HOT WATER SUPPLIES, ANGLE STOPS, AND PIPING BACK TO POINT
- DISCONNECT AND REMOVE EXISTING HOT WATER & COLD WATER PIPING BACK TO POINT INDICATED AND CAP.
- REMOVE DOMESTIC HOT, COLD AND TEMPERED WATER PIPING, INCLUDING VALVES, INSULATION AND HANGERS, AS INDICATED.

Renovations for Five (5) Pre-K Classrooms at Clayton J.
Davenport School

Project Owner Name

Egg Harbor Township School District

Project Location

2501 Spruce Ave, Egg Harbor Township, NJ 08234

11.01.2024

AS NOTED

Drawing Name PRIMARY SCHOOL PLUMB**I**NG REMOVALS -DOMESTIC WATER - FIRST FLOOR PARTIAL

REFERENCE DIMENSION

KEY PLAN - PRIMARY

No. Date Description INDICATED DIMENSION IS MEASURED AT ONE (1) INCH IN LENGTH AND PROVIDED FOR REFERENCE/VERIFICATION ONLY.



11/01/2024 ISSUE FOR BID




ENGINEER

MICHAEL S. GILLAN, PE


2024 GILLAN & HARTMANN, Inc.

NO. 24GE04470000

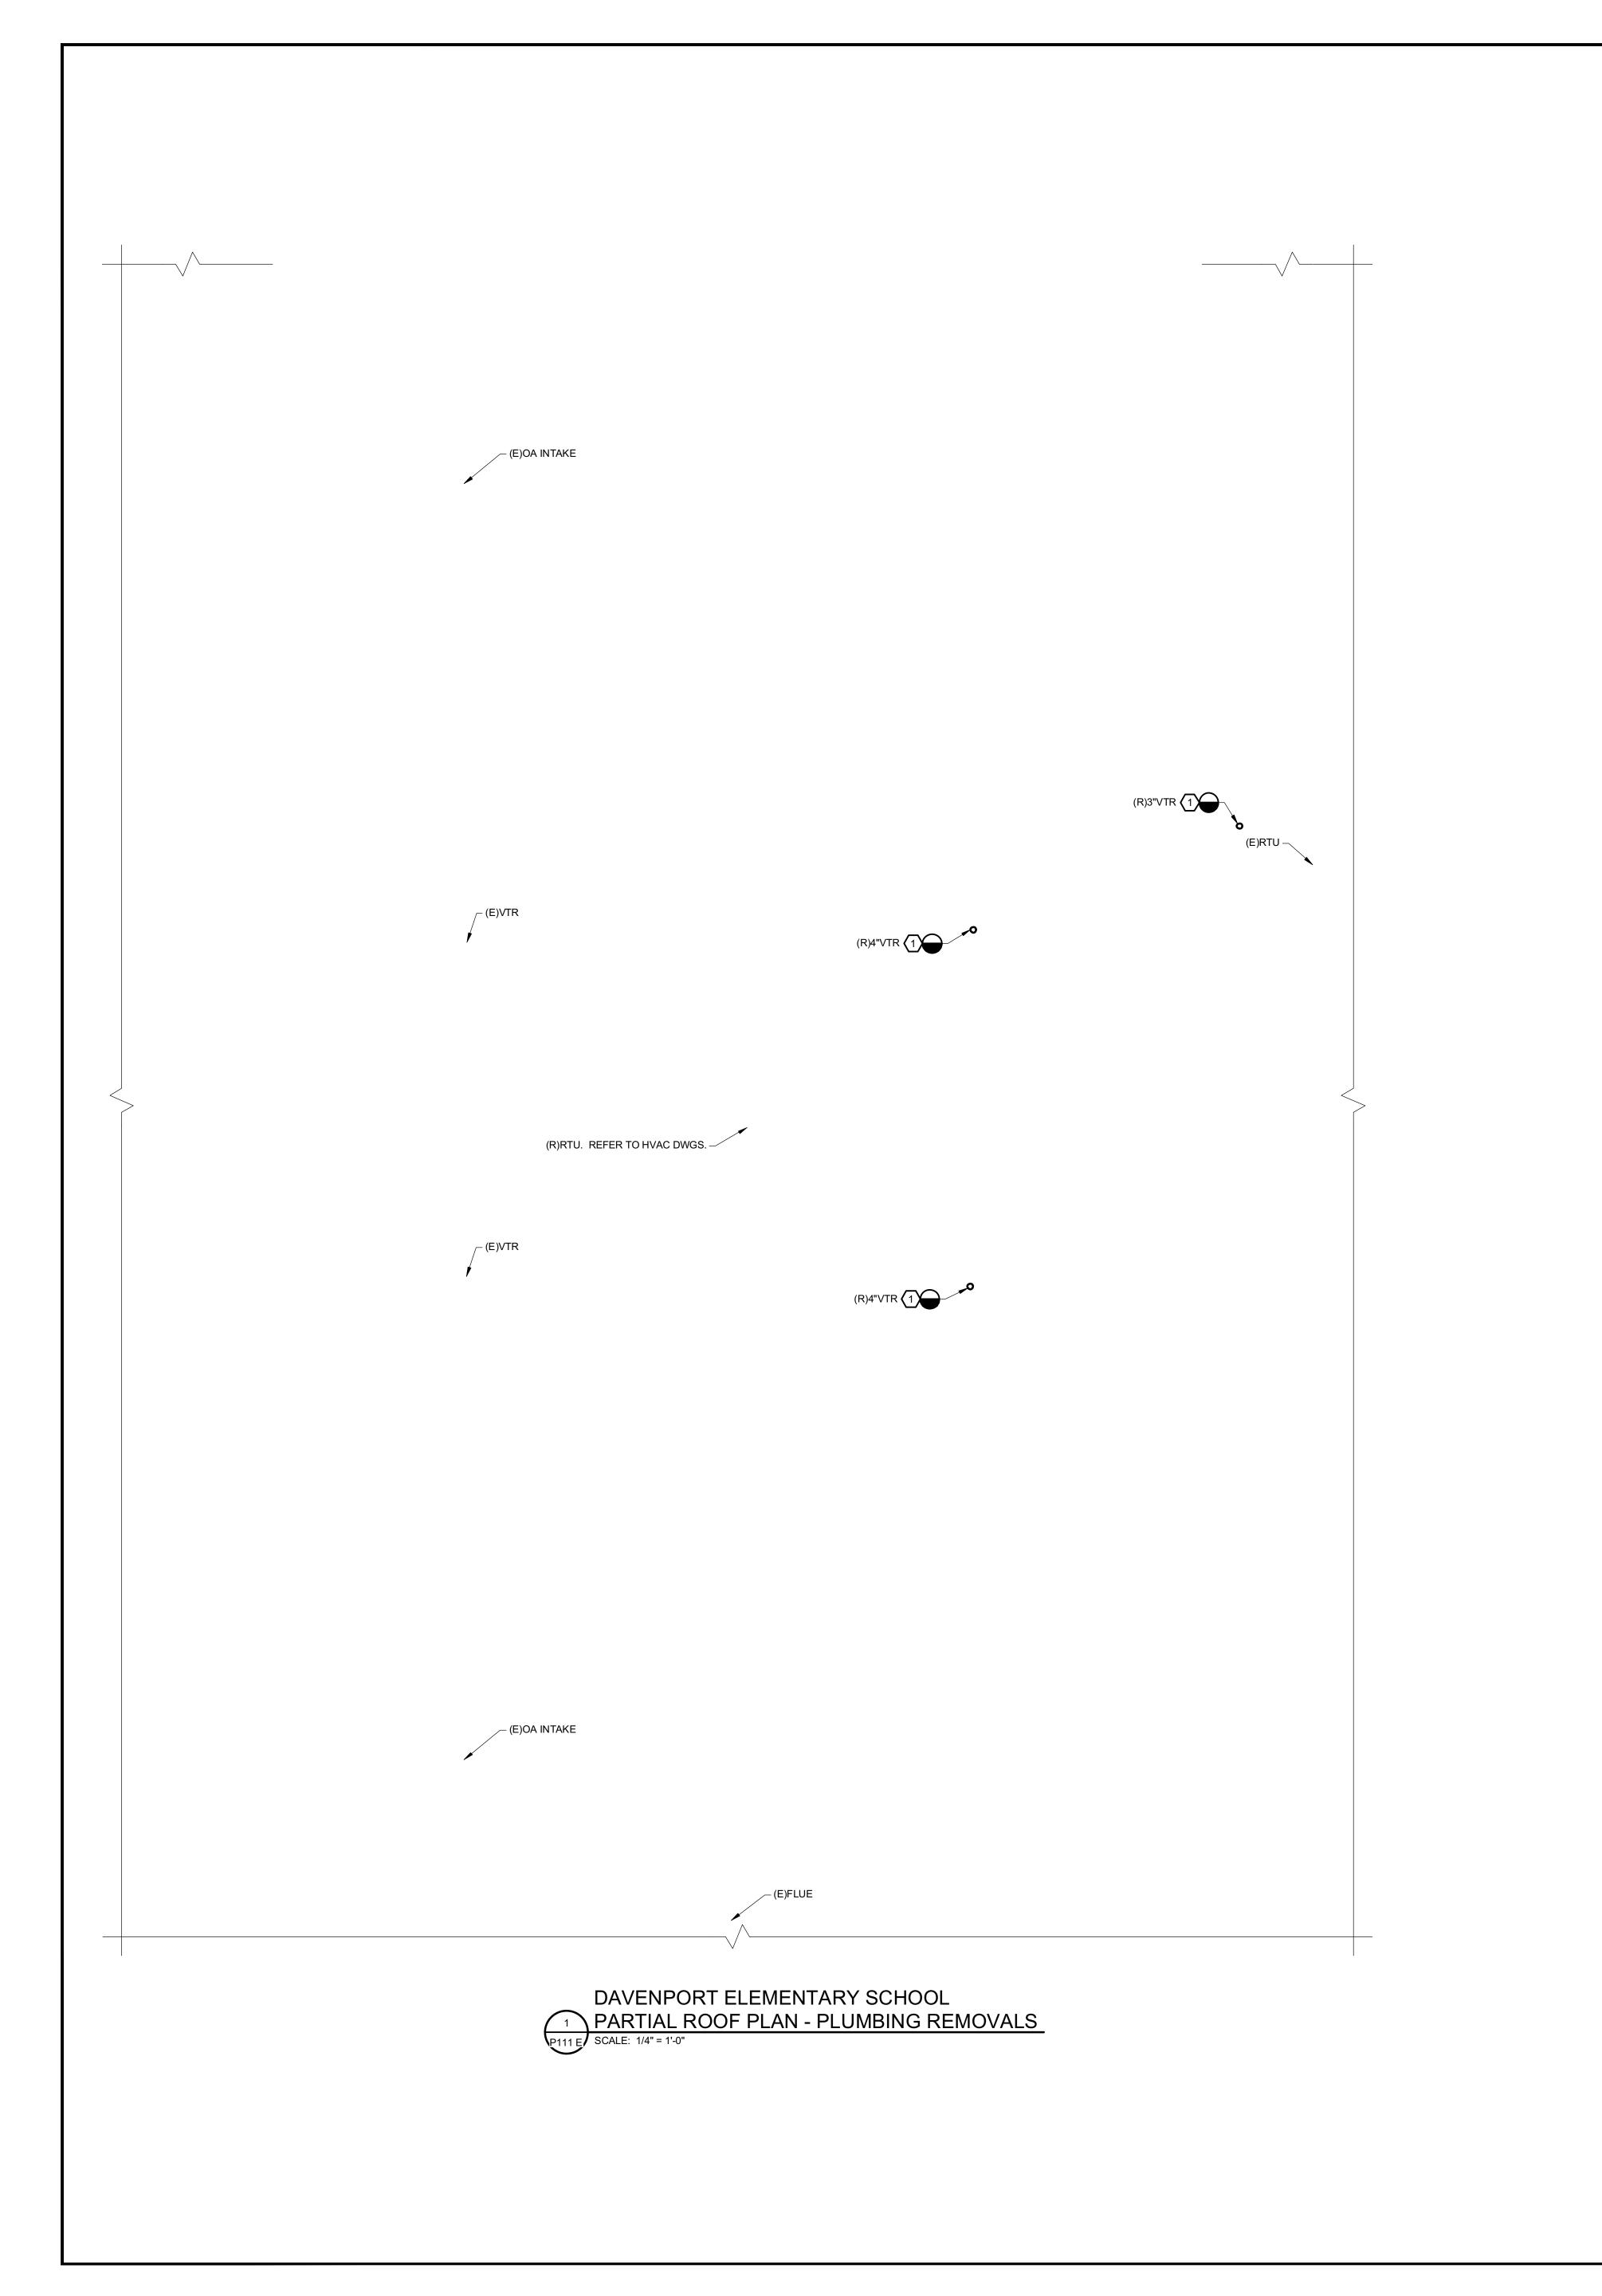

REMOVAL NOTES:

REMOVE EXISTING VENT THROUGH ROOF (VTR) AND ALL ASSOCIATED PIPING, HANGERS AND ANCHORS. COORDINATE ALL CUTTING, PATCHING & PAINTING AS REQUIRED TO MATCH EXISTING. FOR CONTINUATION, REFER TO FIRST FLOOR REMOVAL WORK PLANS.

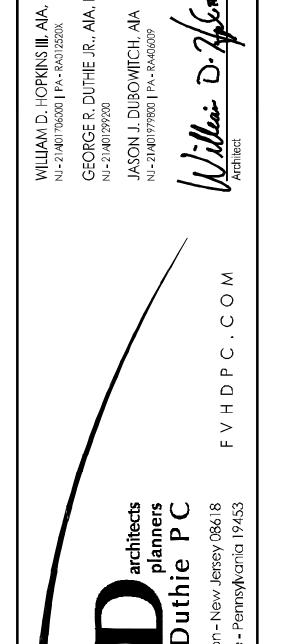

Renovations for Five (5) Pre-K Classrooms at Clayton J.

Davenport School

Project Owner Name

Egg Harbor Township School District

Project Location

2501 Spruce Ave, Egg Harbor Township, NJ 08234

Project Number 11.01.2024

Drawn By

BEK

AS NOTED

Drawing Name ELEMENTARY SCHOOL PLUMBING REMOVALS -PARTIAL ROOF PLAN

REFERENCE DIMENSION

INDICATED DIMENSION IS MEASURED AT ONE (1) INCH IN LENGTH AND PROVIDED FOR REFERENCE/VERIFICATION ONLY.

KEY PLAN - ELEMENTARY

No. Date Description

Drawing Number

11/01/2024 ISSUE FOR BID




ENGINEER

MICHAEL S. GILLAN, PE

2024 GILLAN & HARTMANN, Inc.

NO. 24GE04470000

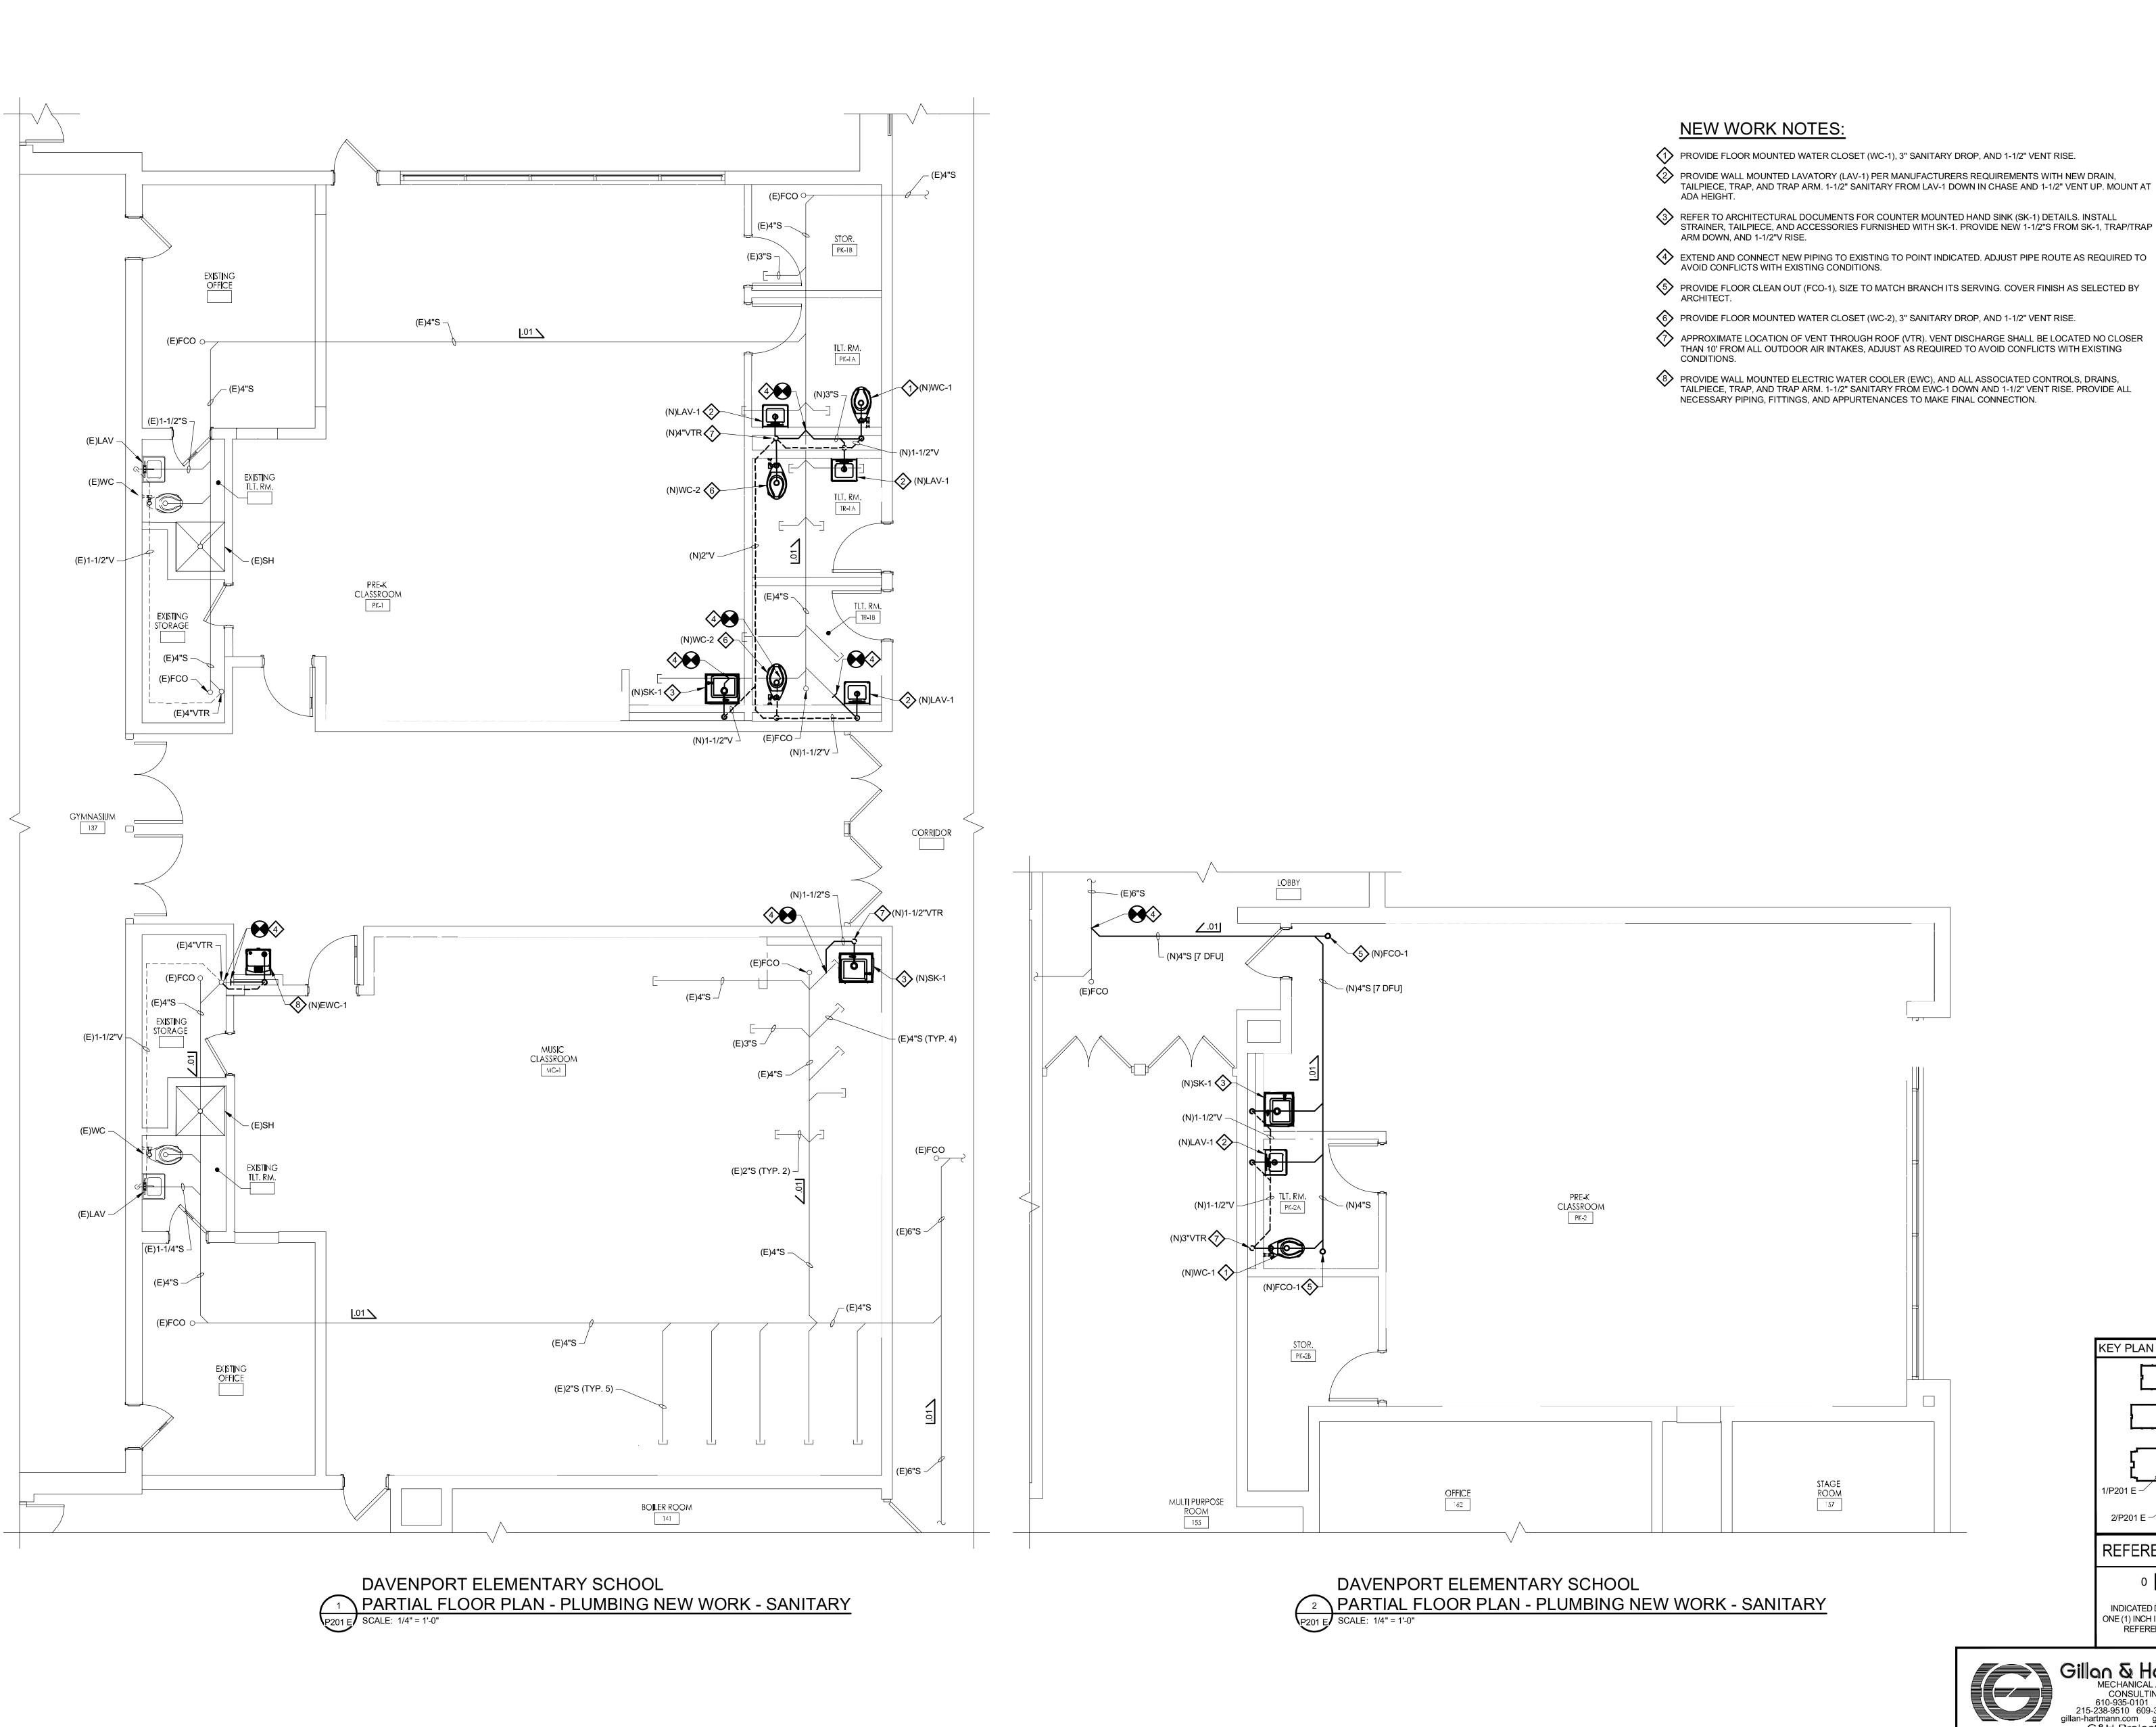

PROVIDE WALL MOUNTED LAVATORY (LAV-1) PER MANUFACTURERS REQUIREMENTS WITH NEW DRAIN, TAILPIECE, TRAP, AND TRAP ARM. 1-1/2" SANITARY FROM LAV-1 DOWN IN CHASE AND 1-1/2" VENT UP. MOUNT AT

REFER TO ARCHITECTURAL DOCUMENTS FOR COUNTER MOUNTED HAND SINK (SK-1) DETAILS. INSTALL STRAINER, TAILPIECE, AND ACCESSORIES FURNISHED WITH SK-1. PROVIDE NEW 1-1/2"S FROM SK-1, TRAP/TRAP

5 PROVIDE FLOOR CLEAN OUT (FCO-1), SIZE TO MATCH BRANCH ITS SERVING. COVER FINISH AS SELECTED BY

APPROXIMATE LOCATION OF VENT THROUGH ROOF (VTR). VENT DISCHARGE SHALL BE LOCATED NO CLOSER THAN 10' FROM ALL OUTDOOR AIR INTAKES, ADJUST AS REQUIRED TO AVOID CONFLICTS WITH EXISTING

PROVIDE WALL MOUNTED ELECTRIC WATER COOLER (EWC), AND ALL ASSOCIATED CONTROLS, DRAINS, TAILPIECE, TRAP, AND TRAP ARM. 1-1/2" SANITARY FROM EWC-1 DOWN AND 1-1/2" VENT RISE. PROVIDE ALL

> Renovations for Five (5) Pre-K Classrooms at Clayton J. Davenport School

> > Project Owner Name

Egg Harbor Township School District

Project Location

2501 Spruce Ave, Egg Harbor Township, NJ 08234

Project Number

11.01.2024

AS NOTED

Drawing Name ELEMENTARY SCHOOL PLUMB**I**NG NEW WORK - SANITARY - FIRST FLOOR

PARTIAL PLAN

2/P201 E REFERENCE DIMENSION

KEY PLAN - ELEMENTARY

No. Date Description INDICATED DIMENSION IS MEASURED AT

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MECHANICAL AND ELECTRICAL

CONSULTING ENGINEERS

610-935-0101 FAX: 610-935-7520

215-238-9510 609-347-1593 302-654-5959

gillan-hartmann.com ghmail@gillan-hartmann.com

G&H Project No. 2024-147


Drawing Number P201 E

DATE NO. 24GE04470000

ENGINEER MICHAEL S. GILLAN, PE


11/01/2024

ISSUE FOR BID

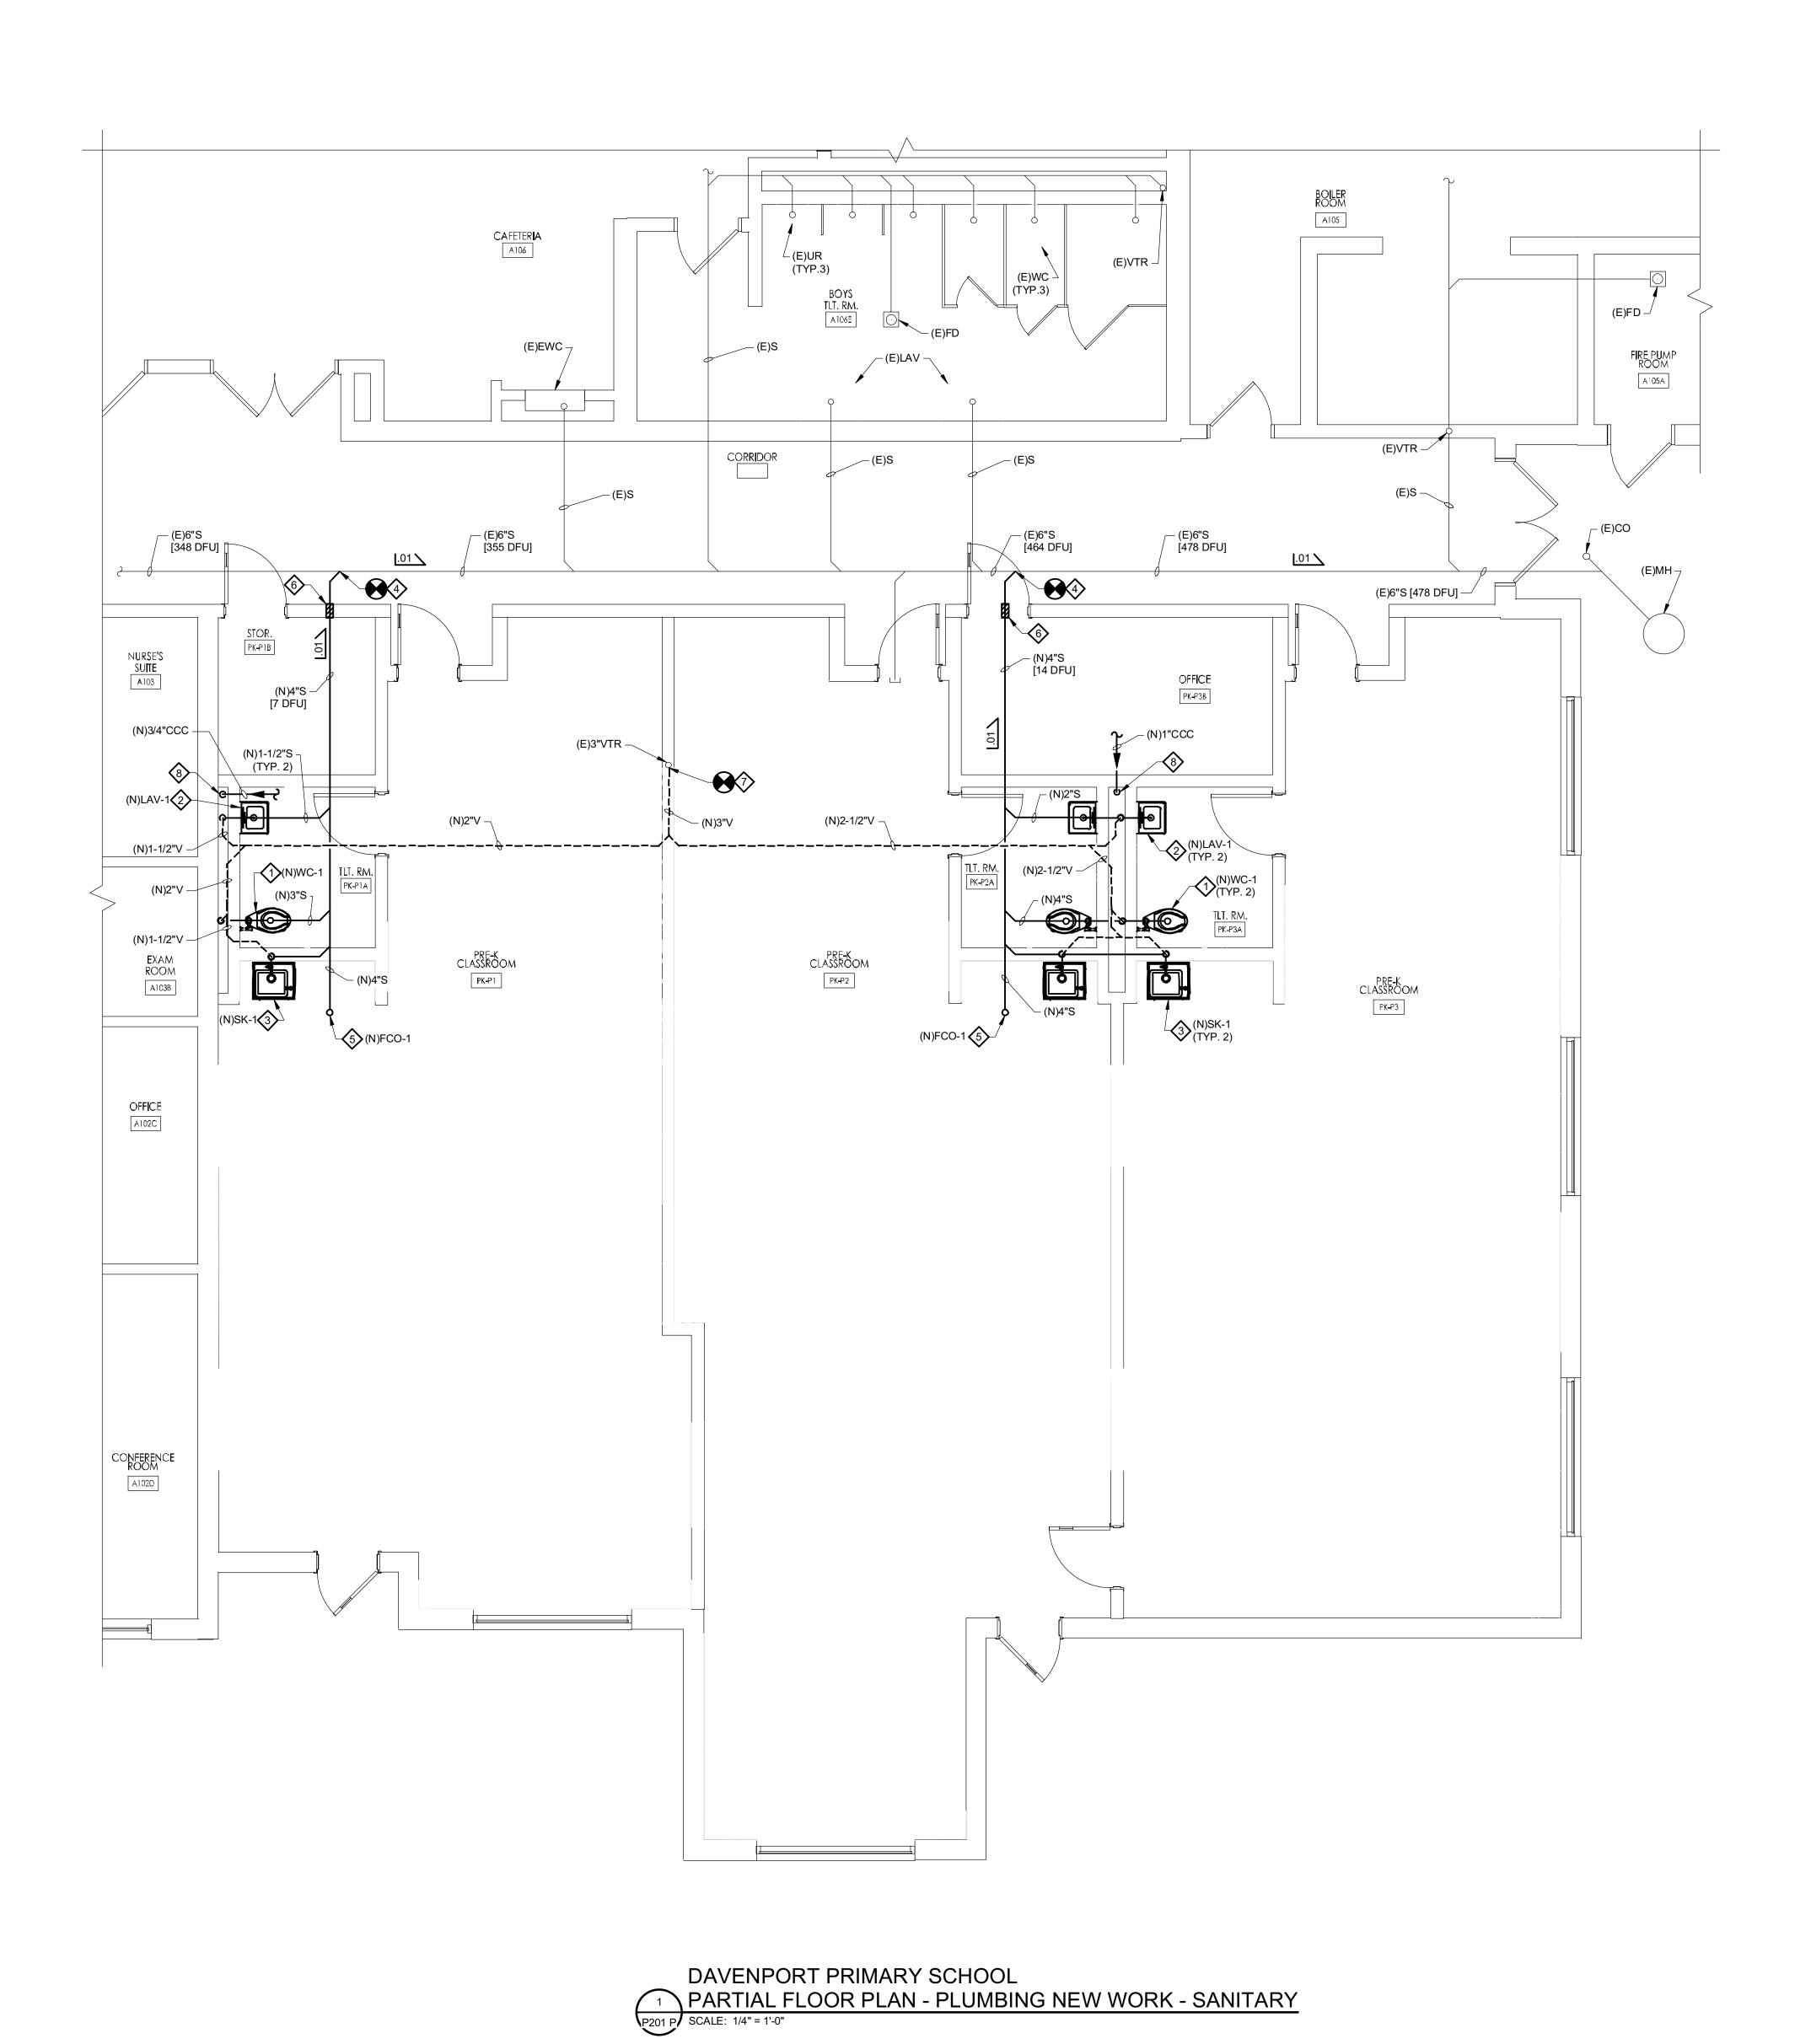

NEW WORK NOTES:

- PROVIDE FLOOR MOUNTED WATER CLOSET (WC-1), 3" SANITARY DROP, AND 1-1/2" VENT RISE.
- PROVIDE WALL MOUNTED LAVATORY (LAV-1) PER MANUFACTURERS REQUIREMENTS WITH NEW DRAIN, TAILPIECE, TRAP, AND TRAP ARM. 1-1/2" SANITARY FROM LAV-1 DOWN IN CHASE AND 1-1/2" VENT UP. MOUNT AT ADA HEIGHT.
- REFER TO ARCHITECTURAL DOCUMENTS FOR COUNTER MOUNTED HAND SINK (SK-1) DETAILS. INSTALL STRAINER, TAILPIECE, AND ACCESSORIES FURNISHED WITH SK-1. PROVIDE NEW 1-1/2"S FROM SK-1, TRAP/TRAP ARM DOWN, AND 1-1/2"V RISE.
- EXTEND AND CONNECT NEW SANITARY PIPING TO EXISTING NEAR AREA INDICATED. ADJUST PIPE ROUTE AS REQUIRED TO AVOID CONFLICTS WITH EXISTING CONDITIONS.
- PROVIDE FLOOR CLEAN OUT (FCO-1), SIZE TO MATCH BRANCH ITS SERVING. COVER FINISH AS SELECTED BY ARCHITECT.
- PROVIDE WALL/FLOOR SLEEVES THROUGH ABOVE AND BELOW GRADE WALLS/FOUNDATIONS FOR ALL PIPE PENETRATIONS. PENETRATION RATING SHALL MATCH EXISTING WALL/FLOOR RATING.
- EXTEND AND CONNECT NEW 3" VENT PIPING TO EXISTING 3" VENT THROUGH ROOF (VTR) NEAR AREA INDICATED.
- EXTEND AND CONNECT TO NEW COOLING COIL CONDENSATE (CCC) PIPING IN CHASE AND MAKE FINAL CONNECTION TO THE SANITARY SYSTEM. SIZE TO MATCH CCC PIPING. REFER TO MECHANICAL DRAWING #1/H202P FOR ADDITIONAL INFORMATION.

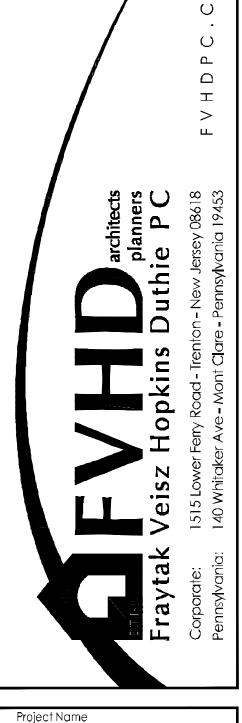

Renovations for Five

(5) Pre-K Classrooms at Clayton J. Davenport School

Project Owner Name

Egg Harbor Township School District

Project Location

2501 Spruce Ave, Egg Harbor Township, NJ 08234

Project Number 11.01.2024

Drawn By

AS NOTED

Drawing Name PRIMARY SCHOOL PLUMBING NEW WORK - SANITARY - FIRST FLOOR PART**I**AL PLAN

REFERENCE DIMENSION

INDICATED DIMENSION IS MEASURED AT ONE (1) INCH IN LENGTH AND PROVIDED FOR REFERENCE/VERIFICATION ONLY.

KEY PLAN - PRIMARY

No. Date Description

Gillan & Hartmann, Inc.

MECHANICAL AND ELECTRICAL

CONSULTING ENGINEERS

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215-238-9510 609-347-1593 302-654-5959

gillan-hartmann.com ghmail@gillan-hartmann.com

G&H Project No. 2024-147


Drawing Number

11/01/2024 ISSUE FOR BID

ENGINEER MICHAEL S. GILLAN, PE

2024 GILLAN & HARTMANN, Inc.

NO. 24GE04470000

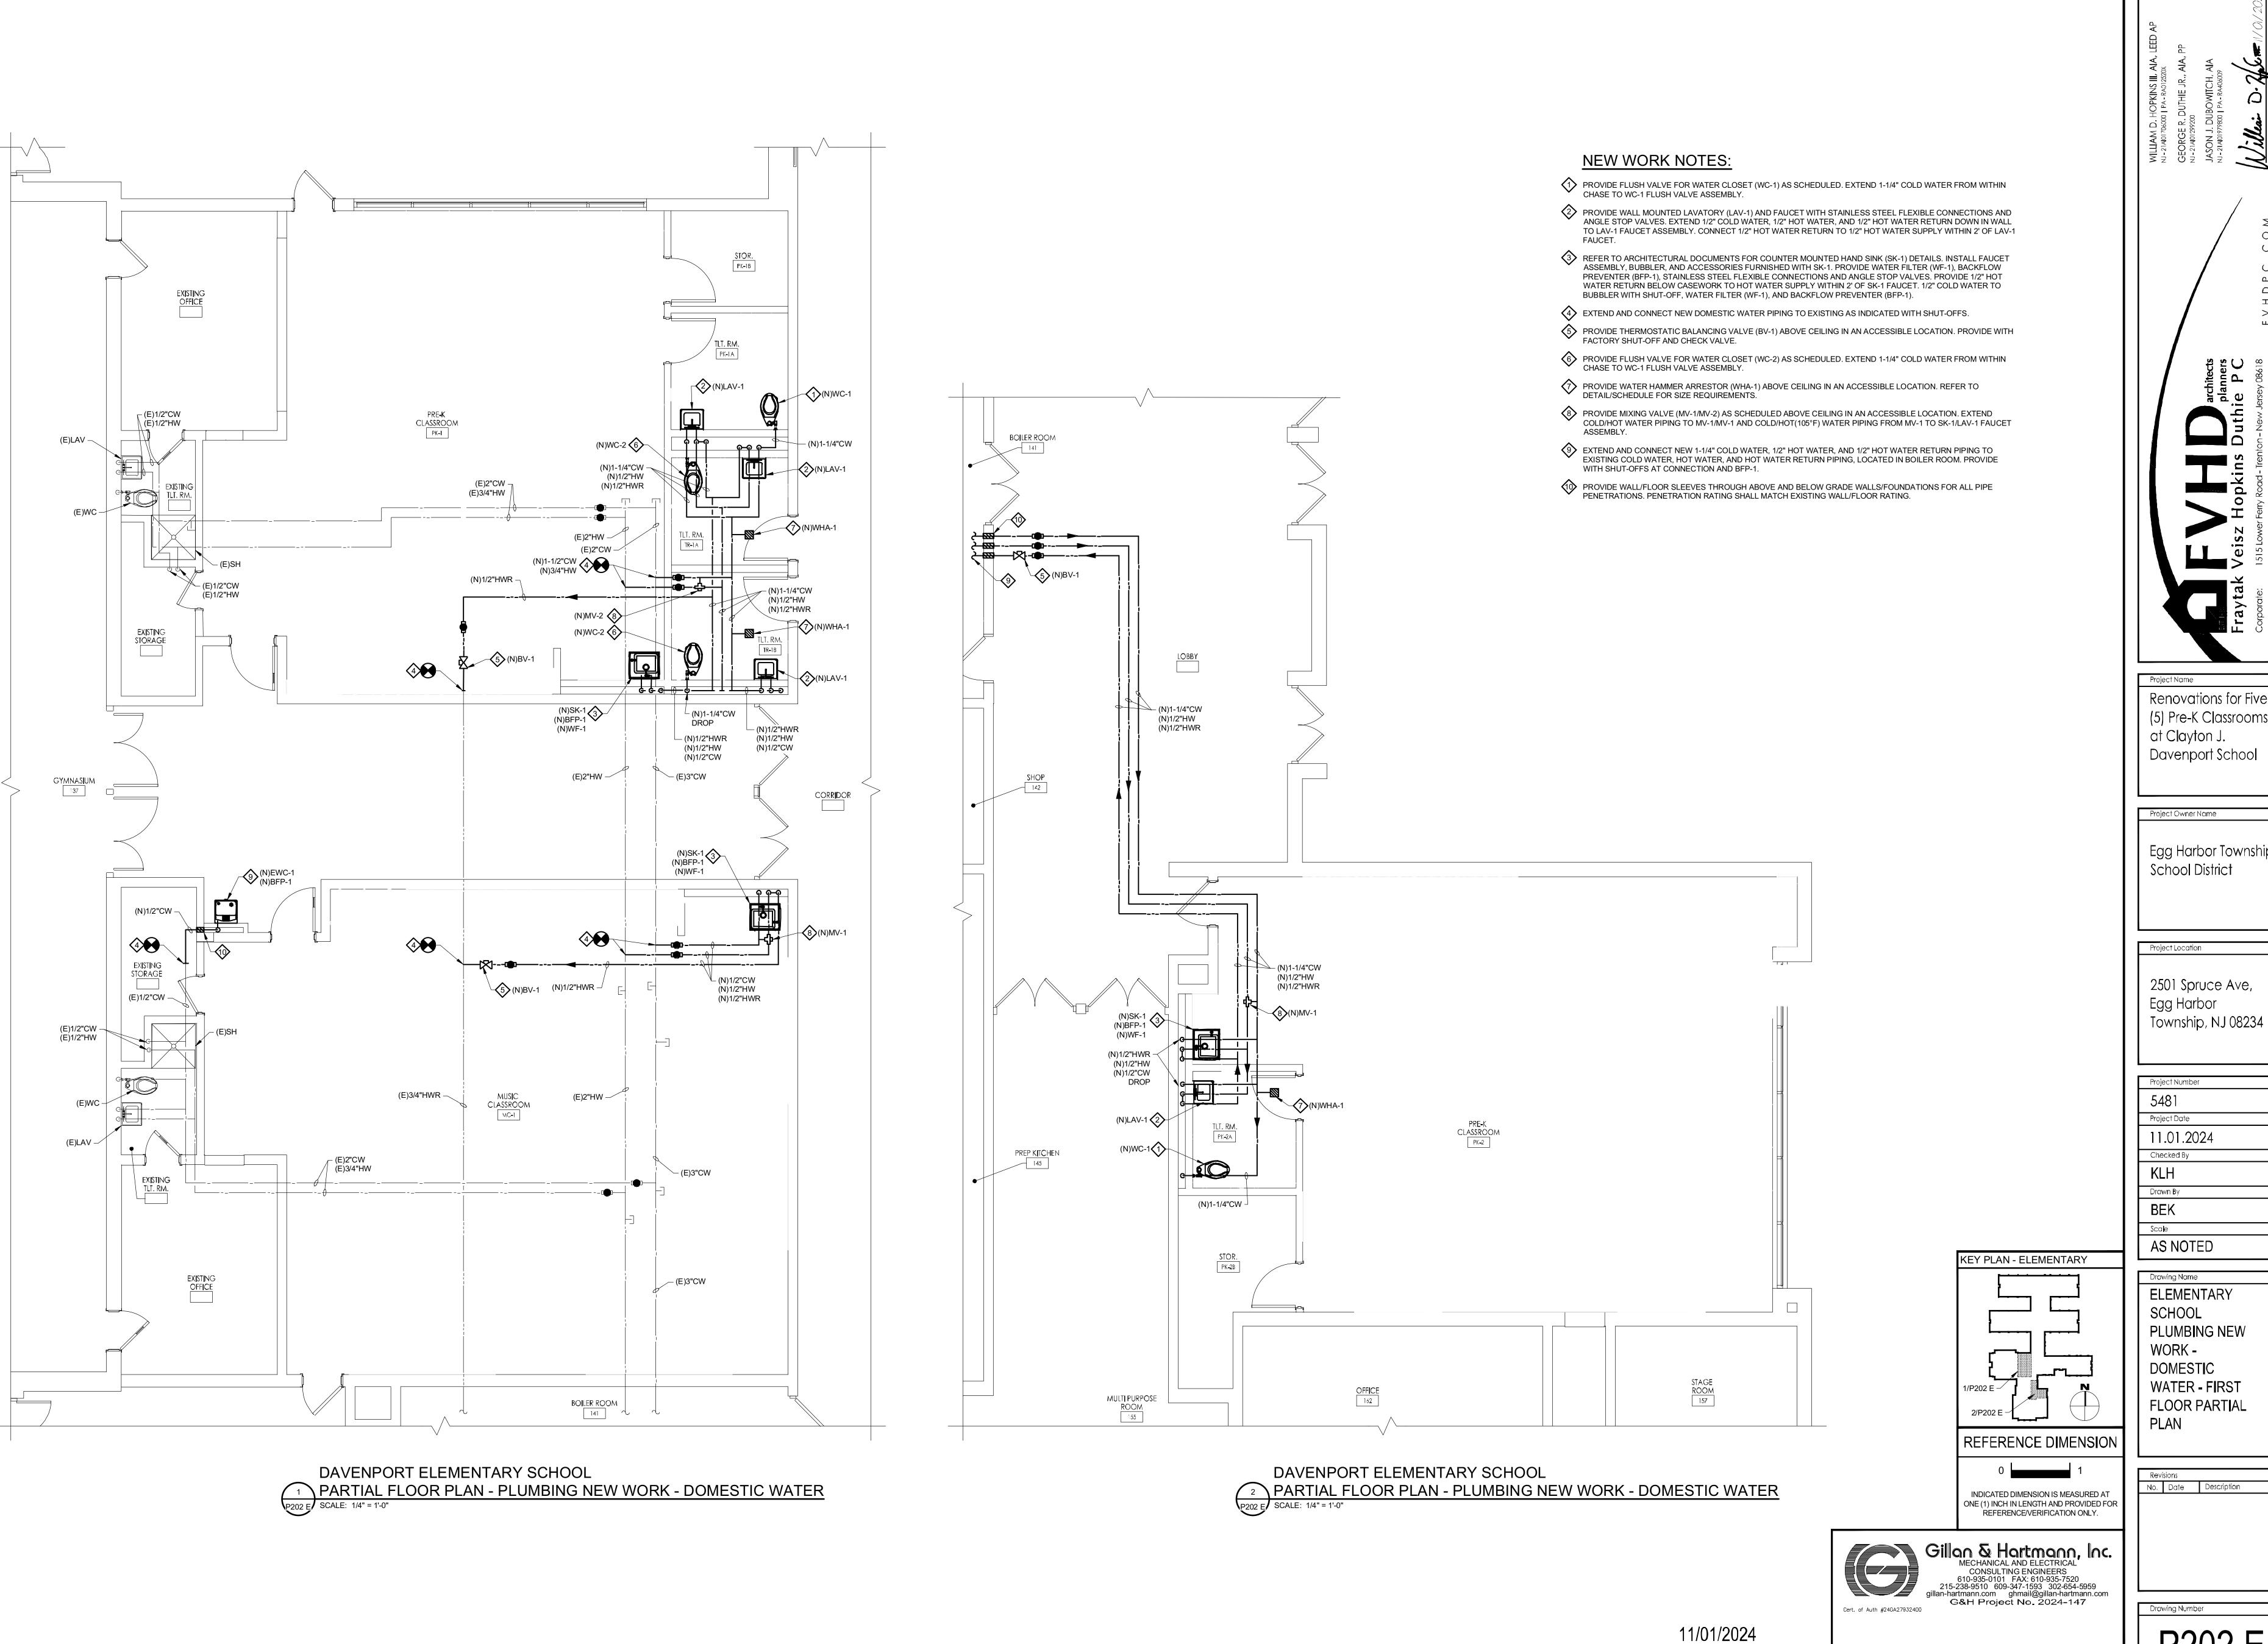

Renovations for Five (5) Pre-K Classrooms at Clayton J.

Project Owner Name

Egg Harbor Township School District

2501 Spruce Ave, Egg Harbor

Drawing Name **ELEMENTARY** SCHOOL PLUMBING NEW WORK -DOMEST**I**C WATER - FIRST FLOOR PARTIAL

No. Date Description


P202 E

MICHAEL S. GILLAN, PE

ENGINEER

DATE NO. 24GE04470000

ISSUE FOR BID

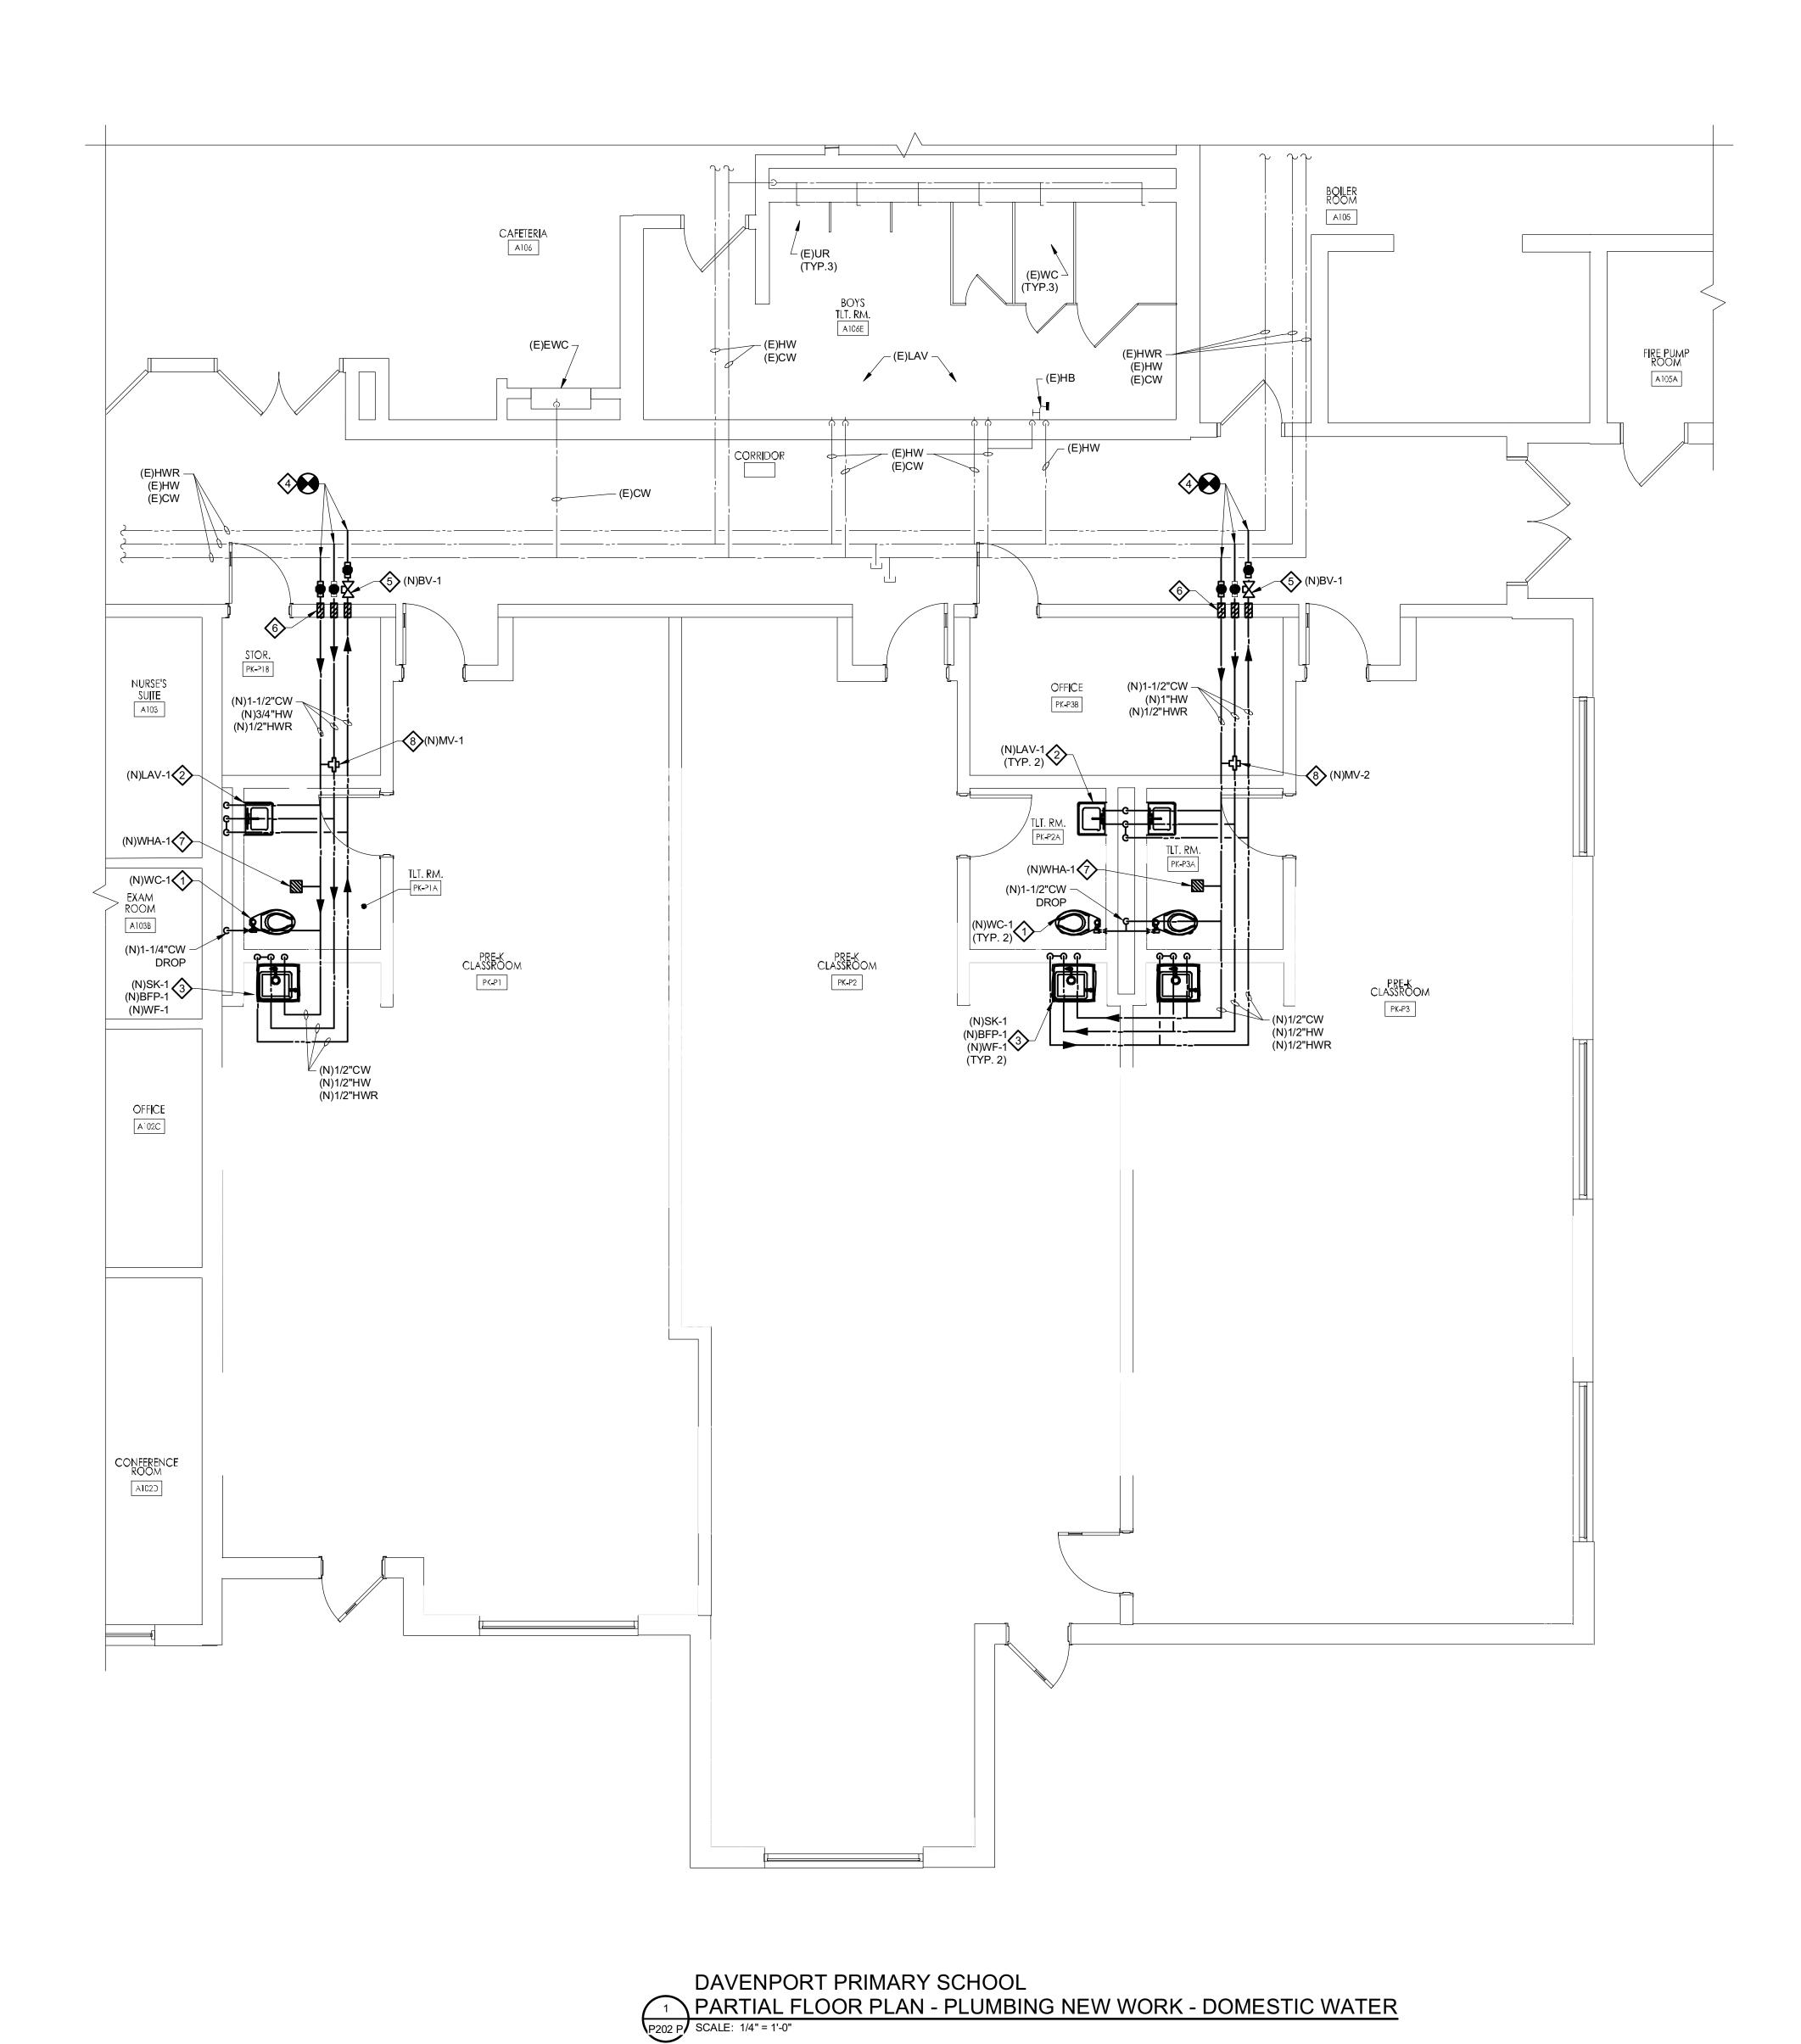

NEW WORK NOTES:

- PROVIDE FLUSH VALVE FOR WATER CLOSET (WC-1) AS SCHEDULED. EXTEND 1-1/4" COLD WATER FROM WITHIN CHASE TO WC-1 FLUSH VALVE ASSEMBLY.
- PROVIDE WALL MOUNTED LAVATORY (LAV-1) AND FAUCET WITH STAINLESS STEEL FLEXIBLE CONNECTIONS AND ANGLE STOP VALVES. EXTEND 1/2" COLD WATER, 1/2" HOT WATER, AND 1/2" HOT WATER RETURN DOWN IN WALL TO LAV-1 FAUCET ASSEMBLY. CONNECT 1/2" HOT WATER RETURN TO 1/2" HOT WATER SUPPLY WITHIN 2' OF LAV-1
- 3 CASEWORK SUBCONTRACTOR SHALL PROVIDE COUNTER MOUNTED HAND SINK (SK-1), FAUCET ASSEMBLY, BUBBLER, AND ACCESSORIES. PLUMBING CONTRACTOR SHALL PROVIDE WATER FILTER (WF-1), BACKFLOW PREVENTER (BFP-1), STAINLESS STEEL FLEXIBLE CONNECTIONS AND ANGLE STOP VALVES. 1/2" HOT WATER RETURN BELOW CASEWORK TO HOT WATER SUPPLY WITHIN 2' OF SK-1 FAUCET. 1/2" COLD WATER TO BUBBLER WITH SHUT-OFF, WATER FILTER (WF-1), AND BACKFLOW PREVENTER (BFP-1).
- EXTEND AND CONNECT NEW DOMESTIC WATER PIPING TO EXISTING NEAR AREA INDICATED WITH SHUT-OFFS.
- PROVIDE THERMOSTATIC BALANCING VALVE (BV-1) ABOVE CEILING IN AN ACCESSIBLE LOCATION. PROVIDE WITH FACTORY SHUT-OFF AND CHECK VALVE.
- PROVIDE WALL/FLOOR SLEEVES THROUGH ABOVE AND BELOW GRADE WALLS/FOUNDATIONS FOR ALL PIPE PENETRATIONS. PENETRATION RATING SHALL MATCH EXISTING WALL/FLOOR RATING.
- PROVIDE WATER HAMMER ARRESTOR (WHA-1) ABOVE CEILING IN AN ACCESSIBLE LOCATION. REFER TO DETAIL/SCHEDULE FOR SIZE REQUIREMENTS.
- PROVIDE MIXING VALVE (MV-1 & MV-2) AS SCHEDULED ABOVE CEILING IN AN ACCESSIBLE LOCATION. EXTEND COLD/HOT WATER PIPING TO MV-1/MV-2 AND COLD/HOT(105°F) WATER PIPING FROM MV-1/MV-2 TO SK-2/LAV-1 FAUCET ASSEMBLY.

Renovations for Five

(5) Pre-K Classrooms at Clayton J. Davenport School

Project Owner Name

Egg Harbor Township School District

Project Location

2501 Spruce Ave, Egg Harbor Township, NJ 08234

Project Number 11.01.2024

Drawn By

\$ca**l**e AS NOTED

Drawing Name PRIMARY SCHOOL PLUMB**I**NG NEW WORK -WATER - FIRST FLOOR PARTIAL

REFERENCE DIMENSION

No. Date Description INDICATED DIMENSION IS MEASURED AT ONE (1) INCH IN LENGTH AND PROVIDED FOR REFERENCE/VERIFICATION ONLY.

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MECHANICAL AND ELECTRICAL

CONSULTING ENGINEERS

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215-238-9510 609-347-1593 302-654-5959

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G&H Project No. 2024-147

KEY PLAN - PRIMARY

1/P202 P ¬

11/01/2024 ISSUE FOR BID




ENGINEER


MICHAEL S. GILLAN, PE


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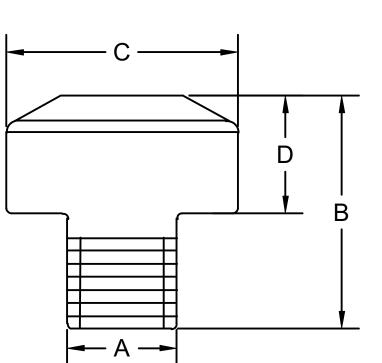
NO. 24GE04470000

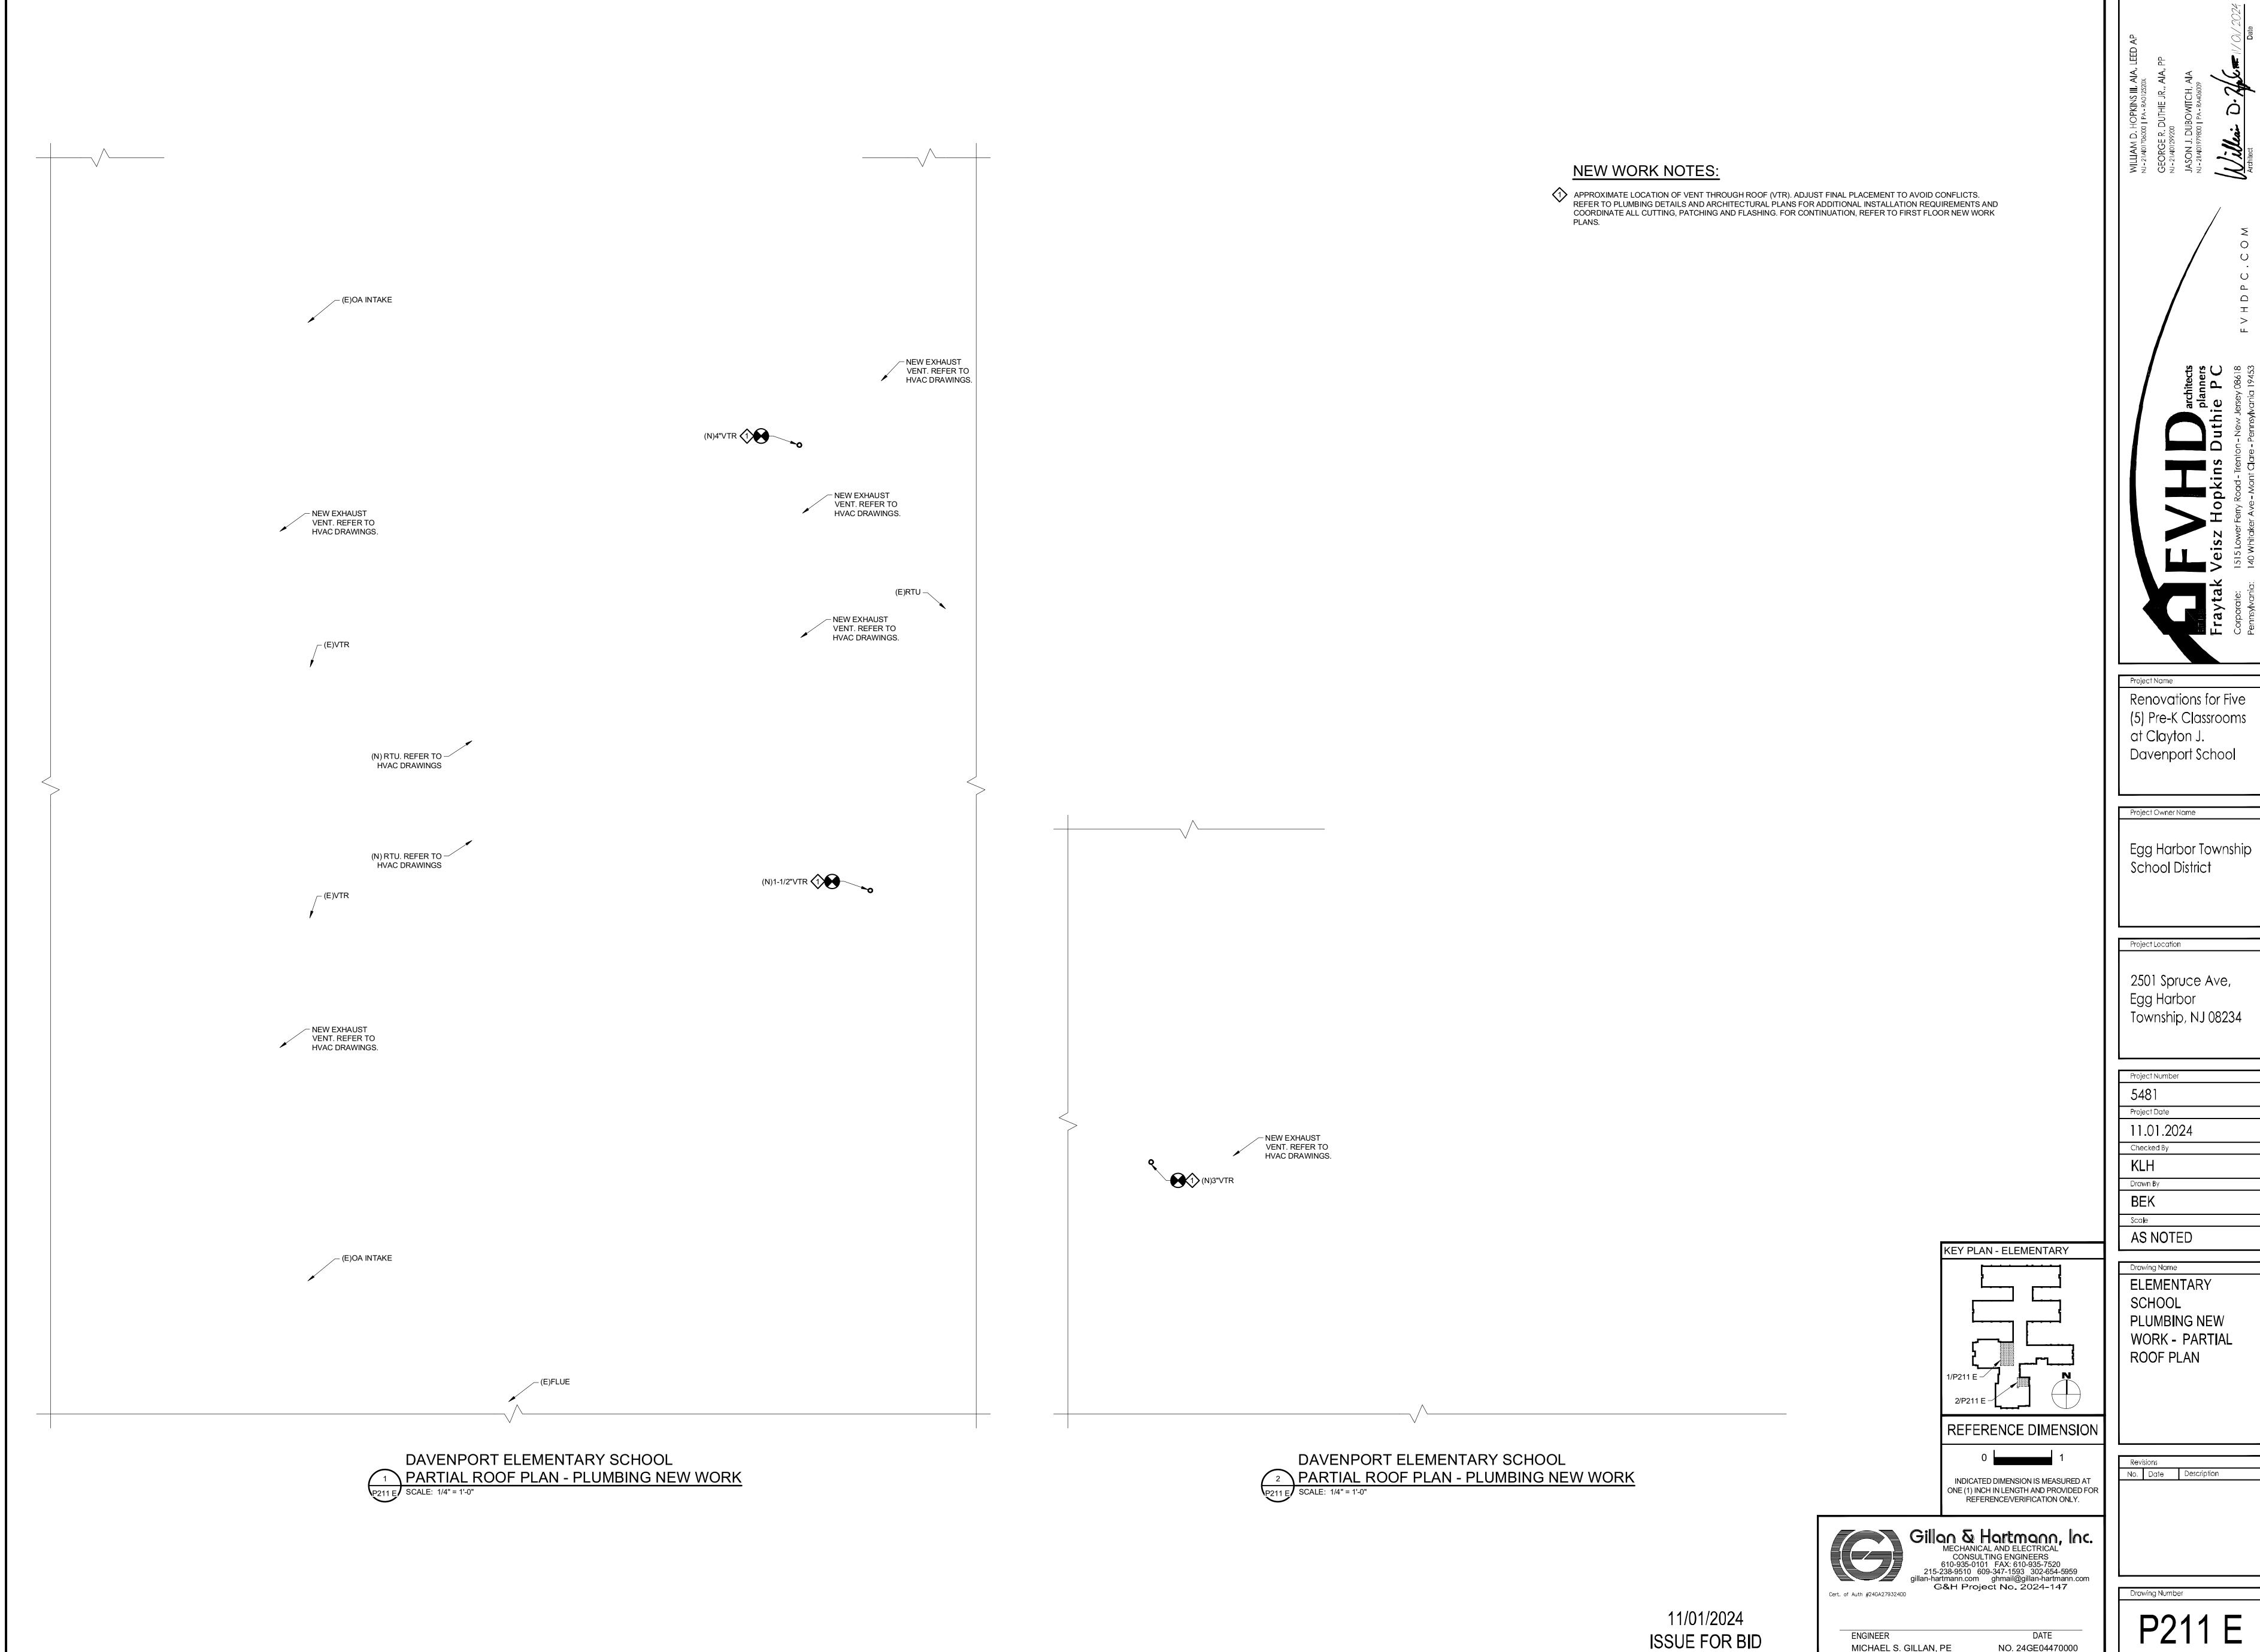

MICHAEL S. GILLAN, PE NO. 24GE04470000 2024 GILLAN & HARTMANN, Inc.



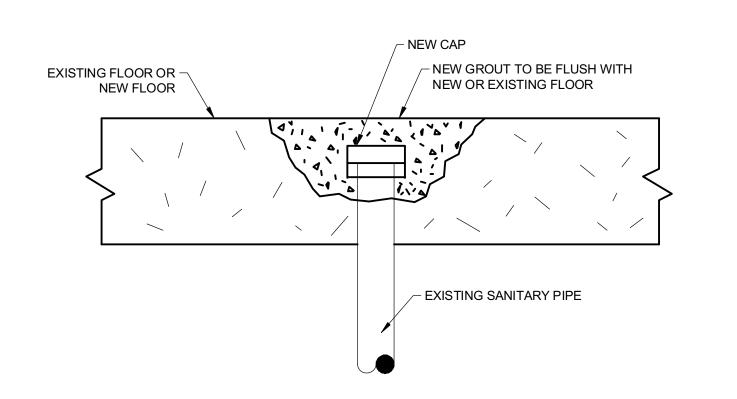

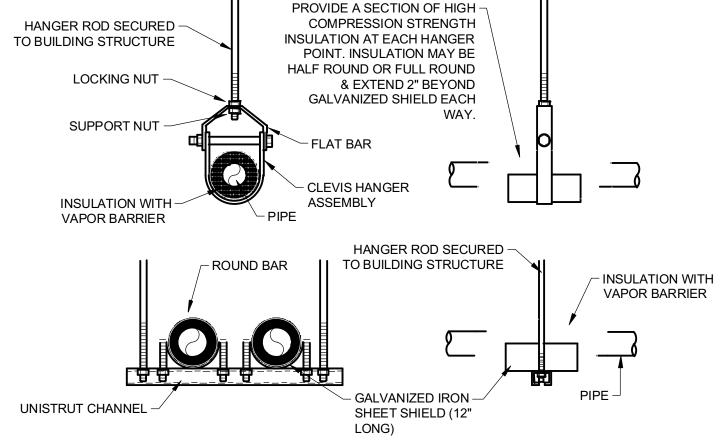

PCN/FIG. NO.

5005

5010


5020

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5040

5050



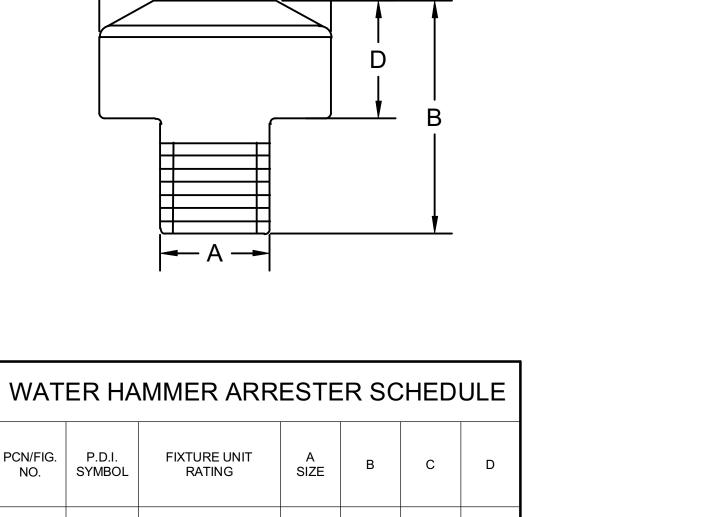

3/4" 3.18" 3.25"


1 3.93" 3.25" 2.13"

1 5.57" 3.25" 3.57"

1 6.53" 3.25" 4.50


4.30" 3.25" 2.42"

5.25" 3.25" 3.38"

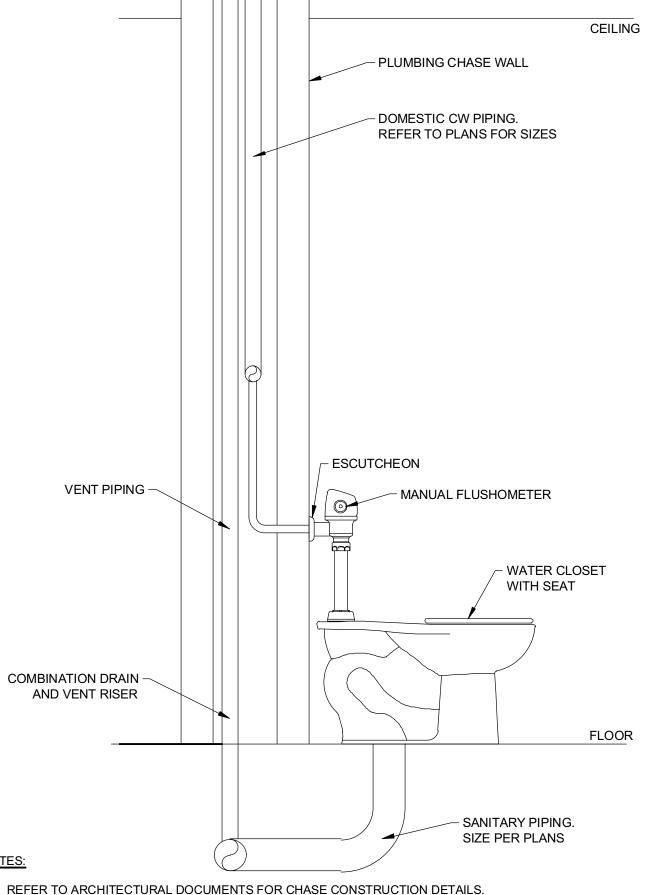


REFER TO ARCHITECTURAL DOCUMENTS FOR CHASE CONSTRUCTION DETAILS.
 REFER TO PLANS FOR PIPE SIZES AND ROUTINGS.

6 DETAIL - CHASE AT TOILET
NO SCALE

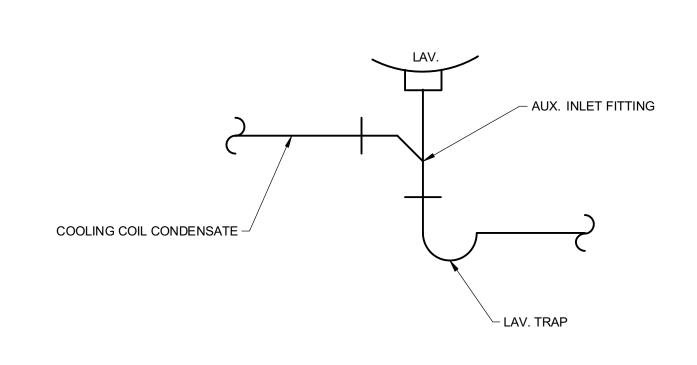

DETAIL - DRAIN CONN.
NO SCALE

\ DETAIL - CAPPING OF EXISTING SANITARY PIPE 1/2" CW, HW, HWR -_ MIXING VALVE (ABOVE CEILING)

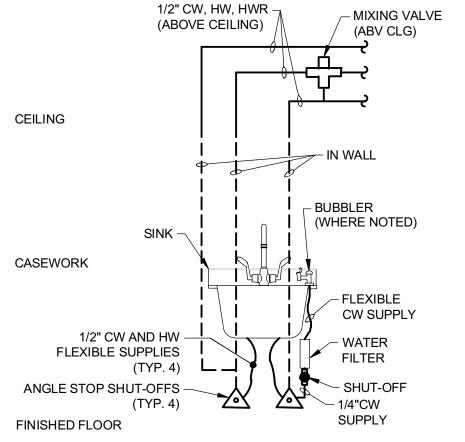

3 DETAIL - SINK WITH BUBBLER

CAULK SEAL PER -

WEATHER TIGHTNESS

METAL FLASHING COLLAR INCLUDING -

SEALS AND CLAMPS REQUIRED FOR


PREFABRICATED PIPE SEAL BY ROOFING

GENERAL NOTES:


1" FIBERGLASS -


INSULATION

APPLICATION

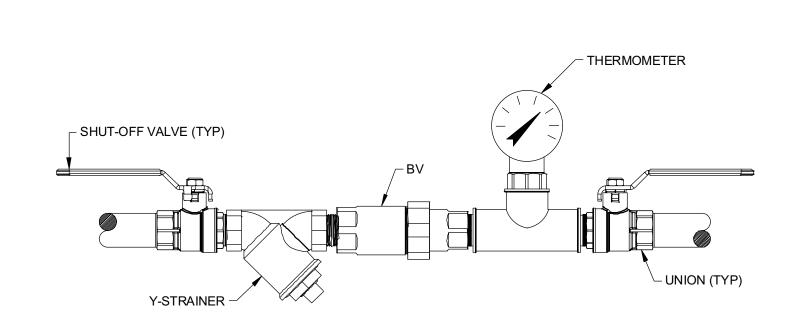



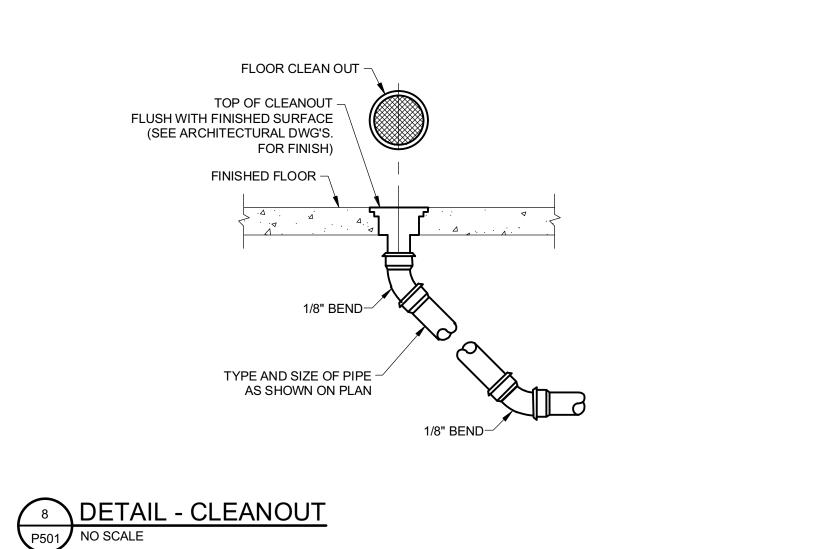

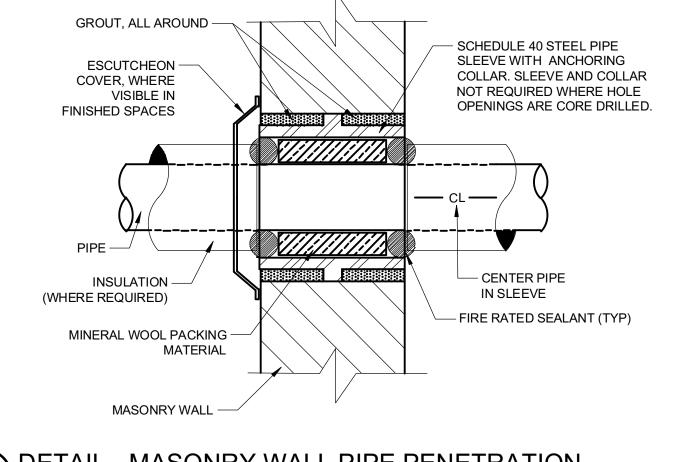

155-330

DETAIL - WATER HAMMER ARRESTER

9	DETAIL - MASONRY WALL PIPE PENETRATION
P501	NO SCALE

VENT STACK SEE PLAN(S) FOR SIZE(S) SUPPORT PIPE FROM STRUCTURE
INCREASE AS REQUIRED RISER CLAMP
7 DETAIL-VENT THRU ROOF P501 NO SCALE

	PLUMBING FIXTURE SCHEDULE														
REF. NO.	F. NO. DESCRIPTION BASIS OF DESIGN MODEL NO. FAUCET AND FLUSH VALVE MOUNTING TYPE DOMESTIC WATER SANITARY									NOTES					
KEF. NO.	DESCRIPTION	BASIS OF DESIGN	WIODEL NO.	FAUCET AND FLUSH VALVE	MOUNTING TYPE	WOONTINGTIPE	WIGONTING I TPE	W.S.F.U.	CW	HW	HWR	D.F.U.	DRAIN	VENT	NOTES
BFP-1	BACKFLOW PREVENTER	WATTS	SD3-MF-LS	-	IN-LINE	-	1/2"	-	-	-	-	-	-		
LAV-1	LAVATORY (BARRIER FREE))	AMERICAN STANDARD	0355.012	AMERICAN STANDARD INNSBROOK 605B.205	WALL	1	1/2"	1/2"	1/2"	1	1-1/2"	1-1/2"	(1)		
SK-1	CLASSROOM SINK WITH BUBBLER (BARRIER FREE)	REFER TO AF	CHITECTURAL DOC	CUMENTS	COUNTER	1.5	1/2"	1/2"	1/2"	2	1-1/2"	1-1/2"	(2)(3)		
WC-1	WATER CLOSET (CHILDRENS HEIGHT)	AMERICAN STANDARD	2282.001	SLOAN 111-1.28	FLOOR	5	1-1/4"	-	-	4	3"	1-1/2"	(5)		
WC-2	WATER CLOSET (BARRIER FREE)	AMERICAN STANDARD	3043.001	SLOAN 111-1.28	FLOOR	5	1-1/4"	-	-	4	3"	1-1/2"	(5)		
WF-1	WATER FILTER	AQUA-PURE	3MFF100	-	BLW COUNTER / IN-LINE	-	1/2"	-	-	-	-	-	(6)		
EWC-1	ELECTRIC WATER COOLER	ELKAY	LZS8WSSP	-	WALL	0.25	1/2"	-	-	0.5	1-1/2"	1-1/2"	(7)		
WHA-1	WATER HAMMER ARRESTOR	J.R. SMITH	5005-5050	-	IN-LINE	-	1/2"	_	-	-	_	-	(4)		

GENERAL NOTES: PROVIDE HARD WIRED SENSOR FAUCET ASSEMBLY, DRAIN, TRAP/TRAP ARM, STRAINER/TAILPIECE, ANGLE STOP VALVES, FLEXIBLE 1/2"CW&HW SUPPLIES, ADA TRAP GUARD, AND WALL CARRIER TO SUIT.

SINK PROVIDED WITH CASEWORK. INSTALL TRAP, TAILPIECE AND OTHER ACCESSORIES FURNISHED WITH SINK. PROVIDE AQUA-PURE WATER FILTER (WF-1) (BASIS OF DESIGN), FLEXIBLE 1/2"CW&HW SUPPLIES, ANGLE STOP VALVES, AND TRAP/TRAP ARM.

12" MINIMUM

(MAXIMUM PER CODE)

┌ ROOF SYSTEM

SIZE PER PDI (REFER TO WATER HAMMER ARRESTOR DETAIL).

PROVIDE ELONGATED OPEN FRONT SEAT, SOFT CLOSING HINGES, AND MANUAL FLUSHOMETER. PROVIDE WATER FILTER SYSTEM MOUNTED UNDER SINK IN AN ACCESSIBLE LOCATION WITH MANUFACTURERS INTEGRAL MOUNTING BRACKET.

PROVIDE MANUFACTURER'S WATER FILTER (MODEL #51600C). PROVIDE MANUFACTURER'S IN-WALL CARRIER (MODEL #MLP100). REDUCE MOUNTING HEIGHT BY 3" FOR INSTALLATION OF CHILDRENS ADA COOLER.

	MIXING VALVE SCHEDULE												
REF. NO.	LOCATION	BASIS OF DESIGN	MODEL	MIN GPM	MAX GPM	PRESS. DROP AT DESIGN FLOW (PSI)	CW INLET TEMP (°F)	HW INLET TEMP (°F)	HW OUTLET TEMP (°F)	CW INLET SIZE	HW INLET SIZE	MIXED OUTLET SIZE	NOTES
MV-1	ABV CLG	WATTS	LFMM/M1	0.5	12	2.5	40°F	120°F	105	1/2"	1/2"	1/2"	(1)(2)(3)
MV-2	ABV CLG	WATTS	LFMMVM1	0.5	12	2.5	40°F	120°F	105	3/4"	3/4"	3/4"	(1)(2)(3)

GENERA	L NOTES:
1.	PROVIDE DOUBLE THROTTLING MIXING VALVE WITH INTEGRAL INLET FILTER WASHERS, DUAL CHECK VALVES, AND ADJUSTABLE CAP WITH LOCKING FEATURE.
2.	MIXING VALVE SHALL BE IN ACCORDANCE WITH ASSE 1070. COORDINATE MIXING VALVE PIPING CONFIGURATION WITH THE MANUFACTUERER REQUIRMENTS.
3.	REFER TO PLANS FOR TOTAL QUANTITIES AND SYSTEMS SERVED BY RESPECTIVE MIXING VALVE.

BALANCING VALVE SCHEDULE							
REF. NO. DESCRIPTION BASIS OF DESIGN MODEL NO. MOUNTING TYPE HWR CONNECTION NOTES							
BV-1	THERMOSTATIC BALANCING VALVE	CIRCUIT SOLVER	CSUAS-1/2-105-TW	IN-LINE	1/2"	(1)	

FACTORY FURNISH WITH (2) SHUT-OFF BALL VALVES, Y-STRAINER, THERMOMETER, & UNIONS.

CLEANOUT SCHEDULE								
REF. NO.	MOUNTING TYPE	BASIS OF DESIGN	MODEL	NOTES				
FCO-1	FLOOR	J.R. SMITH	4020 SERIES - 4023S-FCU	(1)(3)				
WCO-1	WALL	J.R. SMITH	4420 SERIES - 4422C-U	(1)(2)				
GENERAL NO	GENERAL NOTES:							
1.	REFER TO PLAN FOR ASSOCIATED FIXTURE CONNECTION SIZE.							
2.	DUCO CAST IRON CAULK FERRULE WALL CLEANOUT WITH CAST BRONZE							
	TAPER THREADED PLUG AND VANDAL PROOF SCREW.							
3.	PROVIDE NO HUB OUTLET, DUCO CAST IRON FLOOR CLEANOUT WITH							

ROUND ADJUSTABLE SCORIATED SECURED NICKEL BRONZE TOP,

FLANGE WITH FLASHING CLAMP, AND VANDAL PROOF TOP.

REFERENCE DIMENSION INDICATED DIMENSION IS MEASURED AT

ONE (1) INCH IN LENGTH AND PROVIDED FOR REFERENCE/VERIFICATION ONLY.

Gillan & Hartmann, Inc.

MECHANICAL AND ELECTRICAL

CONSULTING ENGINEERS 610-935-0101 FAX: 610-935-7520 215-238-9510 609-347-1593 302-654-5959 gillan-hartmann.com ghmail@gillan-hartmann.com G&H Project No. 2024-147 Cert. of Auth #24GA27932400

11/01/2024 **ENGINEER** ISSUE FOR BID MICHAEL S. GILLAN, PE

NO. 24GE04470000 2024 GILLAN & HARTMANN, Inc.

Drawing Number

Renovations for Five

(5) Pre-K Classrooms

Davenport School

Egg Harbor Township

at Clayton J

Project Owner Name

School District

Project Location

' Egg Harbor

Project Number

Project Date

Checked By

Drawn By

\$cale

AS NOTED

Drawing Name

PLUMB**I**NG

DETAILS AND


SCHEDULES

No. Date Description

11.01.2024

2501 Spruce Ave,

Township, NJ 08234

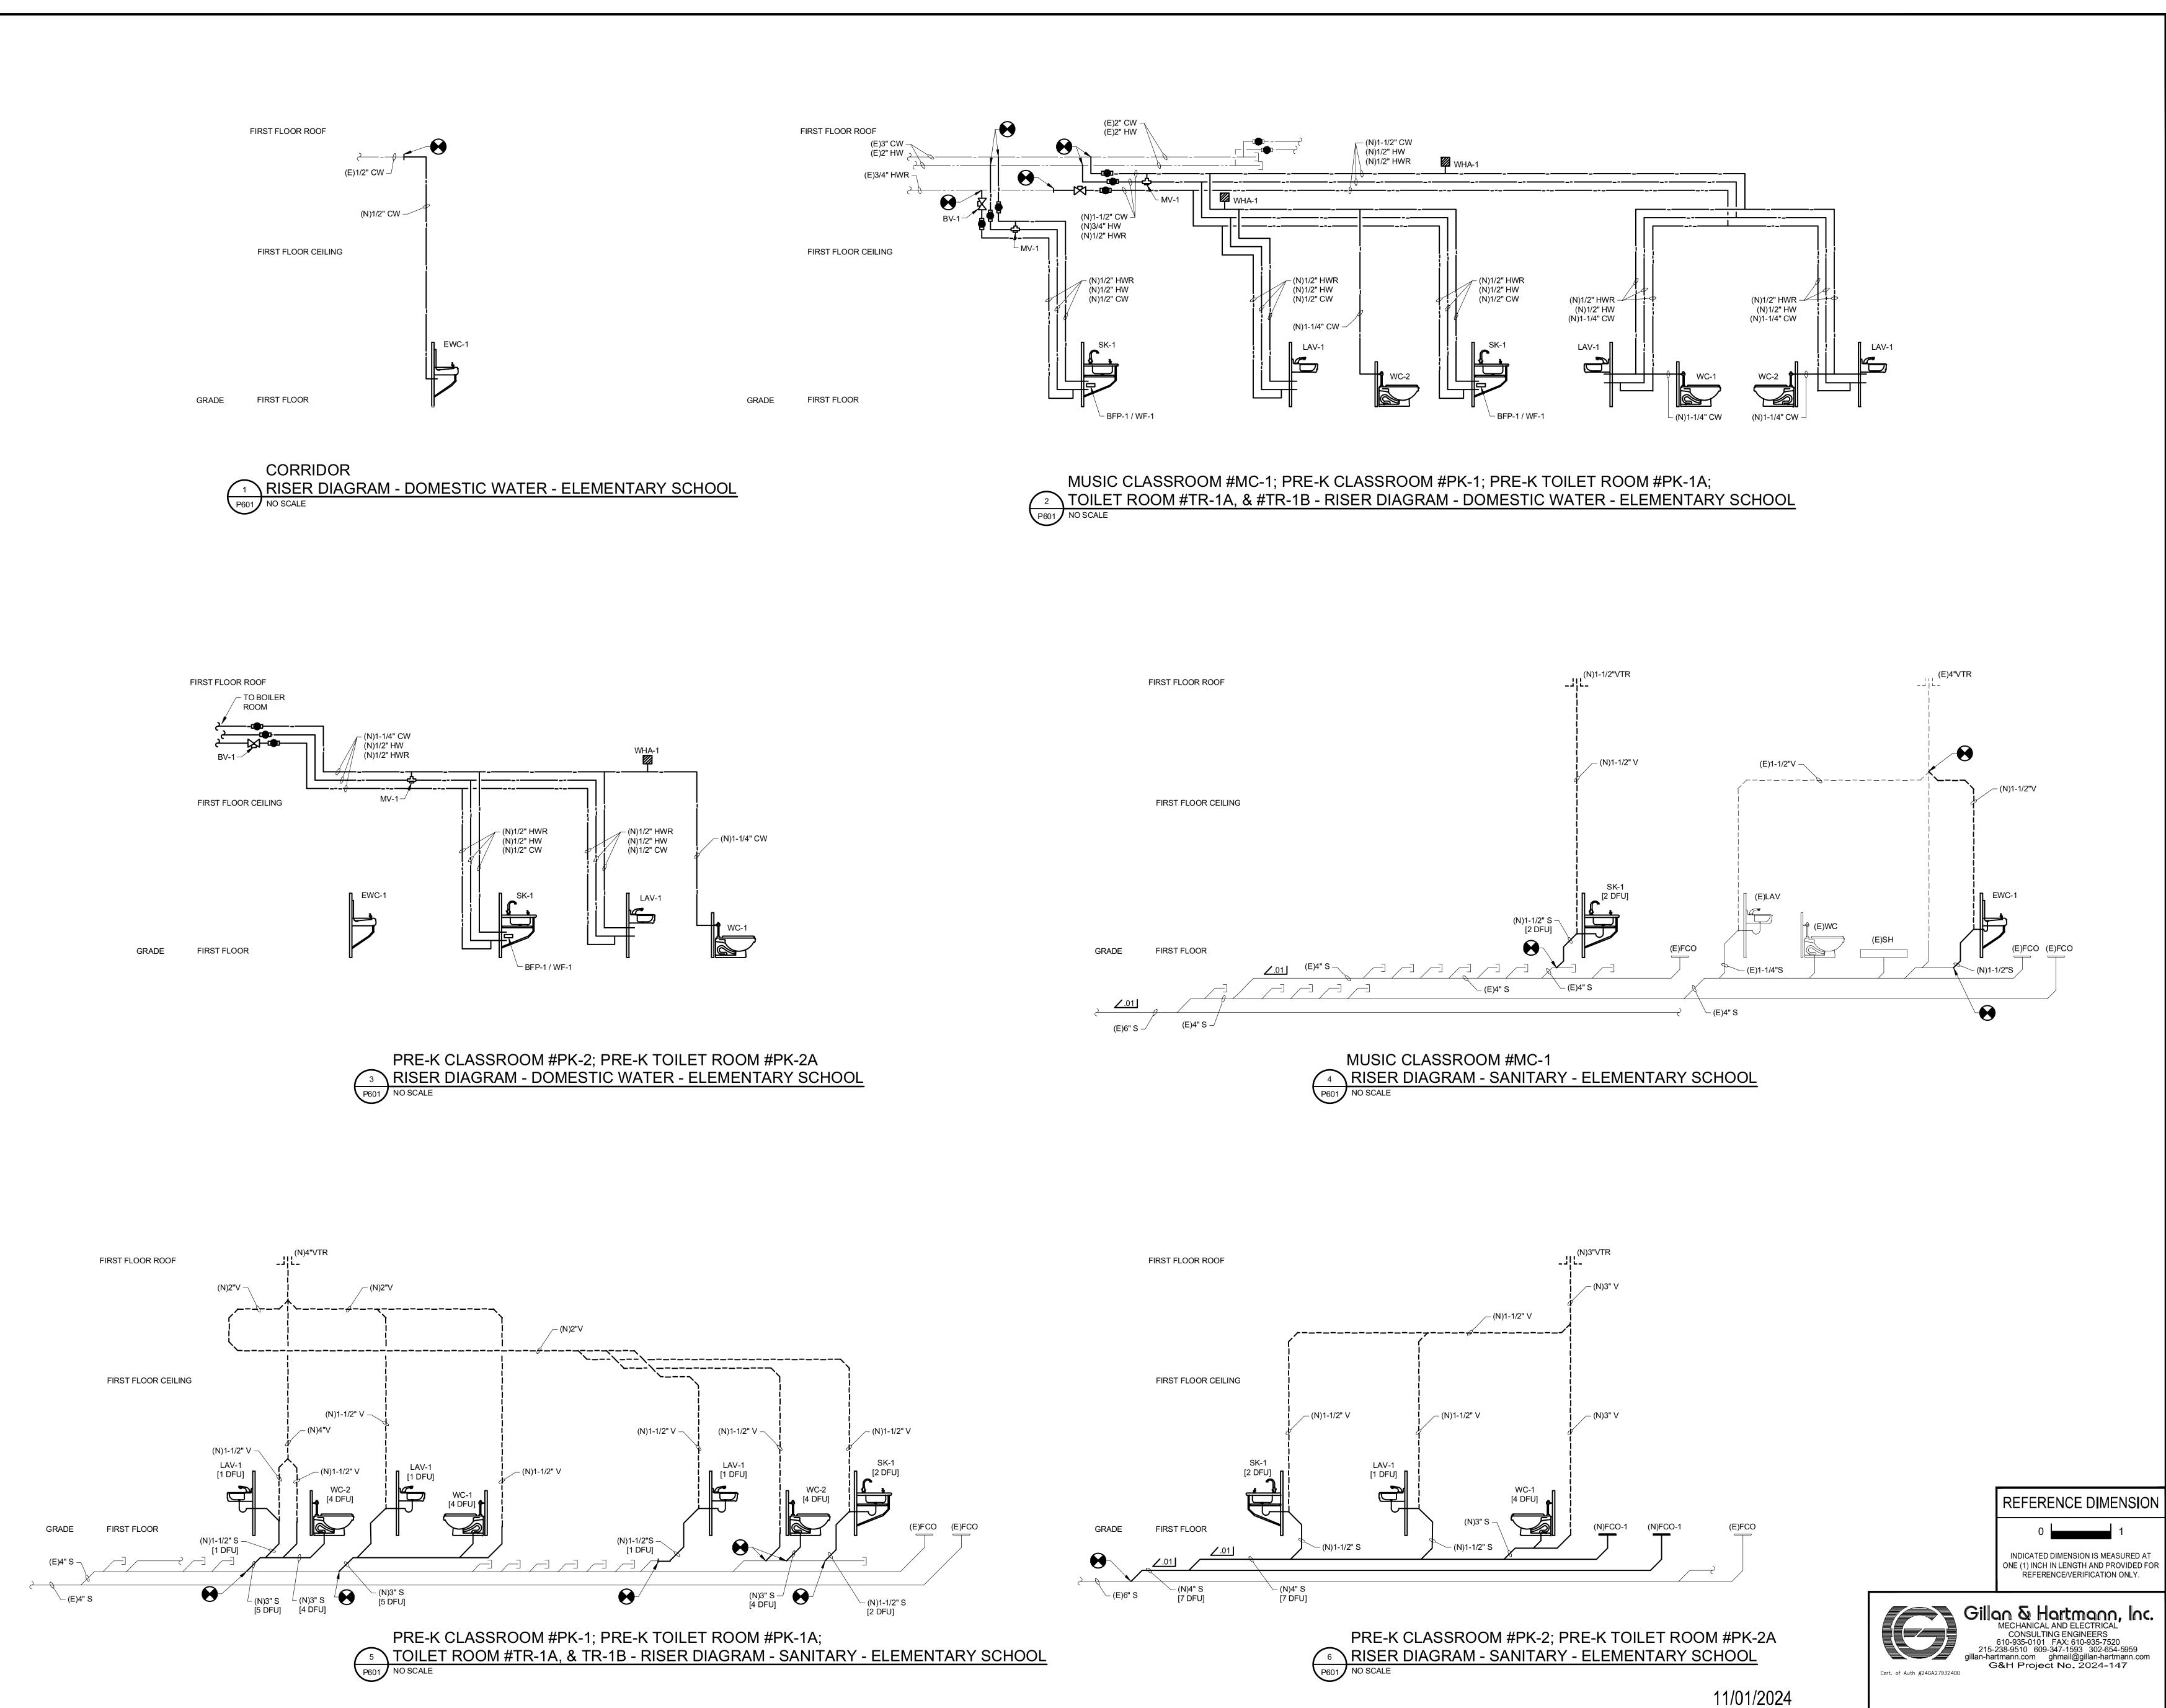

WILLIAM D. HOPKINS III. AJA, LEED AP NI-21A00706500 | PA-RA015250X GEORGE R. DUTHE JR., AJA, PP NI-21A00706500 | PA-RA015250X GEORGE R. DUTHE JR., AJA, PP NI-21A0079500 | PA-RA016009 |

Renovations for Five (5) Pre-K Classrooms at Clayton J.
Davenport School

Project Owner Name

Egg Harbor Township School District

Project Location

2501 Spruce Ave, Egg Harbor Township, NJ 08234

Project Number

5481

Project Date

11.01.2024

Checked By

BEK
Scale
AS NOTED

SCHOOL

Drawn By

PLUMBING RISER
DIAGRAMS ELEMENTARY

Revisions
No. Date Description


P601

Drawing Number


ENGINEER DATE
MICHAEL S. GILLAN, PE NO. 24GE04470000

2024 GILLAN & HARTMANN, Inc.

ISSUE FOR BID

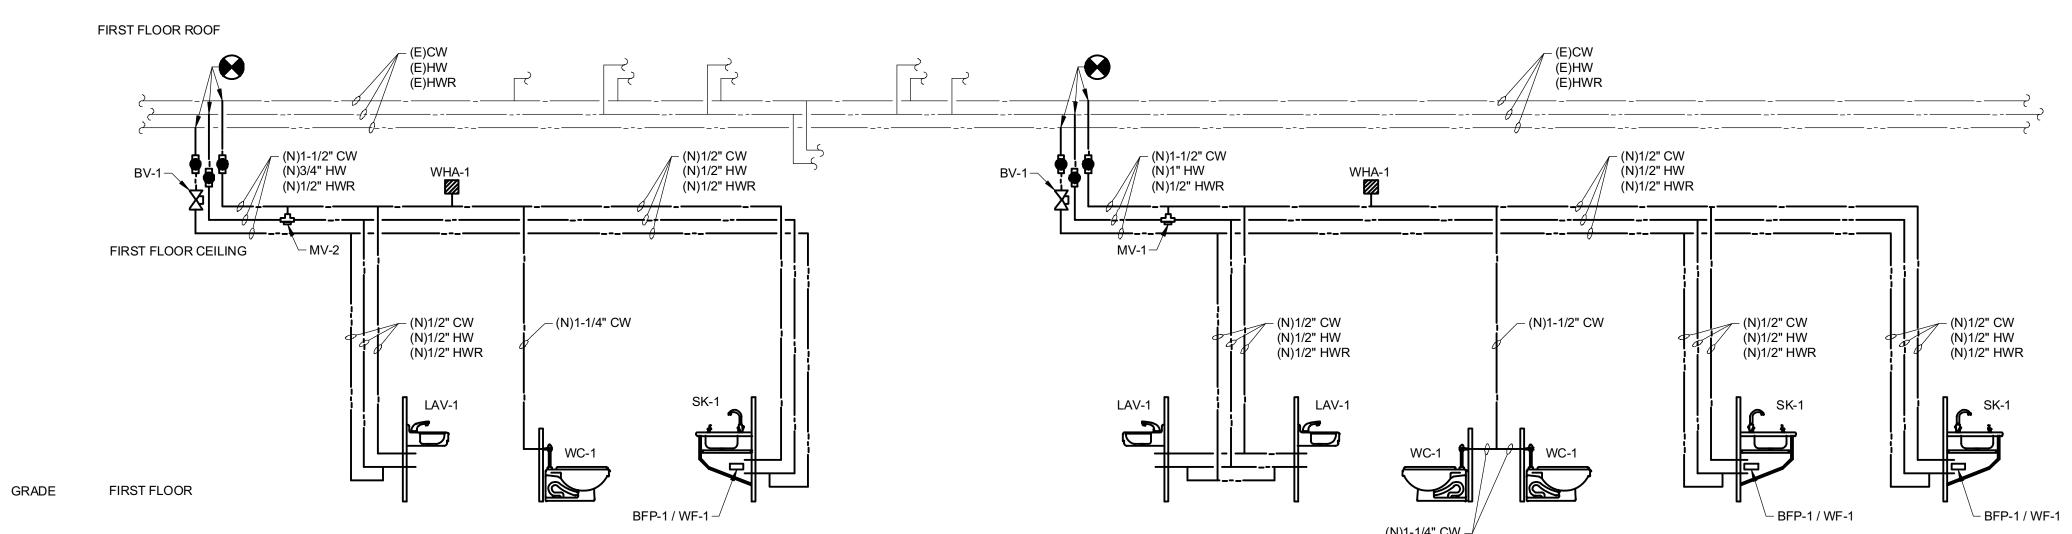

PRE-K TOILET ROOM #PK-P1A, #PK-P2A, & #PK-P3A 1 RISER DIAGRAM - DOMESTIC WATER - PRIMARY SCHOOL
P602 NO SCALE

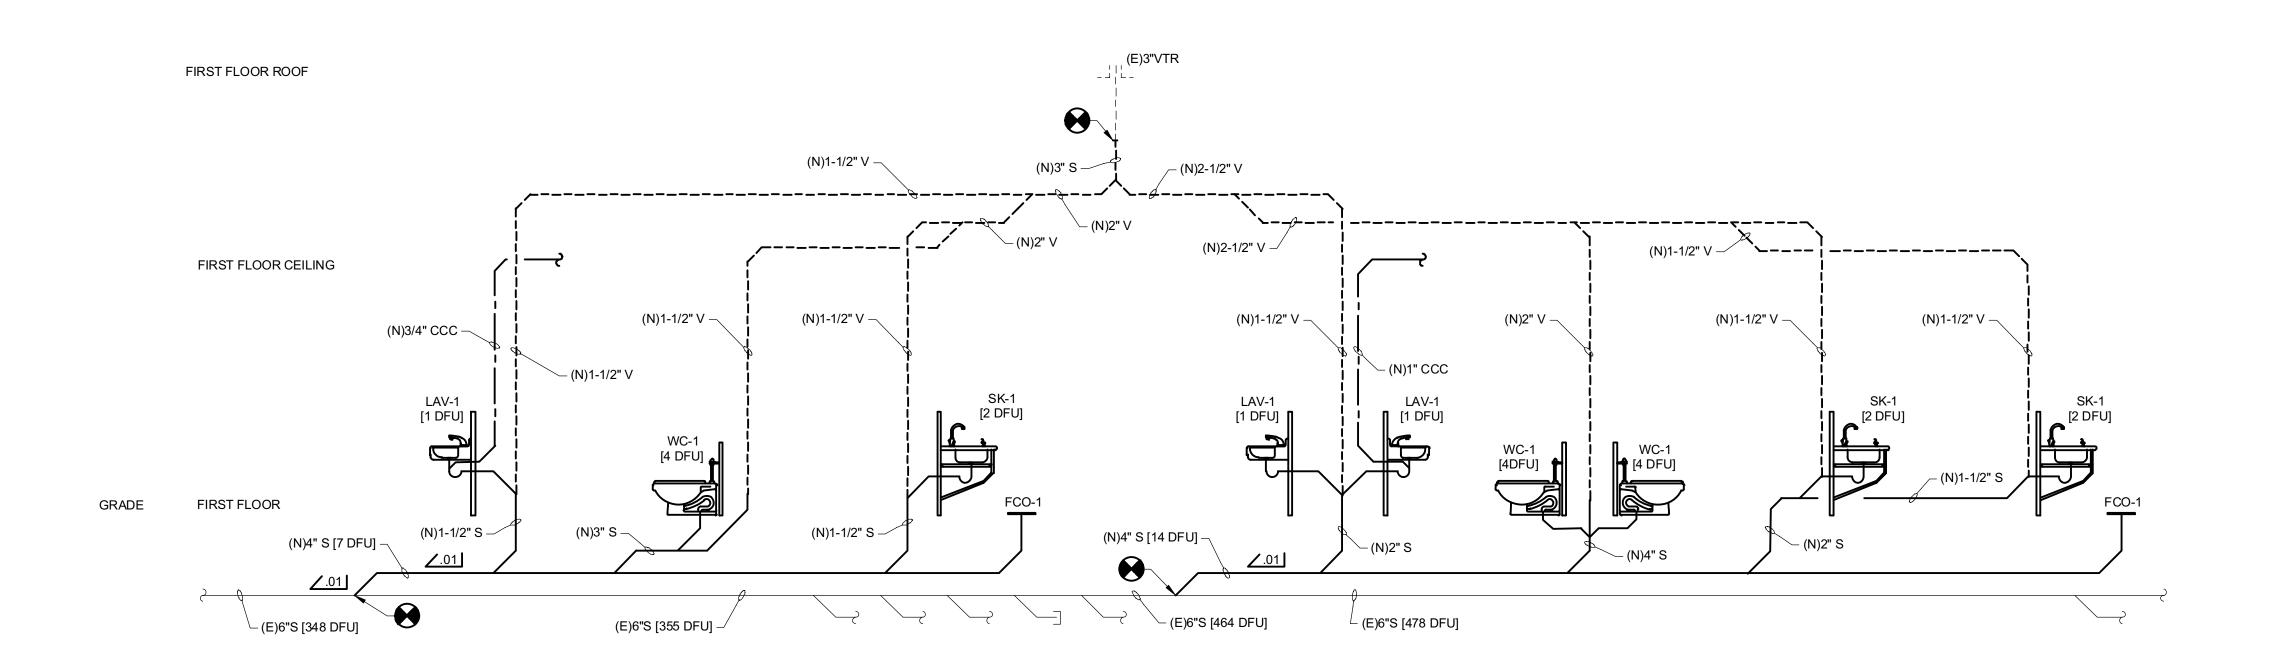

PRE-K TOILET ROOM #PK-P1A, #PK-P2A, & #PK-P3A RISER DIAGRAM - SANITARY - PRIMARY SCHOOL

NO SCALE

REFERENCE DIMENSION

INDICATED DIMENSION IS MEASURED AT ONE (1) INCH IN LENGTH AND PROVIDED FOR REFERENCE/VERIFICATION ONLY.

Gillan & Hartmann, Inc.

MECHANICAL AND ELECTRICAL

CONSULTING ENGINEERS

610-935-0101 FAX: 610-935-7520

215-238-9510 609-347-1593 302-654-5959

gillan-hartmann.com ghmail@gillan-hartmann.com

G&H Project No. 2024-147

NO. 24GE04470000

11/01/2024 ISSUE FOR BID

ENGINEER MICHAEL S. GILLAN, PE

2024 GILLAN & HARTMANN, Inc.

(N)1-1/4" CW

(5) Pre-K Classrooms at Clayton J. Davenport School

Renovations for Five

Project Owner Name

Egg Harbor Township School District

Project Location

2501 Spruce Ave, Egg Harbor Township, NJ 08234

Project Number 11.01.2024

Checked By Drawn By

AS NOTED

Drawing Name PLUMBING RISER DIAGRAMS -PR**I**MARY SCHOOL

No. Date Description


FIRE PROTECTION LEGEND REMOVAL WORK (REFER TO PLAN) THERMOMETER PRESSURE GAUGE W/ COCK PRE ACTION SPRINKLER PIPING PA —— AIR VENT W/ COCK **├** DRY SPRINKLER PIPING FIRE PROTECTION WATER SUPPLY F —— AUTOMATIC AIR VENT $\leftarrow - - - \rightarrow$ AUTOMATIC FIRE SPRINKLER SYSTEM DRAIN ____ CA ____ COMPRESSED AIR AQUASTAT LAWN SPRINKLER SUPPLY _____LS _____ WATER HAMMER ARRESTOR PIPE SLOPE - IN DIRECTION OF ARROW FLOW - IN DIRECTION OF ARROW FLOW SWITCH \longrightarrow GATE VALVE \leftarrow GLOBE VALVE CHECK VALVE PRESSURE SWITCH BALANCING VALVE FIRE PUMP TEST CONNECTION BALL VALVE SIAMESE FIRE DEPARTMENT CONNECTION **BUTTERFLY VALVE** FIRE PUMP TEST CONNECTION VALVE ON RISE WATERPROOF STROBE/HORN SOLENOID VALVE AUXILIARY DRAIN FOR LOW POINT (DRUM DRIP) TWO-WAY CONTROL VALVE THREE-WAY CONTROL VALVE PUMP INLINE PUMP PRESSURE REDUCING VALVE **ROOF DRAIN** RELIEF OR SAFETY VALVE PLAIN COMBO FLOOR DRAIN PLAIN ROUND FLOOR DRAIN STRAINER PLAIN SQUARE FLOOR DRAIN STRAINER W/ BLOW-DOWN VALVE FLOW SENSOR HOSE BIB SIGHT GLASS 2777 - 2 SCM PIPE SLEEVE/GUIDE SUPERVISOR CONTROL MODULE PIPE ANCHOR **RELAY MODULE** PIPE BREAK MINI MONITOR MODULE PIPE CAP **RCM** RELEASE MODULE FLEXIBLE CONNECTION ANGLE GATE VALVE \sim UPRIGHT SPRINKLER CONCEALED SPRINKLER STANDARD SYMBOLS SIDE WALL WET SPRINKLER SIDE WALL DRY SPRINKLER DATUM POINT OS&Y GATE VALVE TEST FLOW METER REVISION DIAPHRAGM NEW WORK NOTE DESIGNATION REMOVAL WORK NOTE DESIGNATION PIPE TURNING DOWN CONNECT TO EXISTING PIPE TURNING UP EXTENT OF REMOVAL - EQUIPMENT ABBREVIATION DROP AND RUN TAG NUMBER DROP AND TURN PLAN, SECTION, OR DETAIL NUMBER — SHEET NUMBER - $\sim \bowtie \sim \bowtie \sim$ BACK FLOW PREVENTER HEAT TRACE SECTION OR DETAIL SHEET NUMBER — NUMBER -**ELEVATION** SHEET NUMBER -

FIRE PROTECTION ABBREVIATIONS:

	THE THOTE OF THE TRANSPORT		<u>. 110.</u>
V	ABOVE	G	NATURAL GAS
	AIR COMPRESSOR	G.C.	GENERAL CONRACTOR
V	ALARM CHECK VALVE	GD	GARAGE DRAIN
	AREA DRAIN	HB	HOSE BIBB
F	ABOVE FINISH FLOOR	HT	HEAT TRACE
J	AUTHORITY HAVING JURISDICTION ACCESS PANEL	IN.	INCH
CNET	BUILDING AUTOMATION & CONTROL NETWORK	INV.	INVERT ELEVATION
N	BELOW	MAX	MAXIMUM
F	BELOW FINISHED FLOOR	M.C.	MECHANICAL CONTRACTOR
P	BACKFLOW PREVENTER	MIN	MINIMUM
S	BUILDING MANAGEMENT SYSTEM	(N)	NEW
В	BOTTOM OF BEAM	N.C.	NORMALLY CLOSED
D	BOTTOM OF DECK	N.I.C.	NOT IN CONTRACT
	CONCRETE PIPING	N.O.	NORMALLY OPEN
	CLEAN OUT	OS&Y	OUTSIDE SCREW & YOKE VALVE
NT.	CONTINUATION	P.C.	PLUMBING CONTRACTOR
111.	CAST IRON	PSI	POUNDS PER SQUARE INCH
.C.L	CAST IRON CEMENT LINED	PVC	POLY VINYL CHLORIDE
	CATCH BASIN	P.I.V.	POST INDICATOR VALVE
G	CEILING	PRESS.	PRESSURE
I	DOMESTIC COLD WATER	PRV	PRESSURE REGULATING VALVE
I	DOMESTIC WATER	Q.Z.V.	QUADRUPLE ZONE VALVE BOX
	DOWN	Q.A.P.	QUADRUPLE ALARM PANEL
	DRY STANDPIPE	(R)	REMOVE
	DECK DRAIN	REF.	REFERENCE
١.	DIAMETER	SMH	SANITARY MANHOLE
λ.P.	DUPLEX ALARM PANEL	SP	SPRINKLER PIPING
V.	DUPLEX ZONE VALVE BOX	STMH	STORM MANHOLE
 Р.	DUCTILE IRON PIPE	STP	STANDARD PIPE
	EXISTING	TC	TERRACOTTA
) .	ELECTRICAL CONTRACTOR	TEMP.	TEMPERATURE
	ELEVATION	T.A.P.	TRIPLE ALARM PANEL
	FROM BELOW	T.Z.V.	TRIPLE ONE VALVE BOX
0	FLOOR CLEAN OUT	T.E.	TOP ELEVATION
С	FIRE DEPARTMENT CONNECTION	TB	THRUST BLOCK
	FIRE HYDRANT	TS	TAMPER SWITCH
N	FLOW SWITCH	TYP.	TYPICAL
	FIRE EXTINGUISHER	<u>V</u>	VACUUM
).V.	FIRE DEPARTMENT VALVE	V	VENT
).C.	FIRE DEPARTMENT CONNECTION	VB	VACUUM BREAKER
).l.	FLOW CONTROL VALVE	YH	YARD HYDRANT
	FLOOR DRAIN	W	WASTE
	FINISHED FLOOR	W.C.	WATER COLUMN
	FORCED MAIN	WCO WF	WALL CLEAN OUT WATER FILTER
I.C.	FIRE HOSE CONNECTION	WH	WALL HYDRANT
₹	FLOOR	WOAC	WALL OPENING ABOVE CEILING
	FIRE PROTECTION	WOBC	WALL OPENING ABOVE CEILING WALL OPENING BELOW CEILING
	FLOW SWITCH	VVODC	WALL OF LINING BLLOW CEILING

FLOW SWITCH

NORTH ARROW

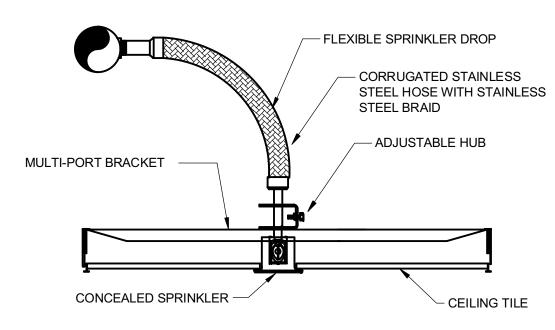

1. CENTER SPRINKLERS IN CEILING TILE.

DETAIL - TYPICAL CONCEALED SPRINKLER HEAD

FP001 P NO SCALE

FIRE PROTECTION GENERAL NOTES:

- 1. GENERAL NOTES APPLY TO ALL FIRE PROTECTION DRAWINGS.
- 2. THE DRAWINGS SHOW A GENERAL REPRESENTATION OF QUANTITIES AND LOCATIONS OF EXISTING FIRE PROTECTION COMPONENTS AND SYSTEMS, AND ARE NOT ALL INCLUSIVE. IT IS THE CONTRACTOR'S RESPONSIBILITY TO PROVIDE REMOVAL OF THE FIRE PROTECTION BUILDING SYSTEMS TO FULFILL THE INTENT OF THE DESIGN INDICATED BY THE CONTRACT DOCUMENTS, UNLESS OTHERWISE NOTED. REMOVAL WORK IS TO INCLUDE, BUT NOT LIMITED TO REMOVAL OF EQUIPMENT, APPARATUS, SYSTEM ACCESSORIES, PIPING, DROPS, AUXILIARY SYSTEMS, PIPING ACCESSORIES, HANGERS AND SYSTEM APPURTENANCES.
- FIRE PROTECTION PIPING LAYOUTS ARE SCHEMATIC IN NATURE. PROVIDE OFFSETS AND FITTINGS AS REQUIRED TO ACCOMMODATE FIELD CONDITIONS AT NO ADDITIONAL COST TO THE OWNER.
- 4. ENSURE ALL WORK IS IN CONFORMANCE WITH ALL APPLICABLE BUILDING CODES. WORK SHALL BE COMPLETED IN STRICT ACCORDANCE WITH THE LATEST EDITIONS OF THE APPLICABLE CONSTRUCTION CODE, AND ALL OTHER FEDERAL, STATE, AND LOCAL AGENCY REGULATIONS HAVING JURISDICTION OVER THIS PROJECT. IN THE EVENT OF ANY DISCREPANCIES BETWEEN AGENCY REQUIREMENTS, OBSERVE THE MORE STRINGENT OF REQUIREMENTS.
- 5. COORDINATE AND FIELD VERIFY ALL DIMENSIONS, SIZES, CLEARANCES, AND FINAL PLACEMENT OF ALL FIRE PROTECTION, HVAC, PLUMBING, AND ELECTRICAL, EQUIPMENT, FIXTURES AND ACCESSORIES WITH THE RESPECTIVE TRADE CONTRACTORS PRIOR TO ROUGH IN. WHEN CONFLICT ARISES, MAKE ANY NECESSARY CHANGES TO ROUTING OF PIPING WITHOUT COMPROMISING THE INTEGRITY AND PERFORMANCE OF THE SYSTEM, AND AT NO ADDITIONAL COST TO THE OWNER.
- 6. INSTALL ALL EQUIPMENT TO MAINTAIN ADEQUATE CLEARANCES PER MANUFACTURER'S REQUIREMENTS. PROVIDE OFFSETS AS NECESSARY TO
- 7. ALL PIPING TO BE CONCEALED UNLESS OTHERWISE INDICATED.
- 8. SCHEDULE AND OBTAIN APPROVAL FOR ALL SYSTEM SHUTDOWNS WITH THE OWNER PRIOR TO COMMENCING WITH REMOVAL AND NEW WORK.

Renovations for Five (5) Pre-K Classrooms at Clayton J. Davenport School

Project Owner Name

Egg Harbor Township School District

Project Location

2501 Spruce Ave, Egg Harbor Township, NJ 08234

Project Number

Project Date 11.01.2024 Checked By

Drawn By

\$cale AS NOTED

Drawing Name

PRIMARY SCHOOL - FIRE PROTECTION ABBREVIATIONS, DETAILS AND **GENERAL NOTES**

REFERENCE DIMENSION

INDICATED DIMENSION IS MEASURED AT ONE (1) INCH IN LENGTH AND PROVIDED FOR REFERENCE/VERIFICATION ONLY.

Revisions

No. Date Description

Drawing Number




NO. 24GE04470000

ENGINEER


11/01/2024 ISSUE FOR BID

MICHAEL S. GILLAN, PE

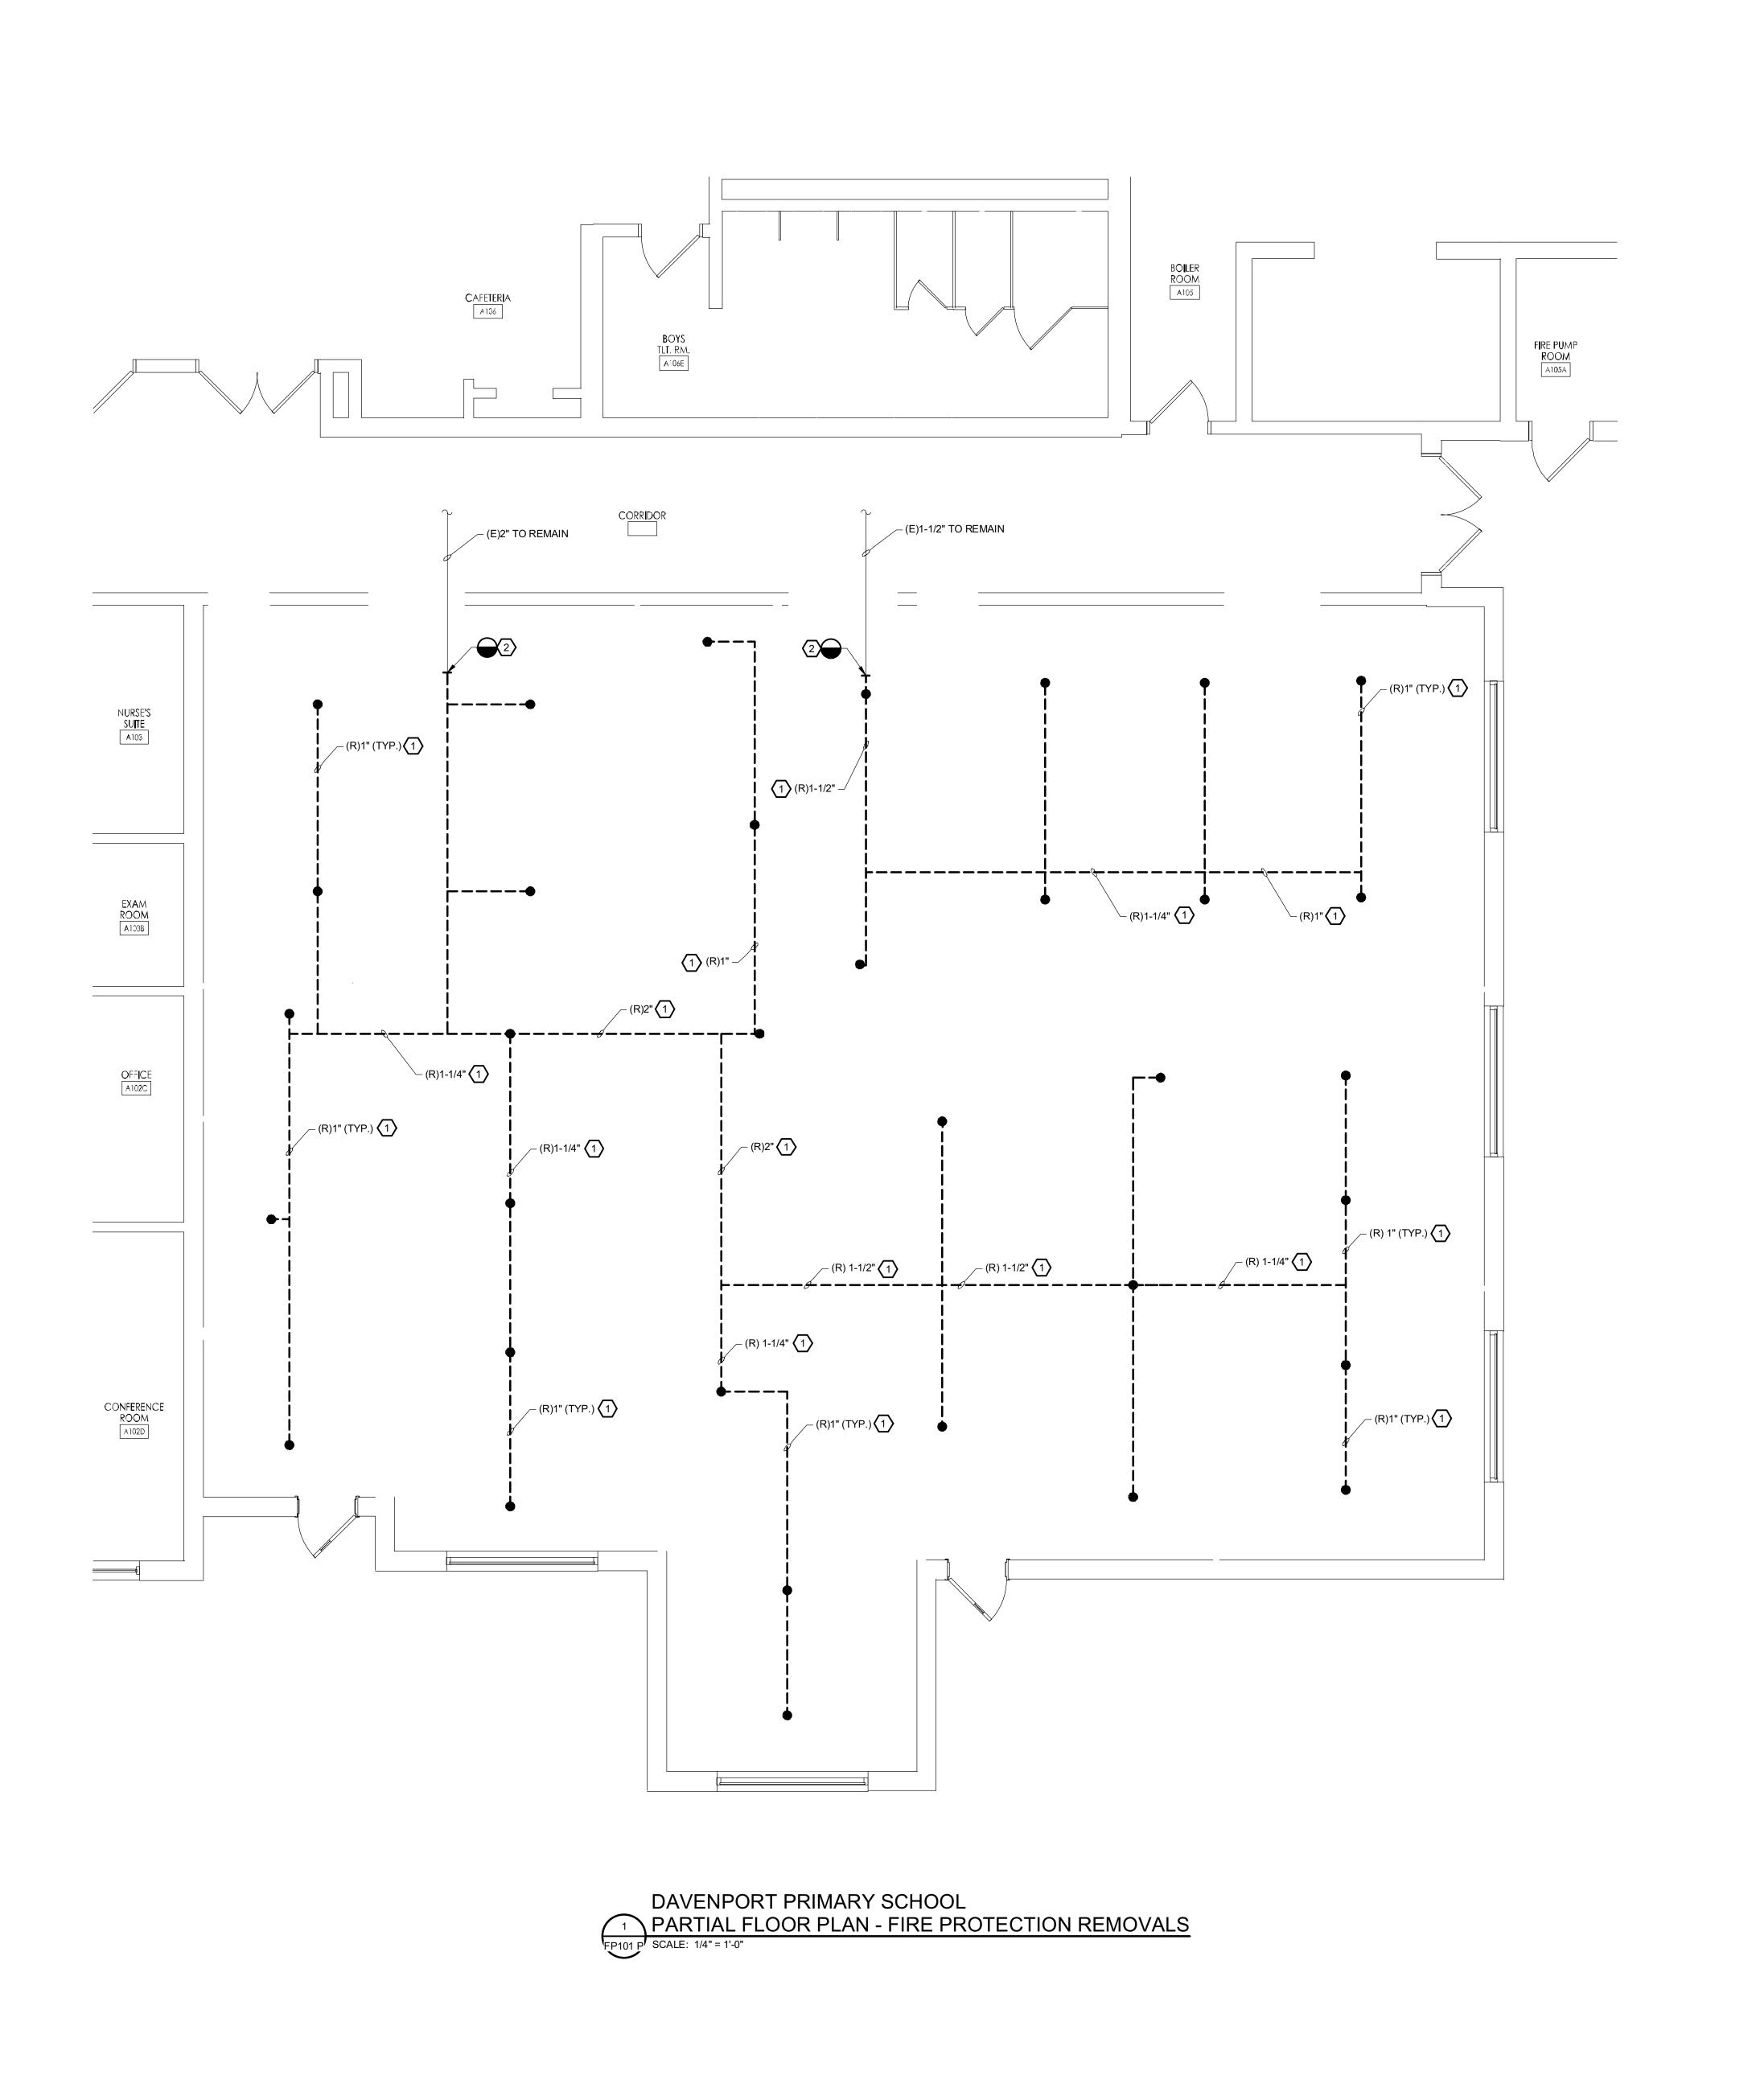

REMOVAL NOTES:

- REMOVE EXISTING SPRINKLER PIPING, INCLUDING SPRINKLERS, FITTINGS, HANGERS AND SUPPORTS, AS INDICATED.
- 2 DISCONNECT AND REMOVE EXISTING SPRINKLER PIPING BACK TO POINT INDICATED AND CAP.

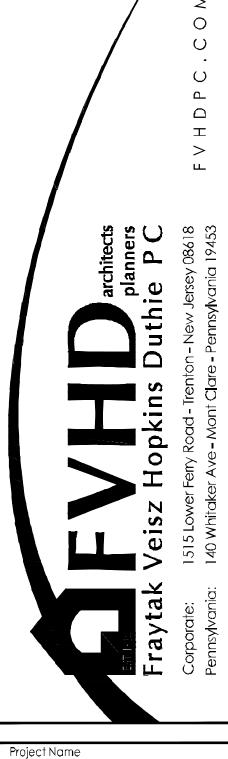

Renovations for Five (5) Pre-K Classrooms at Clayton J. Davenport School

Project Owner Name

Egg Harbor Township School District

Project Location

2501 Spruce Ave, Egg Harbor Township, NJ 08234

Project Number 5481 Project Date 11.01.2024

AS NOTED

Drawing Name PRIMARY SCHOOL FIRE PROTECTION REMOVALS -FIRST FLOOR PART**I**AL PLAN

REFERENCE DIMENSION

INDICATED DIMENSION IS MEASURED AT ONE (1) INCH IN LENGTH AND PROVIDED FOR REFERENCE/VERIFICATION ONLY.

KEY PLAN - PRIMARY

No. Date Description

Gillan & Hartmann, Inc.

MECHANICAL AND ELECTRICAL

CONSULTING ENGINEERS

610-935-0101 FAX: 610-935-7520


215-238-9510 609-347-1593 302-654-5959

gillan-hartmann.com ghmail@gillan-hartmann.com

G&H Project No. 2024-147 Drawing Number

11/01/2024 ISSUE FOR BID

ENGINEER NO. 24GE04470000 MICHAEL S. GILLAN, PE

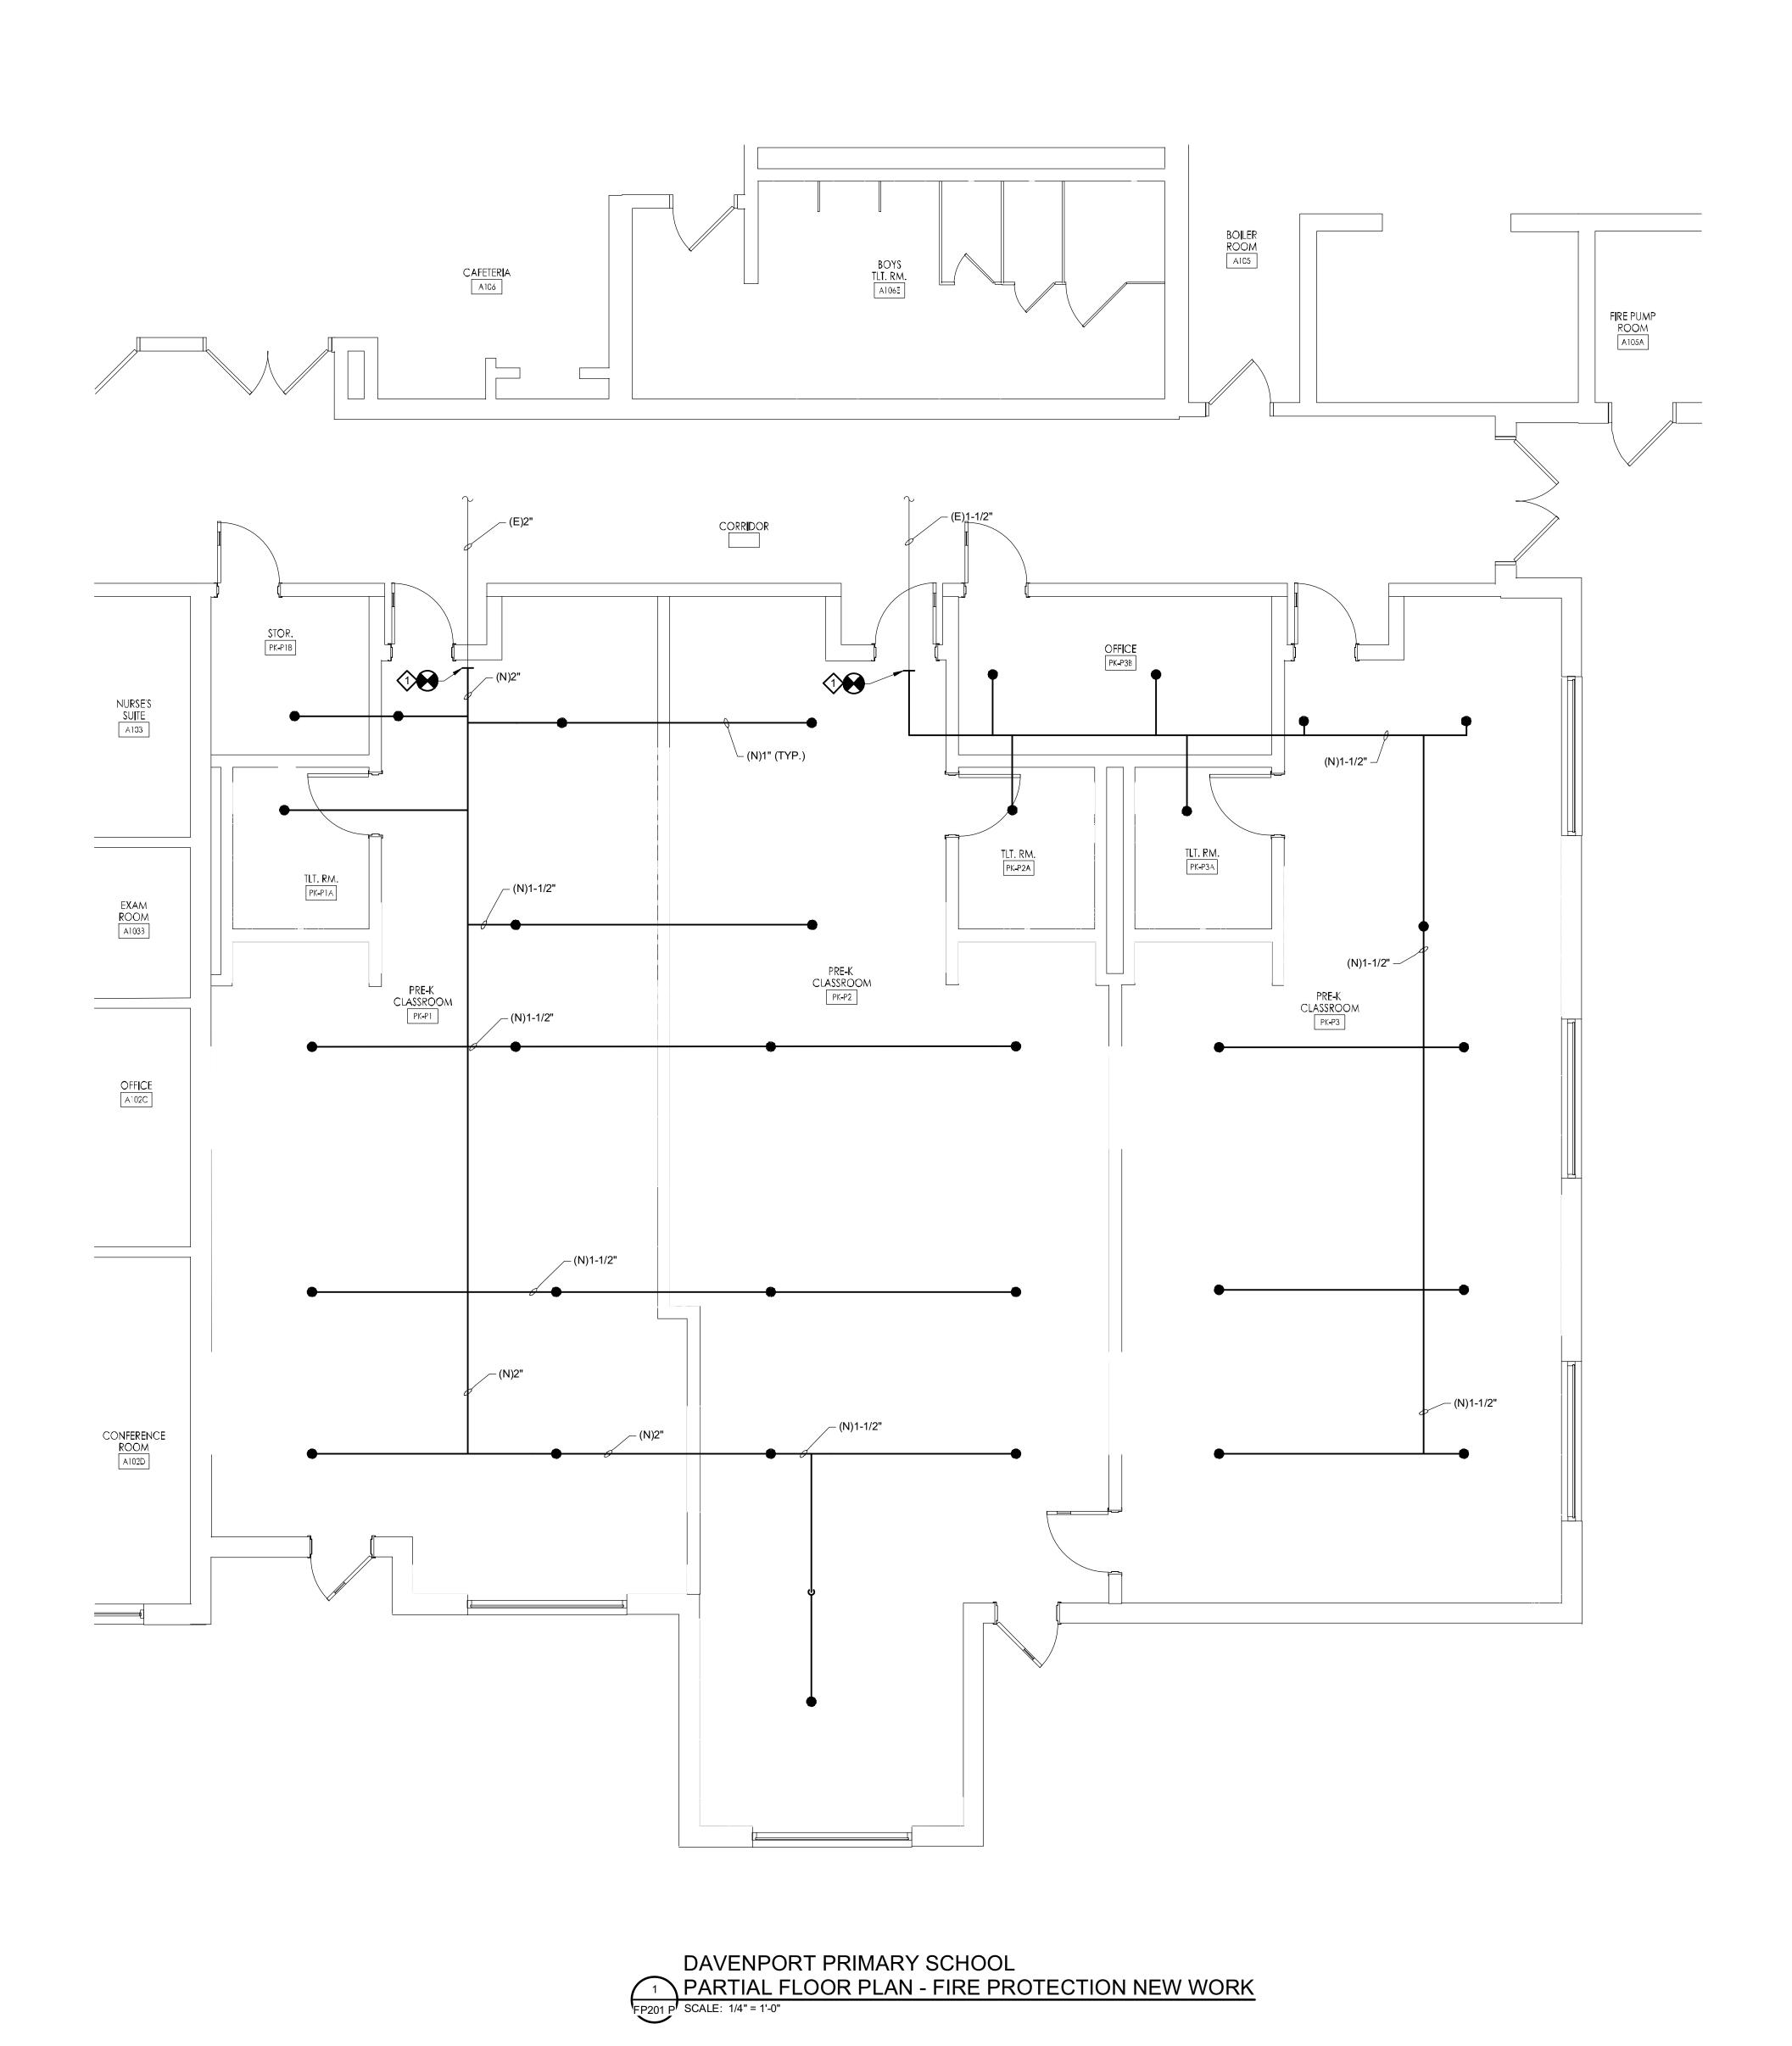



SPRINKLER SYSTEM NOTES:

- 1. PROVIDE A WET-PIPE SPRINKLER SYSTEM IN ACCORDANCE WITH THE APPLICABLE VERSION OF NFPA 13, PROVIDE ALL REQUIRED CALCULATIONS, FLOW TESTS, ETC. TO DETERMINE WATER SUPPLY FLOW RATE, PIPE SIZES, STATIC PRESSURE, RESIDUAL PRESSURE, ETC. TO DESIGN THE NEW SPRINKLER SYSTEM.
- 2. PIPE SIZES SHOWN ARE APPROXIMATE. DETERMINE FINAL PIPE SIZES THROUGH HYDRAULIC CALCULATIONS.
- 3. PROVIDE ALL DATA, DRAWINGS, CALCULATIONS, DRAWINGS, ETC. REQUIRED BY THE AUTHORITY HAVING JURISDICTION TO OBTAIN REQUIRED PERMITS.

NEW WORK NOTES:

CONNECT NEW SPRINKLER PIPING TO EXISTING AS INDICATED. PIPING LAYOUT INDICATED IS SCHEMATIC IN NATURE. PROVIDE HYDRAULIC CALCULATIONS AND SHOP DRAWINGS INDICATING REQUIRED PIPE SIZES AND ROUTING. REFER TO THE SPECIFICATIONS FOR ADDITIONAL INFORMATION.

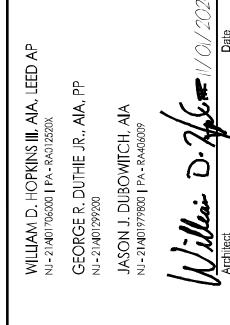

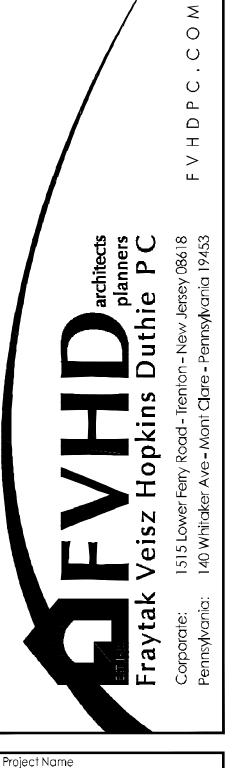

Renovations for Five (5) Pre-K Classrooms at Clayton J.
Davenport School

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Project Owner Name

Egg Harbor Township School District

Project Location

2501 Spruce Ave, Egg Harbor Township, NJ 08234

Project Number

5481

Project Date

11.01.2024

Checked By

BEK Scale

AS NOTED

Drawing Name

PRIMARY
SCHOOL FIRE
PROTECTION
NEW WORK
FIRST FLOOR
PARTIAL PLAN

FOR

Drawing Number

Gillan & Hartmann, Inc.

MECHANICAL AND ELECTRICAL

CONSULTING ENGINEERS

610-935-0101 FAX: 610-935-7520

215-238-9510 609-347-1593 302-654-5959

gillan-hartmann.com ghmail@gillan-hartmann.com

G&H Project No. 2024-147

KEY PLAN - PRIMARY


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R BID

ENGINEER
MICHAEL S. GILLAN, PE
NO. 24GE

2024 GILLAN & HARTMANN, Inc.

DATE NO. 24GE04470000 FP201

11/01/2024 ISSUE FOR B**I**D

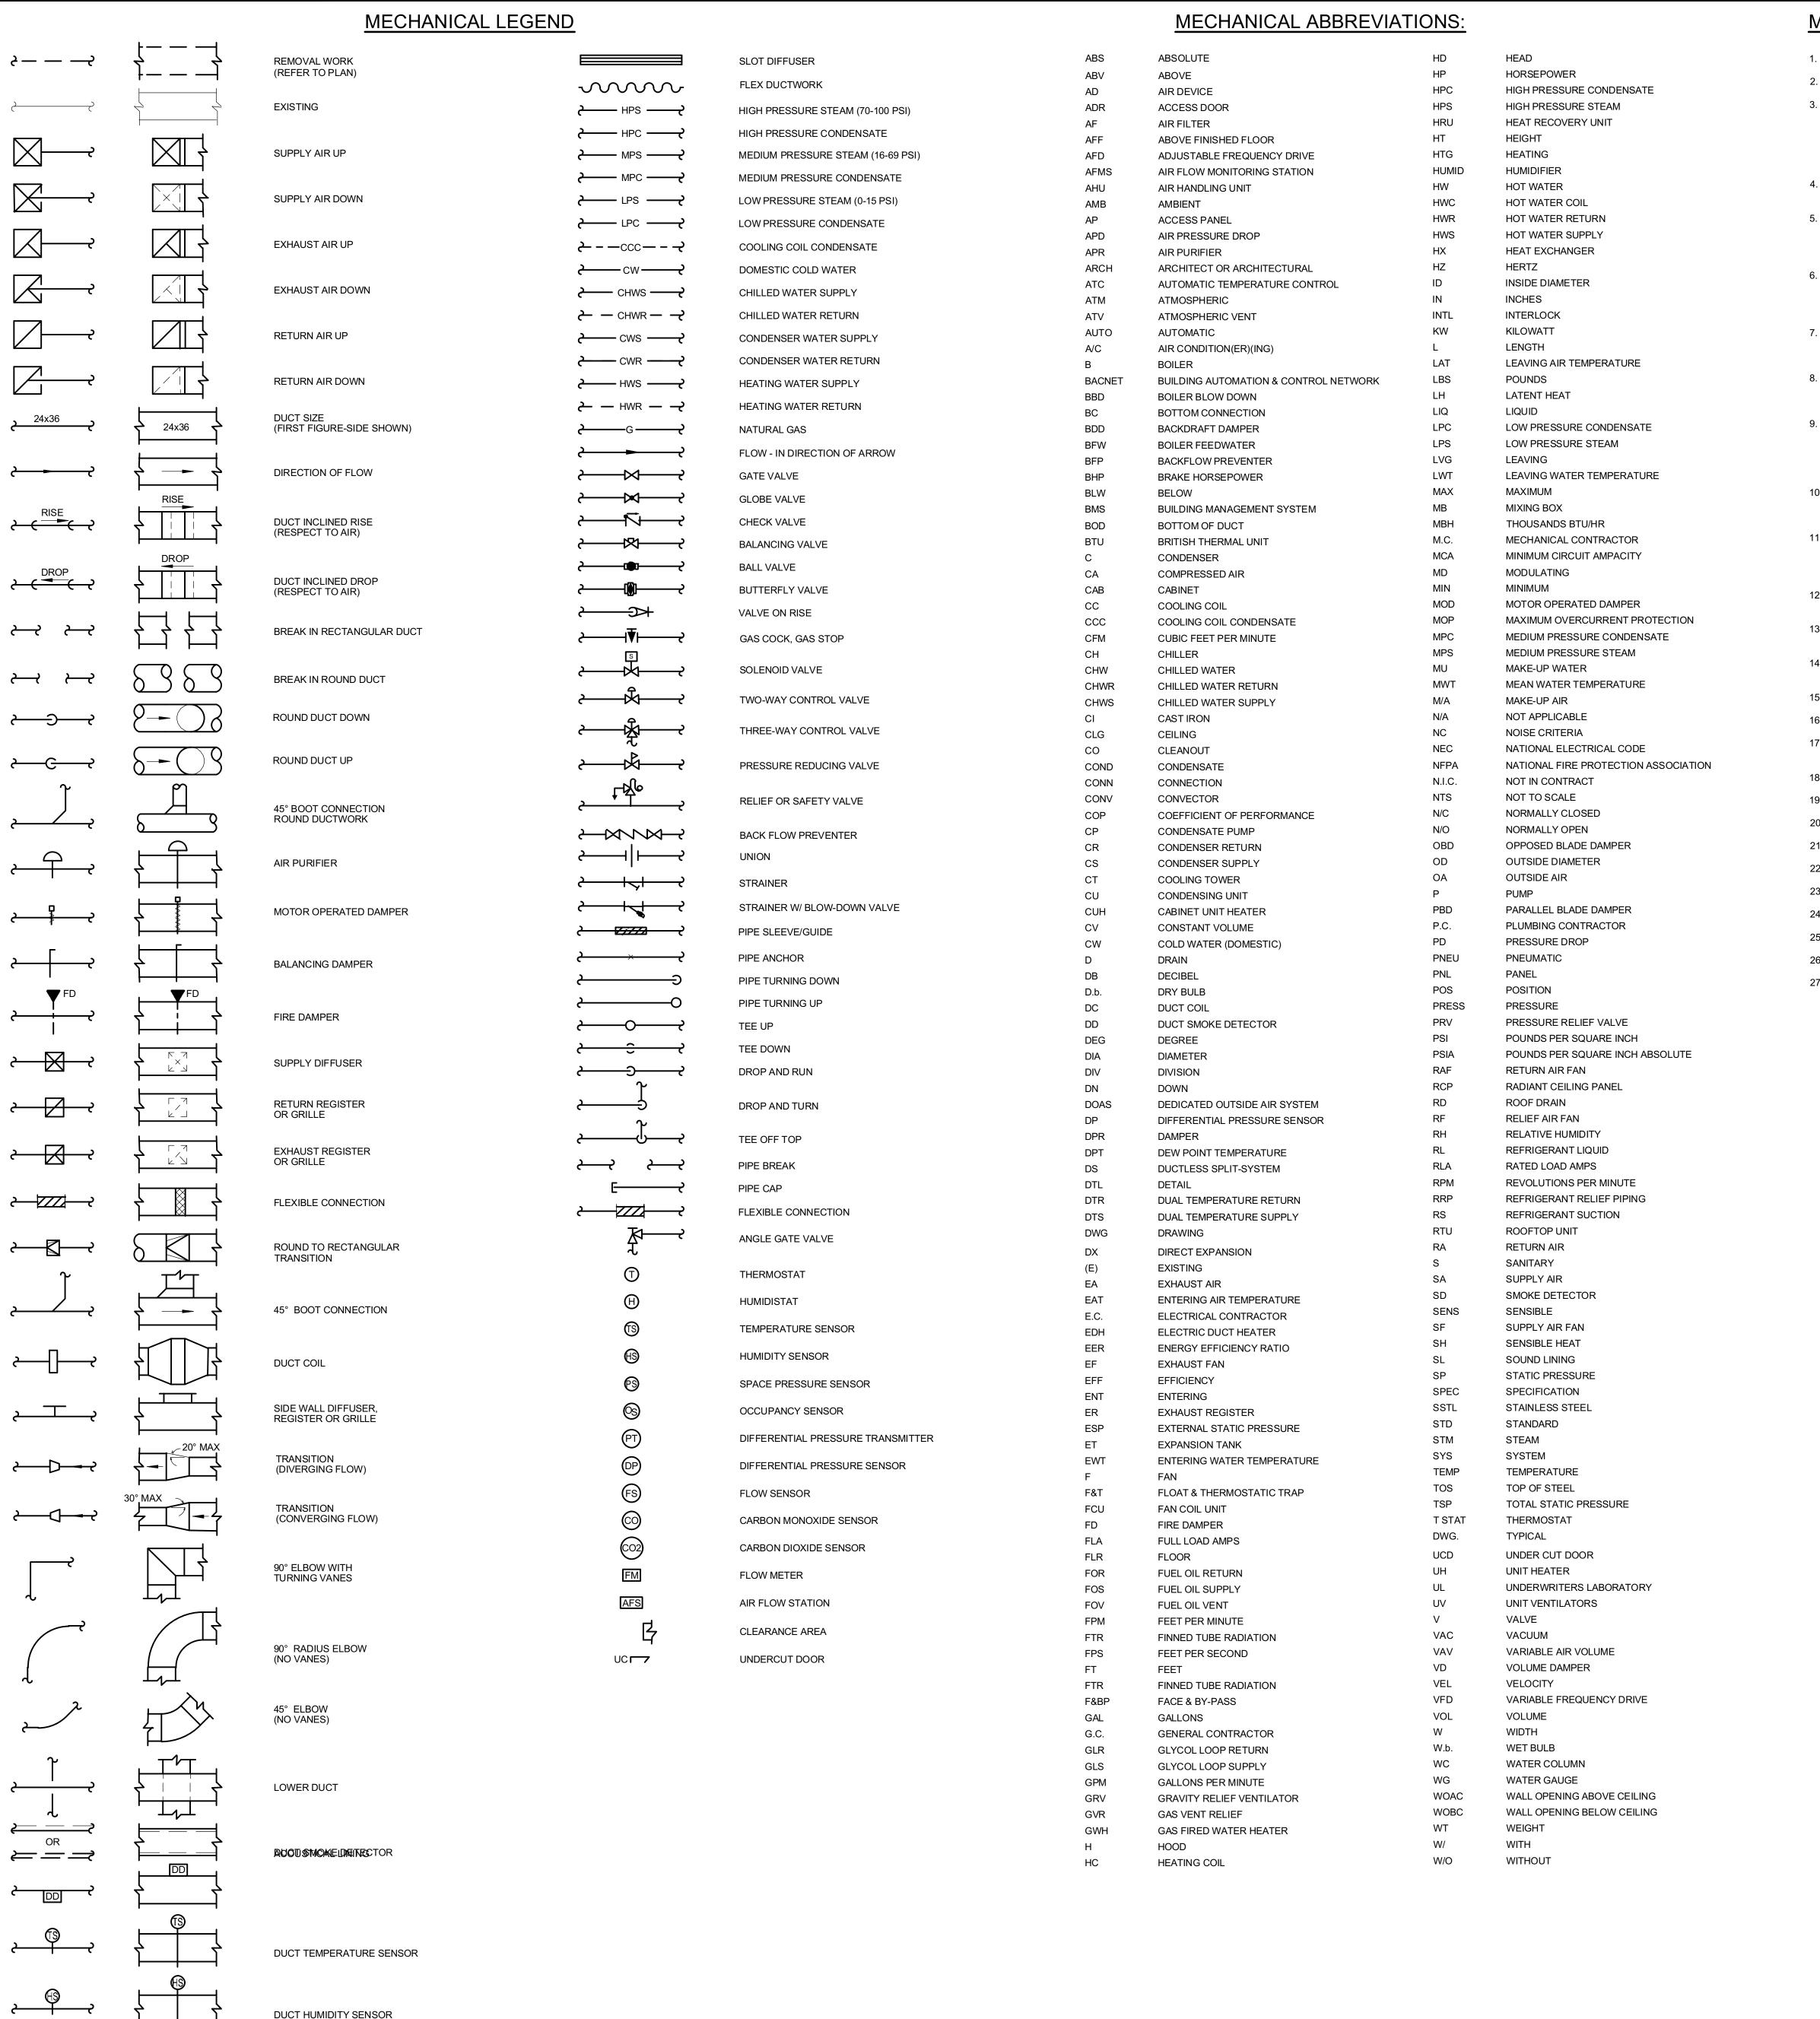


MECHANICAL GENERAL NOTES:


- 1. GENERAL NOTES APPLY TO ALL HEATING, VENTILATING AND AIR-CONDITIONING (HVAC) DRAWINGS.
- 2. THOROUGHLY COORDINATE ALL CONSTRUCTION, PRIOR TO COMMENCEMENT OF INSTALLATION OF HVAC SYSTEMS.
- THE DRAWINGS SHOW A GENERAL REPRESENTATION OF QUANTITIES AND LOCATIONS OF EXISTING HVAC COMPONENTS AND SYSTEMS, AND ARE NOT ALL INCLUSIVE. IT IS THE CONTRACTOR'S RESPONSIBILITY TO PROVIDE REMOVAL OF THE HVAC BUILDING SYSTEMS TO FULFILL THE INTENT OF THE DESIGN INDICATED BY THE CONTRACT DOCUMENTS, UNLESS OTHERWISE NOTED. REMOVAL WORK IS TO INCLUDE, BUT NOT LIMITED TO REMOVAL OF EQUIPMENT, DUCTWORK, APPARATUS, SYSTEM ACCESSORIES, PIPING, INSULATION, VALVES, DROPS, RISERS, AUXILIARY SYSTEMS, PIPING ACCESSORIES, CONTROLS, CONTROL WIRING/TUBING, CONDUITS, BASES, SUPPORTS, HANGERS AND SYSTEM
- 4. HVAC DUCTWORK LAYOUTS ARE SCHEMATIC IN NATURE. PROVIDE OFFSETS AND FITTINGS AS REQUIRED TO ACCOMMODATE FIELD CONDITIONS AT NO ADDITIONAL COST TO THE OWNER.
- ENSURE ALL WORK IS IN CONFORMANCE WITH ALL APPLICABLE BUILDING CODES. WORK SHALL BE COMPLETED IN STRICT ACCORDANCE WITH THE LATEST EDITIONS OF THE APPLICABLE CONSTRUCTION CODE, AND ALL OTHER FEDERAL, STATE, AND LOCAL AGENCY REGULATIONS HAVING JURISDICTION OVER THIS PROJECT. IN THE EVENT OF ANY DISCREPANCIES BETWEEN AGENCY REQUIREMENTS, OBSERVE THE MORE STRINGENT OF REQUIREMENTS.
- WORK SHALL COMPLY WITH THE STANDARDS OF FM GLOBAL, OR THE APPLICABLE RATING BUREAU, THE NATIONAL ELECTRIC CODE (NEC), THE AMERICAN GAS ASSOCIATION (AGA), AND THE AMERICAN SOCIETY OF HEATING, REFRIGERATION AND AIR CONDITIONING ENGINEERS (ASHRAE), OCCUPATIONAL SAFETY AND HEALTH ADMINISTRATION (OSHA), AND ALL OTHER APPLICABLE FEDERAL, STATE AND LOCAL BUILDING CODES AND THE REQUIREMENTS OF ALL PUBLIC UTILITY COMPANIES SERVING THE PROJECT SITE.
- IDENTIFICATION LABELS TO BE USED/MADE FOR ALL SYSTEMS MUST USE THE OWNER'S ROOM NUMBERS AND ROOM NAMES, NOT THE NUMBERS OR NAMES ON THE CONSTRUCTION DOCUMENTS. MEET WITH THE OWNER TO REVIEW AND CONFIRM ROOM NUMBERS AND NAMES PRIOR TO LABELING SYSTEMS.
- ALL MATERIALS EXPOSED WITHIN RETURN AIR PLENUMS SHALL BE RATED FOR USE IN PLENUMS. PROVIDE MATERIALS THAT ARE NON COMBUSTIBLE OR HAVE A FLAME SPREAD INDEX OF NOT MORE THAN 25 AND A SMOKE DEVELOPED INDEX OF NOT MORE THAN 50 WHEN TESTED IN ACCORDANCE WITH ASTM E-84.
- TEMPORARILY REMOVE AND STORE EXISTING CEILING SYSTEMS AS NECESSARY TO PERFORM WORK. PROVIDE TEMPORARY SUPPORT ONCE CEILING IS REMOVED FOR ALL CEILING MOUNTED EQUIPMENT AND DEVICES TO REMAIN AS-IS. REINSTALL CEILINGS AFTER REMOVAL AND NEW WORK HAS BEEN COMPLETED. NOTIFY OWNER OF ANY EXISTING DAMAGE TO CEILING TILE AND/OR SUPPORTS PRIOR TO REMOVAL. REPLACE ANY TILES AND/OR SUPPORTS DAMAGED AS A RESULT OF WORK. EXTENT OF CEILING REMOVAL IS AT THE CONTRACTOR'S DISCRETION.
- 10. COORDINATE THE ROOF SUPPORT SYSTEM, STRUCTURAL STEEL, CROSS BRACING, PENETRATIONS, BUILDING ACCESS, BUILDING EQUIPMENT REINFORCEMENT/SUPPORTS, ETC. TO FACILITATE THE INSTALLATION OF HVAC EQUIPMENT AND ROUTING/LOCATION OF DUCTWORK AND

CONTRACTOR TO CONFIRM EXTENT AND LOCATIONS. REFER TO ARCHITECTURAL DRAWINGS FOR ADDITIONAL REQUIREMENTS.

- 11. COORDINATE AND FIELD VERIFY ALL DIMENSIONS, SIZES, CLEARANCES, AND FINAL PLACEMENT OF ALL HVAC, PLUMBING, AND ELECTRICAL: EQUIPMENT, FIXTURES AND ACCESSORIES WITH THE RESPECTIVE TRADE CONTRACTORS PRIOR TO ROUGH IN. WHEN CONFLICTS ARISE, MAKE ANY NECESSARY CHANGES TO ROUTING OF PIPING AND DUCTWORK WITHOUT COMPROMISING THE INTEGRITY AND PERFORMANCE OF THE SYSTEMS, AND AT NO ADDITIONAL COST TO THE OWNER.
- 12. INSTALL ALL EQUIPMENT TO MAINTAIN ADEQUATE CLEARANCES PER MANUFACTURER'S REQUIREMENTS. PROVIDE OFFSETS AS NECESSARY TO
- 13. ALL EQUIPMENT AND OR MATERIAL BEING REMOVED IS THE RESPONSIBILITY OF THE CONTRACTOR AND WILL BE RETAINED, DISPOSED OF, AND REMOVED FROM THE SITE AT THE DIRECTION OF THE OWNER.
- 14. ALL PIPING AND CONTROL WIRING TO BE CONCEALED IN WALLS, CEILINGS AND CHASES. FOR WALLS WHERE WIRING CANNOT BE CONCEALED IN WALL, ROUTE IN WIREMOLD. COLOR TO MATCH EXISTING WALL.
- 15. EQUIPMENT INSULATION SHALL BE INSTALLED AS NOT TO CONCEAL THE EQUIPMENT NAME PLATE.
- 16. PROVIDE FIRE DAMPERS FOR ALL DUCT PENETRATIONS THROUGH FIRE RATED WALLS.
- 17. PROVIDE HANGERS AND SUPPORTS PER THE SPECIFICATIONS FOR ALL DUCTWORK, PIPING AND HVAC EQUIPMENT TO FACILITATE
- 18. SCHEDULE AND OBTAIN APPROVAL FOR ALL SYSTEM SHUTDOWNS WITH THE OWNER PRIOR TO COMMENCING WITH REMOVAL AND NEW WORK. 19. COORDINATE DE-ENERGIZING AND ENERGIZING EQUIPMENT WITH ELECTRICAL CONTRACTOR.
- 20. COORDINATE REQUIREMENTS FOR LOSS OF PHASE PROTECTION ON ALL THREE PHASE MOTORS SERVING EQUIPMENT ON THIS CONTRACT.
- 21. PROVIDE VIBRATION ISOLATION DEVICES FOR ALL HVAC EQUIPMENT AND SYSTEMS, REFER TO DETAIL SHEET.
- 22. FLEXIBLE DUCTWORK SHALL NOT EXCEED 5'-0" IN LENGTH. FLEXIBLE DUCTWORK SHALL BE INSTALLED WITH SMOOTH RADIUS ELBOWS.
- 23. ASPECT RATIO OF DUCTWORK SIZING CAN BE CHANGED TO SUIT FIELD CONDITIONS AT THE APPROVAL OF THE OWNER'S REPRESENTATIVE.
- 24. PROVIDE FLEXIBLE CONNECTIONS AT ALL DUCTWORK TO EQUIPMENT CONNECTIONS.
- 25. PROVIDE TURNING VANES IN ALL DUCT ELBOWS.
- 26. PROVIDE VOLUME DAMPERS AT BOOT CONNECTIONS AND BRANCHES OF MAINS FOR ALL SUPPLY, RETURN, AND EXHAUST AIR SYSTEMS.
- 27. DUCTWORK DIMENSIONS INDICATE INTERNAL CLEAR DIMENSIONS.

STANDARD SYMBOLS

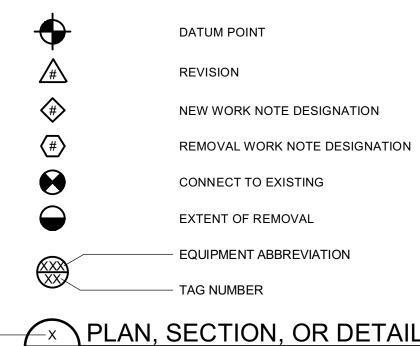

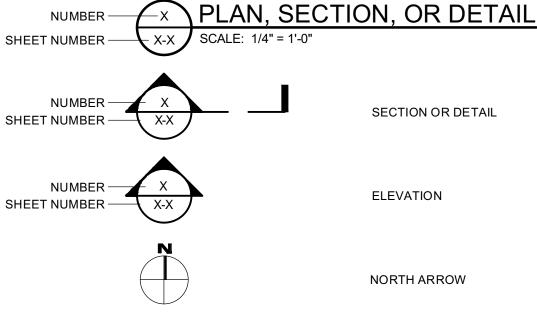

AIR DEVICE NOTE

DIFFUSER TYPE (SEE SCHEDULE) - 6x6 AIR DEVICE SIZE AIRFLOW CFM

REFERENCE DIMENSION

INDICATED DIMENSION IS MEASURED AT ONE (1) INCH IN LENGTH AND PROVIDED FOR REFERENCE/VERIFICATION ONLY.



11/01/2024 ISSUE FOR BID

ENGINEER MICHAEL S. GILLAN, PE NO. 24GE04470000

2024 GILLAN & HARTMANN, Inc.

Project Owner Name

at Clayton.

Egg Harbor Township School District

Renovations for Five

(5) Pre-K Classrooms

Davenport School

Project Location

2501 Spruce Ave, Egg Harbor Township, NJ 08234

Project Number Project Date 11.01.2024 Checked By


Scale AS NOTED

Drawn By

Drawing Name **HVAC LEGEND** ABBREVIATIONS, AND GENERAL NOTES


No. Date Description

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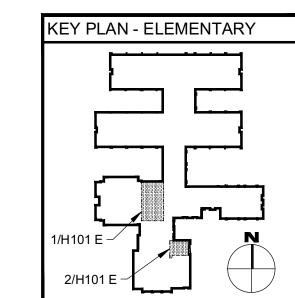


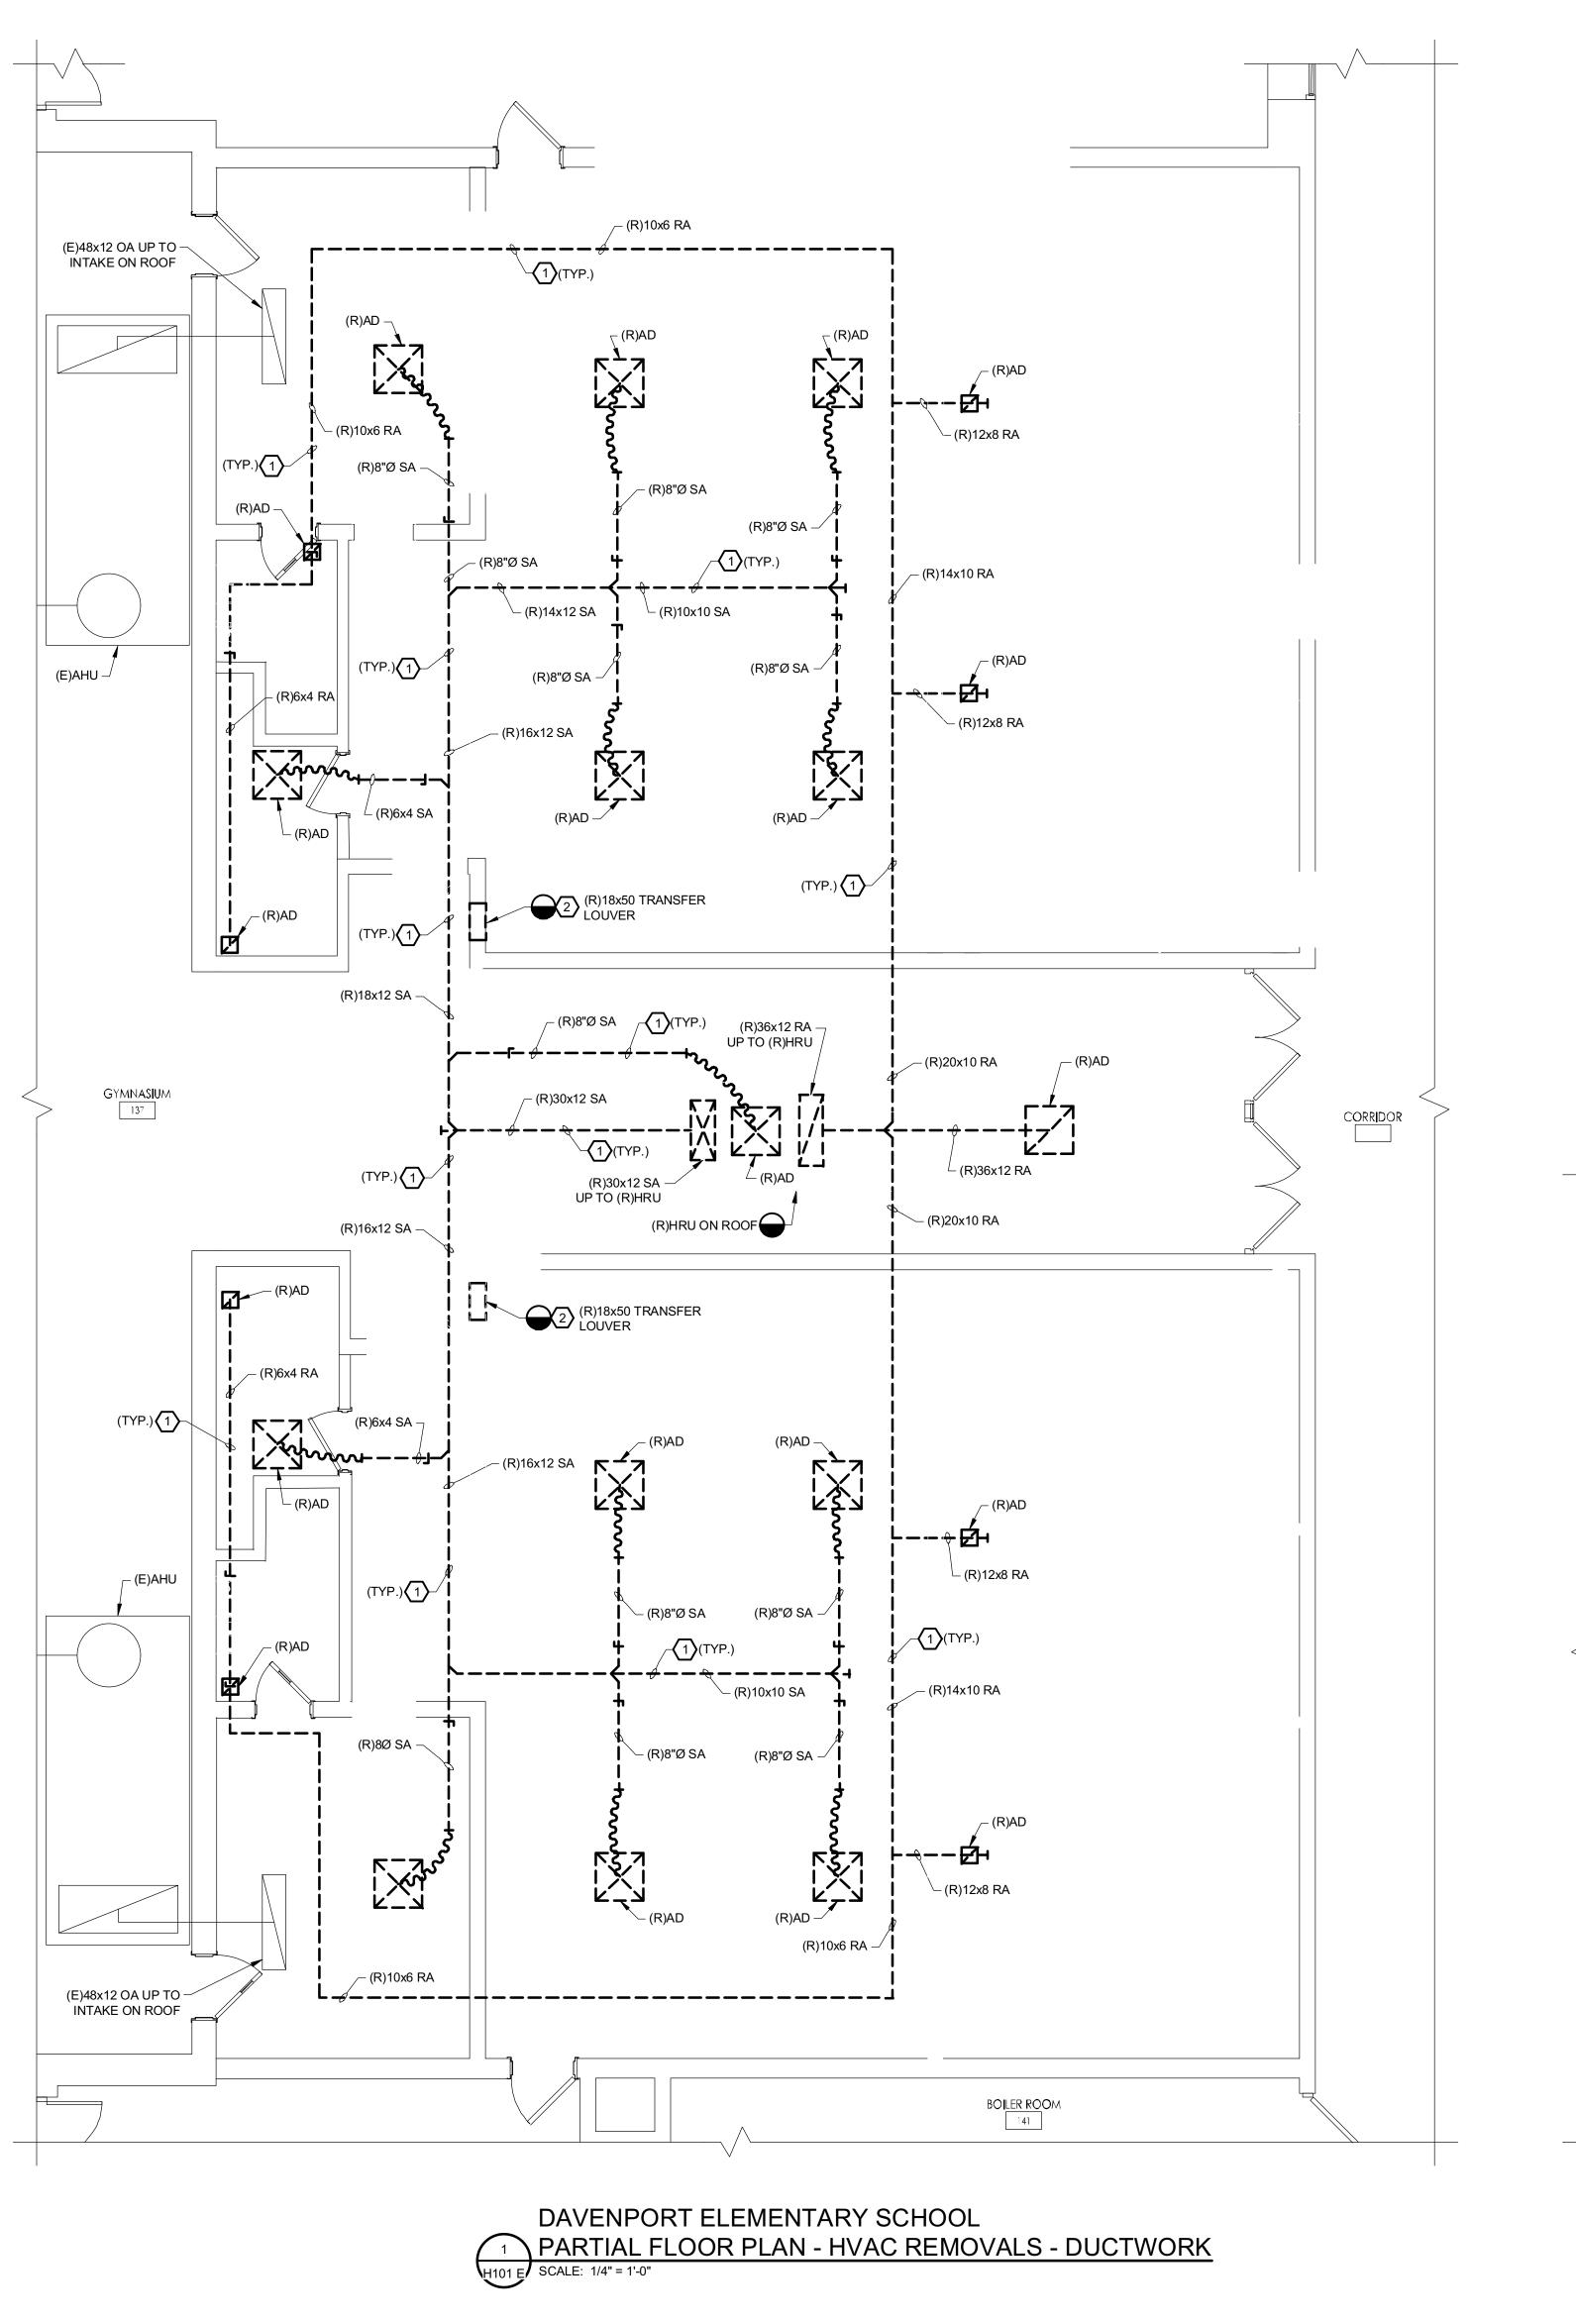- REMOVE EXISTING AIR DEVICES, FLEXIBLE DUCTWORK, RIGID DUCTWORK, AND ALL ASSOCIATED HANGERS AND ANCHORS AS INDICATED BY DASHED LINES.
- REMOVE EXISTING TRANSFER AIR GRILLE, SLEEVE, DUCTWORK, AND ALL ASSOCIATED APPURTENANCES. PATCH PENETRATIONS TO MATCH EXISTING CONSTRUCTION AND RATING.
- 3 REMOVE EXISTING FLOOR MOUNTED UNIT VENTILATOR IN ITS ENTIRETY INCLUDING SUPPORTS, INSULATION, DAMPERS, AND ALL ASSOCIATED APPURTENANCES. LOUVER AND WALL SLEEVE TO REMAIN. PROVIDE ALUMINUM SHEET ON INSIDE OF EXISTING LOUVER. SECURE AND CAULK WATERTIGHT. PROVIDE 4 INCHES OF RIGID INSULATION AND COVER WALL PENETRATION WITH SHEET METAL COVER PAINTED TO MATCH ADJACENT WALL. PROVIDE FLOOR COVERING AND COVE MOLDING TO MATCH EXISTING.



DAVENPORT ELEMENTARY SCHOOL PARTIAL FLOOR PLAN - HVAC REMOVALS - DUCTWORK

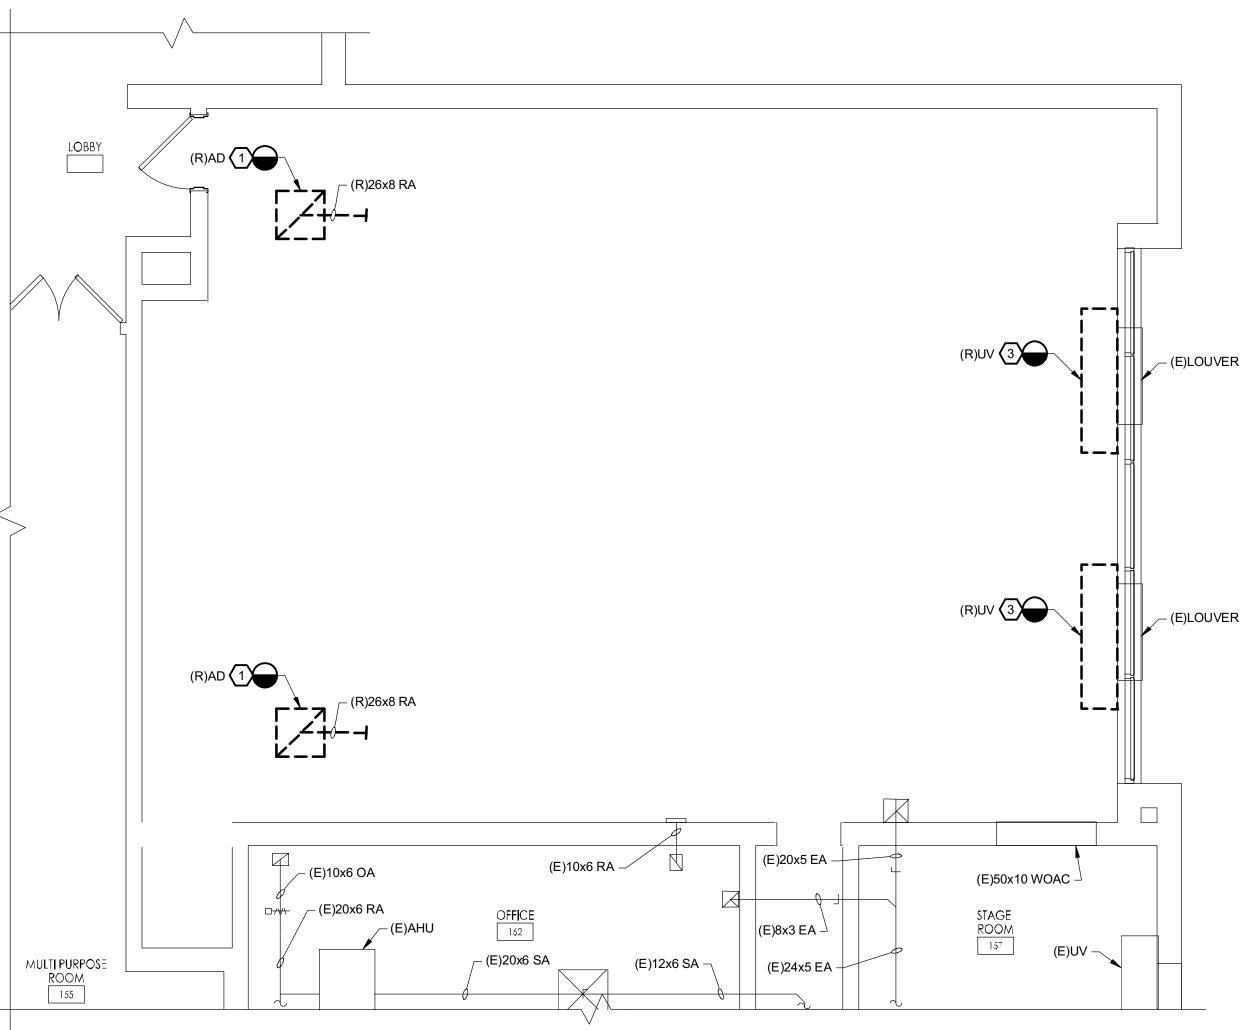SCALE: 1/4" = 1'-0"



REFERENCE DIMENSION

INDICATED DIMENSION IS MEASURED AT ONE (1) INCH IN LENGTH AND PROVIDED FOR REFERENCE/VERIFICATION ONLY.



11/01/2024 ISSUE FOR BID

DATE ENGINEER NO. 24GE04470000 MICHAEL S. GILLAN, PE 2024 GILLAN & HARTMANN, Inc.

Renovations for Five (5) Pre-K Classrooms at Clayton J. Davenport School

Project Owner Name

Egg Harbor Township School District

Project Location

2501 Spruce Ave, Egg Harbor Township, NJ 08234

Project Number 11.01.2024


Drawn By

AS NOTED

Drawing Name ELEMENTARY SCHOOL HVAC REMOVALS -DUCTWORK -FIRST FLOOR PARTIAL PLAN

No. Date Description


Drawing Number H101 E

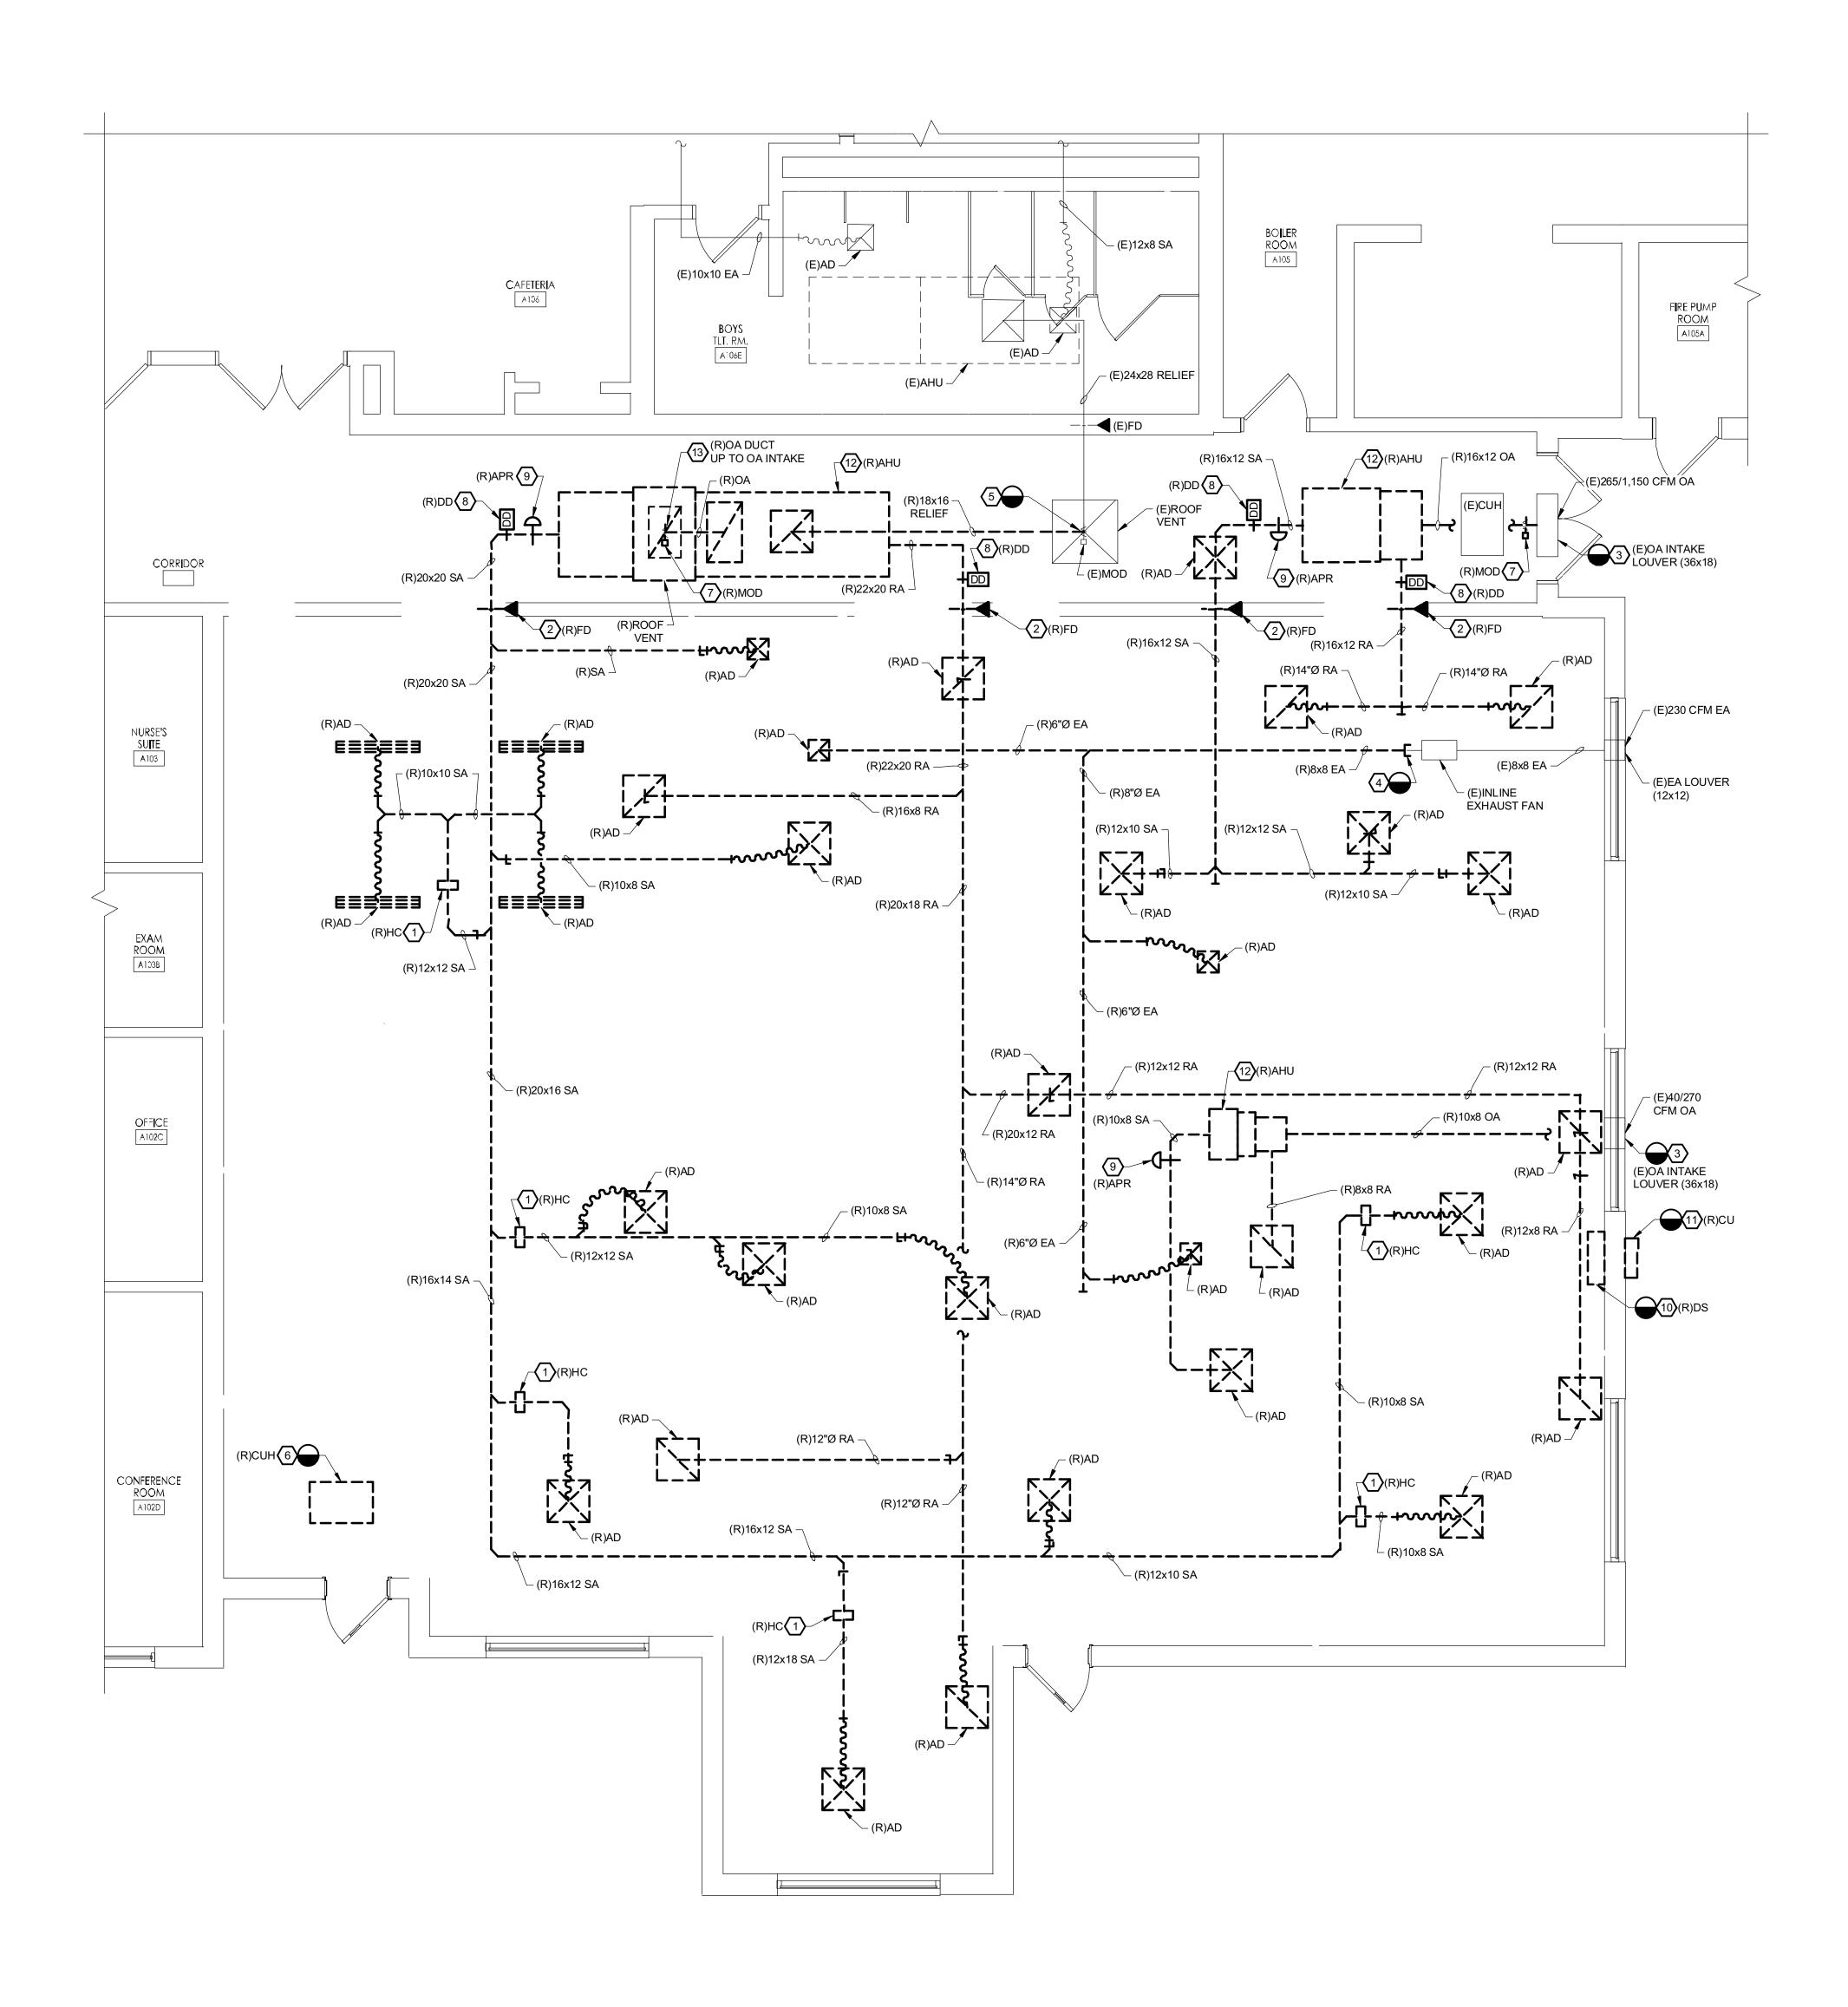

DAVENPORT PRIMARY SCHOOL PARTIAL FLOOR PLAN - HVAC REMOVALS - DUCTWORK H101 P SCALE: 1/4" = 1'-0"

REMOVAL NOTES:

- REMOVE EXISTING ABOVE CEILING MOUNTED HEATING COIL AND DUCTWORK, INCLUDING HANGERS AND
- (2) REMOVE EXISTING FIRE DAMPER AND DUCTWORK INCLUDING SLEEVES AND ALL ASSOCIATED APPURTENANCES. PATCH REMAINING WALL OPENING FLUSH TO WALL FINISH AND MATCH EXISTING WALL FIRE RATING. REFER TO ARCHITECTURAL PLANS FOR ADDITIONAL REQUIREMENTS.
- REMOVE EXISTING OUTSIDE AIR DUCTWORK INCLUDING SLEEVES, DAMPERS, ACTUATORS, WIRING/PNEUMATIC TUBING, SUPPORTS, AND ALL ASSOCIATED APPURTENANCES. PATCH EXTERIOR WALL AT COMPLETION OF REMOVAL WORK. PROVIDE 4" BOARD INSULATION AND SHEET METAL BLANKING TO COVER REMAINING EXTERIOR LOUVER. PATCH REMAINING WALL OPENING FLUSH TO INTERIOR WALL FINISH AND MATCH EXISTING CONSTRUCTION, INSULATION, AND MATERIALS. SEAL WALL PATCHING TO MAKE WEATHERTIGHT. EXISTING EXTERIOR GRILLE TO REMAIN, NO EXTERIOR BRICK WORK TO OCCUR.
- REMOVE EXISTING AIR DEVICE, ASSOCIATED FLEXIBLE DUCTWORK, RIGID DUCTWORK, ALL HANGERS AND ANCHORS BACK TO POINT INDICATED. RETAIN DUCTWORK CONNECTION FOR RE-USE UNDER NEW WORK.
- REMOVE EXISTING ASSOCIATED RELIEF DUCTWORK, HANGERS AND ANCHORS BACK TO POINT INDICATED. CAP DUCTWORK, NOT RE-USED UNDER NEW WORK.
- (6) REMOVE EXISTING CEILING MOUNTED CABINET UNIT HEATER AND ALL ASSOCIATED HANGERS AND ANCHORS. REFER TO HVAC PIPING REMOVAL DRAWINGS FOR ADDITIONAL REQUIREMENTS. PROVIDE NEW CEILING COMPONENTS TO MATCH EXISTING CONSTRUCTION, FINISH, AND MATERIALS. REFER TO ARCHITECTURAL PLANS FOR ADDITIONAL REQUIREMENTS. RETAIN BUILDING CONTROLS CONTRACTOR/VENDOR FOR REMOVAL OF UNIT CONTROLS AND ALL ASSOCIATED CONTROL WIRING.
- (7) REMOVE EXISTING MOTOR OPERATED DAMPER INCLUDING ALL HANGERS AND ANCHORS. RETAIN BUILDING CONTROLS CONTRACTOR/VENDOR FOR REMOVAL OF UNIT CONTROLS AND ALL ASSOCIATED CONTROL WIRING.
- 8 REMOVE EXISTING DUCT MOUNTED SMOKE DETECTOR INCLUDING ALL HANGERS AND ANCHORS. RETAIN BUILDING CONTROLS CONTRACTOR/VENDOR FOR REMOVAL OF UNIT CONTROLS AND ALL ASSOCIATED CONTROL
- 9 REMOVE EXISTING DUCT MOUNTED AIR PURIFIER INCLUDING ALL HANGERS AND ANCHORS. RETAIN BUILDING CONTROLS CONTRACTOR/VENDOR FOR REMOVAL OF UNIT CONTROLS AND ALL ASSOCIATED CONTROL WIRING.
- (10) REMOVE EXISTING WALL MOUNTED DUCTLESS SPLIT INDOOR EVAPORATOR UNIT IN ITS ENTIRETY, INCLUDING SUPPORTS, AND ALL ASSOCIATED APPURTENANCES. REFER TO HVAC PIPING REMOVAL DRAWINGS FOR ADDITIONAL REQUIREMENTS. RETAIN BUILDING CONTROLS CONTRACTOR/VENDOR FOR REMOVAL OF UNIT CONTROLS AND ALL ASSOCIATED CONTROL WIRING. PATCH AND REPAIR FINISHES TO MATCH EXISTING.
- REMOVE EXISTING OUTDOOR WALL MOUNTED CONDENSING UNIT INCLUDING ALL SUPPORTS/SUPPORT RAILS, AND ALL ASSOCIATED APPURTENANCES. REFER TO HVAC PIPING REMOVAL DRAWINGS FOR ADDITIONAL REQUIREMENTS. RETAIN BUILDING CONTROLS CONTRACTOR/VENDOR FOR REMOVAL OF UNIT CONTROLS AND ALL ASSOCIATED CONTROL WIRING. PATCH AND REPAIR FINISHES TO MATCH EXISTING.
- $\langle 12 \rangle$ REMOVE EXISTING DECK SUSPENDED AIR HANDLING UNIT IN ITS ENTIRETY INCLUDING RIGID DUCTWORK, FLEXIBLE DUCTWORK, AIR DEVICES, HANGERS, SUPPORTS, BASE RAILS, AND ALL ASSOCIATED APPURTENANCES. REFER TO HVAC PIPING REMOVAL DRAWINGS FOR ADDITIONAL REQUIREMENTS. RETAIN BUILDING CONTROLS CONTRACTOR/VENDOR FOR REMOVAL OF UNIT CONTROLS AND ALL ASSOCIATED CONTROL WIRING. PATCH AND PAINT AS REQUIRED.
- REMOVE EXISTING OUTSIDE AIR INTAKE ON ROOF INCLUDING SLEEVES, DAMPERS, ACTUATORS, WIRING/PNEUMATIC TUBING, SUPPORTS, AND ALL ASSOCIATED APPURTENANCES. RETAIN EXISTING ROOF CURB AND PROVIDE A CAP.

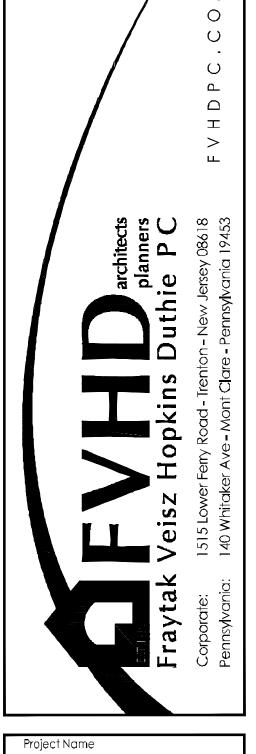

Renovations for Five (5) Pre-K Classrooms at Clayton J. Davenport School

Project Owner Name

Egg Harbor Township School District

Project Location

2501 Spruce Ave, Egg Harbor Township, NJ 08234

11.01.2024

AS NOTED

Drawing Name PRIMARY SCHOOL HVAC REMOVALS -DUCTWORK -FIRST FLOOR PARTIAL PLAN

REFERENCE DIMENSION

No. Date Description INDICATED DIMENSION IS MEASURED AT ONE (1) INCH IN LENGTH AND PROVIDED FOR

Gillan & Hartmann, Inc.

MECHANICAL AND ELECTRICAL

CONSULTING ENGINEERS 610-935-0101 FAX: 610-935-7520 215-238-9510 609-347-1593 302-654-5959 gillan-hartmann.com ghmail@gillan-hartmann.com G&H Project No. 2024-147

Drawing Number


ENGINEER NO. 24GE04470000

REFERENCE/VERIFICATION ONLY.

KEY PLAN - PRIMARY


11/01/2024 ISSUE FOR BID

MICHAEL S. GILLAN, PE 2024 GILLAN & HARTMANN, Inc.

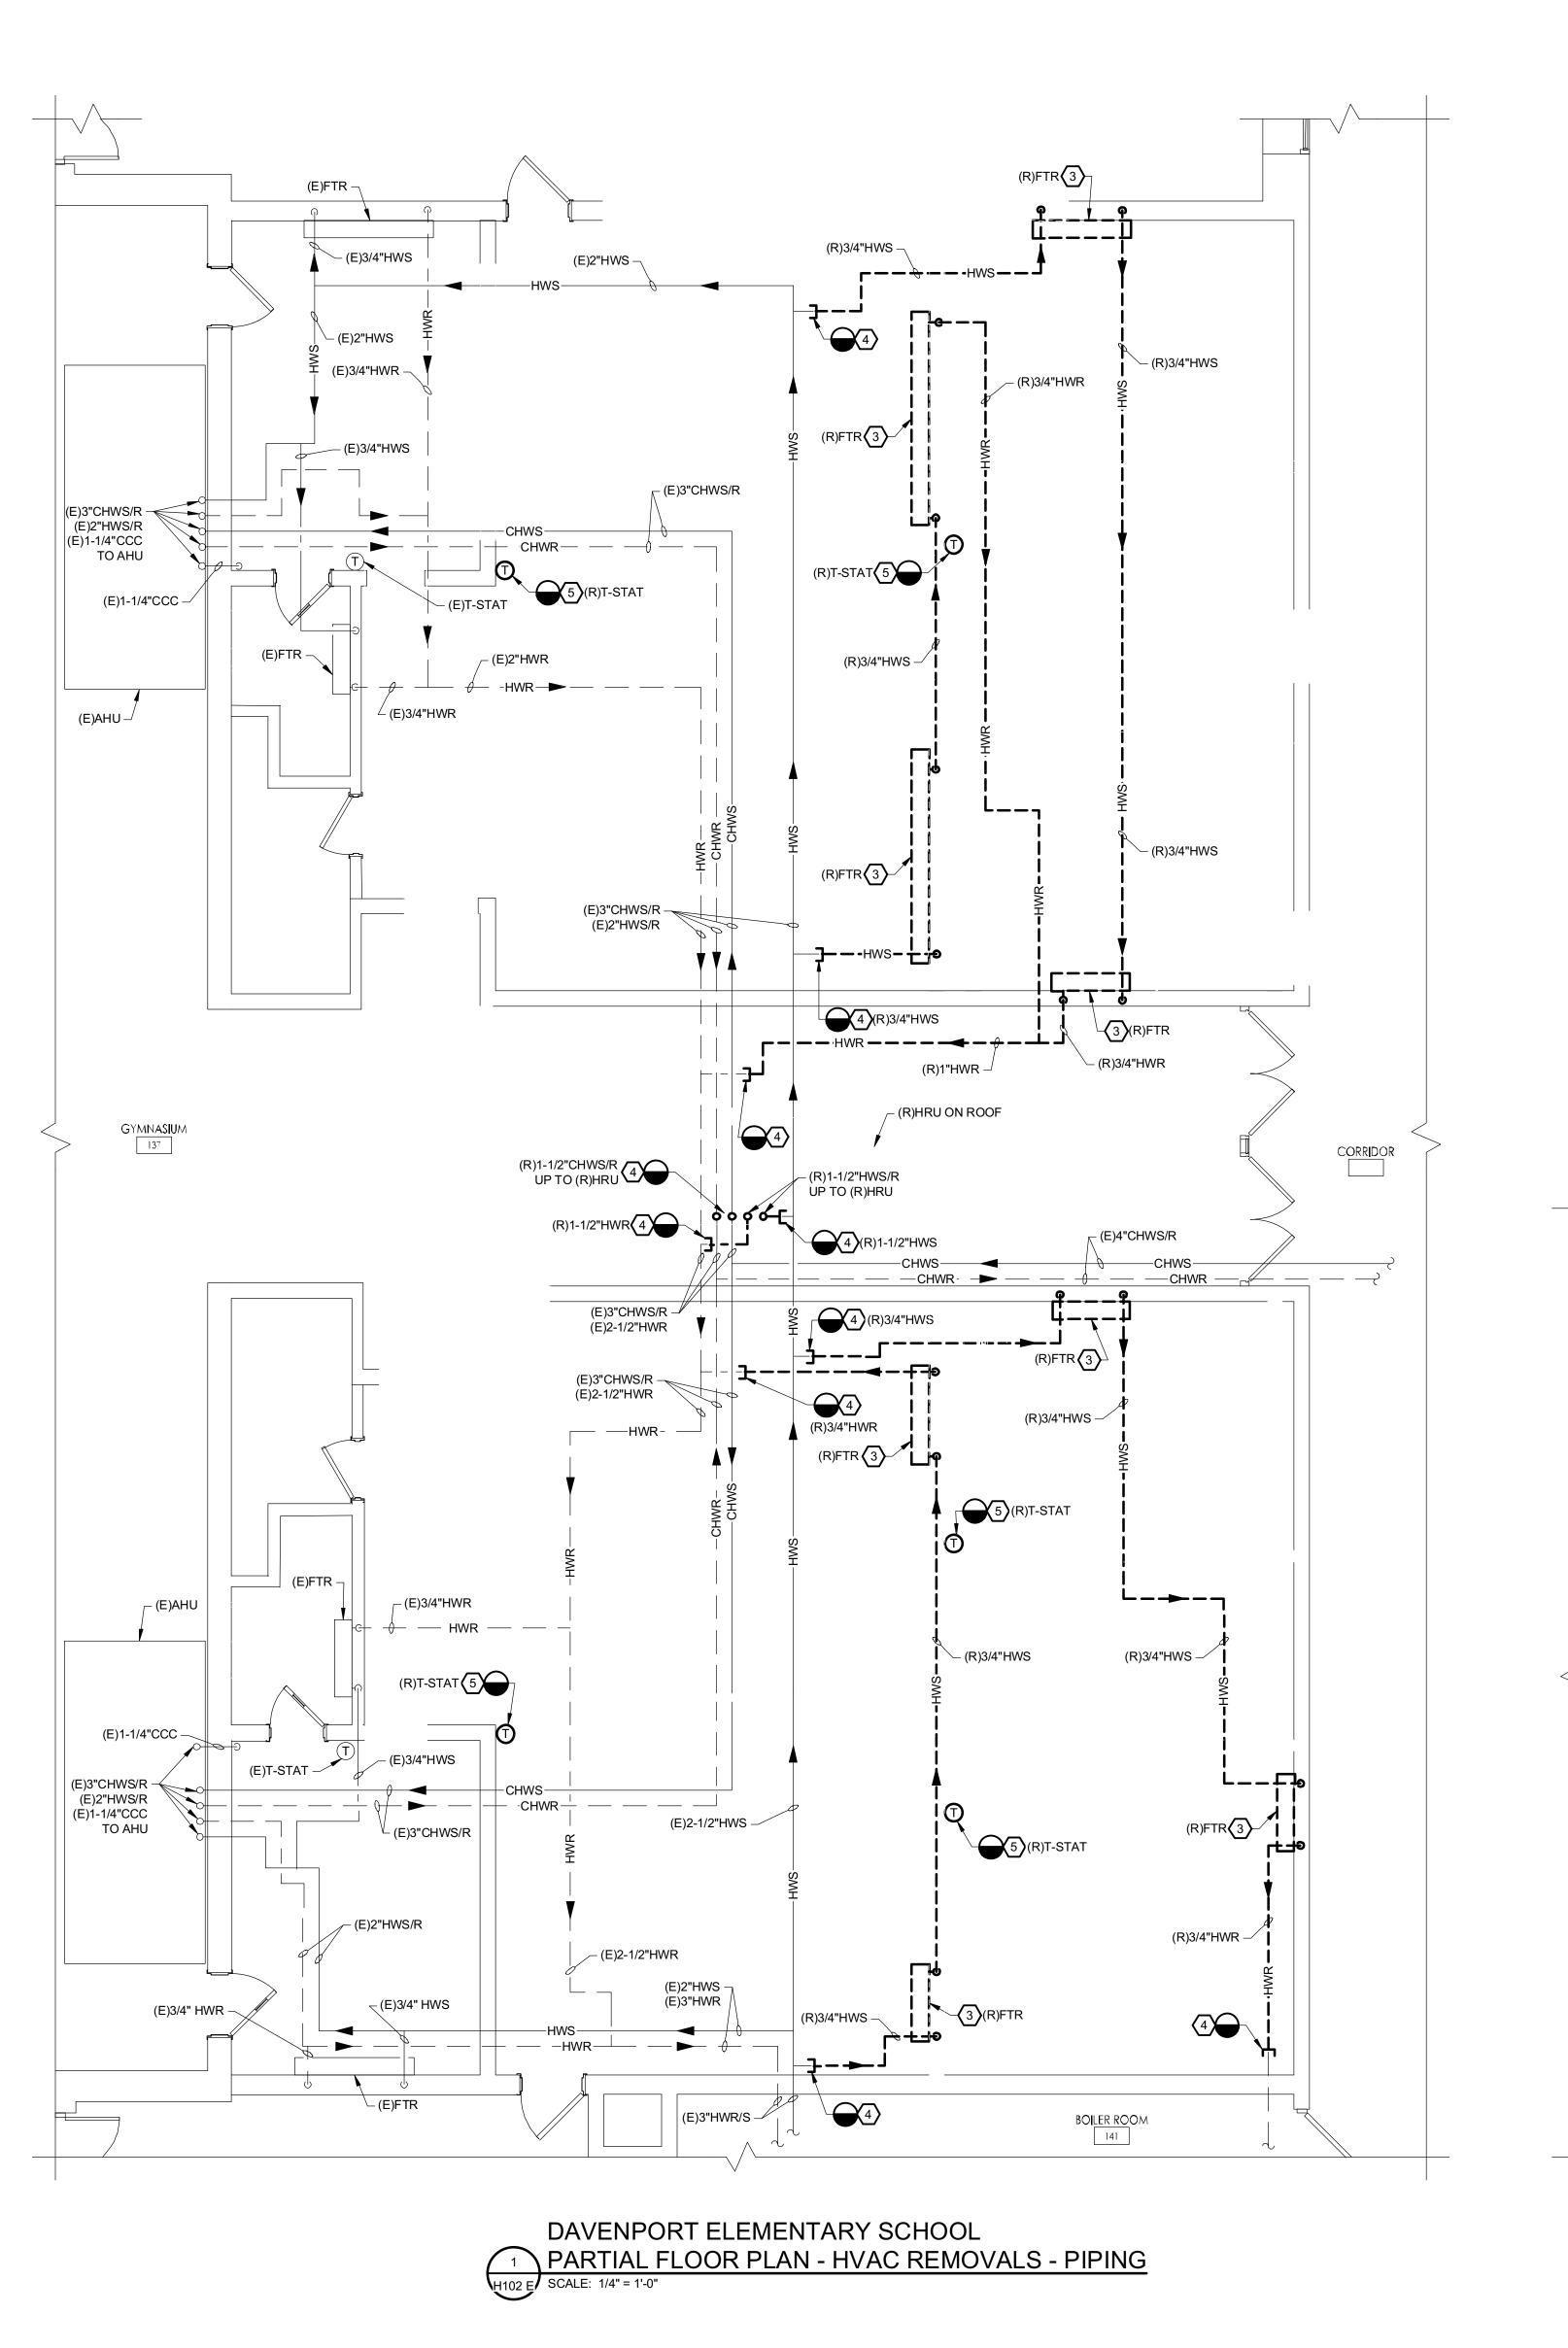

REMOVAL NOTES:

- REMOVE PIPING ENCLOSURE/COVER MOUNTED TO WALL INCLUDING ALL ASSOCIATED PIPING, INSULATION, HANGERS AND ANCHORS. PATCH WALL AND PAINT AT COMPLETION OF REMOVAL TO MATCH EXISTING CONSTRUCTION AND MATERIALS. REFER TO ARCHITECTURAL PLANS FOR ADDITIONAL REQUIREMENTS.
- REMOVE EXISTING CONDENSATE PIPING AND ALL ASSOCIATED INSULATION, SUPPORTS, HANGERS, AND APPURTENANCES. PATCH EXTERIOR WALL WATERTIGHT TO MATCH EXISTING CONSTRUCTION AND FINISH.
- REMOVE FIN TUBE RADIATION AND ALL ASSOCIATED INSULATION, SUPPORTS, CONTROLS, ENCLOSURE, PIPING, VALVES, AND APPURTENANCES. PATCH WALL AND PAINT AT COMPLETION OF REMOVAL TO MATCH EXISTING CONSTRUCTION AND MATERIALS.
- REMOVE PIPING BACK TO LOCATION INDICATED, INCLUDING INSULATION, SUPPORTS, HANGERS, VALVES, FITTINGS, UNIONS, ESCUTCHEONS AND ALL ASSOCIATED APPURTENANCES. CAP PIPING NEAR LOCATION INDICATED. WHERE NEW WORK IS NOT UTILIZING THE EXISTING OPENING, PATCH PENETRATIONS TO MATCH EXISTING CONSTRUCTION AND FINISH. REFER TO HVAC PIPING NEW WORK DRAWINGS FOR ADDITIONAL REQUIREMENTS.
- REMOVE WALL MOUNTED THERMOSTAT IN ITS ENTIRETY, INCLUDING SUPPORTS, WIRING, AND/OR PNEUMATIC TUBING IF APPLICABLE. PATCH WALL AND PAINT AT COMPLETION OF REMOVAL WORK TO MATCH EXISTING CONSTRUCTION AND MATERIALS.
- REMOVE EXISTING FLOOR MOUNTED UNIT VENTILATOR IN ITS ENTIRETY INCLUDING SUPPORTS, ENCLOSURE, PIPING, VALVING, INSULATION, DRAIN PAN, AND ALL ASSOCIATED APPURTENANCES. WHERE A NEW FLOOR MOUNTED UNIT VENTILATOR IS NOT BEING INSTALLED, PROVIDE PATCHING AND PAINTING OF WALL AND FLOOR TO MATCH EXISTING CONSTRUCTION, FINISH, AND MATERIALS. REFER TO HVAC DUCTWORK REMOVAL DRAWINGS AND ARCHITECTURAL PLANS FOR ADDITIONAL REQUIREMENTS.

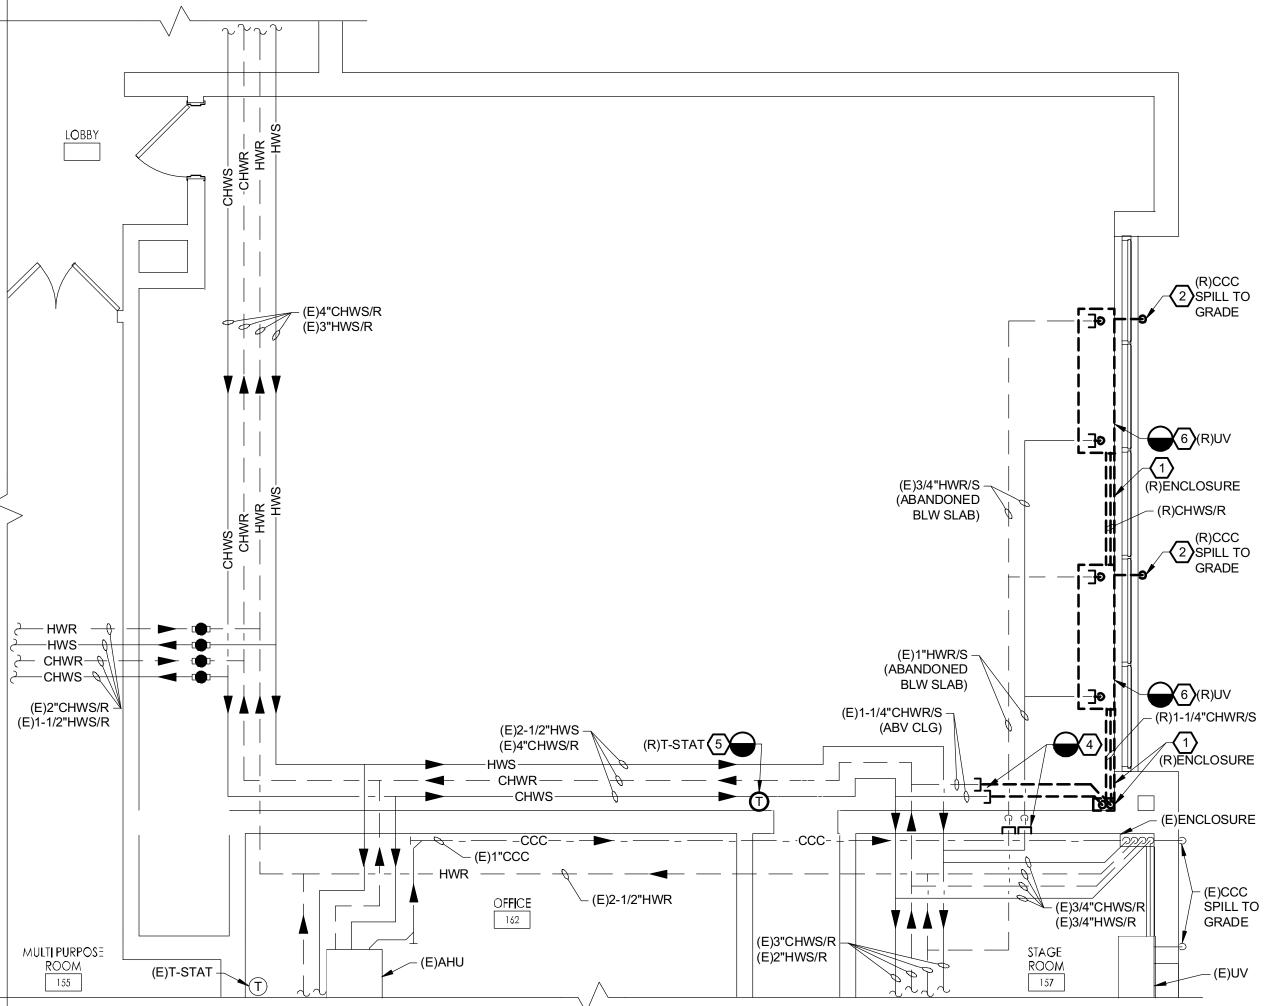

DAVENPORT ELEMENTARY SCHOOL

PARTIAL FLOOR PLAN - HVAC REMOVALS - PIPING

SCALE: 1/4" = 1'-0"

KEY PLAN - ELEMENTARY

1/H102 E

2/H102 E

REFERENCE DIMENSION

0 INDICATED DIMENSION IS MEASURED AT ONE (1) INCH IN LENGTH AND PROVIDED FOR REFERENCE/VERIFICATION ONLY.



11/01/2024 ISSUE FOR BID

ENGINEER DATE
MICHAEL S. GILLAN, PE NO. 24GE04470000

2024 GILLAN & HARTMANN, Inc.

DATE
GE04470000

WILLIAM D. H

WILLIAM D. H

NJ-21A01706200

GEORGE R. D

NJ-21A01709200

JASON J. DUE

NJ-21A01709200

JASON J. DUE

NJ-21A01779801

State Veisz Hopkins Duthie P C

NJ-21A01779801

NJ-21A017

Renovations for Five (5) Pre-K Classrooms at Clayton J.
Davenport School

Project Owner Name

Egg Harbor Township School District

Project Location

2501 Spruce Ave, Egg Harbor Township, NJ 08234

Project Number

5481

Project Date

11.01.2024

Checked By


KLH

RPF
Scale
AS NOTED

ELEMENTARY
SCHOOL HVAC
REMOVALS PIPING - FIRST
FLOOR PARTIAL
PLAN

1 Revisions
No. Date Description

H102 E

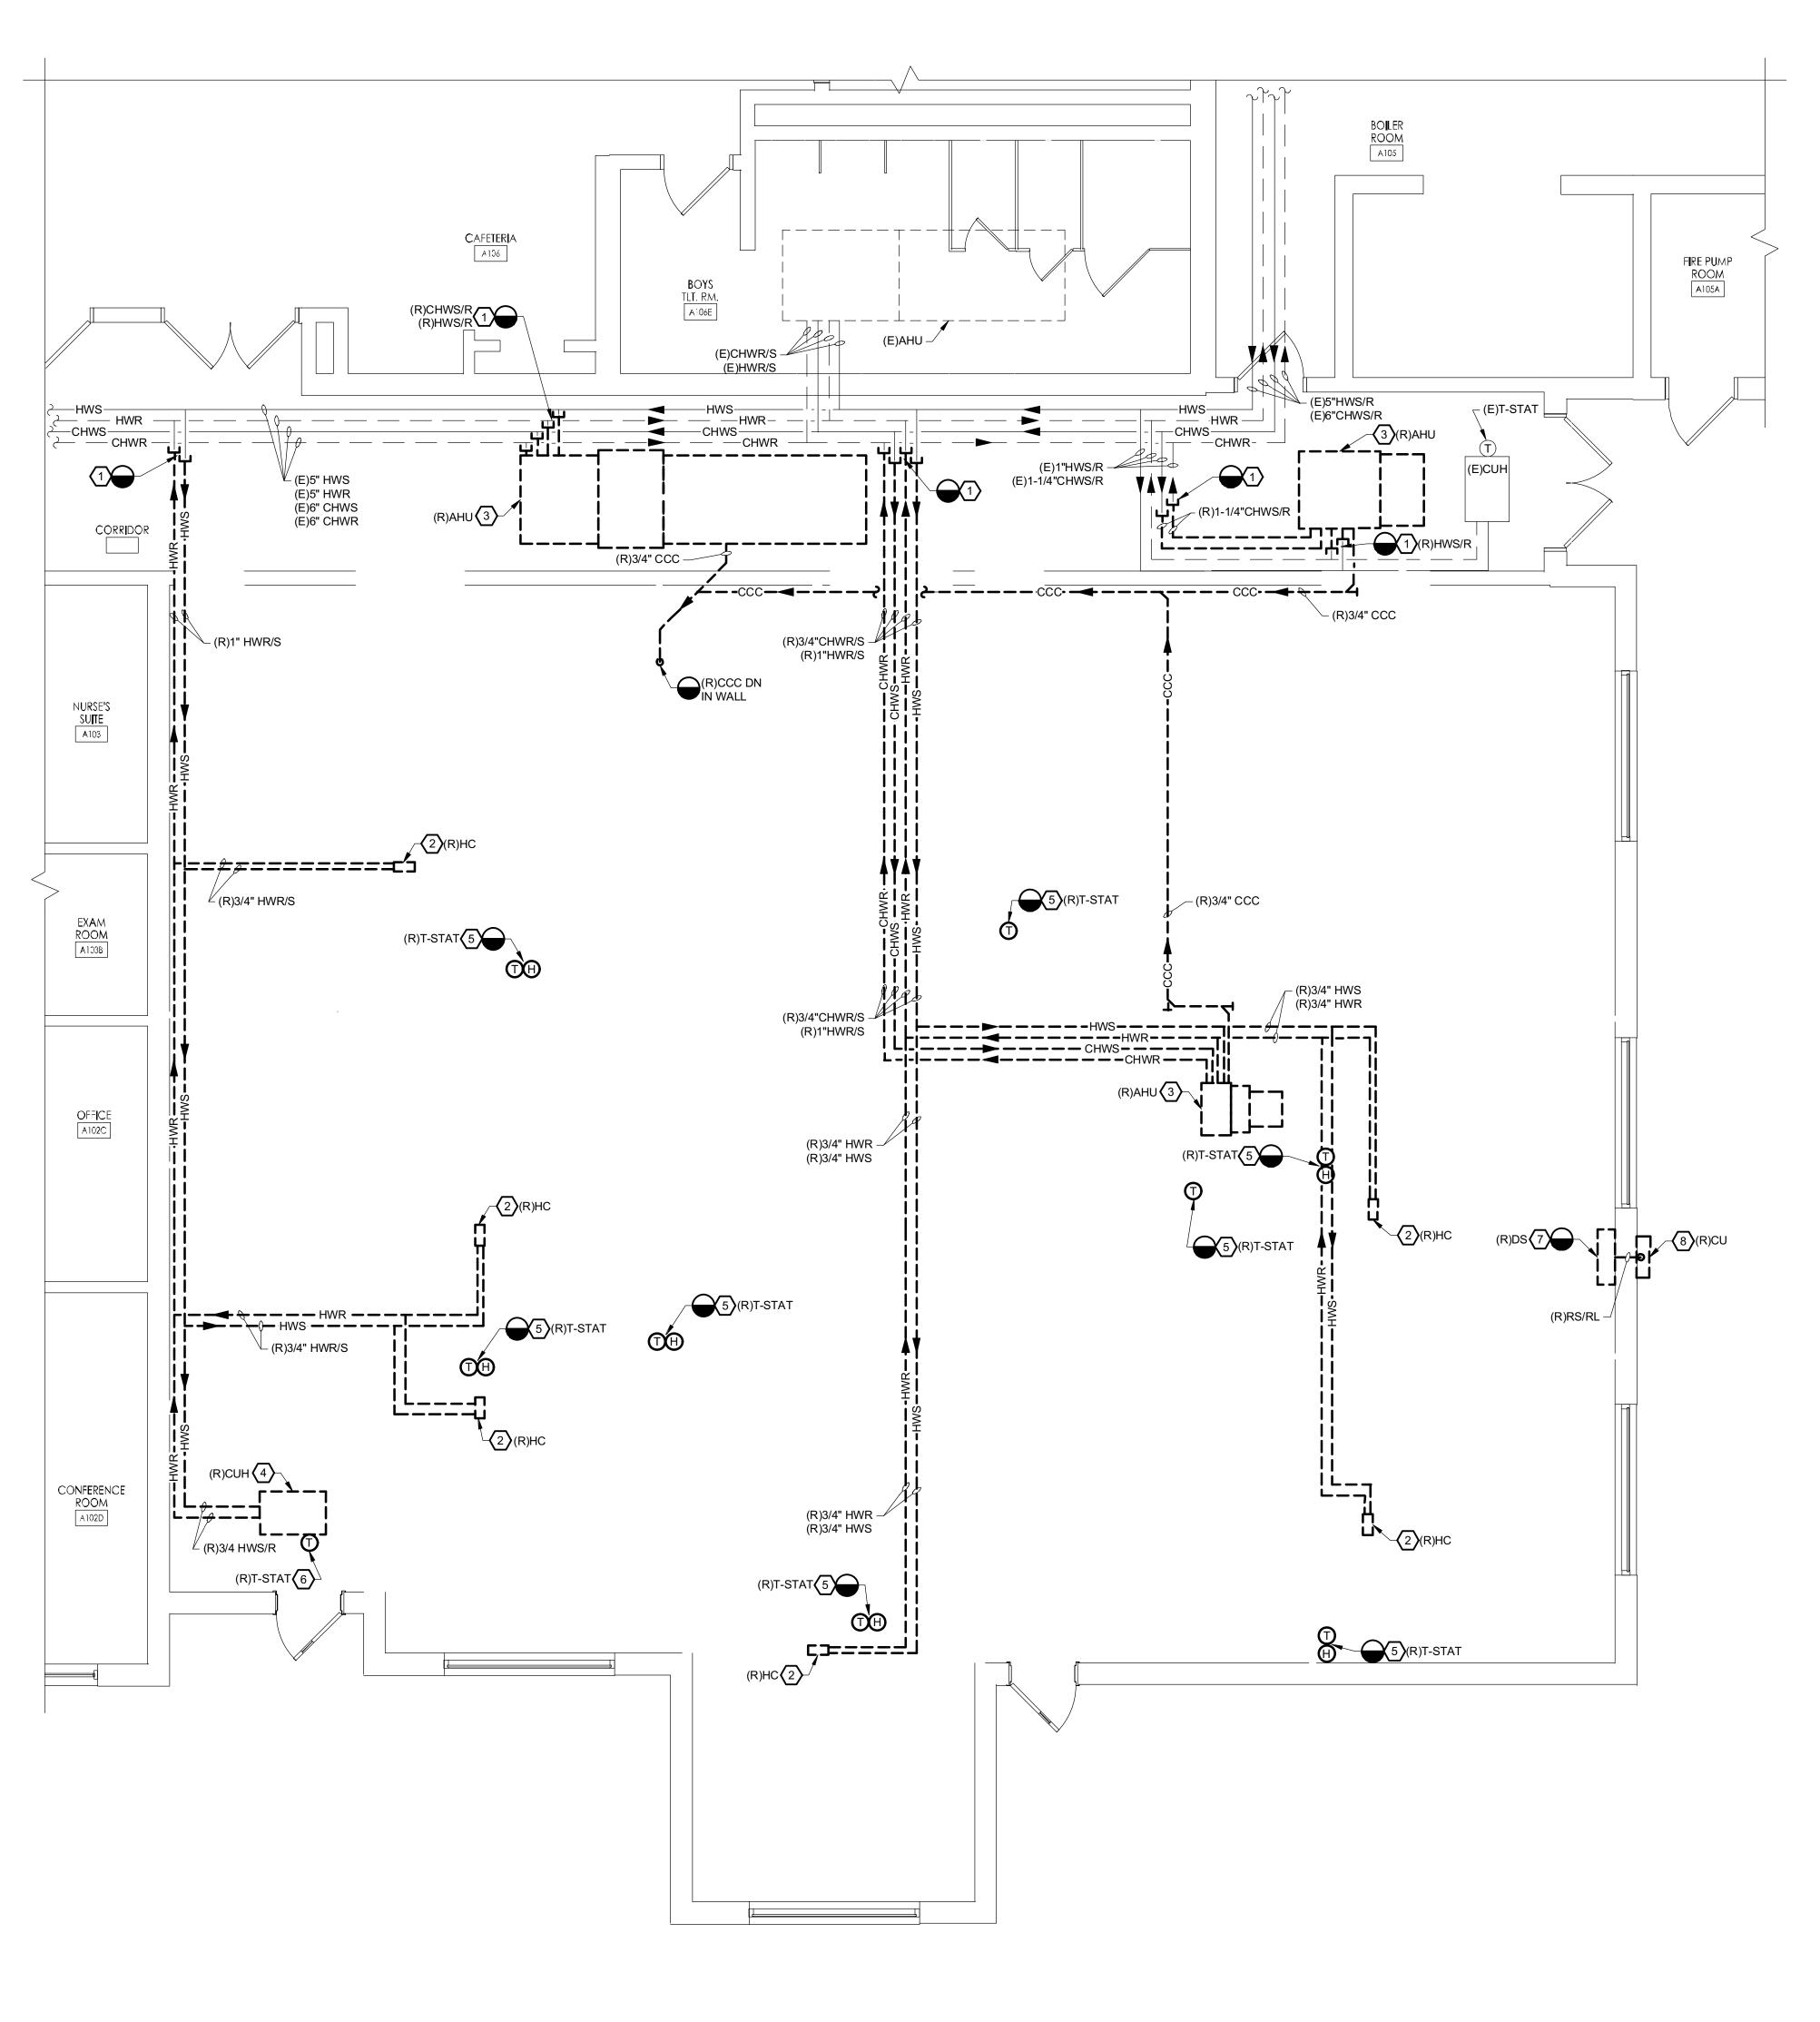

PARTIAL FLOOR PLAN - HVAC REMOVALS - PIPING

DAVENPORT PRIMARY SCHOOL

H102 P SCALE: 1/4" = 1'-0"

REMOVAL NOTES:

- REMOVE PIPING BACK TO LOCATION INDICATED, INCLUDING INSULATION, SUPPORTS, HANGERS, VALVES, FITTINGS, UNIONS, ESCUTCHEONS AND ALL ASSOCIATED APPURTENANCES. CAP PIPING NEAR LOCATION INDICATED. WHERE NEW WORK IS NOT UTILIZING THE EXISTING OPENING, PATCH PENETRATIONS TO MATCH EXISTING CONSTRUCTION AND FINISH. REFER TO HVAC PIPING NEW WORK DRAWINGS FOR ADDITIONAL REQUIREMENTS.
- REMOVE EXISTING DECK SUSPENDED HEATING COIL AND ALL ASSOCIATED PIPING, HANGERS, SUPPORTS, VALVES, INSULATION, AND ALL ASSOCIATED APPURTENANCES. REFER TO HVAC DUCTWORK REMOVAL DRAWINGS FOR ADDITIONAL REQUIREMENTS.
- REMOVE EXISTING DECK SUSPENDED AIR HANDLING UNIT AND ALL ASSOCIATED PIPING, HANGERS, SUPPORTS, ANCHORS, VALVES, AND APPURTENANCES. REMOVE ALL ASSOCIATED CHWS/CHWR AND HWS/HWR PIPING BACK TO POINT INDICATED. REFER TO HVAC DUCTWORK REMOVAL DRAWINGS FOR ADDITIONAL REQUIREMENTS.
- REMOVE EXISTING CEILING MOUNTED CABINET UNIT HEATER AND ALL ASSOCIATED PIPING, HANGERS, SUPPORTS, ANCHORS, VALVES, AND APPURTENANCES. REMOVE ALL ASSOCIATED HWS/HWR PIPING BACK TO POINT INDICATED. REFER TO HVAC DUCTWORK REMOVAL DRAWINGS FOR ADDITIONAL REQUIREMENTS. PROVIDE NEW CEILING COMPONENTS TO MATCH EXISTING CONSTRUCTION, FINISH, AND MATERIALS. REFER TO ARCHITECTURAL PLANS FOR ADDITIONAL REQUIREMENTS.
- 75 REMOVE WALL MOUNTED THERMOSTAT IN ITS ENTIRETY, INCLUDING SUPPORTS, WIRING, AND/OR PNEUMATIC TUBING IF APPLICABLE. PATCH WALL AT COMPLETION OF REMOVAL WORK TO MATCH EXISTING CONSTRUCTION AND MATERIALS. RETAIN BUILDING CONTROLS CONTRACTOR/VENDOR FOR REMOVAL OF UNIT CONTROLS AND ALL ASSOCIATED CONTROL WIRING.
- 6 REMOVE UNIT MOUNTED THERMOSTAT IN ITS ENTIRETY, INCLUDING SUPPORTS, WIRING, AND/OR PNEUMATIC TUBING IF APPLICABLE. RETAIN BUILDING CONTROLS CONTRACTOR/VENDOR FOR REMOVAL OF UNIT CONTROLS AND ALL ASSOCIATED CONTROL WIRING.
- 7 REMOVE EXISTING WALL MOUNTED DUCTLESS SPLIT INDOOR EVAPORATOR, INCLUDING REFRIGERANT PIPING, THERMOSTAT, VALVES, CONDENSATE PIPING, PIPE INSULATION, PIPE PORTALS, AND ALL ASSOCIATED APPURTENANCES TO THE CONDENSING UNIT MOUNTED ON EXTERIOR WALL. DISCONNECT REFRIGERANT PIPING IN A MANNER AS TO CAPTURE REFRIGERANT. REMOVE EQUIPMENT WITHOUT RELEASING REFRIGERANT TO THE ATMOSPHERE. COMPLY WITH ALL APPLICABLE CODES AND REGULATIONS CONCERNING THE USE, RECOVERY. AND RECYCLING OF REFRIGERANTS. PATCH THE REMAINING PENETRATION TO MATCH EXISTING CONSTRUCTION AND FINISH. PATCH EXTERIOR WALL IN ACCORDANCE WITH THE MANUFACTURERS RECOMMENDATIONS. PATCH AND PAINT TO MATCH EXISTING. REFER TO ARCHITECTURAL PLANS FOR ADDITIONAL REQUIREMENTS.
- (8) REMOVE EXISTING OUTDOOR WALL MOUNTED CONDENSING UNIT INCLUDING ALL SUPPORTS/SUPPORT RAILS, AND ALL ASSOCIATED APPURTENANCES TO THE DUCTLESS SPLIT INDOOR EVAPORATOR. REFER TO HVAC DUCTWORK REMOVAL DRAWINGS FOR ADDITIONAL REQUIREMENTS.

Renovations for Five

(5) Pre-K Classrooms at Clayton J. Davenport School

Project Owner Name

Egg Harbor Township School District

Project Location

2501 Spruce Ave, Egg Harbor Township, NJ 08234

Project Number 11.01.2024 Checked By

AS NOTED

Drawn By

Drawing Name PRIMARY SCHOOL HVAC REMOVALS -PIPING - FIRST FLOOR PARTIAL PLAN

REFERENCE DIMENSION

No. Date Description INDICATED DIMENSION IS MEASURED AT ONE (1) INCH IN LENGTH AND PROVIDED FOR REFERENCE/VERIFICATION ONLY.

Gillan & Hartmann, Inc.

MECHANICAL AND ELECTRICAL

CONSULTING ENGINEERS 610-935-0101 FAX: 610-935-7520 215-238-9510 609-347-1593 302-654-5959 gillan-hartmann.com ghmail@gillan-hartmann.com G&H Project No. 2024-147 Drawing Number


11/01/2024 ISSUE FOR BID **ENGINEER**

NO. 24GE04470000

2024 GILLAN & HARTMANN, Inc.


MICHAEL S. GILLAN, PE


KEY PLAN - PRIMARY

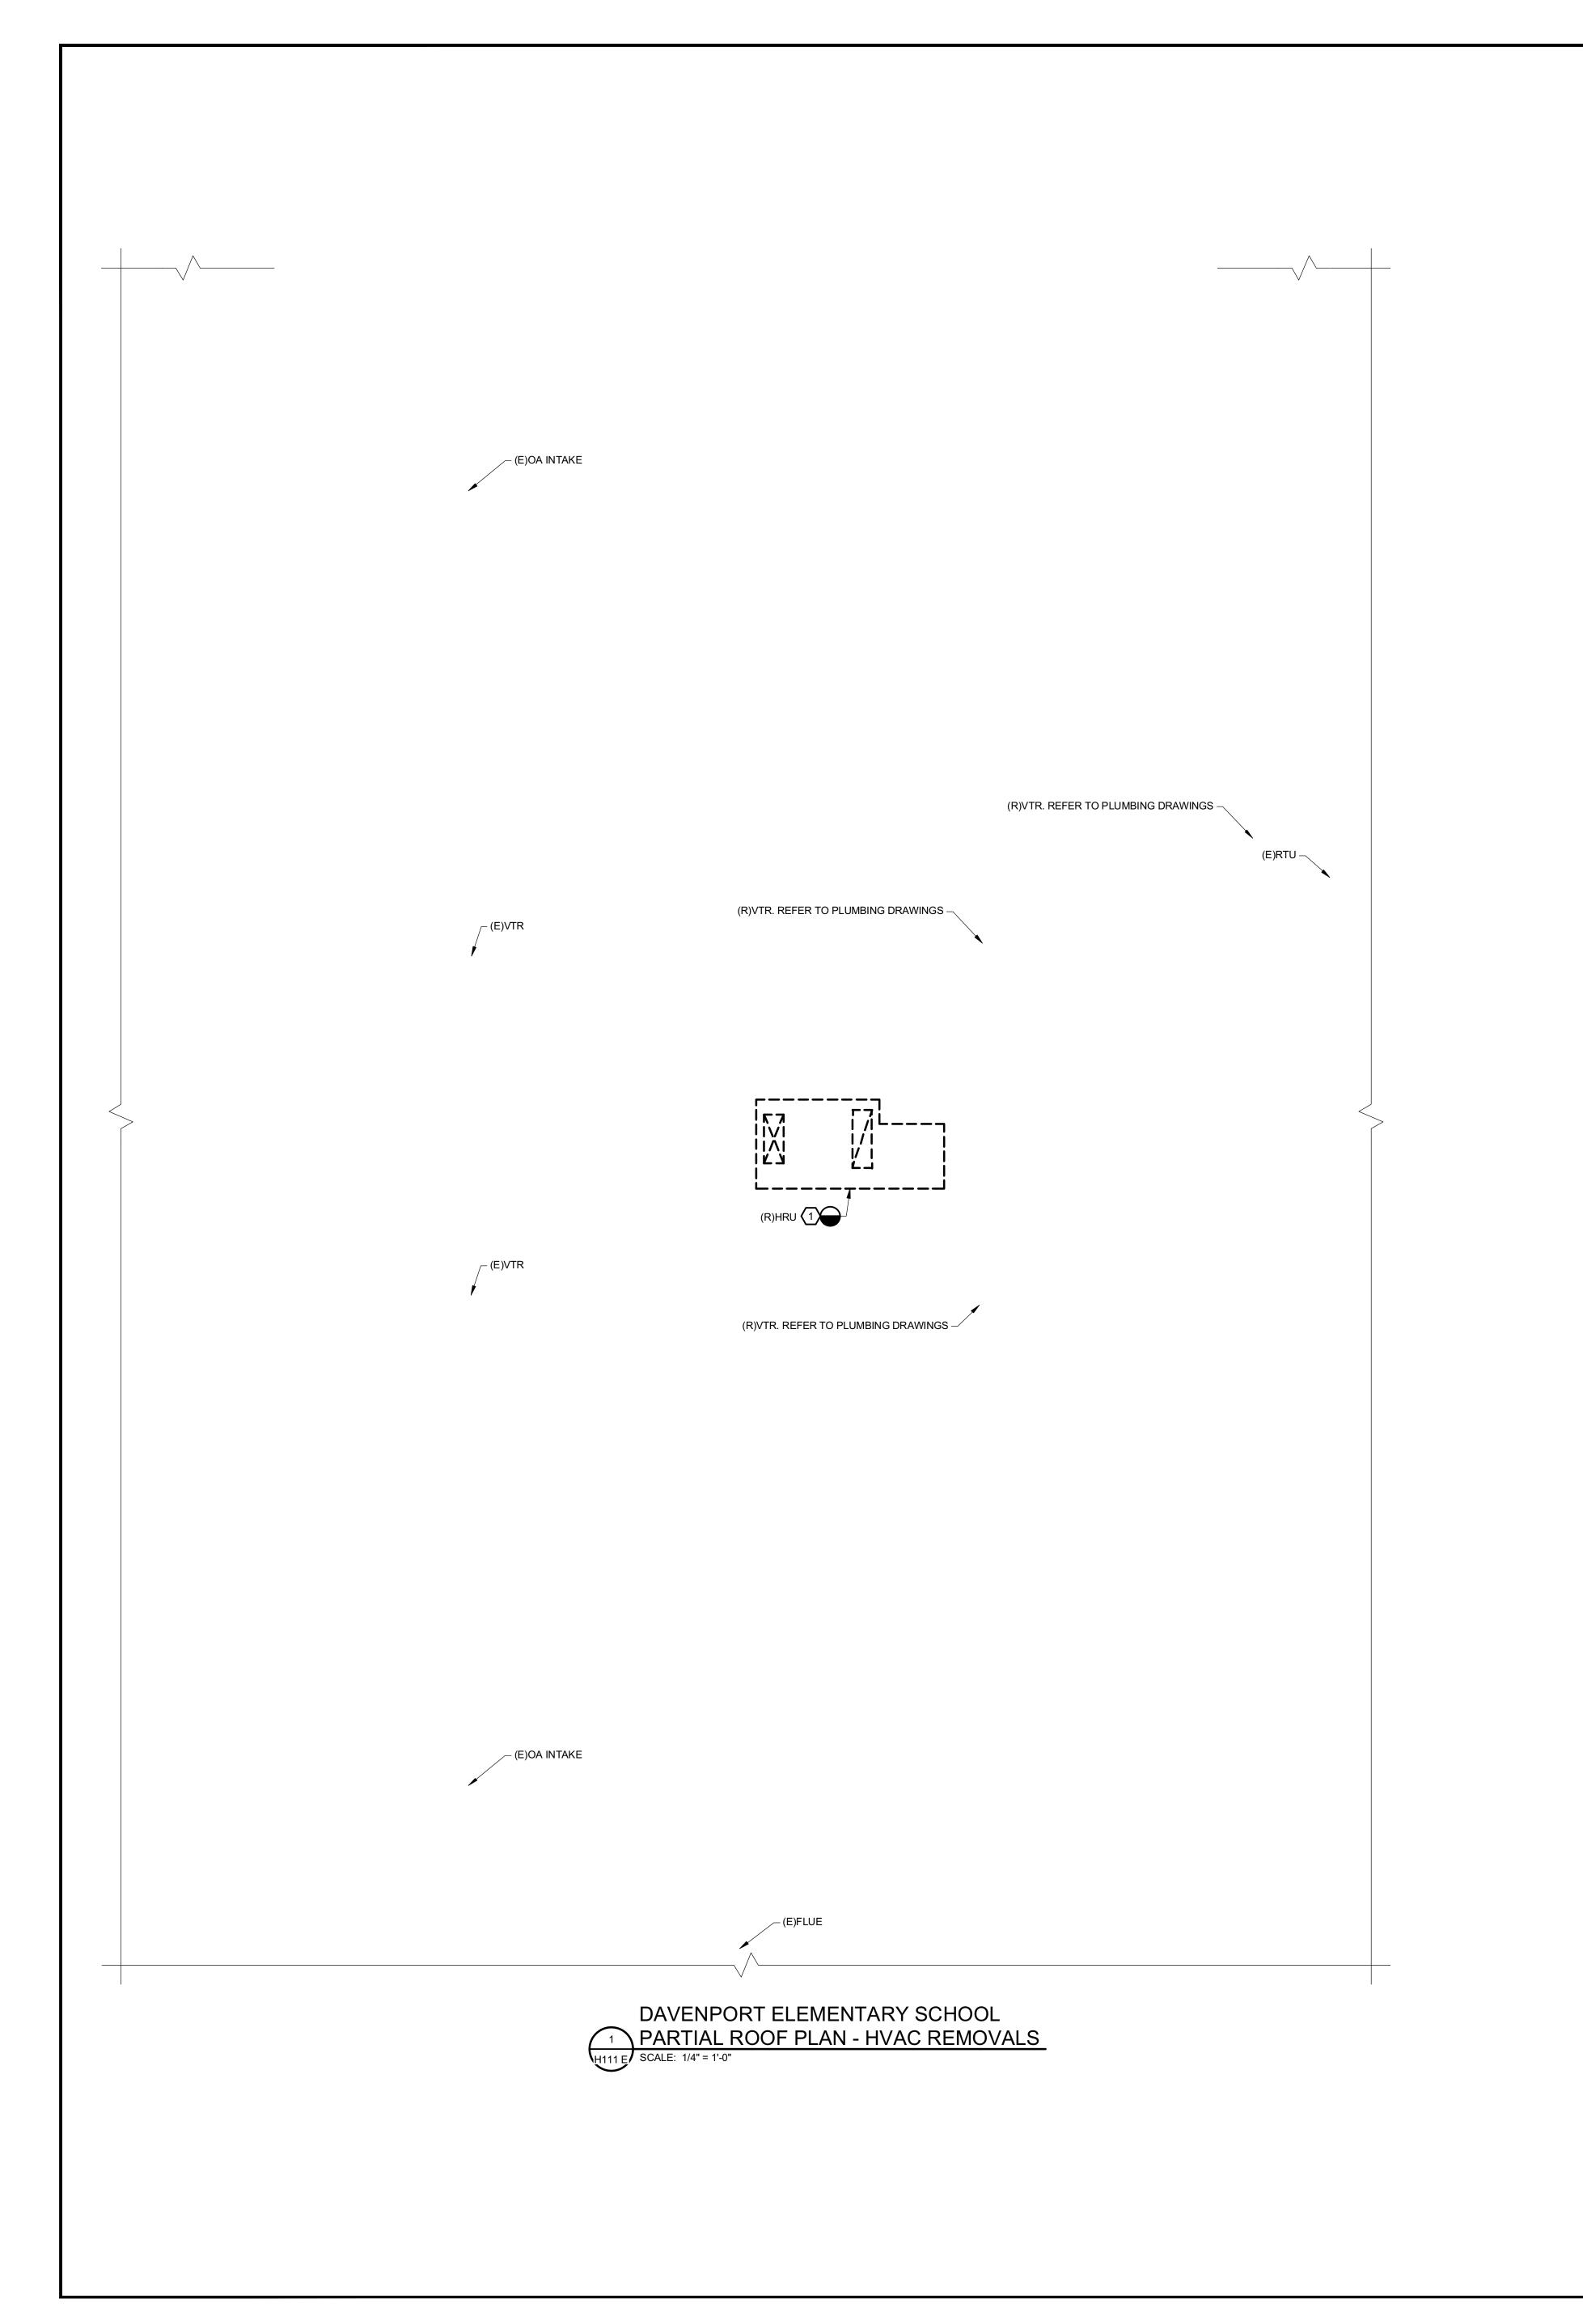

REMOVAL NOTES:

REMOVE EXISTING ROOF TOP UNIT INCLUDING BLOCKING, COUNTER FLASHING, FLEXIBLE CONNECTIONS, VALVES, AND ALL ASSOCIATED APPURTENANCES. REMOVE EXISTING ROOF CURB AND PATCH ROOF TO MATCH WHERE REQUIRED FOR REPLACEMENT UNIT AND NEW CURB INDICATED ON NEW WORK PLANS. ALL ROOF WORK SHALL BE PERFORMED IN ACCORDANCE WITH THE ROOF MANUFACTURER'S RECOMMENDATIONS. MAINTAIN ROOF WARRANTY. REFER TO HVAC PIPING REMOVAL DRAWINGS AND ARCHITECTURAL PLANS FOR ADDITIONAL REQUIREMENTS.

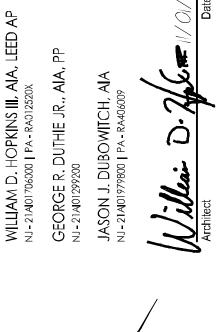

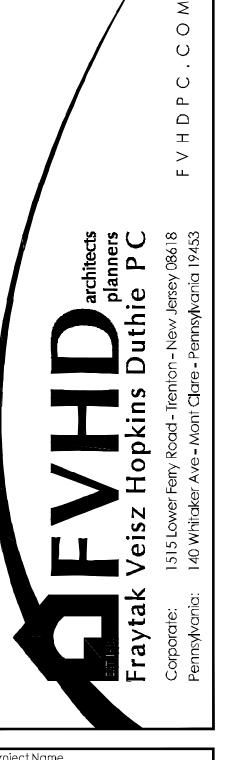

Renovations for Five (5) Pre-K Classrooms at Clayton J.
Davenport School

Project Owner Name

Egg Harbor Township School District

Project Location

2501 Spruce Ave, Egg Harbor Township, NJ 08234

Project Number 11.01.2024

AS NOTED

Drawing Name ELEMENTARY SCHOOL HVAC REMOVALS -PARTIAL ROOF PLAN

REFERENCE DIMENSION

KEY PLAN - ELEMENTARY

INDICATED DIMENSION IS MEASURED AT ONE (1) INCH IN LENGTH AND PROVIDED FOR REFERENCE/VERIFICATION ONLY.

No. Date Description

Gillan & Hartmann, Inc.

MECHANICAL AND ELECTRICAL

CONSULTING ENGINEERS

610-935-0101 FAX: 610-935-7520

215-238-9510 609-347-1593 302-654-5959


gillan-hartmann.com ghmail@gillan-hartmann.com

G&H Project No. 2024-147 Drawing Number

ENGINEER DATE MICHAEL S. GILLAN, PE


11/01/2024 ISSUE FOR BID

NO. 24GE04470000

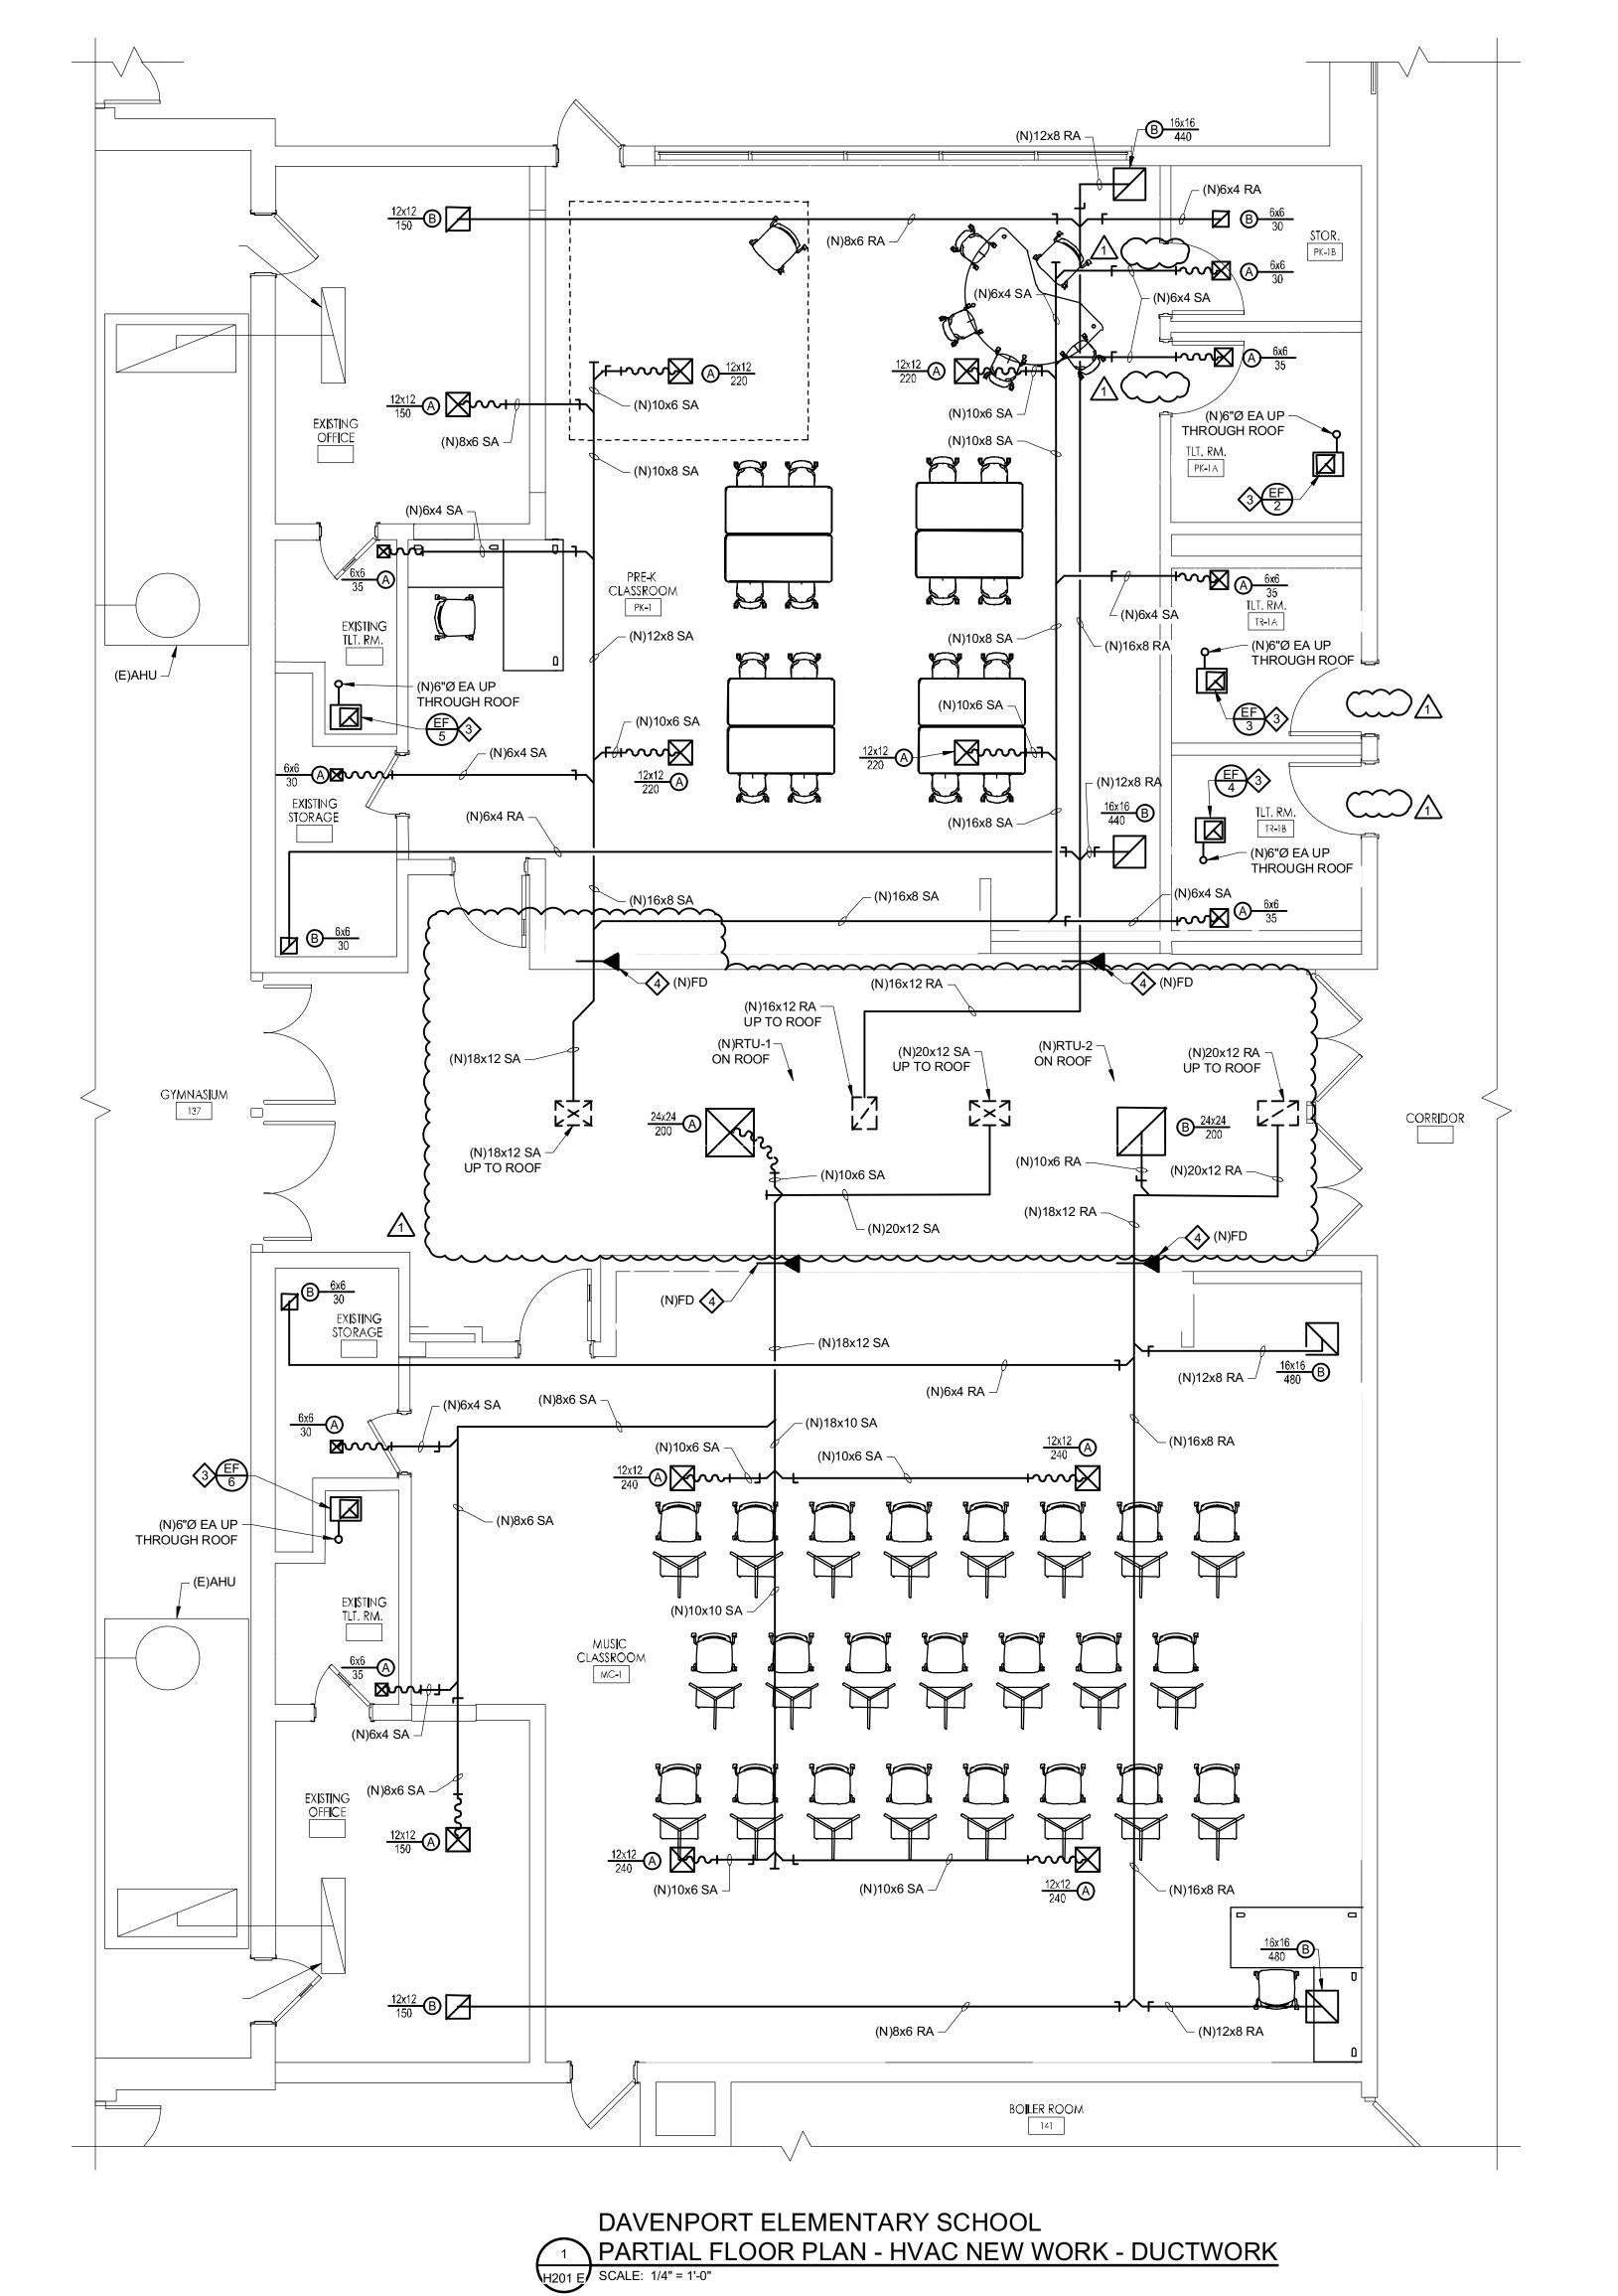




- PROVIDE 18x12 SUPPLY AIR DUCTWORK FROM UV-1 AND ROUTE ABOVE CEILING WITH DUCT SHROUD. EXTEND DUCT SHROUD TO ALL ADJACENT WALL/UNIT SURFACES, DUCTWORK SHALL NOT BE EXPOSED.
- 2> PROVIDE NEW VERTICAL UNIT VENTILATOR (UV-1), DUCT SHROUD, FILLER PANELS, WALL SLEEVE, AND LOUVER. COMPLETED UNIT INSTALLATION SHALL NOT REVEAL ANY EXPOSED INSULATION, PIPING OR UNPAINTED SHEET METAL. REFER TO MECHANICAL DETAILS AND ARCHITECTURAL PLANS FOR ADDITIONAL REQUIREMENTS.
- PROVIDE 6"Ø EXHAUST AIR FROM EXHAUST FAN (EF) WITH FLEXIBLE CONNECTION UP THROUGH ROOF WITH DUCT PENETRATION CURB AND FACTORY CURB DISCHARGE CAP. EXHAUST DISCHARGE LOCATION SHOWN IS APPROXIMATE. ADJUST AS REQUIRED TO AVOID CONFLICTS. COORDINATE FINAL PLACEMENT AND ALL CUTTING, PATCHING AND FLASHING. REFER TO MECHANICAL DETAILS AND ARCHITECTURAL PLANS FOR ADDITIONAL
- PROVIDE 1-1/2 HOUR DYNAMIC FIRE DAMPER (FD), SIZE AS NOTED ON PLAN, IN ACCORDANCE WITH EXISTING FIRE RATED WALL/FLOOR.

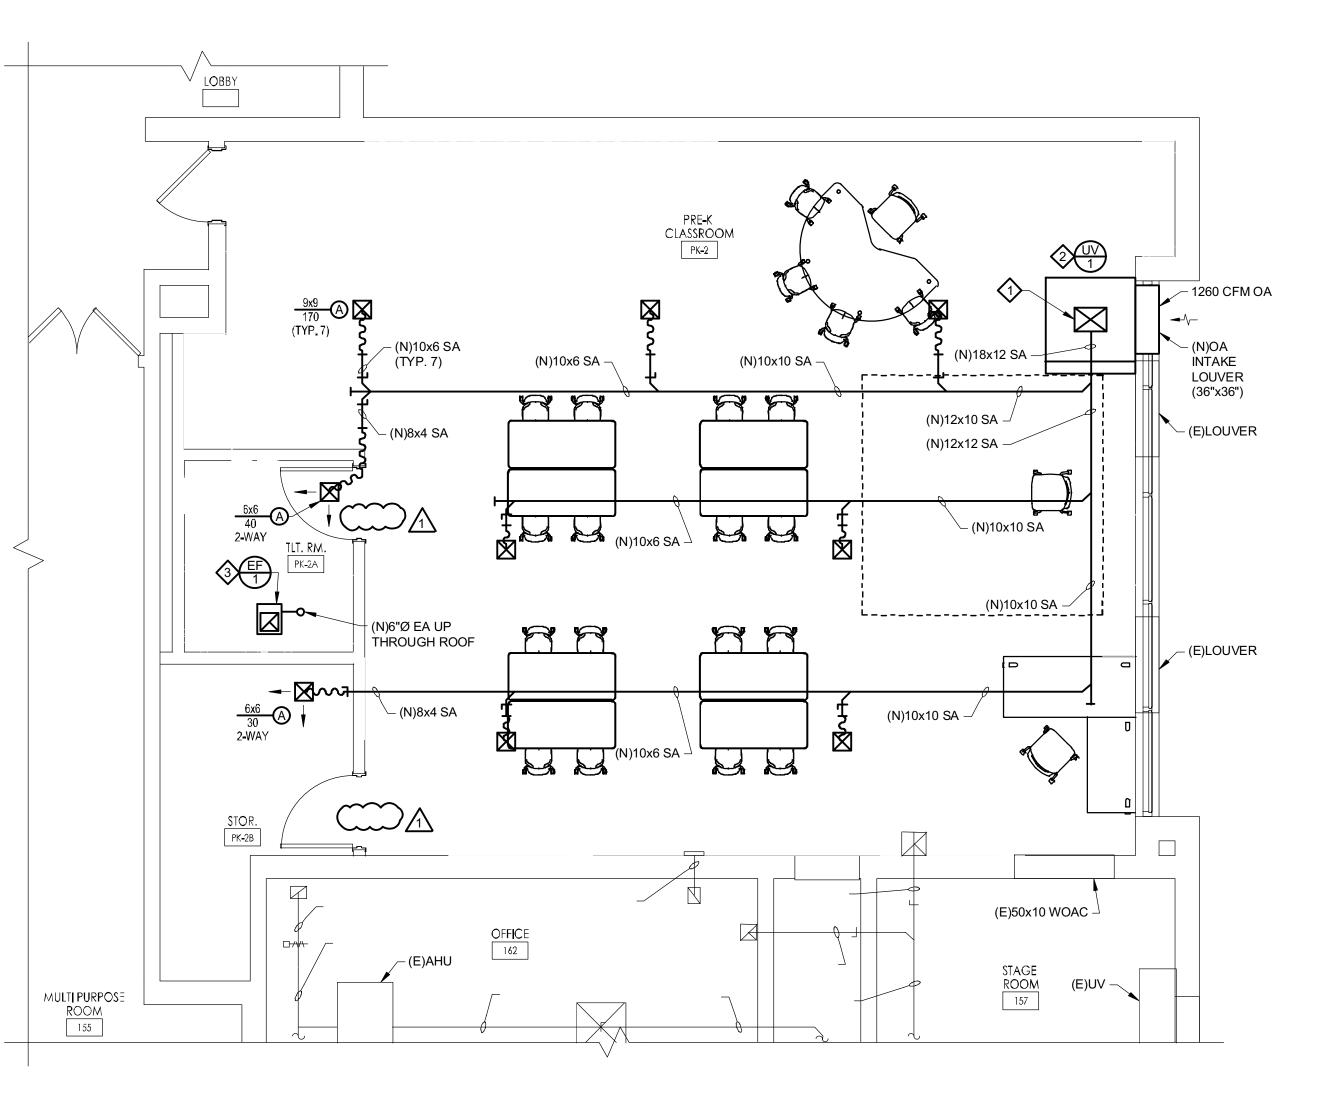

DAVENPORT ELEMENTARY SCHOOL PARTIAL FLOOR PLAN - HVAC NEW WORK - DUCTWORK

SCALE: 1/4" = 1'-0"

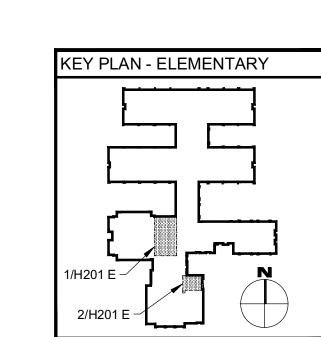

REFERENCE DIMENSION

INDICATED DIMENSION IS MEASURED AT ONE (1) INCH IN LENGTH AND PROVIDED FOR REFERENCE/VERIFICATION ONLY.

Gillan & Hartmann, Inc.

MECHANICAL AND ELECTRICAL

CONSULTING ENGINEERS 610-935-0101 FAX: 610-935-7520 215-238-9510 609-347-1593 302-654-5959 gillan-hartmann.com ghmail@gillan-hartmann.com G&H Project No. 2024-147

11/01/2024 ISSUE FOR BID

ENGINEER DATE NO. 24GE04470000 2024 GILLAN & HARTMANN, Inc.

Renovations for Five (5) Pre-K Classrooms at Clayton J. Davenport School

Project Owner Name

Egg Harbor Township School District

Project Location

2501 Spruce Ave, Egg Harbor Township, NJ 08234

11.01.2024


AS NOTED

Drawing Name **ELEMENTARY** SCHOOL HVAC NEW WORK -DUCTWORK -FIRST FLOOR PART**I**AL PLAN

No. Date Description 11.26.24 Addendum 1

Drawing Number H201 E


MICHAEL S. GILLAN, PE

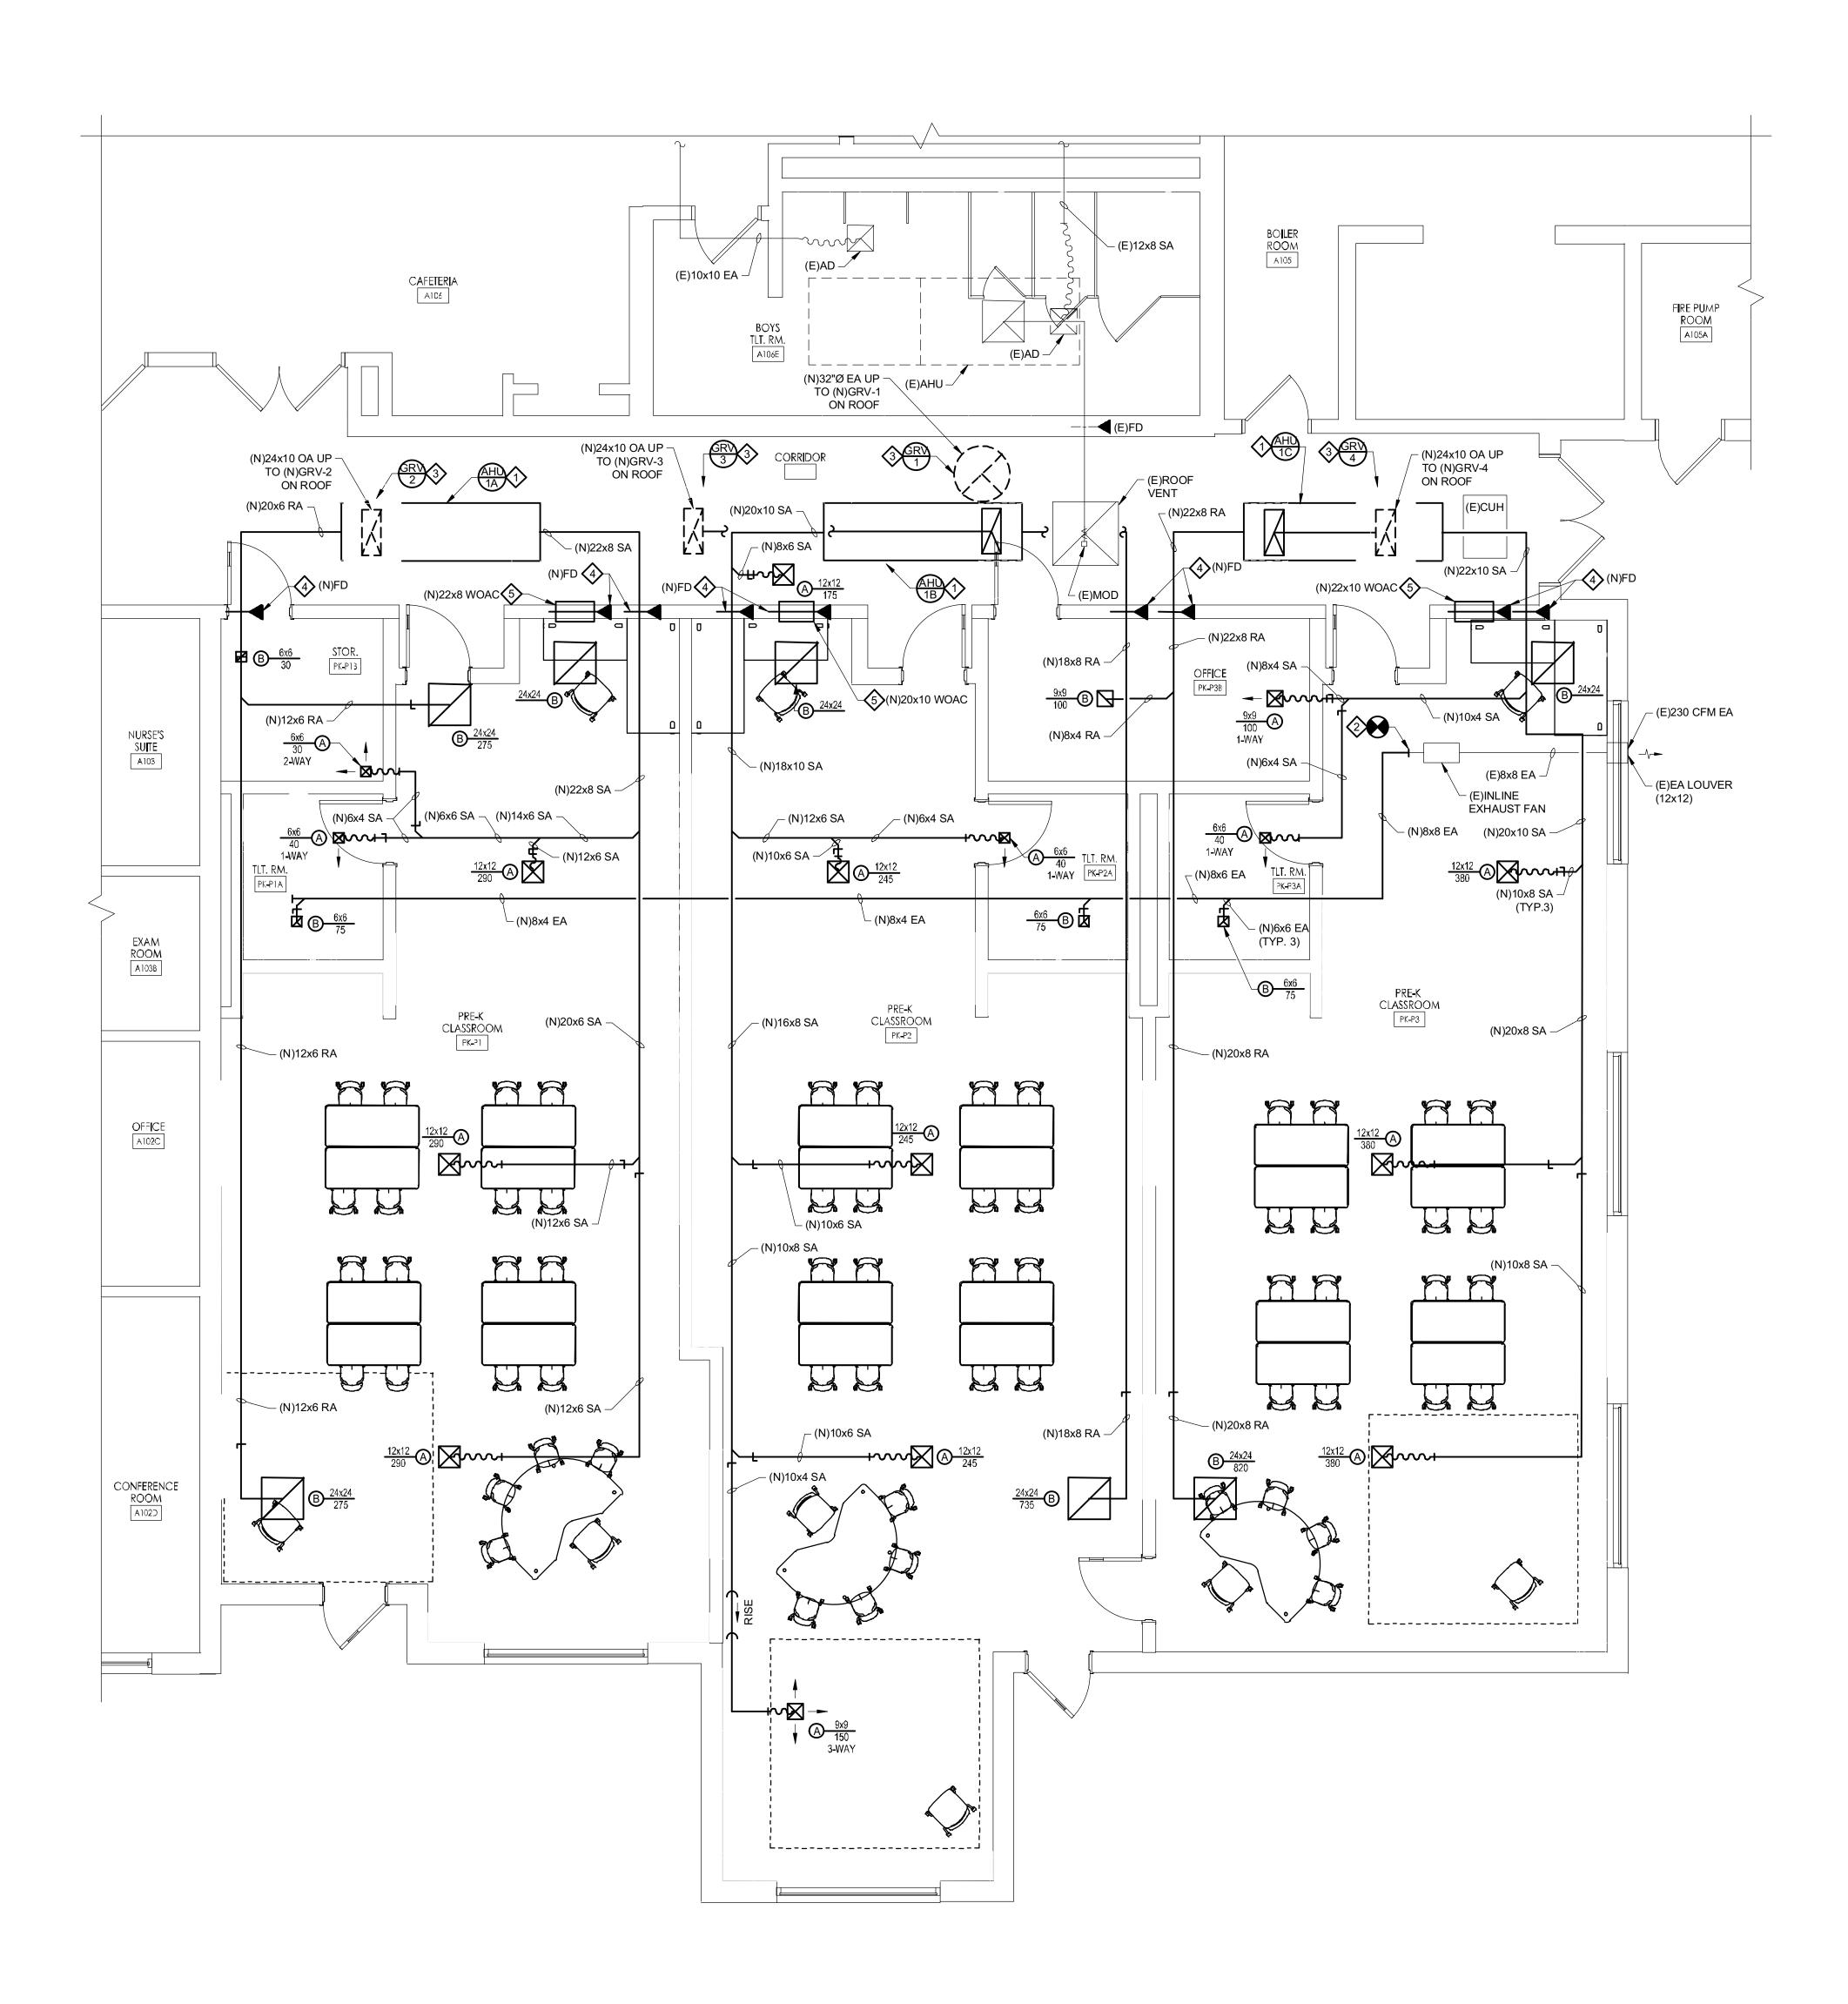

DAVENPORT PRIMARY SCHOOL PARTIAL FLOOR PLAN - HVAC NEW WORK - DUCTWORK H201 P SCALE: 1/4" = 1'-0"

NEW WORK NOTES:

- PROVIDE NEW ABOVE CEILING AIR HANDLING UNIT (AHU), OUTSIDE AIR INTAKE ROOF CURB, AND ALL ASSOCIATED HANGERS AND ANCHORS. COORDINATE AHU INSTALLATION HEIGHT WITH DUCTWORK, PIPING, STRUCTURAL STEEL, AND REQUIRED MAINTENANCE/ACCESS CLEARANCES. RETAIN BUILDING CONTROLS CONTRACTOR/VENDOR TO PROVIDE ALL REQUIRED UNIT CONTROLS AND ALL ASSOCIATED CONTROL WIRING. ALL ROOF WORK SHALL BE PERFORMED IN ACCORDANCE WITH THE ROOF MANUFACTURER'S RECOMMENDATIONS
- 2 EXTEND AND CONNECT NEW DUCTWORK TO EXISTING DUCTWORK REMAINING FROM DEMOLITION NEAR LOCATION INDICATED. PROVIDE SUPPORTS/HANGERS, RIGID DUCTWORK AND TRANSITIONS. ADJUST DUCTWORK AS NECESSARY TO AVOID CONFLICTS.
- PROVIDE NEW GRAVITY ROOF VENTILATOR NEAR LOCATION INDICATED ON ROOF WITH MANUFACTURERS ROOF CURB AND ALL REQUIRED MOUNTING/ANCHORING. ALL ROOF WORK SHALL BE PERFORMED IN ACCORDANCE WITH THE ROOF MANUFACTURER'S RECOMMENDATIONS AND MAINTAIN ROOF WARRANTY.
- PROVIDE 1-1/2 HOUR DYNAMIC FIRE DAMPER, SIZE AS NOTED ON PLAN, IN ACCORDANCE WITH EXISTING FIRE RATED WALL/FLOOR.
- PROVIDE NEW INTERIOR WALL OPENING ABOVE CEILING WITH FIRE DAMPER AND BIRD SCREEN, SIZE AS NOTED ON PLAN, TO ACCOMMODATE PLENUM TRANSFER AIR.

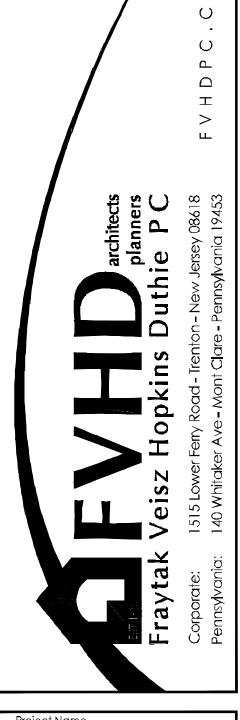

Renovations for Five (5) Pre-K Classrooms at Clayton J. Davenport School

Project Owner Name

Egg Harbor Township School District

Project Location

2501 Spruce Ave, Egg Harbor Township, NJ 08234

Project Number 11.01.2024

AS NOTED

Drawing Name PRIMARY SCHOOL HVAC NEW WORK -DUCTWORK -FIRST FLOOR PARTIAL PLAN

REFERENCE DIMENSION

REFERENCE/VERIFICATION ONLY.

No. Date Description INDICATED DIMENSION IS MEASURED AT ONE (1) INCH IN LENGTH AND PROVIDED FOR

Drawing Number


11/01/2024 ISSUE FOR BID




ENGINEER NO. 24GE04470000

KEY PLAN - PRIMARY

MICHAEL S. GILLAN, PE

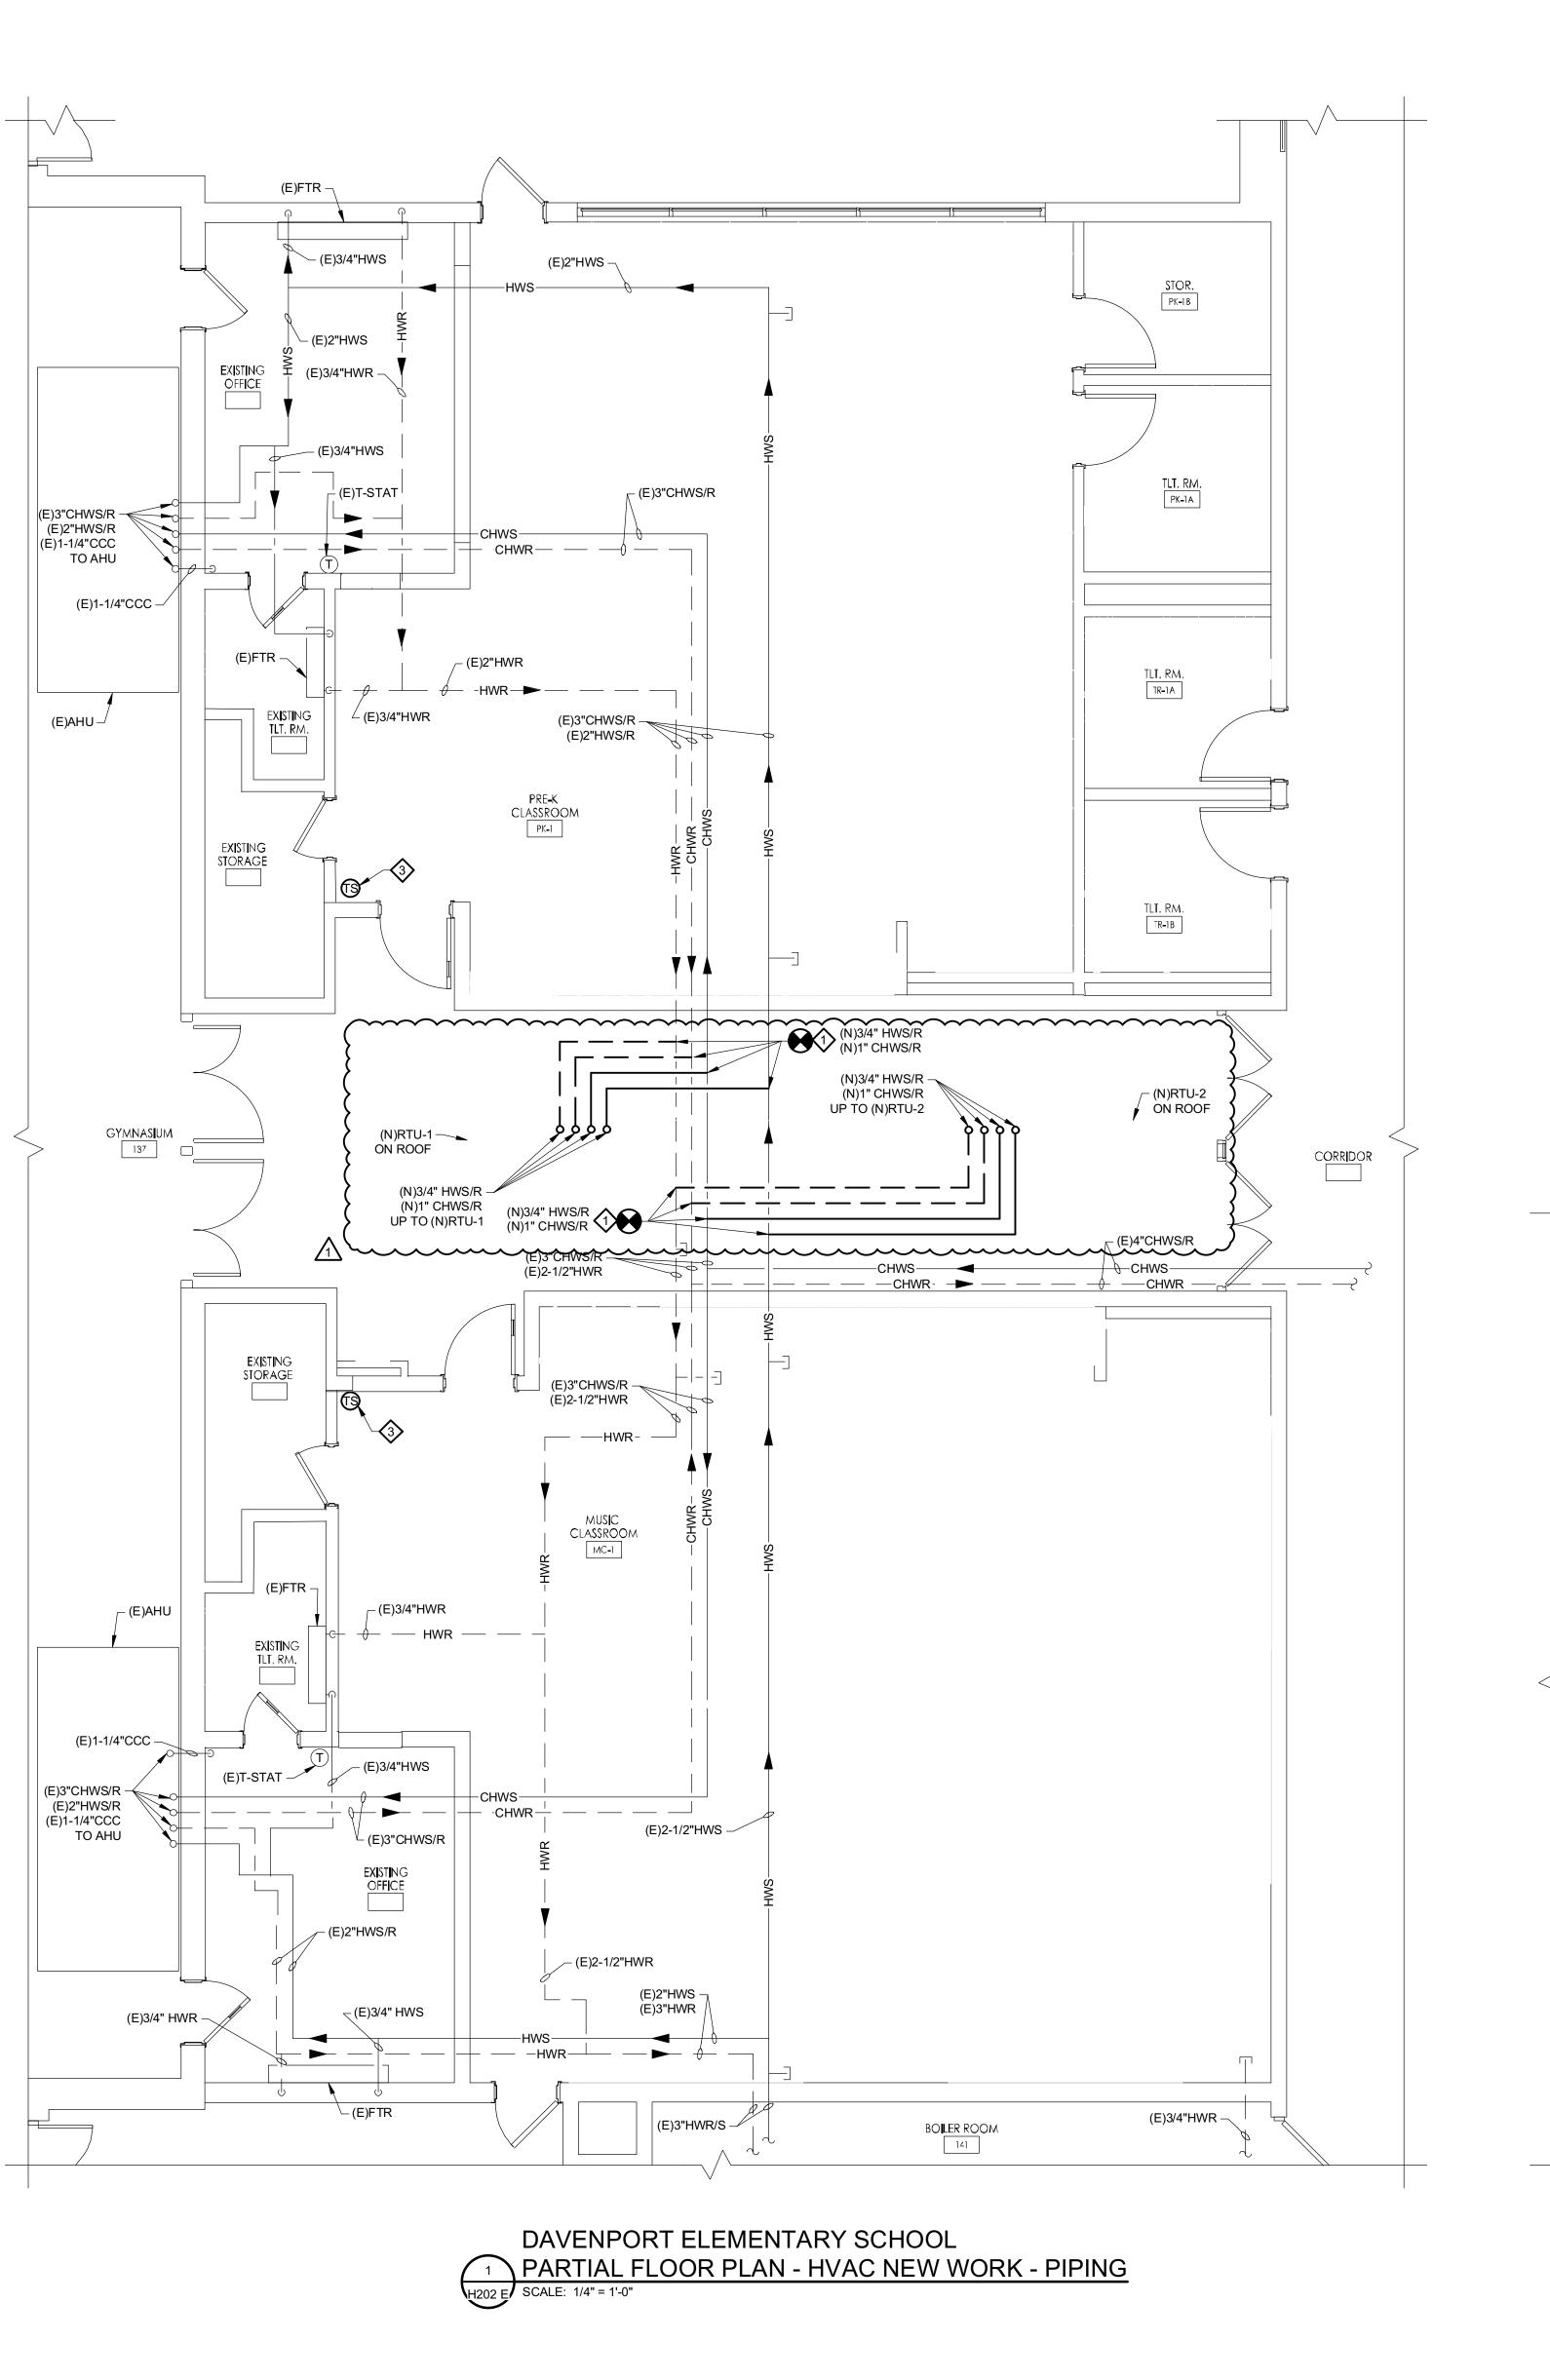


- EXTEND AND CONNECT NEW PIPING, AS SIZED ON PLAN, WITH SHUT-OFF/ISOLATION VALVES TO EXISTING PIPE CONNECTION REMAINING FROM REMOVAL WORK CLOSE TO THE EXISTING PIPE MAINS.
- 2 PROVIDE NEW VERTICAL UNIT VENTILATOR (UV-1) AND ALL ASSOCIATED MOUNTING AND ANCHORS. VERIFY IN FIELD ALL EXISTING DIMENSIONS FOR NEW UV. WHERE UV REQUIRES REAR EXTENSION PANELS DUE TO EXISTING SILL HEIGHT, PROVIDE REAR EXTENSIONS, UPPER FILLER PANELS AND FACTORY UNIT COLOR MATCHED SIDE COVERS PANELS. COMPLETED UNIT INSTALLATION SHALL NOT REVEAL ANY EXPOSED INSULATION, PIPING OR UNPAINTED SHEET METAL. REFER TO MECHANICAL DETAILS AND ARCHITECTURAL PLANS FOR ADDITIONAL
- REQUIREMENTS. PROVIDE NEW TEMPERATURE SENSOR MOUNTED AT ADA HEIGHT WITH SURFACE MOUNTED WIREMOLD/RACEWAY.
- PROVIDE WALL PENETRATION WITH PIPE SLEEVE (LINK SEAL) TO FACILITATE INSTALLATION OF 3/4" CCC PIPING SPILL TO GRADE. PIPE PENETRATION TO OCCUR AT BOTTOM OF WALL AS INDICATED. PROVIDE PIPE TURN DOWN AND CONCRETE SPLASH BLOCK.

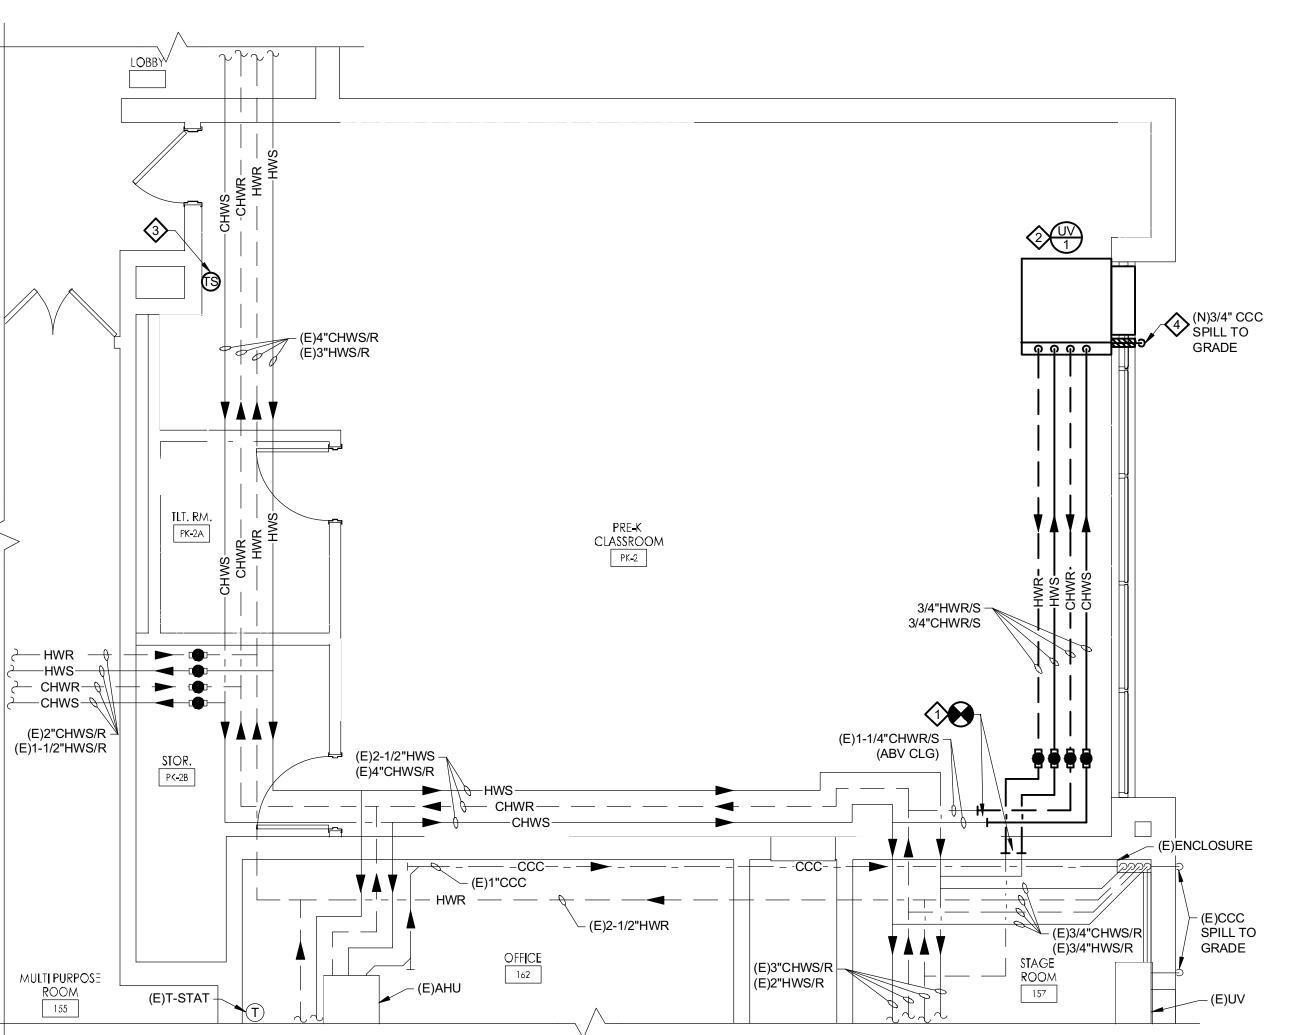

DAVENPORT ELEMENTARY SCHOOL PARTIAL FLOOR PLAN - HVAC NEW WORK - PIPING

SCALE: 1/4" = 1'-0"

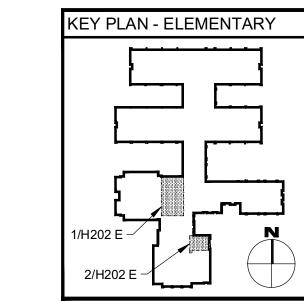


REFERENCE DIMENSION

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11/01/2024 ISSUE FOR BID



2024 GILLAN & HARTMANN, Inc.

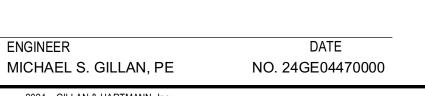Renovations for Five (5) Pre-K Classrooms at Clayton J. Davenport School

Project Owner Name

Egg Harbor Township School District

Project Location

2501 Spruce Ave, Egg Harbor Township, NJ 08234


Project Number 11.01.2024 Drawn By

AS NOTED

Drawing Name **ELEMENTARY** SCHOOL HVAC NEW WORK -PIPING - FIRST FLOOR PARTIAL PLAN

No. Date Description 1 11.26.24 Addendum 1

Drawing Number H202 E

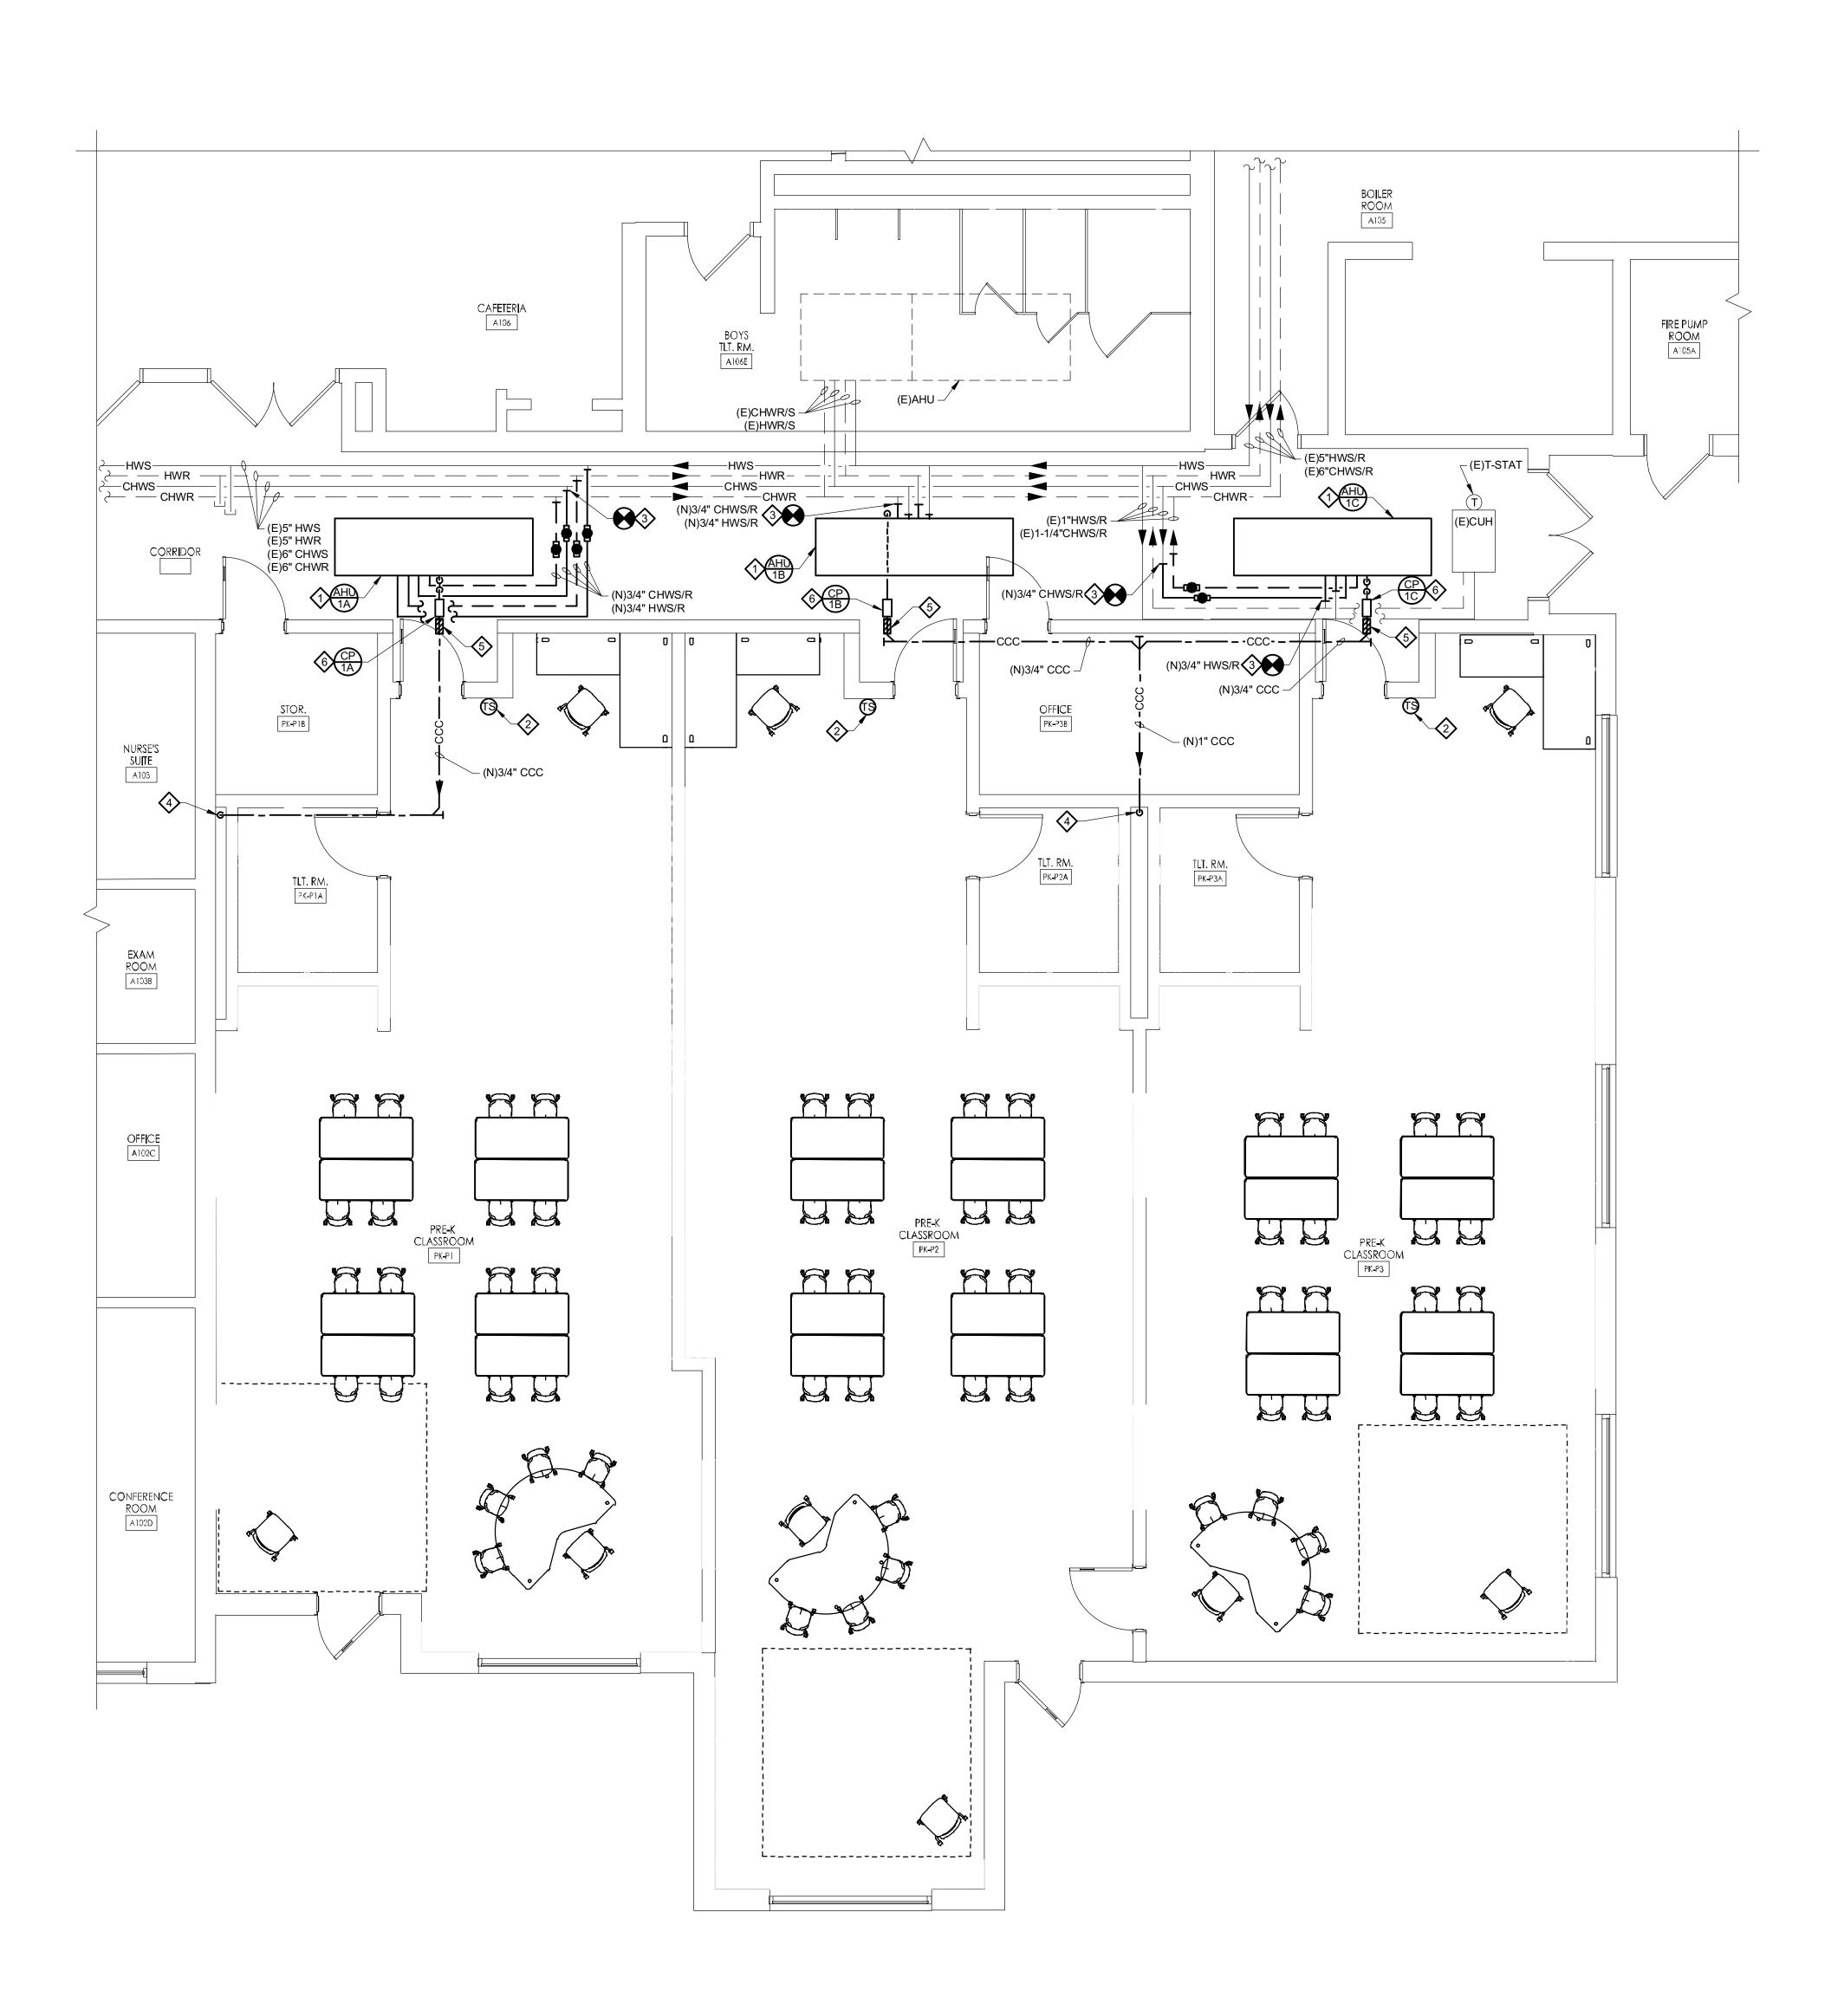

DAVENPORT PRIMARY SCHOOL

H202 P SCALE: 1/4" = 1'-0"

PARTIAL FLOOR PLAN - HVAC NEW WORK - PIPING

NEW WORK NOTES:

- PROVIDE NEW ABOVE CEILING AIR HANDLING UNIT (AHU) AND ALL ASSOCIATED VALVES, HANGERS AND ANCHORS. COORDINATE LOCATION WITH MANUFACTURES CLEARANCE REQUIREMENTS.
- PROVIDE NEW TEMPERATURE SENSOR MOUNTED AT ADA HEIGHT. RETAIN BUILDING CONTROLS CONTRACTOR/VENDOR TO PROVIDE ALL REQUIRED UNIT CONTROLS AND ALL ASSOCIATED CONTROL WIRING. COORDINATE LOCATION WITH ADJACENT WIRING DEVICES.
- EXTEND AND CONNECT NEW PIPING, AS SIZED ON PLAN, WITH SHUTOFF/ISOLATION VALVES TO EXISTING PIPE CONNECTION REMAINING FROM REMOVAL WORK.
- PROVIDE NEW COOLING COIL CONDENSATE PIPING DOWN IN CHASE WITH FUNNEL TRAP, TRAP PRIMER AND PIPE ROUTING. REFER TO PLUMBING DRAWING #1/P201P FOR ADDITIONAL INFORMATION AND FINAL PIPE CONNECTION.
- PROVIDE WALL/FLOOR SLEEVES THROUGH ABOVE AND BELOW GRADE WALLS/FOUNDATIONS FOR ALL PIPE PENETRATIONS. PENETRATION RATING SHALL MATCH EXISTING WALL/FLOOR RATING.
- PROVIDE NEW ABOVE CEILING CONDENSATE PUMP WITH REQUIRED MOUNTING BRACKET, CHECK VALVE, AND OVERFLOW SIGNAL RELAY CONNECTION. MOUNT PUMP TO WALL NEAR LOCATION INDICATED. COORDINATE CONDENSATE PUMP MOUNTING HEIGHT WITH ASSOCIATED EQUIPMENT HEIGHT IN ORDER TO MAINTAIN REQUIRED SLOPE. COORDINATE WITH ELECTRICAL NEW WORK TO PROVIDE HARD WIRED POWER CONNECTION.

Renovations for Five (5) Pre-K Classrooms at Clayton J.

Davenport School

Project Owner Name

Egg Harbor Township School District

Project Location 2501 Spruce Ave, Egg Harbor Township, NJ 08234

11.01.2024

AS NOTED

Drawing Name PRIMARY SCHOOL HVAC NEW WORK -PIPING - FIRST FLOOR PARTIAL PLAN

REFERENCE DIMENSION

INDICATED DIMENSION IS MEASURED AT ONE (1) INCH IN LENGTH AND PROVIDED FOR REFERENCE/VERIFICATION ONLY.

KEY PLAN - PRIMARY

No. Date Description

Gillan & Hartmann, Inc.

MECHANICAL AND ELECTRICAL


CONSULTING ENGINEERS 610-935-0101 FAX: 610-935-7520 215-238-9510 609-347-1593 302-654-5959 gillan-hartmann.com ghmail@gillan-hartmann.com G&H Project No. 2024-147

Drawing Number

NO. 24GE04470000


11/01/2024 ISSUE FOR BID

ENGINEER MICHAEL S. GILLAN, PE

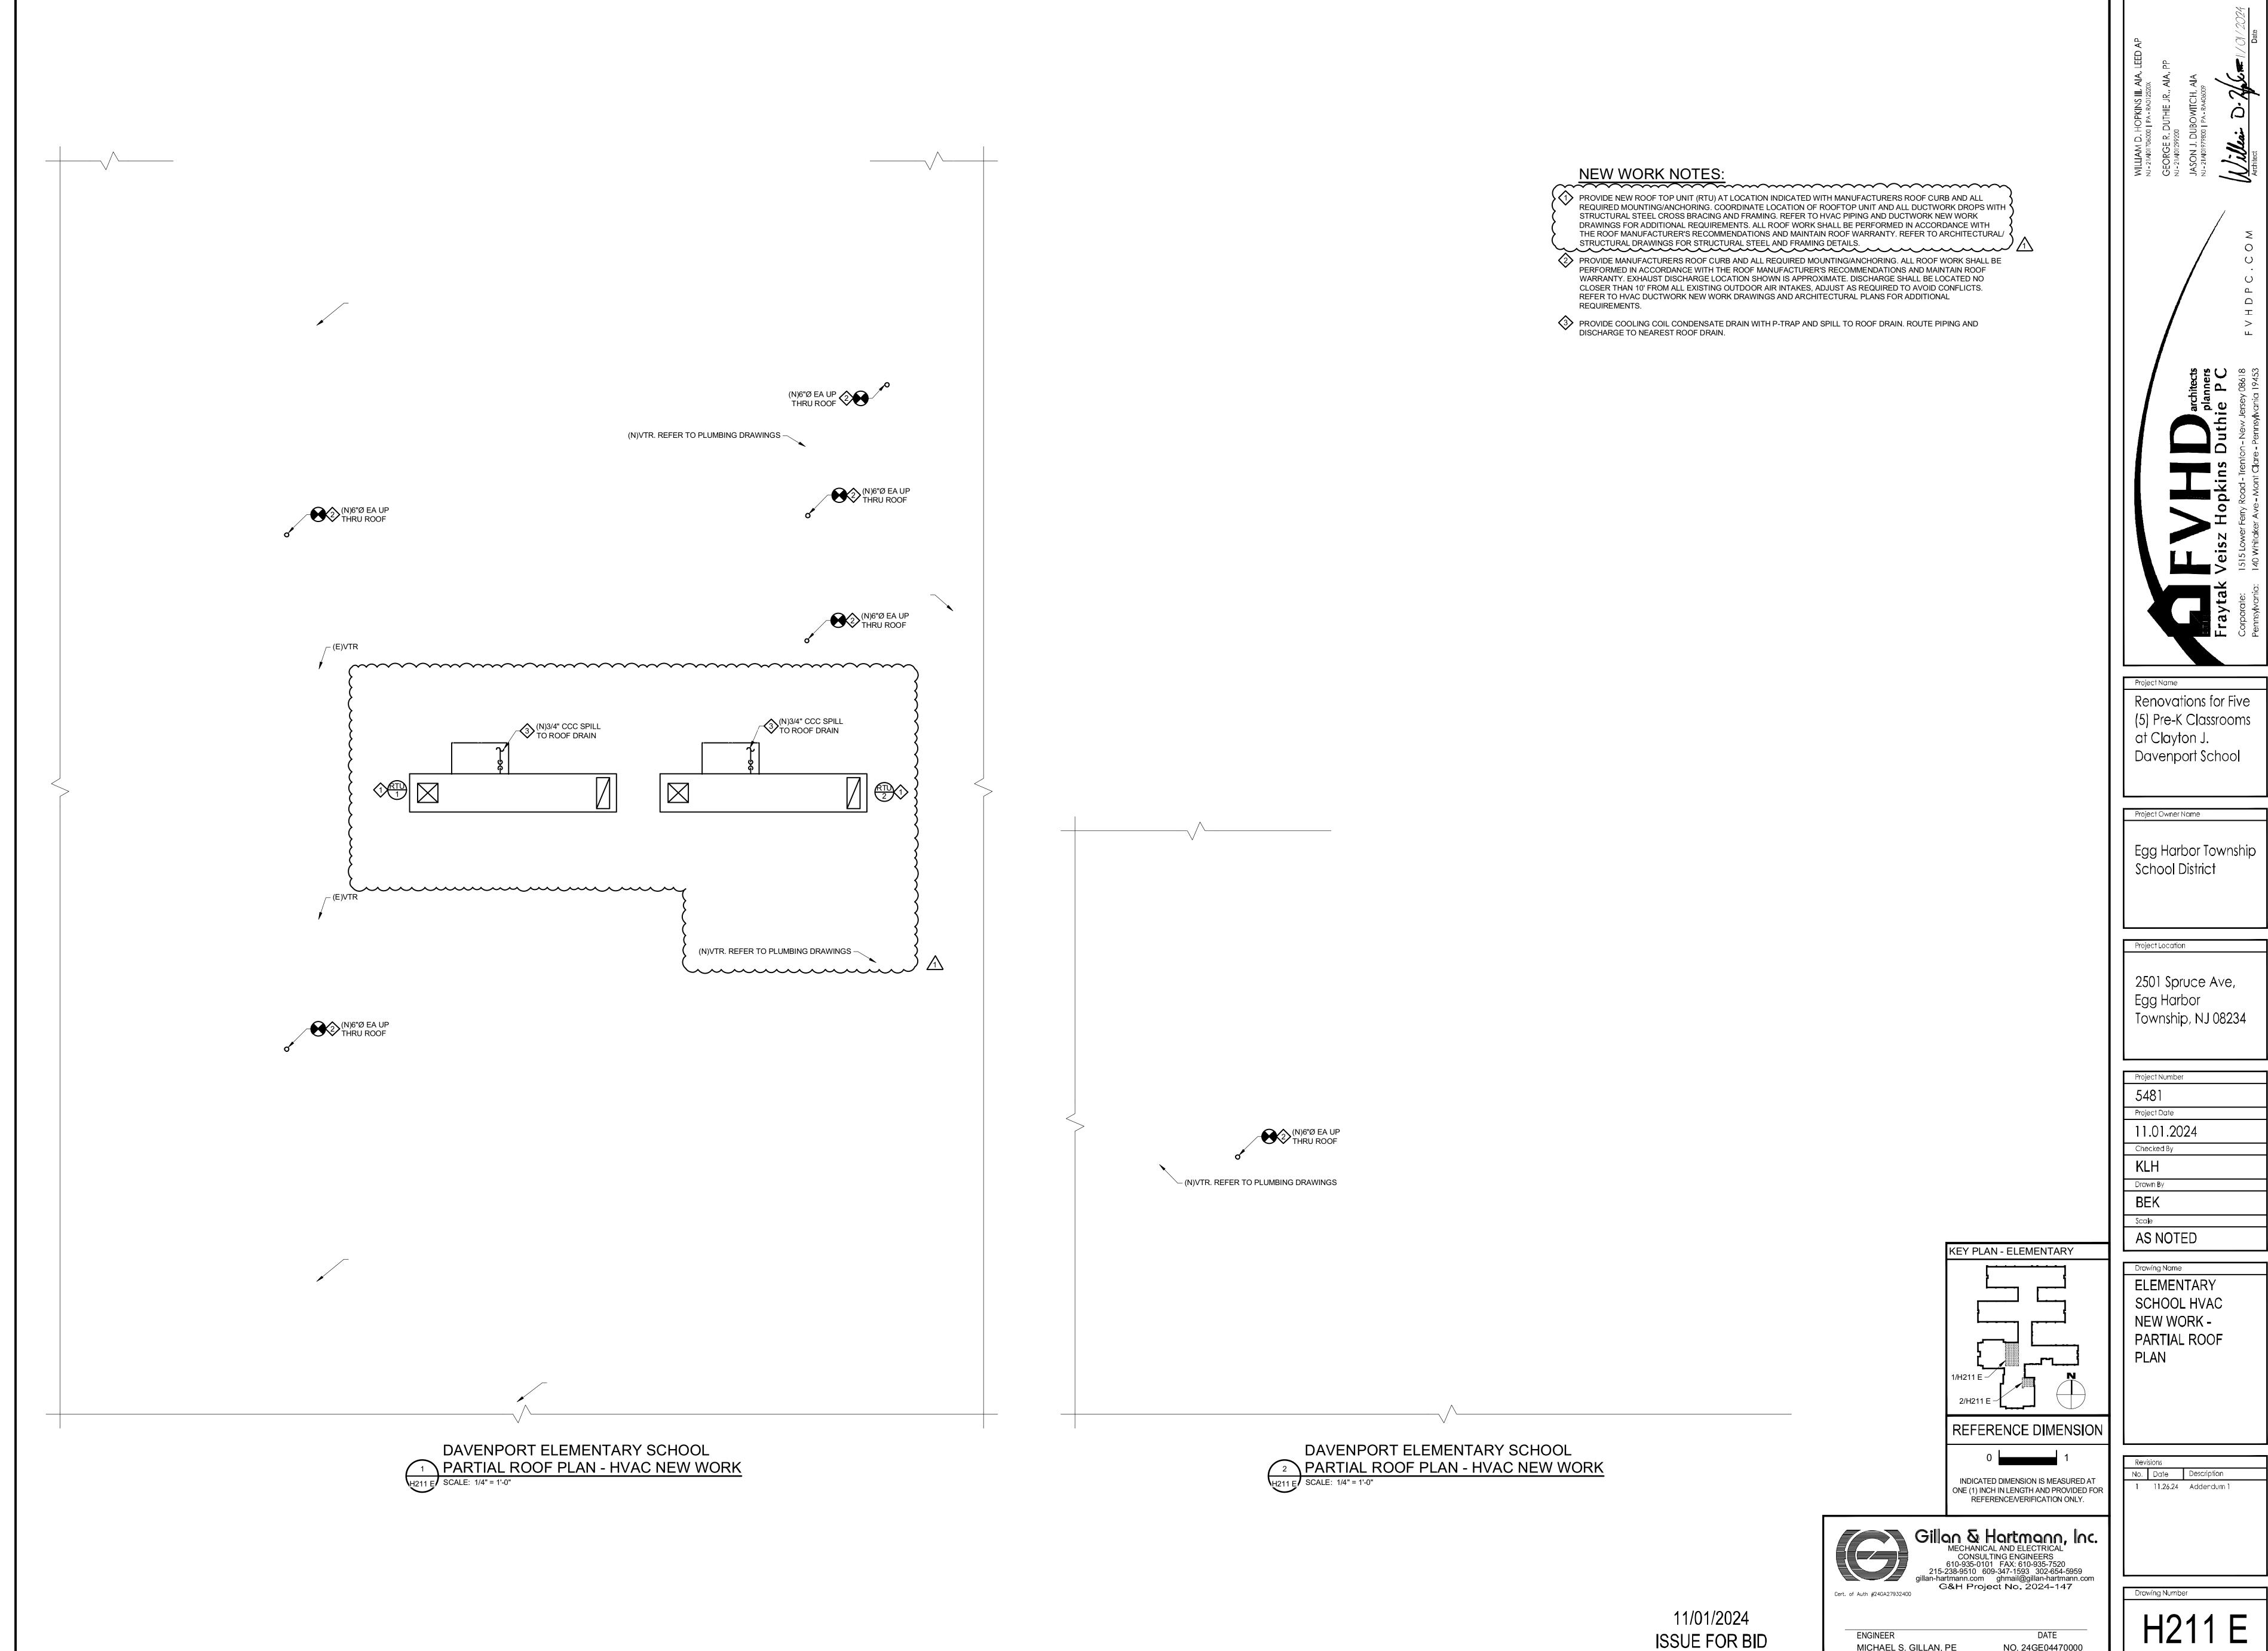


ENGINEER MICHAEL S. GILLAN, PE

DATE NO. 24GE04470000 2024 GILLAN & HARTMANN, Inc.

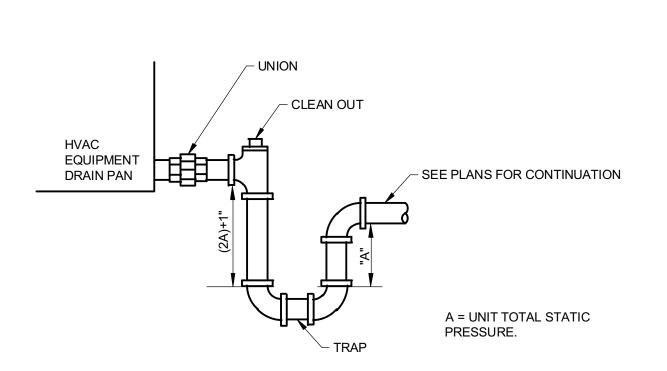


FOR ROOFTOP UNITS TURN PIPING DOWN AND TERMINATE PIPING 3-INCHES ABOVE FINISHED ROOF. PROVIDE 12"Lx12"Wx1/2"H RUBBER PAD FOR CONDENSATE TO SPILL ON, UNLESS OTHERWISE NOTED. COORDINATE PAD REQUIREMENTS TO MAINTAIN EXISTING ROOF WARRANTY. ALL PIPES FULL SIZE OF UNIT OUTLET.


DETAIL - CONDENSATE TRAP

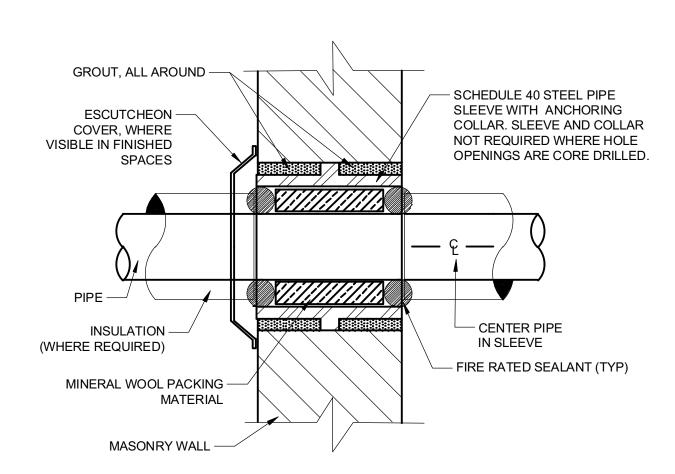

DETAIL - MASONRY WALL PIPE PENETRATION

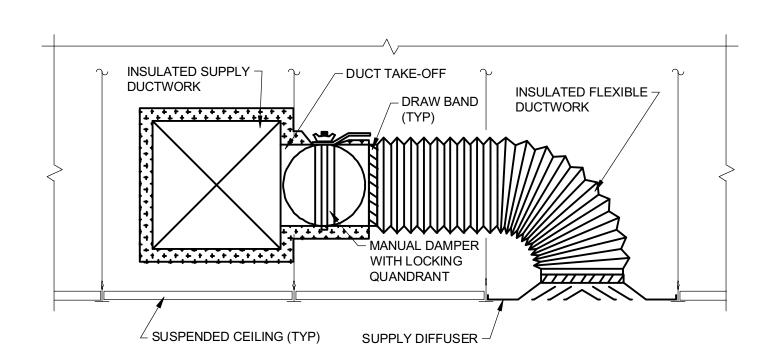


9 DETAIL - FLEXIBLE DUCT CONNECTION TO DIFFUSER

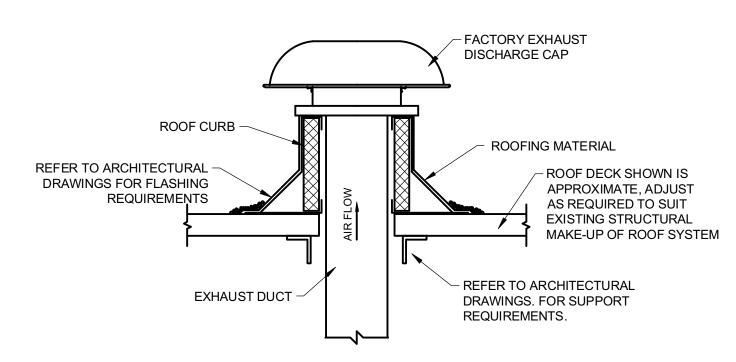


PROVIDE ROOF CURB, COUNTER FLASHING, AND ALL NECESSARY WOOD BLOCKING FOR INSTALLATION AND COORDINATE WITH BUILDING STRUCTURE. PROVIDE BASE FLASHING AND MAKE FINAL CONNECTIONS INTO ROOF ASSEMBLY FOR A COMPLETE WEATHER TIGHT SEAL.


13 DETAIL - DUCT CURB ASSEMBLY & FLASHING H501 NO SCALE

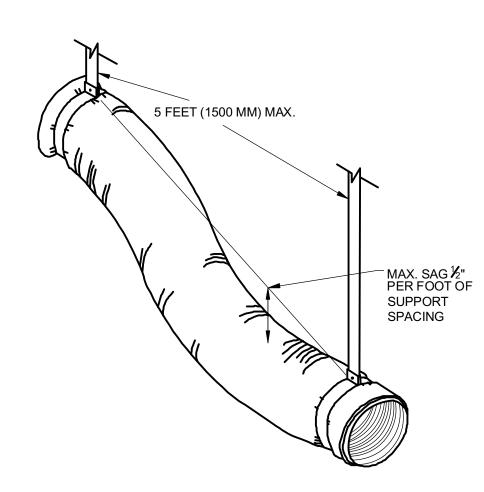


DETAIL - FLEX DUCT SUPPORT

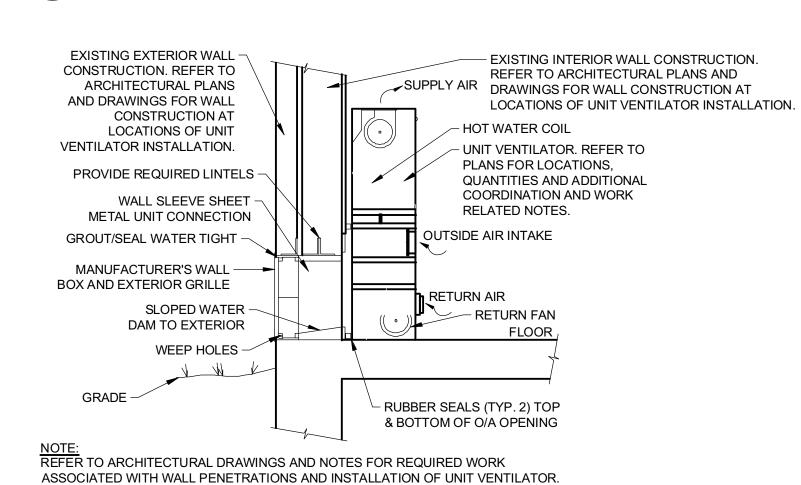

6 DETAIL - UNIT VENTILATOR MOUNTING
NO SCALE

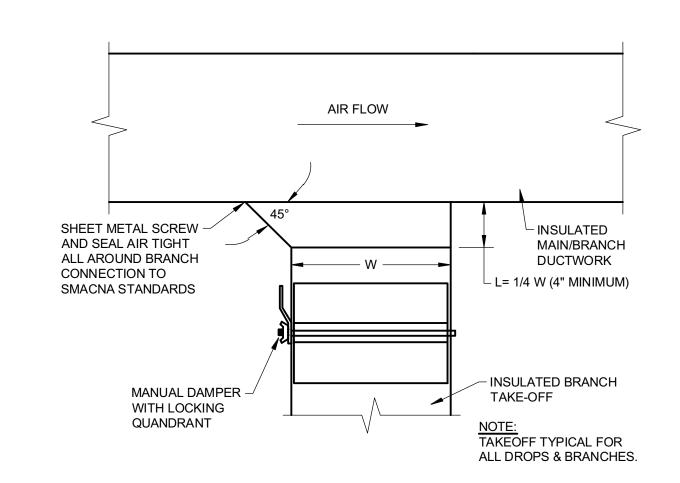


DETAIL - TYPICAL RECTANGLE TAKE-OFF H501 NO SCALE

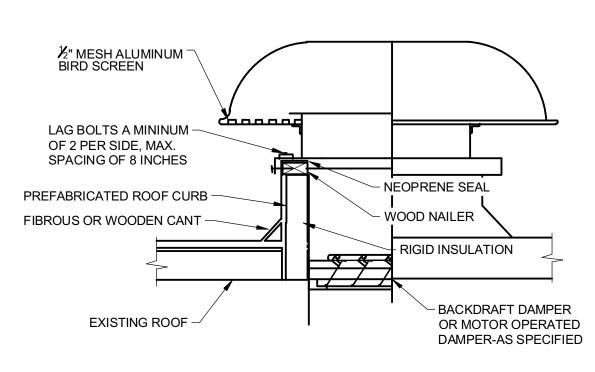


PROVIDE ROOF CURB, COUNTER FLASHING, AND ALL NECESSARY WOOD BLOCKING FOR INSTALLATION AND COORDINATE WITH BUILDING STRUCTURE. PROVIDE BASE FLASHING AND MAKE FINAL CONNECTIONS INTO ROOF ASSEMBLY FOR A COMPLETE WEATHER TIGHT SEAL.


14 DETAIL - GRAVITY ROOF VENTILATOR

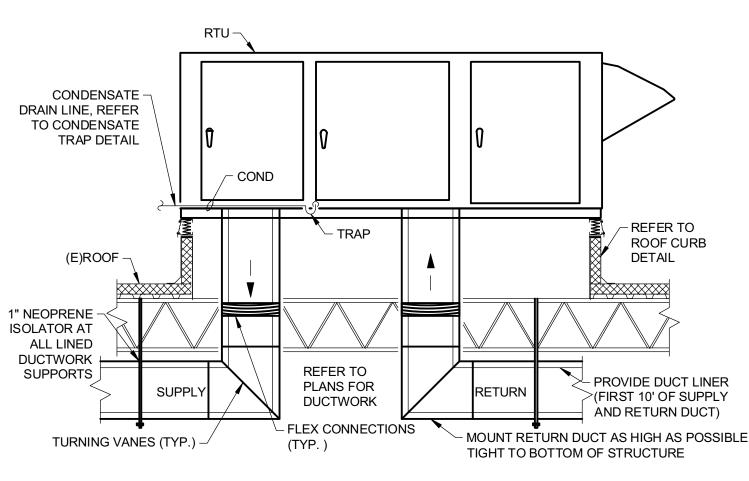

3 DETAIL - ROOFTOP UNIT DETAIL

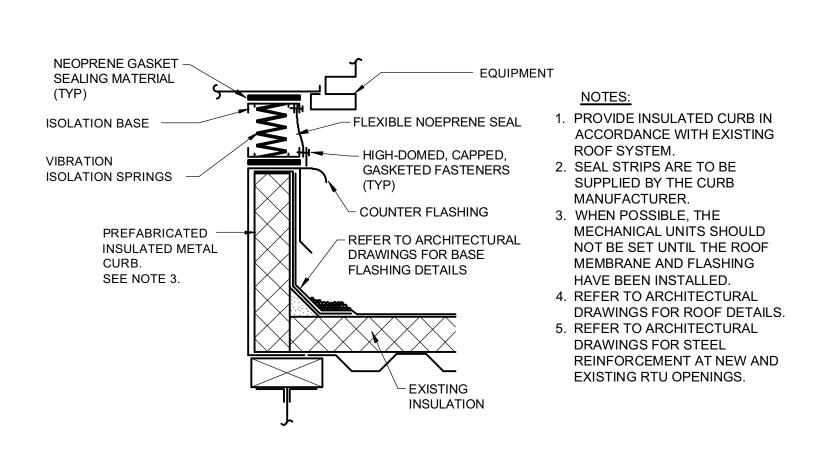


7 DETAIL - ROOF CURB NO SCALE

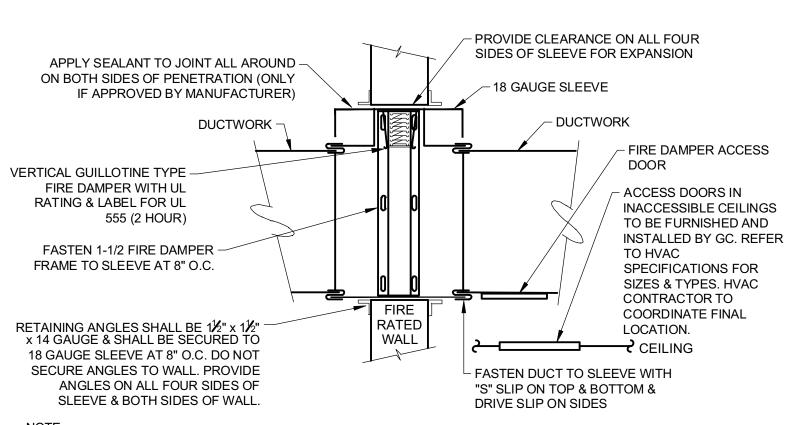


THE FIRE DAMPER MANUFACTURER'S INSTALLATION DETAILS AND INSTRUCTIONS AS TESTED AND APPROVED BY U.L. MUST BE USED IN LIEU OF THIS DETAIL WHERE APPLICABLE.

11 DETAIL - DYNAMIC VERTICAL FIRE DAMPER H501 NO SCALE

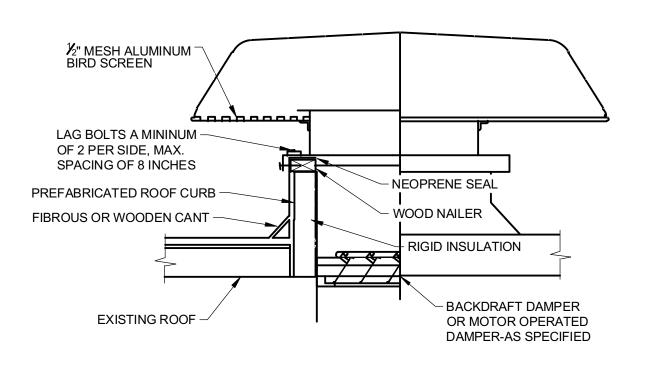


PROVIDE ROOF CURB, COUNTER FLASHING, AND ALL NECESSARY WOOD BLOCKING FOR INSTALLATION AND COORDINATE WITH BUILDING STRUCTURE. PROVIDE BASE FLASHING AND MAKE FINAL CONNECTIONS INTO ROOF ASSEMBLY FOR A COMPLETE WEATHER TIGHT SEAL.


15 DETAIL - GRAVITY ROOF VENTILATOR H501 NO SCALE

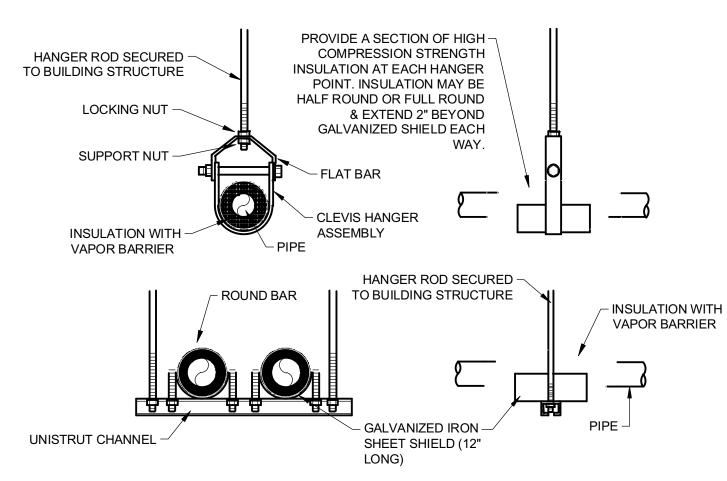

DETAIL-PIPE HANGERS

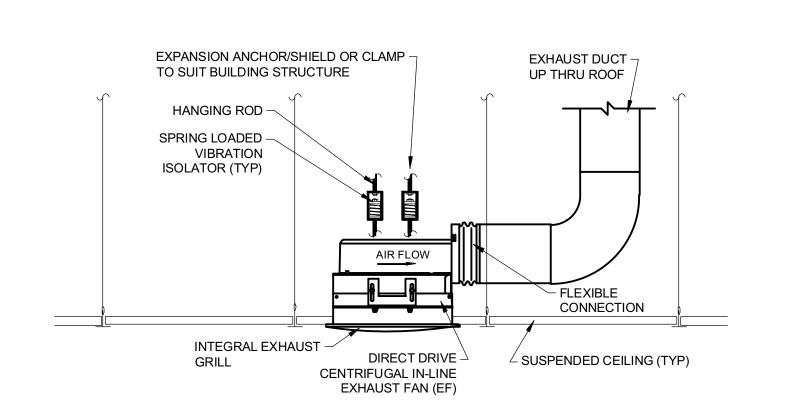

8 DETAIL - CEILING MOUNTED EXHAUST FAN NO SCALE

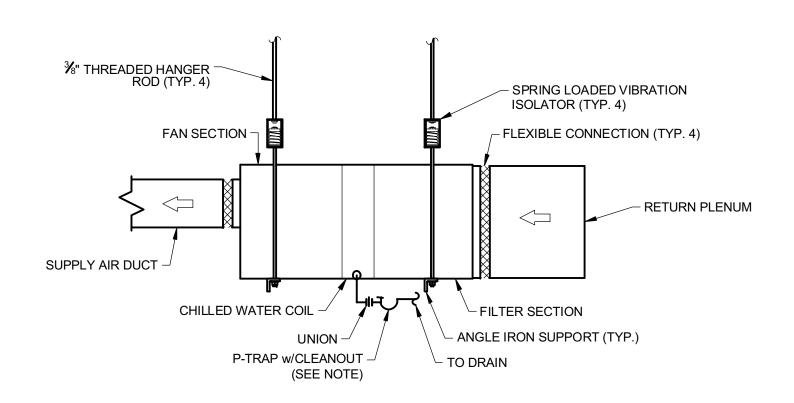

NOTE: CONDENSATE P-TRAP SHALL HAVE SUFFICIENT DEPTH TO OVERCOME UNIT'S STATIC PRESSURE.

DETAIL-TYPICAL AIR HANDLING UNIT MOUNTING

NO SCALE

Renovations for Five

(5) Pre-K Classrooms at Clayton J Davenport School

Project Owner Name

Egg Harbor Township School District

Project Location

2501 Spruce Ave, Egg Harbor Township, NJ 08234

Project Number Project Date 11.01.2024 Checked By Drawn By

\$cale AS NOTED

Drawing Name

HVAC DETAILS

Revisions No. Date Description

ONE (1) INCH IN LENGTH AND PROVIDED FOR REFERENCE/VERIFICATION ONLY. 610-935-0101 FAX: 610-935-7520 215-238-9510 609-347-1593 302-654-5959 gillan-hartmann.com ghmail@gillan-hartmann.com

Drawing Number

ENGINEER MICHAEL S. GILLAN, PE

2024 GILLAN & HARTMANN, Inc.

11/01/2024 ISSUE FOR BID NO. 24GE04470000

REFERENCE DIMENSION

INDICATED DIMENSION IS MEASURED AT

G&H Project No. 2024-147

																			AIF	HAN	DLING	UNIT	ГЅСН	IEDUI	.E																				
				FAN	SECTION									HEATIN	GCOIL												СО	OLING COIL	_						OUTS	SIDE AIR		ELECTI	RICAL CHA	RACTER	ISTICS				
TAG	ADEA SEDVED			STATIC		MOTO	R				AIR TEM	P (°F)			F	CE 1M	ATER TEI	1D (°E)	F	RESS			AIR TEM	P (°F)			TOTAL	SENSIBLE	FACE		W	/ATER		PRESS.	· BAINI	MAX.							BASIS OF DESIGN	MODEL	NOTES
IAG	AREA SERVED	CFM	RPM	PRESS. IN. WG.	OHANTITY	ЦВ	VOLTS	PHASE	OUTSID	E AIR E	ENTERIN	G AIR	LEAVIN	3 AIR	MBH V	EL.	AIER IEI	וור (ר)	GPM	DROP	OUTSIDE	AIR E	ENTERIN	G AIR	LEAVIN	G AIR	MBH	MBH	VEL.	GLYCOL %	TE	MP (°F)	GPM	DROP	CFM	OEM	VOLTS	PHASE	HZ	MOP	MCA	FLA C	SASIS OF DESIGN	MIODEL	NOTES
				TOT. EXT.	QUANTITI	ПГ	VOLIS	FHASE	D.B.	W.B.	D.B.	W.B.	D.B.	W.B.	(F	PM) E	ENT.	LVG.	F	T. WG.	D.B.	W.B.	D.B.	W.B.	D.B.	W.B.	INIDLI	IVIDII	(FPM)		ENT.	LVG.		FT. WG.	. CFIVI	CFIVI									
AHU-1A	P.S. CLASSROOM PK-P1	940	2154	- 1.5	1	0.5	460	3	10	-	48.1	-	81.8	-	38.3	13	180	160	3.9	0.3	93	75	81.3	68.7	59.8	59.6	28.8	22.8	289	30	45	55	5.7	0.1	360	940	460	3	60	15	3.8	3	CARRIER	39MN ((1)(2)(3)(4)
AHU-1B	P.S. CLASSROOM PK-P2	1100	3550	- 1.5	1	0.75	460	3	10	-	49.1	-	84.2	-	43.7	53	180	160	4.2	0.3	93	75	81	68.5	58.9	58.7	33.8	25.8	317	30	45	55	6.7	0.2	365	1100	460	3	60	15	3.8	3	CARRIER	39MN ((1)(2)(3)(4)
AHU-1C	P.S. CLASSROOM PK-P3	1280	2448	- 1.5	1	1	460	3	10	-	52.9	-	86.5	-	50.2	341	180	160	5.1	0.4	93	75	80.1	67.8	58.9	58.6	37.6	29.6	379	30	45	55	7.5	0.3	360	1280	460	3	60	15	3.8	3	CARRIER	39MN ((1)(2)(3)(4)
GENERAL	NOTES:																																												

1. PROVIDE FIELD INSTALLED FUSED DISCONNECT SWITCH AND CONVENIENCE RECEPTACLE.

2. MANUFACTERER PROVIDED REMOTE SAFETY SHUTDOWN TERMINALS AND HIGH CONDENSATE LEVEL SWITCH.

3. MANUFACTURER PROVIDED INTERNAL CONTROL PANEL AND CONTROLS INCLUDING BACNET MSTP CAPABILITY. 4. COORDINATE LEFT / RIGHT HAND COIL CONFIGURATION AND LEFT / RIGHT HAND MIXING BOX CONFIGURATION WITH EXISTING FIELD CONDITIONS TO MAINTAIN EQUIPMENT CLEARANCE.

																					ROOF	TOP (JNIT S	CHE	DULE																				
			SUPPL	Y FAN S	SECTIO	N	RE	ETURN	FAN SEC	TION						HEAT	ING COIL	-											ÇO	OLING COIL							OUTS	SIDE AIR	ELECT	RICAL CHAR	ACTERISTIC	ICS			
TAC	ADEA SERVED				SP [MOTOR				МОТ	OR		AIR TI	EMP (°F)				FACE	WATER 1	ERAD (°E)		PRESS			AIR TEN	/IP (°F)			TOTAL	CENCIDI E	FACE		WA	TER		PRESS.	. BAINI	REAV					ACIE OF DECICAL	MADEL	NOTES
TAG	AREA \$ERVED	CFI	M R	PM	1 18/0	ΝВ	CFM	RPN	VI E.S.F	P	, (OUTSIDE AIR	ENTER	RING AIR	LEAM	NG AIR	MBH	VEL.	WAIER	EWIF (F)	GPM	DROP	OUTSID	E AIR	ENTERI	NG AIR	LEAVIN	G AIR	MARU	SENSIBLE	VEL.	GLYCOL %	TEM	P (°F)	GPM	DROP	CFM	CFM	VOLTS	PHASE	HZ	DA	ASIS OF DESIGN	MODEL	NOTES
				"	V. VVG.	пР				П		D.B. W.B.	D.B.	W.B.	D.B.	W.B.		(FPM)	ENT.	LVG.		FT. WG.	D.B.	W.B.	D.B.	W.B.	D.B.	W.B.	INDU	MIDH	(FPM)		ENT.	LVG.		FT. WG.	. CFIVI	CFM							
RTU-1	E.S. CLASSROOM PK-1	123	0 2	472	2.98	8.0	1240	2099	9 1.88	3 0.5	5	10 -	48.5	-	83.1	•	48.1	589	180	160	4.9	0.6	93	75	81	68.8	58.6	58.5	39.5	29.1	353	30	45	55	8.3	0.5	415	1240	480	3	60		CARRIER	39 M W	(1)(2)(3)
RTU-2	E.S. MUSIC CLASSROOM MC	-1 137	5 2	572	3.04	1	1290	212	3 1.66	0.5	5	10 -	49.8	_	78.9	-	45.7	666	180	160	4.7	0.5	93	75	80.9	68.9	58.6	58.3	46	32.8	399	30	45	55	9.7	2.4	445	1290	480	3	60		CARRIER	39MW	(1)(2)(3)
GENER	AL NOTES:											_																		_									_						

1. PROVIDE FACTORY MOUNTED NON-FUSED DISCONNECT SWITCH AND CONVENIENCE RECEPTACLE OR FIELD INSTALLED FUSED DISCONNECT SWITCH AND CONVINIENCE OUTLET.

2. MANUFACTURER PROVIDED CONTROLS INCLUDING INTEGRATED BACNET CAPABILITY.

3. HYDRONIC CONTROL VALVES AND ALL ASSOCIATED APPURTENANCES TO BE FIELD PROVIDED AND FIELD INSTALLED BY CONTROLS CONTRACTOR.

												UNIT V	ENTIL	ATOR SO	HEDULE														
			F	AN						LING			_			Н	EATING COIL					ELECTRI	CAI		OUTSIE	E AIR			
TAG	AREA SERVED	ORIENTATION	0514		TOTAL	SENSIBLE	ENTERIN	I .	LEAVING AIR	01.74001.0	, ENT. WATER	LEAVING	0.011	WPD TO	AL ENT AIR	LEAVING AIR	ENT. WATER	LEAVING	000	WPD	C	HARACTER			MIN.	MAX.	BASIS OF DESIGN	MODEL	NOTES
			CFM	E.S.P.	МВН	МВН	D.B.	W.B.	TEMP (°F) D.B. W.B.	GLYCOL %	TEMP (°F)	WATER TEMP (°F)	GPM	FT. HD. ME	BH TEMP(°F)	TEMP(°F)	TEMP (°F)	WATER TEMP (°F)	GPM	FT. HD.	VOLTS	PHASE	MCA	МОР	CFM.	CFM.			
UV-1	E.S. CLASSROOM PK-2	VERTICAL	1260	0.5	53.7	35.7	80.5	67.9	54.6 54.1	30	44	54	10.7	4.3 55	.4 51.2	91.8	180	160	5.7	1.0	120	1	12.75	15	365	1260	CHANGEAIR	CAH	(1)(2)(3)(4)
GENE	AL NOTES:																										_		

1. PROVIDE MATCHING DUCT SHROUD, TRIM PANELS, WALL SLEEVE, EXTERIOR WALL LOUVER AS SPECIFIED.

PROVIDE FACTORY NON-FUSED DISCONNECT SWITCH.

PROVIDE OPTION 1 (CLASS DEFAULT) IQ SOUND PACKAGE. MANUFACTURER PROVIDED VALVE PACKAGE SHIPPED LOOSE TO BE FIELD INSTALLED.

			AIR DEVIC	E SCHE	DULE					
REF. NO.	TYPE	LOCATION	BLOW PATTERN	NECK SIZE	CFM	MAX PD [IN. W.G.]	MAX NECK VELOCITY [FPM]	BASIS OF DESIGN	MODEL	NOTES
A	SUPPLY DIFFUSER	CEILING	4 WAY	SEE PLANS	SEE PLANS	80.0	500	TITUS	TMS	(1)(2)(3)(4)
В	RETURN/EXHAUST REGISTER	WALL/CEILING	-	SEE PLANS	SEE PLANS	0.08	500	TITUS	300RL	(1)(4)

GENERAL NOTES:

FINISH COLOR TO BE APPROVED BY THE ARCHITECT.

PROVIDE OPPOSED BLADE BALANCING DAMPER IN DEVICE, ADJUSTABLE FROM THE FRONT FACE.

3. ALL DIFFUSERS TO BE 4 WAY BLOW PATTER UNLESS NOTED OTHERWISE ON PLANS.

4. PROVIDE FINAL BOARDER/MOUNTING WITH CEILING TYPE.

				EXHA	UST F	AN S	CHEDUL	.E			
			EXTERNAL		мото	OR INFOR	RMATION				
REF. NO.	AREA SERVED	CFM	STATIC PRESSURE (IN. WC.)	DRIVE	WATTS	V/C/P	FAN RPM	TYPE	BASIS OF DESIGN	MODEL	NOTES
EF-1	E.S. TOILET ROOM PK-2A	50	0.12	DIRECT	21	115/60/1	550	CEILING	LOREN COOK	GC-126	(1)(2)(3)(4)(5)
EF-2	E.S. TOILET ROOMPK-1A	50	0.12	DIREÇT	21	115/60/1	550	CEILING	LOREN COOK	GC-126	(1)(2)(3)(4)(5)
EF-3	E.S. TOILET ROOMTR-1A	50	0.12	DIREÇT	21	115/60/1	550	CEILING	LOREN COOK	GC-126	(1)(2)(3)(4)(5)
EF-4	E.S. TOILET ROOMTR-1B	50	0.12	DIRECT	21	115/60/1	550	CEILING	LOREN COOK	GC-126	(1)(2)(3)(4)(5)
EF-5	E.S. EXISTING TOILET ROOM	50	0.12	DIRECT	21	115/60/1	550	CEILING	LOREN COOK	GC-126	(1)(2)(3)(4)(5)
EF-6	E.S. EXISTING TOILET ROOM	50	0.12	DIRECT	21	115/60/1	550	CEILING	LOREN COOK	GC-126	(1)(2)(3)(4)(5)

4. PROVIDE MANUFACTURER'S HANGING ISOLATOR KIT WITH SPRING ISOLATORS.5. PROVIDE MANUFACTURER'S ALUMINUM BACK DRAFT DAMPER.

			EXTERNAL		MOTO	OR INFOR	RMATION				I	
REF. NO.	AREA SERVED	CFM	STATIC PRESSURE (IN. WC.)	DRIVE	WATTS	V/C/P	FAN RPM	TYPE	BASIS OF DESIGN	MODEL	NOTES	
EF-1	E.S. TOILET ROOM PK-2A	50	0.12	DIRECT	21	115/60/1	550	CEILING	LOREN COOK	GC-126	(1)(2)(3)(4)(5)	
EF-2	E.S. TOILET ROOMPK-1A	50	0.12	DIREÇT	21	115/60/1	550	CEILING	LOREN COOK	GC-126	(1)(2)(3)(4)(5)	
EF-3	E.S. TOILET ROOMTR-1A	50	0.12	DIRECT	21	115/60/1	550	CEILING	LOREN COOK	GC-126	(1)(2)(3)(4)(5)	
EF-4	E.S. TOILET ROOMTR-1B	50	0.12	DIRECT	21	115/60/1	550	CEILING	LOREN COOK	GC-126	(1)(2)(3)(4)(5)	
EF-5	E.S. EXISTING TOILET ROOM	50	0.12	DIRECT	21	115/60/1	550	CEILING	LOREN COOK	GC-126	(1)(2)(3)(4)(5)	
EF-6	E.S. EXISTING TOILET ROOM	50	0.12	DIRECT	21	115/60/1	550	CEILING	LOREN COOK	GC-126	(1)(2)(3)(4)(5)	
GENERAL	NOTES:											
1.	COORDINATE ALL ELECTRICA	L REQUI	REMENTS WITH	THE ELEC	TRIÇAL Ç	ONTRAC	TOR.					
2.	STATIC PRESSURE VALUE INC	LDUES L	OSS FROM FAN	I MANUFAC	TURER'S	GRILLE A	ND BACKDE	RAFT DAMP	ER.			
3.	PROVIDE MANUFACTURER'S F	ROOF CU	RB AND CURB I	DISCHARG	E CAP WI	TH BIRD S	SCREEN.					
4.	PROVIDE MANUFACTURER'S H	HANGING	ISOLATOR KIT V	WITH SPRIN	NG ISOLA	TORS.						

			VE	NTILATIO	N SCHE	OULE - ES						
RM	ROOM	SQ.	NO. OF			CFM REQUIRED				CFM F	URNISHED	
NO.	NAME	FT.	PEOPLE	CFM/PERSON	CFM/FT^2	EFFECTIVENESS	O/A	EXHAUST	SUPPLY	RETURN	EXHAUST	O/A
PK-1	PRE-K CLASSROOM	947	20	10	0.12	0.8	392	-	880	880	0	392
-	EXISTING OFFICE	168	2	5	0.06	0.8	25	-	150	150	0	30
-	EXISTING TOILET ROOM	42	1	-	-	8.0	-	50	35	0	50	7
-	EXISTING STORAGE	52	0	-	0.12	0.8	-	-	30	30	0	6
PK-1B	STORAGE	55	0	-	0.12	0.8	-	-	30	30	0	6
PK-1A	TOILET ROOM	75	1	-	-	0.8	-	50	35	0	50	7
TR-1A	TOILET ROOM	70	1	-	-	0.8	-	50	35	0	50	7
TR-1B	TOILET ROOM	70	1	-	_	8.0	-	50	35	0	50	7
MC-1	MUSIC CLASSROOM	1,229	25	10	0.06	0.8	405	-	960	960	0	405
-	EXISTING STORAGE	54	0	-	0.12	0.8	-	-	30	30	0	6
-	EXISTING TOILET ROOM	42	1	-	-	8.0	-	50	35	0	50	7
-	EXISTING OFFICE	168	2	5	0.06	0.8	25		150	150	0	30
-	CORRIDOR	570	2	-	0.06	0.8	-	-	200	200	0	40
PK-2	PRE-K CLASSROOM	1,056	20	10	0.12	0.8	408	_	1,190	1,190	0	408
PK-2A	TOILET ROOM	70	1	-	-	0.8	-	50	40	0	50	8
PK-2B	STORAGE	88	0	-	0.12	0.8	-	_	30	0	0	6

				CONDEN	יו אט	L I GIV	001				
					М	IOTOR INI	FORMATIO	N			
TAG	ASSOCIATED EQUIPMENT	GPH	FT. HEAD	TANK SIZE	НР	VOLTS	PHASE	HZ	BASIS OF DESIGN	MODEL	NOTES
CP-1A	AHU-1A	25	10	1/2 GALLON	1/50	115	1	60	LITTLE GIANT	VCMA-15UL	(1)(2)(3)
CP-1B	AHŲ-1B	25	10	1/2 GALLON	1/50	115	1	60	LITTLE GIANT	VCMA-15UL	(1)(2)(3)
CP-1C	AHU-1C	25	10	1/2 GALLON	1/50	115	1	60	LITTLE GIANT	VCMA-15UL	(1)(2)(3)
					GEN	IERAL NO	TES:				

2. PROVIDE WALL MOUNTING BRACKET FOR INSTALLATION ABOVE CEILING. 3. PROVIDE MANUFACTURER'S OVERFLOW SIGNAL RELAY CONNECTION AND CHECK VALVE.

		GR/	AVITY RO	OF VENT	ILATION	SCHE	DULE			
TAG	AREA SERVING	MAX. CFM	MAX PRESS. DROP IN. WG.	THROAT VELOCITY FPM	ROOF OPENING	HOOD SIZE	INTAKE OR RELIEF	BASIS OF DESIGN	MODEL	NOTES
GRV-1	CORRIDOR	3,320	0.042	455.4	36.5	56.25	RELIEF	GREENHECK	GRSR 36	(1)(2)
GRV-2	PRE-K CLASSROOM PK-P1	940	0.025	470	12x24	28x39	INTAKE	GREENHECK	FGI	(1)(2)(3)
GRV-3	PRE-K CLASSROOM PK-P2	1,100	0.017	440	12x30	27x51	INTAKE	GREENHECK	FGI	(1)(2)(3)
GRV-4	PRE-K CLASSROOM PK-P3	1,280	0.026	427	12x36	31x51	INTAKE	GREENHECK	FGI	(1)(2)(3)

PROVIDE MANUFACTURER'S ROOF CURB AND BIRD SCREEN.

2. MANUFACTURER PROVIDED GRAVITY DAMPER SHIPPED LOOSE FOR FIELD ISNTALLATION. GRAVITY DAMPER TO BE INSTALLED IN MANUFACTURER PROVIDED DAMPER TRAY LOCATED IN ROOF CURB.

3. MANUFACTURER PROVIDED ALUMINUM MESH FILTER.

			VE	NTILATIO	N SCHEE	OULE - ES						
RM	ROOM	SQ.	NO. OF		I	CFM REQUIRED				CFM F	URNISHED	
NO.	NAME	FT.	PEOPLE	CFM/PERSON	CFM/FT^2	EFFECTIVENESS	O/A	EXHAUST	SUPPLY	RETURN	EXHAUST	O/A
PK-P1	PRE-K CLASSROOM	930	20	10	0.12	0.8	390	-	870	870	0	390
PK-P1A	TOILET ROOM	70	1	-	-	0.8	-	50	40	0	75	0
PK-P1B	STORAGE	65	0	5	0.06	0.8	5	-	30	30	0	5
PK-P2	PRE-K CLASSROOM	1,065	20	10	0.12	0.8	4 10	-	885	885	0	410
PK-P2A	TOILET ROOM	70	1	-	-	0.8	-	50	40	0	75	0
PK-P3	PRE-K CLASSROOM	930	20	10	0.12	0.8	390	-	1,140	1,140	0	390
PK-P3A	TOILET ROOM	70	1	-	-	0.8	-	50	40	0	75	0
PK-P3B	OFFICE	130	2	5	0.06	0.8	22	-	100	100	-	22

REFERENCE DIMENSION INDICATED DIMENSION IS MEASURED AT ONE (1) INCH IN LENGTH AND PROVIDED FOR

REFERENCE/VERIFICATION ONLY.

DATE

NO. 24GE04470000

Gillan & Hartmann, Inc.

MECHANICAL AND ELECTRICAL

CONSULTING ENGINEERS

AND ELECTRICAL

CONSULTING ENGINEERS 610-935-0101 FAX: 610-935-7520 215-238-9510 609-347-1593 302-654-5959 gillan-hartmann.com ghmail@gillan-hartmann.com G&H Project No. 2024-147

Drawing Number

Revisions

No. Date Description

Project Name

at Clayton J.

Project Owner Name

School District

Project Location

Egg Harbor

Project Number

11.01.2024

AS NOTED

Drawing Name

SCHEDULES

Checked By

Drawn By

2501 Spruce Ave,

Township, NJ 08234

Renovations for Five


(5) Pre-K Classrooms

Davenport School

Egg Harbor Township

11/01/2024 ISSUE FOR BID ENGINEER

MICHAEL S. GILLAN, PE 2024 GILLAN & HARTMANN, Inc.

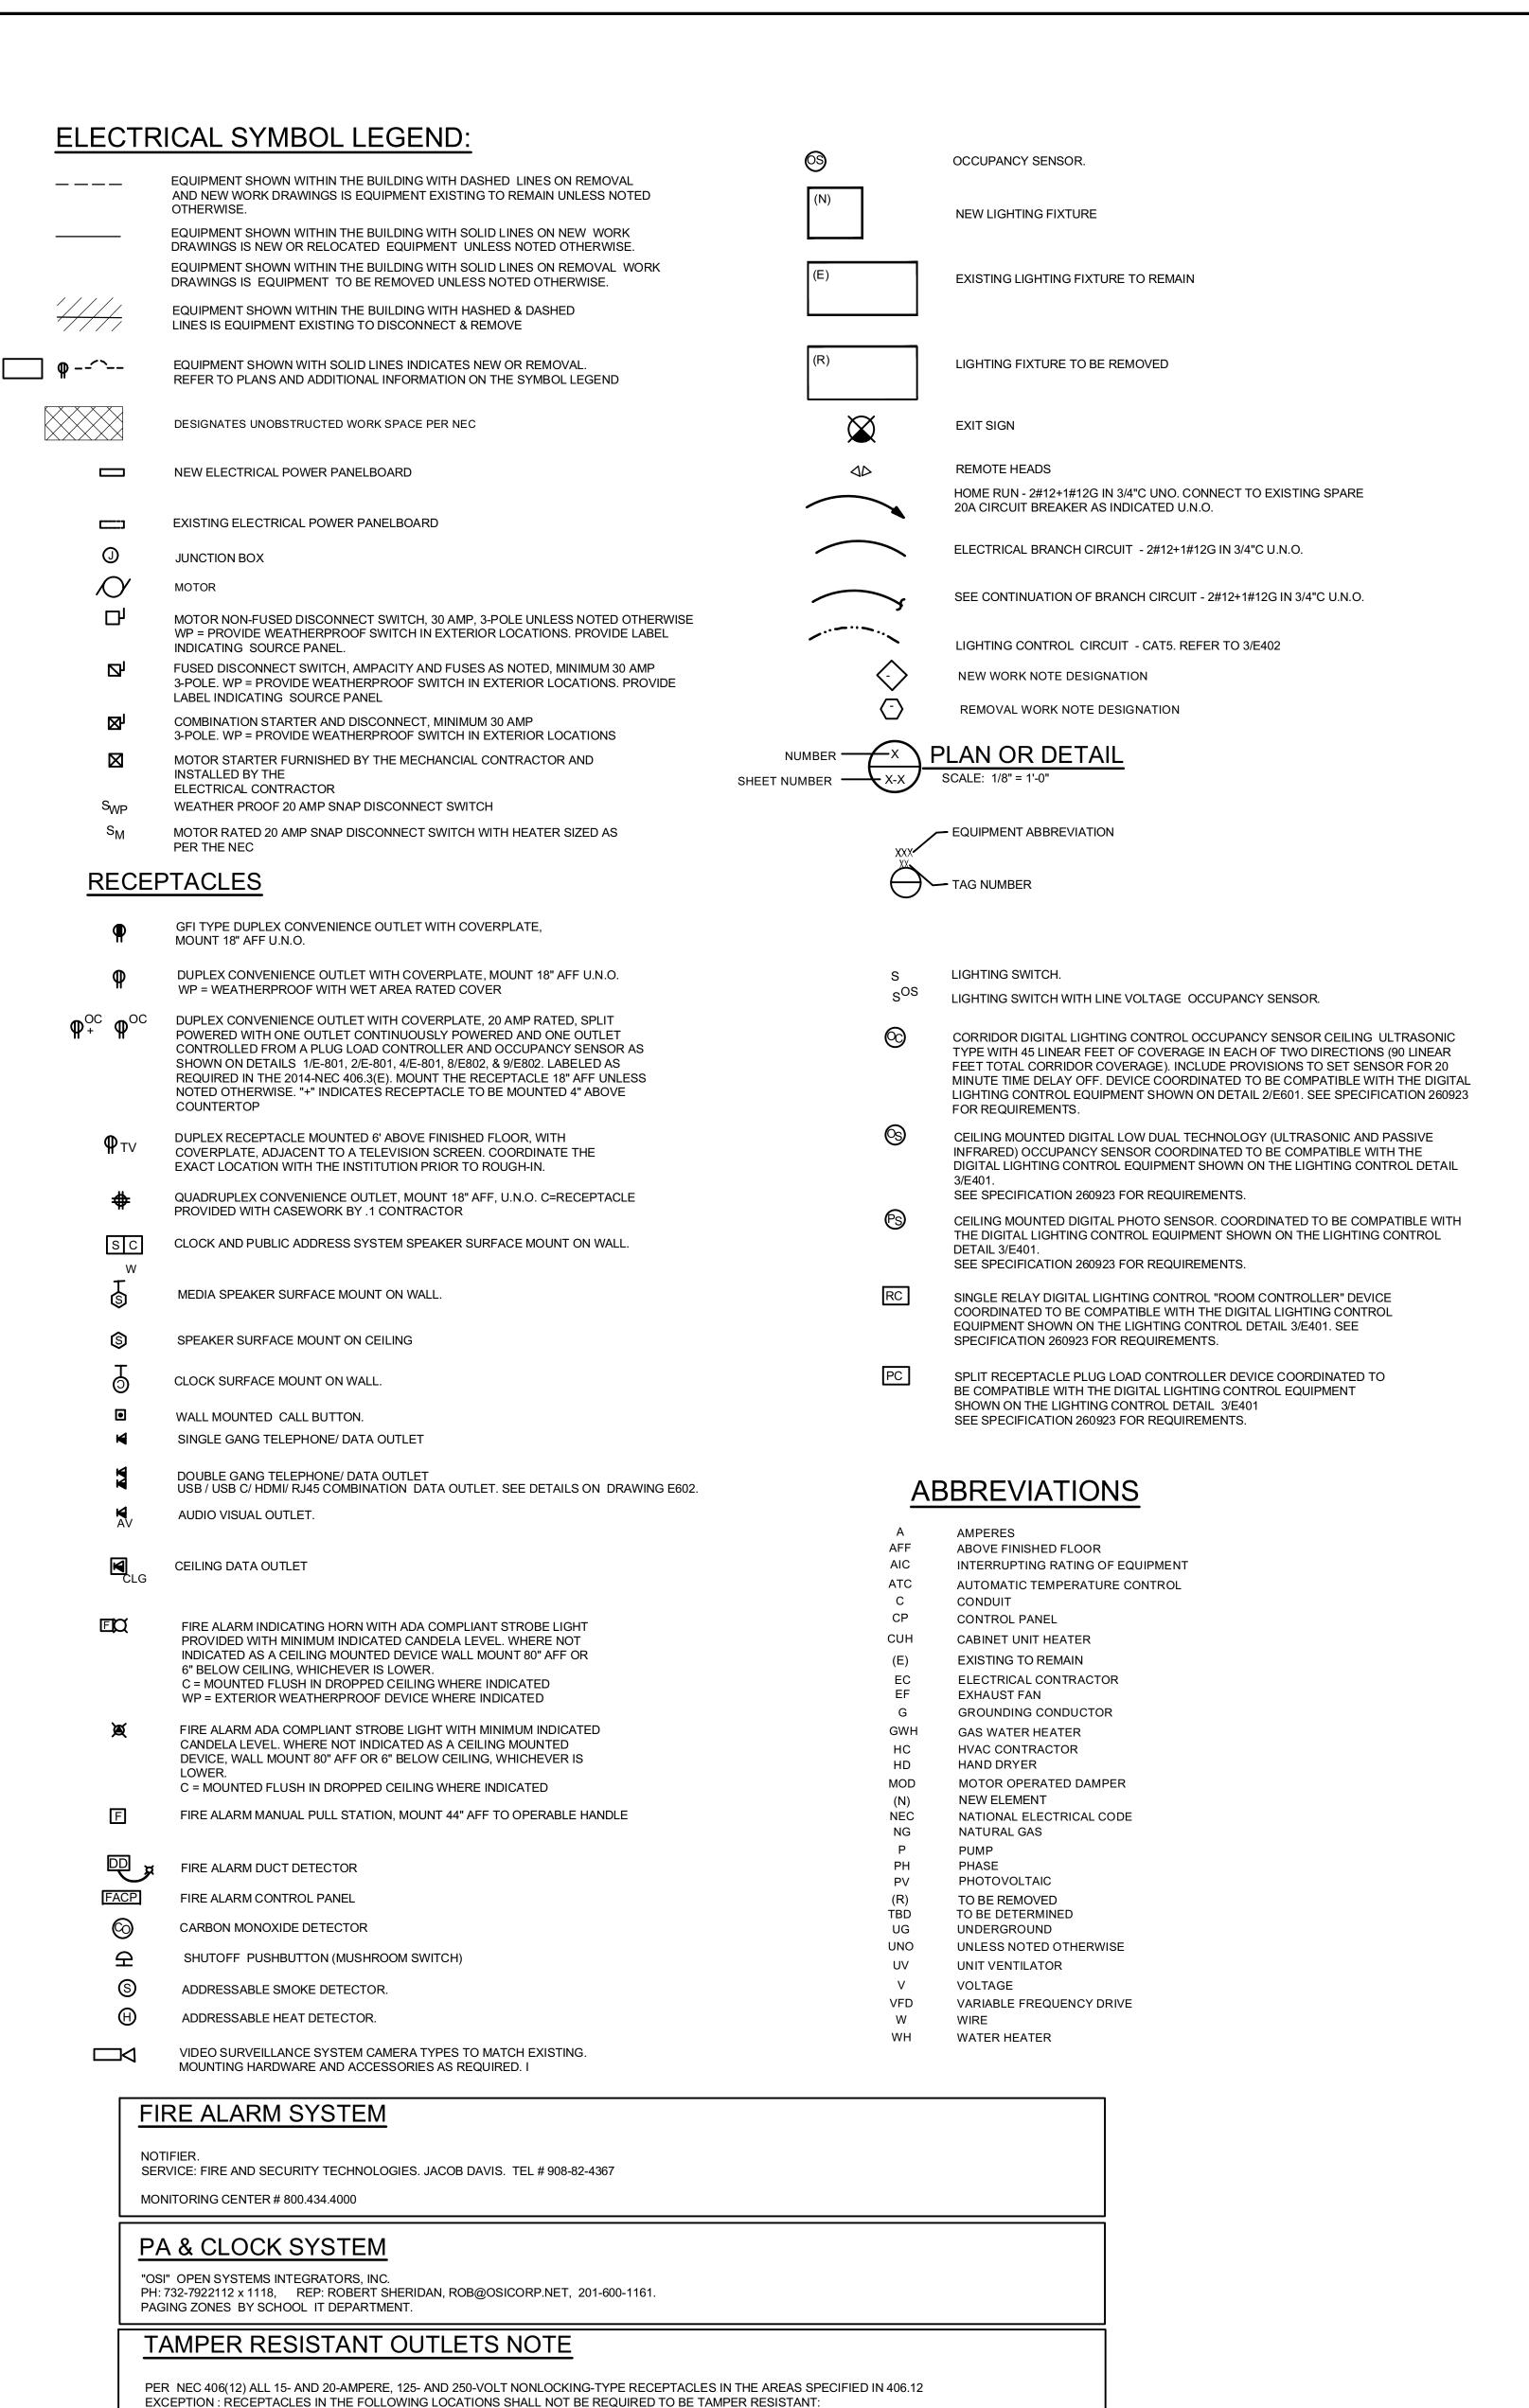

(1) RECEPTACLES LOCATED MORE THAN 1.7 M (5 ½ FT) ABOVE THE FLOOR

(3) A SINGLE RECEPTACLE OR A DUPLEX RECEPTACLE FOR TWO APPLIANCES LOCATED WITHIN THE DEDICATED SPACE FOR EACH APPLIANCE THAT, IN

NORMAL USE. IS NOT EASILY MOVED FROM ONE PLACE TO ANOTHER AND THAT IS CORD-AND-PLUG-CONNECTED IN ACCORDANCE WITH 400.10(A)(6).

(2) RECEPTACLES THAT ARE PART OF A LUMINAIRE OR APPLIANCE

(A)(7), OR (A)(8)

GENERAL ELECTRICAL NOTES

- (GENERAL NOTES APPLY TO ALL ELECTRICAL DRAWINGS)
- COORDINATE THE LOCATIONS OF EQUIPMENT AND ROUTING OF ELECTRICAL WIRING WITH THE TRADE DRAWINGS AND INSTALLING CONTRACTOR FOR THE MECHANICAL AND PLUMBING EQUIPMENT PRIOR TO INSTALLATION.
- PROVIDE MINIMUM 2#10AWG+1#12AWG WIRING FOR ALL 20A BRANCH CIRCUITS LONGER THAN 100 FEET. PRICE FOR 10 ADDITIONAL 20A, 120V BRANCH CIRCUITS EACH 100FEET LONG.
- 3. ALL EQUIPMENT IDENTIFICATION LABELS AND ALL FINAL ELECTRICAL PANEL SCHEDULES (FOR NEW AND EXISTING PANELS USED ON THIS PROJECT) ARE TO BE UPDATED AND CONFORM TO THE OWNER'S ROOM NUMBERS AND ROOM

ROOM NUMBERS AND NAMES PRIOR TO THE START OF WORK.

4. ALL WORK MUST COMPLY WITH THE NATIONAL ELECTRICAL CODE 2020 EDITION.

NAMES. COORDINATE WITH THE OWNER AND ARCHITECT TO CONFIRM ACTUAL

- WHERE REQUIRED, REMOVE AND REPLACE EXISTING CEILING TILES AND CEILING MOUNTED EQUIPMENT AS REQUIRED FOR ALL ELECTRICAL WORK.
- 6. PERFORM ALL CUTTING, PATCHING, AND PAINTING NECESSARY TO PERFORM WORK. MATCH EXISTING MATERIALS, FINISHES, FIRE RATINGS, PAINT COLORS, ETC. IN ALL AREAS OF PATCHING.
- 7. FOR ALL EXISTING PANELBOARDS USED ON THIS PROJECT PROVIDE A NEW TYPED PANELBOARD SCHEDULE THAT INCLUDES THE SAME INFORMATION FOR CIRCUITS NOT CHANGED ON THIS PROJECT AND THE NEW HVAC TAG NUMBERS
- 8. PROVIDE PIPE SLEEVES FOR INSTALLATION OF RACEWAYS AND CABLES THROUGH FIRE RATED WALLS AND CEILING SLABS. ALL CORRIDOR WALL AND CEILING SLABS SHALL BE ASSUMED TO BE 1-1/2 HOUR. FOR ALL PENETRATIONS PROVIDE FIRE STOPPING USING A UL APPROVED ASSEMBLY FOR THE RESPECTIVE WALL OR SLAB CONSTRUCTION. REFER TO THE ARCHITECTURAL DOCUMENTS FOR WALL FIRE RATINGS.
- 9. PROVIDE FIRE PROOFING AT WALL PENETRATIONS.

AND APPLICABLE ROOM NUMBERS.


- 10. ELECTRICAL CONDUITS AND DEVICE LAYOUTS ARE SCHEMATIC IN NATURE. PROVIDE OFFSETS AND FITTINGS AS REQUIRED TO ACCOMMODATE FIELD CONDITIONS AND ALL TRADE WORK BY OTHERS.
- 11. ALL WORK SHALL COMPLY WITH THE STANDARDS OF THE AMERICAN INSURANCE ASSOCIATION, XL GLOBAL, FM GLOBAL, OR THE APPLICABLE RATING BUREAU, THE NATIONAL ELECTRICAL CODE (NEC), AND THE OCCUPATIONAL SAFETY AND HEALTH ADMINISTRATION (OSHA), AND ALL OTHER APPLICABLE FEDERAL, STATE, AND LOCAL BUILDING CODES AND THE REQUIREMENTS OF THE PUBLIC UTILITY COMPANIES SERVING THE SITE.
- 12. ENSURE ALL WORK IS IN CONFORMANCE WITH ALL APPLICABLE BUILDING CODES. WORK SHALL BE COMPLETED IN STRICT ACCORDANCE WITH THE LATEST EDITIONS OF THE APPLICABLE CONSTRUCTION CODE. AND ALL OTHER FEDERAL, STATE, AND LOCAL AGENCY REGULATIONS HAVING JURISDICTION OVER THIS PROJECT. IN THE EVENT OF ANY DISCREPANCIES BETWEEN AGENCY REQUIREMENTS. OBSERVE THE MORE STRINGENT OF REQUIREMENTS.
- 13. FOR ALL HVAC EQUIPMENT BRANCH CIRCUITS INCLUDED IN THE REMOVAL AND NEW WORK PROCESS OF THIS PROJECT, VERIFY THAT THE CIRCUITS ACTUALLY FEED THE DEVICES LISTED ON THE PANEL SCHEDULE PRIOR TO REMOVING EQUIPMENT FROM THOSE BRANCH CIRCUITS.
- 14. UNLESS NOTED OTHERWISE, UTILIZE THE HVAC EQUIPMENT CURBS AND RUBBER BOOTS PROVIDED WITH THE HVAC EQUIPMENT FOR BRANCH CIRCUIT ACCESS TO ALL ROOFTOP HVAC EQUIPMENT AND RECEPTACLES.
- 15. ELECTRICAL DRAWINGS ARE SCHEMATIC IN NATURE. PROVIDE OFFSETS AND FITTINGS AS REQUIRED TO ACCOMMODATE FIELD CONDITIONS AND ALL TRADE WORK BY OTHERS.
- 16. IDENTIFICATION LABELS FOR ALL SYSTEMS MUST USE THE OWNER'S ROOM NAME AND NUMBER AND NOT THE ROOM NAMES AND NUMBERS ON THE CONTRACT DOCUMENTS. MEET WITH THE OWNER TO REVIEW AND CONFIRM ROOM NAMES AND ROOM NUMBERS PRIOR TO LABELING SYSTEMS.

GENERAL ELECTRICAL REMOVAL NOTES:

- 1. UNLESS NOTED OTHERWISE, DEVICES ON THE REMOVAL DRAWINGS INDICATES A DEVICE THAT IS REQUIRED TO BE DISCONNECTED AND REMOVED. FOR DEVICES INDICATED TO BE REMOVED AND NOT REINSTALLED, REMOVE ALL ASSOCIATED SAFETY SWITCHES, ELECTRICAL BOXES, RACEWAYS AND WIRING BACK TO THE POWER SOURCE. WHERE AN EXISTING BRANCH CIRCUIT PROVIDES POWER TO MULTIPLE DEVICES INCLUDING SOME REQUIRED TO REMAIN IN PLACE, MAINTAIN BRANCH CIRCUIT POWER TO THE DEVICES THAT ARE REQUIRED TO REMAIN; INTERCEPT AND EXTEND BRANCH CIRCUIT WIRING AS REQUIRED.
- 2. PROVIDE ALL WORK AND COSTS ASSOCIATED WITH THE DISCONNECTION, REMOVAL, RELOCATION, AND DISPOSAL OF THE ELECTRICAL EQUIPMENT THAT IS REQUIRED TO BE DEMOLISHED.
- 3. THE OWNER RETAINS THE FIRST RIGHT TO KEEP ANY REMOVED EQUIPMENT. REVIEW THE DISPOSITION OF ALL EQUIPMENT WITH OWNER PRIOR TO REMOVAL. ALL EQUIPMENT AND OR MATERIAL BEING REMOVED IS THE RESPONSIBILITY OF THE CONTRACTOR AND SHALL BE RETAINED, DISPOSED OF, AND REMOVED FROM THE SITE IN ACCORDANCE WITH LOCAL, STATE, AND FEDERAL GUIDELINES.
- 4. QUANTITY OF HVAC EQUIPMENT SHOWN ON THE REMOVAL DRAWINGS IS INDICATIVE OF EXISTING QUANTITY AND LOCATION. REFER TO THE HVAC REMOVAL DRAWINGS FOR QUANTITIES AND LOCATIONS OF HVAC EQUIPMENT TO BE DEMOLISHED. VERIFY ACTUAL QUANTITIES OF ASSOCIATED ELECTRICAL EQUIPMENT TO BE REMOVED, SUCH AS DISCONNECT SWITCHES AND MOTOR STARTERS, AND INCLUDE IN BID.
- 5. PERFORM ALL REQUIRED PATCHING AND PAINTING AFTER DEMOLITION AS REQUIRED TO RESTORE SURFACES TO MATCH SURROUNDING SURFACE FINISHES.
- 6. TAG ALL EQUIPMENT AND DEVICES BEING REMOVED AND REINSTALLED WITH THE ROOM NUMBER AND LOCATION FROM WHICH IT IS BEING REMOVED TO ENSURE THAT IT IS REINSTALLED IN THE SAME ROOM AND LOCATION.
- 7. THE OWNER WILL REMOVE AND REINSTALL ALL MOVABLE EQUIPMENT AND FLOOR MOUNTED SHELVING UNO. REMOVE, STORE AND REINSTALL EXISTING BUILT-IN EQUIPMENT AS REQUIRED TO PERFORM THE WORK, UNLESS NOTED OTHERWISE.
- 8. GENERAL ELECTRICAL REMOVAL NOTES APPLY TO ALL ELECTRICAL REMOVAL DRAWINGS AND DETAILS.
- 9. FOR EXISTING BRANCH CIRCUITS THAT ARE ENTIRELY REMOVED, CLEARLY MARK THE EXISTING PANELBOARD SCHEDULE FOR THAT BRANCH CIRCUIT AS "SPARE."


GENERAL FIRE ALARM WORK NOTES

- 1. FOR NEW DEVICES BELOW CEILINGS IN OCCUPIED SPACES THAT ARE REQUIRED TO BE INSTALLED ON EXISTING WALLS, PROVIDE WIRING IN SURFACE MOUNTED WIREMOLD RACEWAYS PAINTED TO MATCH THE WALL, AND PROVIDE FITTED BACKBOXES (FITTED = COLOR AND SIZE MATCHED TO THE DIMENSIONS OF THE FIRE ALARM DEVICE, LISTED BY THE FIRE ALARM EQUIPMENT MANUFACTURER TO BE USED WITH THE DEVICE). EXPOSED CONDUIT AND NON-FITTED BACKBOXES ARE NOT ACCEPTABLE. CONCEAL ALL REMAINING WIRING ABOVE ACCESSIBLE CEILINGS. SEE GENERAL FIRE ALARM NOTE 3 FOR EXCEPTIONS.
- 2. IDENTIFICATION LABELS TO BE USED/MADE FOR THE FIRE ALARM SYSTEM ADDRESSES MUST USE THE OWNER'S ROOM NUMBERS AND ROOM NAMES, NOT THE NUMBERS OR NAMES ON THE CONSTRUCTION DOCUMENTS. MEET WITH OWNER TO REVIEW AND CONFIRM ROOM NUMBERS AND NAMES PRIOR TO LABELING SYSTEMS.
- 3. THE EXISTING FIRE ALARM SYSTEM IS NOTIFIER .SERVICE: FIRE AND SECURITY TECHNOLOGIES. JACOB DAVIS. TEL # 908-82-4367 ALL NEW FIRE ALARM COMPONENTS PROVIDED AS A PART OF THIS PROJECT SHALL BE FULLY COMPATIBLE WITH THE EXISTING FIRE ALARM SYSTEM.
- 4. COORDINATE WITH THE FIRE ALARM SYSTEM VENDOR AND PROVIDE ALL REQUIRED WIRING, EQUIPMENT, LABOR, PROGRAMMING, AND MATERIALS TO REMOVE EXISTING FIRE ALARM DEVICES INDICATED TO BE REMOVED AND PROVIDE NEW FIRE ALARM SYSTEM DEVICES AS INDICATED FOR A FULLY FUNCTIONAL
- 5. PROVIDE TEMPORARY SUPPORT AND PROTECTION OF EXISTING CEILING MOUNTED FIRE ALARM SYSTEM SMOKE AND HEAT DETECTORS AND WIRING DURING CONSTRUCTION.
- 6. THIS PROJECT INCLUDES, BUT IS NOT LIMITED TO REQUIREMENTS FOR THE REMOVAL OF FIRE ALARM DEVICES AS SHOWN ON THE REMOVAL PLAN AND THE INSTALLATION OF NEW FIRE ALARM DEVICES AS SHOWN ON THE SYSTEMS PLAN, INCLUDING DUCT MOUNTED SMOKE DETECTORS.
- 7. SEE SPECIFICATION 283111 FOR ADDITIONAL FIRE ALARM SYSTEM REQUIREMENTS.
- 8. PROVIDE SEPARATE SURFACE MOUNTED WIREMOLD RACEWAY (PAINTED TO MATCH THE WALL FINISH) FOR ALL FIRE ALARM DEVICES EXTENDING FROM THE DEVICES AND UP TO ABOVE THE CEILING.

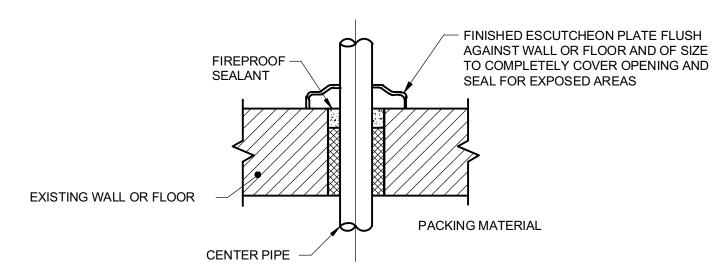


ALL WALL/FLOOR PENETRATIONS TO BE SEALED/FIRE STOPPED WITH ULASSEMBLIES APPROVED FOR THE RESPECTIVE TYPE OF WALL/FLOOR.

DETAIL - TYPICAL CONDUIT THRU FIRE RATED WALL/FLOOR

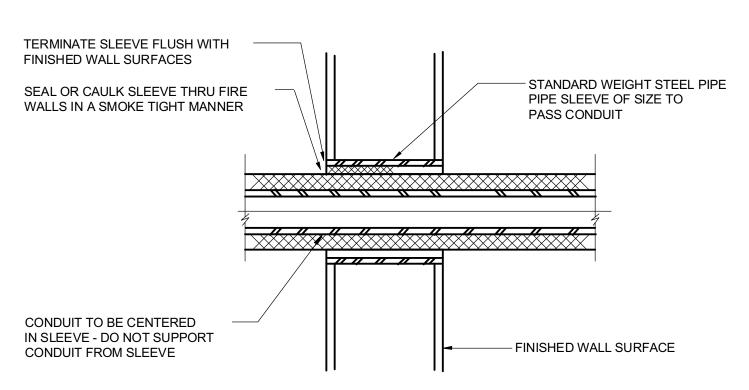

ALL WALL PENETRATIONS TO BE SEALED/FIRE STOPPED WITH UL ASSEMBLIES APPROVED FOR THE RESPECTIVE TYPE OF WALL.

DETAIL - INTERIOR CONDUIT SLEEVES THRU WALL
NO SCALE

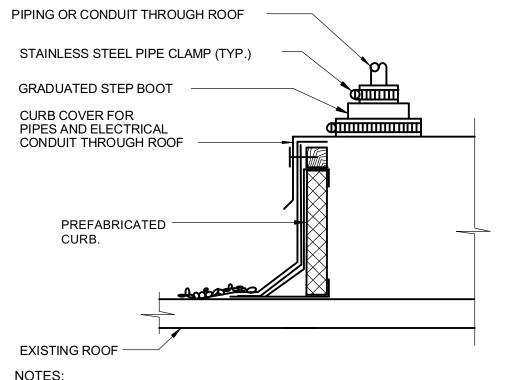

NOTES:


1. FURNISH CURB SUITABLE FOR ROOF SYSTEM. REFER TO ARCHITECTURAL DRAWINGS FOR ROOF SYSTEM AND DETAILS REFER TO ARCHITECTURAL DRAWINGS FOR ROOF DETAILS.

2. FURNISH INSULATED POOF CLIPP WITH WOODEN NAMED.


FURNISH INSULATED ROOF CURB WITH WOODEN NAILER.
 PROVIDE COUNTERFLASHING.

DETAIL - ELECTRICAL RACEWAY CURB ASSEMBLY & FLASHING

NO SCALE

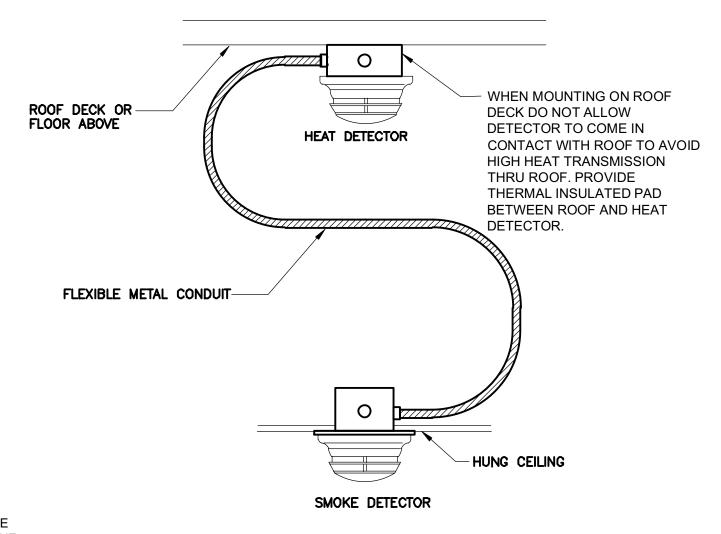



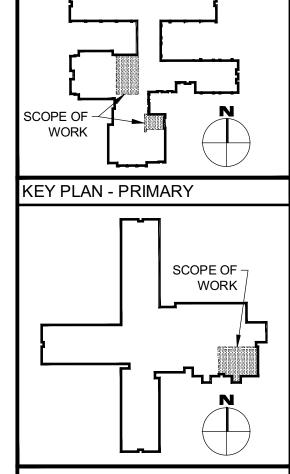

KEY PLAN - ELEMENTARY

REFERENCE DIMENSION

1

INDICATED DIMENSION IS MEASURED AT ONE (1) INCH IN LENGTH AND PROVIDED FOR REFERENCE/VERIFICATION ONLY.



11/01/2024 ISSUE FOR BID

ENGINEER DATE
MICHAEL S. GILLAN, PE NO. 24GE04470000

2024 GILLAN & HARTMANN, Inc.

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EUU

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JASON J. DUE
NJ-21401979800 I
C . C O M
Architect

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1515 Lower Ferry Road - Trenton - New Jersey 08618

Rokkopic: 140 Whitaker Ave - Mont Clare, Pennsykopic 19453

Renovations for Five (5) Pre-K Classrooms at Clayton J.
Davenport School

Egg Harbor Township School District

2501 Spruce Ave, Egg Harbor Township, NJ 08234

Project Number

5481

Project Date

11.01.2024

Checked By

DRH

Checked By

DRH

Drawn By

MV

Scale

AS NOTED


Drawing Name

ELECTRICAL

ELECTRICAL
LEGEND,
ABBREVIATIONS,
AND GENERAL
NOTES

Revisions
No. Date Description

No. Date Description

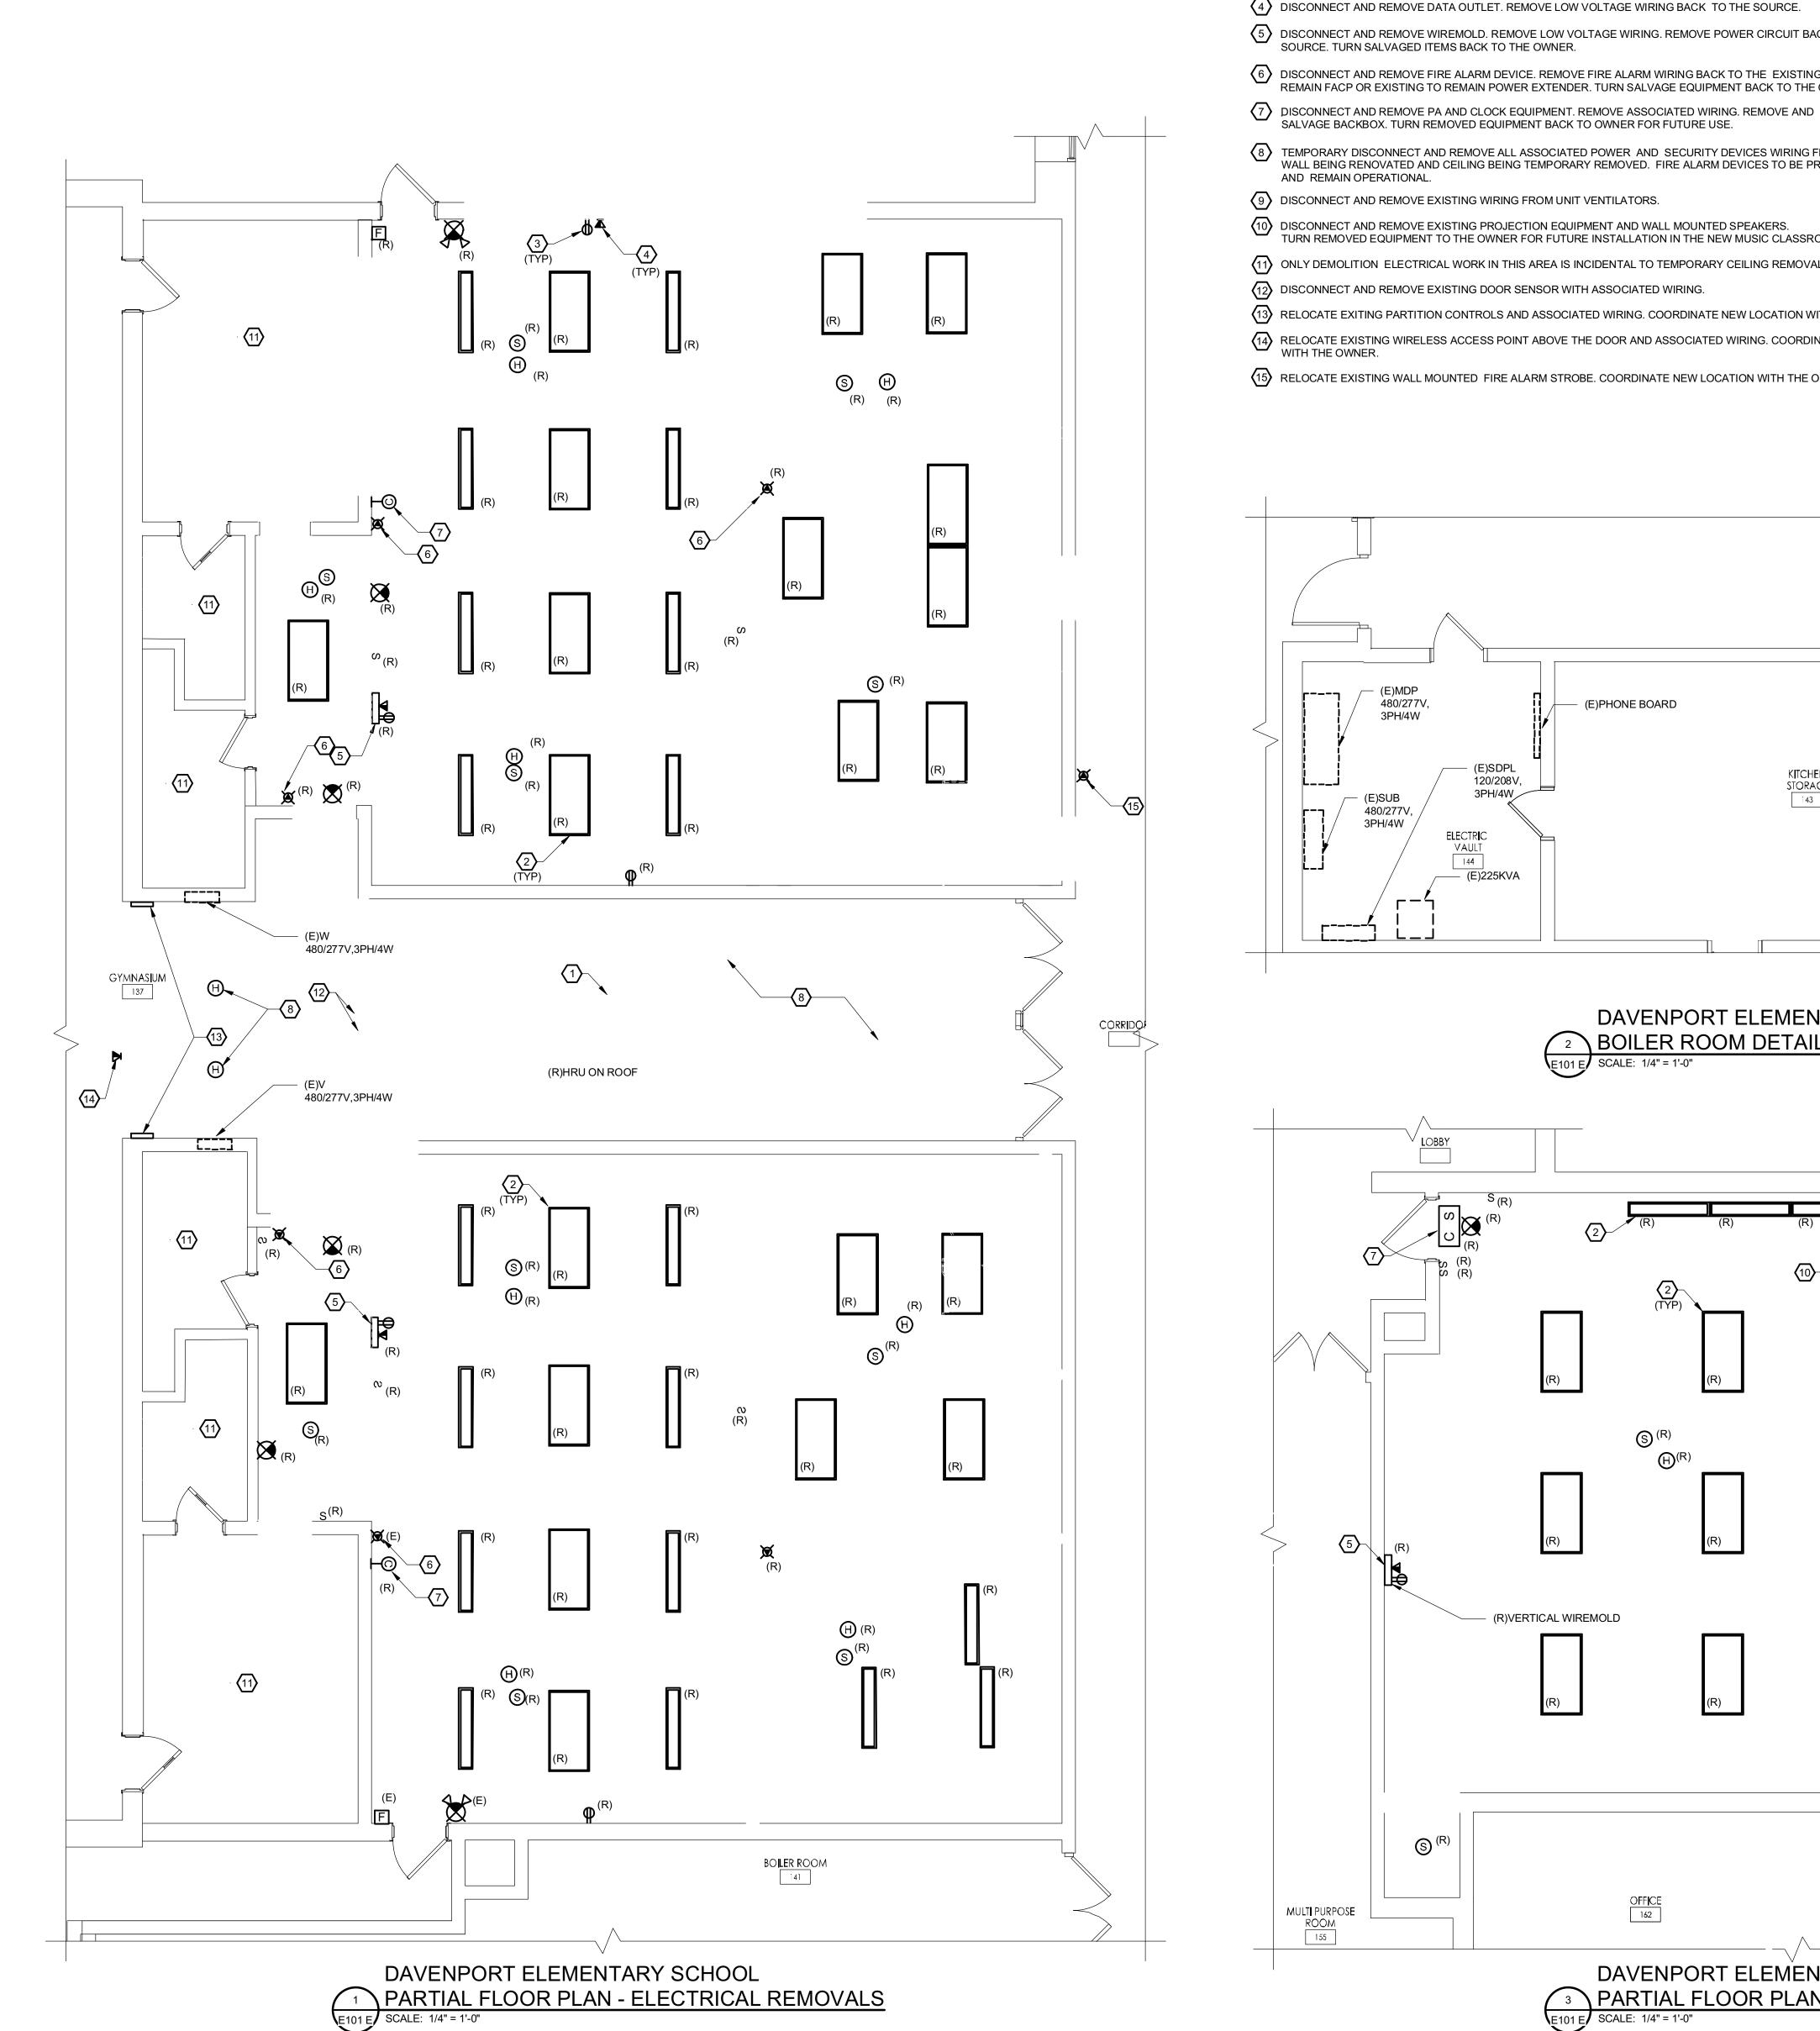

REMOVAL NOTES:

- DISCONNECT AND REMOVE BACK TO THE SOURCE ALL ASSOCIATED POWER AND CONTROL WIRING FROM THE RTU LOCATED ON THE ROOF. MARK CIRCUIT BREAKER AS SPARE.
- DISCONNECT AND REMOVE BACK TO THE SOURCE ALL ASSOCIATED WIRING FROM THE LIGHTING FIXTURE. REMOVE LIGHTING FIXTURE. MARK ASSOCIATED CIRCUIT BREAKER AS SPARE.
- DISCONNECT AND REMOVE RECEPTACLE. REMOVE CIRCUIT BACK TO THE SOURCE. MARK ASSOCIATED CIRCUIT
- DISCONNECT AND REMOVE DATA OUTLET. REMOVE LOW VOLTAGE WIRING BACK TO THE SOURCE.

SALVAGE BACKBOX. TURN REMOVED EQUIPMENT BACK TO OWNER FOR FUTURE USE.


- DISCONNECT AND REMOVE WIREMOLD. REMOVE LOW VOLTAGE WIRING. REMOVE POWER CIRCUIT BACK TO THE SOURCE. TURN SALVAGED ITEMS BACK TO THE OWNER.
- 6 DISCONNECT AND REMOVE FIRE ALARM DEVICE. REMOVE FIRE ALARM WIRING BACK TO THE EXISTING TO
- REMAIN FACP OR EXISTING TO REMAIN POWER EXTENDER. TURN SALVAGE EQUIPMENT BACK TO THE OWNER.
- TEMPORARY DISCONNECT AND REMOVE ALL ASSOCIATED POWER AND SECURITY DEVICES WIRING FROM THE WALL BEING RENOVATED AND CEILING BEING TEMPORARY REMOVED. FIRE ALARM DEVICES TO BE PROTECTED AND REMAIN OPERATIONAL.
- DISCONNECT AND REMOVE EXISTING WIRING FROM UNIT VENTILATORS.
- DISCONNECT AND REMOVE EXISTING PROJECTION EQUIPMENT AND WALL MOUNTED SPEAKERS.
 TURN REMOVED EQUIPMENT TO THE OWNER FOR FUTURE INSTALLATION IN THE NEW MUSIC CLASSROOM.
- ONLY DEMOLITION ELECTRICAL WORK IN THIS AREA IS INCIDENTAL TO TEMPORARY CEILING REMOVAL.
- DISCONNECT AND REMOVE EXISTING DOOR SENSOR WITH ASSOCIATED WIRING.
- RELOCATE EXITING PARTITION CONTROLS AND ASSOCIATED WIRING. COORDINATE NEW LOCATION WITH THE OWNER.
- RELOCATE EXISTING WIRELESS ACCESS POINT ABOVE THE DOOR AND ASSOCIATED WIRING. COORDINATE NEW LOCATION WITH THE OWNER.
- RELOCATE EXISTING WALL MOUNTED FIRE ALARM STROBE. COORDINATE NEW LOCATION WITH THE OWNER.

TEMPORARY REMOVAL AND REINSTALLATION OF EXISTING **CEILINGS AND CEILING MOUNTED EQUIPMENT:**


- 1. PROVIDE TEMPORARY SUPPORT OF EXISTING CEILING MOUNTED FIRE ALARM DEVICES WHEN EXISTING CEILINGS ARE REMOVED IN ANY PHASE OF CONSTRUCTION.
- 2. THE ELECTRICAL CONTRACTOR TO DISCONNECT, REMOVE, CLEAN, STORE, AND RE-INSTALL EXISTING LIGHT FIXTURES WHEN THE CEILINGS ARE TEMPORARILY REMOVED AND REINSTALLED. NOTIFY OWNER OF ANY EXISTING DAMAGE TO LIGHT FIXTURES PRIOR TO REMOVAL.
- 3. THE CEILING SYSTEMS TO BE TEMPORARILY REMOVED AND REINSTALLED BY THE GENERAL CONTRACTOR. REMOVE, STORE AND RE-INSTALL EXISTING DROPPED CEILINGS AS NECESSARY TO PERFORM WORK. NOTIFY OWNER OF ANY EXISTING DAMAGE TO CEILING TILE AND SUPPORTS PRIOR TO REMOVAL. REPLACE ANY TILES AND SUPPORTS DAMAGED AS A RESULT OF WORK. AMOUNT OF CEILING TO BE REMOVED IS AT CONTRACTOR'S DISCRETION. REINSTALL ALL REMOVED CEILING AT COMPLETION OF WORK. MAKE EVERY EFFORT TO MINIMIZE OPEN CEILINGS.

GENERAL NOTES:

1. TAKE NECESSARY STEPS TO PROTECT EXISTING DATA CABLE, LIGHTING FIXTURES, FIRE ALARM DEVICES, FIRE ALARM WIRING, LIGHTING AND POWER WIRING, AUDIO EQUIPMENT AND ITS WIRING IN THE PLENUM SPACE IN THE AREAS AFFECTED BY CEILING AND DUCT WORK REMOVAL. REMOVAL AND INSTALLATION OF THE POWER, LIGHTING, FIRE ALARM, DATA, AUDIO EQUIPMENT AND WIRING INCIDENTAL TO OTHER TRADE WORK SHALL BE INCLUDED IN THE ELECTRICAL SCOPE AND PRICED.

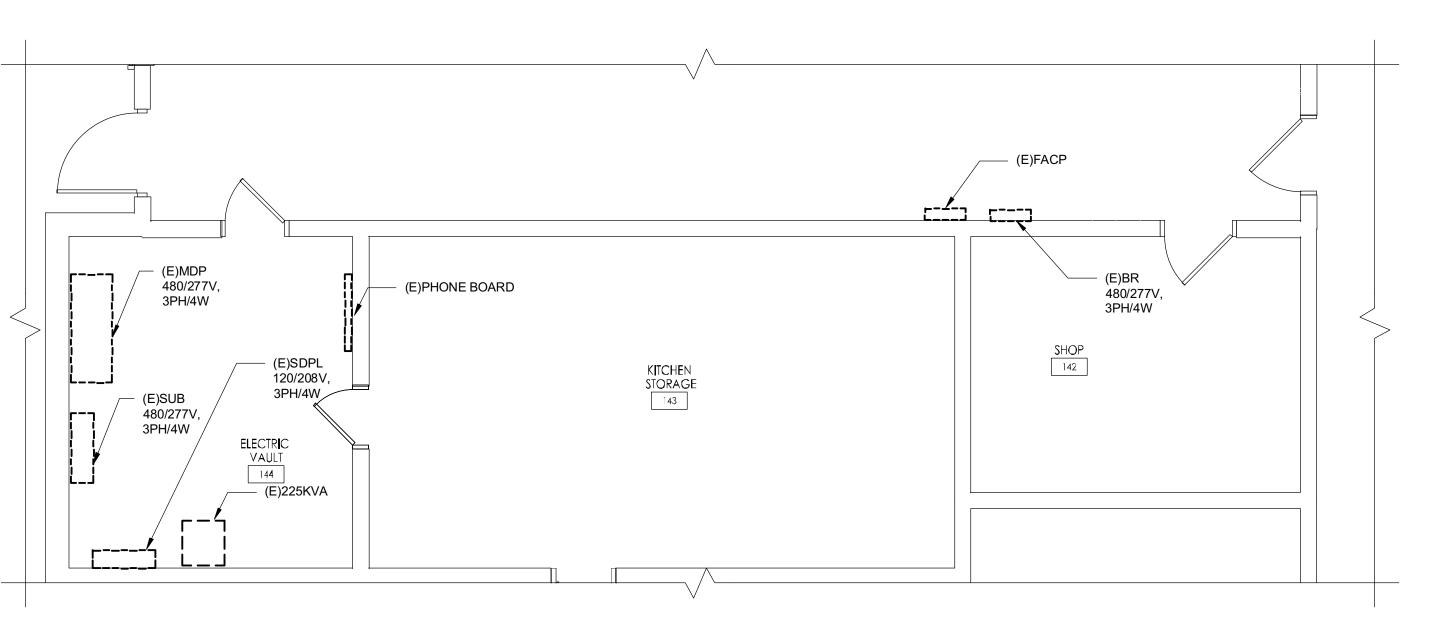

DAVENPORT ELEMENTARY SCHOOL BOILER ROOM DETAIL - ELECTRICAL REMOVALS

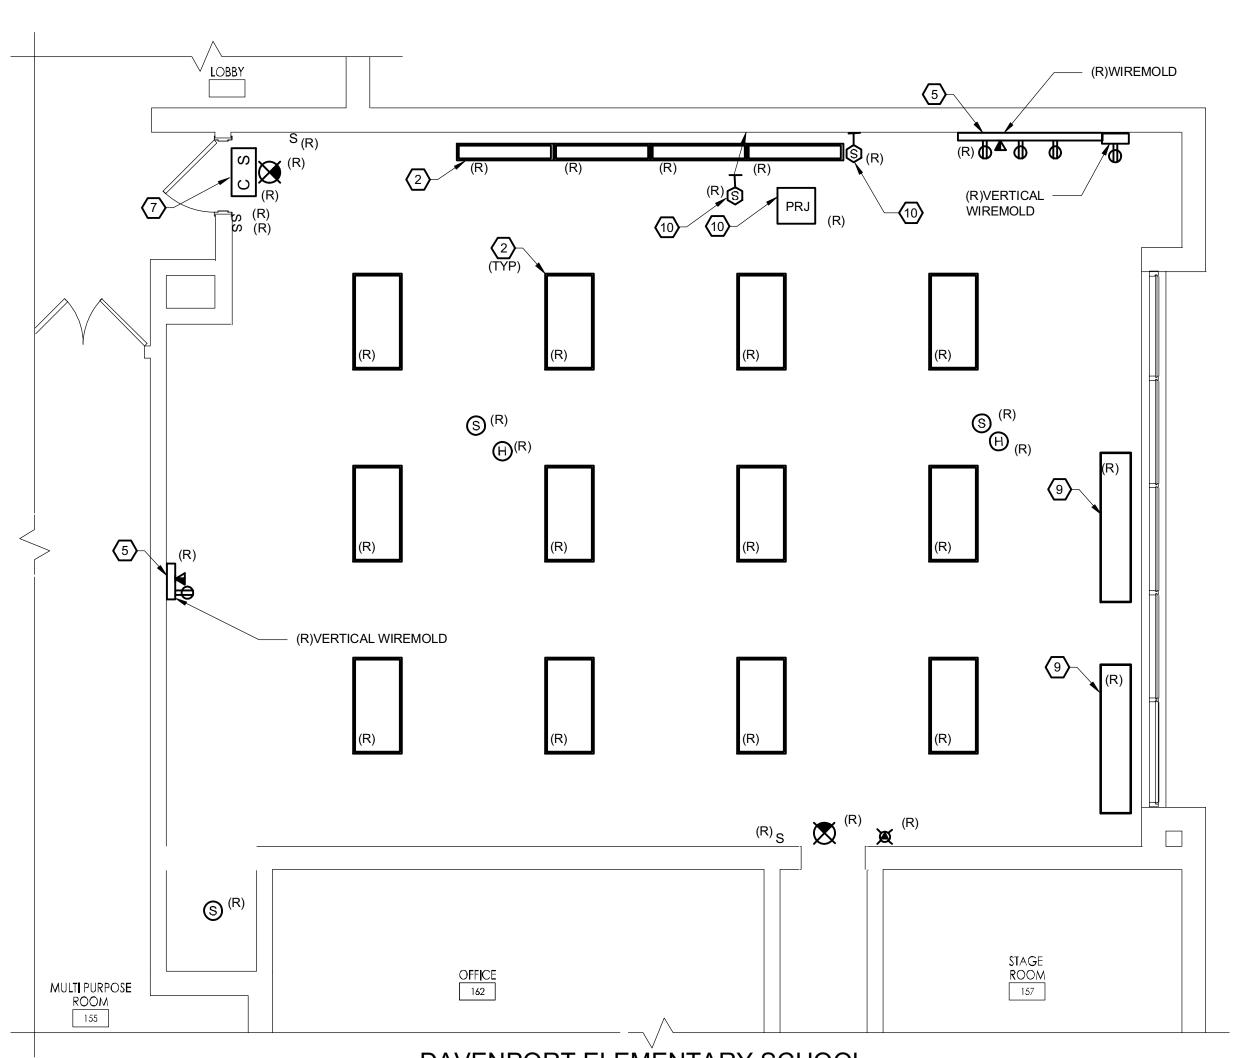

DAVENPORT ELEMENTARY SCHOOL PARTIAL FLOOR PLAN - ELECTRICAL REMOVALS

SCALE: 1/4" = 1'-0" Gillan & Hartmann, Inc.

MECHANICAL AND ELECTRICAL

CONSULTING ENGINEERS

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215-238-9510 609-347-1593 302-654-5959

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G&H Project No. 2024-147

KEY PLAN - ELEMENTARY

3/E101 E

ENGINEER DATE MICHAEL S. GILLAN, PE

2024 GILLAN & HARTMANN, Inc.

11/01/2024

ISSUE FOR BID

E101 E NO. 24GE04470000

Renovations for Five (5) Pre-K Classrooms at Clayton J.

Project Owner Name Egg Harbor Township School District

Davenport School

Project Location 2501 Spruce Ave, Egg Harbor Township, NJ 08234


Project Number 11.01.2024

AS NOTED Drawing Name

ELEMENTARY SCHOOL **ELECTRICAL** REMOVALS -PARTIAL PLAN

REFERENCE DIMENSION

No. Date Description INDICATED DIMENSION IS MEASURED AT ONE (1) INCH IN LENGTH AND PROVIDED FOR REFERENCE/VERIFICATION ONLY.

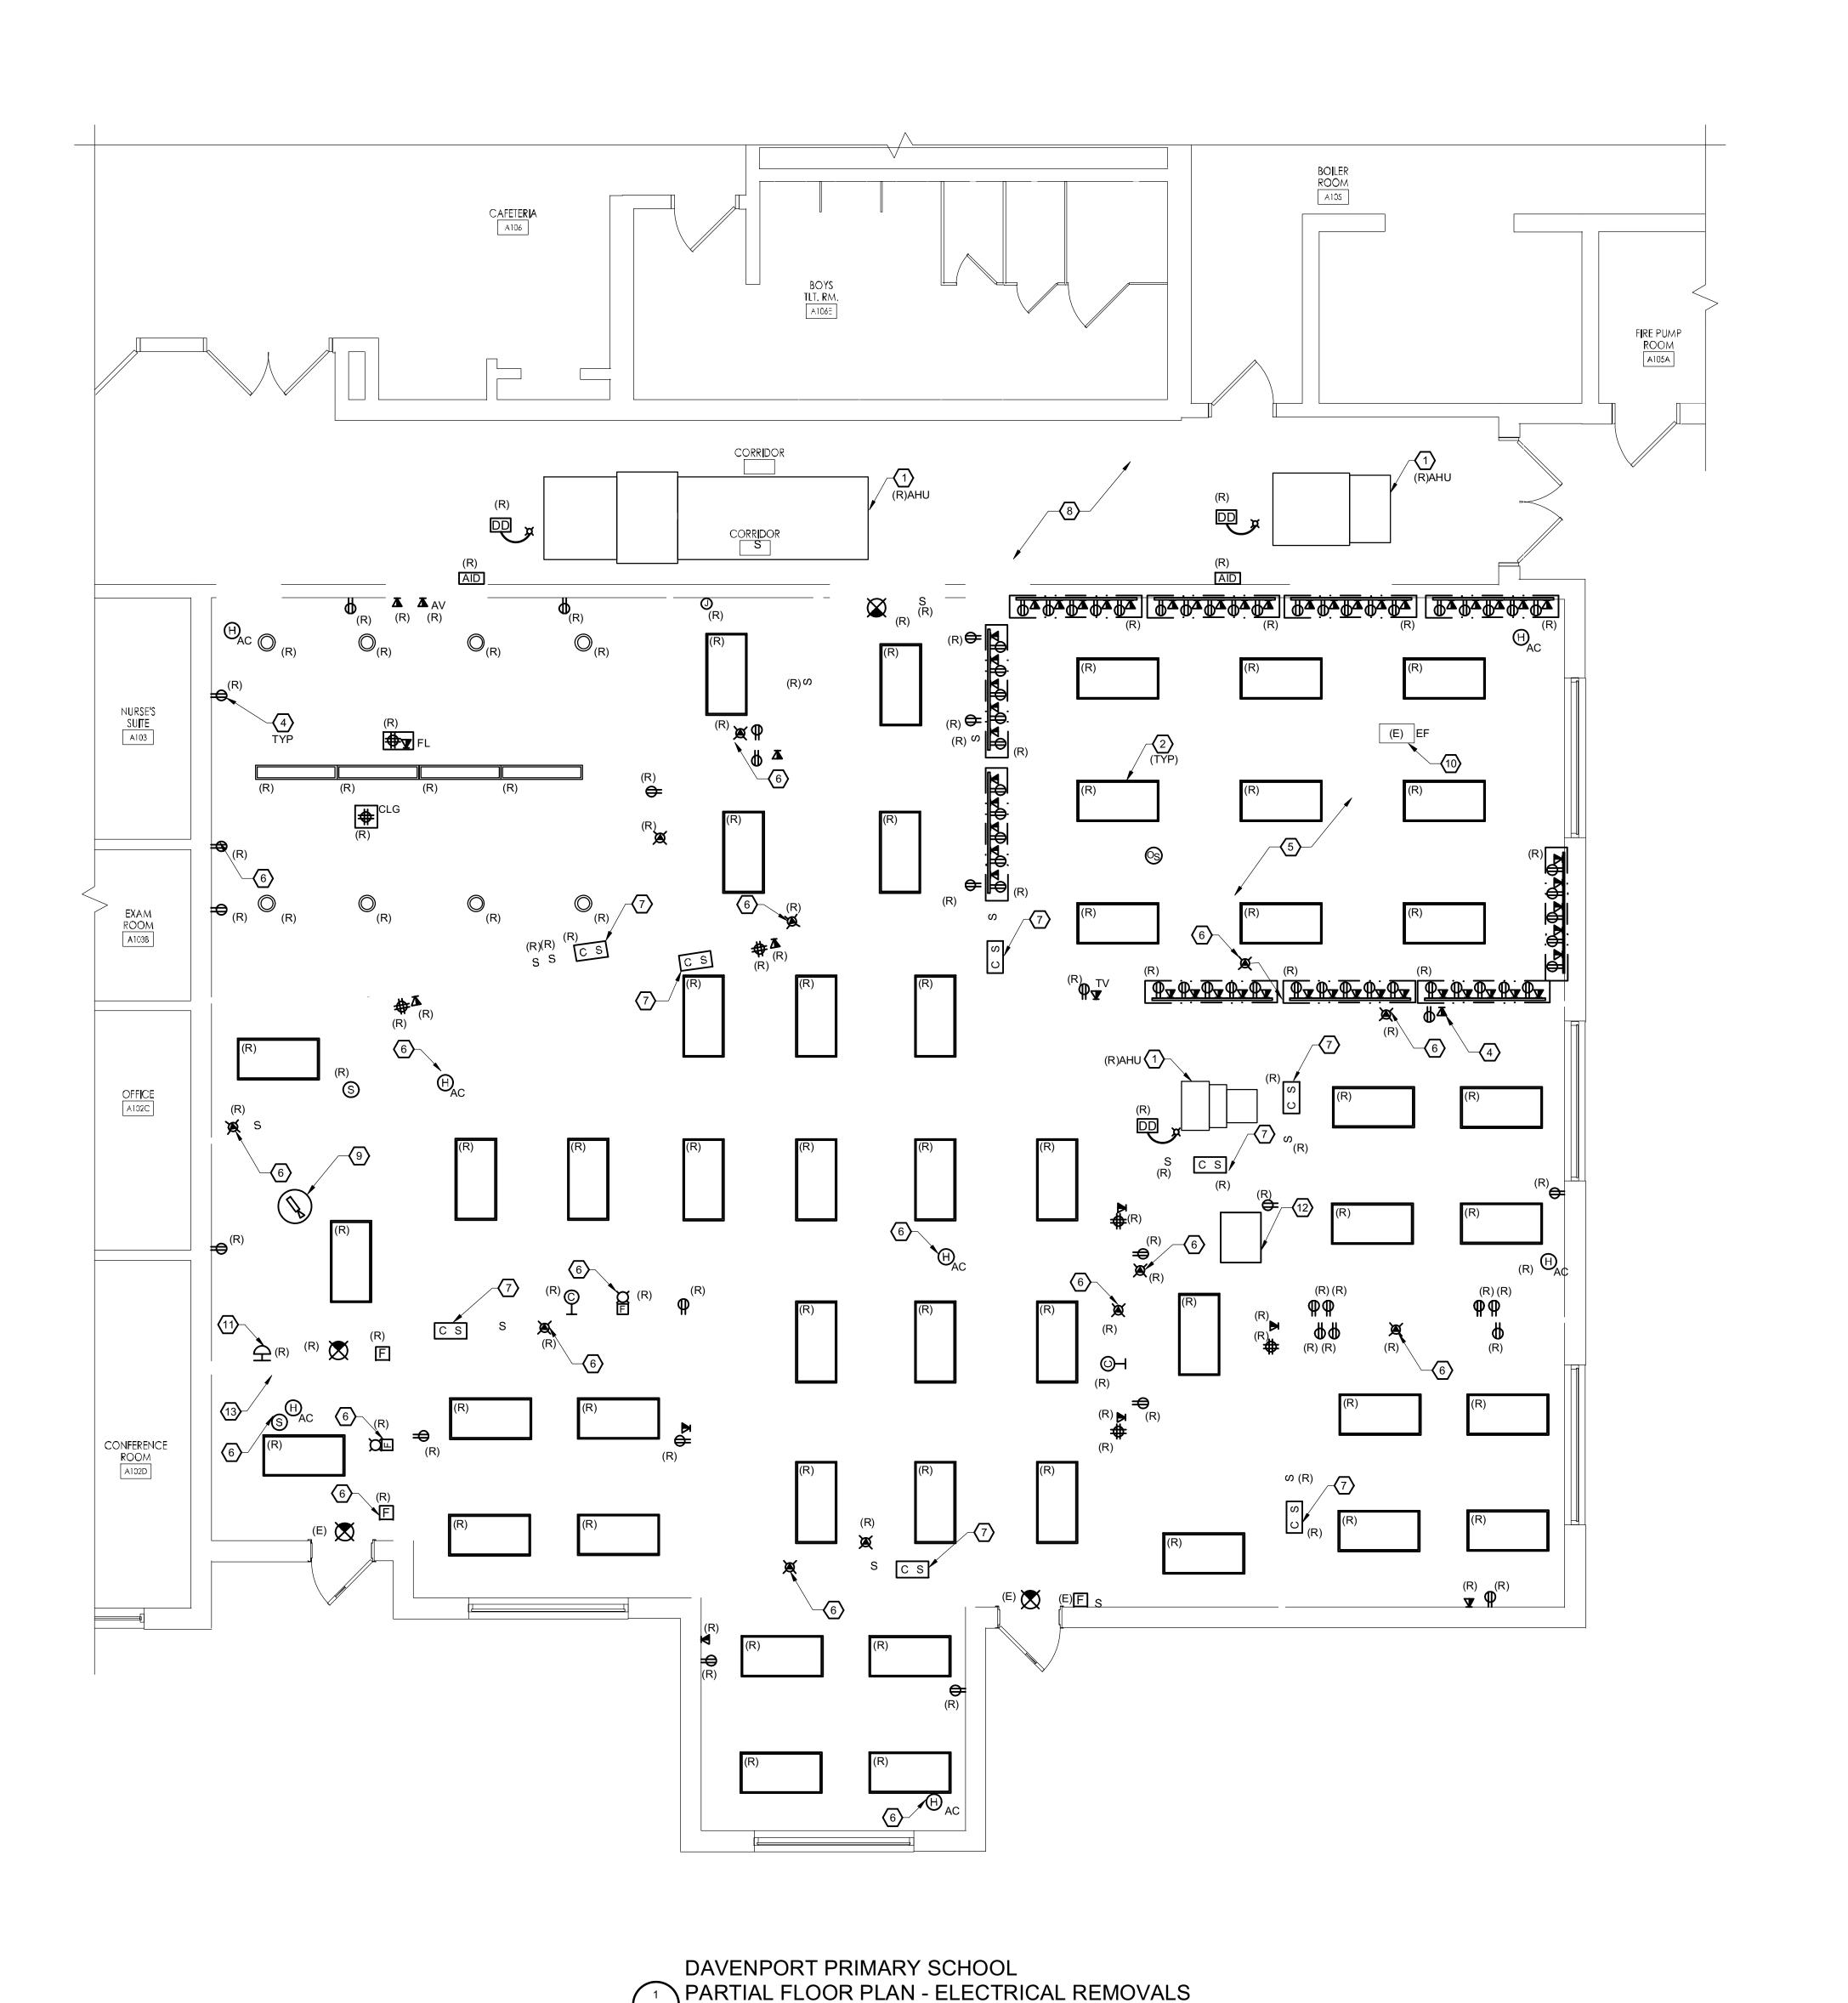

TEMPORARY REMOVAL AND REINSTALLATION OF EXISTING **CEILINGS AND CEILING MOUNTED EQUIPMENT:**

- 1. PROVIDE TEMPORARY SUPPORT OF EXISTING CEILING MOUNTED FIRE ALARM DEVICES WHEN EXISTING CEILINGS ARE REMOVED IN ANY PHASE OF CONSTRUCTION.
- 2. THE ELECTRICAL CONTRACTOR TO DISCONNECT, REMOVE, CLEAN, STORE, AND RE-INSTALL EXISTING LIGHT FIXTURES WHEN THE CEILINGS ARE TEMPORARILY REMOVED AND REINSTALLED. NOTIFY OWNER OF ANY EXISTING DAMAGE TO LIGHT FIXTURES PRIOR TO REMOVAL.
- 3. THE CEILING SYSTEMS TO BE TEMPORARILY REMOVED AND REINSTALLED BY THE GENERAL CONTRACTOR.
- 4. THE GENERAL CONTRACTOR TO REMOVE, STORE AND RE-INSTALL EXISTING DROPPED CEILINGS AS NECESSARY TO PERFORM WORK. NOTIFY OWNER OF ANY EXISTING DAMAGE TO CEILING TILE AND SUPPORTS PRIOR TO REMOVAL. REPLACE ANY TILES AND SUPPORTS DAMAGED AS A RESULT OF WORK. AMOUNT OF CEILING TO BE REMOVED IS AT CONTRACTOR'S DISCRETION. REINSTALL ALL REMOVED CEILING AT COMPLETION OF WORK. MAKE EVERY EFFORT TO MINIMIZE OPEN CEILINGS.

GENERAL NOTES:

1. ELECTRICAL CONTRACTOR TO TAKE NECESSARY STEPS TO PROTECT EXISTING DATA CABLE, LIGHTING FIXTURES, FIRE ALARM DEVICES, FIRE ALARM WIRING, LIGHTING AND POWER WIRING, AUDIO EQUIPMENT AND ITS WIRING IN THE PLENUM SPACE IN THE AREAS AFFECTED BY CEILING AND DUCT WORK REMOVAL. REMOVAL AND INSTALLATION OF THE POWER, LIGHTING, FIRE ALARM, DATA, AUDIO EQUIPMENT AND WIRING INCIDENTAL TO OTHER TRADE WORK SHALL BE INCLUDED IN THE ELECTRICAL SCOPE AND PRICED.

2. ALL EXISTING DATA DROPS AT THE PRIMARY SCHOOL SHALL BE REMOVED FROM THE WIRING DEVICES AND CABLES LEFT FOR THE OWNER TO REMOVE BACK TO THE DATA RACK SWITCH.

REMOVAL NOTES:

- DISCONNECT AND REMOVE BACK TO THE SOURCE ALL ASSOCIATED POWER AND CONTROL WIRING FROM THE AHU LOCATED ABOVE THE CEILING. MARK CIRCUIT BREAKER AS SPARE.
- DISCONNECT AND REMOVE BACK TO THE SOURCE ALL ASSOCIATED WIRING FROM THE LIGHTING FIXTURE. REMOVE LIGHTING FIXTURE. TURN SALVAGED ITEMS BACK TO OWNER. MARK ASSOCIATED CIRCUIT BREAKER AS
- DISCONNECT AND REMOVE RECEPTACLE. REMOVE CIRCUIT BACK TO THE SOURCE. . MARK ASSOCIATED CIRCUIT BREAKER AS SPARE.
- DISCONNECT AND REMOVE DATA OUTLET. COIL AND ATTACH TO JOIST EXISTING DATA WIRING.
- DISCONNECT WIREMOLD DATA AND POWER OUTLETS. DATA WIRING TO BE PRESERVED. ATTACH COILED DATA WIRING TO THE JOIST. COORDINATE WITH LOCAL IT DEPARTMENT. REMOVE WIRE MOLD POWER CIRCUIT BACK TO THE SOURCE. TURN SALVAGED ITEMS BACK TO THE OWNER.
- 6 DISCONNECT AND REMOVE FIRE ALARM DEVICE. REMOVE FIRE ALARM WIRING BACK TO THE EXISTING TO REMAIN FACP OR EXISTING TO REMAIN POWER EXTENDER. TURN SALVAGE EQUIPMENT BACK TO THE OWNER.
- DISCONNECT AND REMOVE PA AND CLOCK EQUIPMENT. REMOVE ASSOCIATED WIRING. REMOVE AND SALVAGE BACKBOX. TURN REMOVED EQUIPMENT BACK TO OWNER FOR FUTURE USE.
- TEMPORARY DISCONNECT AND REMOVE ALL ASSOCIATED POWER AND SECURITY DEVICES WIRING FROM THE WALL BEING RENOVATED AND CEILING BEING TEMPORARY REMOVED. FIRE ALARM DEVICES TO BE PROTECTED AND REMAIN OPERATIONAL.
- DISCONNECT AND REMOVE SECURITY CAMERA AND ASSOCIATED WIRING. COORDINATE CAMERA REMOVAL WITH IT DEPARTMENT. TURN REMOVED EQUIPMENT BACK TO THE OWNER.
- EXISTING INLINE EXHAUST FAN IN CEILING SPACE TO REMAIN CONNECTED TO EXISTING CIRCUIT.
- DISCONNECT AND REMOVE EXISTING MUSHROOM SWITCH AND ASSOCIATED EQUIPMENT. SALVAGE REMOVED EQUIPMENT AND TURN IT BACK TO THE OWNER.
- SERVER RACK TO BE DISCONNECTED REMOVED AND TURNED BACK TO IT DEPARTMENT. DATA WIRING TO BE DISCONNECTED.
- (13) REMOVE EXISTING CARD READER AND ASSOCIATED WIRING.

Renovations for Five (5) Pre-K Classrooms at Clayton J. Davenport School

Project Owner Name

Egg Harbor Township School District

Project Location

2501 Spruce Ave, Egg Harbor Township, NJ 08234

Project Number Project Date 11.01.2024 Checked By

AS NOTED Drawing Name PR**I**MARY SCHOOL **ELECTRICAL** REMOVALS -FIRST FLOOR

PARTIAL PLAN

No. Date Description

Scale

REFERENCE DIMENSION

DATE NO. 24GE04470000

INDICATED DIMENSION IS MEASURED AT ONE (1) INCH IN LENGTH AND PROVIDED FOR

KEY PLAN - PRIMARY

REFERENCE/VERIFICATION ONLY.

Drawing Number

Gillan & Hartmann, Inc.


MECHANICAL AND ELECTRICAL

CONSULTING ENGINEERS 610-935-0101 FAX: 610-935-7520 215-238-9510 609-347-1593 302-654-5959 gillan-hartmann.com ghmail@gillan-hartmann.com G&H Project No. 2024-147


11/01/2024 ISSUE FOR BID

MICHAEL S. GILLAN, PE 2024 GILLAN & HARTMANN, Inc.

ENGINEER

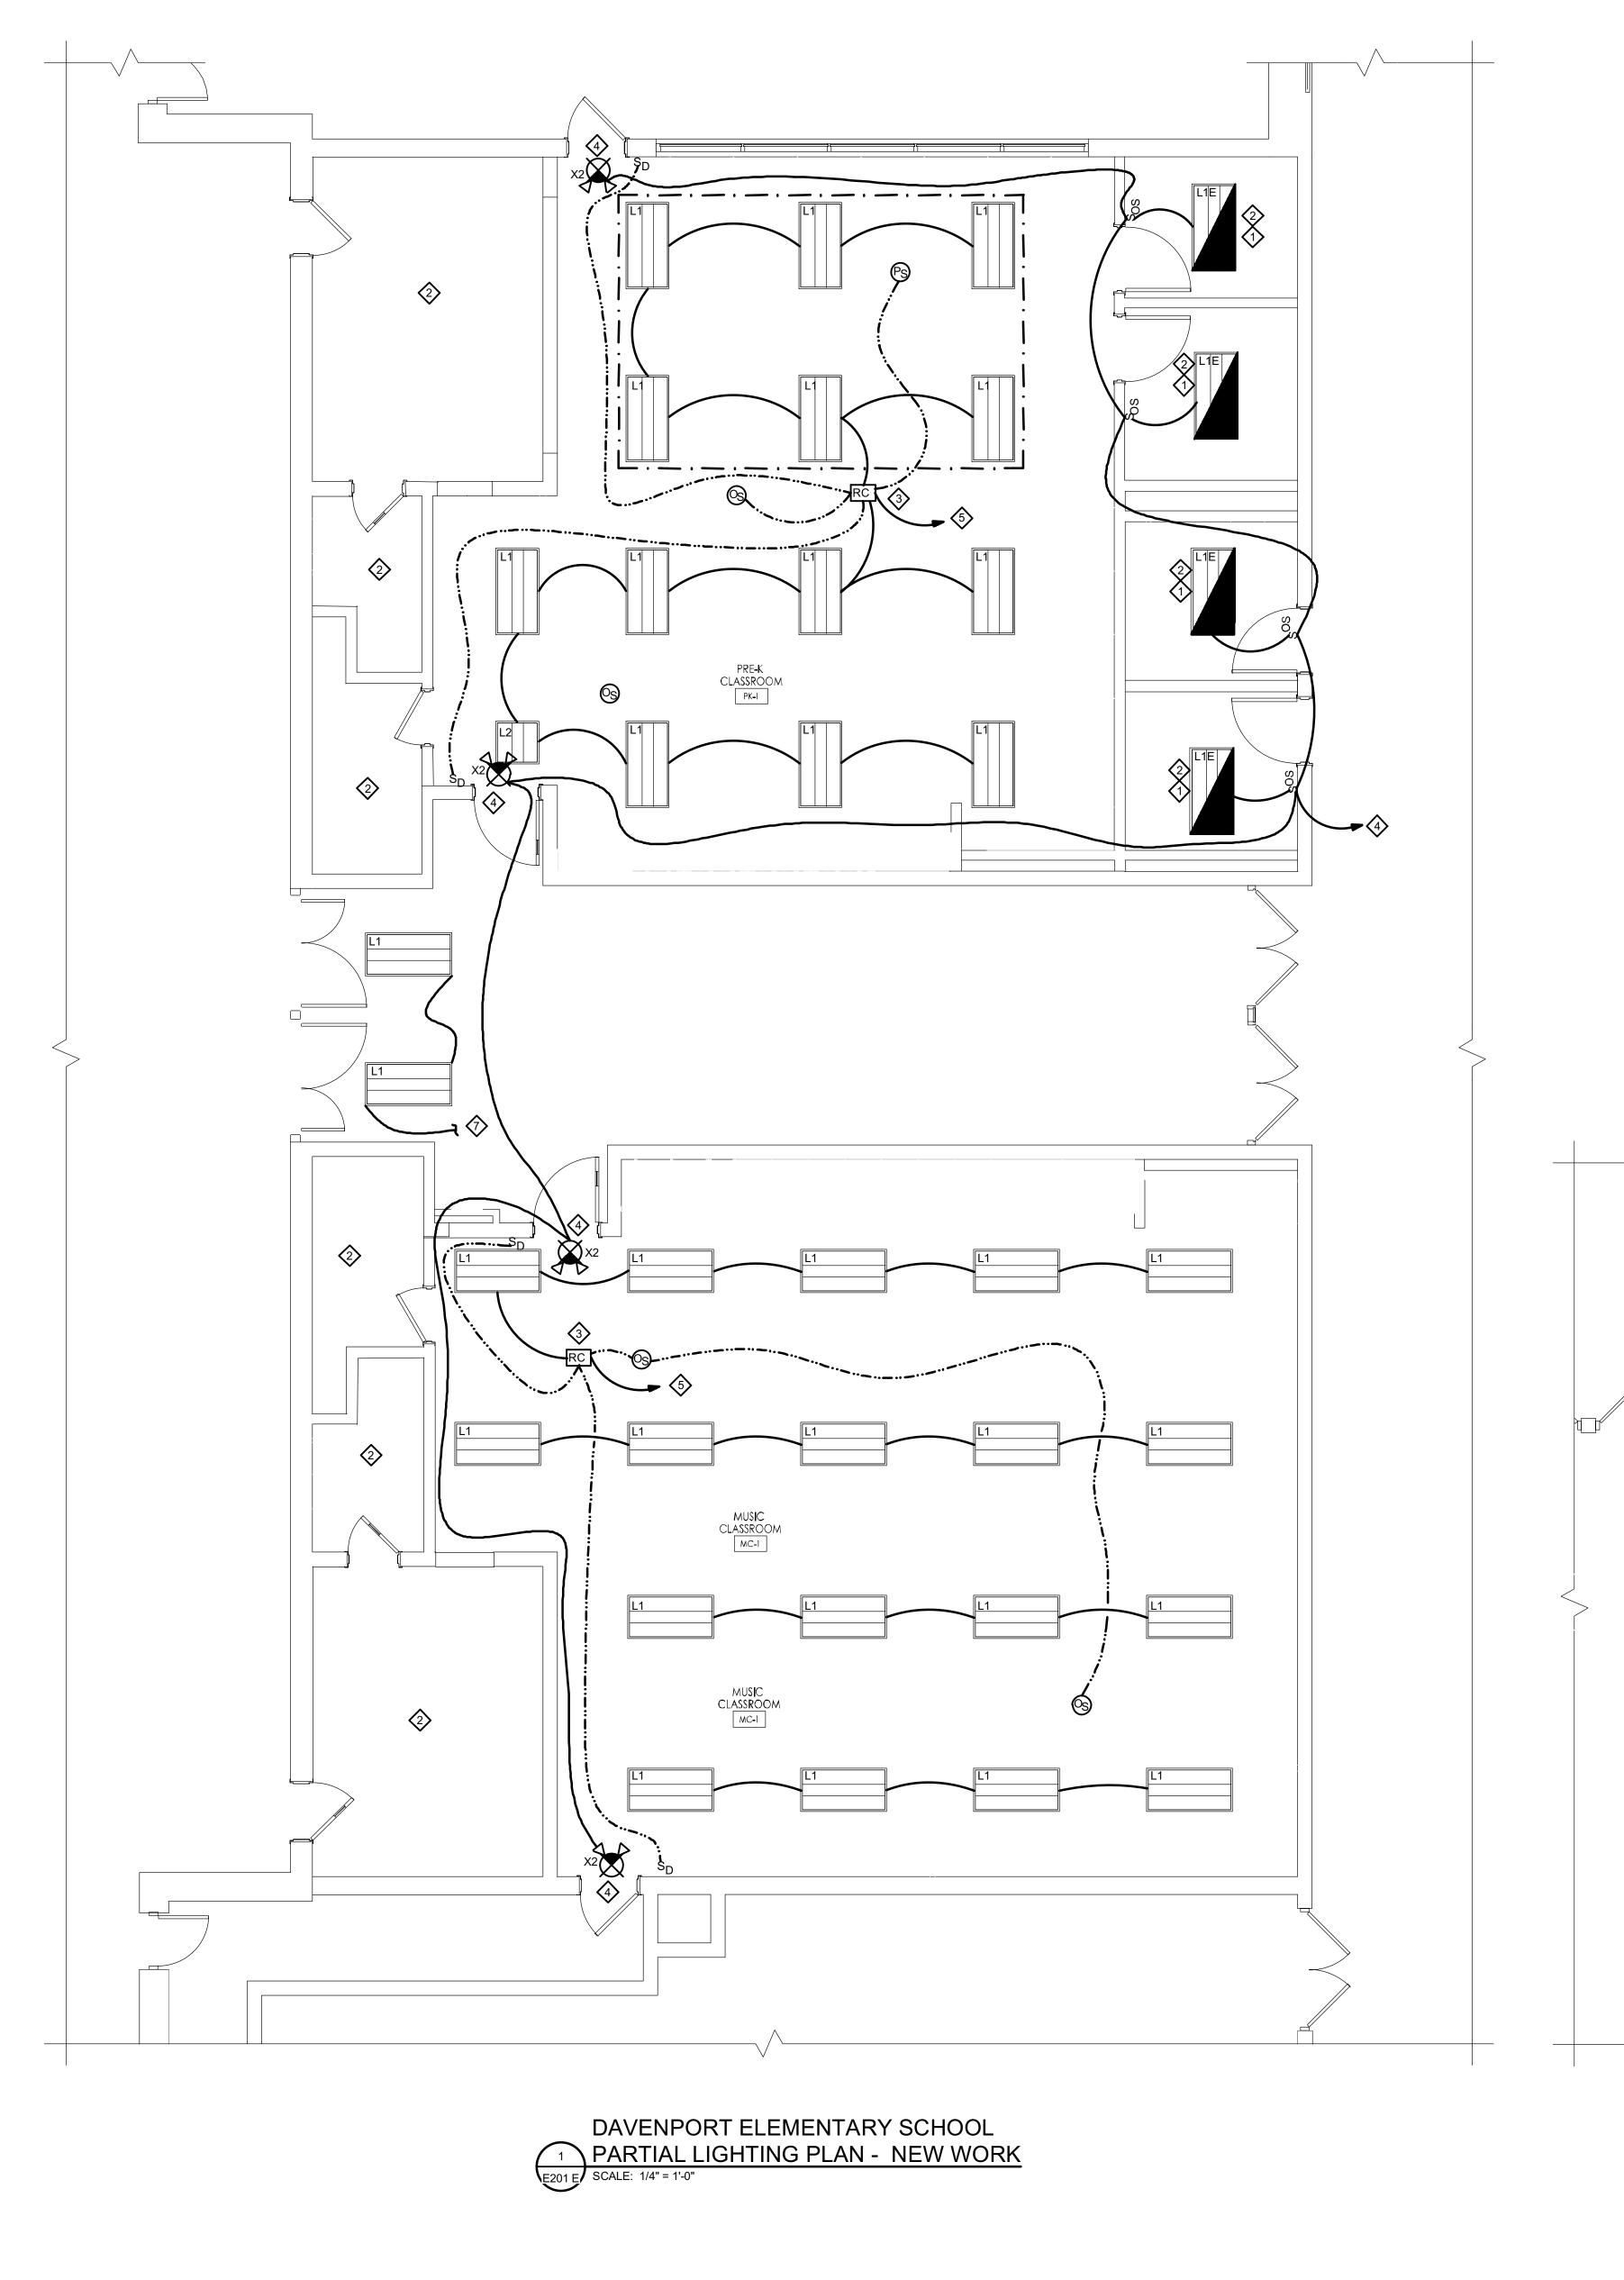

- PROVIDE EMERGENCY BACK-UP LED DRIVER FOR L1E TYPE FIXTURES. THE EMERGENCY BACK-UP LED DRIVER SHALL BE UL LISTED AND IT SHALL PROVIDE AT LEAST 90 MIN OPERATION IN EMERGENCY MODE. BASIS OF DESIGN: BSL07 BODINE OR EQUAL.
- EMERGENCY DRIVER TO BE CONNECTED TO THE UNSWITCHED LIGHTING CIRCUIT.
- PLUG LOAD CONTROLLER IS SHOWN ON DRAWING E202E.
 REFER TO DETAIL 3 ON DRAWING E401 FOR LIGHTING CONTROLS CONNECTION INSTRUCTIONS.
- TO EXISTING EMERGENCY LIGHTING CIRCUIT.
- TO EXISTING NORMAL LIGHTING CIRCUIT.
- 6 LIGHTING FIXTURES AND LIGHTING CONTROLS IN THIS AREA ARE EXISTING TO REMAIN.
- CONNECT NEW LIGHTING FIXTURES TO EXISTING LIGHTING CIRCUITS IN THE CORRIDOR.

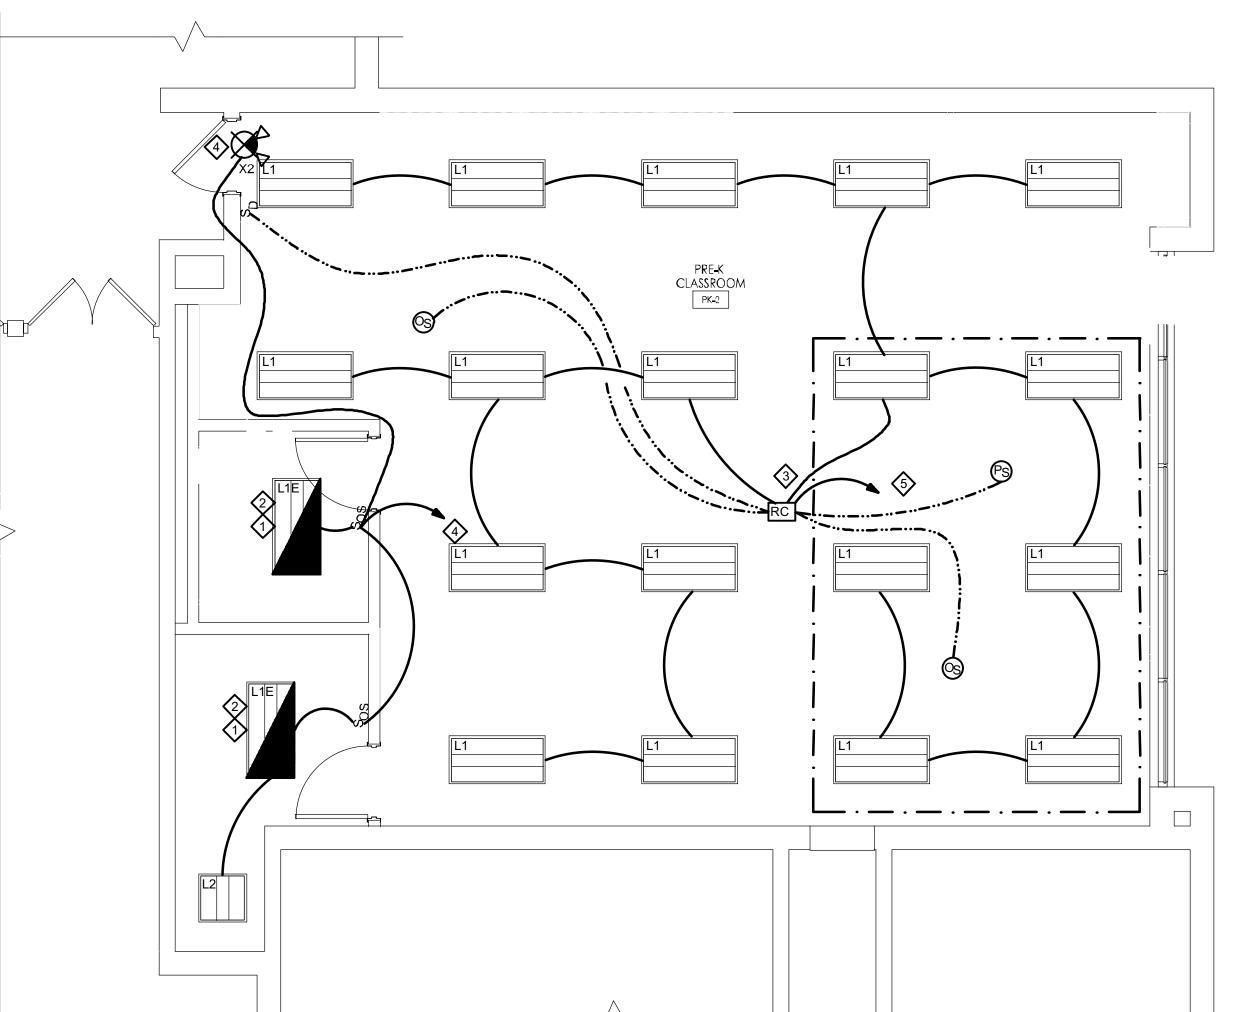

DAVENPORT ELEMENTARY SCHOOL PARTIAL LIGHTING PLAN - NEW WORK

| SCALE: 1/4" = 1'-0" KEY PLAN - ELEMENTARY 2/E201 E

REFERENCE DIMENSION

INDICATED DIMENSION IS MEASURED AT ONE (1) INCH IN LENGTH AND PROVIDED FOR REFERENCE/VERIFICATION ONLY.

Gillan & Hartmann, Inc.

MECHANICAL AND ELECTRICAL

CONSULTING ENGINEERS

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215-238-9510 609-347-1593 302-654-5959

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G&H Project No. 2024-147

DATE NO. 24GE04470000

MICHAEL S. GILLAN, PE

2024 GILLAN & HARTMANN, Inc.

11/01/2024 ENGINEER ISSUE FOR BID

Renovations for Five (5) Pre-K Classrooms at Clayton J.

Davenport School

Project Owner Name

Egg Harbor Township School District

Project Location


2501 Spruce Ave, Egg Harbor Township, NJ 08234

11.01.2024

AS NOTED

Drawing Name ELEMENTARY SCHOOL NEW WORK - LIGHTING PARTIAL PLAN

No. Date Description

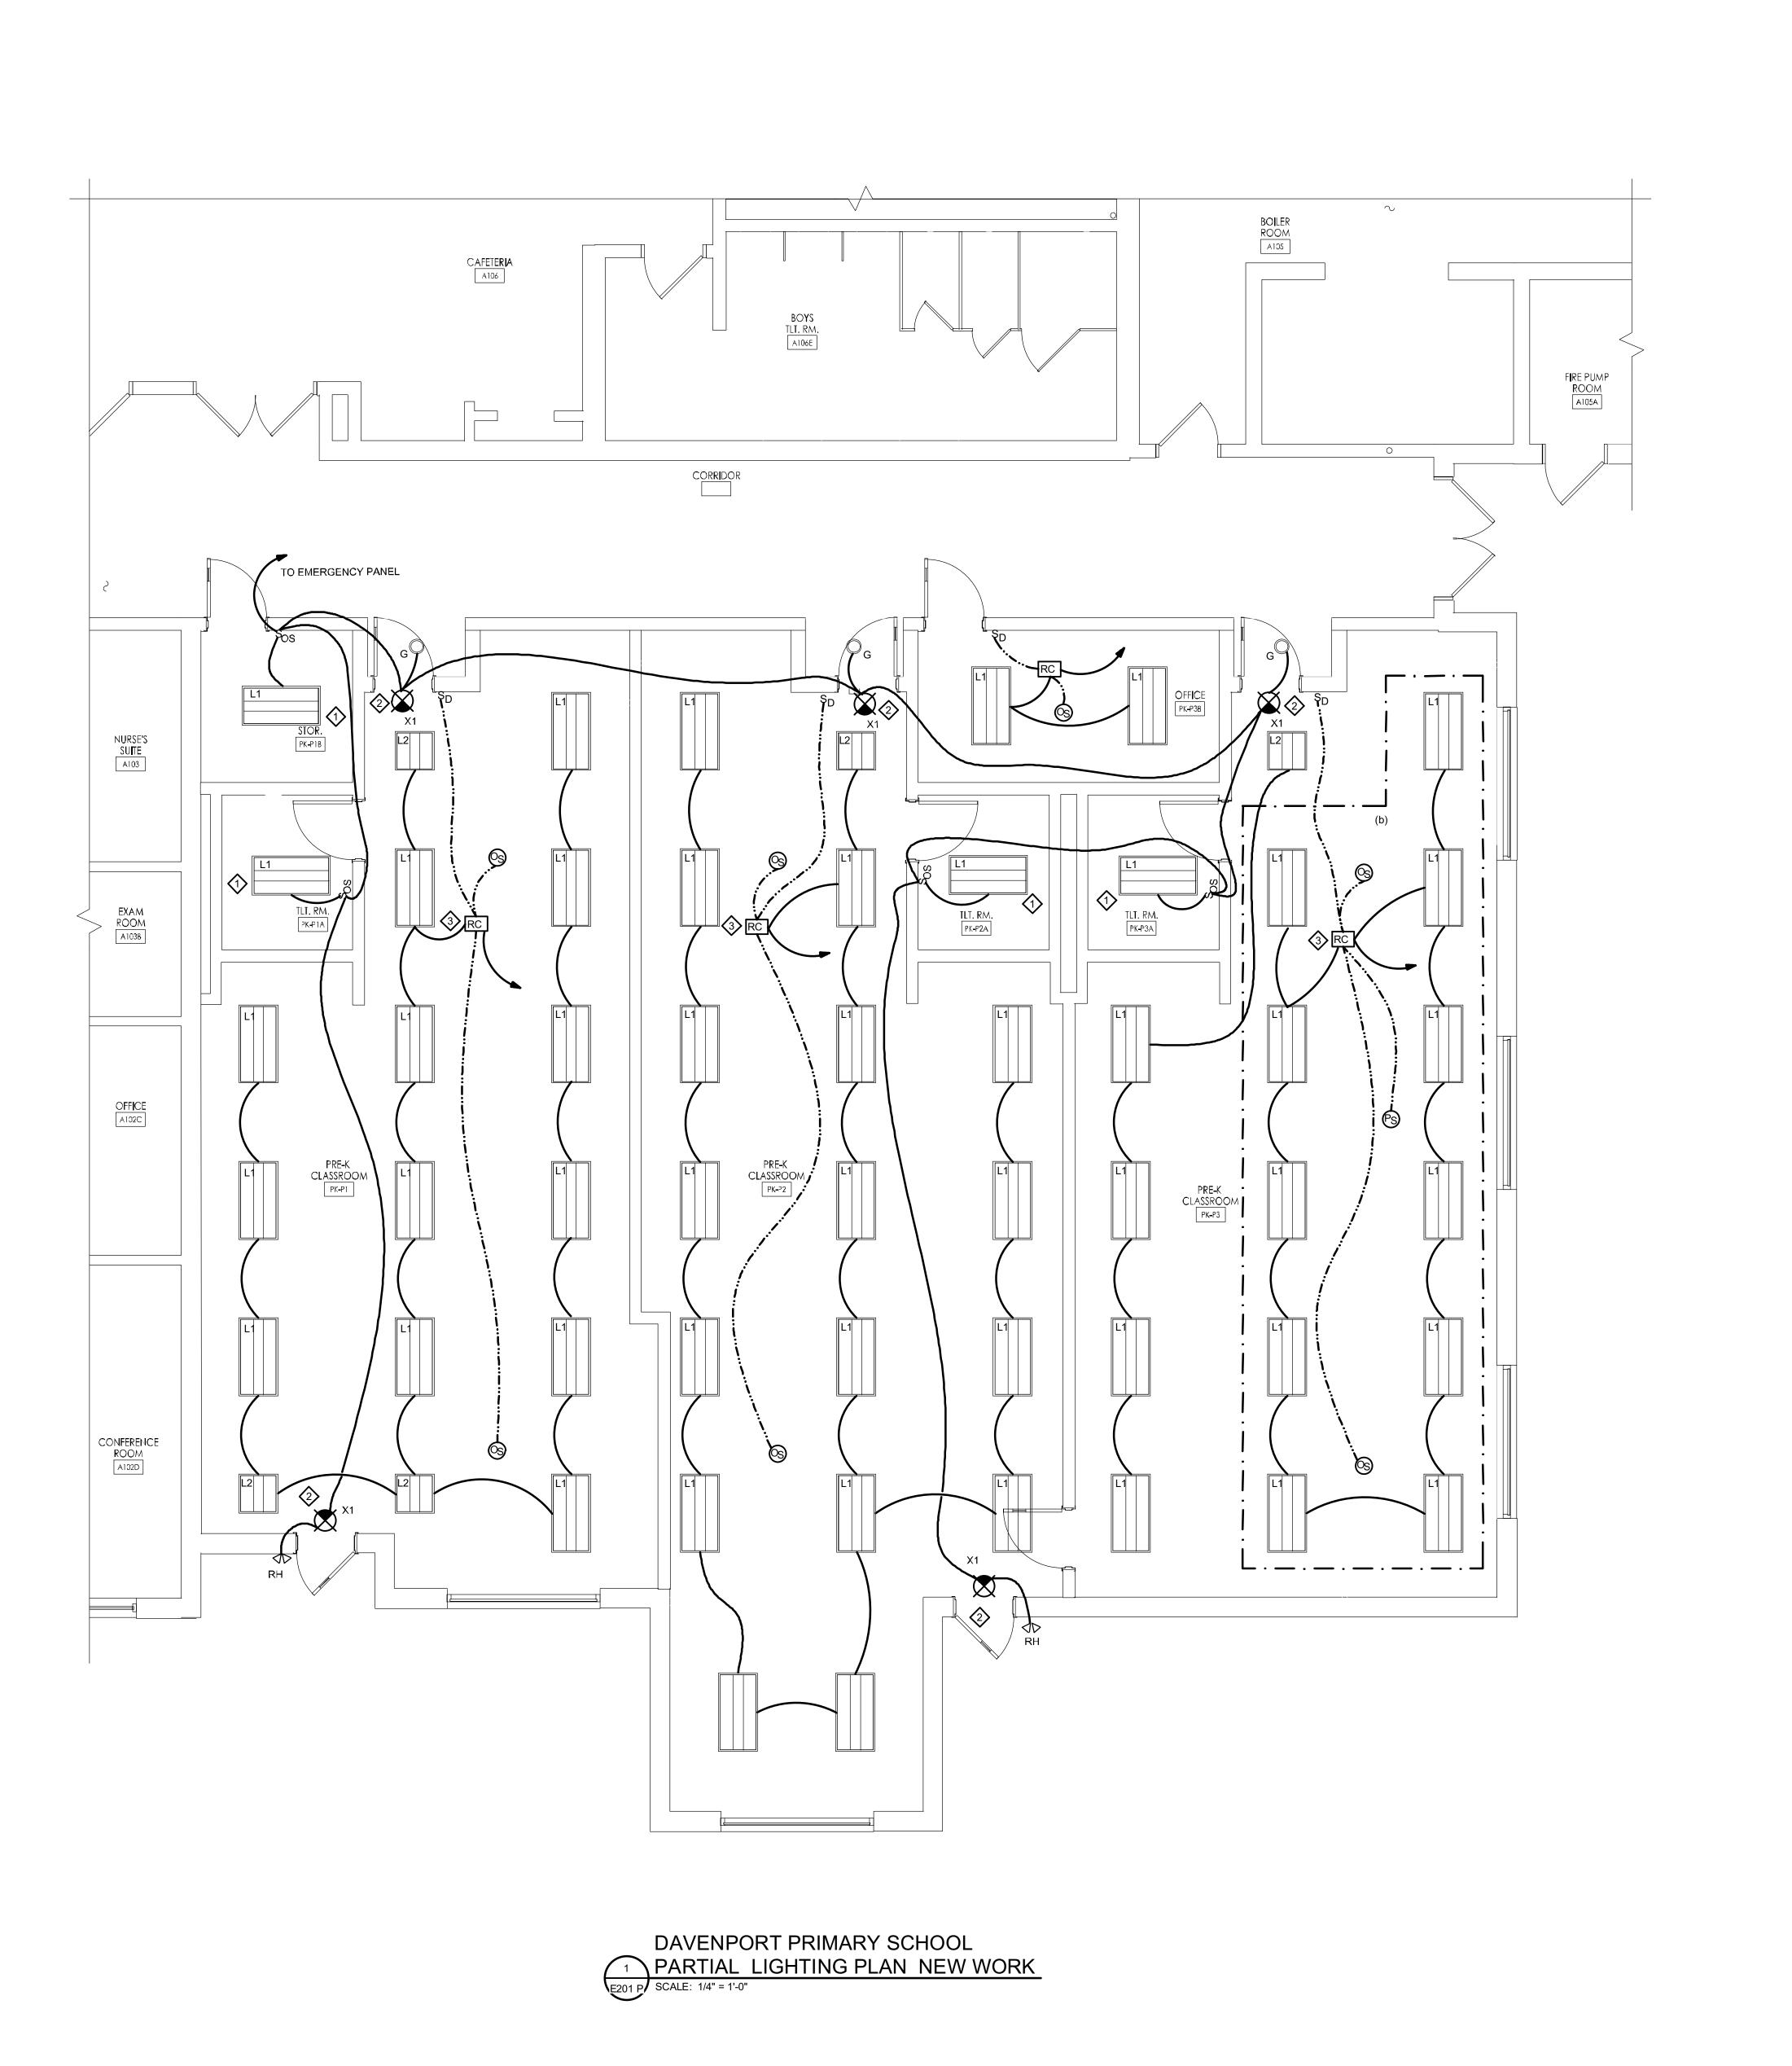

- CONNECT TO EMERGENCY LIGHTING CIRCUIT.
- EXIT SIGN TO BE CONNECTED TO THE UNSWITCHED EMERGENCY LIGHTING CIRCUIT.
- PLUG LOAD CONTROLLER IS SHOWN ON DRAWING E202P.
 REFER TO DETAIL 3 ON DRAWING E401 FOR CONNECTION INSTRUCTIONS.

Renovations for Five (5) Pre-K Classrooms at Clayton J. Davenport School

Project Owner Name

Egg Harbor Township School District

Project Location

2501 Spruce Ave, Egg Harbor Township, NJ 08234

Project Number 11.01.2024 DRH

AS NOTED

Drawing Name PR**I**MARY SCHOOL LIGHTING NEW WORK - FIRST FLOOR PARTIAL

REFERENCE DIMENSION

No. Date Description INDICATED DIMENSION IS MEASURED AT ONE (1) INCH IN LENGTH AND PROVIDED FOR REFERENCE/VERIFICATION ONLY.

Drawing Number


11/01/2024 ISSUE FOR BID

Gillan & Hartmann, Inc.

MECHANICAL AND ELECTRICAL
CONSULTING ENGINEERS
610-935-0101 FAX: 610-935-7520
215-238-9510 609-347-1593 302-654-5959
gillan-hartmann.com ghmail@gillan-hartmann.com
G&H Project No. 2024-147

KEY PLAN - PRIMARY

ENGINEER DATE MICHAEL S. GILLAN, PE NO. 24GE04470000

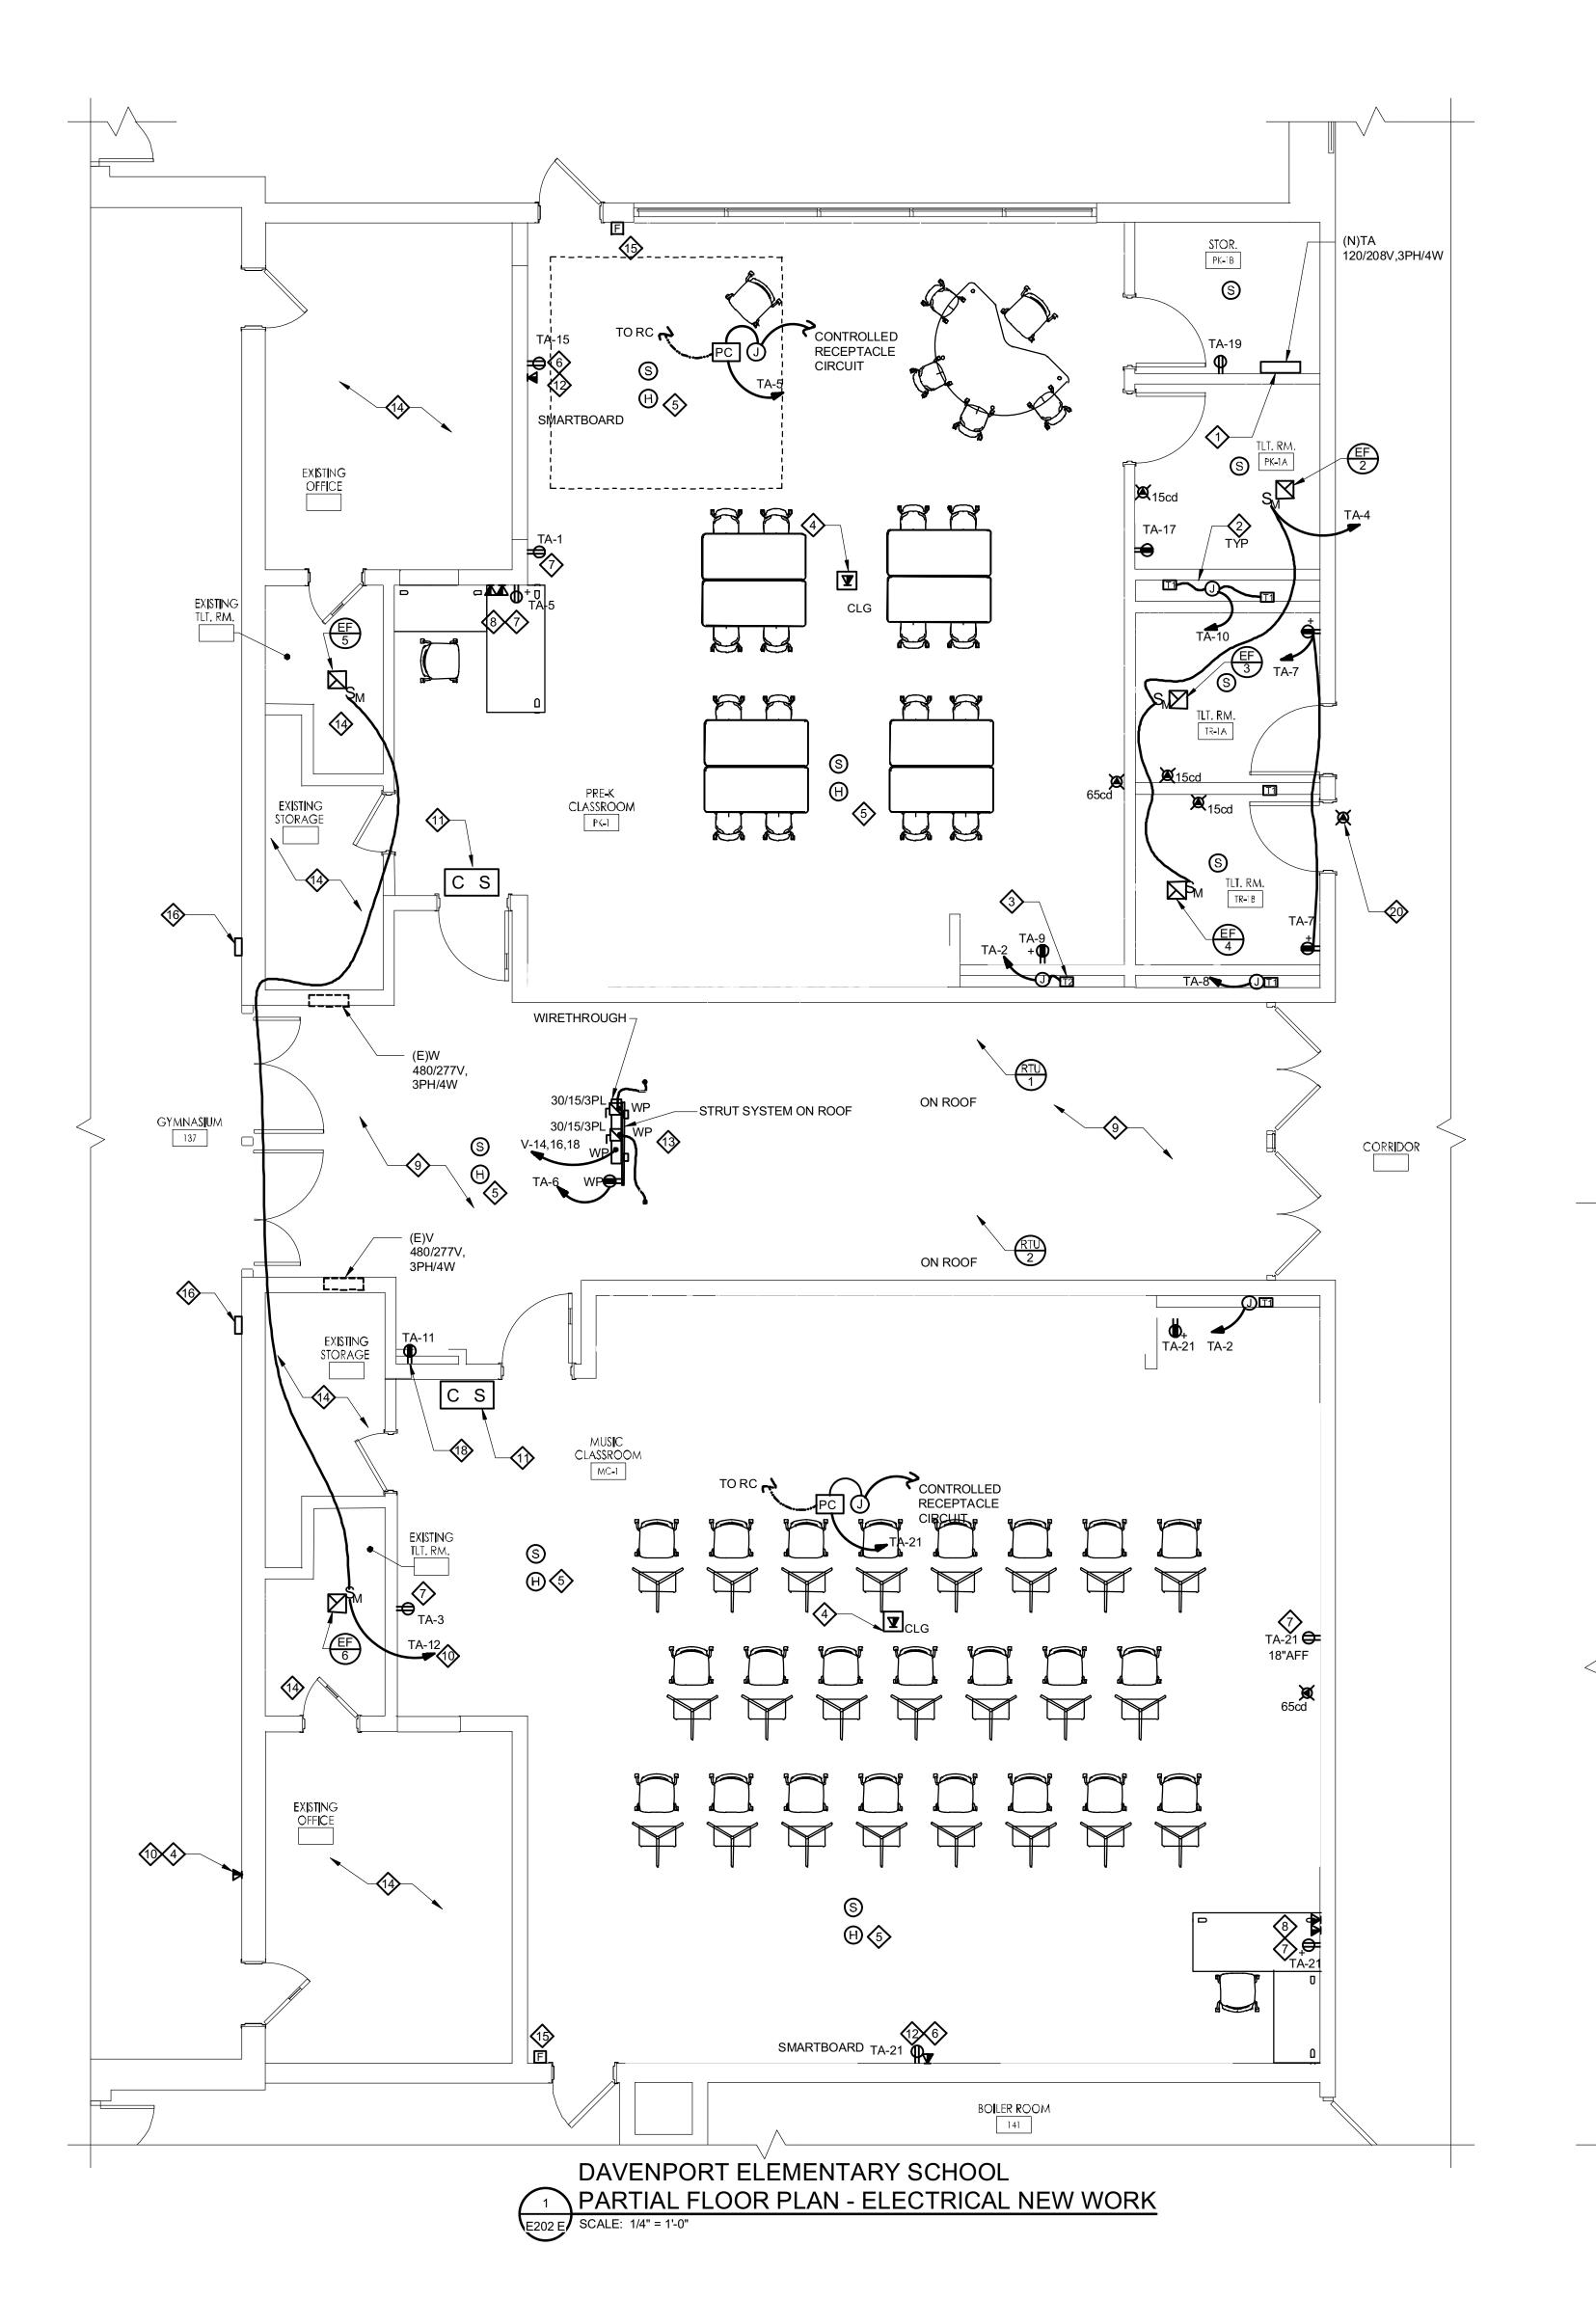

- PROVIDE NEW ELECTRICAL PANEL. REFER TO PANEL SCHEDULE AND SINGLE LINE DIAGRAM FOR PANEL INFORMATION.
- PROVIDE HARDWIRED 120VAC CIRCUIT AND 2 GANG BACKBOX FOR NEW TRANSFORMER T1 120V/24V. MOOD RING PROVIDED BY MANUFACTURER. TRANSFORMER EL208-40 IS PROVIDED WITH PLUMBING EQUIPMENT.
- PROVIDE NEW TRANSFORMER T2 120V/6V PROVIDE 2GANG BACK BOX WITH MOOD RING. PROVIDE HARDWIRED 120VAC CIRCUIT. TRANSFORMER EL-386 TO BE ORDERED FROM PLUMBING EQUIPMENT MANUFACTURER.
- DATA OUTLET FOR WI-FI ROUTER INSTALLED ON THE CEILING UNO. 5 HEAT DETECTOR ABOVE THE CEILING.

USB-C PORT,

- 6 PROVIDE SURFACE MOUNTED DATA OUTLET. INSTALL DATA WIRING IN SURFACE RACEWAY. USE WIREMOLD 2000 SERIES RACEWAY. ELEVATION AS SHOWN.
- 7 PROVIDE SURFACE MOUNTED DUPLEX RECEPTACLE. INSTALL BACKBOX AND 2000 SERIES WIREMOLD TO CEILING SPACE. USE MC CABLE. ELEVATION AS SHOWN.
- 8 PROVIDE DOUBLE GANG SURFACE MOUNTED BACK BOX. USE 2" X 1" SOLID WALL WIRE DUCT PVC CABLE RACEWAY (OR EQUAL) PROVIDE: WALL PLATE WITH USB 3.0 PORT,
- 4K HDMI 2.0 OUTLET, WALL PLATE WITH 2X RG45 OUTLETS. EXAMPLES: RITEAV 4 PORT CUSTOM KEYSTONE WALL PLATE W/DECOR-Z POWER OUTLET.
- ALTERNATE MANUFACTURERS: LEGRAND, BASEPORT, BUYER'S POINT, JIEYI, IBL-2. PREINSTALL TEMPORARY REMOVED ASSOCIATED POWER AND SECURITY DEVICES WIRING FROM THE WALL BEING RENOVATED AND CEILING BEING TEMPORARY REMOVED OR REPLACED. REINSTALL TEMPORARY REMOVED LIGHTING FIXTURES AND ASSOCIATED WIRING. REFER TO ARCHITECTURAL DRAWING A104.
- RELOCATED EQUIPMENT. COORDINATE LOCATION WITH THE OWNER. PROVIDE PROTECTIVE COVER WHEN LOCATED ON GYM WALLS.
- (1) INSTALL WALL MOUNTED COMBINATION CLOCK-SPEAKER. PROVIDE NEW BACKBOX. INSTALL SALVAGED CLOCK-SPEAKER EQUIPMENT. PROVIDE 1"CONDUIT WITH A PULL STRING UP TO CEILING SPACE IN NEW WALL OR SURFACE MOUNTED WIRE-DUCT ON EXISTING WALL. WIRING AND FINAL CONNECTION BY DISTRICT IT DEPARTMENT.
- PROVIDE SURFACE MOUNTED DUPLEX RECEPTACLE AT 45" AFF FOR SMART BOARD. INSTALL BACKBOX AND SURFACE USE ELECTRIDUCT 2" X 1" SOLID WALL WIRE DUCT PVC CABLE RACEWAY. MC CABLE ABOVE CEILING IS ACCEPTABLE.
- PROVIDE ROOF PENETRATION CURB AS REQUIRED. REFER TO DETAIL 3/E001.
- NO NEW ELECTRICAL WORK IN THIS AREA UNLESS NOTED OTHERWISE
- PROVIDE LIFT COVER FOR FIRE ALARM PULL STATIONS.
- RELOCATED GYM PARTITION CONTROLS. COORDINATE LOCATION WITH THE OWNER.
- ROUTE WIREMOLD BELOW WINDOW FRAME ALONG WALL.
- PROVIDE GFI PROTECTED RECEPTACLE FOR WATER COOLER AT 19"AFF COORDINATE FINAL LOCATION WITH PLUMBING DRAWINGS AND WATER COOLER SPECIFICATION SHEET.
- PROVIDE FLUSH MOUNTED DUPLEX RECEPTACLE.
- RELOCATED FIRE ALARM STROBE. MAINTAIN MOUNTING HEIGHT. COORDINATE LOCATION WITH THE OWNER.


TEMPORARY REMOVAL AND REINSTALLATION OF EXISTING **CEILINGS AND CEILING MOUNTED EQUIPMENT:**

- 1. PROVIDE TEMPORARY SUPPORT OF EXISTING CEILING MOUNTED FIRE ALARM DEVICES WHEN EXISTING CEILINGS ARE REMOVED IN ANY PHASE OF CONSTRUCTION.
- 2. THE ELECTRICAL CONTRACTOR TO DISCONNECT, REMOVE, CLEAN, STORE, AND RE-INSTALL EXISTING LIGHT FIXTURES WHEN THE CEILINGS ARE TEMPORARILY REMOVED AND REINSTALLED. NOTIFY OWNER OF ANY EXISTING
- 3. THE CEILING SYSTEMS TO BE TEMPORARILY REMOVED AND REINSTALLED .
- 4. REMOVE, STORE AND RE-INSTALL EXISTING DROPPED CEILINGS AS NECESSARY TO PERFORM WORK. NOTIFY OWNER OF ANY EXISTING DAMAGE TO CEILING TILE AND SUPPORTS PRIOR TO REMOVAL. REPLACE ANY TILES AND SUPPORTS DAMAGED AS A RESULT OF WORK. AMOUNT OF CEILING TO BE REMOVED IS AT CONTRACTOR'S DISCRETION. REINSTALL ALL REMOVED CEILING AT COMPLETION OF WORK. MAKE EVERY EFFORT TO MINIMIZE OPEN CEILINGS.


GENERAL NOTES:

DAMAGE TO LIGHT FIXTURES PRIOR TO REMOVAL.

- 1. TAKE NECESSARY STEPS TO PROTECT EXISTING DATA CABLE, LIGHTING FIXTURES, FIRE ALARM DEVICES,FIRE ALARM WIRING, LIGHTING AND POWER WIRING, AUDIO EQUIPMENT AND ITS WIRING IN THE PLENUM SPACE IN THE AREAS AFFECTED BY CEILING AND DUCT WORK REMOVAL. REMOVAL AND INSTALLATION OF THE POWER, LIGHTING, FIRE ALARM, DATA, AUDIO EQUIPMENT AND WIRING INCIDENTAL TO OTHER TRADE WORK SHALL BE INCLUDED IN THE ELECTRICAL SCOPE AND PRICED.
- 2. RECEPTACLES SHALL BE OF TAMPER RESISTANCE TYPE INSTALLED PER NEC 406.12
- 3. EXISTING FIRE ALARM CONTROL PANEL IS SHOWN ON DRAWING 2/E101E.

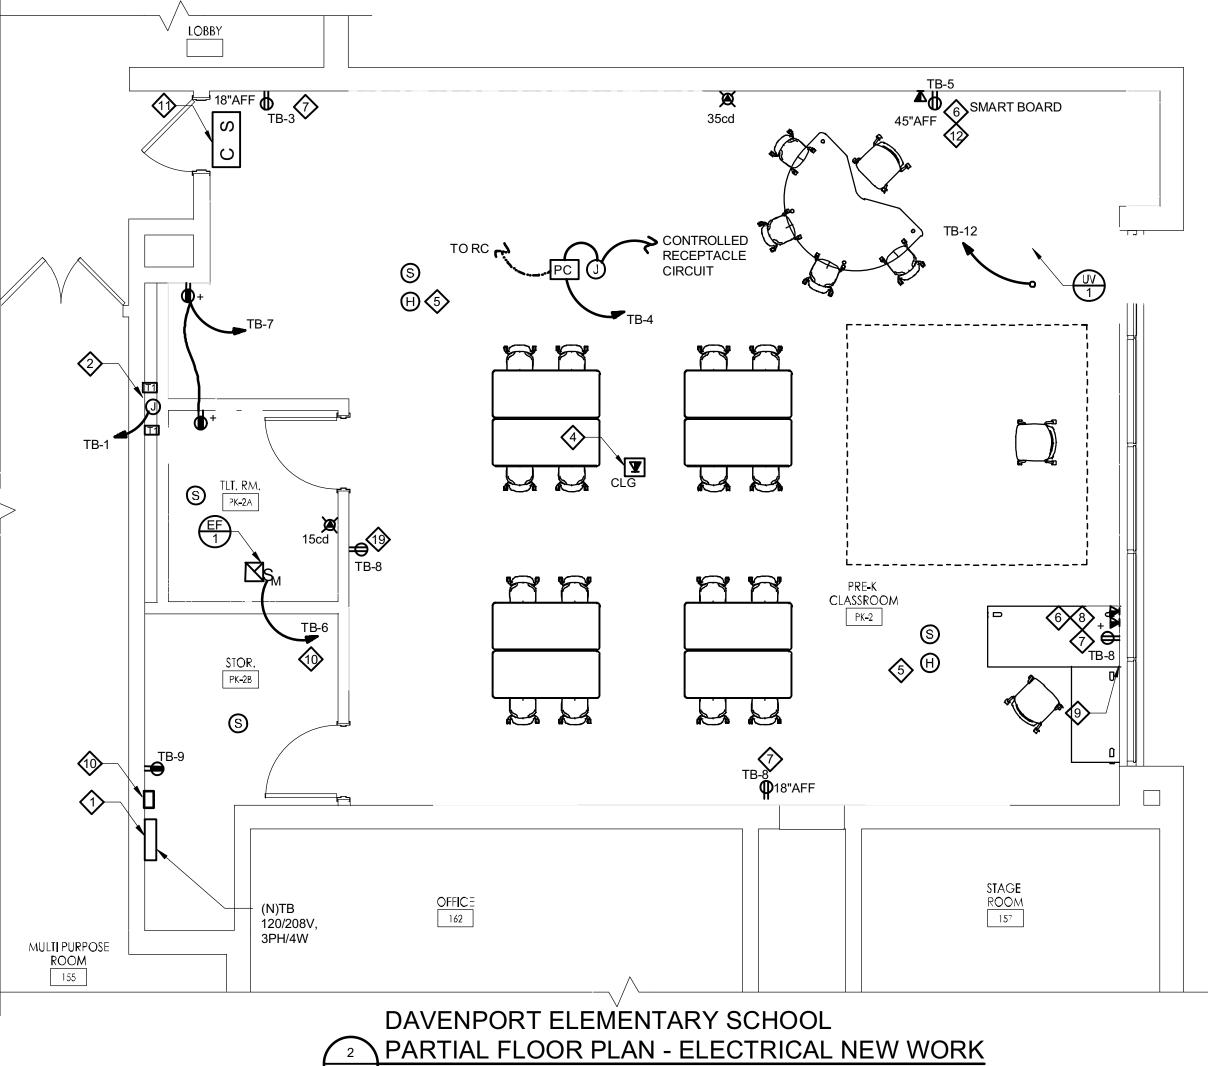

E202 E SCALE: 1/4" = 1'-0"

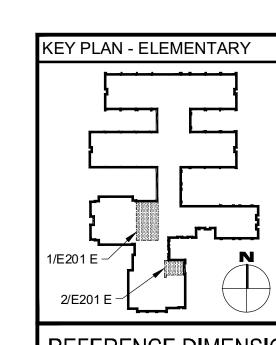

REFERENCE DIMENSION

INDICATED DIMENSION IS MEASURED AT ONE (1) INCH IN LENGTH AND PROVIDED FOR REFERENCE/VERIFICATION ONLY.

Gillan & Hartmann, Inc.

MECHANICAL AND ELECTRICAL

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gillan-hartmann.com ghmail@gillan-hartmann.com

G&H Project No. 2024-147

DATE

NO. 24GE04470000

11/01/2024 ISSUE FOR BID **ENGINEER** MICHAEL S. GILLAN, PE

2024 GILLAN & HARTMANN, Inc.

Renovations for Five (5) Pre-K Classrooms at Clayton J. Davenport School

Project Owner Name Egg Harbor Township School District

Project Location 2501 Spruce Ave,


Egg Harbor Township, NJ 08234 Project Number

Project Date 11.01.2024

Scale AS NOTED Drawing Name **ELEMENTARY**

SCHOOL **ELECTRICAL NEW** WORK - PARTIAL PLAN

No. Date Description

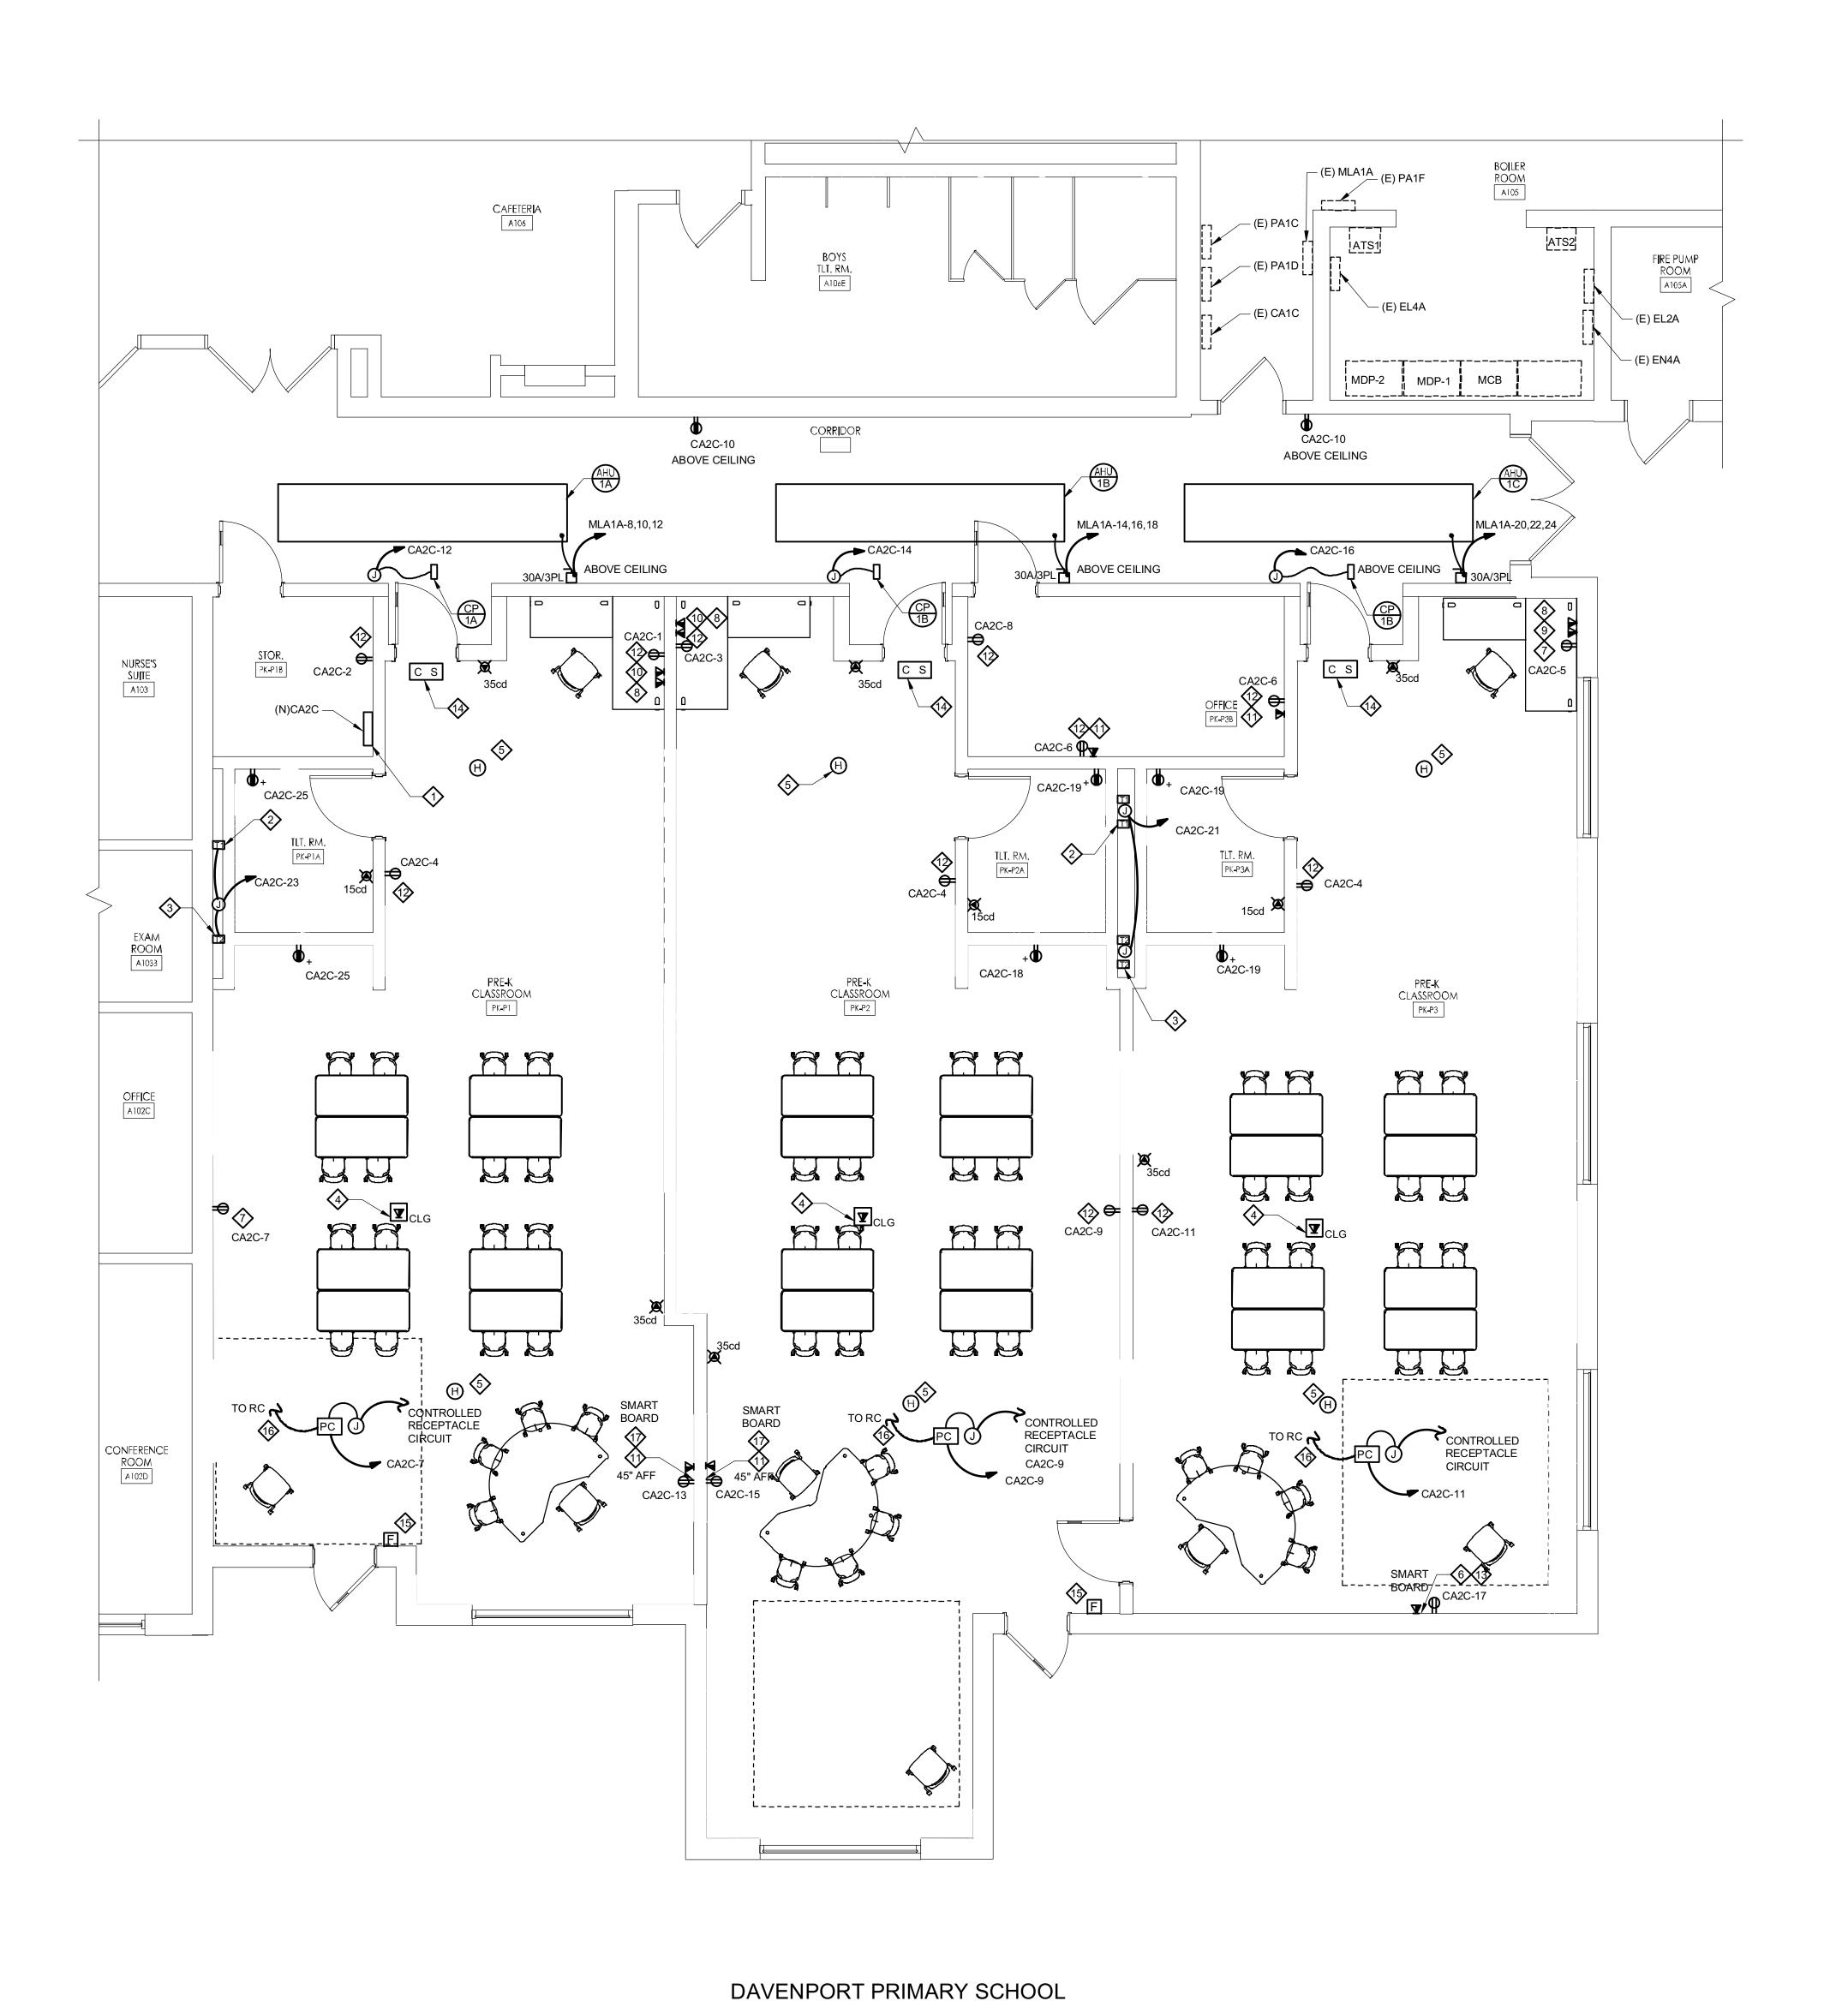

PARTIAL FLOOR PLAN - ELECTRICAL NEW WORK

E202 P SCALE: 1/4" = 1'-0"

TEMPORARY REMOVAL AND REINSTALLATION OF EXISTING CEILINGS AND CEILING MOUNTED EQUIPMENT:


- 1. PROVIDE TEMPORARY SUPPORT OF EXISTING CEILING MOUNTED FIRE ALARM DEVICES WHEN EXISTING CEILINGS ARE REMOVED IN ANY PHASE OF CONSTRUCTION.
- 2. DISCONNECT, REMOVE, CLEAN, STORE, AND RE-INSTALL EXISTING LIGHT FIXTURES WHEN THE CEILINGS ARE TEMPORARILY REMOVED AND REINSTALLED. NOTIFY OWNER OF ANY EXISTING DAMAGE TO LIGHT FIXTURES PRIOR
- 3. THE CEILING SYSTEMS TO BE TEMPORARILY REMOVED AND REINSTALLED BY THE GENERAL CONTRACTOR.
- 4. REMOVE, STORE AND RE-INSTALL EXISTING DROPPED CEILINGS AS NECESSARY TO PERFORM WORK. NOTIFY OWNER OF ANY EXISTING DAMAGE TO CEILING TILE AND SUPPORTS PRIOR TO REMOVAL. REPLACE ANY TILES AND SUPPORTS DAMAGED AS A RESULT OF WORK. AMOUNT OF CEILING TO BE REMOVED IS AT CONTRACTOR'S DISCRETION. REINSTALL ALL REMOVED CEILING AT COMPLETION OF WORK. MAKE EVERY EFFORT TO MINIMIZE OPEN CEILINGS.

GENERAL NOTES:

- TAKE NECESSARY STEPS TO PROTECT EXISTING DATA CABLE, LIGHTING FIXTURES, FIRE ALARM DEVICES, FIRE ALARM WIRING, LIGHTING AND POWER WIRING, AUDIO EQUIPMENT AND ITS WIRING IN THE PLENUM SPACE IN THE AREAS AFFECTED BY CEILING AND DUCT WORK REMOVAL. REMOVAL AND INSTALLATION OF THE POWER, LIGHTING, FIRE ALARM, DATA, AUDIO EQUIPMENT AND WIRING INCIDENTAL TO OTHER TRADE WORK SHALL BE INCLUDED IN THE ELECTRICAL SCOPE AND PRICED.
- 2. EC TO FURNISH AND INSTALL NEW DATA CABLE AS INDICATED ON THE DRAWING. TERMINATE CABLE IN RJ45 JACKS. EACH DATA CABLE TO BE ROUTED TO DATA RACK SWITCH. PROVIDE 6FT SLACK. CABLE TO BE LABELED PER OUTLET LOCATION. FINAL CONNECTION TO THE SWITCH BY THE SCHOOL IT DEPARTMENT.
- 3. RECEPTACLES SHALL BE OF TAMPER RESISTANCE TYPE INSTALLED PER NEC 406.12
- 4. EXISTING FIRE ALARM CONTROL PANEL IS LOCATED IN THE MAIN OFFICE.

NEW WORK NOTES:

- PROVIDE NEW ELECTRICAL PANEL. REFER TO PANEL SCHEDULE AND SINGLE LINE DIAGRAM FOR PANEL INFORMATION.
- PROVIDE HARDWIRED 120VAC CIRCUIT AND 2 GANG BACKBOX FOR NEW TRANSFORMER T1 120V/24V. MOOD RING PROVIDED BY MANUFACTURER. TRANSFORMER EL208-40 IS PROVIDED WITH PLUMBING EQUIPMENT.
- 3 PROVIDE NEW TRANSFORMER T2 120V/6V PROVIDE 2GANG BACK BOX WITH MOOD RING. PROVIDE HARDWIRED 120VAC CIRCUIT. TRANSFORMER EL-386 TO BE ORDERED FROM PLUMBING EQUIPMENT MANUFACTURER.
- DATA OUTLET FOR WI-FI ROUTER INSTALLED ON THE CEILING. COORDINATE LOCATION WITH LIGHTING PLAN.
- 5 HEAT DETECTOR ABOVE THE CEILING.
- 6 FURNISH AND INSTALL SURFACE MOUNTED DATA OUTLET. INSTALL DATA WIRING IN WIREMOLD 2000 SERIES RACEWAY.
- PROVIDE SURFACE MOUNTED DUPLEX RECEPTACLE. INSTALL BACKBOX AND 3/4" CONDUIT UP TO CEILING SPACE. ELEVATION AS
- INDICATED. MC CABLE ABOVE CEILING IS ACCEPTABLE.
- 8 PROVIDE WALL PLATE WITH: USB 3.0 PORT, USB-C PORT, 4K HDMI 2.0 OUTLET, WALL PLATE WITH 2X RG45 OUTLETS. EXAMPLES: RITEAV 4 PORT CUSTOM KEYSTONE WALL PLATE W/DECOR-Z POWER OUTLET. ALTERNATE MANUFACTURERS: LEGRAND, BASEPORT, BUYER'S POINT, JIEYI, IBL-2.
- PROVIDE DOUBLE GANG SURFACE MOUNTED BACK BOX. AT 18"AFF UNO. LOW VOLTAGE WIRE TO BE INSTALLED IN SURFACE WIREMOLD COVERED TRAY.
- PROVIDE DOUBLE GANG FLUSH MOUNTED BACK BOX AT 18" AFF PROVIDE EMPTY 1" CONDUIT WITH A PULL STRING UP TO CEILING SPACE FOR DATA WIRING.
- PROVIDE SINGLE GANG FLUSHMOUNTED BACKBOX. PROVIDE FLUSHMOUNTED DATA OUTLET. ELEVATION AS INDICATED. PROVIDE 1" PVC CONDUIT WITH A PULL STRING UP TO CEILING LEVEL.
- PROVIDE FLUSH MOUNTED DUPLEX RECEPTACLE AT 18"AFF UNLESS NOTED OTHERWISE.
- PROVIDE SURFACE MOUNTED DUPLEX RECEPTACLE AT 45"AFF FOR SMART BOARD.
- INSTALL WALL MOUNTED COMBINATION CLOCK-SPEAKER. PROVIDE NEW BACKBOX. INSTALL SALVAGED CLOCK-SPEAKER EQUIPMENT. PROVIDE 1"CONDUIT WITH A PULL STRING UP TO CEILING SPACE. WIRING AND FINAL CONNECTION BY DISTRICT IT DEPARTMENT.
- PROVIDE ALARM LIFT COVER FOR FIRE ALARM PULL STATIONS.
- PLUG LOAD CONTROLLER TO BE CONTROLLED BY ROOM CONTROLLER. SHOWN ON DRAWING E201P. REFER TO DETAIL 3 ON DRAWING E401 FOR CONNECTION INSTRUCTIONS
- PROVIDE FLUSH MOUNTED DUPLEX RECEPTACLE AT 45"AFF FOR SMART BOARD.

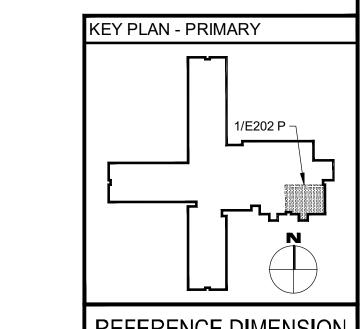

REFERENCE DIMENSION

ENGINEER DATE NO. 24GE04470000

INDICATED DIMENSION IS MEASURED AT ONE (1) INCH IN LENGTH AND PROVIDED FOR REFERENCE/VERIFICATION ONLY. Gilan & Hartmann, Inc.

MECHANICAL AND ELECTRICAL

CONSULTING ENGINEERS 610-935-0101 FAX: 610-935-7520 215-238-9510 609-347-1593 302-654-5959 gillan-hartmann.com ghmail@gillan-hartmann.com G&H Project No. 2024-147

11/01/2024 ISSUE FOR BID MICHAEL S. GILLAN, PE

2024 GILLAN & HARTMANN, Inc.

Project Owner Name Egg Harbor Township School District

> Project Location 2501 Spruce Ave, Egg Harbor

> > Township, NJ 08234

Renovations for Five

(5) Pre-K Classrooms

Davenport School


at Clayton J.

Project Number Project Date 11.01.2024 Checked By

DRH Drawn By Scale AS NOTED

Drawing Name PR**I**MARY SCHOOL **ELECTRICAL NEW** WORK - FIRST FLOOR PARTIAL

No. Date Description

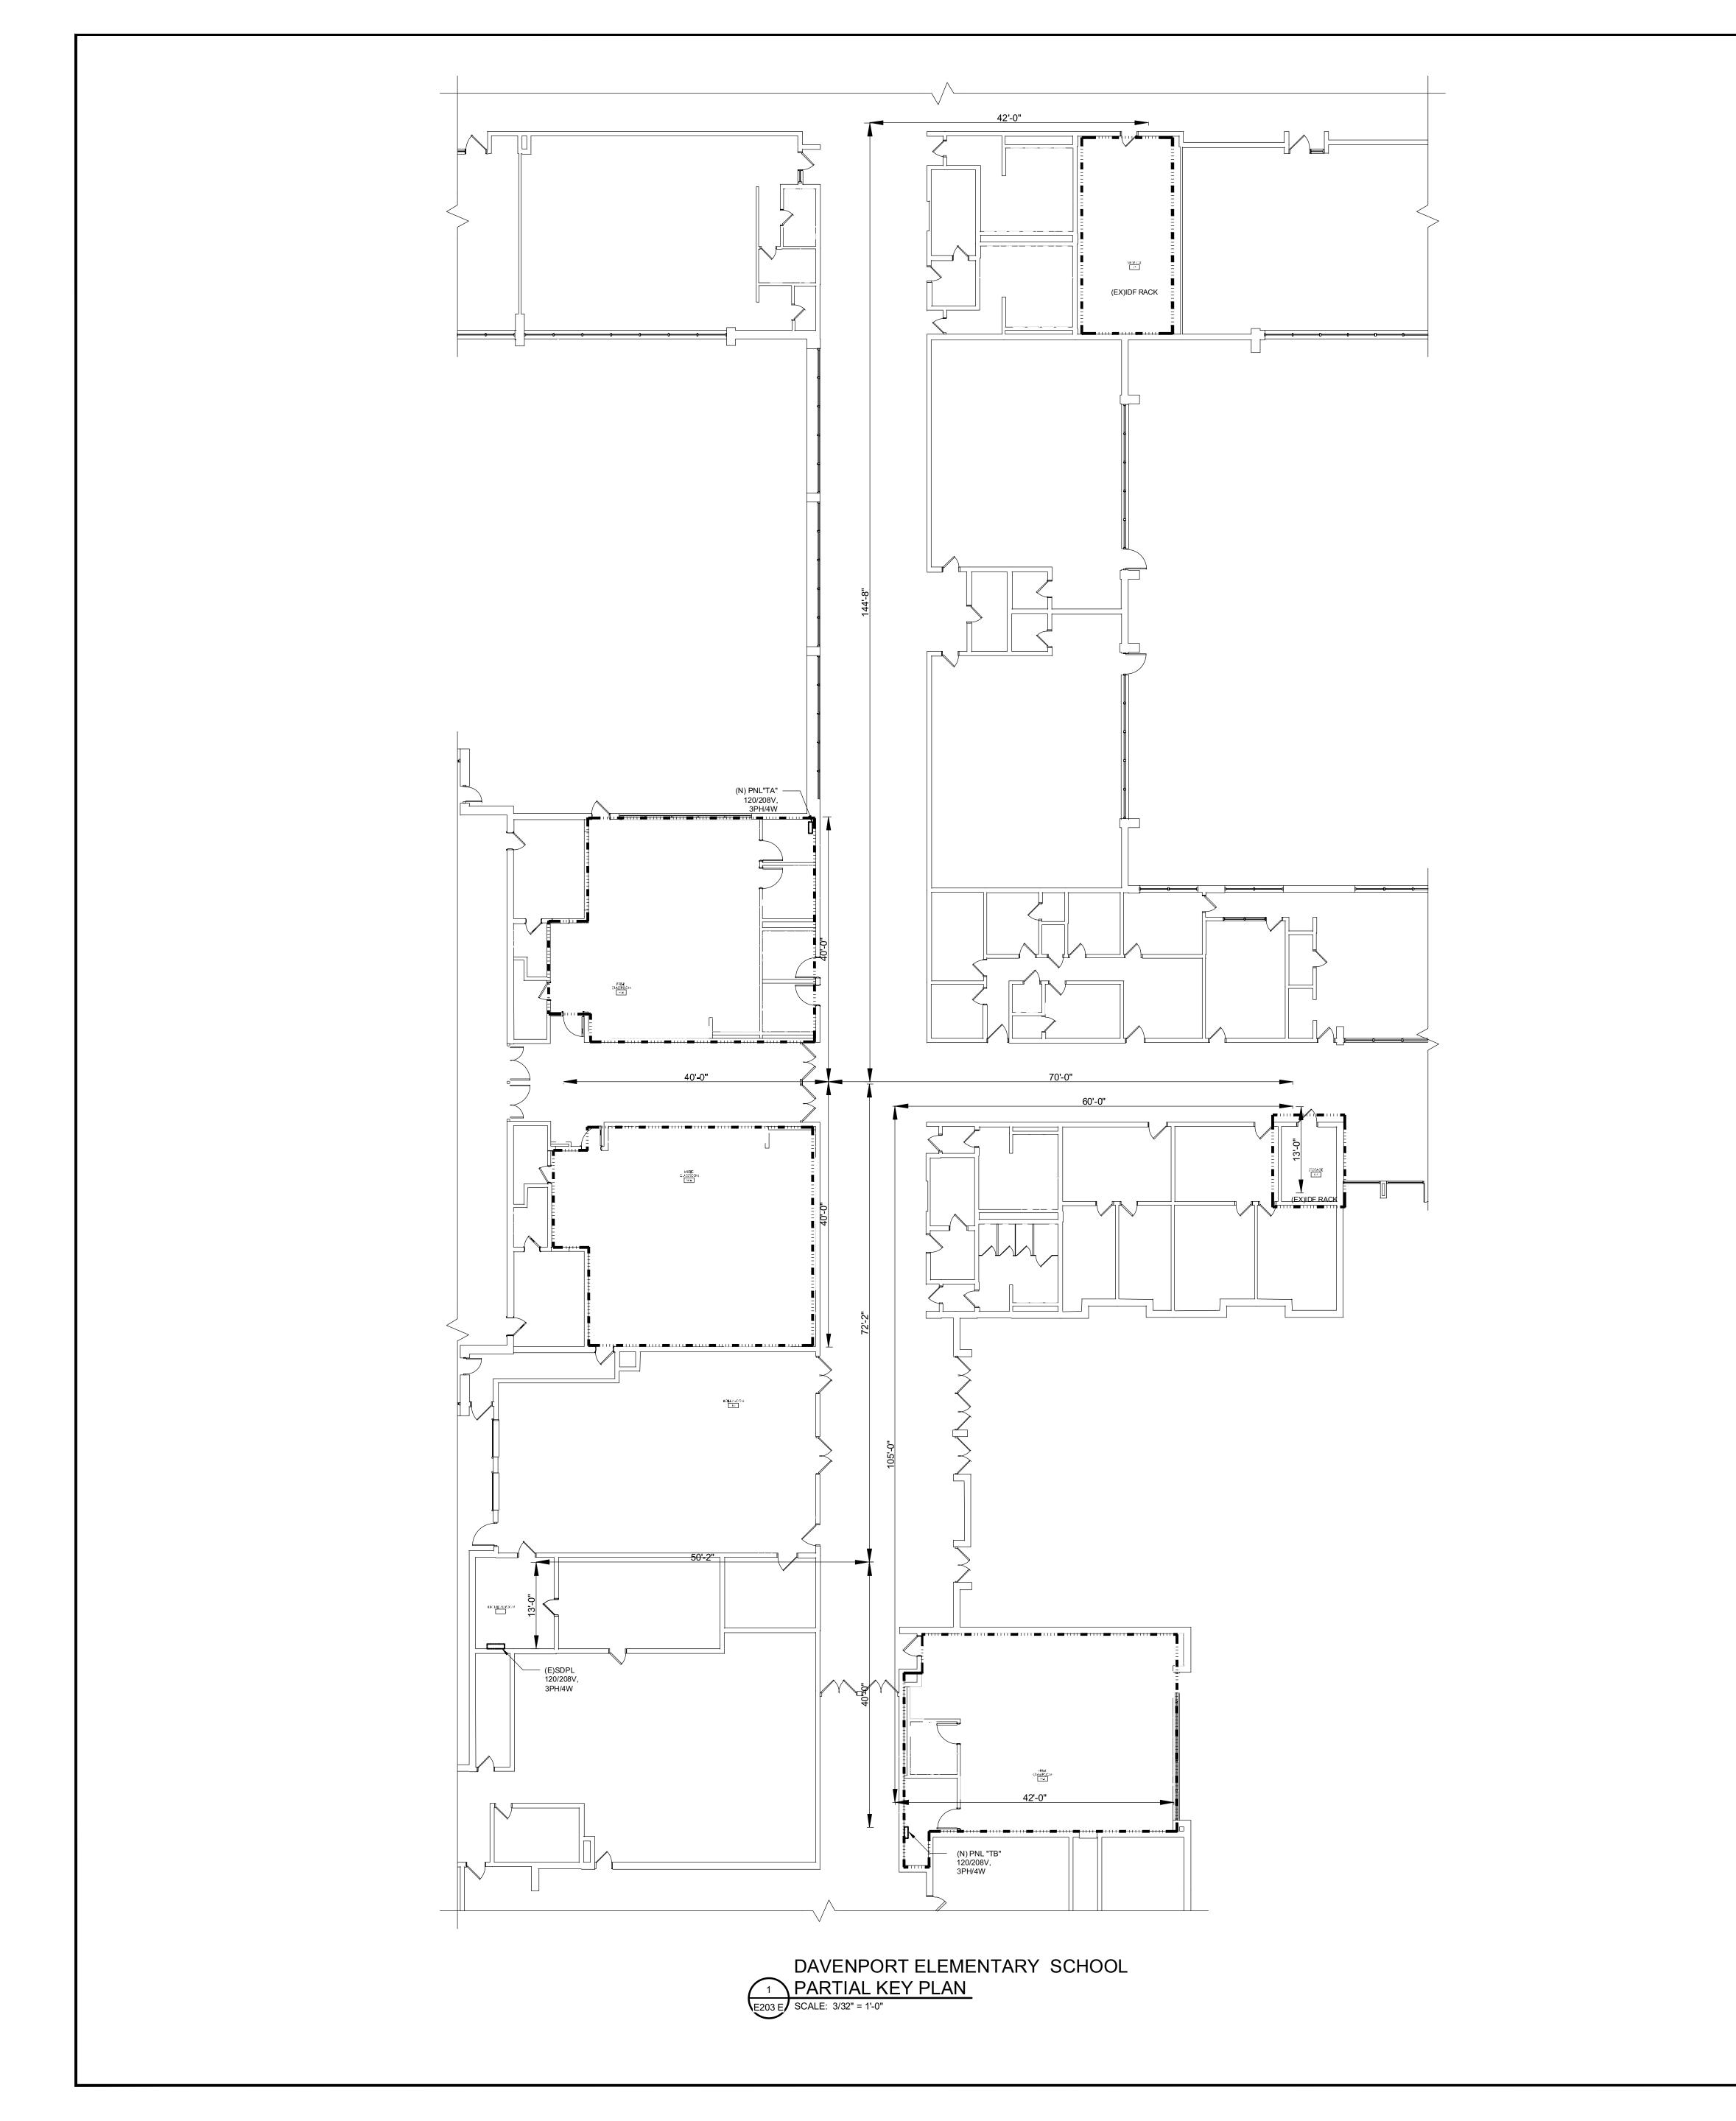

Renovations for Five (5) Pre-K Classrooms at Clayton J. Davenport School

Project Owner Name Egg Harbor Township School District

Project Location 2501 Spruce Ave, Egg Harbor Township, NJ 08234

Project Number 11.01.2024 DRH AS NOTED

KEY PLAN - ELEMENTARY Drawing Name **ELEMENTARY** SCHOOL PARTIAL KEY PLAN

1/E203 E REFERENCE DIMENSION

INDICATED DIMENSION IS MEASURED AT ONE (1) INCH IN LENGTH AND PROVIDED FOR REFERENCE/VERIFICATION ONLY.

No. Date Description

Gillan & Hartmann, Inc.

MECHANICAL AND ELECTRICAL

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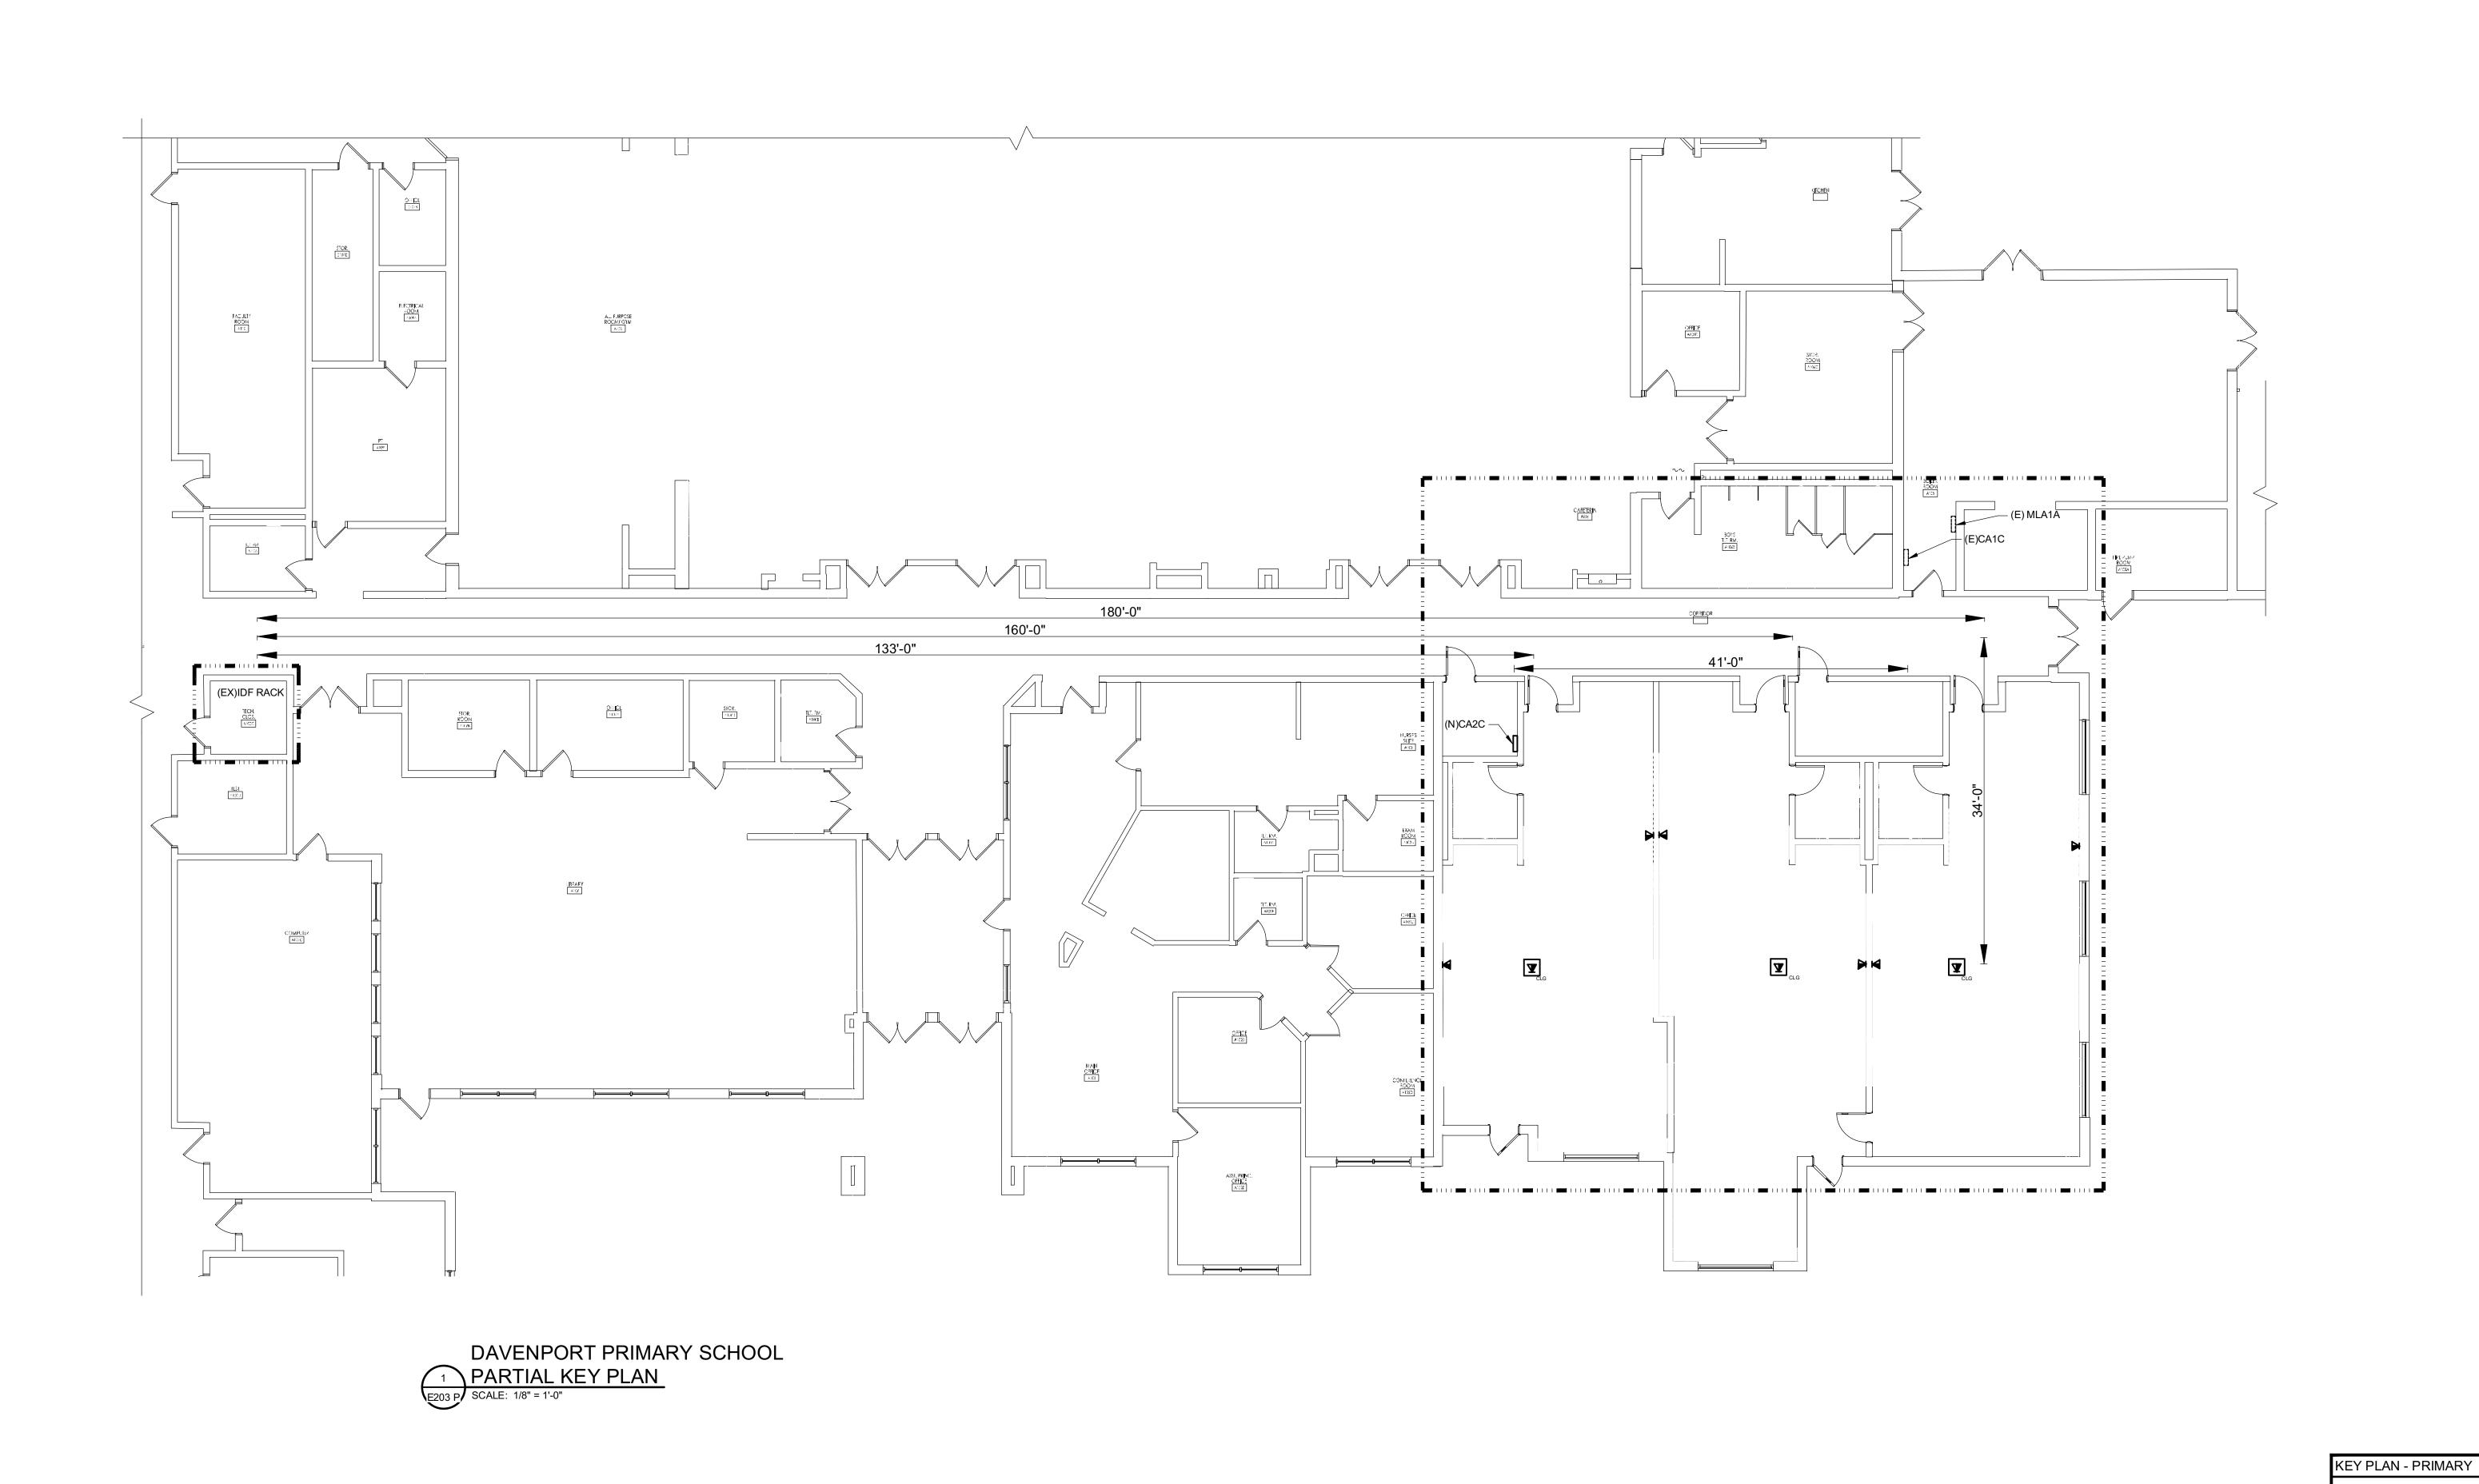
G&H Project No. 2024-147

Drawing Number

DATE NO. 24GE04470000

11/01/2024 ISSUE FOR BID

ENGINEER MICHAEL S. GILLAN, PE



Renovations for Five (5) Pre-K Classrooms at Clayton J. Davenport School

Project Owner Name Egg Harbor Township School District

Project Location 2501 Spruce Ave, Egg Harbor Township, NJ 08234

Project Number 5481 Project Date 11.01.2024 Checked By

Drawn By Scale

AS NOTED

Drawing Name

PRIMARY SCHOOL PARTIAL KEY PLAN

No. Date Description

INDICATED DIMENSION IS MEASURED AT ONE (1) INCH IN LENGTH AND PROVIDED FOR REFERENCE/VERIFICATION ONLY.

Gillan & Hartmann, Inc.

MECHANICAL AND ELECTRICAL

CONSULTING ENGINEERS

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G&H Project No. 2024-147 Drawing Number

11/01/2024 ISSUE FOR BID


Cert. of Auth #24GA27932400 ENGINEER

DATE MICHAEL S. GILLAN, PE


2024 GILLAN & HARTMANN, Inc.

REFERENCE DIMENSION


NO. 24GE04470000

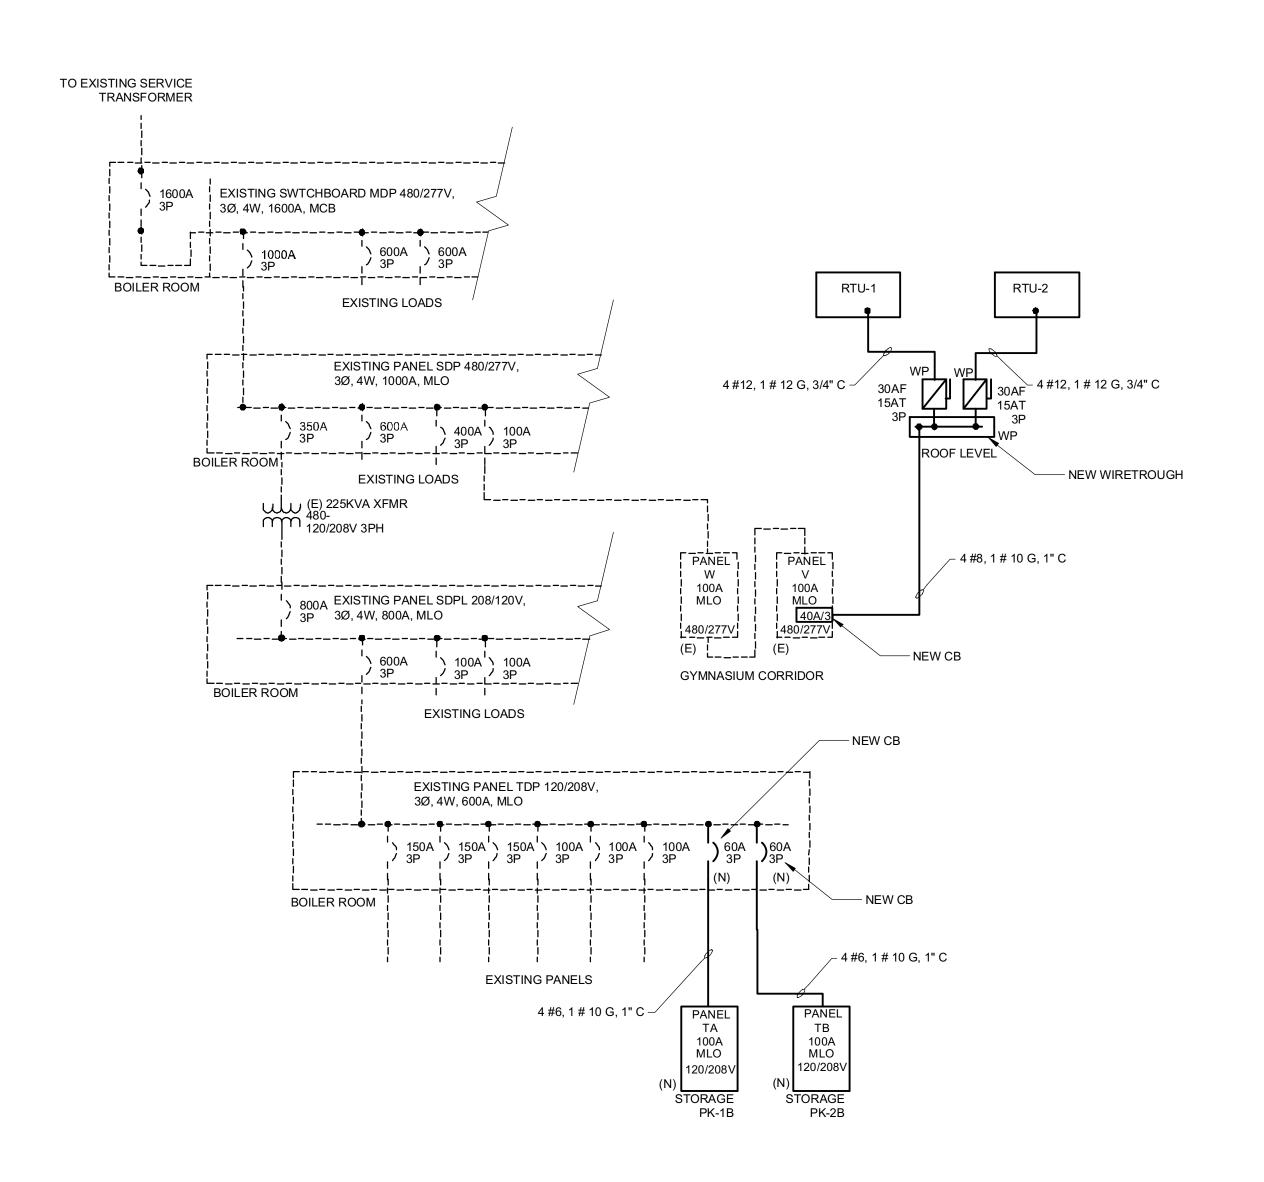


1 ELEMENTARY SCHOOL PARTIAL SINGLE LINE DIAGRAM
E401 SCALE: NO SCALE

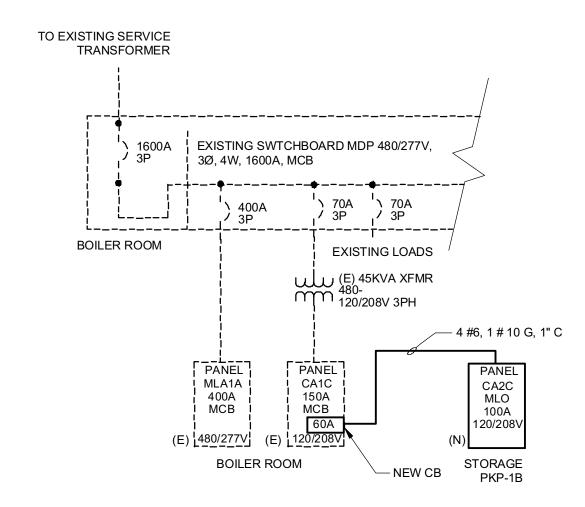

PRIMARY SCHOOL PARTIAL SINGLE LINE DIAGRAM E401 SCALE: NO SCALE

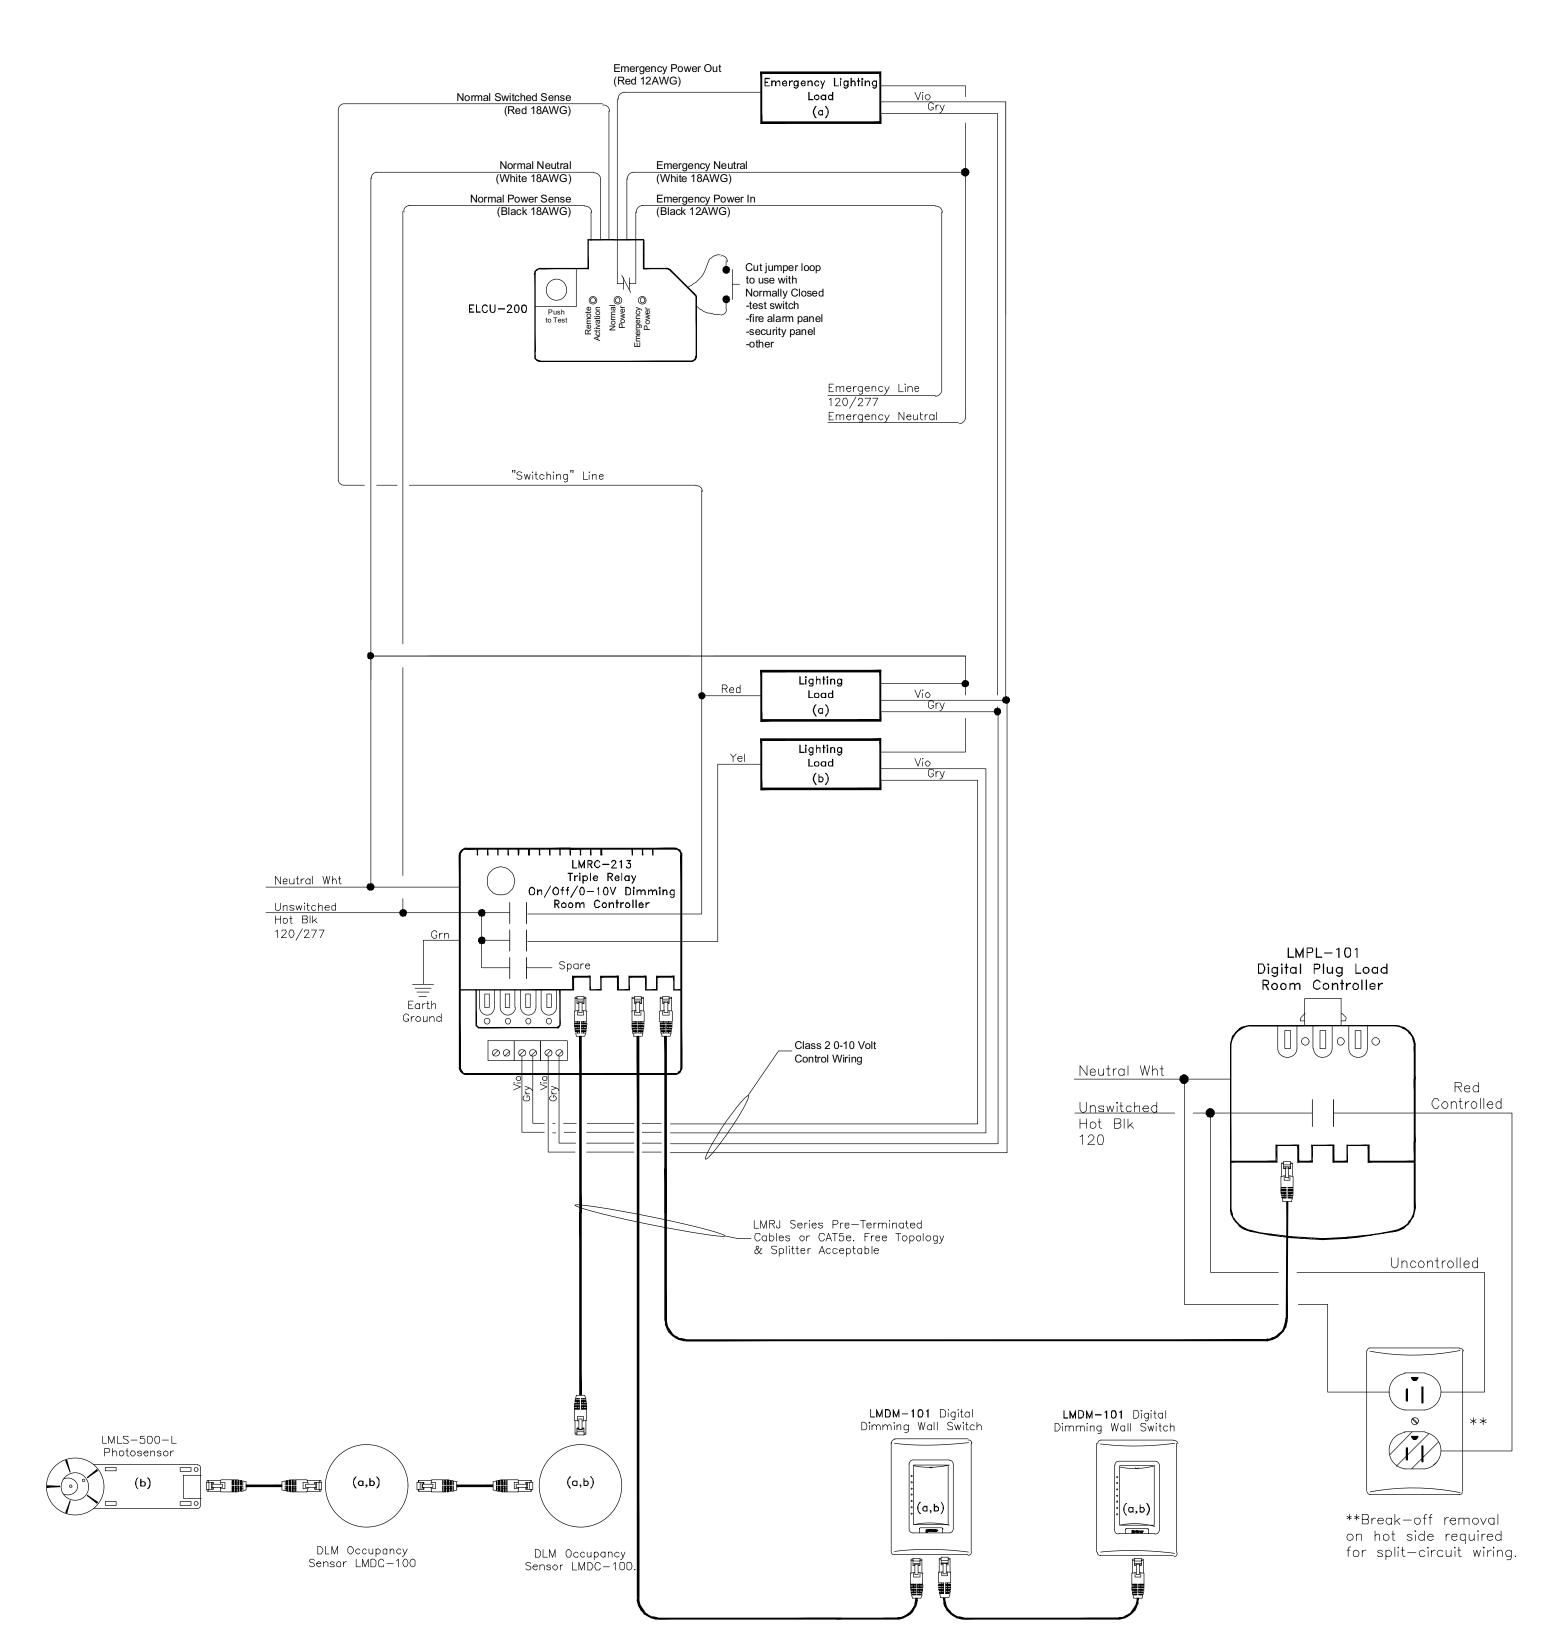

TYPICAL CLASSROOM LIGHTING CONTROL DIAGRAM E401 SCALE: NO SCALE

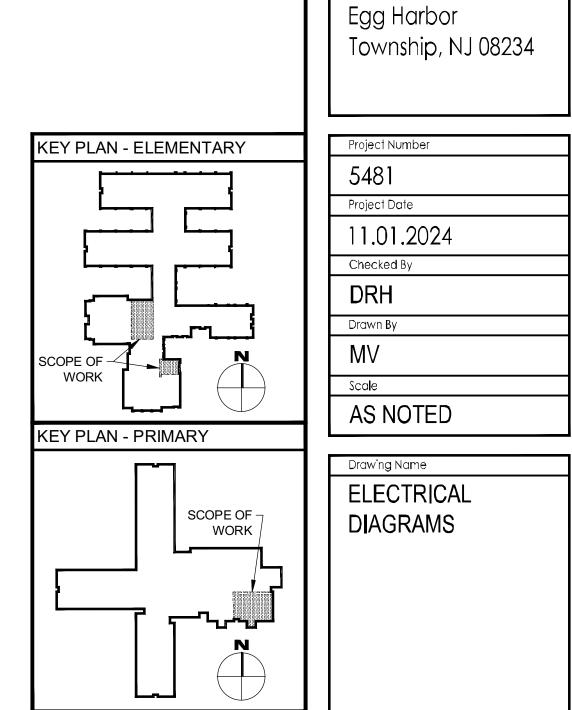

No. Date Description INDICATED DIMENSION IS MEASURED AT ONE (1) INCH IN LENGTH AND PROVIDED FOR

Renovations for Five

(5) Pre-K Classrooms

Davenport School

Egg Harbor Township

at Clayton J.

Project Owner Name

School District

Project Location

2501 Spruce Ave,

Gillan & Hartmann, Inc.

MECHANICAL AND ELECTRICAL

CONSULTING ENGINEERS

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G&H Project No. 2024-147 DATE

REFERENCE DIMENSION

REFERENCE/VERIFICATION ONLY.

11/01/2024 ISSUE FOR BID

ENGINEER MICHAEL S. GILLAN, PE NO. 24GE04470000

2024 GILLAN & HARTMANN, Inc.

	_			MLA1A 22KAIC 480Y/277Volt 3 Phase	4 Wi	re		Exis	sting P	anel				Main Circuit Breaker Number of Poles:	40			
FEE	DER C	ATA	CIR NO	LOAD DESCRIPTION		C.B. TRIP	C.B. LOAD	PHASE A	PHASE B	PHASE C		C.B. TRIP	POLE	LOAD DESCRIPTION	CIR	FEE	DER I	ATAC
No.	WIRE	GND			NQ.	Α .	VA	``	-	•	VA	Α	NO.		NO.	No.	WIRE	GND
			1 3 5	EXISTING P-3	3	60						20	3	EXISTING EF-1	SP AR E			
			7 9 11	EXISTING PUMP-4	3	60		831	831	831	831 831 831	15	3	(N)AHU-1A	8 10 12	4	12	12
			13 15 17	EXISTING PUMP-5	3	40		831	831	831	831 831 831	15	3	(N)AHU-1B	14 16 18	4	12	12
			19 21 23	EXISTING COOLING TOWER	3	60		831	831	831	831 831 831	15	3	(N)AHU-1C	20 22 24	4	12	12
			25 27 29	SPARE	3	20						50	3	EXISTING AHU -14	26 28 30			
			31 33 35	SPARE	3	20						50	3	SPARE	32 34 36			
2			37	EXISTING A HU 16	1	20						20	1	EX PARKING LT LTG	38	2		
2			39	EXISTING A HU 20	1	20						20	1	EX FLAG POLE AND T- CLK	40	2		
2			41	SPA RE	1	20						20	1	EX PARKING LT LTG	42	2		
Pa	nel T	уре:	Nen	na 1	 P	hase (Conn.	2493	2493	2493	VA			Remarks:				
Мо	untin	g:	Sur	face	То	tal Co	nnecte	d Load	7	KVA	9	AMI	PS					
	catior d Fro		BOI MDI	ILER RM PS P			,	Voltage	400 480			-		All conduit 3/4" Unless Oth (N) Provide new breaker.	erwis	e Sp	ecifie	d.

-	•		CA1C 22KAIC 208Y/120Volt 3 Phase	e 4 wir	е		Exis	sting P	anel				Main Lugs Only Number of Poles:	<u> </u>	50 -2		
	R DATA	CIR NO	LOAD DESCRIPTION		TRIP		PHASE A	PHASE B	PHASE C	C.B. LOAD	1	I	LOAD DESCRIPTION	CIR		EDER C	
o. WR	E GND			NO.	A	VA				VA	A	NÓ.		NO.	No.	WRE	GNE
			EXISTING LOAD	1	20						20	1	SPARE	2			
			EXISTING LOAD	1	20						20	1	EX GYM	4			
			EXISTING LOAD	1	20						20	1	EX KITCHEN	6			
			EXISTING LOAD	1	20						20	1	SPARE	8			
			EXISTING LOAD	1	20						20	1	EXISTING LOAD	10			l
			EXISTING LOAD	1	20						20	1	EXISTING LOAD	12			
			EXISTING LOAD	1	20						20	1	EXISTING LOAD	14			
			EXISTING LOAD	1	20						20	1	EXISTING LOAD	16			
			EXISTING LOAD	1	20						20	1	EXISTING LOAD	18			
			EXISTING LOAD	1	20						20	1	EXISTING LOAD	20			
			SPARE	1	20						20	1	EXISTING LOAD	22			
			SPARE	1	20						20	1	SPARE	24			
		25	SPARE	1	20						20	1	EX NURSES RM	26			
			EX LIBRARY	1	20						20	1	EX LIBRARY	28			
		29	SPARE	1	20						15	1	SPARE	30			
		31	SPARE	1	20		2758			2758				32			
		33	SPARE	2	20			2386		2386	60	3	(N) PANEL "CA2C"	34	4	6	10
		35			20				2026	2026				36			l
			SPARE	1	20						15	1	SPARE	38			
			SPARE	1	20						15	1	SPARE	40			
		41	SPARE								15	1	SPARE	42			
anel	Туре:	Ne	ma 1	Πр	hase (Çonn.	2758	2386	2026	VA			Remarks:				
				_							1						
l ount	ing:	Su	rface	''	tai Çü	mecte	d Load	7	KVA	20	AMI	75					
ocati	on:	ВС	ILER RM PS					225]				All conduit 3/4" Unless Ot	herwis	e Sp	ecifie	d.
ed F	rom:	ΧF	MR			,	Voltage	208									


•		: CA2C 22KAIC ge: 208Y/120Volt 3 Phase 4 wire						New Panel					Main Lugs Only Number of Poles:		00 2			
FEEDER DATA			CIR NO	I CAD DESCRIPTION	C.B. POLE NO.	C.B. TRIP A		PHASE A	PHASE B	PHASE C	C.B. LOAD VA		C.B. POLE NO.	LOAD DESCRIPTION	CIR NO.	FEEDER DA		
_				RCPT TCH DESK	1	20		720			360	20	1	STORAGE GFI		_		12
: :	12 12	12 12		RCPT TCH DESK	1	20	360	720	720		360	20 20			2	2	12 12	_
_	12	12			<u> </u>	20	360		720	700		20		SERVICE RCPT	4	2		1:
1				RCPT TCH DESK	1	20	360	000		720	360			RCPT OFFICE PK-P3B3K	6	2	12	1:
4	12	12		RCPT PLUG CONTROL PK-P1	1	20	720	900	4000		180	20	_	RCPT OFFICE PK-P3B3K	8	2	12	_
4	12	12		RCPT PLUG CONTROL PK-P2	1	20	720		1080	888	360	20	1	GFI SERVICE AHU ABOVE CLG	10	2	12	1
+	12 12	12	-	RCPT PLUG CONTROL PK-P3	1 1	20 20	720 250	418		১ ৯৯	168 168	20 20		CP-1 PWR ABOVECLG	12	2	12 12	1
_		12		RCPT TV PK-P1	<u> </u>			418	440		168			CP-2 PWR ABOVE CLG	14	2		1
+	12	12		RCPT TV PK-P2	1	20	250 250		418	250	108	20		CP-3 PWR ABOVECLG	16	2	12	Ľ
-	12	12		RCPT TV PK-P3	1	20		200		250		20		SPARE	18	ሥ		\vdash
4	12	12		RCPT GFI COUNTER	1	20	360	360	400			20		SPARE	20	ሥ		\vdash
4	12	12		FOSETS PK-P2A, PK-P3A,	1 1	20	168		168	400		20		SPARE	22	ሥ		\vdash
4	12	12		FOSETS PKP1A, COUNTER	1	20	168	222		168		20	1	SPARE	24	ሥ	igwdown	\vdash
4	12	12		RCPT	1	20	360	360				20	1	SPARE	26	ሥ		\vdash
+				SPARE	1	20						20	1	SPARE SPARE	28	ሥ		\vdash
+				SPARE	1	20						15	1	SPARE	30	ሥ		\vdash
4				SPARE	1	20						20	2	SPARE	32	! !		
			33 35	SPARE	2	20								0P1 PF	34	ሥ		\vdash
+				054.55	+ -							20	1	SPARE	36	ሥ		\vdash
4				SPARE	1	20				*		15	1	SPARE SPARE	38	╙	└	\vdash
4				SPARE	1	20						15	1	SPARE	40	╙	└	\vdash
_			41	SPARE								15	<u>'</u>	SPARE	42			
aı	nel T	уре:	Nei	na 1	Ph	nase (Conn.	2758	2386	2026	VA			Remarks:				
l o	untin	g:	Sui	face	Tot	tal Co	nnecte	ed Load	7	KVA	20	AME	P\$					
00	atio	n:	ST	ORAGE PS	٦				100]				All conduit 3/4" Unless Othe	erwis	e S	pecifie	d.
	d Fro		CA		1		,	Voltage		1								
C	. I IC	7111.	<u> </u>	10				• onage	200	J								

Designation: TA 22KAIC Panel Voltage: 208Y/120Volt 3 Phase 4					4 wire	1 wire			New Panel					Main Lugs Only Number of Poles:		100 30		
FEEDER DATA		CIR NO	L LOAD DESCRIPTION	C.B. POLE NO.	C.B. TRIP A		PHASE A	PHASE B	PHASE C	C.B. LOAD VA	C.B. TRIP A	C.B. POLE NO.	E LOAD DESCRIPTION		FEEDER DAT			
VO .	WIRE	GND			140.		V -								NO.	No.	WRE	
_	40	45	-	SPARE	1	20	000	56			56	20	1	FAUCET PK-1	2	2	12	1
2	12	12		RCPT MC-1	1	20	360		528	000	168	20	1	EF-2, EF-3, EF-4	4	2	12	-
2	12	12	_	RCPT PLUG CONTROL PK1	7	20	540	416		900	360 56	20	٦	RCPT GFI ROOF	6	2	12	
2	12	12		RCPT GFI TR-1A, TR-1B		20	360 360	410	416		56 56	20 20	1	FAUCET TR-1B	8	2	12	
2	12 12	12 12		RCPT GFI PK-1 COUNTER RCPT GFI WATER COOLER	1	20 20	560		416	672	112	20	1	FAUCET PK-1A, TR-1A EF-5 EF-6 VIA TIMECLOCK	10	2	12 12	
_	12	12		SPARE SPARE	1	20	500	250		0/2	250	20	١	PROJECTION M.C-1	14	2	12	
2	12	12		RCPT TV PK-1	1	20	360	250	710		350	20	1	RCPT TV MC-1	16	2	12	
2	12	12		RCPT IV PK-1	1	20	360		710	360	350	20	1	SPARE	18		12	⊢
2	12	12		RCPT STORAGE PK-1B	1	20	360	360		300		20	1	SPARE	_	20		
2	12	12		RCPT PLUG CONTROL M.C-1	+ +	20	360	300	360			20	-	SPARE SPARE	22	\vdash	\vdash	
2	12	12		RCPT GFI M C-1 COUNTER	1	20	360		300	360		20	-	SPARE	24	\vdash	\vdash	
-	12	12		SPARE	1	20	500			500		20	1	SPARE	26	\vdash		
				SPARE	1	20						20	1	SPARE	28			
				SPARE	+ 1	20						20	1	SPARE	30			
Panel Type: Mounting: Location:				Phase Conn. Total Connecte		1082 ed Load	2014 5	2292 KVA	VA 15			Remarks: All conduit 3/4" Unless Otherwise Specified.						
			TD		-		,	/oltoge						-		- 1		
re	d Fro	m:	טון	۲	,			Voltage 208										

Designation: TB 22KAIC Panel Voltage: 208Y/120Volt 3 Phase 4					4 wire			N				Main Lugs Only Number of Poles:	-	100 30				
FEEDER DATA		DATA	CIR NO	LOAD DESCRIPTION	C.B. POLE	TRIP	C.B. LOAD	PHASE A	PHASE B	PHASE C	C.B. LOAD		POLE	LOAD DESCRIPTION	CIR	Ľ	EDER	
No.	WIRE	GND			NO.	A	VA				VA	А	NO.		NO.	No.	WIRE	GN
2	12	12	1	FAUCET PWR PK-2A	1	20	156	156				20	1	SPARE	2	2	12	12
2	12	12	_	RCPT PK-2	1	20	360		360			20	1	SPARE	4	2	12	12
2	12	12	5	RCPT TV PK-2	1	20	360			425	65	20	1	EF-1 VIA TIME CLOCK	6	2	12	12
2	12	12	7	RCPT GFI PK-2B	1	20	360	1080			720	20	1	RCPT PLUG CONTROL PK2	8	2	12	12
2	12	12	_	RCPT STORA GE PK-2B	1	20	180		180			20	1	SPARE	10			
2	12	12	11	SPARE	1	20				1530	1530	15	1	UV-1	12			
				SPARE	1	20						20	1	SPARE	14			
П			15	SPARE	1	20						20	1	SPARE	16			
			17	SPACE	1								1	SPACE	18			
			19	SPACE	1								1	SPACE	20			
			21	SPACE	1								1	SPACE	22			
			23	SPACE	1								1	SPACE	24			
			25	SPACE	1								1	SPACE	26			
			27	SPACE	1								1	SPACE	28			
			29	SPACE	1								1	SPACE	30			
Pa	nel T	уре:	Ne	ma 1	PI	Phase Conn.			540	1955	VA			Remarks:				
Мо	untin	g:	Su	rface	To	tal Co	nnecte	ed Load	4	KVA	10	AMI	PS					
Loc	cation	ո:	ST	ORAGE RM PK-2B ES					100					All conduit 3/4" Unless Otl	nerwis	se S	pecifie	ed.
Fe	d Fro	m:	TD	Р			,	Voltage	208]								

FEEDER DATA		ATA	CIR	I DADDESCRIPTION	POLE	TRIP	LOAD	PHASE A	PHASE B	PHASE C	C.B. LOAD	C.B. TRIP	C.B. POLE	LOAD DESCRIPTION	CIR	HEEDER DATA			
No.	WRE	GND				NO.	Α .	VA	''	-	-	VA	A	NO.		NO.	No.	WIRE	GNE
\neg			2	EX GYM LTG	1	20						20	1	EX GYMT LTG	1	2			
			4	EX GYM LTG	1	20						20	1	EX GYMT LTG	3	2			
			6	SPARE	1	20						20	1	SPARE	5	2			
			8	EX LOCKER 122 LTG	1	20						20	1	EX SHOWER LTG 120	7	2			
			10	EX LOCKER 130, OFF 134 LTG	1	20						20	1	EX CORR & SHOWER LTG 128	9	2			
			12	EX GYM LTG	1	20						20	1	EX LTG	11	2			
П			14				1460	1460				20	1	EX LTG	13	2			
4	8	10	16	(N) RTU-1 +(N) RTU-2	3	40	1460		1460						15				
			18				1460			1460			3	EX SUBFEED LUGS	17	1			
			20	ΕX	1	20									19				
			22												21				
			24	(E) AHU	3	20						20	3	(E) AHU	23	1			
			26												25	L	<u></u>	Щ	
Pa	nel T	уре:	Ner	 na 1	1 р	hase (Conn	1460	1460	1460	VA			Remarks:					
	untin		-	cessed	Phase Conn. Total Connecte				4	KVA	5 5	AMPS							

Symbol	Qty	Туре	Fixture Description	Manufacturer	Catalog Number	CONTROLS	ССТ	Volts	Watts	Lumens	Notes
L1	108	L1	2X4 ARCHITECTURAL TROFFER DROPPED CENTER LENS	LITHONIA LIGHTING	2GTL4400LMLP835 (CI-237C10)	0-10V DIMMING	3500K	120-277	34.1	4391	Or Equal
L1E	3	L1E	2X4 ARCHITECTURAL TROFFER DROPPED CENTER LENS PROVIDE FIELD INSTALLED EMERGENCY DRIVER	LITHONIA LIGHTING BODINE	2GTL4400LMLP835 (CI-237C10) BSL07 EM DRIVER	0-10V DIMMING	3500K	120-277	34.1	4391	Or Equal
 L2	5	A2	2X2 ARCHITECTURAL TROFFER DROPPED CENTER LENS	LITHONIA LIGHTING	2GTL2400LMLP835 (CI-237C10)	0-10V DIMMING	3500K	120-277	34.1	4391	Or Equal
G (A)	3	G	4IN ROUND RECESSED DOWNLIGHT	PRESCOLITE	LFR-4RD-M-10L35K8-XW-DM1 + LFR-4RD-T-SS-WT-CL	0-10V DIMMING	3500K	UNV	7.6	903	Or Equal
*	4	X2	LED EXIT/EMERGENCY COMBO SIGN REMOTE HEAD CAPABLE	EVENLIGHT	TDCOM-R 1-WW-RC	N/A	N/A	120-277	N/A	N/A	Or Equal
×	5	X1	EDGE LIT EXIT SIGN	EVENLIGHT	SOVII-EM-R-1C-BA-RC-AR-SD-FT	N/A	N/A	120-277	N/A	N/A	Or Equal
RH∢⊳	2	RH	REMOTE HEADS EXTERIOR	EVENLIGHT	PRWLED2-MV	N/A	N/A	12 OR 24 V	N/A	N/A	Or Equa

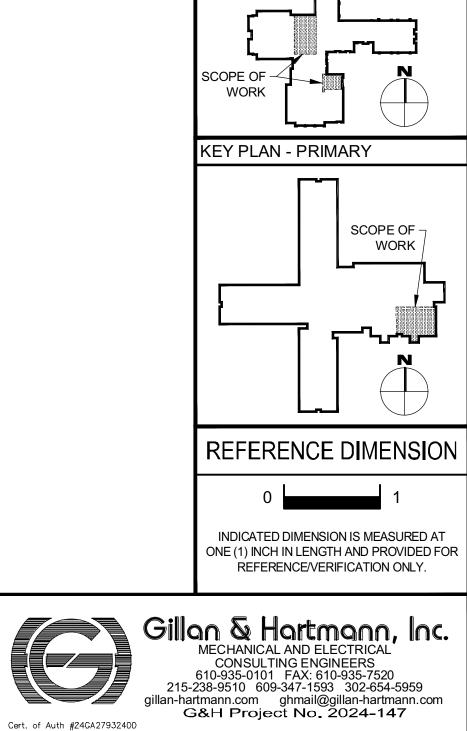

Cert. of Auth #24GA27932400 ENGINEER

DATE MICHAEL S. GILLAN, PE NO. 24GE04470000 2024 GILLAN & HARTMANN, Inc.

KEY PLAN - ELEMENTARY

SCOPE OF -WORK

E402

Drawing Number

Revisions

No. Date Description

Renovations for Five

(5) Pre-K Classrooms at Clayton J. Davenport School

Egg Harbor Township School District

2501 Spruce Ave, Egg Harbor Township, NJ 08234

Project Owner Name

Project Location

Project Number

5481

Project Date

Checked By

DRH

Drawn By

Scale

AS NOTED


Drawing Name

ELECTRICAL

SCHEDULES

11.01.2024

11/01/2024 ISSUE FOR BID

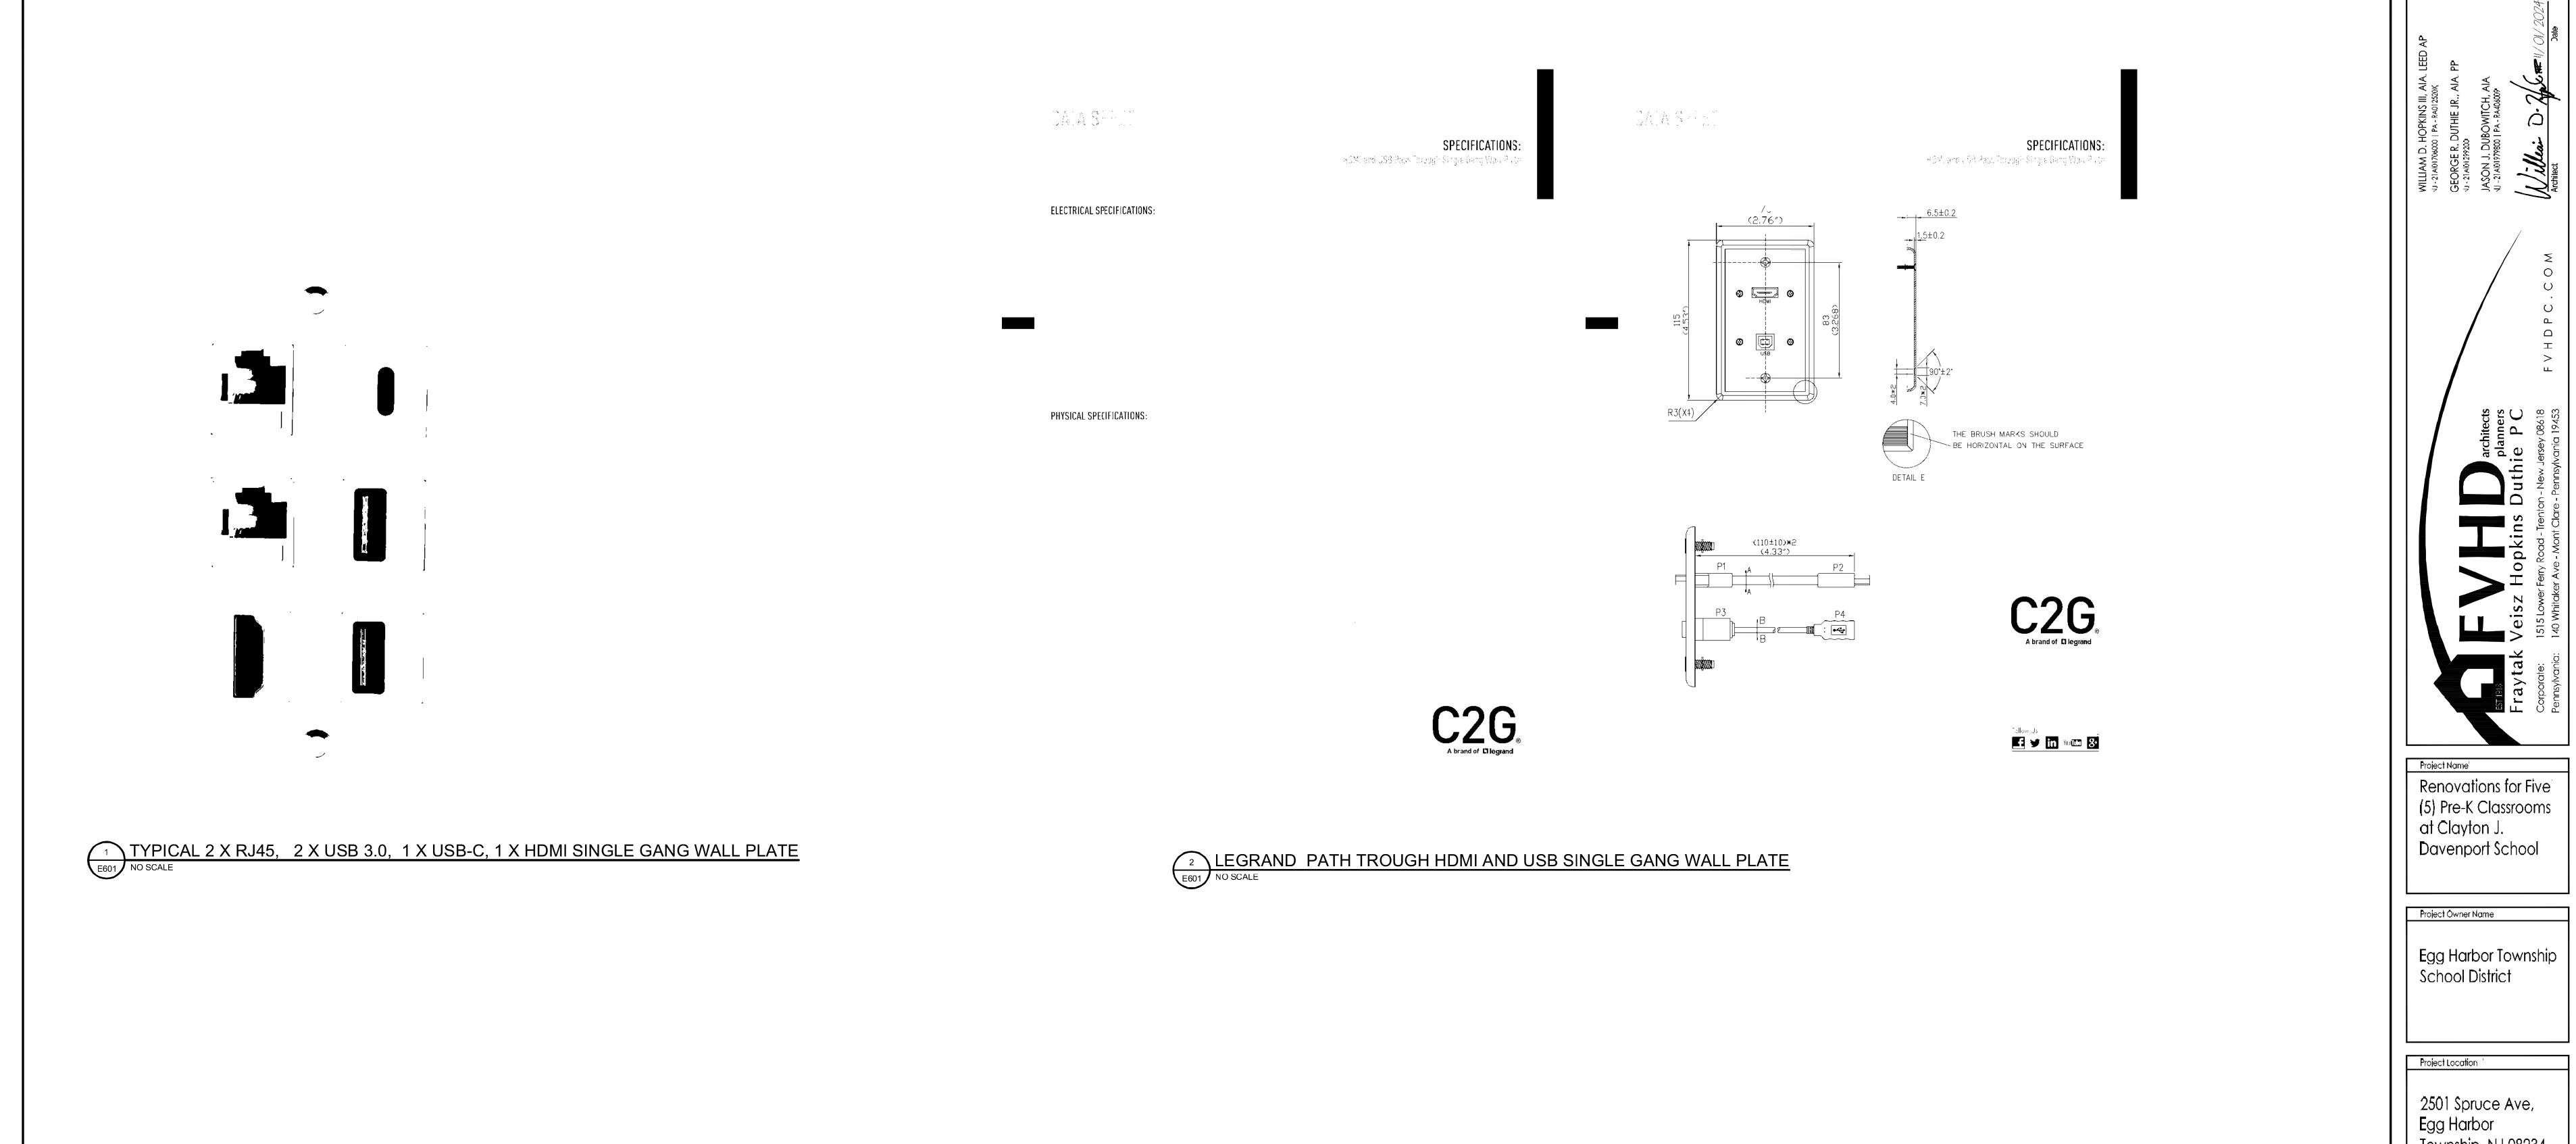

2501 Spruce Ave, Egg Harbor Township, NJ 08234 KEY PLAN - ELEMENTARY Project Number Project Date 11.01.2024 Checked By Drawn By SCOPE OF ~ WORK Scale AS NOTED KEY PLAN - PRIMARY Drawing Name ' ELECTRICAL SCOPE OF 7 WORK **DETAILS**

REFERENCE DIMENSION No.' Date Description

INDICATED DIMENSION IS MEASURED AT ONE (1) INCH IN LENGTH AND PROVIDED FOR REFERENCE/VERIFICATION ONLY. Gillan & Hartmann, Inc.

MECHANICAL AND ELECTRICAL

CONSULTING ENGINEERS

610-935-0101 FAX: 610-935-7520

215-238-9510 609-347-1593 302-654-5959

gillan-hartmann.com ghmail@gillan-hartmann.com

G&H Project No. 2024-147

Drawing Number E601

11/01/2024 ISSUE FOR BID

ENGINEER DATE MICHAEL S. GILLAN, PE NO. 24GE04470000