# SIGNATURE CHIEF SCHOOL ADMINISTRATOR SIGNATURE

# KITCHEN AND OFFICE RENOVATIONS AT BRIGANTINE CONSOLIDATED SCHOOL

301 EAST EVANS BLVD. BRIGANTINE, NJ 08203 FOR THE

# BRIGANTINE BOARD OF EDUCATION

301 EAST EVANS BLVD., BRIGANTINE, NJ 08203

SUPERINTENDENT:
BUSINESS ADMINISTRATOR:

JONATHAN HOUDART

**GLENN ROBBINS** 

SPIEZLE COMISSION NUMBER:

20K009

DOE STATE PROJECT NUMBER(S):

01-0570-300-20-2000 01-0570-300-21-1000

MEP CONSULTANT
KSI MECHANICAL ENGINEERS



SPIEZLE ARCHITECTURAL GROUP, INC 1395 YARDVILLE HAMILTON SQUARE ROAD SUITE 2A HAMILTON, NJ 08691

HAMILTON, NJ 08691
Phone: 609.695.7400 Fax: 609.394.2274
www.spiezle.com

BID DATE:

09/24/20

FOOD SERVICE CONSULTANT
RAYMOND AND RAYMOND


KITCHEN AND OFFICE RENOVATIONS AT BRIGANTINE CONSOLIDATED SCHOOL

20K009

DRAWING NUMBER:

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SCHOOL BOARD PRESIDENT OR VICE PRESIDENT

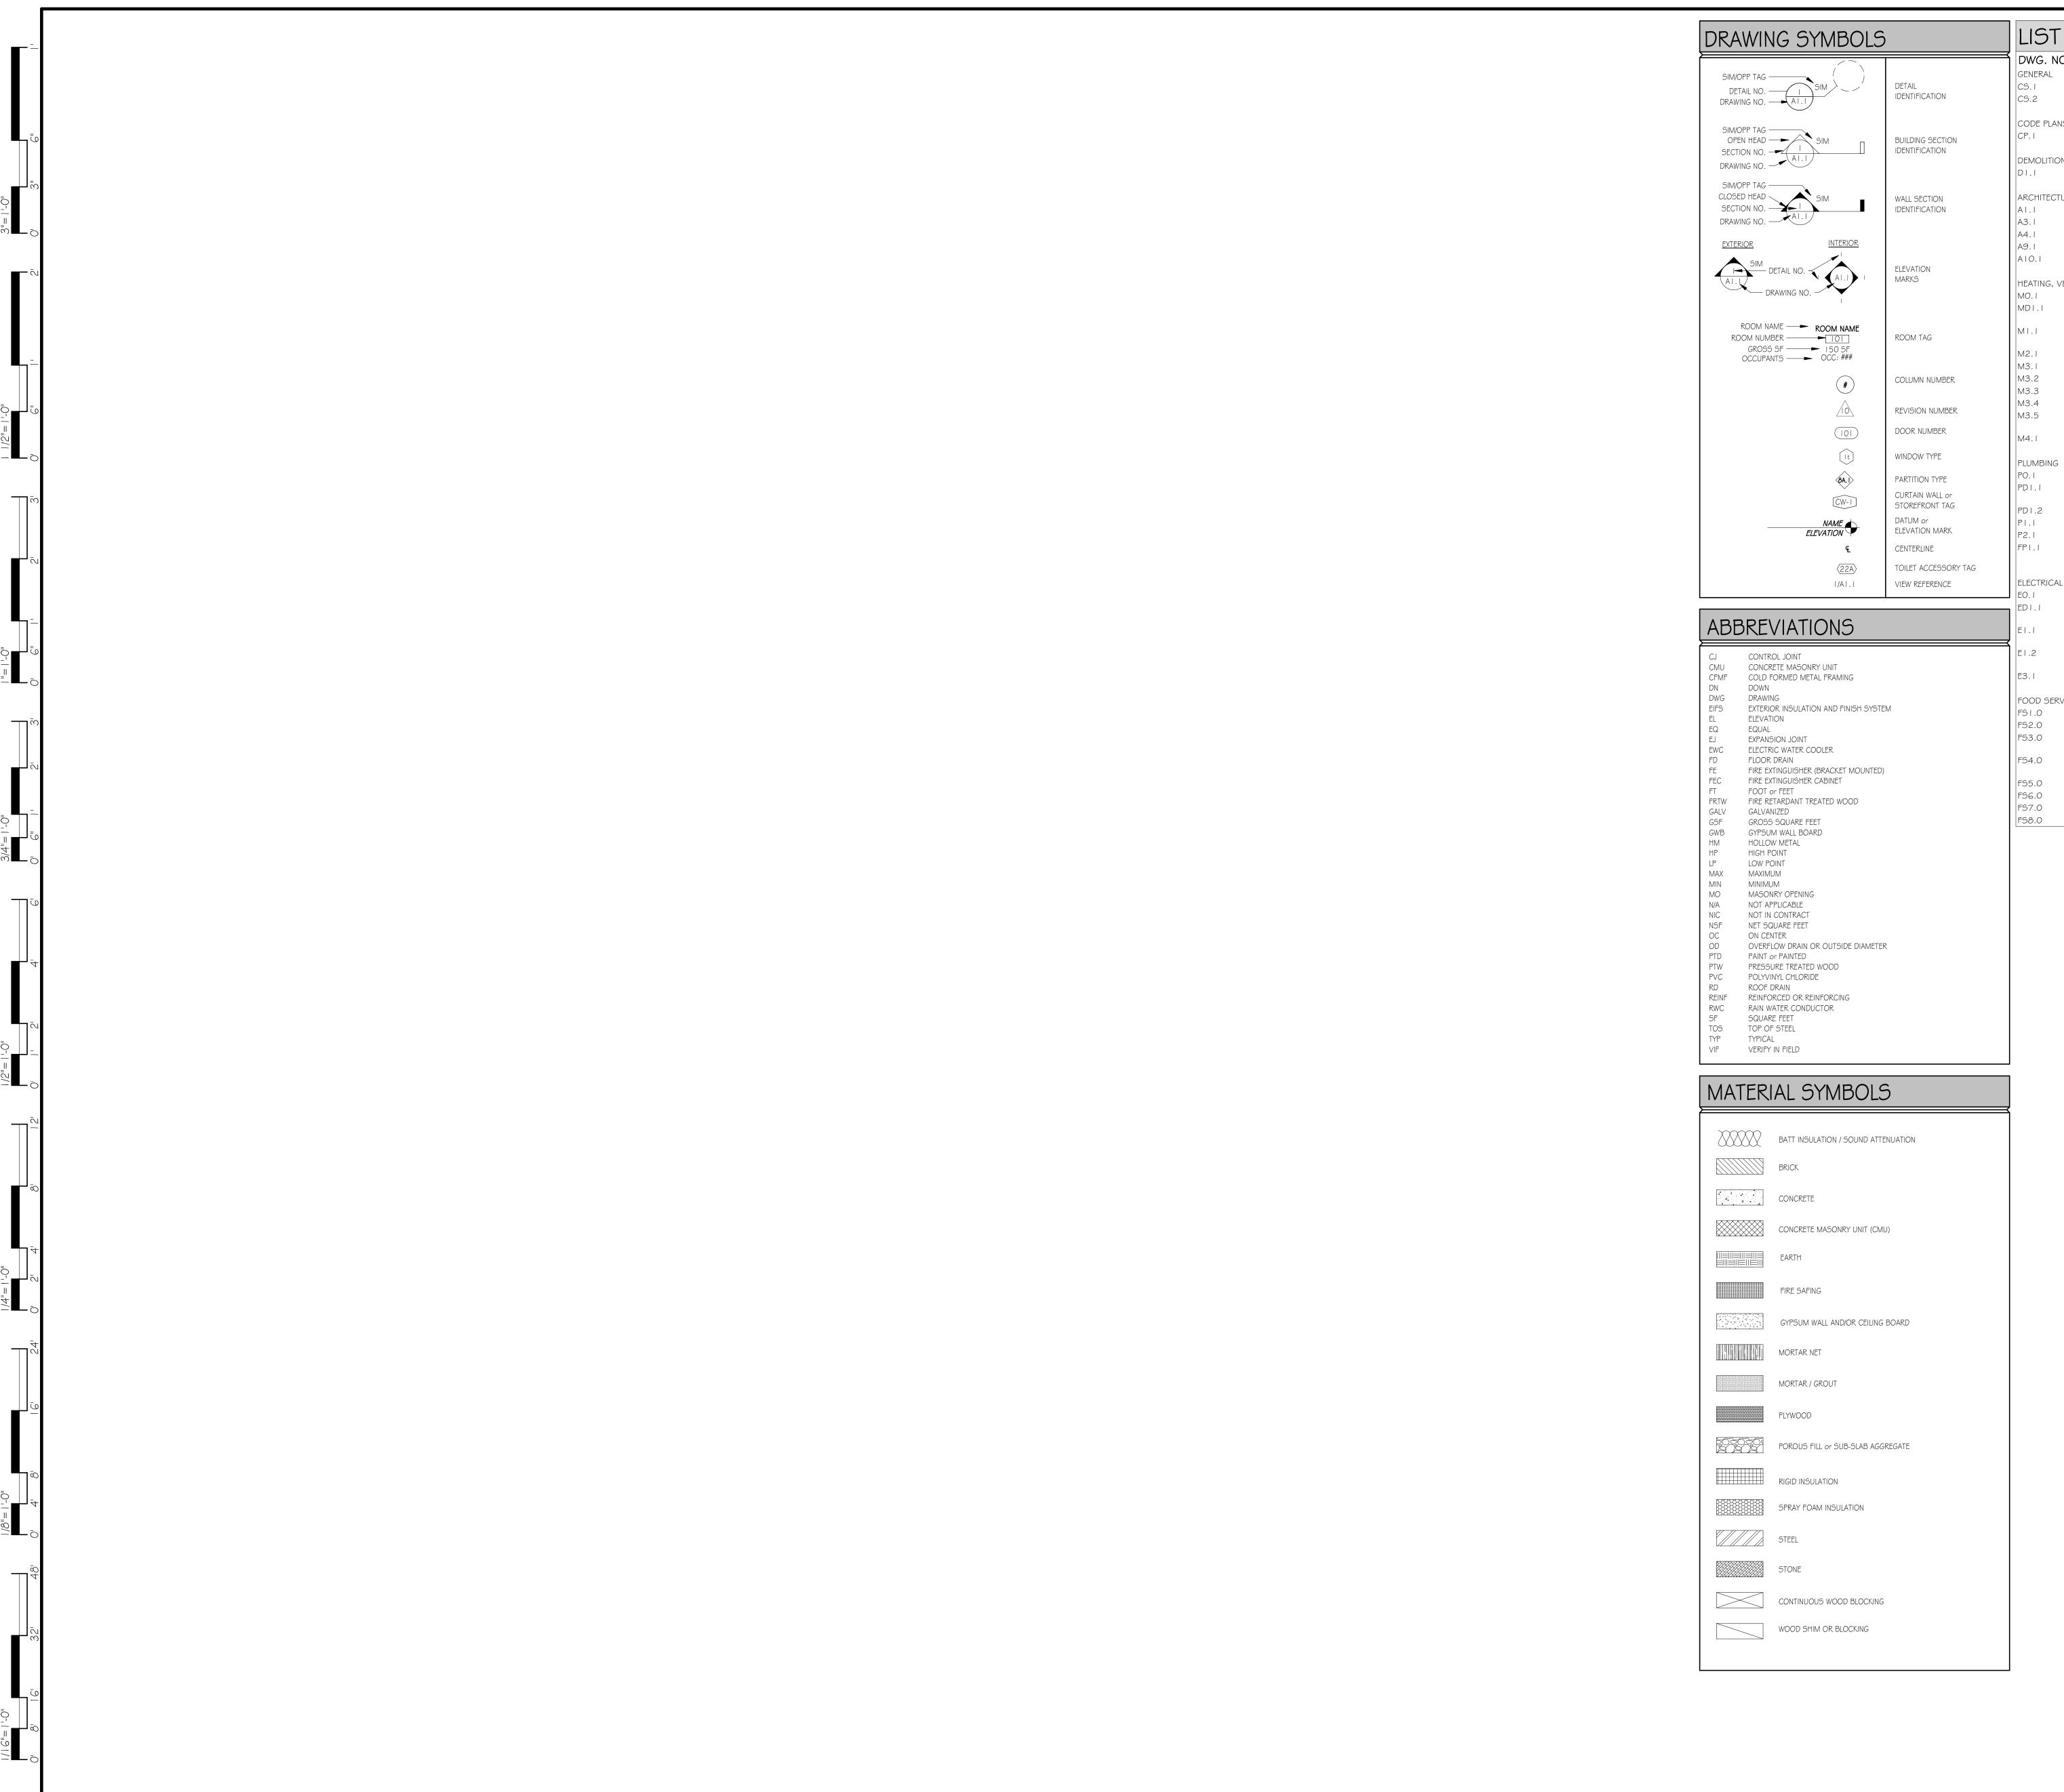

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LIST OF DRAWINGS DWG. NO. TITLE NOTES, ABBREVIATIONS AND LIST OF DRAWINGS CODE PLANS CODE PLANS DEMOLITION DI.I PARTIAL DEMOLITION PLANS ARCHITECTURAL A I . I PARTIAL FLOOR PLANS ROOF PLANS AND DETAILS REFLECTED CEILING PLANS AND DETAILS FINISH PLANS AND INTERIOR DETAILS DOOR, FRAME, AND WIDOW SCHEDULES AND DETAILS HEATING, VENTILATION, AND AIR CONDITIONING MECHANICAL GENERAL INFORMATION MECHANICAL FIRST, SECOND FLOOR AND ROOF DEMOLITION PARTIAL PLANS MECHANICAL FIRST, SECOND FLOOR AND ROOF NEW WORK PARTIAL PLANS MECHANICAL SCHEDULES MECHANICAL DETAILS MECHANICAL DETAILS MECHANICAL DETAILS MECHANICAL DETAILS FOR KITCHEN EXHAUST FAN (KEF-I) MECHANICAL DETAILS FOR KITCHEN MAKE UP AIR UNIT (MUA-1) MECHANICAL CONTROLS DETAILS PLUMBING GENERAL INFORMATION PLUMBING FIRST AND SECOND FLOOR DEMOLITON PARTIAL PLUMBING SECOND FLOOR DEMOLITION PARTIAL PLANS PLUMBING FIRST AND SECOND NEW WORK PARTIAL PLANS PLUMBING RISER DIAGRAMS FIRE PROTECTION FIRST AND SECOND FLOOR NEW WORK PARTIAL PLANS ELECTRICAL ELECTRICAL GENERAL INFORMATION ELECTRICAL FIRST AND SECOND FLOOR DEMOLITION PARTIAL ELECTRICAL FIRST AND SECOND FLOOR NEW WORK PARTIAL PLANS ELECTRICAL FIRST AND SECOND FLOOR NEW WORK POWER ELECTRICAL SCHEDULES AND DETAILS FOOD SERVICE FOOD SERVICE EQUIPMENT PLAN AND SCHEDULE FS2.0 FOOD SERVICE EXHAUST HOOD SCHEDULE \$ NOTES FS3.0 FOOD SERVICE EXHAUST HOOD SCHEUDLE AND NOTES CONTINUED FOOD SERVICE EXHAUST HOOD SCHEUDLE AND NOTES CONTINUED FOOD SERVICE ELECTRICAL CONNECTIONS PLAN AND NOTES FOOD SERVICE PLUMBING CONNECTIONS PLAN AND NOTES FOOD SERVICE SPECIAL CONDITIONS PLAN AND NOTES FOOD SERVICE SPECIAL CONDITIONS PLAN AND NOTES

CODE REVIEW: CERTIFICATE:

1395 YARDVILLE HAMILTON SQUARE ROAD SUITE 2A HAMILTON, NJ 08691 Phone: 609-695-7400 SIGNATURE: THOMAS S. PERRINO SCOTT E. DOWNIE STEVEN LEONE STEVEN G. SIEGEL 21AI01505400 21AI01674400 21Al01170100 21Al01564200

SPIEZLE ARCHITECTURAL GROUP INC.

SPIEZLE ARCHITECTURAL GROUP, INC. 21AC00063000 SEAL:

CONSULTANTS:

BID SET 09-24-20

PROJECT:

KITCHEN AND OFFICE RENOVATIONS AT BRIGANTINE CONSOLIDATED SCHOOL 301 EAST EVANS BLVD. BRIGANTINE, NJ 08203

BRIGANTINE BOARD OF EDUCATION

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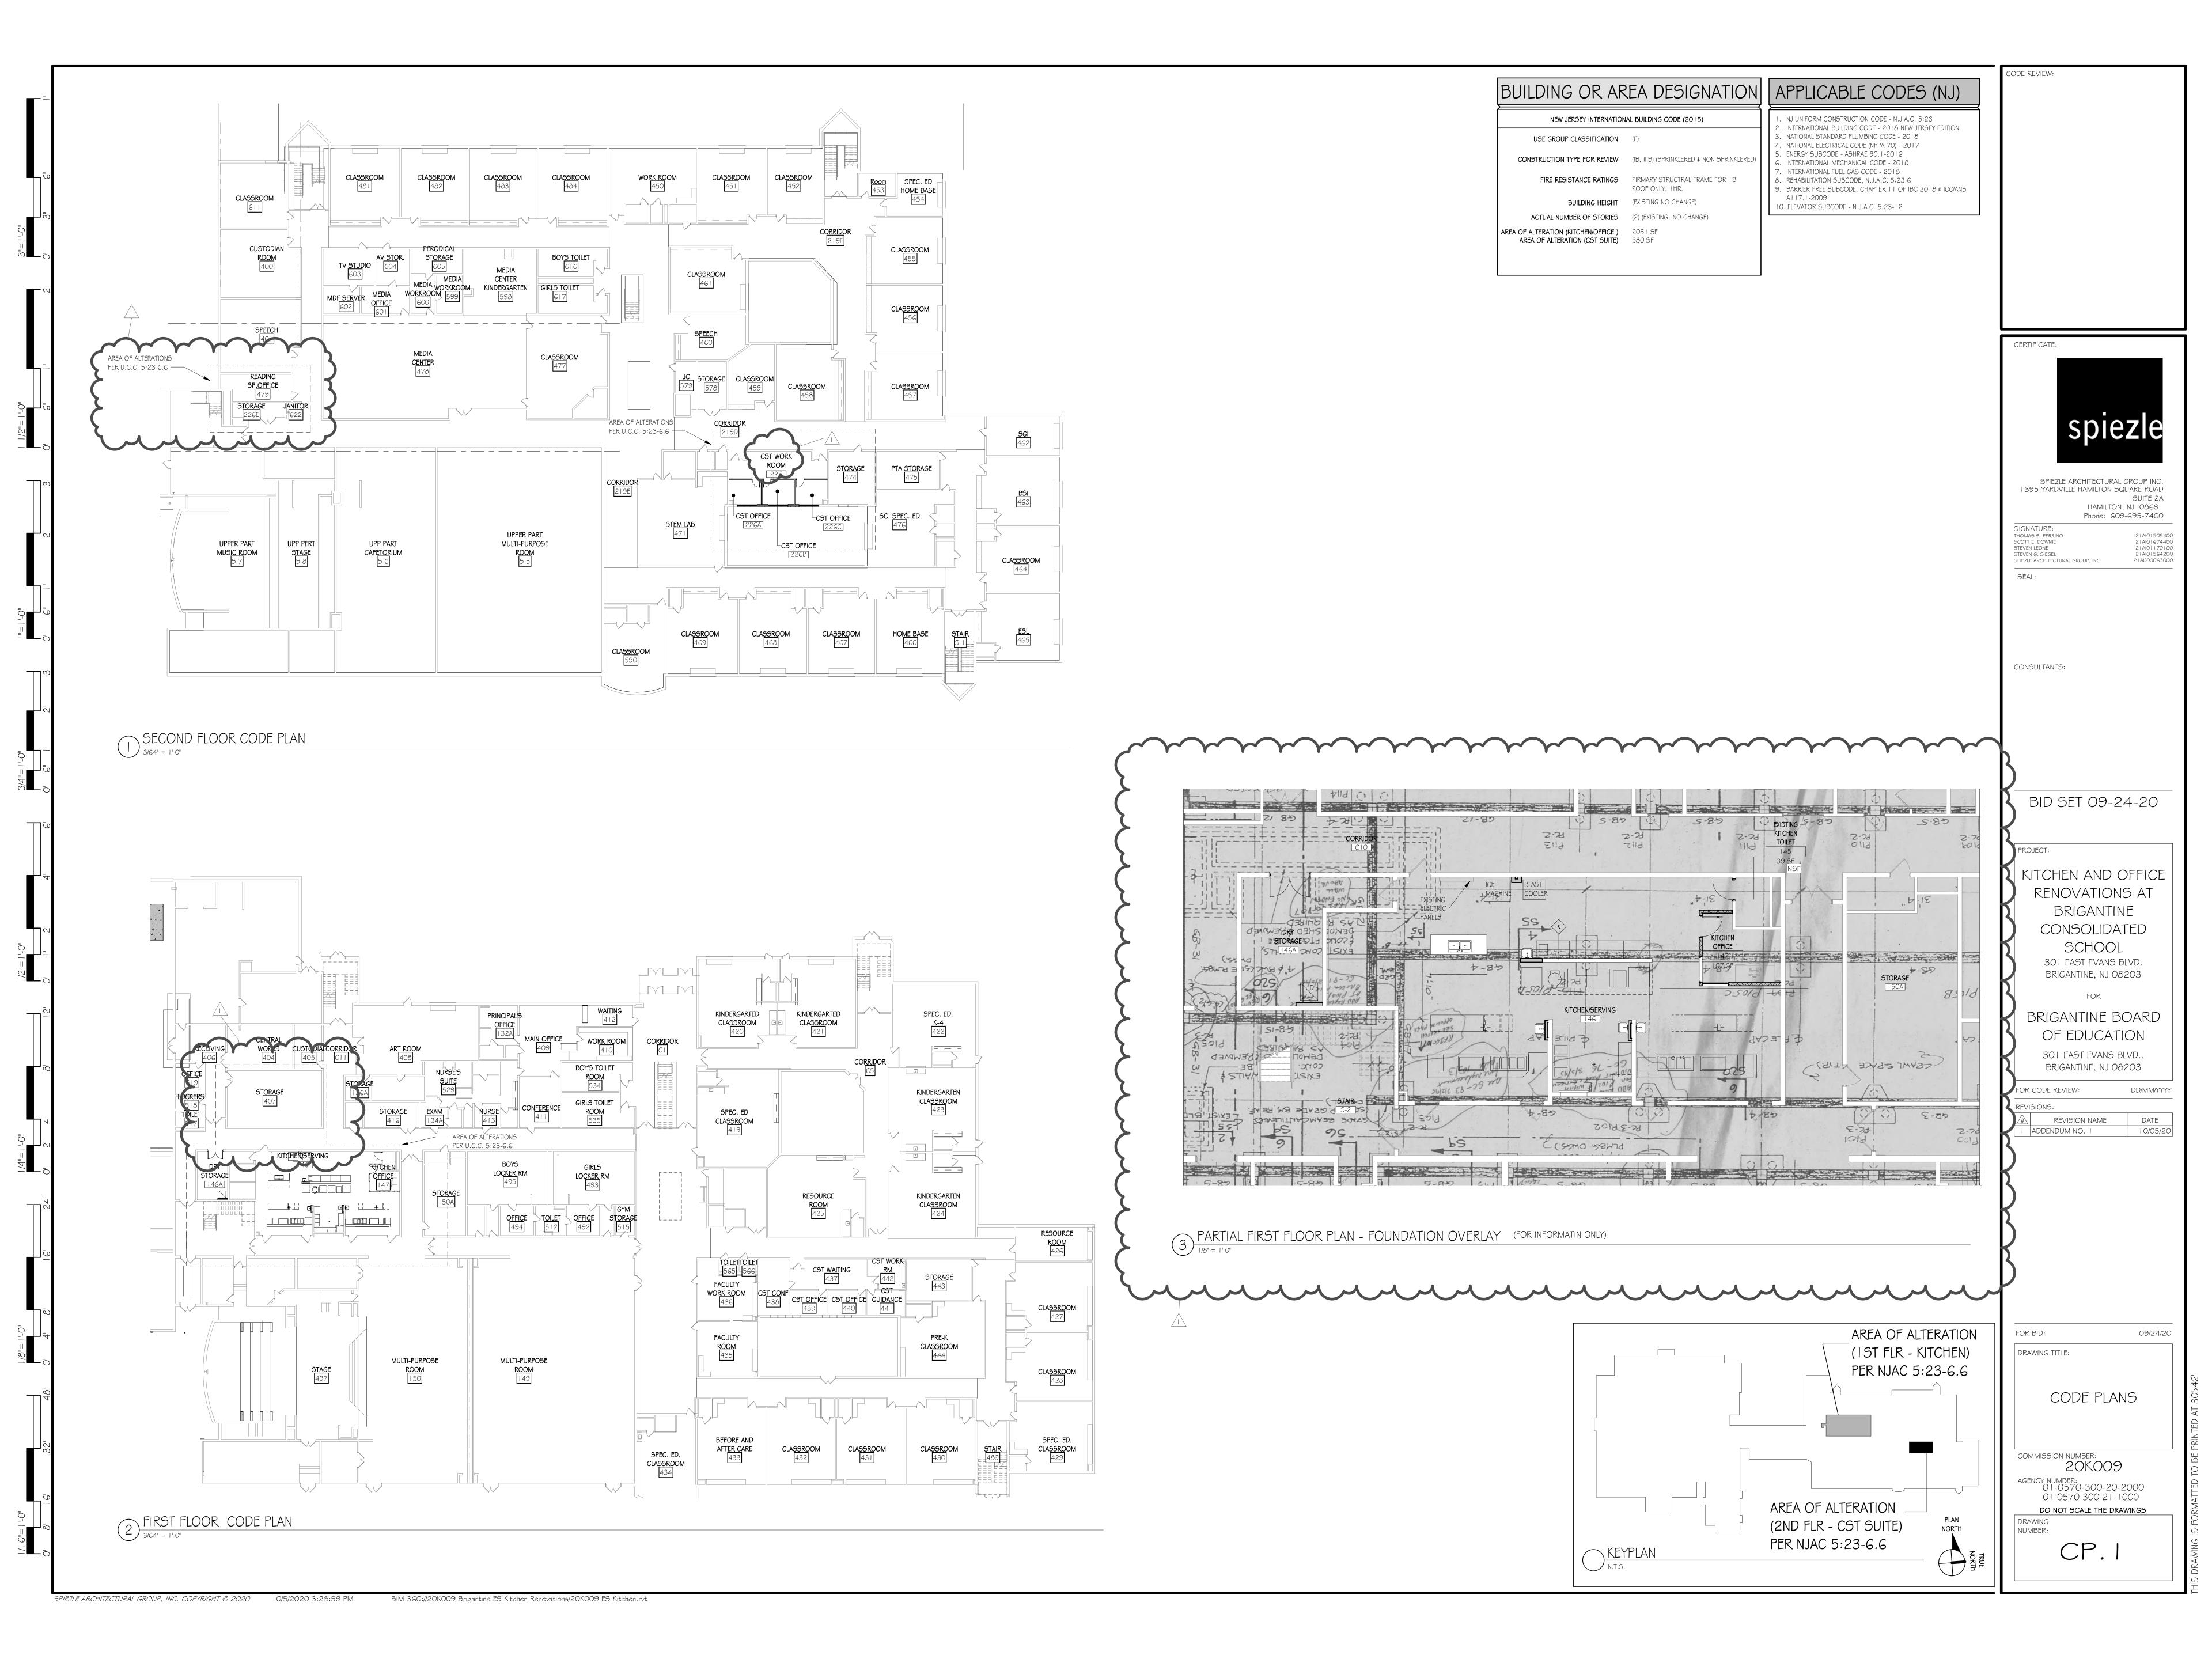
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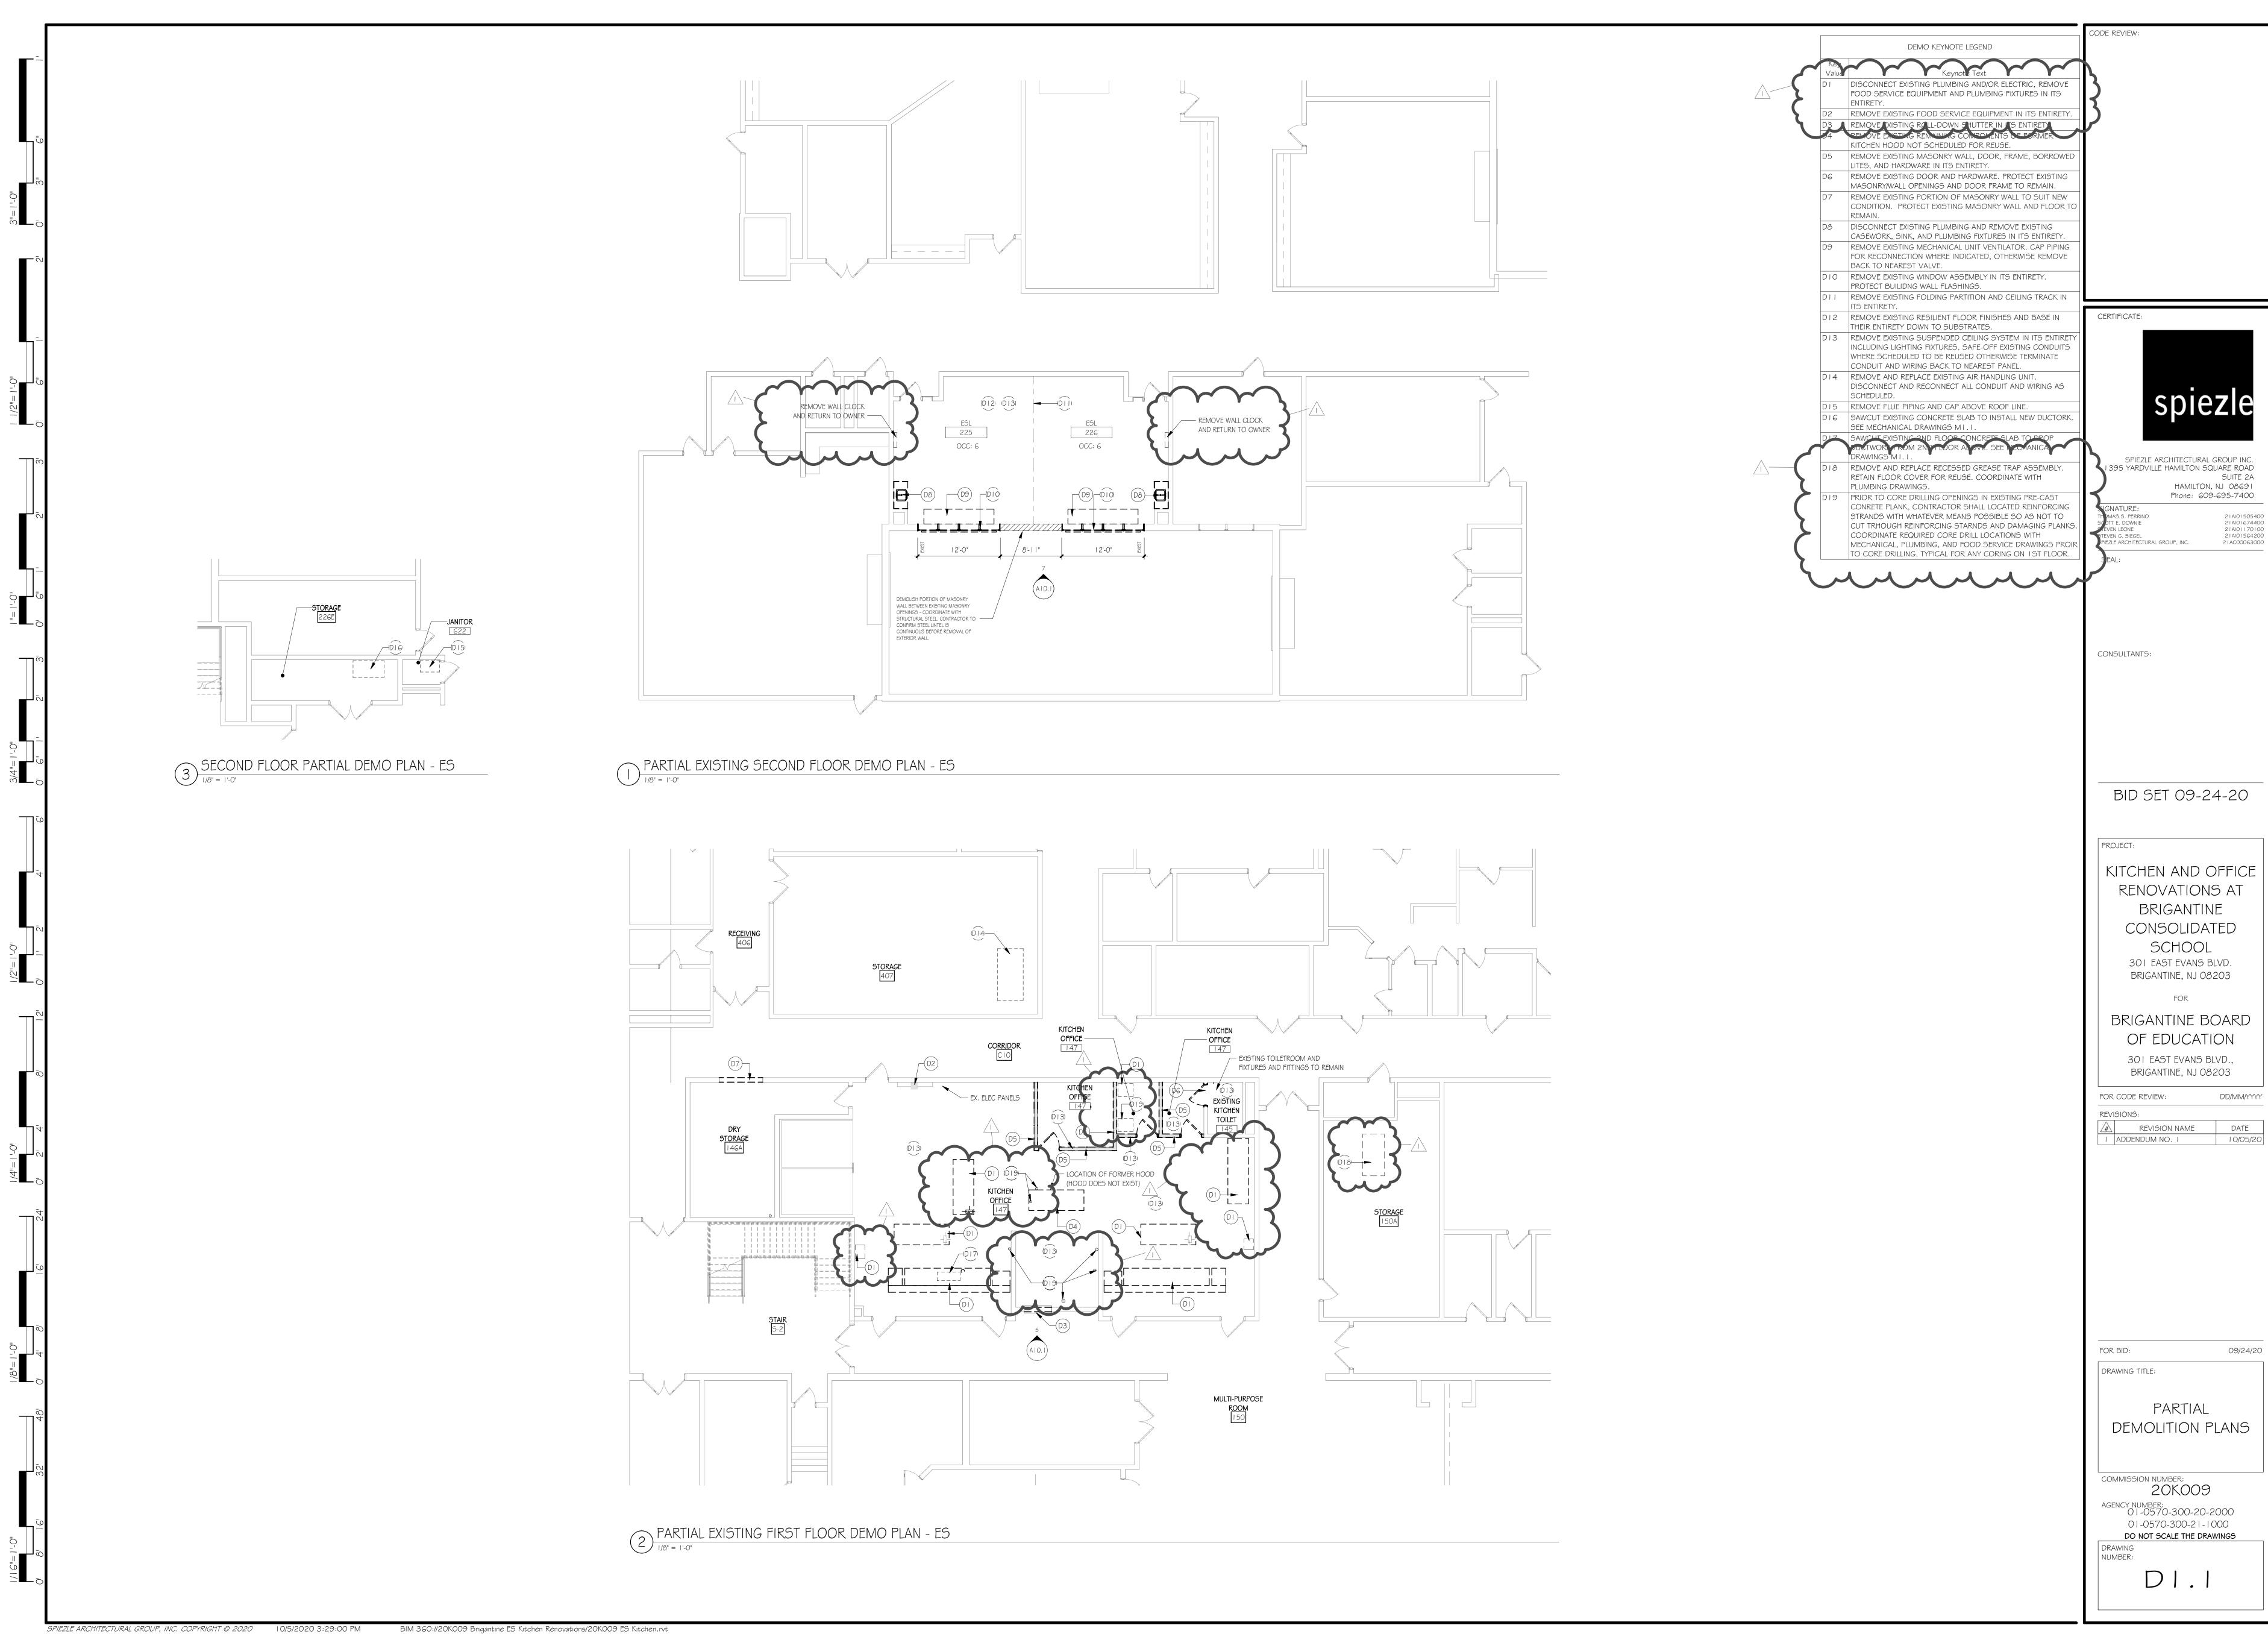
AND LIST OF DRAWINGS

COMMISSION NUMBER: 20K009

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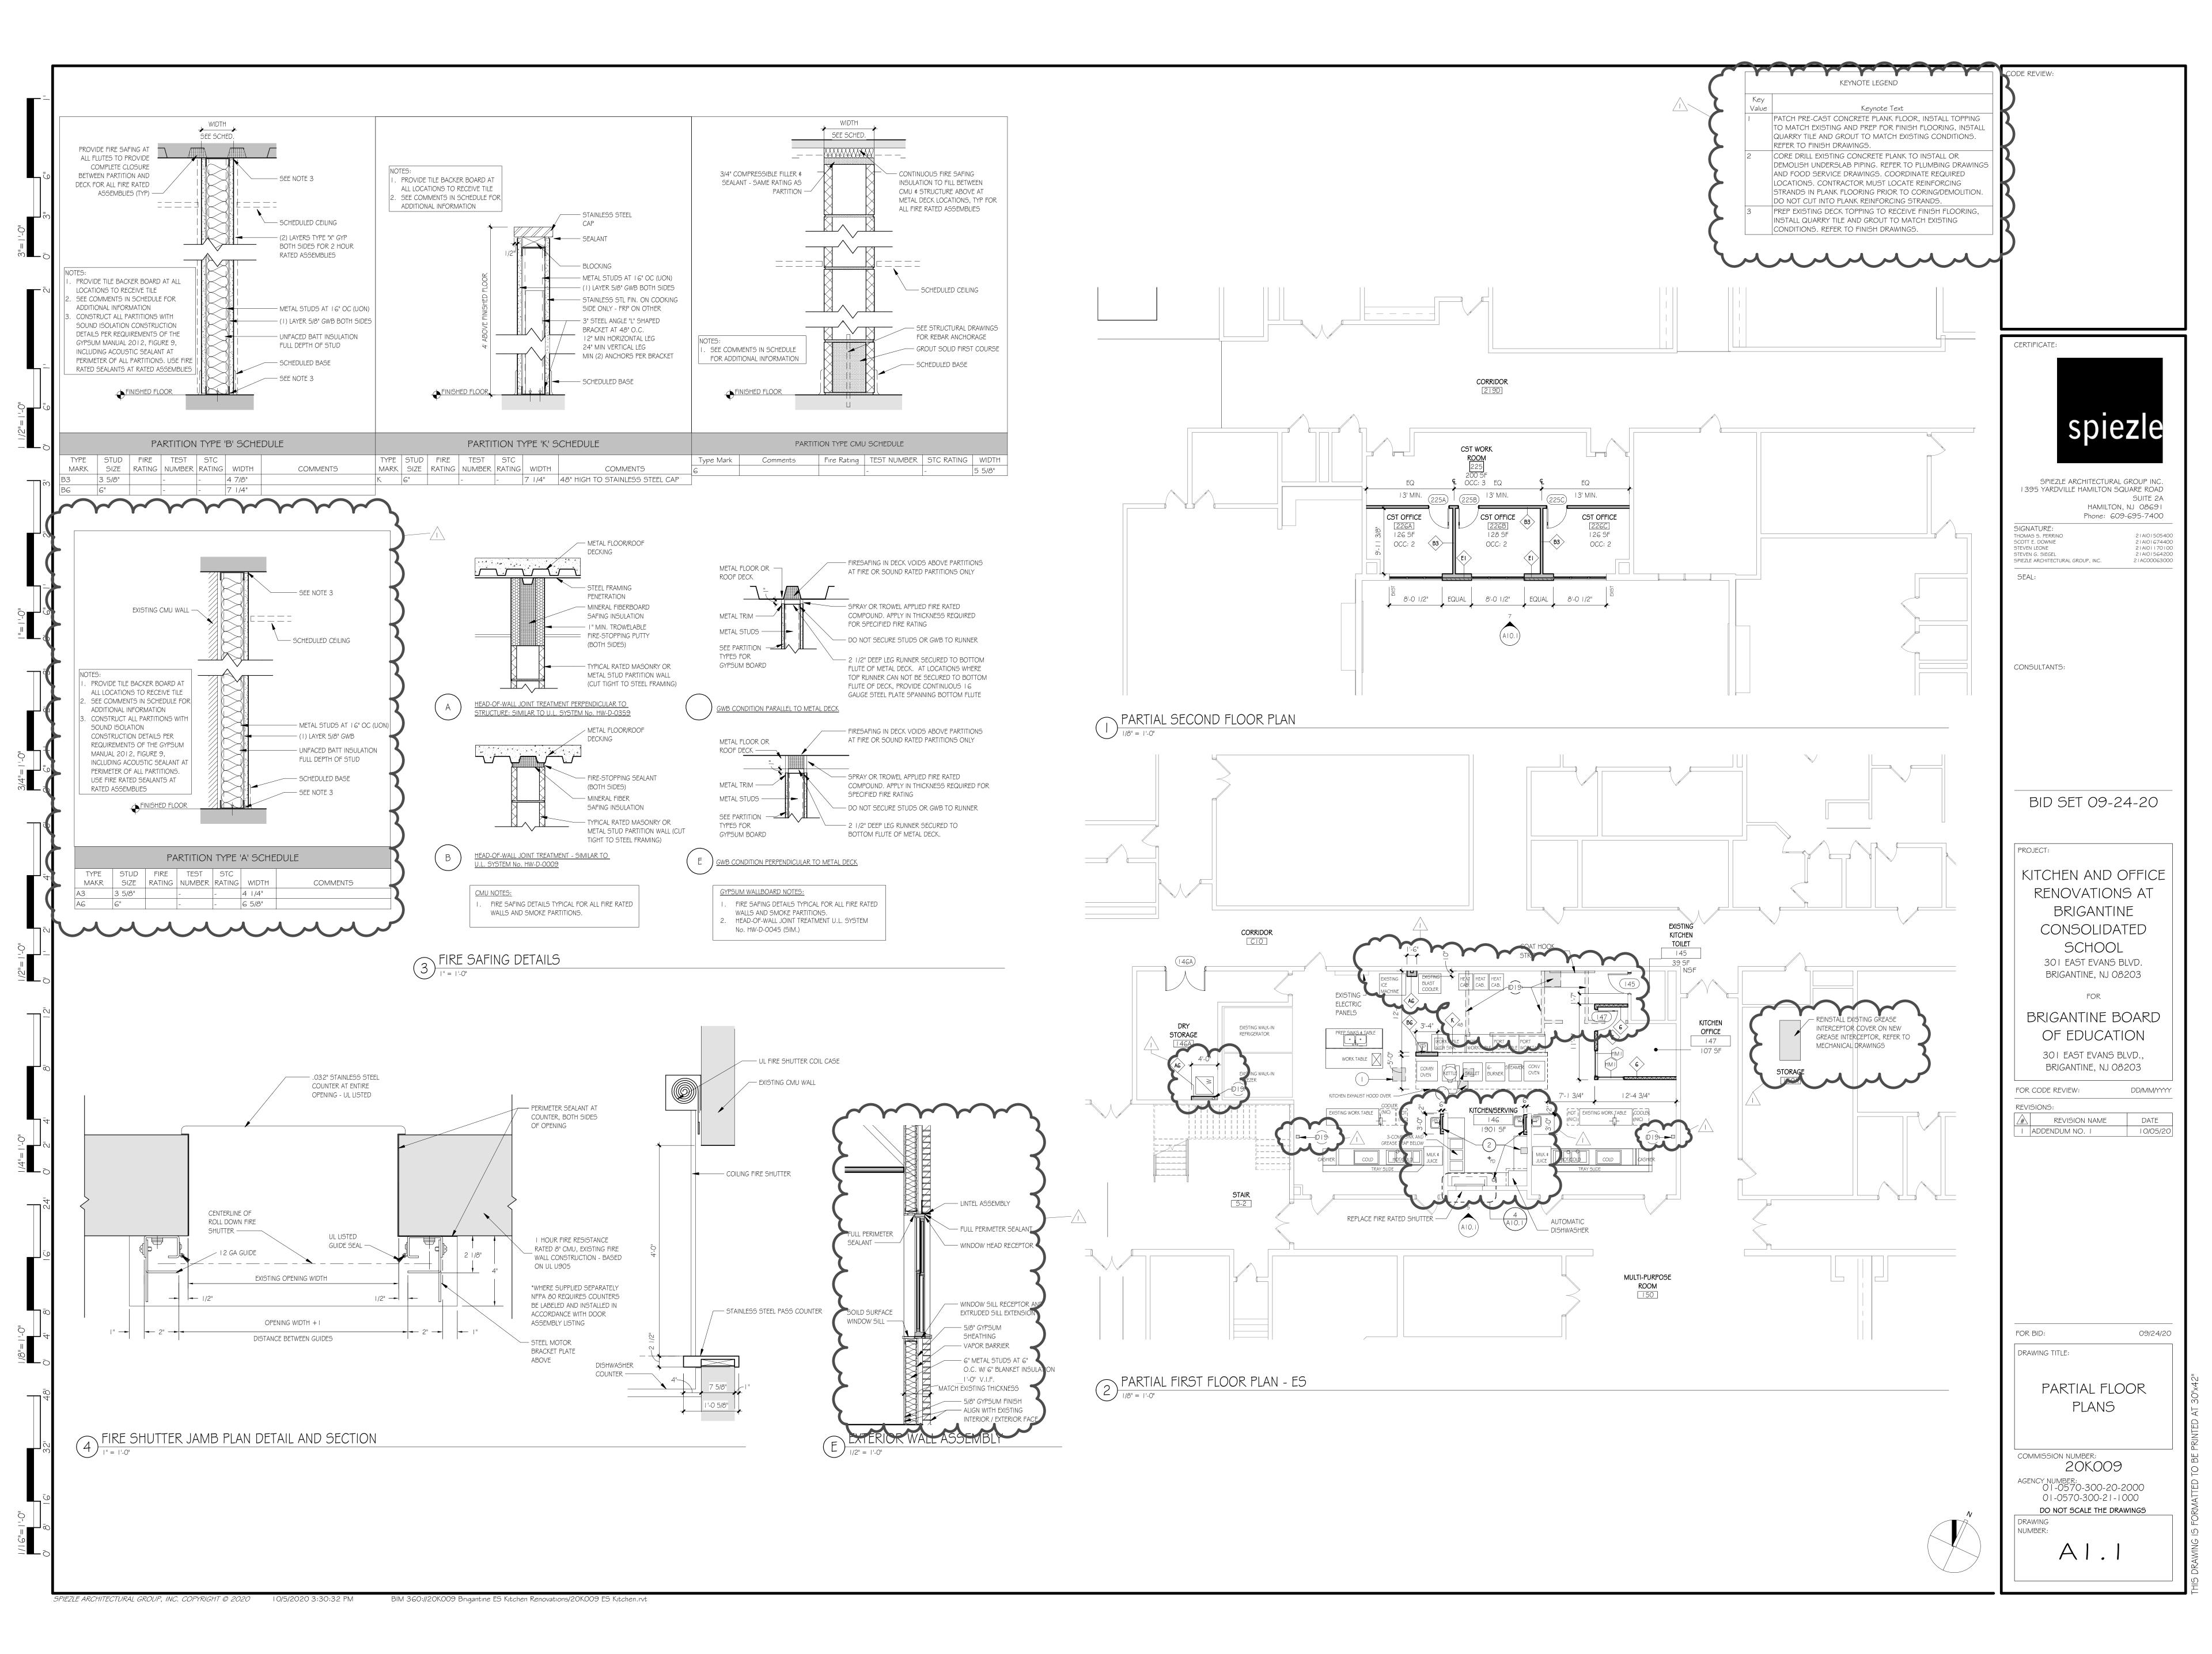
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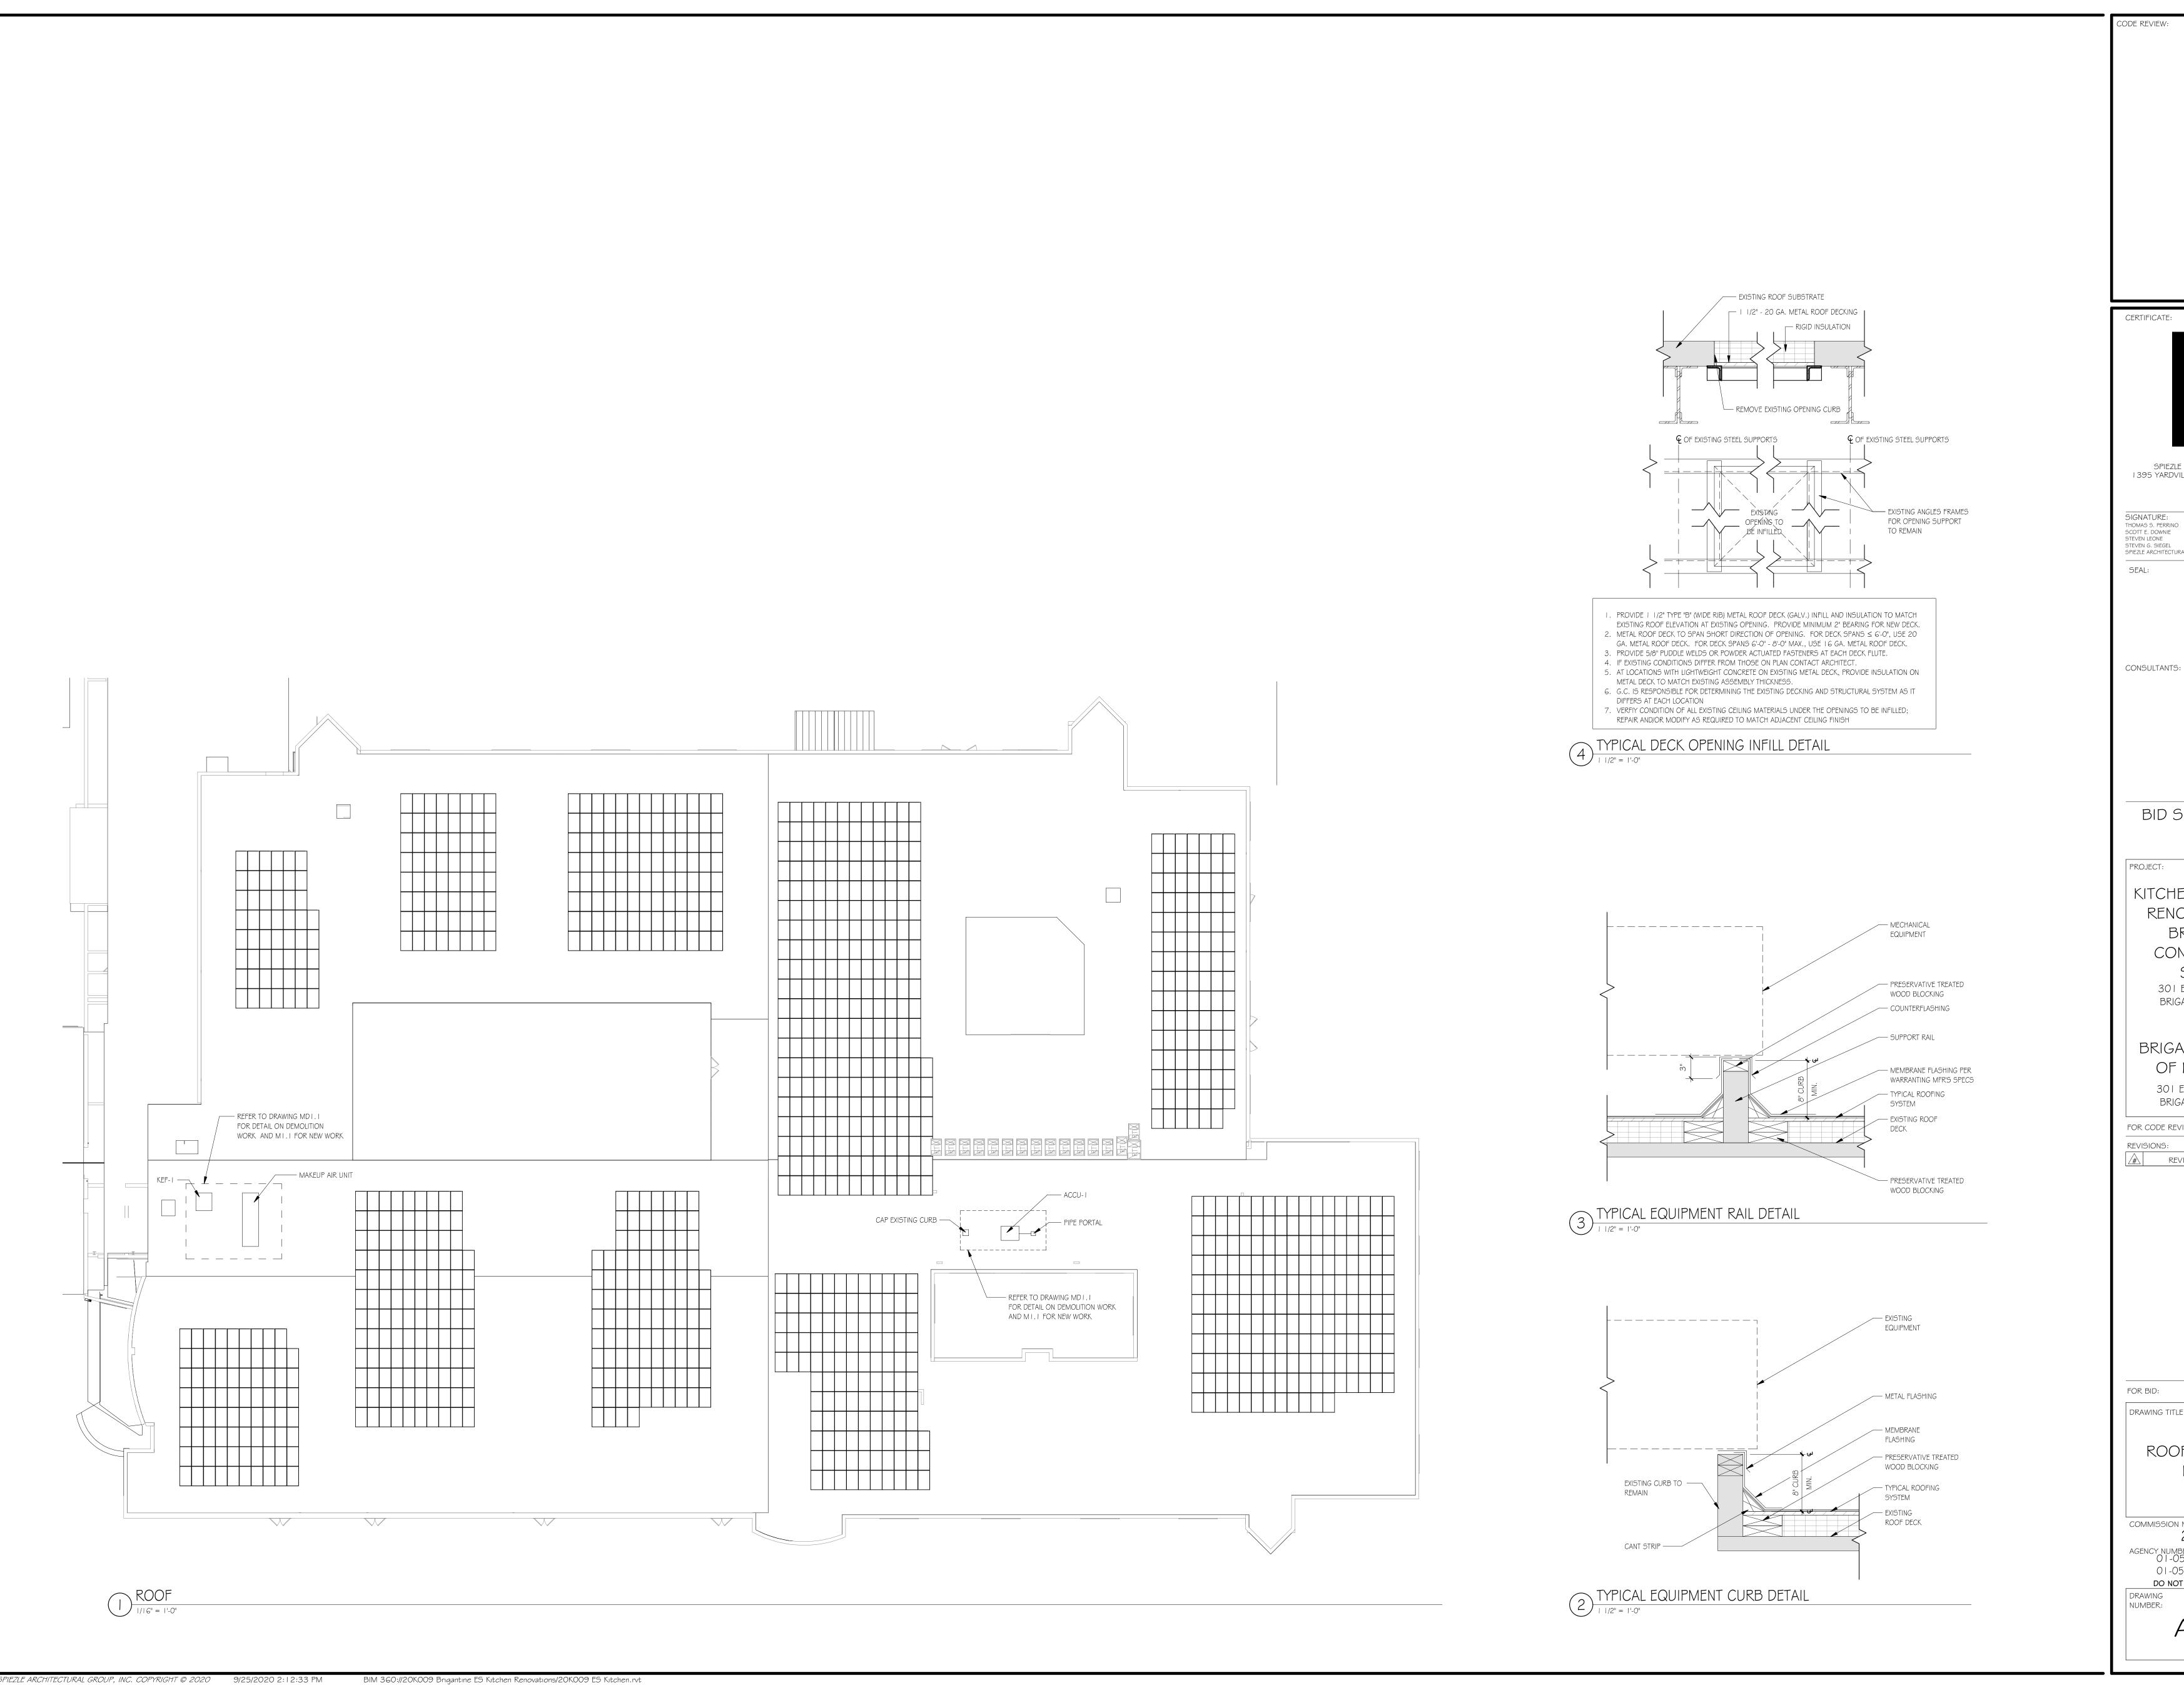




SUITE 2A

10/05/20





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SPIEZLE ARCHITECTURAL GROUP INC. 1395 YARDVILLE HAMILTON SQUARE ROAD

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HAMILTON, NJ 08691 Phone: 609-695-7400 SIGNATURE: THOMAS S. PERRINO 21Al01505400 21Al01674400 21Al01170100 21Al01564200 SCOTT E. DOWNIE
STEVEN LEONE
STEVEN G. SIEGEL
SPIEZLE ARCHITECTURAL GROUP, INC. 21AC00063000

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BRIGANTINE, NJ 08203 BRIGANTINE BOARD

OF EDUCATION 301 EAST EVANS BLVD., BRIGANTINE, NJ 08203

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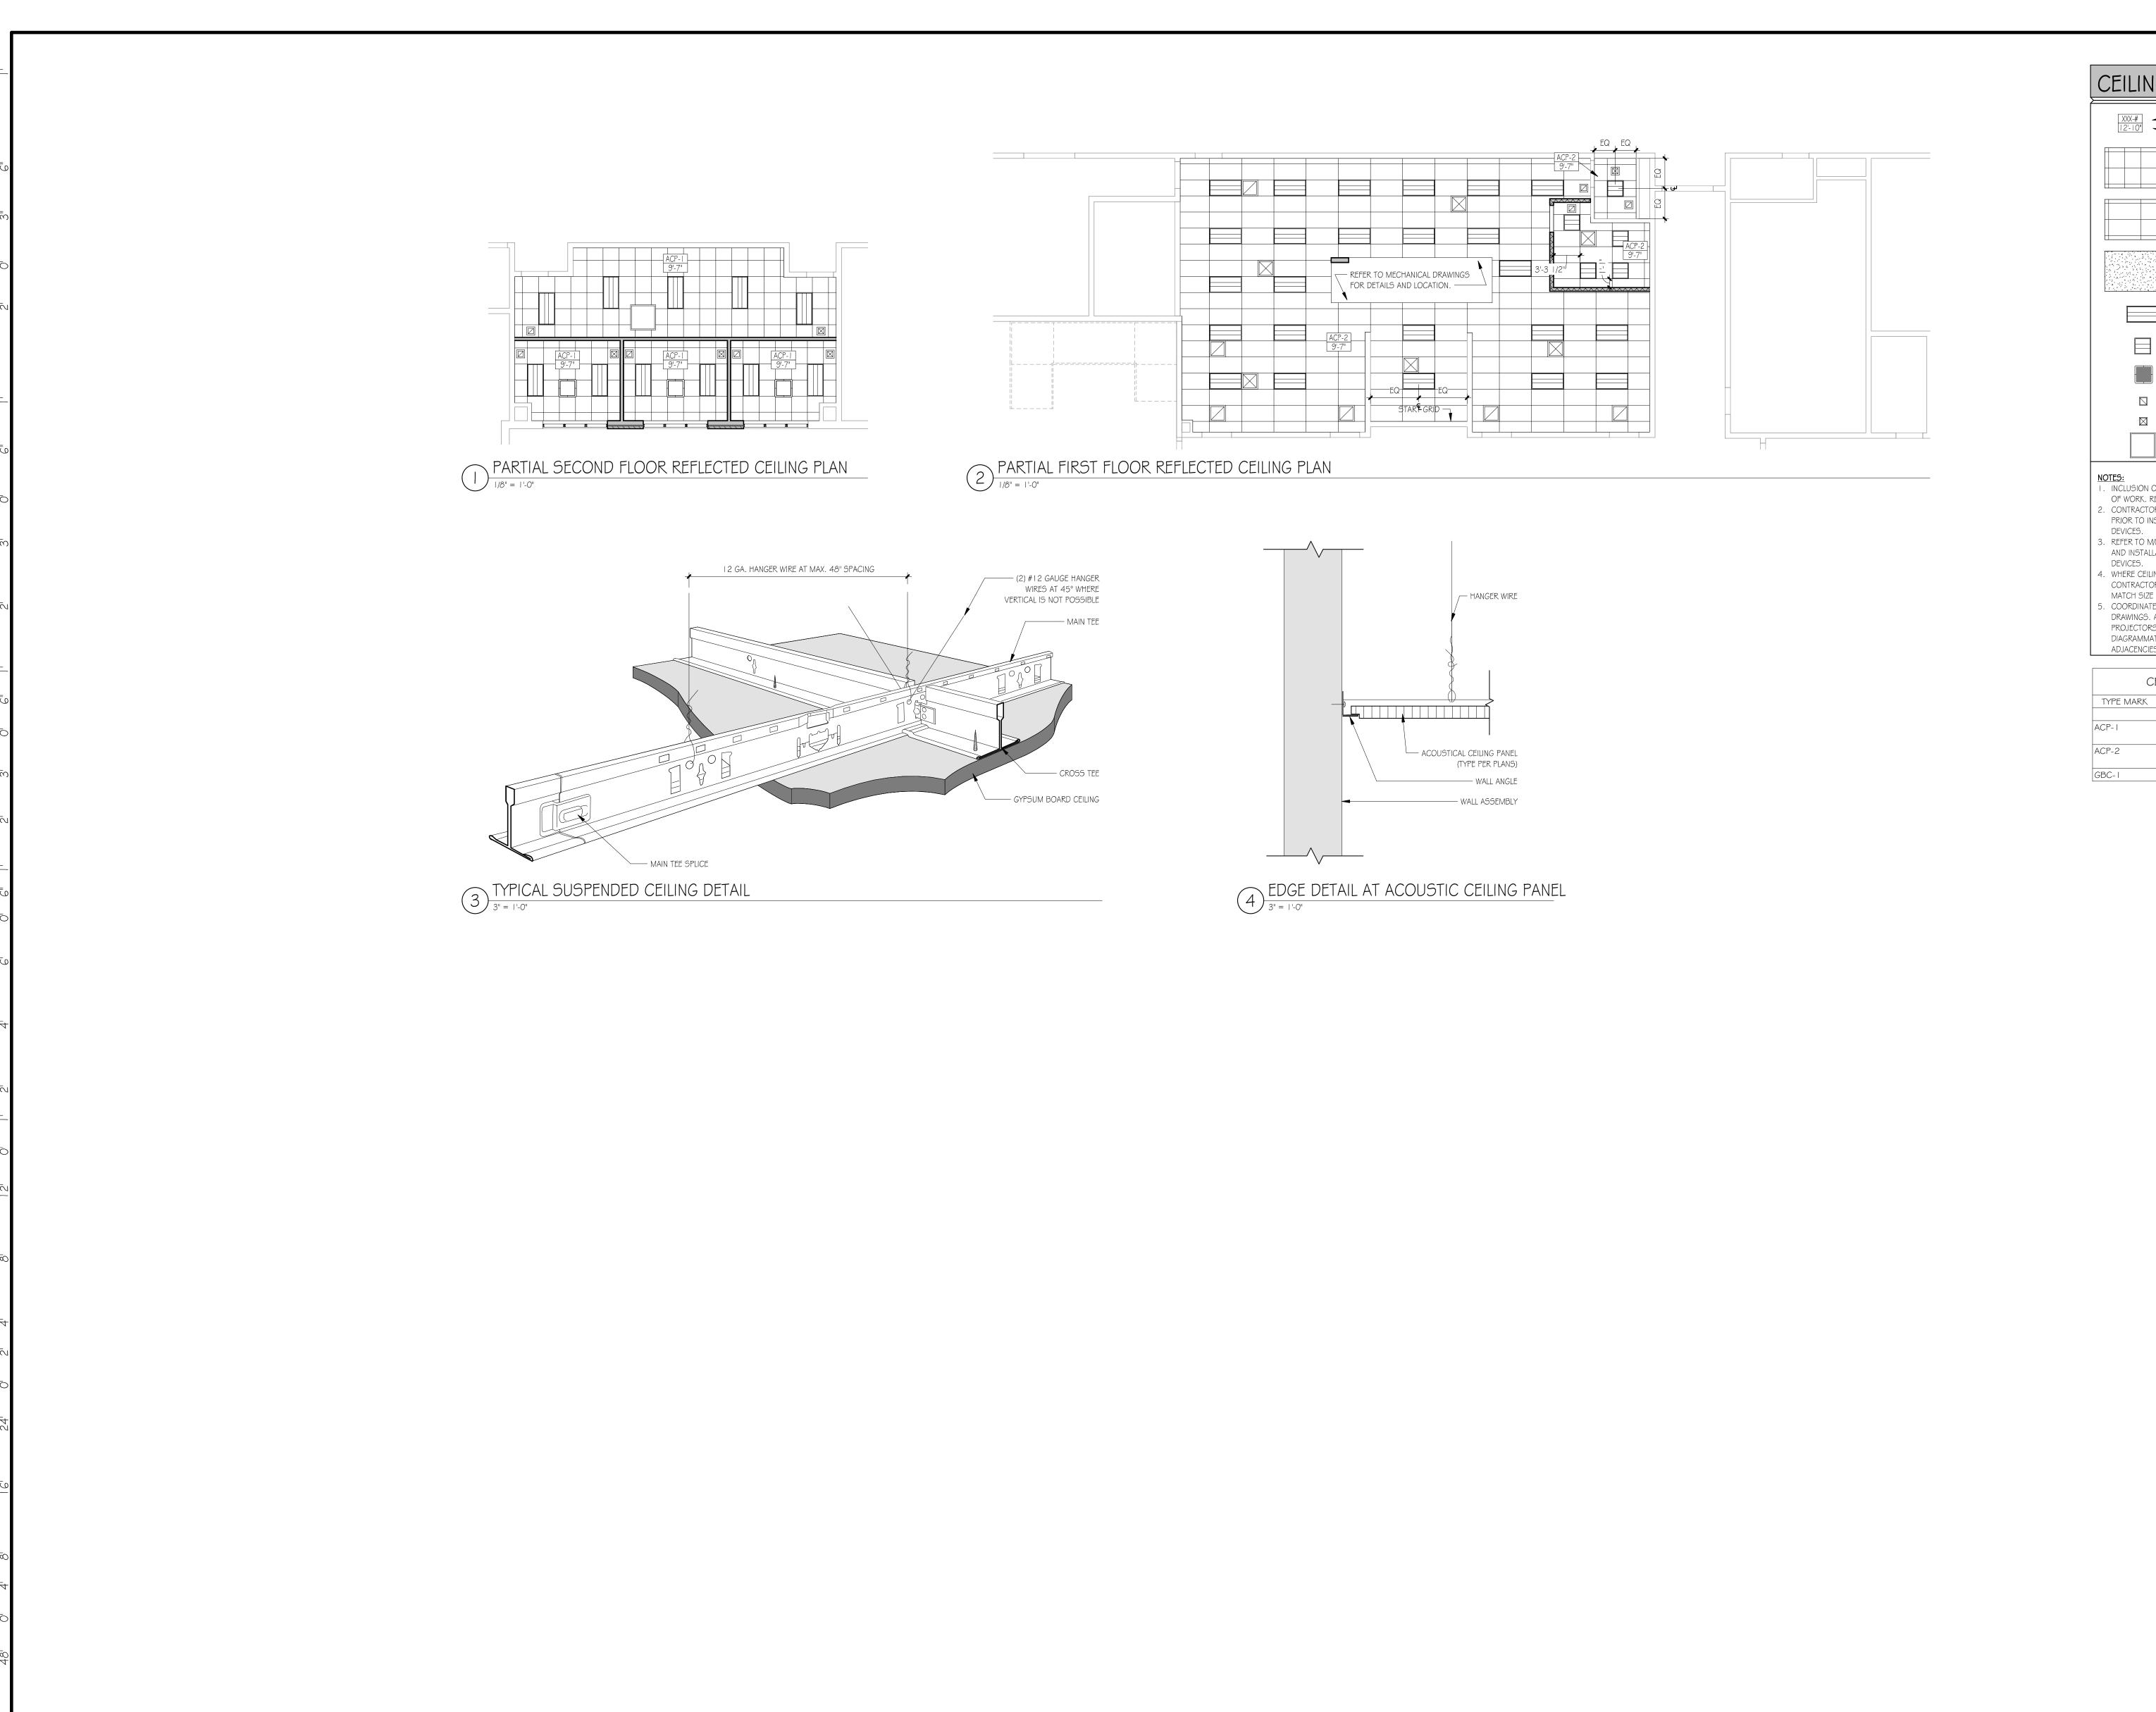
ROOF PLANS AND


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DETAILS

COMMISSION NUMBER: 20K009 AGENCY NUMBER: 01-0570-300-20-2000 01-0570-300-21-1000 DO NOT SCALE THE DRAWINGS

A3.1



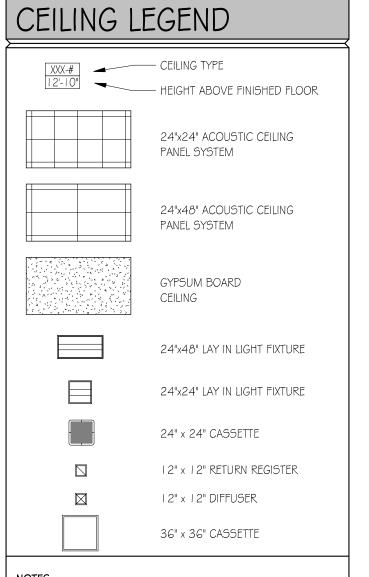

 INCLUSION OF SYMBOL IN LEGEND DOES NOT IMPLY SCOPE
 OF WORK, REFER TO PLANS. 2. CONTRACTORS SHALL COORDINATE WITH ALL OTHER TRADES PRIOR TO INSTALLATION OF FIXTURES AND OTHER CEILING

B. REFER TO M/E/P DRAWINGS FOR SIZES, TYPES, QUANTITIES AND INSTALLATION REQUIREMENTS OF FIXTURES AND CEILING 4. WHERE CEILING HEIGHTS ARE BELOW WINDOW HEADS THE CONTRACTOR SHALL PROVIDE FASCIA MOLDING OR TRIM TO

MATCH SIZE AND COLOR OF CEILING TRIM. . COORDINATE ALL AUDIO AND VISUAL DEVICES WITH AV DRAWINGS. AV EQUIPMENT SHOWN HERE, INCLUDING PROJECTORS AND PROJECTION SCREENS ARE DIAGRAMMATIC AND ARE SHOWN HERE TO DEPICT ADJACENCIES WITH OTHER LIGHTING AND CEILING DEVICES.

Ct	EILING TYPE SCHEDULE
TYPE MARK	DESCRIPTION
ACP- I	ACOUSTIC CEILING PANEL SYSTEM 24"x24"
ACP-2	ACOUSTIC CEILING PANEL CEILING 24"x48"
GBC-1	GYPSUM BOARD CEILING

CODE REVIEW: CERTIFICATE:

SUITE 2A

HAMILTON, NJ 08691

Phone: 609-695-7400 SIGNATURE:
THOMAS S. PERRINO
SCOTT E. DOWNIE
STEVEN LEONE
STEVEN G. SIEGEL
SPIEZLE ARCHITECTURAL GROUP, INC. 2 | A|O | 505400 2 | A|O | 674400 2 | A|O | | 170 | 100 2 | A|O | 564200 21AC00063000

SPIEZLE ARCHITECTURAL GROUP INC. I 395 YARDVILLE HAMILTON SQUARE ROAD

SEAL:

CONSULTANTS:

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KITCHEN AND OFFICE RENOVATIONS AT BRIGANTINE CONSOLIDATED SCHOOL 301 EAST EVANS BLVD.

BRIGANTINE, NJ 08203 BRIGANTINE BOARD

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REFLECTED CEILING PLANS AND DETAILS

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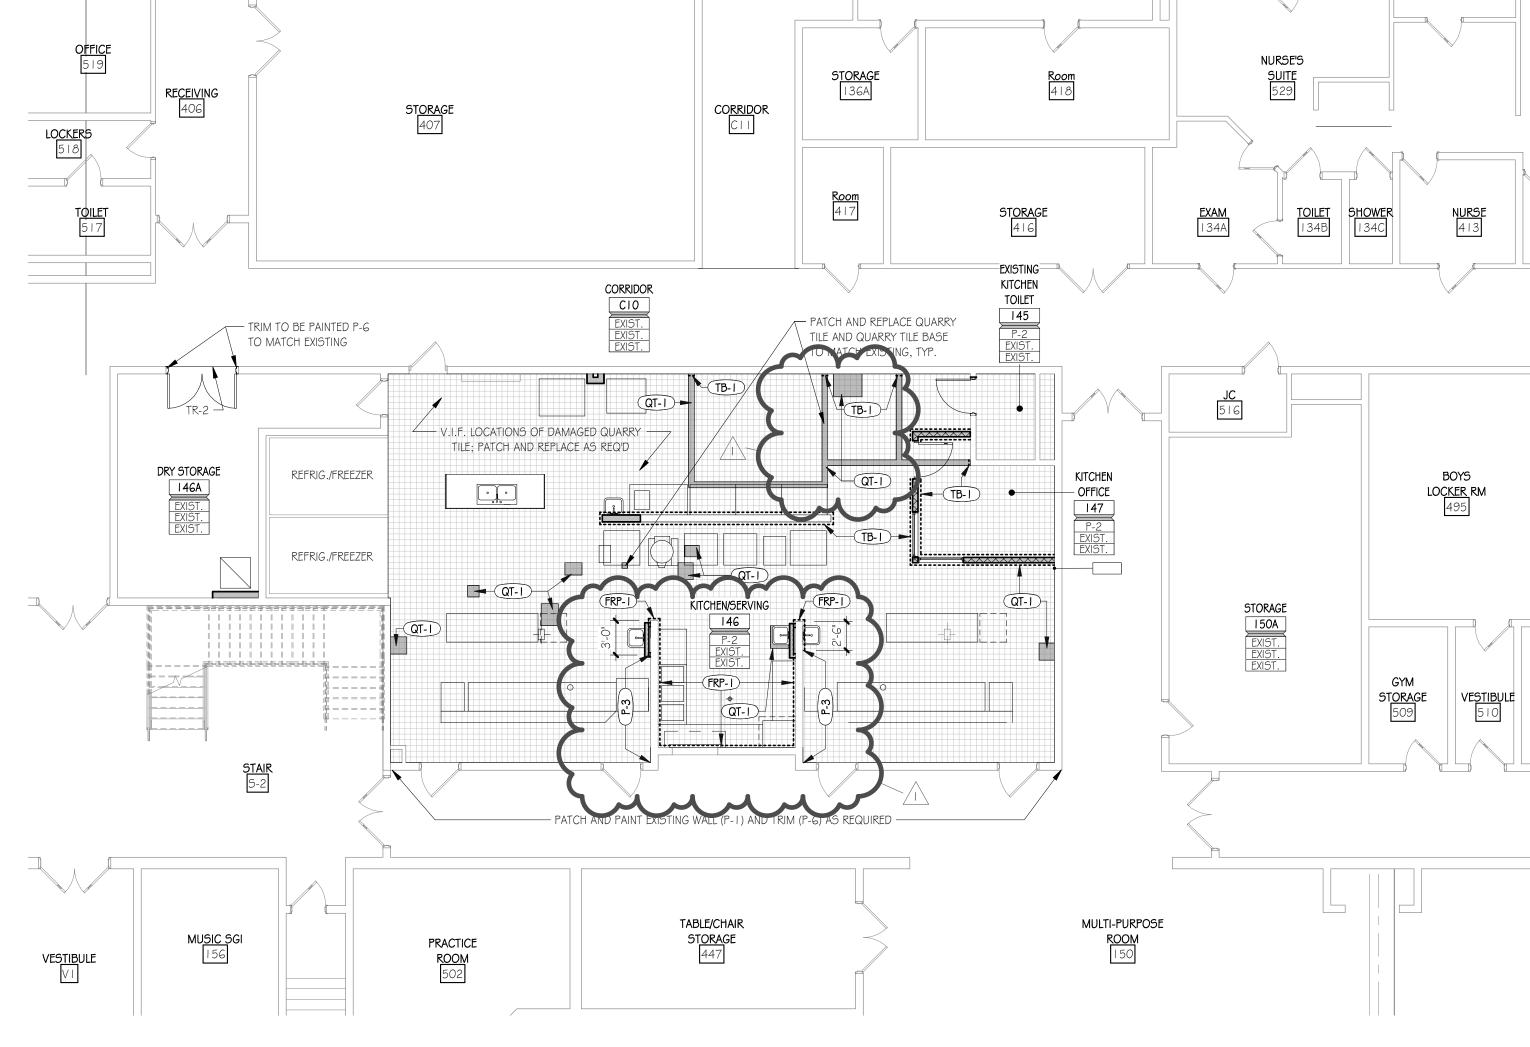
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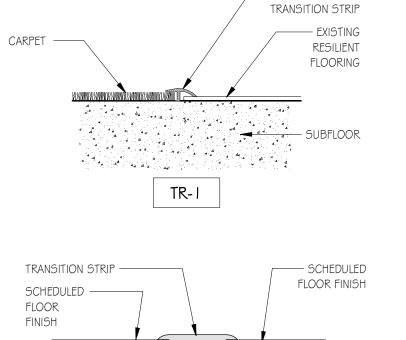




#### INTERIOR FINISH LEGEND DESCRIPTION: TRIM PAINT - MATCH EXISTING FINISH: SEMI-GLOSS RUBBER BASE DESCRIPTION: DESCRIPTION: TRIM PAINT - NEW WORK MANUFACTURER: ROPPE MANUFACTURER: SHERWIN WILLIAMS PINNACLE TRADITIONAL TOE STYLE: COLOR NAME: LOYAL BLUE COLOR: BLACK COLOR NUMBER: SW 6510 RB-I SIZE: 4" X 120' COILS P-7 FINISH: SEMI-GLOSS DESCRIPTION: TILE BASE MANUFACTURER: DALTILE DESCRIPTION: CEILING PAINT COLLECTION: QUARRY TILE MANUFACTURER: SHERWIN WILLIAMS COLOR NAME: CEILING BRIGHT WHITE STYLE: COVE BASE Q-3565 COLOR NUMBER: SW 7007 COLOR: ARID FLASH 0Q48 CP-I FINISH: FLAT SIZE: 5" X 6" CONTACT: RACHAEL FERNBACH **QUARRY TILE** TB-I CONTACT: RACHAEL.FERNBACH@DALTILE.COM DESCRIPTION: QUARRY TILE MANUFACTURER: DALTILE MANUFACTURER: SHAW CONTRACT STYLE: QUARRY COLLECTION: CAMPUS COLOR: ARID FLASH 0Q48 STYLE: COMMONS TILE 5T323 DIMENSION: 6" X 6" COLOR: INK 23486 FINISH: MATTE DIMENSIONS: 24 X 24 THICKNESS: QUARTER TURNED INSTALLATION: CONTACT: RACHAEL FERNBACH CONTACT: VICKY MCCONAGHY QT-I CONTACT: RACHAEL.FERNBACH@DALTILE.COM CPT-1 | CONTACT: VICKY.MCCONAGHY@SHAWINC.COM SOLID SURFACE DESCRIPTION: WINDOW STOOLS @ OFFICES DESCRIPTION: WALL PAINT - MATCH EXISTING MANUFACTURER: CORIAN MATCH EXISTING FINISH: COLOR NAME: TBD - PRICE GROUP C SS-I COLOR NUMBER: TBD DESCRIPTION: WALL PAINT - KITCHEN MANUFACTURER: BENJAMIN MOORE WALL PANELS COLOR NAME: ANTIQUE WHITE DESCRIPTION: FIBERGLASS REINFORCED PANELS COLOR NUMBER: BM 909 MANUFACTURER: MARLITE P-2 FINISH: SEMI-GLOSS STANDARD FRP STYLE: DESCRIPTION: ACCENT PAINT - KITCHEN COLOR: S100 WHITE MANUFACTURER: SHERWIN WILLIAMS FINISH: SMOOTH SURFACE COLOR NAME: LOYAL BLUE SIZE: 4' X 8' X 3/32" COLOR NUMBER: SW 6510 FRP-1 TRIM: P-3 FINISH: SEMI-GLOSS WINDOW TREATMENT DESCRIPTION: WALL PAINT - OFFICES MANUFACTURER: DRAPER MANUFACTURER: BENJAMIN MOORE STYLE: SHEERWEAVE SERIES COLOR NAME: ANTIQUE WHITE PW4400 BY PHIFER COLOR NUMBER: BM 909 WIN-1 COLOR: P-4 FINISH: EGGSHELL

----- CARPET-TO-

RESILIENT RUBBER



ACCENT PAINT - OFFICES

MANUFACTURER: BENJAMIN MOORE

COLOR NUMBER: BM 1474

P-5 FINISH:

COLOR NAME: CAPE MAY COBBLESTONE

TR-2 FLOORING TRANSITION DETAILS

## GENERAL FINISH NOTES:

7		
	CPT-I)	FINISH TAG
	P-I WT-2	FINISH SEPARATION TAG
_	••••••	INDICATES EXTENT OF INDICATED FINISH
		SPAN DIRECTION OF SHEET OR BROAD LOOM PRODUCTS
		ROOM FINISH TAG
	ROOM NAME -	ROOM NAME
	A1000	ROOM NUMBER
	WF BF FF	—— TYPICAL WALL FINISH —— BASE FINISH —— FLOOR FINISH

NOTES PERTAIN TO AREAS WITHIN THIS SCOPE OF WORK ONLY. CONTACT INTERIOR DESIGNER/ARCHITECT FOR CLARIFICATION IN THE EVENT OF CONTRADICTORY INFORMATION BETWEEN DRAWINGS, LEGEND AND/ OR

REFER TO FINISH LEGEND AND PLAN FOR GENERAL FINISHES.

- REFER TO ALL INTERIOR FINISH NOTES AND INTERIOR DRAWINGS (INCLUDING PLANS, ELEVATIONS AND DETAILS) FOR COMPLETE INTERIORS INFORMATION. THE CONTRACTOR IS RESPONSIBLE FOR VERIFYING PRODUCT LEAD TIMES
- THE CONTRACTOR IS RESPONSIBLE TO FIELD VERIFY ALL SITE CONDITIONS AND CONFIRM QUANTITIES PRIOR TO ORDERING PRODUCTS. IN THE EVENT OF CONTRADICTORY INFORMATION CONTACT THE INTERIOR DESIGNER/ARCHITECT FOR CLARIFICATION PRIOR TO ORDERING.
- RECOMMENDED INSTALLATION METHODS AND ADHESIVES.
- WARRANTY INFORMATION AND INSTRUCTIONS OF MAINTENANCE ON ALL FINISH MATERIALS SHALL BE PROVIDED TO THE OWNER AND INCLUDED IN THE CLOSEOUT WARRANTY AND MAINTENANCE MANUAL.

. THE CONTRACTOR IS RESPONSIBLE FOR SUBMITTING SAMPLES OF ALL FINISHES SPECIFIED TO INTERIOR DESIGNER/ARCHITECT FOR APPROVAL PRIOR TO ORDERING MATERIAL.

O. ALL SUBSTRATE SURFACES ARE TO BE PROPERLY PREPARED TO RECEIVE FINISH MATERIALS. SUBCONTRACTOR IS NOT TO APPLY FINISHES UNTIL SUBSTRATE IS PREPARED PER MANUFACTURES WRITTEN INSTRUCTIONS FOR

TO MATCH THE SURFACE ON WHICH THEY OCCUR IF THE ITEM IS ON A WALL-COVERED WALL. PROVIDE A CUSTOM PAINT COLOR USED TO MATCH. SUBMIT TO INTERIOR DESIGNER/ARCHITECT FOR APPROVAL.

2. ALL DIRECTIONAL LAMINATES SHOULD RUN WITH THE VERTICAL GRAIN PATTERN UON.

14. ALL METAL AND PAINTED TRIM TO BE SEMI-GLOSS ENAMEL FINISH UON.

I 6. FINISHES INDICATED ON "ROOM FINISH TAG" ARE INCLUSIVE OF ALL RESPECTIVE SURFACES IN ROOM (UNLESS OTHERWISE NOTED) WHETHER OR

FLOOR FINISH NOTES:

- . INSTALL DIRECTIONAL FLOORING ORIENTED AS SPECIFIED IN THE FINISH
- REFERENCE MANUFACTURERS INSTALLATION SPECIFICATIONS FOR EACH FLOOR FINISH TYPE TO VERIFY REQUIREMENTS.
- DOORWAY UON.
- ADHERE TO THE AMERICANS WITH DISABILITIES ACT.

CEILING NOTES:

. ALL NEW GWB CEILINGS/SOFFITS TO BE PAINTED CP-1 UNLESS OTHERWISE

SPECIFICATIONS OR IF COLOR AND/OR FINISH IS NOT SPECIFIED.

- TO ENSURE DELIVERY THAT MEETS THE PROJECT SCHEDULE.
- ALL MATERIALS SHALL BE INSTALLED USING MANUFACTURERS

ALL INSTALLATIONS OR APPLICATIONS.

. PAINT GRILLES, WALL DIFFUSERS, ELECTRICAL PANELS, WALL MOUNTED

BOXES, ACCESS PANELS, ETC., WHICH ARE EXPOSED IN FINISHED SPACES

3. ALL WALL PAINT TO BE EGGSHELL FINISH UON.

15. ALL VINYL/RUBBER BASE TO BE ROLLED GOODS, NOT LINEAR 4' LENGTHS,

NOT INDICATED ON PLANS OR ELEVATIONS.

PROVIDE SHOP DRAWING LAYOUT SHOWING ALL FLOOR PATTERN LOCATIONS, GRAIN DIRECTION AND SEAMING DIAGRAMS.

- ALIGN TRANSITION OF FLOOR MATERIAL WITH CENTER OF HINGE IN
- 5. IN A WALL OPENING WITHOUT HINGES REFER TO FINISH PLANS FOR TRANSITION LOCATION OF WRAPPED MATERIALS.
- . FLASH PATCH THE FLOOR AT TRANSITION OF ALL MATERIALS, PROVIDE TRANSITION STRIPS AS NECESSARY. SUBMIT TRANSITIONS TO INTERIOR DESIGNER/ARCHITECT FOR APPROVAL. ALL FLOORING TRANSITIONS MUST

CERTIFICATE:

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SPIEZLE ARCHITECTURAL GROUP INC 1395 YARDVILLE HAMILTON SQUARE ROAD SUITE 2A HAMILTON, NJ 08691 Phone: 609-695-7400

THOMAS S. PERRINO SCOTT E. DOWNIE 21AI0150540 21Al01674400 21Al01170100 21Al01564200 STEVEN LEONE STEVEN G. SIEGEL SPIEZLE ARCHITECTURAL GROUP, INC. 21AC00063000 SEAL:

CONSULTANTS:

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BRIGANTINE BOARD OF EDUCATION

FOR

301 EAST EVANS BLVD., BRIGANTINE, NJ 08203 DD/MM/YYYY FOR CODE REVIEW:

REVISION NAME DATE 10/05/20 I ADDENDUM NO. I

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**REVISIONS:** 

FINISH PLANS AND INTERIOR DETAILS

09/24/20

COMMISSION NUMBER: 20K009 AGENCY NUMBER: 01-0570-300-20-2000


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PARTIAL FIRST FLOOR FINISH PLAN - ES

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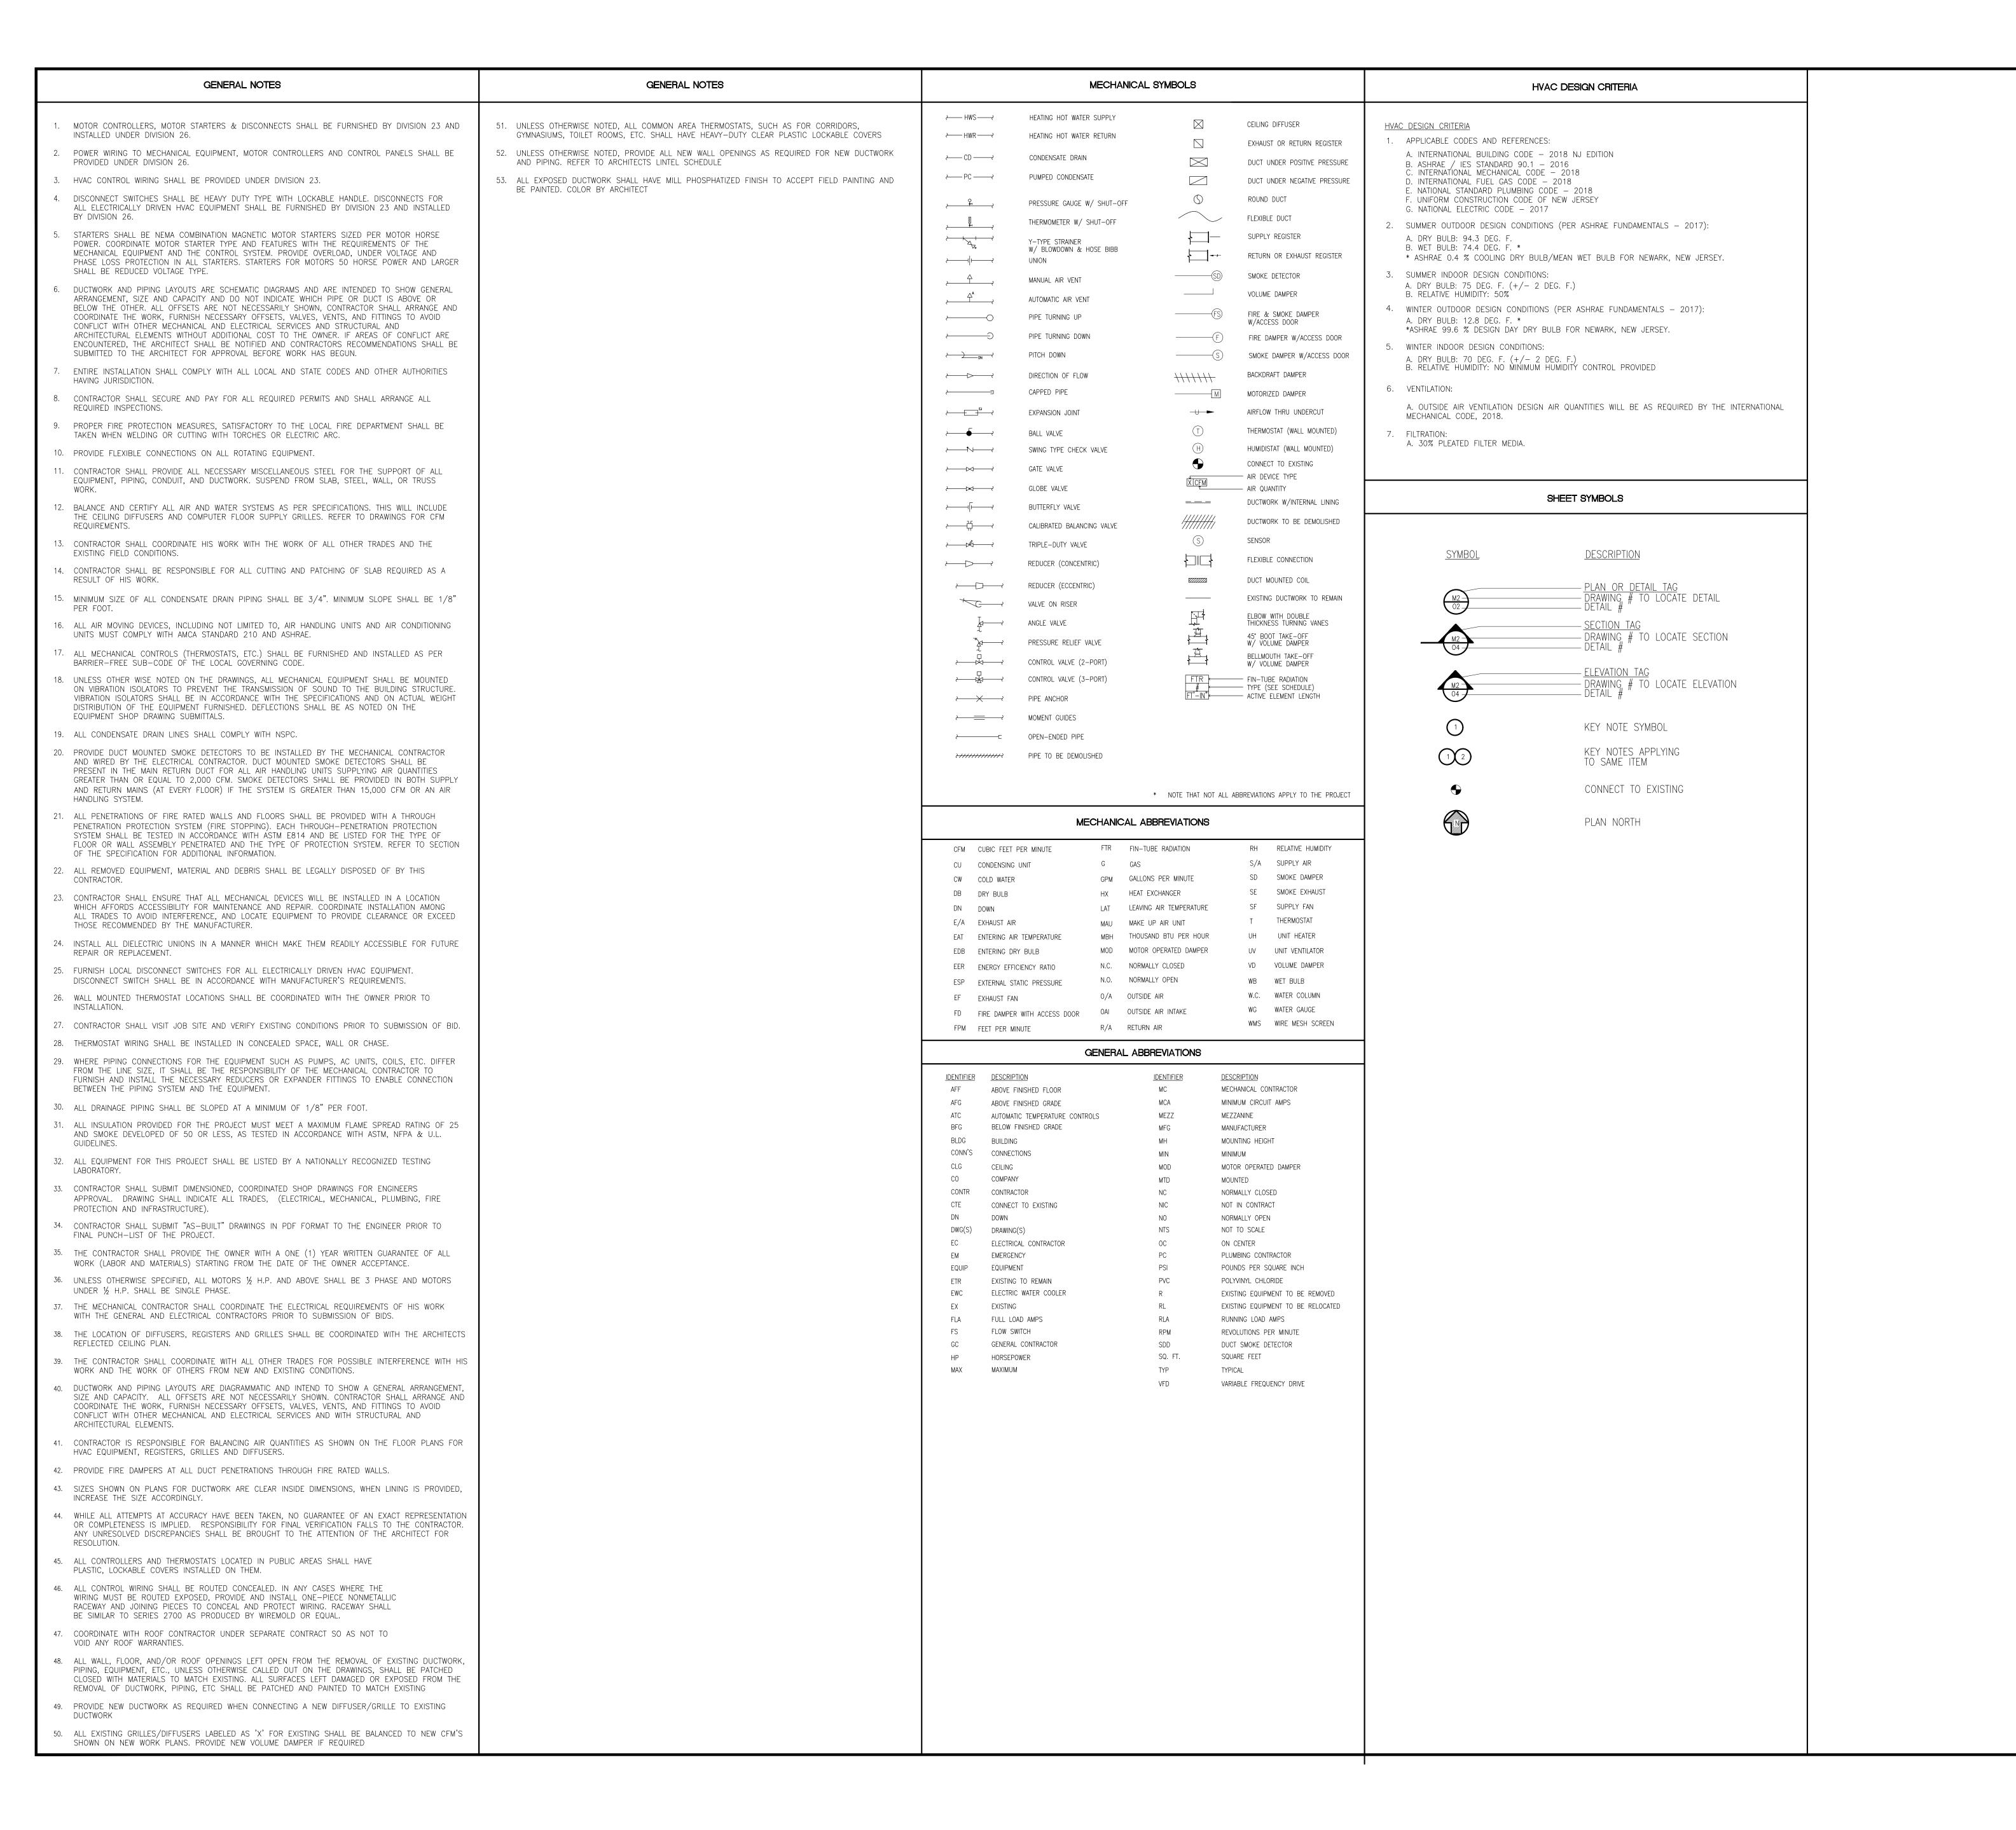
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AND DETAILS

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SPIEZLE ARCHITECTURAL GROUP, INC. SEAL:

CONSULTANTS: KSI CONSULTING ENGINEERS, LLC P.O. BOX 628 FARMINGDALE, NJ 07727 PHONE: 732,938,2666 CERTIFICATE OF AUTHORIZATION NO. 24GA28124300 PAUL RIPISH, N.J.P.E. LICENSE NUMBER 4515800 ALL DRAWINGS AND WRITTEN MATERIALS APPEARING HEREIN CONSTITU ORIGINAL AND UNPUBLISHED WORK OF THE ENGINEER, THE REPRODUCTION O THIS DRAWING FOR THE PURPOSE OF COPYING THIS WORK OR REVISING SADDRAWING SHALL BE CONSIDERED A VIOLATION OF BOTH THE PROFESSION DRAWING SHALL BE CONSIDERED A VIOLATION OF BOTH THE PROFESSIONAL CODE OF ETHICS AND A THEFT OF COMPANY ASSETS, BOTH OF WHICH SHALL BI PROSECUTED TO THE FULLEST EXTENT OF CURRENT STATUTES.

KSI PROJECT #: 20100M\_04

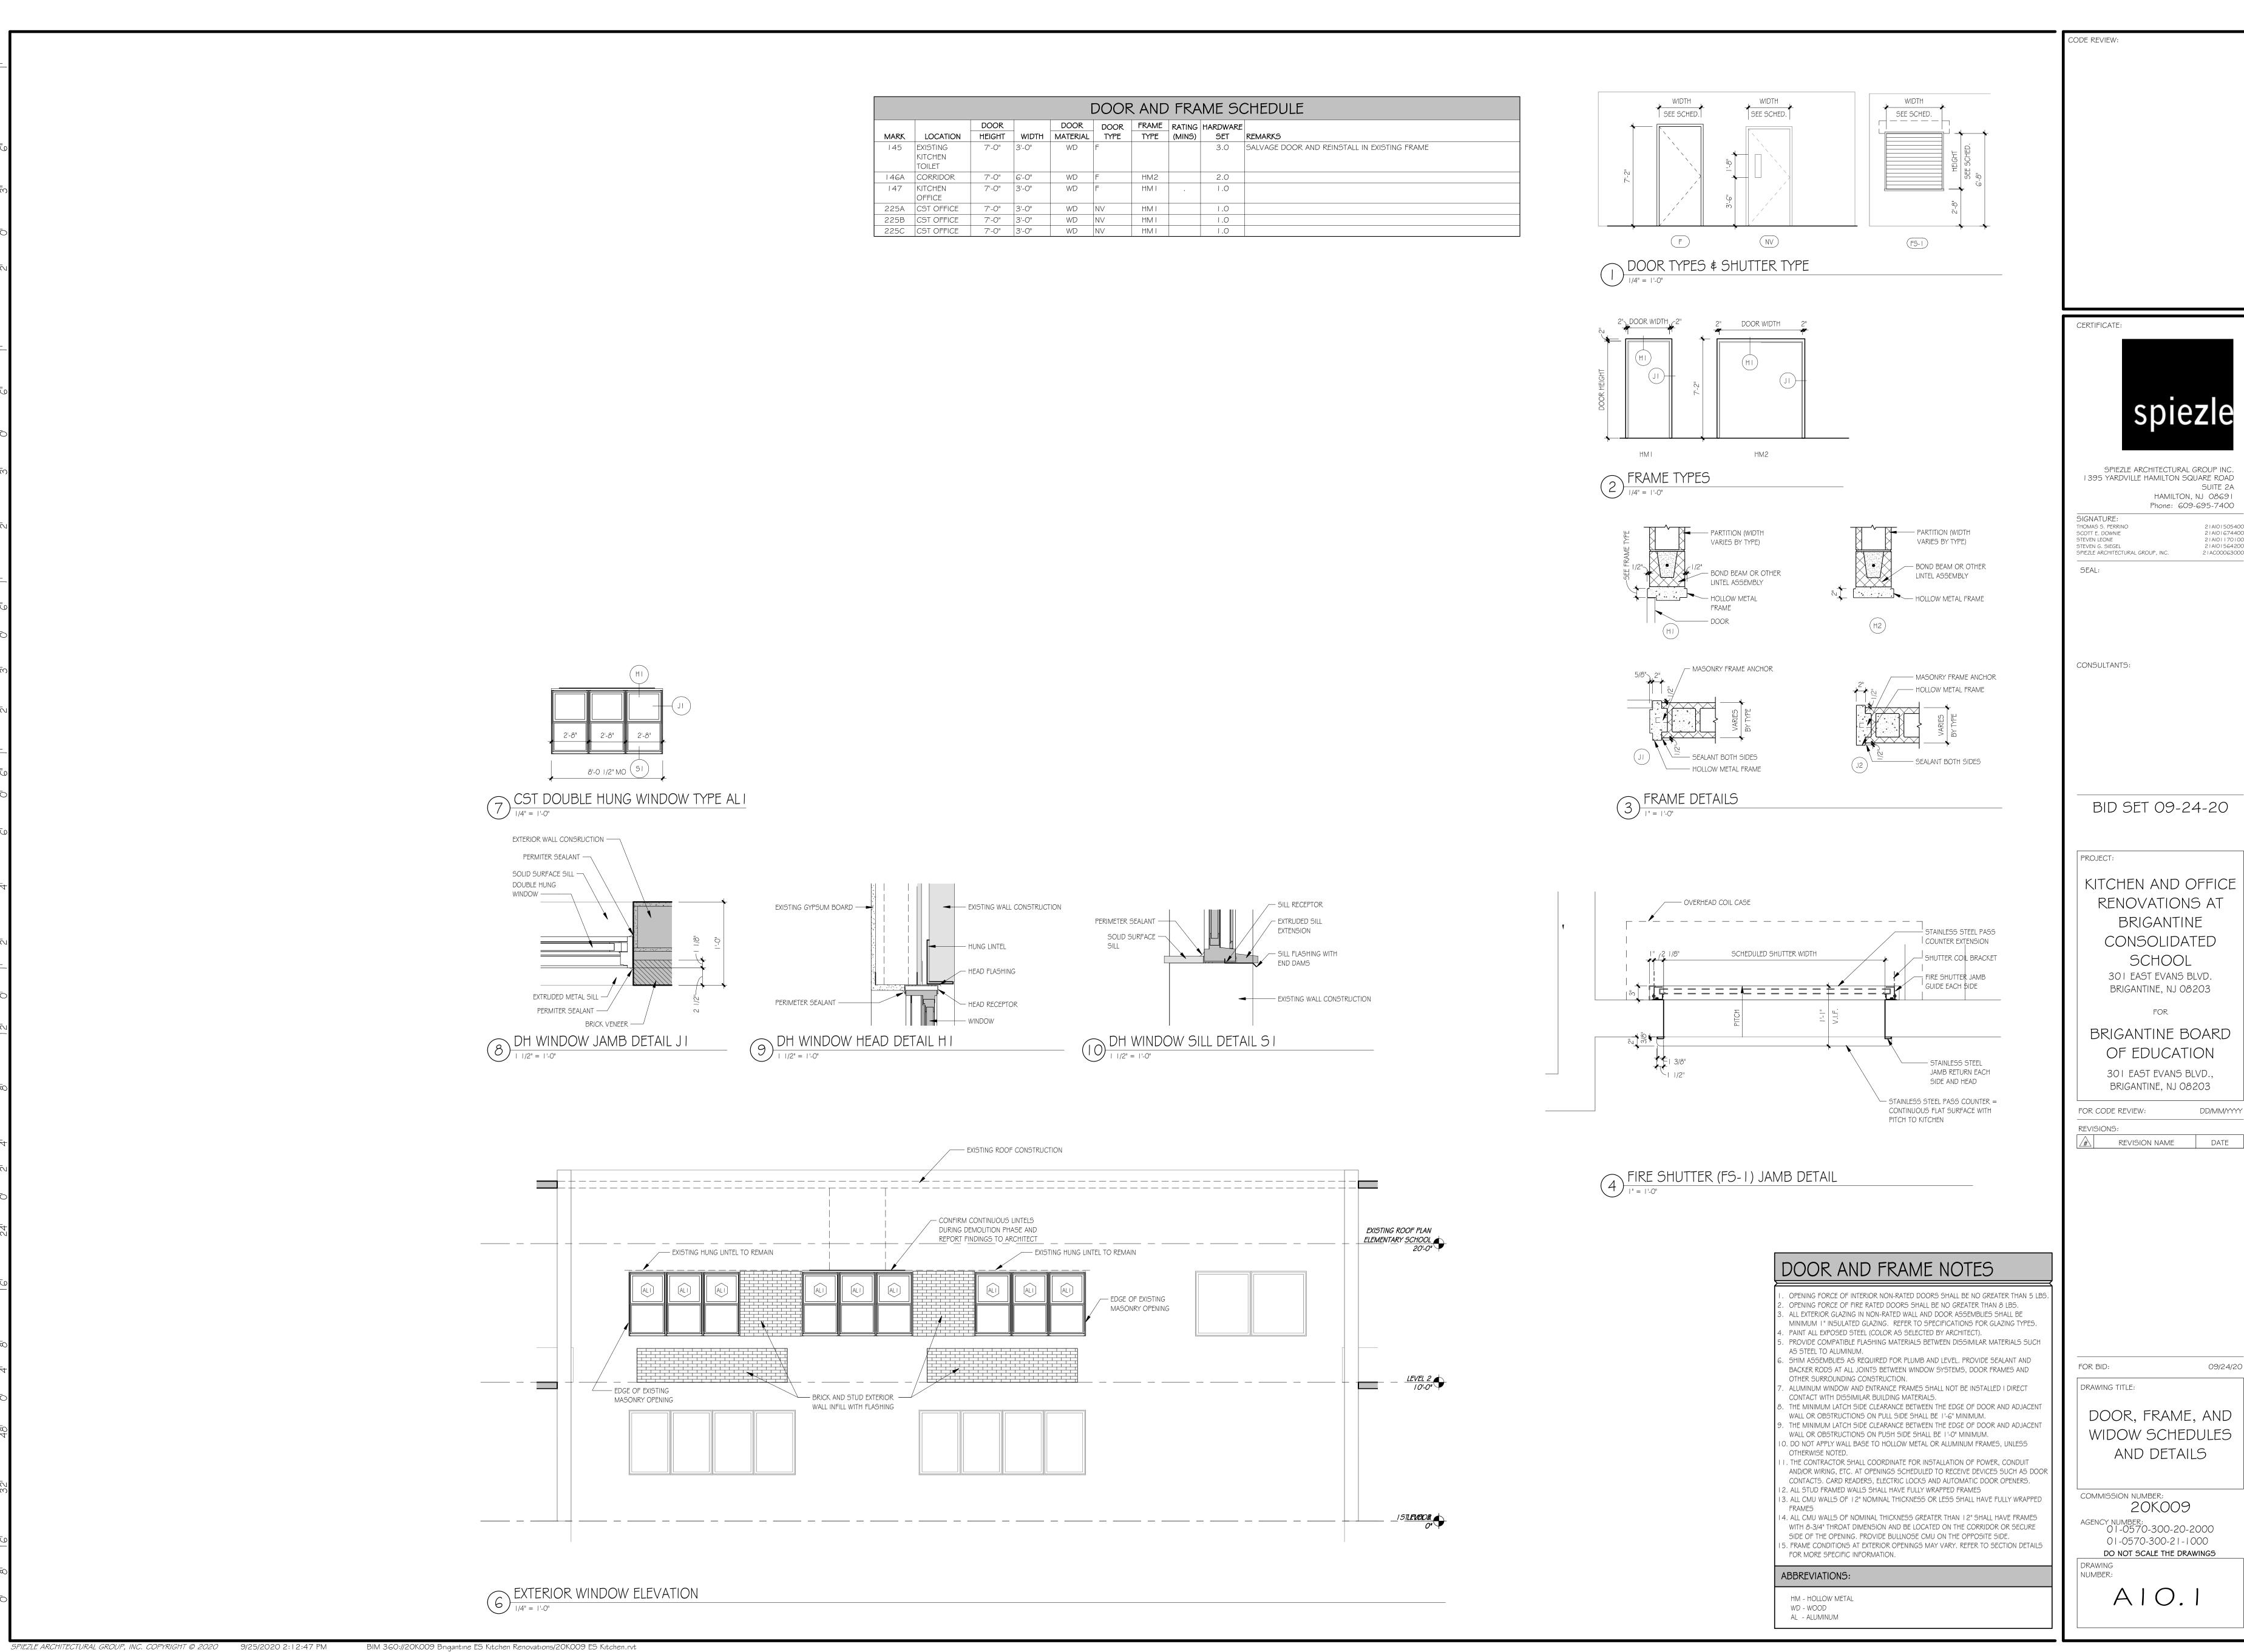90% 9/18/20

KITCHEN **UPGRADES AND** CLASSROOM **ALTERATIONS AT** BRIGANTINE **ELEMENTARY** 

> BRIGANTINE OF EDUCATION

301 E Evans Brigantine, NJ 0820

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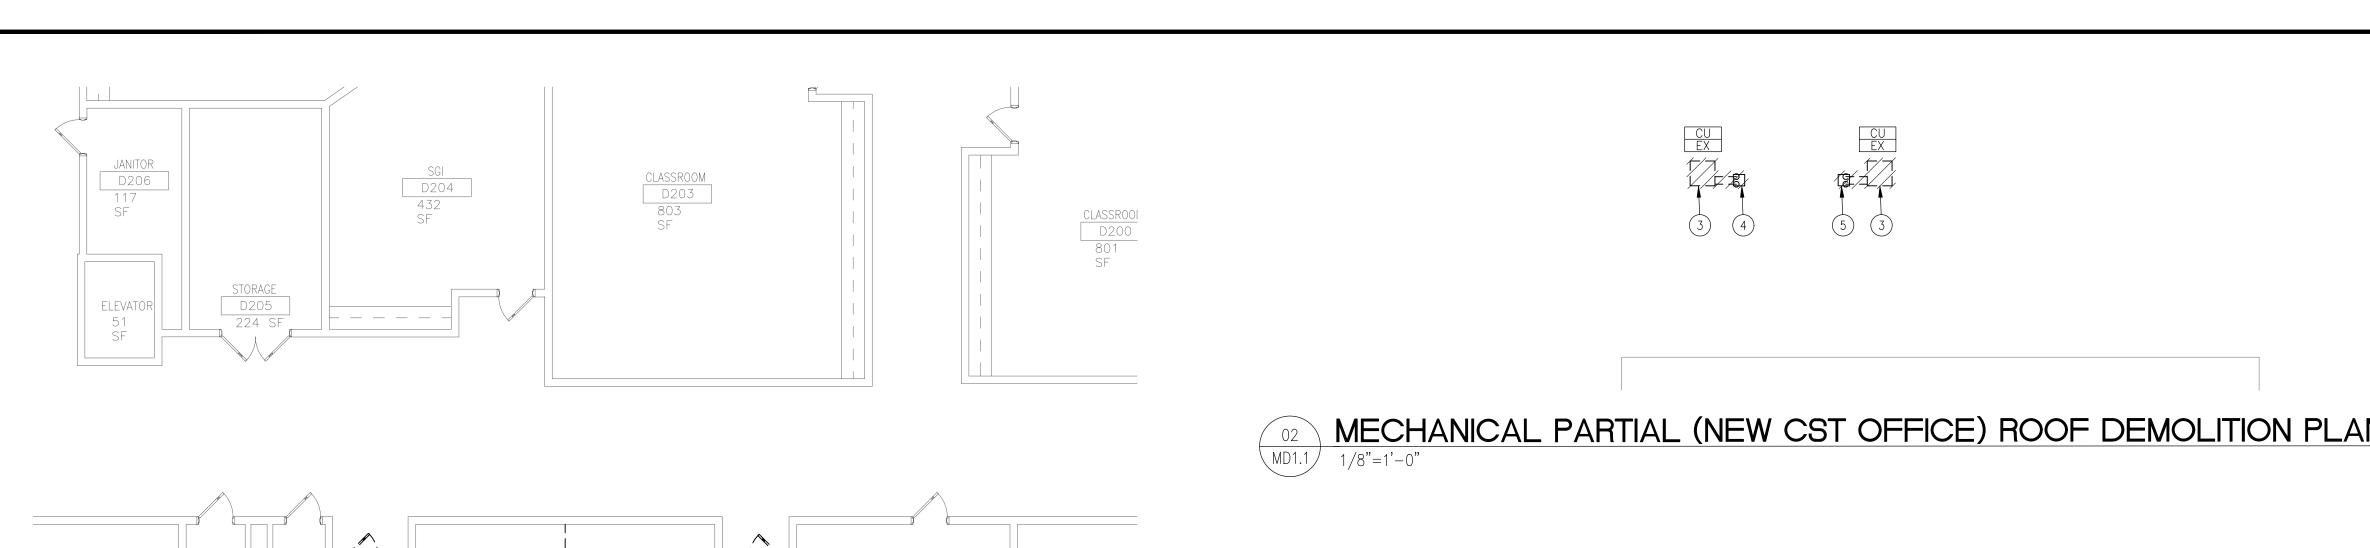
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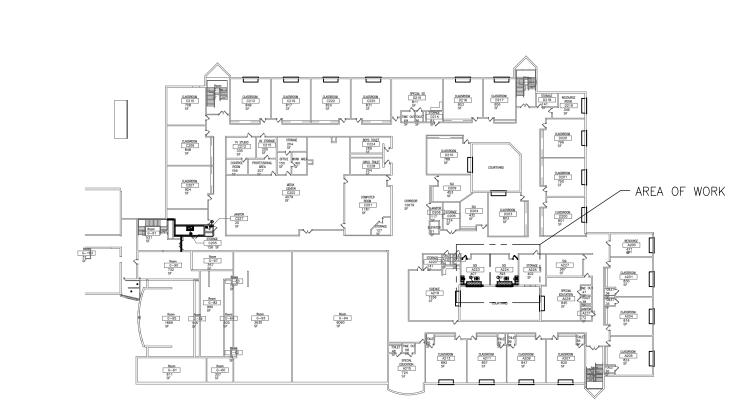
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- 1. DEMOLISH EXISTING UNIT VENTILATOR AND ALL ASSOCIATED PIPING, CONTROLS, WIRING, ETC. DEMOLISH EXISTING EXTERIOR WALL LOUVER AND PATCH EXTERIOR WALL TO MATCH EXISTING. DEMOLISH EXISTING HOT WATER AND CONDENSATE PIPING DOWN THROUGH FLOOR. CAP PIPING IN CEILING BELOW. PATCH EXISTING 8" CORE-DRILLED FLOOR OPENING TO MATCH EXISTING. PATCH ALL EXISTING WALLS AND SURFACES TO MATCH EXISTING
- 2. DEMOLISH EXISTING SHEET METAL ENCLOSURE AND ENCLOSED PIPING. PATCH WALL TO MATCH
- 3. DEMOLISH EXISTING ROOF MOUNTED CONDENSING UNIT AND ALL ASSOCIATED PIPING, CONTROLS, WIRING, ETC. EXISTING ROOF RAILS TO BE ABANDONED IN PLACE
- 4. CAP EXISTING REFRIGERANT PIPE CURB WITH 1/2" PLYWOOD AND CAP WITH GALVANIZED SHEET METAL WITH A MINIMUM 3" LIP DOWN THE SIDES OF THE CURB. SECURE WITH SCREWS AND CAULK WEATHER TIGHT
- 5. EXISTING REFRIGERANT PIPE CURB TO BE REUSED

KITCHEN RENOVATION KEY NOTES

12. DEMOLISH EXISTING DUCTWORK

CONTROLS, ETC.

1. EXISTING ABANDONED CAPPED CURB TO REMAIN

2. DEMOLISH EXISTING ABANDONED CAPPED CURB

10. EXISTING GREASE EXHAUST DUCT TO BE REUSED

13. DEMOLISH EXISTING CLOTHES DRYER CLEANOUT CONTAINER

4. DEMOLISH EXISTING ABANDONED FLUE. CAP WEATHER TIGHT 12" ABOVE ROOF LINE

11. DEMOLISH EXISTING AHU. MODIFY EXISTING PIPING, DUCTWORK, ETC. FOR CONNECTION TO NEW


14. DEMOLISH EXISTING CLOTHES DRYER EXHAUST FAN AND ALL ASSOCIATED DUCTWORK, WIRING,

15. EXISTING FIRE/SMOKE DAMPER ABOVE CEILING FOR KITCHEN TRANSFER AIR IS PRESENTLY CLOSED. RE-PROGRAM FIRE ALARM SYSTEM FOR DAMPER TO BE OPEN. RE-PROGRAM FOR

DAMPER TO CLOSE UPON FIRE ALARM CONDITION/SMOKE DETECTION. TYPICAL FOR 4

5. EXISTING GAS PIPING. REFER TO PLUMBING DRAWINGS FOR SCOPE OF WORK

3. EXISTING OUTDOOR AIR INTAKE TO REMAIN

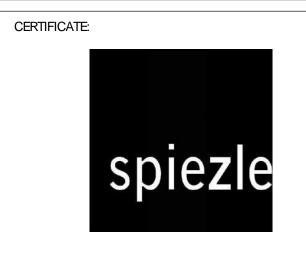

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> 21Al01505400 21Al01674400 21Al01564200

21AC00063000

SIGNATURE: THOMAS S. PERRINO SCOTT E. DOWNIE STEVEN LEONE STEVEN G. SIEGEL SPIEZLE ARCHITECTURAL GROUP, INC.

P.O. BOX 628 FARMINGDALE, NJ 07727 732.938.2666 PHONE: 732.938.2521 CERTIFICATE OF AUTHORIZATION NO. 24GA28124300 PAUL RIPISH, N.J.P.E. LICENSE NUMBER 4515800 ALL DRAWINGS AND WRITTEN MATERIALS APPEARING HEREIN CONSTITUTE ORIGINAL AND UNPUBLISHED WORK OF THE ENGINEER. THE REPRODUCTION OF THIS DRAWING FOR THE PURPOSE OF COPYING THIS WORK OR REVISING SAID DRAWING SHALL BE CONSIDERED A VIOLATION OF BOTH THE PROFESSIONAL CODE OF ETHICS AND A THEFT OF COMPANY ASSETS, BOTH OF WHICH SHALL BE PROSECUTED TO THE FULLEST EXTENT OF CURRENT STATUTES.

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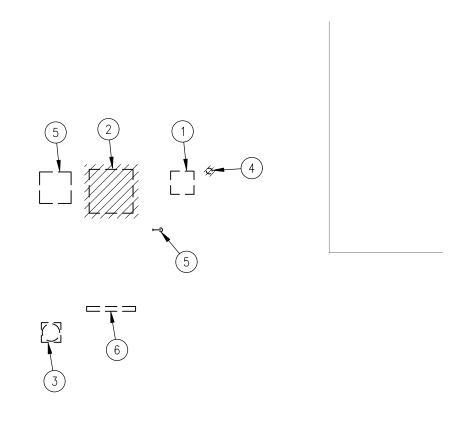
MECHANICAL FIRST, SECOND FLOOR AND ROOF DEMOLITION PARTIAL PLANS

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MECHANICAL PARTIAL (KITCHEN) SECOND FLOOR DEMOLITION PLAN




MECHANICAL PARTIAL (KITCHEN)




ROOF DEMOLITION PLAN

1/8"=1'-0"

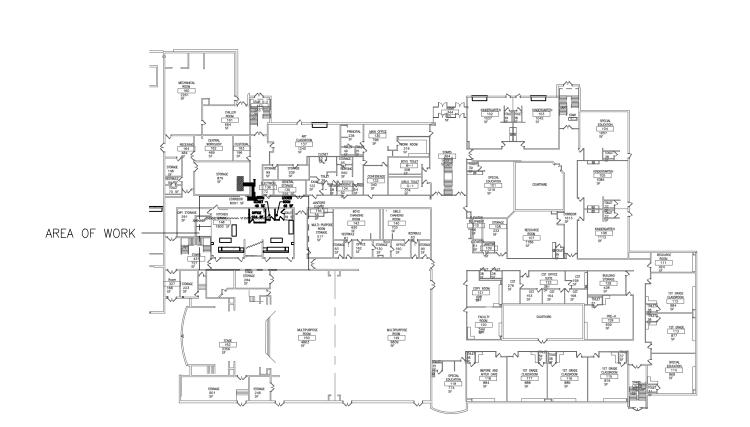

O7 FIRST FLOOR KEYPLAN

MD1.1 1/64"=1'-0"

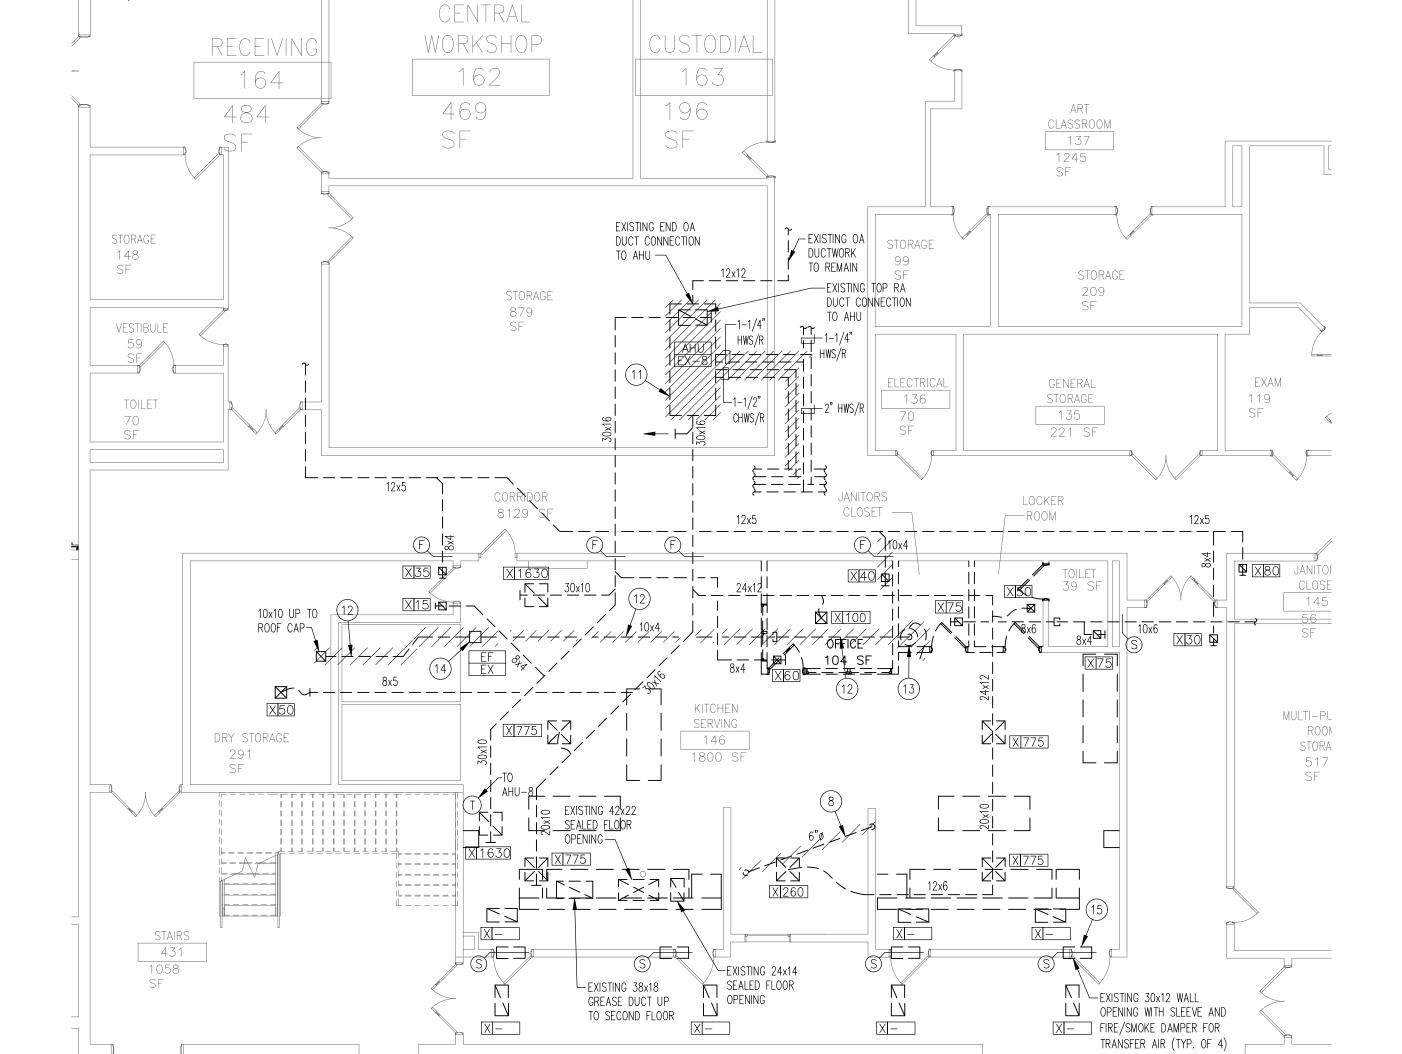



MECHANICAL PARTIAL (KITCHEN) FIRST FLOOR DEMOLITION PLAN

MECHANICAL PARTIAL (NEW CST OFFICE) SECOND FLOOR DEMOLITION PLAN


1/8"=1"-0"

SCIENCE

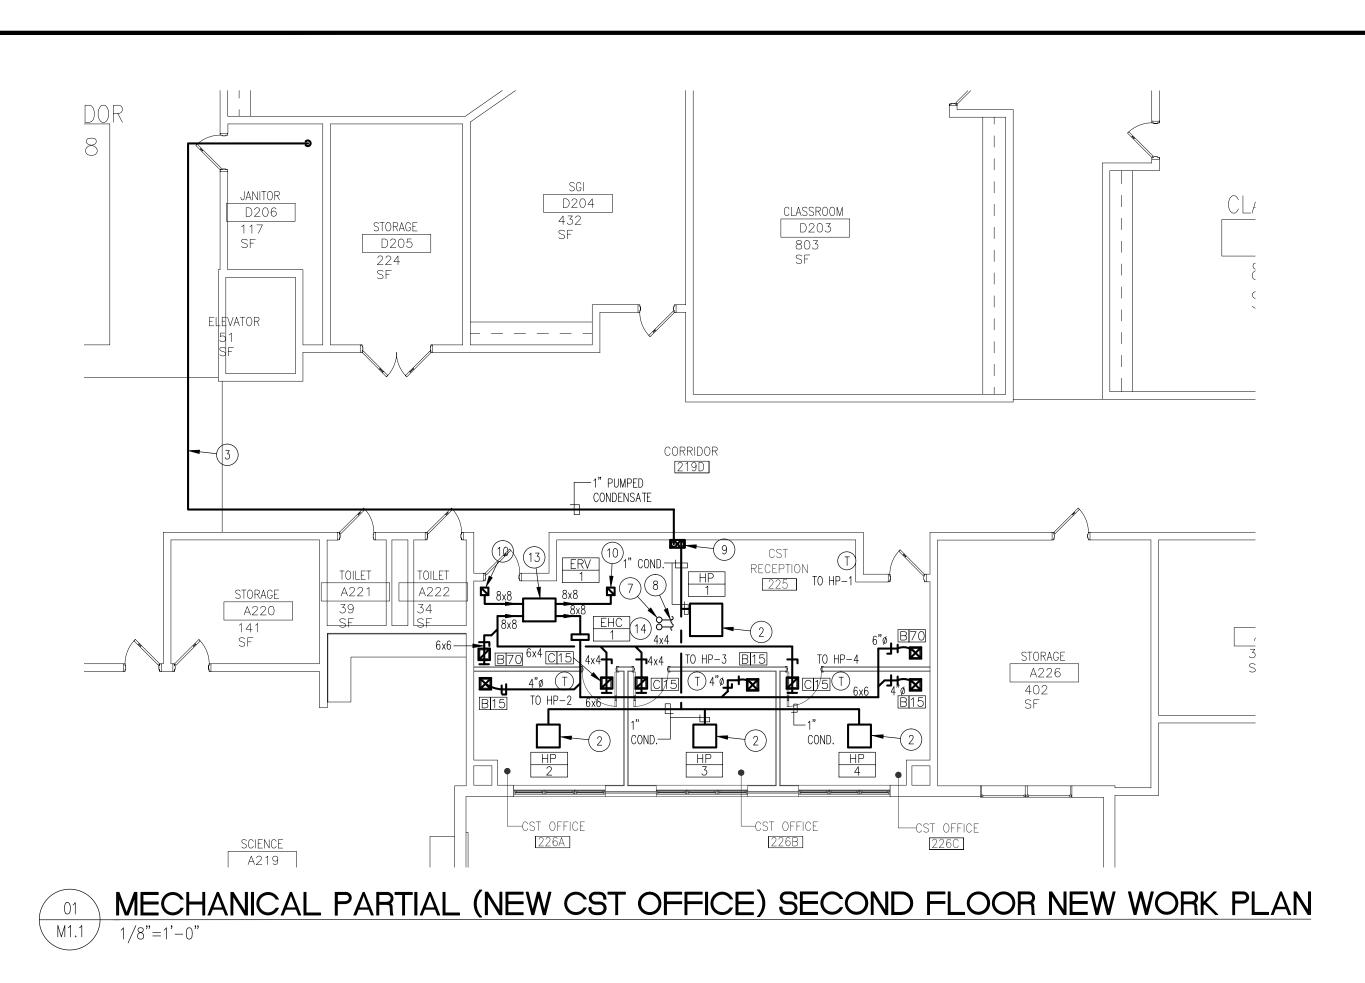

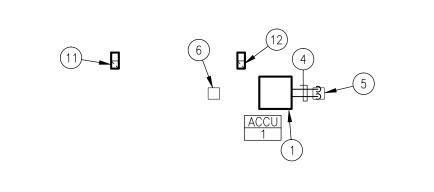

MECHANICAL PARTIAL (NEW CST OFFICE) ROOF NEW WORK PLAN

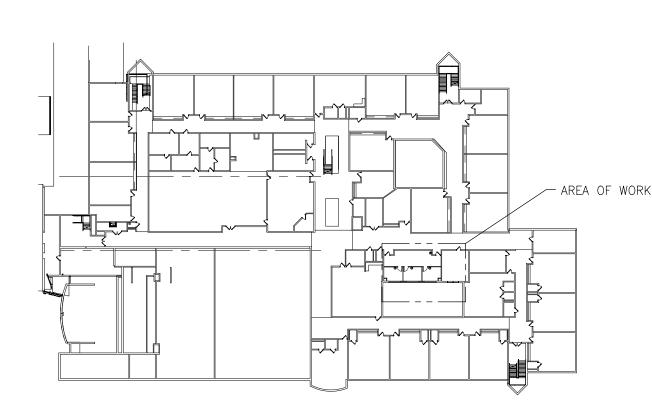

SECOND FLOOR (NEW CST OFFICE) KEYPLAN

#### NEW CST OFFICE KEY NOTES

- 1. PROVIDE NEW ROOF MOUNTED CONDENSING UNIT AND NEW ROOF RAILS. REFER TO ROOF EQUIPMENT SUPPORT RAIL DETAIL
- 2. PROVIDE NEW CEILING CASSETTE HEAT PUMP UNIT
- 3. PROVIDE NEW 1" CONDENSATE PIPING ABOVE EXISTING SUSPENDED CEILING. SPILL TO JANITORS
- 4. PROVIDE NEW REFRIGERANT PIPING. SIZE AND INSTALL AS PER MANUFACTURER'S INSTRUCTIONS
- 5. PROVIDE NEW REFRIGERANT PIPING DOWN THROUGH ROOF. REUSE EXISTING ROOF CURB. REFER TO ROOF PIPE CURB DETAIL
- 6. CAP EXISTING CURB AS PER DEMOLITION PLANS
- 7. PROVIDE NEW REFRIGERANT PIPING UP THROUGH ROOF
- 8. PROVIDE INTERCONNECTING REFRIGERANT PIPING FROM ACCU-1 TO VRF HP'S 1 THRU 4. SIZE AND INSTALL AS PER MANUFACTURER'S RECOMMENDATIONS. REFER TO VRF REFRIGERANT PIPING
- 9. PROVIDE CONDENSATE PUMP BY LITTLE GIANT OR EQUAL. MOUNT ABOVE CEILING. PUMP
- CONDENSATE TO JANITORS CLOSET
- 11. PROVIDE NEW GOOSENECK FOR OUTDOOR AIR. REFER TO GOOSENECK DETAIL
- 12. PROVIDE NEW GOOSENECK FOR RELIEF AIR. REFER TO GOOSENECK DETAIL
- 13. PROVIDE NEW ERV ABOVE SUSPENDED CEILING

10. PROVIDE NEW DUCTWORK UP THROUGH ROOF

AND WIRING DIAGRAM ON M3.3

14. PROVIDE NEW ELECTRIC DUCT HEATING COIL EHC-1. TRANSITION TO DUCTWORK AS REQUIRED

CERTIFICATE:

CODE REVIEW:



SPIEZLE ARCHITECTURAL GROUP INC. 1395 YARDVILLE HAMILTON SQUARE ROAD SUITE 2A HAMILTON, NJ 08691 Phone: 609-695-7400

21AI01674400

21Al01564200 21AC00063000

THOMAS S. PERRINO SCOTT E. DOWNIE STEVEN G. SIEGEL SPIEZLE ARCHITECTURAL GROUP, INC.

SEAL:

CONSULTANTS: P.O. BOX 628 FARMINGDALE, NJ 07727 PHONE: 732.938.2666 732.938.2521 CERTIFICATE OF AUTHORIZATION NO. 24GA28124300 PAUL RIPISH, N.J.P.E. LICENSE NUMBER 4515800 ALL DRAWINGS AND WRITTEN MATERIALS APPEARING HEREIN CONSTITUTE ORIGINAL AND UNPUBLISHED WORK OF THE ENGINEER. THE REPRODUCTION OF THIS DRAWING FOR THE PURPOSE OF COPYING THIS WORK OR REVISING SAID DRAWING SHALL BE CONSIDERED A VIOLATION OF BOTH THE PROFESSIONAL CODE OF ETHICS AND A THEFT OF COMPANY ASSETS, BOTH OF WHICH SHALL BE PROSECUTED TO THE FULLEST EXTENT OF CURRENT STATUTES.

KSI PROJECT #: 20100M\_04

PROJECT: KITCHEN UPGRADES AND CLASSROOM ALTERATIONS AT

> BRIGANTINE ELEMENTARY

BRIGANTINE OF EDUCATION

301 E Evans Brigantine, NJ 0820

FOR CODE REVIEW: DD/MM/YYYY **REVISIONS:** DATE

REVISION NAME ADDENDUM #1 10/05/20

FOR BID: 09/23/2020 DRAWING TITLE: MECHANICAL FIRST, SECOND FLOOR AND ROOF NEW WORK PARTIAL PLANS

COMMISSION NUMBER:


20K009 AGENCY NUMBER: 01-0570-300-20-2000 01-0570-300-21-1000 DO NOT SCALE THE DRAWINGS


MI.I

1. PROVIDE NEW ROOF MOUNTED HOOD EXHAUST FAN (KEF-1). INSTALL AS PER DETAILS

KITCHEN RENOVATION KEY NOTES

- 2. PROVIDE NEW ROOF MOUNTED HOOD MAKE-UP AIR UNIT (MUA-1)
- 3. EXISTING OUTDOOR AIR INTAKE TO REMAIN
- 4. EXISTING GREASE EXHAUST DUCT TO REMAIN
- 5. PROVIDE NEW 32x14 HOOD MAKE-UP AIR SUPPLY DUCTWORK
- 6. BALANCE EACH SUPPLY AIR HOOD CONNECTION TO 583 CFM. TYPICAL FOR 6
- 7. PROVIDE NEW 32x14 MAKE-UP AIR DUCT UP THROUGH FLOOR. PROVIDE NEW FIRESTOPPING AROUND NEW DUCT AT CEILING SLAB PENETRATION
- 8. PROVIDE NEW 34x16 GREASE EXHAUST DUCTWORK. PROVIDE MATERIALS, ACCESS DOORS AND INSULATION AS PER THE SPECIFICATIONS
- 9. EXISTING (NEVER USED) 38x18 STEEL GREASE EXHAUST DUCT TO REMAIN. CONNECT TO NEW GREASE EXHAUST DUCTWORK WITH WELDED CONNECTIONS AND INSULATE ALL DUCTWORK AS PER THE SPECIFICATIONS. PROVIDE NEW FIRE STOPPING AND NEW INSULATION AT CEILING SLAB 10. BALANCE HOOD EXHAUST TO 2000 CFM PER HOOD CONNECTION
- 11. EXISTING 30x12 WALL OPENING, WALL SLEEVE AND SMOKE DAMPER FOR TRANSFER AIR TO REMAIN. EXISTING SMOKE DAMPER IS PRESENTLY CLOSED AND NEEDS TO BE NORMALLY OPEN. CONTRACTOR SHALL COORDINATE WITH FIRE ALARM VENDOR TO RE-PROGRAM SMOKE DAMPER TO BE NORMALLY OPEN AND CLOSE UPON SMOKE DETECTION BY FIRE ALARM SYSTEM
- 12. CAP EXISTING DUCTWORK AIR TIGHT
- 13. PROVIDE NEW 1-1/4" CONDENSATE PIPING TO EXISTING FLOOR DRAIN
- 14. PROVIDE NEW HOT WATER PIPING FROM CORRIDOR MAIN TO NEW AHU-8 AS SHOWN
- 15. PROVIDE NEW CHILLED WATER PIPING FROM CORRIDOR MAIN TO NEW AHU-8 AS SHOWN 16. PROVIDE NEW 6"Ø DRYER EXHAUST VENT FROM NEW CLOTHES DRYER TO EXISTING ROOF PENETRATION. INSTALL VENT DUCTWORK AS PER SPECIFICATIONS
- 17. PROVIDE NEW FIRESTOPPING FOR ALL NEW PIPE THROUGH WALL PENETRATIONS
- 18. PROVIDE NEW CEILING SUSPENDED AHU WITH 1" SPRING VIBRATION ISOLATION
- 19. CONNECT NEW AHU TO EXISTING OUTSIDE AIR DUCTWORK. PROVIDE NEW DUCTWORK AND TRANSITIONS AS REQUIRED
- 20. CONNECT NEW AHU TO NEW RETURN AIR DUCTWORK. PROVIDE NEW TRANSITIONS AS REQUIRED 21. PROVIDE NEW DUCTWORK THROUGH EXISTING WALL. PROVIDE NEW WALL OPENING AND LINTEL AS
- REQUIRED 22. PROVIDE NEW DUCT TRANSITIONS AS REQUIRED
- 23. PROVIDE NEW 32x14 ROOF MOUNTED MAKE-UP AIR SUPPLY DUCTWORK ON ROOF. REFER TO DUCT PENETRATION THROUGH ROOF DETAIL. INSULATE DUCTWORK AS PER SPECIFICATIONS
- 24. PROVIDE NEW 20" MUA CURB. REFER TO NOTE #9 IN MUA UNIT SCHEDULE
- 25. PROVIDE NEW CLEAN-OUT ON BOTTOM OF EXISTING CLOTHES DRYER VERTICAL RISER
- 26. REFER TO PLUMBING PLANS FOR GAS PIPING REQUIREMENTS

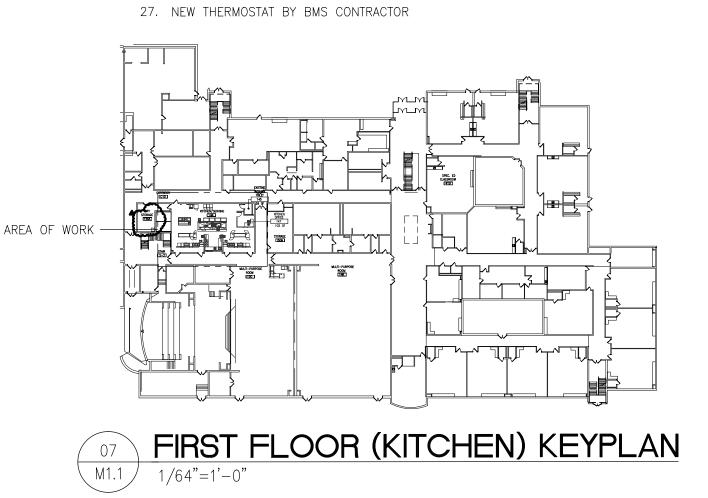

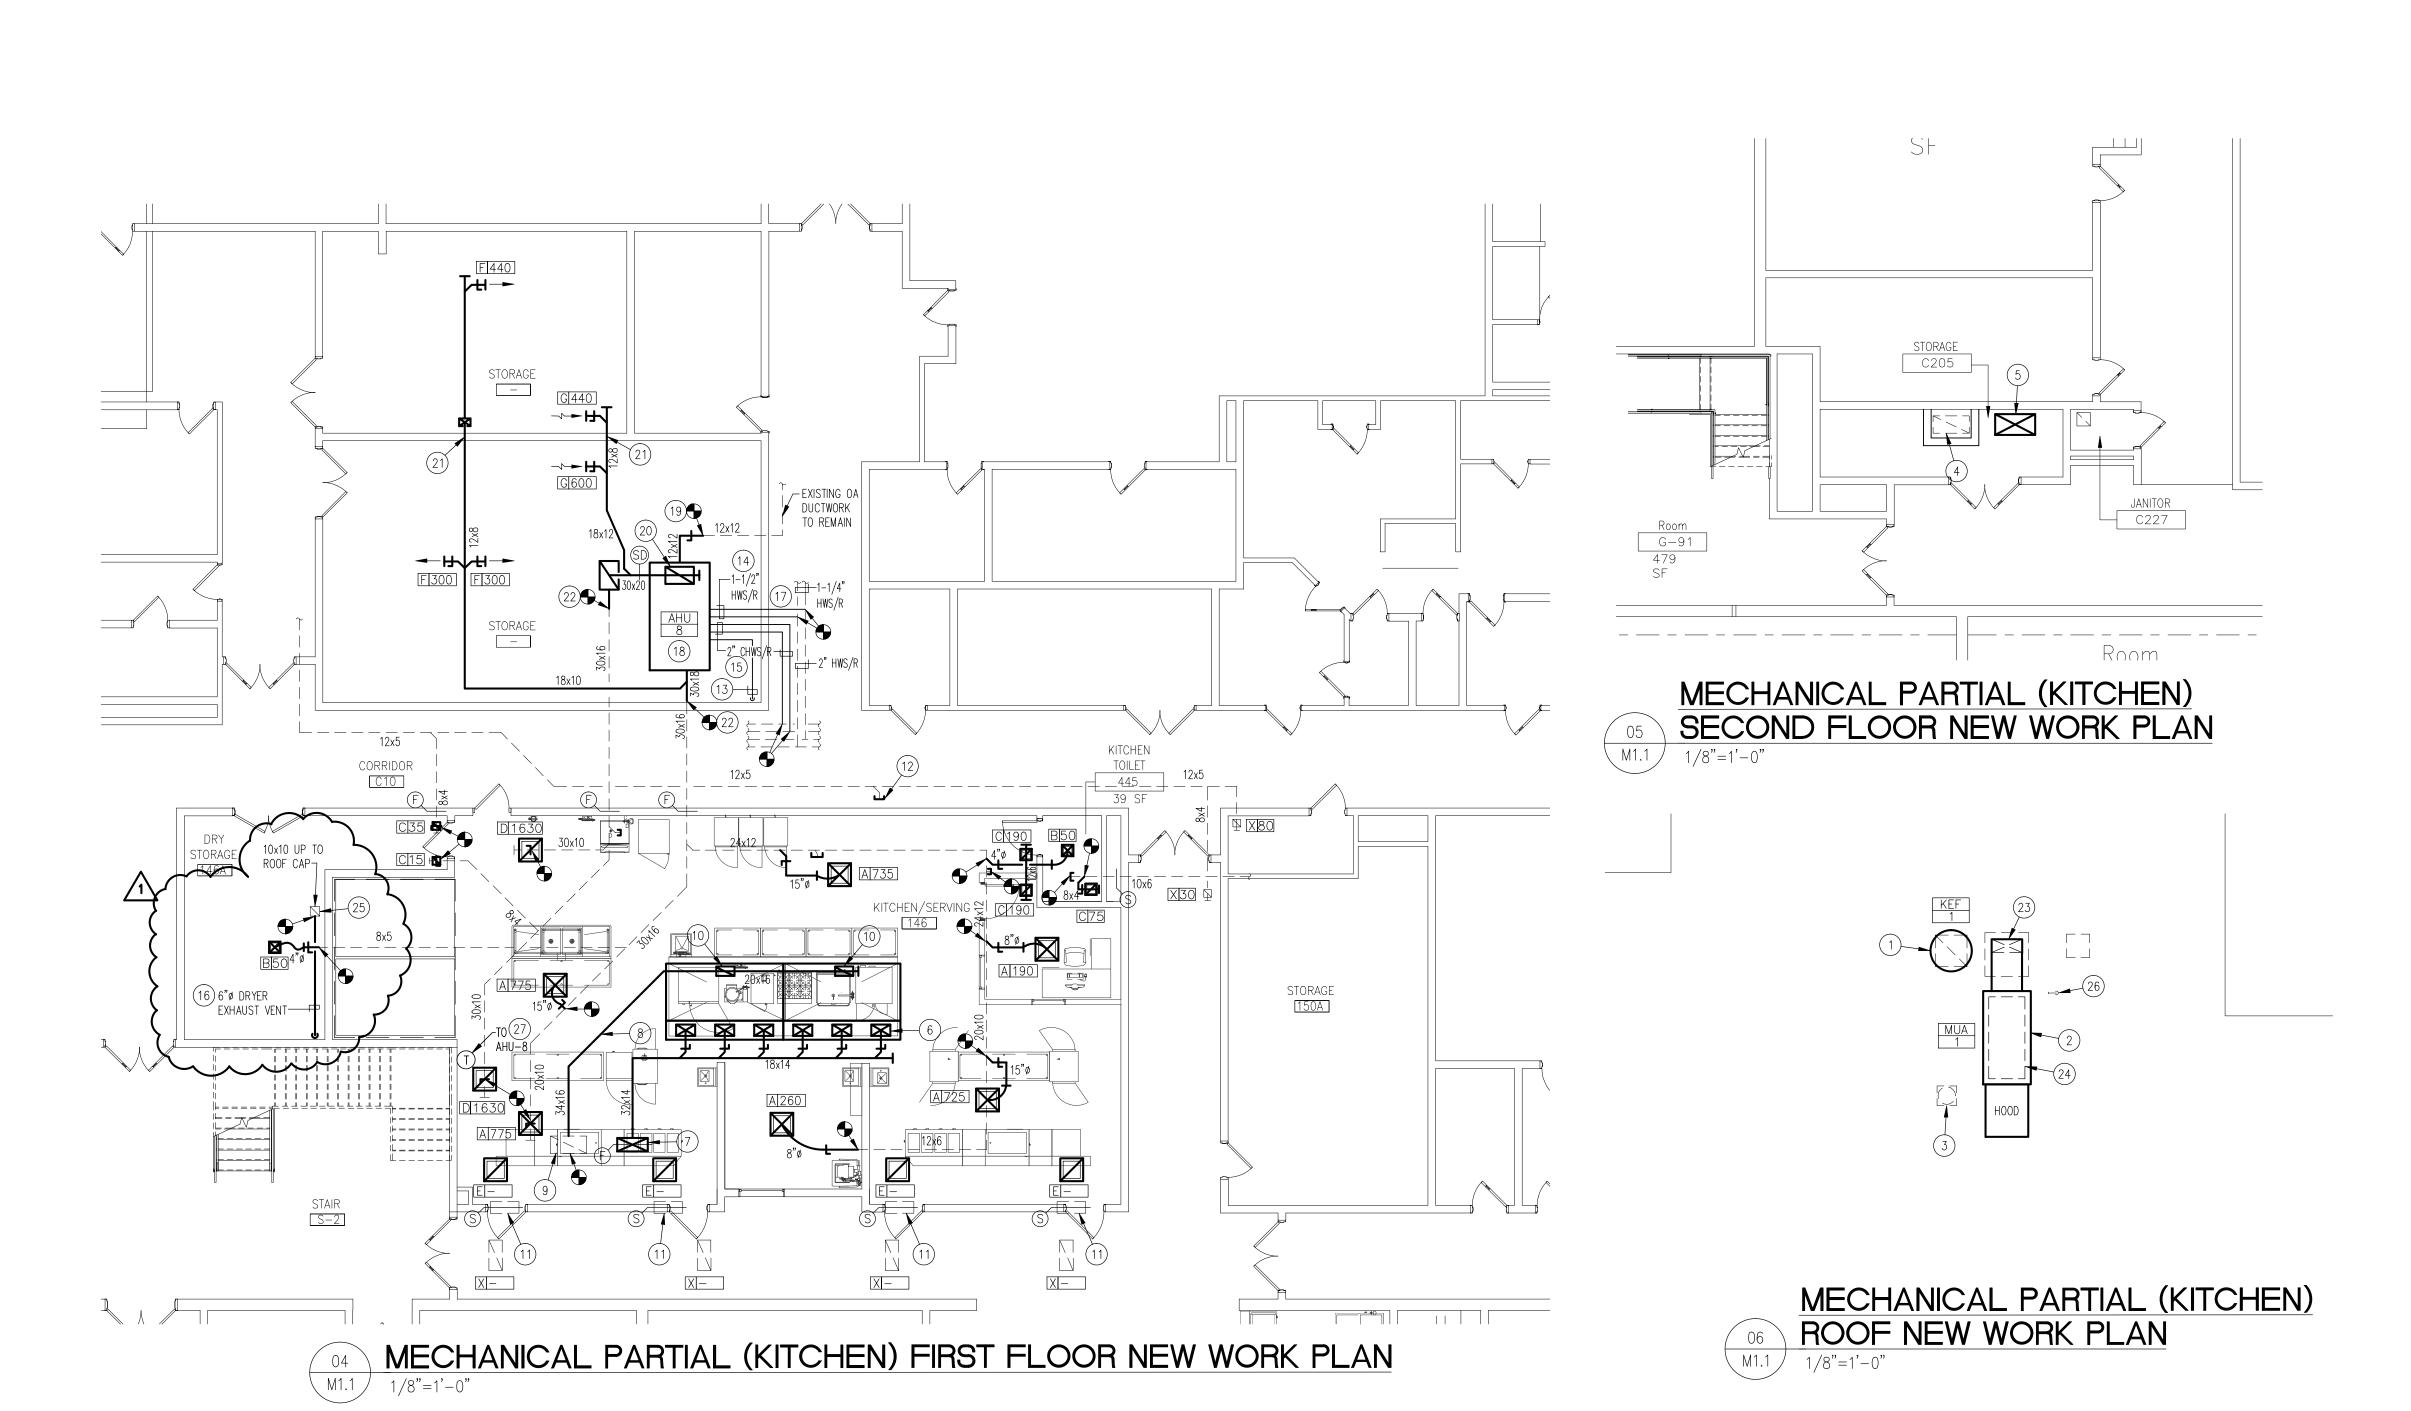

KITCHEN E	XHAUST FAN SCHEDL	JLE (KEF)		<b>,</b>			7		· · · · · · · · · · · · · · · · · · ·				
UNIT ID	MANUFACTURER	MODEL	TYPE	SERVICE	INTERLOCKED	CFM	ESP	DRIVE	MOTOR	El	LECTRICA	AL.	WEIGHT
		NUMBER			WITH		IN. W.G.		POWER (HP)	VOLTS	PHASE	HERTZ	(LBS)
KEF-1	CAPTIVEAIRE	DU240HFA	CENTRIFUGAL UPBLAST	HOOD	MUA-1	4,000	1.75	DIRECT	5	460	3	60	350
		NOTES:											

1. INSTALL CURBS AND FANS PER MANUFACTURER'S INSTRUCTIONS.

2. PROVIDE 20" TALL VENTED ROOF CURB 3. FAN SHALL BE UL762 LISTED FOR GREASE AND HIGH HEAT OPERATION

4. PROVIDE WEATHERPROOF DISCONNECT

PROVIDE GREASE BOX

7. PROVIDE HINGE KIT 8. ELECTRICAL CONTRACTOR SHALL RUN 460V 3 PHASE WIRING FROM BREAKER TO HOOD CONTROL PACKAGE. ELECTRICAL CONTRACTOR

<u>NOTES</u> 1. SELECTIONS BASED ON INDEECO. 2. AUTOMATIC RESET THERMAL CUTOUT 3. AIRFLOW SWITCH 4. MAGNETIC CONTACTORS 5. DOOR INTERLOCK DISCONNECT SWITCH SCR CONTROL 7. PROVIDE TIE IN TO SCHOOL BMS 5. PROVIDE INVERTER DUTY TEFC MOTOR FOR VARIABLE FREQUENCY DRIVE CONTROL (VFD SUPPLIED AS PART OF HOOD CONTROL PACKAGE) 8. PROVIDE DISCHARGE AIR TEMPERATURE CONTROL 9. PROVIDE SLIP-IN ARRANGEMENT SHALL ALSO RUN 460V 3 PHASE WIRING FROM HOOD CONTROL PACKAGE TO KITCHEN EXHAUST FAN. REFER TO WIRING DIAGRAMS ON PLANS

ELECTRIC DUCT HEATER SCHEDULE (EDH)

UNITID SERVING MODEL CFM KW MBH STAGES EAT LAT VOLTS PH

ERV-1 QUA 115 1.5 5 SCR 30 71 460 3

			OA INLET EXTERNAL	EA OUTLET EXTERNAL	ENTHALPY	ENTHALPY		E	LECTRICA	L		D	IMENSIONS	S & WEIGH	IT
UNIT	MODEL	CAPACITY	STATIC	STATIC	RECOVERY	RECOVERY	VOLTS	PHASE	HERTZ	FLA	MOCP	WIDTH	HEIGHT	DEPTH	WEIGHT
NO.	NO.	(CFM)	PRESSURE	PRESSURE	EFFICIENCY	EFFICIENCY						(INCH)	(INCH)	(INCH)	(LBS.)
			(IN W.G.)	(IN W.G.)	(HEATING)	(COOLING)									
ERV-1	EV200	115	0.7	0.7	77%	64%	120	1	60	1.5	15	34	20	24	68

1. SELECTIONS BASED ON EQUIPMENT MANUFACTURED BY RENEWAIRE

2. PROVIDE MERV 8 FILTERS ON EACH SIDE OF HEAT EXCHANGER 3. DISCONNECT SWITCH BY MECHANICAL CONTRACTOR

4. CROSS CONTAMINATION < 1% 5. TIE INTO SCHOOL BMS

GAS FIRED MAKEUP AIR UNIT SCHEDULE (MUA) ELECTRICAL (FOR FAN MOTOR ONLY-THIS POWER IS FROM OPER. COOLING SECTION GAS HEAT SECTION HOOD CONTROL PACKAGE VFD) | WEIGHT | ESTIMATED | TOTAL TEMP GAS WITHOUT CURB ESTIMATED MBH RISE PRESSURE CURB | WEIGHT | WEIGHT TOTAL MINIMUM OUTDOOR ESP (IN. MOTOR | INPUT | OUTPUT | (DEG F) | (IN W.C.) | VOLTS | PH | MCA | MOP | (LBS) | (LBS) UNIT ID MANUFACTURER | MODEL NUMBER | CFM | CFM | AIR % | W.C.) | HP MUA-1 CAPTIVEAIRE A2-IBT-400-G15 3,500 2,500 100 0.75 2 - NO COOLING - 315,705 252,564 60 7 - 14 460 3 3.3 15 1150 250

NOTES

1. PROVIDE MOTORIZED OUTDOOR INTAKE DAMPER AND WEATHERHOOD

2. PROVIDE LOW FIRE START

3. PROVIDE FREEZSTAT 4. PROVIDE END DISCHARGE

5. PROVIDE FULLY MODULATING GAS CONTROLS

6. PROVIDE BLOWER MOUNTED DISCHARGE AIR TEMPERATURE SENSOR 7. UNIT SHALL BE A COMPLETE PACKAGE INCLUDING ALL CONTROLS TESTED IN ACCORDANCE WITH ANSI STANDARDS AND ETL LABEL

8. PROVIDE DISCONNECT

9. PROVIDE NEW 20" FULL PERIMETER WIND LOAD RATED INSULATED ROOF CURB. CURB SUBMITTAL SHALL INDICATE ATTACHMENTS REQUIRED FOR A MINIMUM WIND SPEED OF 135 MPH (WINDSPEED FOR BRIGANTINE, NJ). WINDLOADING CALCULATIONS SHALL BE SIGNED AND SEALED

CAPTIVE-AIRE'S STANDARD 180 MPH MIAMI-DADE FLORIDA SIGNED AND SEALED CURB CALCULATION PACKAGE IS ACCEPTABLE 10. PROVIDE TEFC INVERTER DUTY-MOTOR. VFD FOR FAN MOTOR IS SUPPLIED AS PART OF THE HOOD CONTROL PACKAGE

11. PROVIDE SEPARATE 120V (15 AMP BREAKER) POWER CONNECTION AND WIRING FOR MUA HEATER CONTROLS

12. ELECTRICAL CONTRACTOR SHALL RUN 460√3 PHASE WIRING FROM BREAKER TO HOOD CONTROL PACKAGE. CONTRACTOR SHALL ALSO RUN 460√3 PHASE WIRING FROM

HOOD CONTROL PACKAGE TO MAKE-UP AIR UNIT. REFER TO WIRING DIAGRAMS ON PLANS 13. PROVIDE ALL LOW VOLTAGE WIRING IN BETWEEN HOOD CONTROLS PACKAGE AND MUA UNIT AS PER THE WIRING DIAGRAMS

			SUPPLY FA	٩N				CHILLED WA	ATER COOL	ING COIL					HOT WAT	ER HEATIN	NG COIL				ELECTRIC	AL CHARA	CTERISTIC	·S	ļ	DIMENSIO	NS		OPE
UNIT	MODEL	AREA	TOTAL	OA	% OA	ESP	MOTOR	TOTAL	SENS	FLOW	WATER PRESSURE	EAT (F)	LAT (F)	EWT/LWT	EAT (F)	LAT (F)	TOTAL	FLOW	WATER PRESSURE	EWT/LWT					Г	WIDTH	LENGTH	HEIGHT	WEI
ID	NO.	SERVED	CFM	CFM	, ,	IN. WG.	HP	MBH	MBH	(GPM)	DROP (FT H2O)	DB/WB	DB/WB	DEGF	DB	DB	(MBH)	(GPM)	DROP (FT H2O)	DEG F	VOLTS	PHASE	HERTZ	MCA	MOCP	(INCH)	(INCH)	(INCH)	LB
AHU-8	UCCAG10C0F0RAL	KITCHEN/STORAGE	4600	200	4%	0.8	5	135	110	26.9	2.26	76/64	54.1/53.6	44/54	67	95.9	143.4	14.4	2.6	180/160	460	3	60	10.5	15	63	113	38	14
	NOTES:  1. SELECTION BASED ON EQUIPMENT FROM TRANE  2. DISCONNECT BY MECHANICAL CONTRACTOR  3. CONTROLS BY ATC CONTRACTOR  4. UNIT TO BE MOUNTED IN HORIZONTAL CONFIGURATION  5. PROVIDE MIXING BOX WITH TOP RETURN AIR INTAKE, END OUTSIDE AIR INTAKE, AND PLEATED MERV 8 FILTERS  6. UNIT TO MOUNTED FROM STRUCTURE WITH 1" SPRING VIBRATION ISOLATORS. REFER TO STRUCTURAL PLANS																												

AIR-COOLE	D CONDENSING	SUNIT SCHED	<b>ULE (ACC</b>	U)													
		AREA	MATCHED	NOMINAL COOLING	NOMINAL HEATING	CORRECTED COOLING	CORRECTED HEATING	COOLING	ELECTRICA	L				DIMENSIO	NS & WEIG	HT (EACH M	ODULE)
UNIT	MODEL	SERVED	INDOOR	CAPACITY	CAPACITY	CAPACITY	CAPACITY	EER	VOLTS	PHASE	HERTZ	MCA	MOCP	WIDTH	HEIGHT	DEPTH	WEIGHT
NO.	NO.		HP UNITS	(BTUH)	(BTUH)	(BTUH)	(BTUH)					(AMPS)	(AMPS)	(INCH)	(INCH)	(INCH)	(LBS.)
ACCU - 1	TUMYH048	CST OFFICES	HP-1,2,3,4	48,000	54,000	48,236	51,300	12.2	208	1	60	36	44	42	53	14	275
1. 2. 3. 4. 5. 6.	NOTES: SELECTIONS BASE MOUNT CONDENSIN DISCONNECT SWITG ANTI-SHORT CYCLE CONDENSER COIL ( REFRIGERANT SHA PROVIDE LOW AME	NG UNIT ON PRE-F CH BY MECHANIC TIMER GUARD LL BE R410A	ABRICATED	EQUIPMENT SUPPOR	RT CURB												

9. ENTIRE ACCU SHALL BE MANUFACTURED, TESTED AND THEN SENT FOR AN ENTIRE UNIT COATING/DIPPING UTILIZING MICROGUARD AD35 HVAC ANTI-CORROSION PROTECTION.
ALL COSTS ASSOCIATED WITH SHIPPING BETWEEN MANUFACTURER, DIPPING FACILITY AND JOB SITE SHALL BE COORDINATED AND INCLUDED IN THE BID.

					COOLING				HEATING			ELECTR	CAL CHA	RACTE	RISTICS		DIMENSIC	NS		
UNIT	MODEL	TYPE	SERVING	MATCHED	NOM. TOT	CORRECTED	ENTERING AIR	CONDITIONS	NOM HEATING	CORRECTED	ENTERING AIR					***************************************				T
NUMBER	NUMBER		AREA	OUTDOOR	CAPACITY	CAPACITY	DRY BULB	WET BULB	CAPACITY	CAPACITY	CONDITIONS	VOLTS	DHAGE	⊔⊏ DT7	MCA	MOP				
NOWBER	NOMBLK		ANLA	OUTDOOK	CAPACITI	CAPACITI	DKI BOLD	VVL I BOLD	CAPACITI	CAPACITI	DRY BULB	VOLIS	FIIASL	HLKIZ	IVICA	MOF	WIDTH	HEIGHT	DEPTH	WEIGH
				UNIT	(BTUH)	(BTUH)	٥F	٥F	(BTUH)	(BTUH)	٥F						(INCH)	(INCH)	(INCH)	(LBS.
HP - 1	TPLFYP024	4-WAY CEILING CASSETTE	CST RECEPTION	ACCU-1	24,000	21,082	75	63	27,000	25,650	70	208	1	60	0.54	15	36	12	36	75
HP - 2	TPLFYP008	4-WAY CEILING CASSETTE	CST OFFICE 226A	ACCU-1	8,000	7,027	75	63	9,000	8,550	70	208	1	60	0.28	15	24	10	24	40
HP - 3	TPLFYP008	4-WAY CEILING CASSETTE	CST OFFICE 226B	ACCU-1	8,000	7,027	75	63	9,000	8,550	70	208	1	60	0.28	15	24	10	24	40
HP - 4	TPLFYP008	4-WAY CEILING CASSETTE	CST OFFICE 226C	ACCU-1	8,000	7,027	75	63	9,000	8,550	70	208	1	60	0.28	15	24	10	24	40

5	PROVIDE	FACTORY INSTALLEI	D CONDENSATE PUMP (	CAPABLE OF 0.8 GPH WITH LIFT OF 33"	
FFUS	ER AND	REGISTER SCHE	DULE		
NIT ID	MODEL	FACE SIZE	NECK SIZE	DESCRIPTION	REMARKS
Α	ASCD	24x24	REFER TO TABLE 1	ALUMINUM CONSTRUCTION 3-CONE CEILING DIFFUSER	1 THROUGH 7
В	ASCD	12x12	REFER TO TABLE 2	ALUMINUM CONSTRUCTION 3-CONE CEILING DIFFUSER	
С	630	REFER TO TABLE 3	REFER TO TABLE 3	ALUMINUM RETURN GRILLE WITH FIXED 45 DEGREE LOUVERS AND 3/4" SPACING	
D	10A	REFER TO TABLE 4	REFER TO TABLE 4	ALUMINUM PERFORATED RETURN GRILLE	

G 630 REFER TO TABLE 6 REFER TO TABLE 6 ALUMINUM RETURN GRILLE WITH FIXED 45 DEGREE LOUVERS AND 3/4" SPACING NOTES:

SELECTIONS ARE BASED ON PRICE INDUSTRIES.

2. BRANCH DUCTS AND FLEXIBLE DUCTS CONNECTING TO THE DIFFUSERS SHALL BE FULL SIZE OF NECK DIAMETER.

ALUMINUM PERFORATED RETURN GRILLE

F 620 REFER TO TABLE 5 REFER TO TABLE 5 ALUMINUM DOUBLE DEFLECTION SUPPLY REGISTER WITH 3/4" BLADE SPACING. FRONT BLADES PARALLEL TO THE SHORT DIMENSION

3. ALL UNITS ARE POWERED OFF OF THE ACCU. PROVIDE INTERCONNECTING POWER AND CONTROL WIRING BETWEEN THE HP AND THE ACCU

3. BAKED ENAMEL FINISH, COLOR TO BE SELECTED BY ARCHITECT. 4. DIFFUSERS SHALL BE 4-WAY BLOW UNLESS OTHERWISE INDICATED ON PLANS.

8. INDOOR EVAPORATORS ARE FED THROUGH THE OUTDOOR UNIT

1. SELECTIONS BASED ON EQUIPMENT MANUFACTURED BY TRANE. 2. CONTRACTOR SHALL SUPPLY ALL DISCONNECT SWITCHES.

4. PROVIDE TRANE PROGRAMMABLE CONTROLLER WITH BACNET INTERFACE

5. MOUNTING FRAME TYPE SHALL BE COORDINATED WITH CEILING/WALL/DUCT CONSTRUCTION TYPE. 6. REFER TO ARCHITECTS REFLECTED CEILING PLANS FOR FINAL LOCATION OF DIFFUSERS AND GRILLES

7. PROVIDE SQUARE TO ROUND NECK ADAPTERS IF REQUIRED

TABLE 2: 12x12 DIFFUSER NECK SIZE TABLE UP TO 80 CFM - 4" DIAMETER

81 TO 150 CFM - 6" DIAMETER

151 TO 250 CFM - 8" DIAMETER

TABLE 3: 630 RETURN GRILLE/REGISTER SIZE TABLE | TABLE 4: 24x24 '10' PERFORATED RETURN SIZE TABLE UP TO 80 CFM - 6x6 NECK, 8x8 FACE 81 TO 180 CFM - 8x8 NECK, 10x10 FACE 181 TO 240 CFM - 10x10 NECK, 12x12 FACE 241 TO 370 CFM - 12x12 NECK, 14x14 FACE

371 TO 475 CFM - 14x14 NECK, 16x16 FACE

UP TO 415 CFM - 10x10 NECK 416 TO 680 CFM - 14x14 NECK 681 TO 1100 CFM - 18x18 NECK 1101 TO 1650 CFM - 22x22 NECK TABLE 5: 620 SUPPLY REGISTER SIZE TABLE UP TO 125 CFM - 8x4 NECK, 10x6 FACE 126 TO 260 CFM - 12x6 NECK, 14x8 FACE 261 TO 360 CFM - 12x8 NECK, 14x10 FACE 361 TO 540 CFM - 16x10 NECK, 18x12 FACE

541 TO 710 CFM - 20x10 NECK, 22x12 FACE

651 TO 901 CFM - 15" DIAMETER TABLE 6: 630 RETURN GRILLE/REGISTER SIZE TABLE UP TO 125 CFM - 8x6 NECK, 10x8 FACE 126 TO 260 CFM - 14x8 NECK, 16x10 FACE 261 TO 360 CFM - 16x10 NECK, 18x12 FACE 361 TO 540 CFM - 18x12 NECK, 20x14 FACE 541 TO 710 CFM - 24x12 NECK, 26x14 FACE

711 TO 900 CFM - 28x14 NECK, 30x16 FACE 901 TO 1200 CFM - 40x14 NECK, 42x16 FACE

TABLE 1: 24x24 DIFFUSER NECK SIZE TABLE

UP TO 160 CFM - 6" DIAMETER

161 TO 275 CFM - 8" DIAMETER 276 TO 380 CFM - 10" DIAMETER

381 TO 500 CFM - 12" DIAMETER

501 TO 650 CFM - 14" DIAMETER

CERTIFICATE: SPIEZLE ARCHITECTURAL GROUP INC. 1395 YARDVILLE HAMILTON SQUARE ROAD HAMILTON, NJ 08691 Phone: 609-695-7400 SIGNATURE: THOMAS S. PERRINO SCOTT E. DOWNIE 21Al01505400 21Al01674400 STEVEN LEONE STEVEN G. SIEGEL 21Al01170100 21Al01564200 SPIEZLE ARCHITECTURAL GROUP, INC. 21AC00063000 SEAL:

CODE REVIEW:

P.O. BOX 628 FARMINGDALE, NJ 07727 PHONE: 732.938.2666 732.938.2521 CERTIFICATE OF AUTHORIZATION NO. 24GA28124300 PAUL RIPISH, N.J.P.E. LICENSE NUMBER 4515800 ALL DRAWINGS AND WRITTEN MATERIALS APPEARING HEREIN CONSTITUTE ORIGINAL AND UNPUBLISHED WORK OF THE ENGINEER. THE REPRODUCTION OF THIS DRAWING FOR THE PURPOSE OF COPYING THIS WORK OR REVISING SAID DRAWING SHALL BE CONSIDERED A VIOLATION OF BOTH THE PROFESSIONAL CODE OF ETHICS AND A THEFT OF COMPANY ASSETS, BOTH OF WHICH SHALL BE PROSECUTED TO THE FULLEST EXTENT OF CURRENT STATUTES.

KSI PROJECT #: 20100M\_04 90% 9/18/20

> KITCHEN **UPGRADES AND** CLASSROOM ALTERATIONS AT BRIGANTINE ELEMENTARY

BRIGANTINE OF EDUCATION

301 E Evans Brigantine, NJ 0820

DD/MM/YYYY FOR CODE REVIEW: REVISIONS: REVISION NAME DATE

FOR BID:


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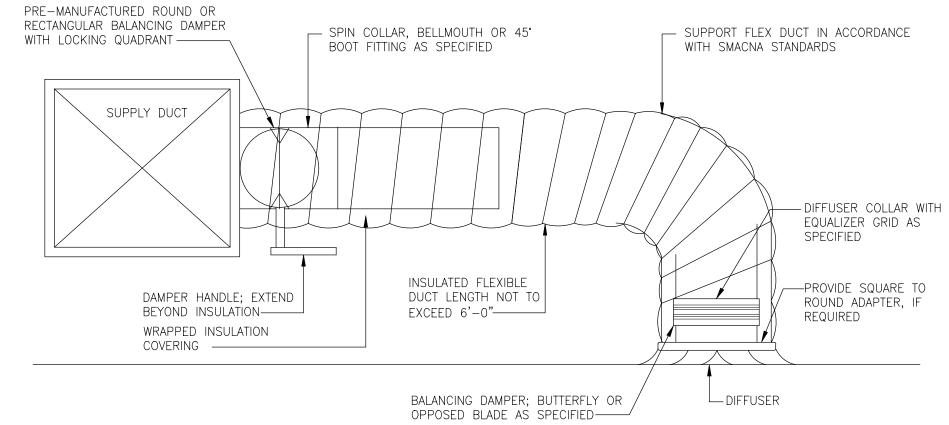
COMMISSION NUMBER:

DO NOT SCALE THE DRAWINGS

M2.1


DD/MM/YYYY DRAWING TITLE: SCHEDULES 20K009 AGENCY NUMBER:



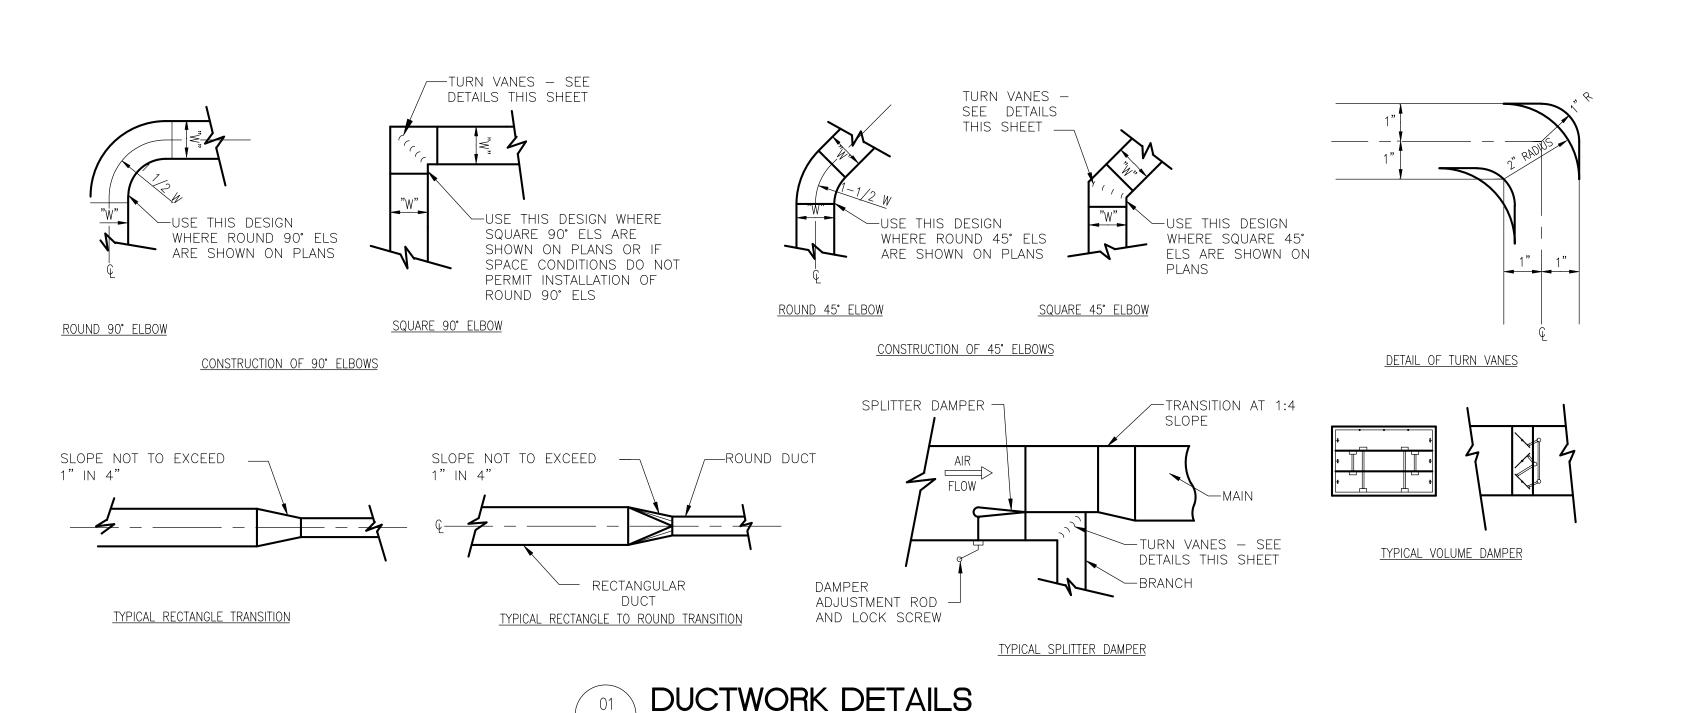

- 1. PROVIDE AT FLEXIBLE DUCT CONNECTION A METAL DRAWNBAND ON THE INTERIOR FLEXIBLE DUCT. SECURE THE INSULATION OVER THE DRAW BAND WITH AN ADDITIONAL DRAWBAND.
- 2. PROVIDE MINIMUM 2" COLLARS FOR ATTACHMENT OF THE FLEX DUCT TO ROUND DUCT, DAMPERS
- 3. BAND RIGID ROUND DUCT INSULATION TO DUCT AND PROVIDE TAPE FOR INSULATION OVERLAP.



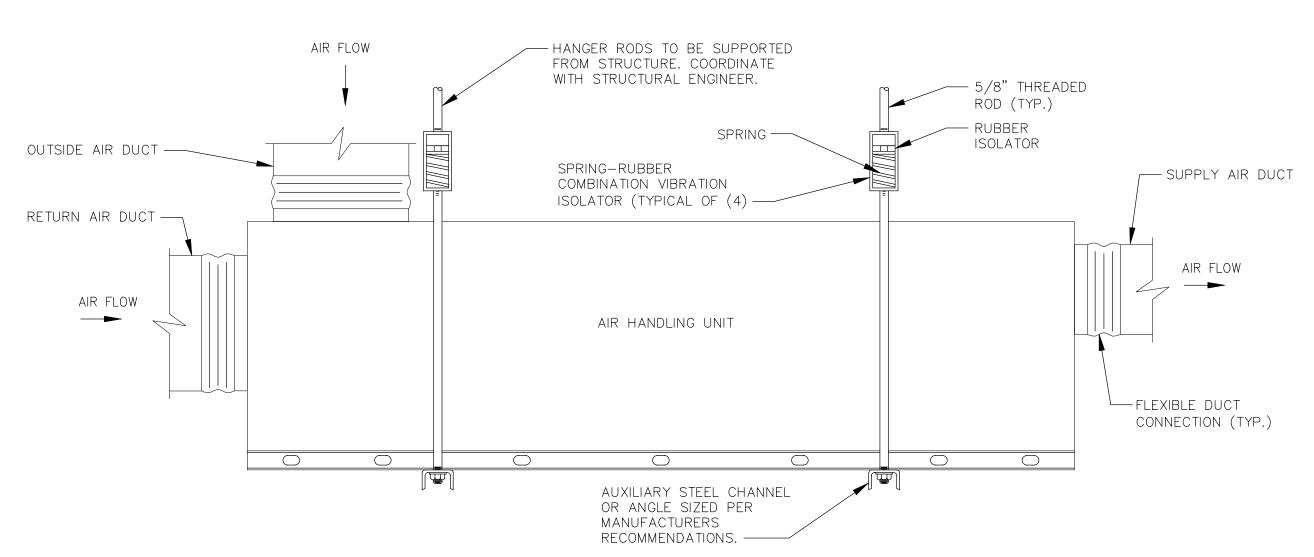


CEILING HUNG UNIT SUPPORT DETAIL


M3.1

1. COORDINATE SUPPORTING UNIT FROM STRUCTURE ABOVE WITH FIELD CONDITIONS, STRUCTURAL ENGINEER AND ARCHITECT, AS WELL AS CORRECT METHODS, SUPPORT POINT QUANTITIES & LOCATIONS AND RECOMMENDATIONS AS PER THE UNIT

- 2. PROVIDE P-TRAP FOR CONDENSATE DRAIN.
- 3. CONTRACTOR SHALL SECURE THE UNIT IN ACCORDANCE WITH LOCAL SEISMIC BUILDING CODES.
- 4. UNIT SHALL BE HORIZONTAL SUPPLY AND RETURN AIR DUCTED WITH OUTSIDE AIR FILTER MIXING BOX.
- 5. UNIT SHALL BE HORIZONTAL SUPPLY AND RETURN DUCTED.
- 6. SEE FLOOR PLANS, DETAILS AND SPECIFICATIONS FOR PIPING REQUIREMENTS.

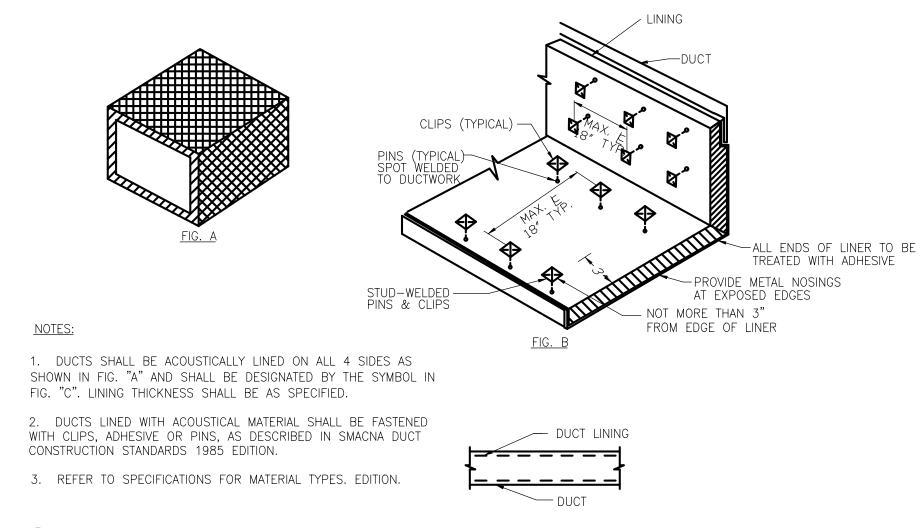


ACOUSTICAL TREATMENT - DUCT LINING DETAIL

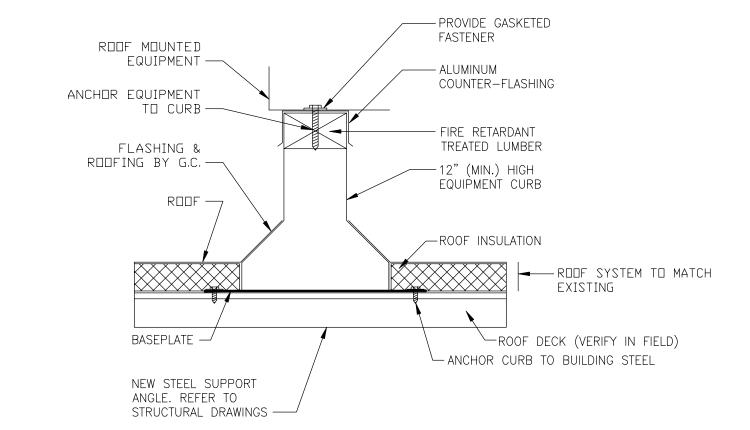


THE CONTRACTOR SHALL BE RESPONSIBLE TO REMOVE THE EXISTING ROOFING WHERE THE NEW EQUIPMENT CURBS ARE TO BE SET. AFTER INSTALLATION OF THE EQUIPMENT CURBS, PROVIDE NEW ROOF FLASHING AND COUNTER FLASHING. IF THE ROOF HAS VALID WARRANTY, THEN THE CONTRACTOR SHALL HIRE THE SERVICES OF THE OWNER'S CERTIFIED ROOFING CONTRACTOR TO PERFORM ALL WORK OF INSTALLING CURBS NOT TO VOID THE ROOF GUARANTEES (COORDINATE WITH OWNER).



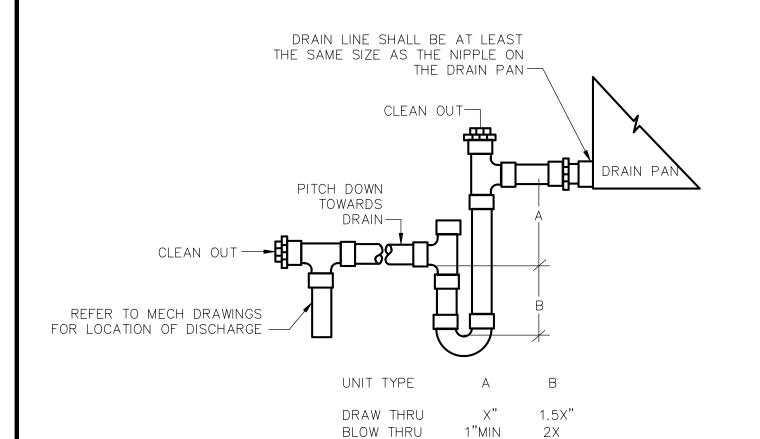




	RECTAI	NGULAR D	DUCT HAN	IGER SCH	EDULE (N	MINIMUM S	SIZES)	
HALF DUCT	PAIR AT 10	)' SPACING	PAIR AT 8	' SPACING	PAIR AT 5	' SPACING	PAIR AT	4' SPACING
PERIMETER RANGE	STRAP	WIRE/ROD	STRAP	WIRE/ROD	STRAP	WIRE/ROD	STRAP	WIRE/ROD
P/2 < 30'	1"x 22 GA.	10 GA. (0.135")	1"x 22 GA.	10 GA. (0.135")	1"x 22 GA.	12 GA. (0.106")	1"x 22 GA.	12 GA. (0.106")
P/2 < 72"	1"x 18 GA.	3/8"	1"x 20 GA.	1/4"	1"x 22 GA.	1/4"	1"x 22 GA.	1/4"
P/2 < 96"	1"x 16 GA.	3/8"	1"x 18 GA.	3/8"	1"x 20 GA.	3/8"	1"x 22 GA.	1/4"
P/2 < 120"	1-1/2"x 16 GA.	1/2"	1"x 16 GA.	3/8"	1"x 18 GA.	3/8"	1"x 20 GA.	1/4"
P/2 < 168"	1-1/2"x 16 GA.	1/2"	1"x 16 GA.	1/2"	1"x 16 GA.	3/8"	1"x 18 GA.	3/8"
P/2 < 192"	_	1/2"	1−1/2"x 16 GA.	1/2"	1"x 16 GA.	3/8"	1"x 16 GA.	3/8"

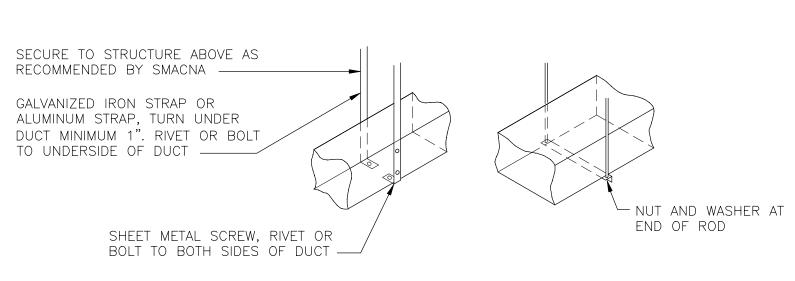




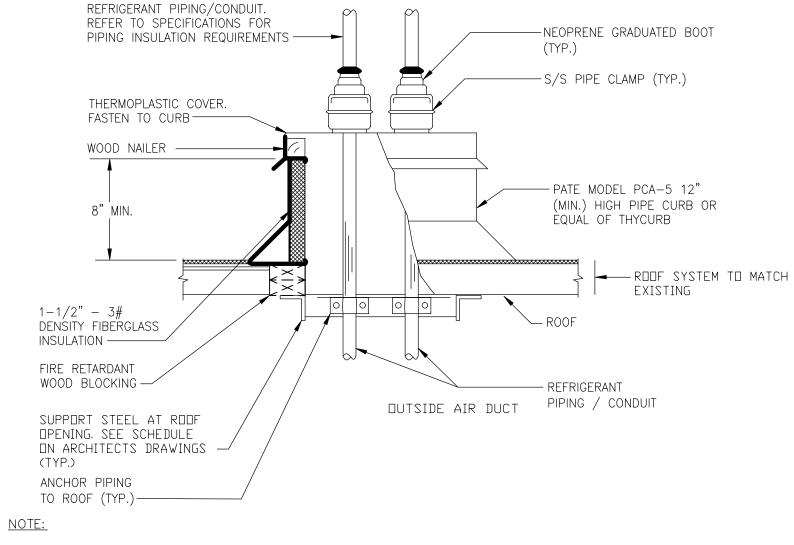

1. CONTRACTOR SHALL HIRE THE SERVICES OF THE PROJECT ROOFING CONTRACTOR TO PERFORM ALL ROOFING WORK (FLASHING, COUNTER FLASHING, INSULATION CUTTING, ETC.) ASSOCIATED WITH INSTALLING EQUIPMENT CURBS NOT TO VOID WARRANTEES. CONTRACTOR SHALL COORDINATE WITH G.C. / ROOFING



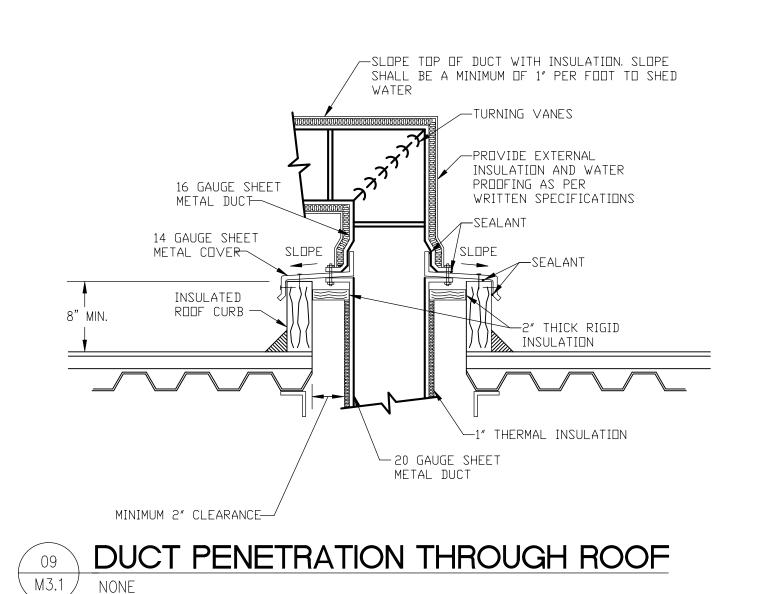



CODE REVIEW:

HAMILTON, NJ 08691 Phone: 609-695-7400

SIGNATURE: THOMAS S. PERRINO SCOTT E. DOWNIE 21Al01505400 21Al01674400 STEVEN LEONE STEVEN G. SIEGEL 21Al01564200 SPIEZLE ARCHITECTURAL GROUP, INC. 21AC00063000

SEAL:

CONSULTANTS: KSI CONSULTING ENGINEERS, LLC P.O. BOX 628 FARMINGDALE, NJ 07727 PHONE: 732.938.2666 732.938.2521 CERTIFICATE OF AUTHORIZATION NO. 24GA28124300 PAUL RIPISH, N.J.P.E. LICENSE NUMBER 4515800

ALL DRAWINGS AND WRITTEN MATERIALS APPEARING HEREIN CONSTITUTE ORIGINAL AND UNPUBLISHED WORK OF THE ENGINEER. THE REPRODUCTION OF THIS DRAWING FOR THE PURPOSE OF COPYING THIS WORK OR REVISING SAID DRAWING SHALL BE CONSIDERED A VIOLATION OF BOTH THE PROFESSIONAL CODE OF ETHICS AND A THEFT OF COMPANY ASSETS, BOTH OF WHICH SHALL BE PROSECUTED TO THE FULLEST EXTENT OF CURRENT STATUTES.

KSI PROJECT #: 20100M\_04 90% 9/18/20

PROJECT:

KITCHEN **UPGRADES AND** CLASSROOM ALTERATIONS AT BRIGANTINE **ELEMENTARY** 

BRIGANTINE OF EDUCATION

301 E Evans Brigantine, NJ 0820

DD/MM/YYYY FOR CODE REVIEW: **REVISIONS:** REVISION NAME DATE

FOR BID: DD/MM/YYYY

DRAWING TITLE: **MECHANICAL** DETAILS

COMMISSION NUMBER: 20K009


AGENCY NUMBER:

DO NOT SCALE THE DRAWINGS DRAWING NUMBER:

M3.1

- 1. PROVIDE AIR VENTS ON ALL HIGH POINTS AND / OR WHERE AIR CAN BE TRAPPED IN PIPING.
- 2. ALL PIPING TO BE THROUGH BOTTOM OF THE UNIT.
- 3. SEE FLOOR PLANS FOR PIPING SIZES
- 4. PROVIDE COIL FREEZE PROTECTION WITH FREEZESTAT INTERLOCKED WITH CONTROL VALVE. SEE SPECIFICATIONS AND DIAGRAMS FOR MORE DETAILS.
- 5. PROVIDE SWING JOINT PIPING CONNECTION TO COIL WITH MINIMUM OF 3 BENDS.


HOT/CHILLED WATER COIL W/ 2-WAY CONTROL VALVE PIPING DETAIL

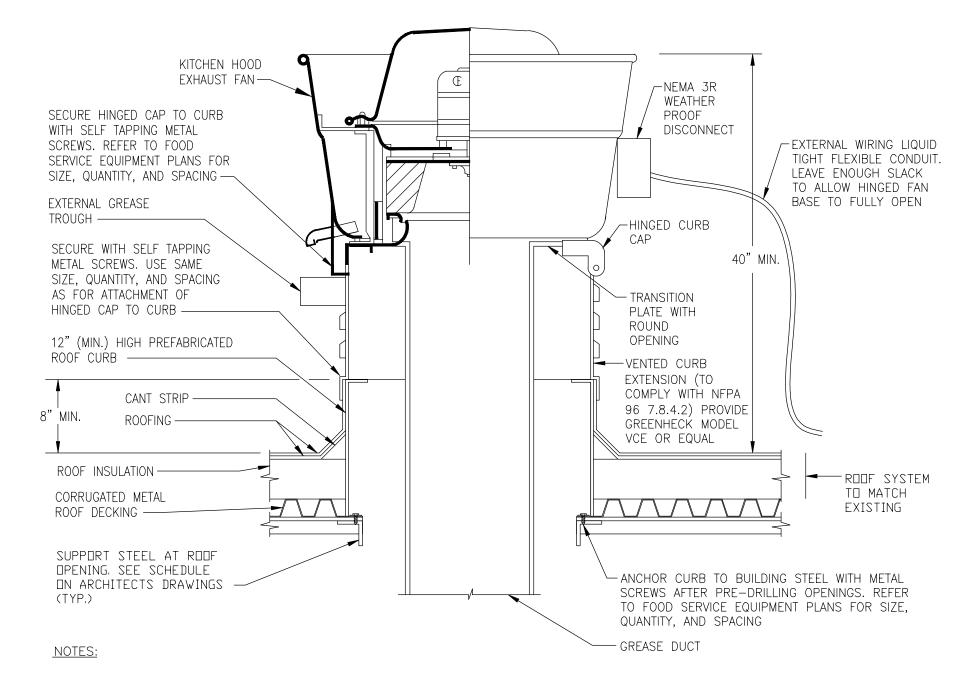

1. THE CONTRACTOR SHALL BE RESPONSIBLE TO REMOVE THE EXISTING ROOFING WHERE THE NEW EQUIPMENT CURBS ARE TO BE SET AND WHERE NEW PIPING PENETRATIONS THROUGH THE ROOF OCCUR, THE CONTRACTOR SHALL BE RESPONSIBLE TO CUT NEW ROOF OPENINGS FOR NEW PIPING, ETC. AFTER INSTALLATION OF THE DUCT AND EQUIPMENT CURBS, PROVIDE NEW ROOF FLASHING AND COUNTER FLASHING. IF THE ROOF HAS VALID WARRANTY, THE CONTRACTOR SHALL HIRE THE SERVICES OF A CERTIFIED ROOFING CONTRACTOR TO INSTALL ALL CURBS AND DUCT PENETRATIONS SO NOT TO VOID THE ROOF GUARANTEES. COORDINATE WITH THE OWNER AND THE ARCHITECT. THE PIPING SHALL BE INSTALLED TO PROVIDE ADEQUATE CLEARANCE BELOW PIPING FOR FUTURE


RE-ROOFING OPERATIONS.

# COOKING HOOD EXHAUST FAN DETAIL NONE

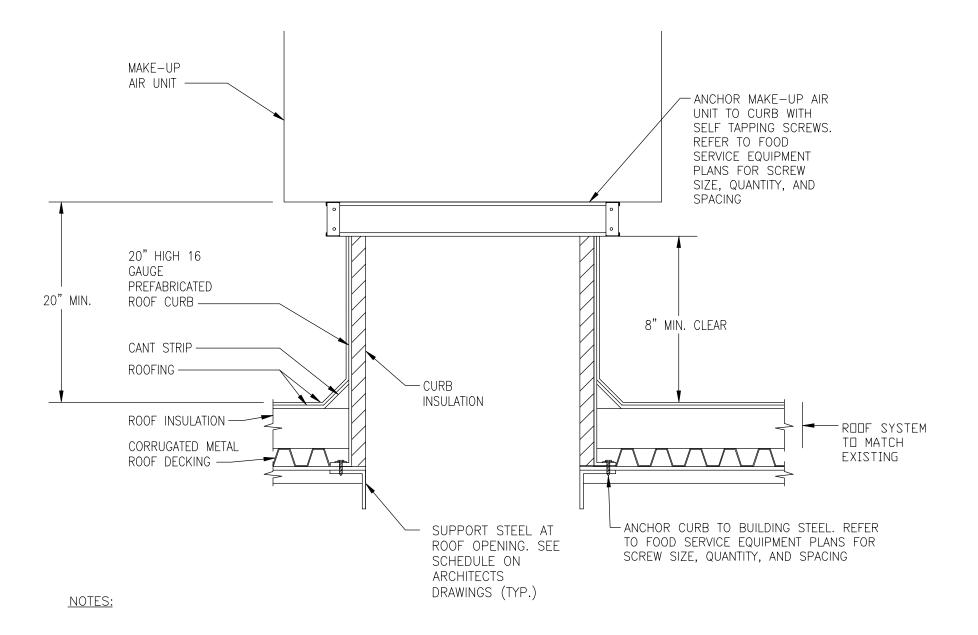


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## MAKE-UP AIR UNIT ROOF CURB



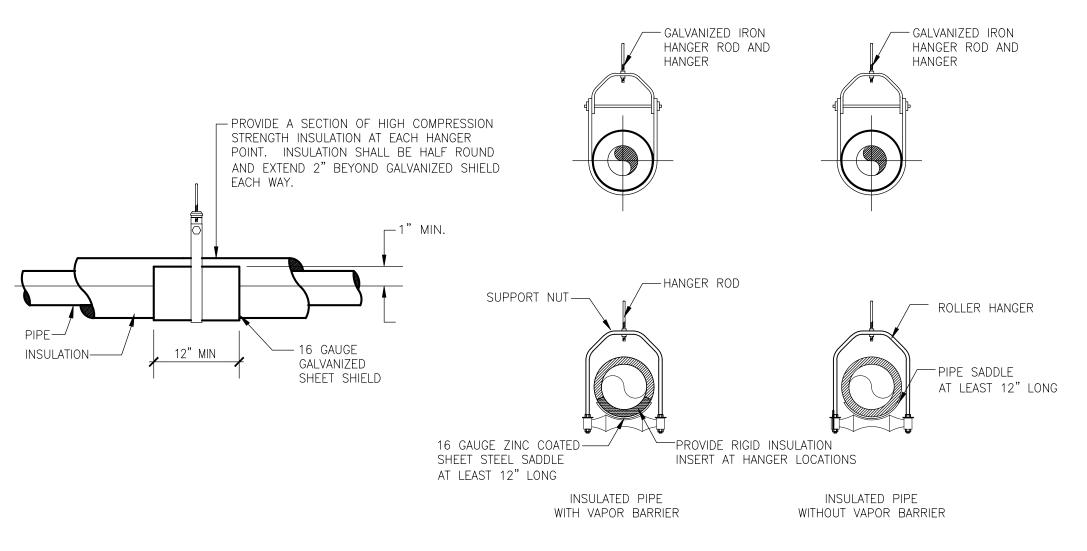

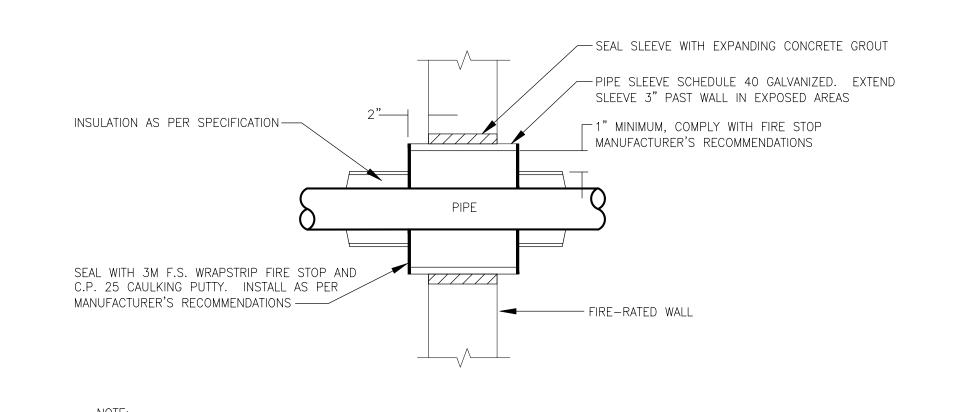

PIPE PENETRATION THROUGH FIRE-RATED WALL

1. DETAIL SHALL BE APPLIED TO ALL NEW, CORRIDOR WALL PIPING PENETRATIONS AND EXISTING WHICH ARE DAMAGED DURING CONSTRUCTION.

#### -1/2" THREADED ROD (TYP.) HANGER RODS TO BE SUPPORTED FROM STRUCTURE -CONDENSATE DRAIN CONNECTION LIQUID AND SUCTION - OPTIONAL OUTDOOR AIR REFRIGERANT PIPING DUCT CONNECTION CONNECTIONS — OPTIONAL SUPPLY AIR — SUSPENDED CEILING DUCT CONNECTION ----TILE (TYP.) "CEILING CASSETTE" AC UNIT ELASTOMER VIBRATION - SUSPENDED CEILING ISOLATOR —— GRID FRAME SUSPENDED CEILING FACTORY ARCHITECTURAL COMBINATION SUPPLY AIR DISCHARGE AND RETURN SUPPLY AIR FLOW AIR INTAKE GRILLE (TYP.) SUPPLY AIR FLOW SUPPLY AIR FLOW SUPPLY AIR FLOW RETURN AIR FLOW <u>SIDE VIEW</u>


PIPE HANGER DETAIL

- 1. COORDINATE SUPPORTING UNIT FROM STRUCTURE ABOVE WITH FIELD CONDITIONS, STRUCTURAL ENGINEER AND ARCHITECT, AS WELL AS CORRECT METHODS AND RECOMMENDATIONS AS PER THE UNIT MANUFACTURER. 2. PROVIDE P-TRAP FOR CONDENSATE DRAIN.
- 4. UNIT SHALL BE PROVIDED WITH FACTORY INTEGRAL CONDENSATE PUMP (33" LIFT MINIMUM). 5 UNIT SHALL BE 4-WAY BLOW WITH AUTOMATIC MODULATING ADJUSTABLE AIR DISCHARGE VANES.

CONTRACTOR SHALL SECURE THE UNIT IN ACCORDANCE WITH LOCAL SEISMIC BUILDING CODES.

- 6. SIZE AND INSTALL ALL REFRIGERANT PIPING AND PROVIDE QUANTITIES AS PER THE MANUFACTURER'S RECOMMENDATIONS (QUANTITIES SHOWN ARE FOR DIAGRAMMATIC PURPOSES). INSULATE AS PER SPECIFICATIONS.
- 7. UNIT SHALL BE CENTERED IN CEILING GRID TILES AND COORDINATED WITH CEILING MOUNTED COMPONENTS / DEVICES SUCH AS LIGHTS, SMOKE/HEAT DETECTORS, OCCUPANCY SENSORS, SPRINKLER HEADS, ETC. WHERE UNITS CAN NOT BE
- CENTERED, COORDINATE WITH THE ARCHITECT AND ENGINEER PRIOR TO INSTALLING. 8. UNIT SHALL HAVE INTEGRAL OCCUPANCY MOTION DETECTOR OPTION TO ALLOW FOR UNIT SHUT-DOWN AND SPACE TEMPERATURE SET-BACK MAINTAINING.




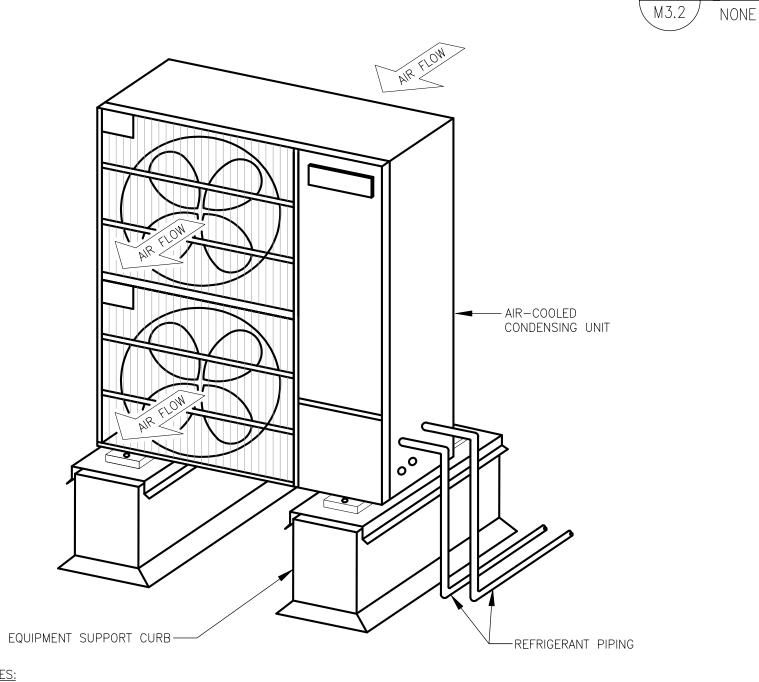


#### NOTES: 1. CONTRACTOR SHALL SECURE THE UNIT IN ACCORDANCE WITH LOCAL SEISMIC BUILDING CODES.

- 2. PROVIDE REDUCERS/INCREASERS AS REQUIRED FOR CORRECT CONNECTION TO UNIT.
- 3. SIZE AND INSTALL ALL REFRIGERANT PIPING AND PROVIDE QUANTITIES AS PER THE MANUFACTURER'S RECOMMENDATIONS (QUANTITIES SHOWN ARE FOR DIAGRAMMATIC PURPOSES).
- 4. THE CONTRACTOR SHALL BE RESPONSIBLE TO REMOVE THE EXISTING ROOFING WHERE THE NEW EQUIPMENT CURBS ARE TO BE SET. AFTER INSTALLATION OF THE EQUIPMENT CURBS, PROVIDE NEW ROOF FLASHING AND COUNTER FLASHING. IF THE ROOF HAS VALID WARRANTY, THEN THE CONTRACTOR SHALL HIRE THE SERVICES OF THE OWNER'S CERTIFIED ROOFING CONTRACTOR TO PERFORM ALL WORK OF INSTALLING CURBS NOT TO VOID THE ROOF GUARANTEES (COORDINATE WITH OWNER).



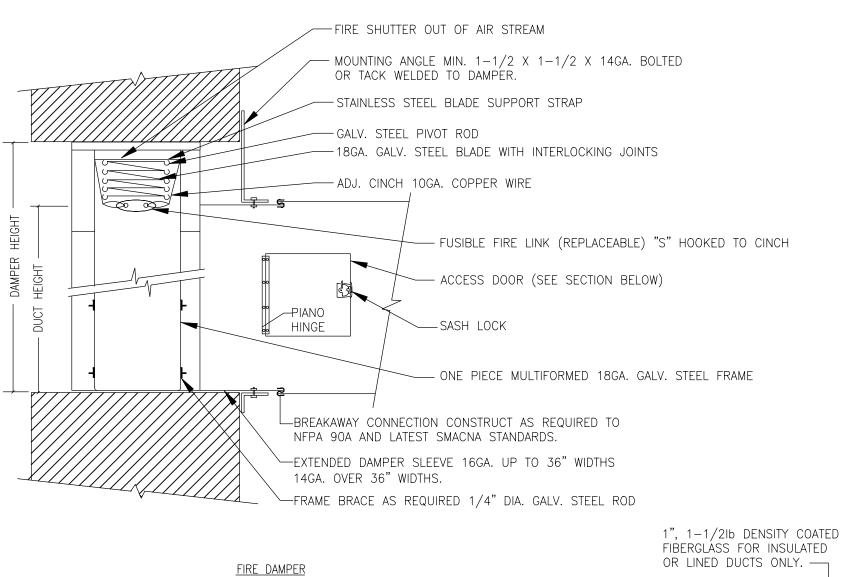

NOTE: 1. VERTICAL INSTALLATION SHOWN. HORIZONTAL INSTALLATION IS SIMILAR.

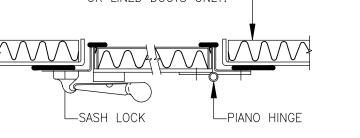

ACCESS DOOR



CERTIFICATE:

CODE REVIEW:

SPIEZLE ARCHITECTURAL GROUP INC. 1395 YARDVILLE HAMILTON SQUARE ROAD SUITE 2 A HAMILTON, NJ 08691 Phone: 609-695-7400

21Al01505400

21Al01674400

21Al01170100

21Al01564200

21AC00063000

SIGNATURE: THOMAS S. PERRINO SCOTT E. DOWNIE STEVEN LEONE STEVEN G. SIEGEL SPIEZLE ARCHITECTURAL GROUP, INC.

SEAL:

CONSULTANTS: KSI CONSULTING ENGINEERS, LL P.O. BOX 628 FARMINGDALE, NJ 07727 732.938.2666 PHONE: 732.938.2521 CERTIFICATE OF AUTHORIZATION NO. 24GA28124300 PAUL RIPISH, N.J.P.E. LICENSE NUMBER 4515800 ALL DRAWINGS AND WRITTEN MATERIALS APPEARING HEREIN CONSTITUTE ORIGINAL AND UNPUBLISHED WORK OF THE ENGINEER. THE REPRODUCTION OF THIS DRAWING FOR THE PURPOSE OF COPYING THIS WORK OR REVISING SAID DRAWING SHALL BE CONSIDERED A VIOLATION OF BOTH THE PROFESSIONAL CODE OF ETHICS AND A THEFT OF COMPANY ASSETS, BOTH OF WHICH SHALL BE PROSECUTED TO THE FULLEST EXTENT OF CURRENT STATUTES.

KSI PROJECT #: 20100M\_04 90% 9/18/20

PROJECT:

KITCHEN **UPGRADES AND** CLASSROOM **ALTERATIONS AT** BRIGANTINE **ELEMENTARY** 

BRIGANTINE OF EDUCATION

301 E Evans Brigantine, NJ 0820

DD/MM/YYYY FOR CODE REVIEW: **REVISIONS:** REVISION NAME DATE

FOR BID: DD/MM/YYYY

DRAWING TITLE: **MECHANICAL DETAILS** 

COMMISSION NUMBER: 20K009

AGENCY NUMBER:

DO NOT SCALE THE DRAWINGS DRAWING NUMBER:

M3.2



CODE REVIEW:

spiezle

SPIEZLE ARCHITECTURAL GROUP INC. 1395 YARDVILLE HAMILTON SQUARE ROAD SUITE 2 A HAMILTON, NJ 0869 I Phone: 609-695-7400

> 21 Al01505400 21 Al01674400 21 Al01170100 21 Al01564200 21 AC00063000

SIGNATURE:
THOMAS S. PERRINO
SCOTT E DOWNIE
STEVEN LEONE
STEVEN G. SIEGEL
SPIEZLE ARCHITECTURAL GROUP, INC.

SEAL:

KSI CONSULTING ENGINEERS, LLC
P.O. BOX 628 FARMINGDALE, NJ 07727
PHONE: 732.938.2666
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DATE: KSI PROJECT #: 20100M\_04

90% 9/18/20

90 /0 9/10/2 PROJECT:

KITCHEN
UPGRADES AND
CLASSROOM
ALTERATIONS AT
BRIGANTINE
ELEMENTARY

BRIGANTINE OF EDUCATION

FOR

301 E Evans Brigantine, NJ 0820

FOR CODE REVIEW: DD/MM/YYYY

REVISIONS:

REVISION NAME DATE

FOR BID:

DRAWING TITLE:

DD/MM/YYYY

MECHANICAL DETAILS

COMMISSION NUMBER:

20K009

AGENCY NUMBER:

DO NOT SCALE THE DRAWINGS
DRAWING
NUMBER:

M3.3


THIS DRAWING IS FORMATTED TO BE PRINTED AT 30"x42"

<i>I</i> . 1	OPTIO1	M C	
FAN FAN UNIT NO	TAG	QTY	DESCRIPTION
		1	GREASE BOX.
1	KEF-1	1	MIAMI DADE CERTIFICATION - NOA-1 ALUMINUM UPBLAST.
		1	LOAD REACTOR MOUNTED IN FAN.
		1	STANDARD ELECTRICAL CONNECTION (MAIN AND CONTROL PANEL) FOR STANDING POWER - SINGLE MODULE. IF A NON-DCV PREWIRE IS USED ON THE IBT HEATER, THE #28, #47, "NS", "MA", OR "E2" OPTION PREWIRE MUST BE SELECTED. DO NOT PROVIDE SUPPLY STARTER IN PREWIRE.
		1	MOTORIZED BACKDRAFT DAMPER FOR A2-I HOUSING.
		1	INLET PRESSURE GAUGE, 0-35".
2	MUA-1	1	MANIFOLD PRESSURE GAUGE, 0 TO 10" WC, 1 FURNACE.
		1	IBT SIZE 1 & 2 SIDE DISCHARGE.
		1	MIAMI DADE CERTIFICATION - NOA-2 SUPPLY.
		1	FREEZESTAT.
		1	SEPARATE 120V WIRING PACKAGE (REQUIRED AND USED ONLY FOR DCV OR PREWIRE WITH VFD) — THREE PHASE ONLY.
		1	LOAD REACTOR MOUNTED IN FAN.

CURB ASSEMBLIES

NO	□N FAN	TAG	WEIGHT	ITEM	SIZE
1	# 1	KEF-1	76 LBS	CURB	31.500"W X 31.500"L X 24.000"H RIGHT VENTED HINGED 16 GAUGE.
2	# 2	MUA-1	126 LBS	CURB	31.000"W X 97.188"L X 20.000"H RIGHT INSULATED 16 GAUGE.

#### FAN #1 DU240HFA - EXHAUST FAN (KEF-1)

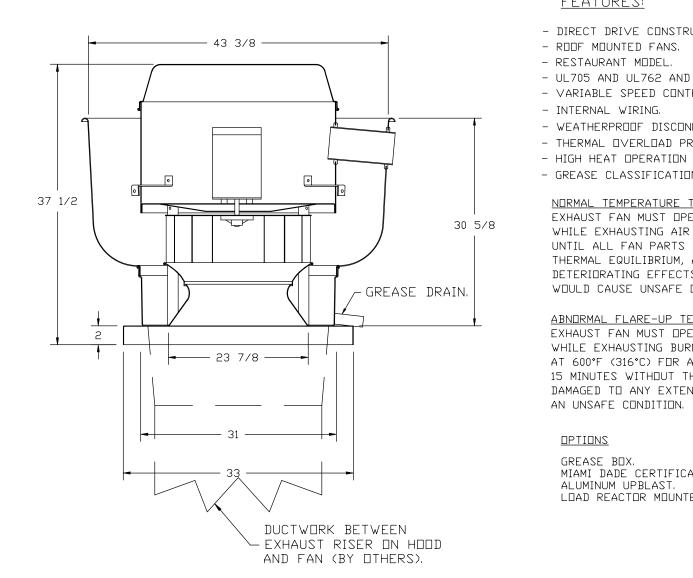

#### <u>FEATURES:</u>


- INTERNAL WIRING.


- DIRECT DRIVE CONSTRUCTION (NO BELTS/PULLEYS).
- ROOF MOUNTED FANS. - RESTAURANT MODEL.
- UL705 AND UL762 AND ULC-S645 - VARIABLE SPEED CONTROL.
- WEATHERPROOF DISCONNECT. - THERMAL OVERLOAD PROTECTION (SINGLE PHASE). - HIGH HEAT OPERATION 300°F (149°C). - GREASE CLASSIFICATION TESTING
- NORMAL TEMPERATURE TEST EXHAUST FAN MUST OPERATE CONTINUOUSLY WHILE EXHAUSTING AIR AT 300°F (149°C) UNTIL ALL FAN PARTS HAVE REACHED THERMAL EQUILIBRIUM, AND WITHOUT ANY

DETERIORATING EFFECTS TO THE FAN WHICH

WOULD CAUSE UNSAFE OPERATION.

- ABNORMAL FLARE-UP TEST EXHAUST FAN MUST OPERATE CONTINUOUSLY WHILE EXHAUSTING BURNING GREASE VAPORS AT 600°F (316°C) FOR A PERIOD OF 15 MINUTES WITHOUT THE FAN BECOMING DAMAGED TO ANY EXTENT THAT COULD CAUSE
- GREASE BOX. MIAMI DADE CERTIFICATION - NOA-1 ALUMINUM UPBLAST. LOAD REACTOR MOUNTED IN FAN.

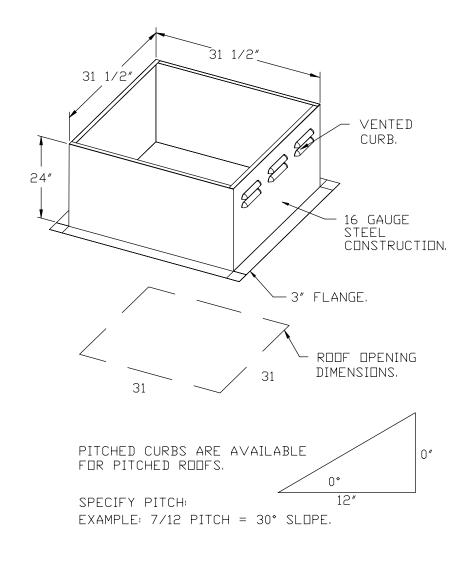

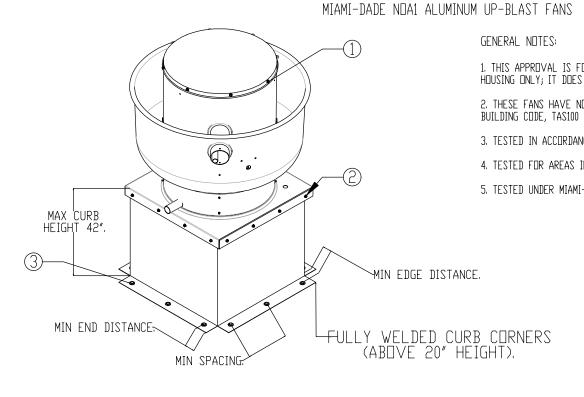

N/A


N/A

PENETRATION

MINIMUM EDGE

DISTANCE MINIMUM END

DISTANCE

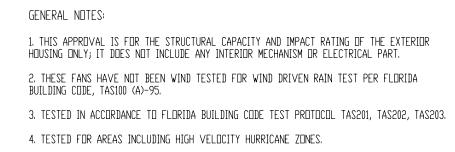

- 5. TESTED UNDER MIAMI-DADE COUNTY NOTIFICATION NUMBER ATI-08033.
  - 1. SECURE LID TO FAN USING (8)

    1./4"-14 X 1" ZINC PLATED STEEL SELF
    DRILLING SHEET METAL SCREWS WITH
    RUBBER WASHER SPACED EVENLY

3"

CURB MATERIAL: DESIGN PRESSURE: +150.0 / -150.0 PSF. 20" HIGH & LESS = 20 GA. STEEL. LARGE MISSILE IMPACT RESISTANT. ABOVE 20" THRU 42" = 16 GA. STEEL. **INSTALLATION FASTENER TYPES** CONCRETE (2500 PSI WOOD (SG = 0.42 STEEL (12 GAUGE MIN.) **FAN TO CURB** MIN. CRACKED CONCRETE) 5/16"-18 X 2" SELF 3/8" DIA. SS HILTI 3/8" DIA. ZINC 1/4"-14 DRIL-FLEX SELF DRILLING SCREW (ELCO DRIL-FLEX OR BETTER) **FASTENER** KWIK BOLT TZ PLATED LAG BOLT DRILLING SCREW EXPANSION ANCHOR MINIMUM THREAD 2-1/2" 12 GAUGE


	MINIMUM S	PACING		N/A 1-1/2" 3/4"										5-1/2"					
						IN	ISTALLAT	ION FASTE	NER QTY										
		CURB TO (ROOF		CURB TO (WALL)		WOOD (	ROOF)	WOOD (	WALL)	STEEL (R	OOF)	STEEL (V	VALL)	CONC (ROC		CONC (WAI			
FAN	N MODEL	PER SIDE	TOTAL	PER SIDE	TOTAL	PER SIDE	TOTAL	PER SIDE	TOTAL	PER SIDE	TOTAL	PER SIDE	TOTAL	PER SIDE	TOTAL	PER SIDE	тот		
I	DU240	3 12		3	12	6	24	6	24	7	28	7	28	6	24	6	2,		

1-1/2"

2-5/8"

3/8"

3/8"

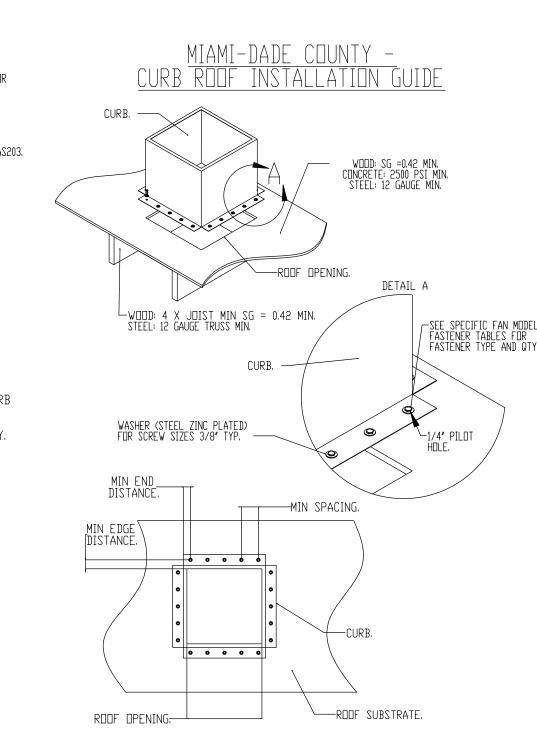

Exhaust Fan Wiring	J□B	4460207 - Br	~iga		
DRAWING NUMBER EXH4460207-1	SHIP DATE	8/14/2020	MODEL	DU240HFA	
	•		•		<u>Installed Options</u>
.BK				LR-02 BK \1 \ \2	<u>Component Identification</u> <u>Label Description</u> Locat
OBK			_	B1 B2 MT-01 GR	LR-XX Line/Load Reactor [3]
○ <u>GR</u> — — — — <u>÷</u>				₹	MT-01 Fan Motor [3]
					SW-01 Main disconnect switch [3]
					MOTOR INFO
					EXHAUST 5HP-460V-3P-7.0FLA
					ELECTRICAL INFORMATION
					FLECTRICAL INFORMATION MOTOR/CTRL MCA: 8.8A MOTOR/CTRL MOP: 15A
					NOTES DENOTES FIELD WIRING - DENOTES INTERNAL WIRING
					<u>WIRE COLOR</u>
					BK – BLACK YW – YELLOW BL – BLUE GR – GREEN BR – BROWN GY – GRAY

CERTIFICATE:

CODE REVIEW:



SPIEZLE ARCHITECTURAL GROUP INC. 1395 YARDVILLE HAMILTON SQUARE ROAD SUITE 2 A HAMILTON, NJ 08691 Phone: 609-695-7400

21Al01505400

21Al01674400

21 Al01170100 21 Al01564200

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KSI PROJECT #: 20100M\_04

90% 9/18/20

PROJECT:

KITCHEN **UPGRADES AND** CLASSROOM ALTERATIONS AT BRIGANTINE ELEMENTARY

BRIGANTINE OF EDUCATION

301 E Evans Brigantine, NJ 0820

FOR CODE REVIEW: DD/MM/YYYY REVISIONS: DATE REVISION NAME

FOR BID:

DD/MM/YYYY

DRAWING TITLE:

MECHANICAL DETAILS FOR KITCHEN EXHAUST FAN (KEF-1)

COMMISSION NUMBER: 20K009

AGENCY NUMBER:

DO NOT SCALE THE DRAWINGS

M3.4


3. SIDE DISCHARGE - AIR FLOW RIGHT -> LEFT. 3. SIDE DISCHARGE - AIR FLUW RIGHT -> LEFT.
4. SEPARATE 120V ELECTRICAL CONNECTION FOR ALL IBT HEATERS WITH 1 MODULE FOR STANDING POWER. 120V MUST BE RUN BY ELECTRICIAN FROM BUILDING PANEL TO MUA SWITCH.
5. MOTORIZED BACK DRAFT DAMPER 22.75" X 24" FOR SIZE 2 STANDARD & MODULAR HEATER UNITS W/EXTENDED SHAFT, STANDARD GALVANIZED CONSTRUCTION, 3/4" REAR FLANGE, LOW LEAKAGE, LF120S ACTUATOR INCLUDED.
6. GAS PRESSURE GAUGE, 0-35", 2.5" DIAMETER, 1/4" THREAD SIZE.
7. GAS PRESSURE GAUGE, 0 TO +10 INCHES WC., 2.5" DIAMETER, 1/8" THREAD SIZE, REAR THREAD.
8. USED WITH SIZE 1 AND SIZE 2 SIDE DISCHARGE IBT MODULES.
9 MIAMI DADE IMPACT AND WIND LOAD CERTIFICATION +30 / -130 PSF - MIAMI DADE COUNTY PRODUCT CONTROL APPROVED.

9. MIAMI DADE IMPACT AND WIND LOAD CERTIFICATION +30 / -130 PSF - MIAMI DADE COUNTY PRODUCT CONTROL APPROVED. FLORIDA BUILDING CODE APPROVAL. ROOF MOUNT EXHAUST CURBS UP TO 20" HIGH MUST BE 16 GAUGE ALUMINIZED. 10. Freezestat Factory set at 35°F and 10 minutes.


11. SEPARATE 120VAC WIRING PACKAGE FOR MAKE-UP AIR UNITS. OPTION MUST BE SELECTED WHEN MOUNTING VFD IN PREWIRE PANEL OR WITH DCV PACKAGE. PROVIDES SEPARATE 120VAC INPUT TO SUPPLY FAN. THIS 120V SIGNAL MUST BE RUN BY ELECTRICIAN FROM DCV TO MUA SWITCH.


12. MOUNT LOAD REACTOR IN FAN.
IBT - US PATENT 877119 B2.

\*NOTE: SUPPLY DUCT MUST BE INSTALLED TO MEET SMACNA STANDARDS. A MINIMUM STRAIGHT DUCT LENGTH MUST BE MAINTAINED DOWNSTREAM OF UNIT DISCHARGE AS OUTLINED IN AMCA PUBLICATION 201, WHEN USING RECTANGULAR DUCTWORK, ELBOWS MUST BE RADIUS THROAT, RADIUS BACK WITH TURNING VANES. FLEXIBLE DUCTWORK AND SQUARE THROAT/SQUARE BACK ELBOWS SHOULD NOT BE USED, ANY TRANSITION AND/OR TURNS IN THE DUCTWORK WILL CAUSE SYSTEM EFFECT. SYSTEM EFFECT WILL DRASTICALLY INCREASE STATIC PRESSURE AND REDUCE AIRFLOW, DO NOT RELY ON UNIT TO SUPPORT DUCT IN ANY WAY, FAILURE TO PROPERLY SIZE DUCTWORK MAY CAUSE SYSTEM EFFECTS AND REDUCE PERFORMANCE OF THE EQUIPMENT. SUGGESTED STRAIGHT DUCT SIZE IS 20" × 20".

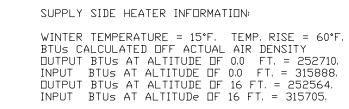





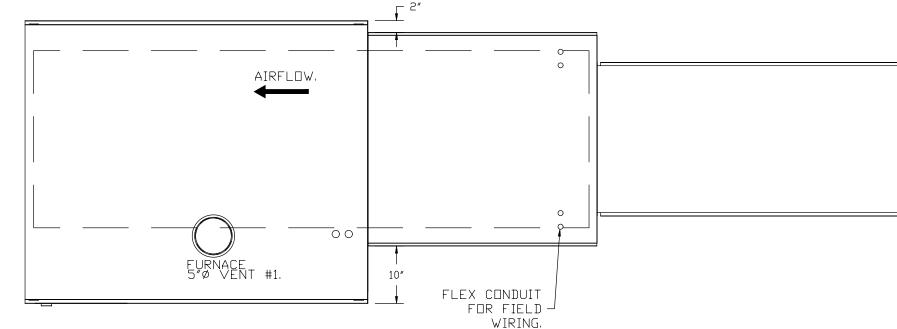

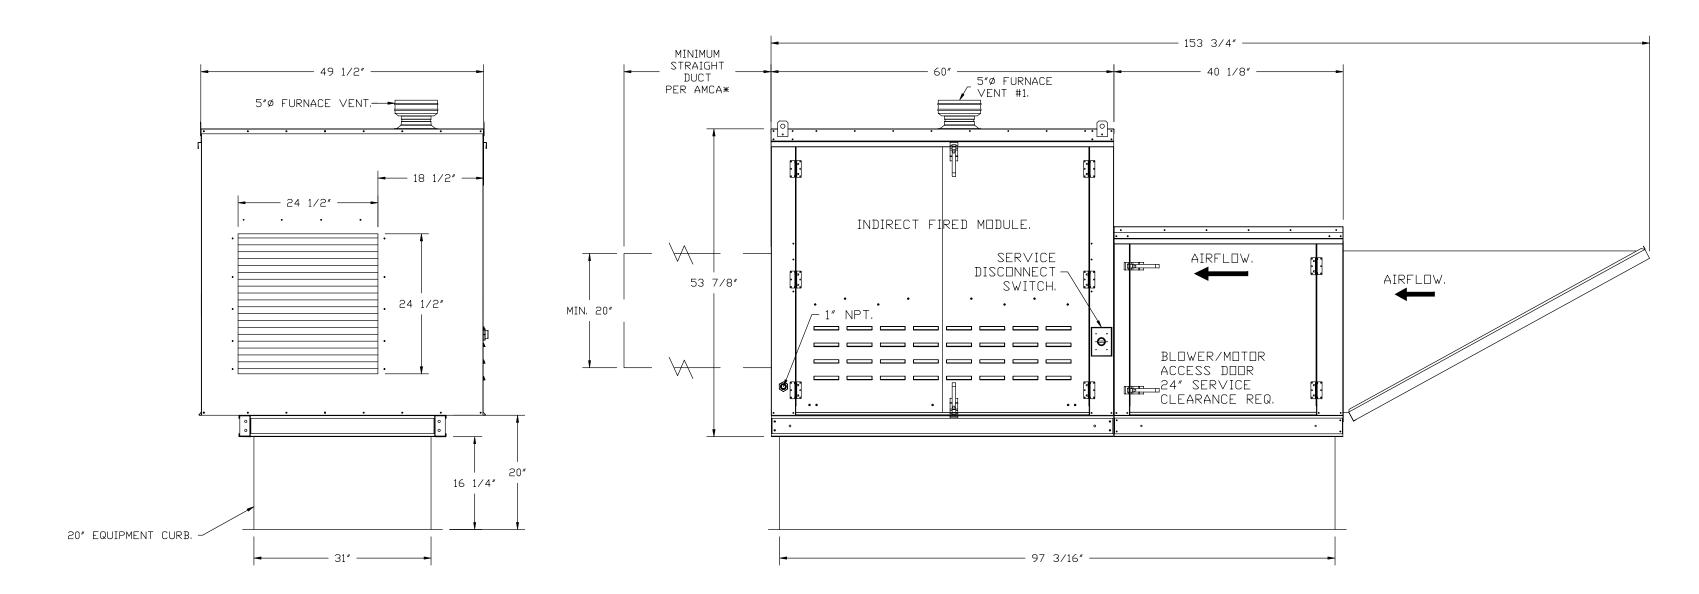


Installation Wiring

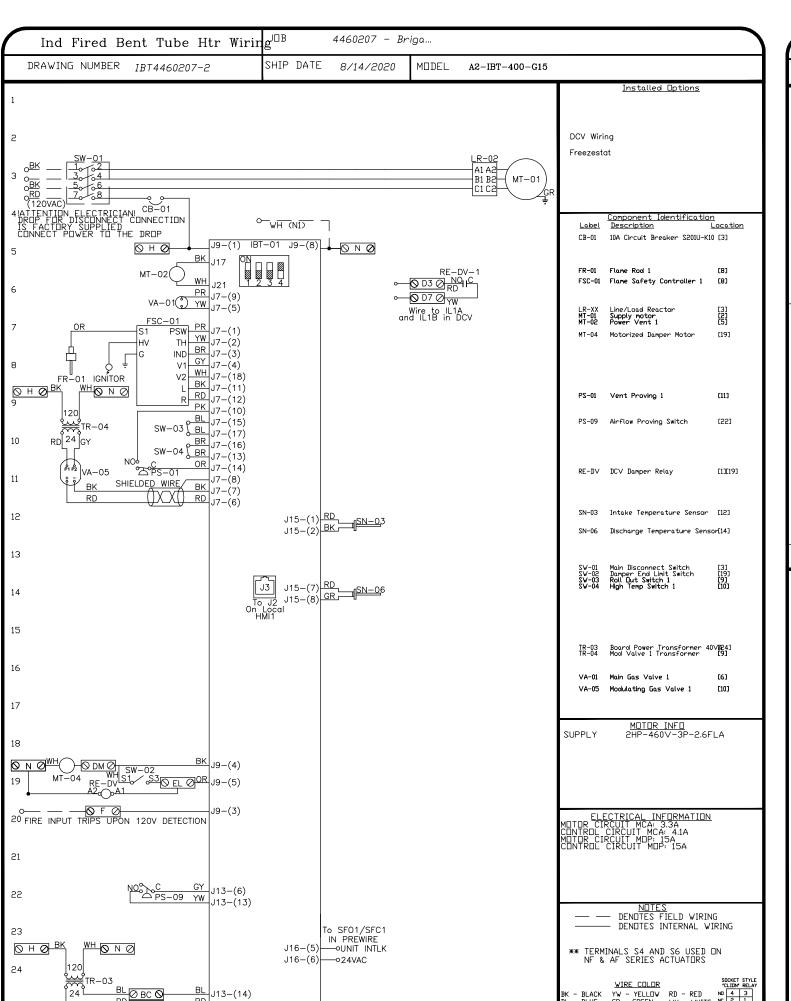

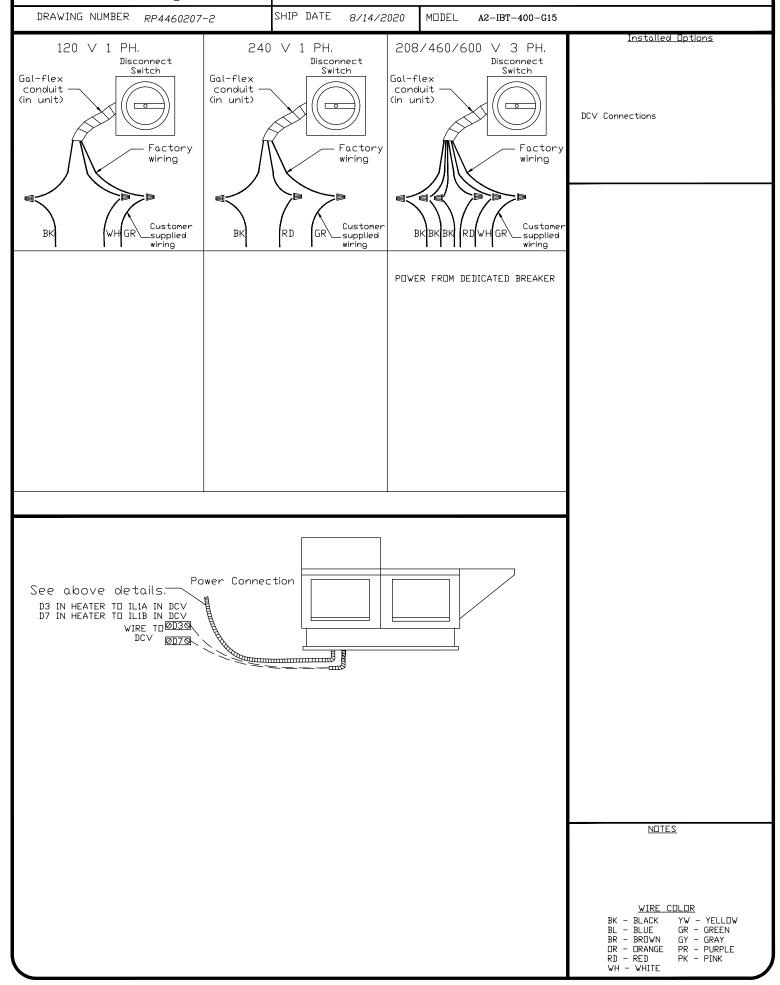


4460207 - Briga...

#### MIAMI-DADE NOA2 SUPPLY FANS

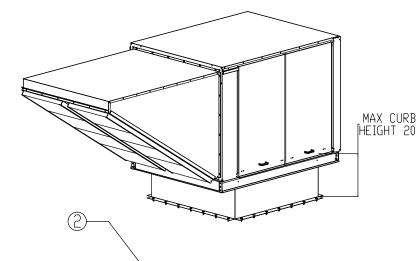

GENERAL NOTES: 1. THIS APPROVAL IS FOR THE STRUCTURAL CAPACITY AND IMPACT RATING OF THE EXTERIOR HOUSING ONLY; IT DOES NOT INCLUDE ANY INTERIOR MECHANISM OR ELECTRICAL PART. 2. THESE FANS HAVE NOT BEEN WIND TESTED FOR WIND DRIVEN RAIN TEST PER FLORIDA BUILDING CODE, TAS100 (A)-95.

3. TESTED IN ACCORDANCE TO FLORIDA BUILDING CODE TEST PROTOCOL TAS201, TAS202, TAS203. 4. TESTED FOR AREAS INCLUDING HIGH VELOCITY HURRICANE ZONES. 5. TESTED UNDER MIAMI-DADE COUNTY NOTIFICATION NUMBER ATI-08034.

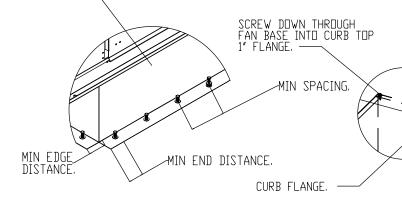

INSTALLATION INSTRUCTIONS: 1. SECURE FAN BASE TO TOP OF CURB USING 1/4-14 X 1" ZINC PLATED STEEL SELF DRILLING SCREWS (A307 OR BETTER) THROUGH FAN BASE. SEE TABLE BELOW FOR QTY. 2. SECURE CURB TO ROOF FRAMING MEMBERS BY DRILLING 1/4" DIA PILOT HOLES IN CURB AT LOCATION SHOWN IN BOTTOM LEFT DIAGRAM. SEE TABLE BELOW FOR FASTENER TYPE AND QTY.

DESIGN PRESSURE: +30.0 / -130.0 PSF. LARGE MISSILE IMPACT RESISTANT.

	IN:	STALLATION FASTENER	TYPES	_
	FAN TO CURB	WOOD (SG = 0.42 MIN.)	STEEL (12 GAUGE MIN.)	CONCRETE (2500 PSI MIN. CRACKED CONCRETE)
FASTENER	1/4"-14 X 1" SELF DRILLING SCREW (A307 OR BETTER)	3/8" DIA. ZINC PLATED LAG BOLT	1/4"-14 DRIL-FLEX SELF DRILLING SCREW	3/8" DIA. SS HILTI KWIK BOLT TZ EXPANSION ANCHOR
MINIMUM THREAD PENETRATION	N/A	2"	12 GAUGE	2-5/16"
MINIMUM EDGE DISTANCE	N/A	1-1/2"	3/8"	3"
MINIMUM END DISTANCE	N/A	2-5/8"	3/8"	4"
MINIMUM SPACING	N/A	1-1/2"	3/4"	7"

ALL CONTROLS, CONTROL WIRING, INSTALLATION AND START-UP SHALL BE PROVIDED BY KITCHEN EQUIPMENT MANUFACTURER. PROVIDE A MINIMUM OF 4 HOURS OF OWNER INSTRUCTION

CERTIFICATE:

CODE REVIEW:



SPIEZLE ARCHITECTURAL GROUP INC. 1395 YARDVILLE HAMILTON SQUARE ROAD SUITE 2 A HAMILTON, NJ 08691 Phone: 609-695-7400

> 21Al01505400 21Al01674400

> 21Al01170100 21Al01564200

21AC00063000

SIGNATURE: THOMAS S. PERRINO SCOTT E. DOWNIE STEVEN LEONE STEVEN G. SIEGEL SPIEZLE ARCHITECTURAL GROUP, INC.

SEAL:

CONSULTANTS: KSI CONSULTING ENGINEERS, LLC P.O. BOX 628 FARMINGDALE, NJ 07727 732.938.2666 PHONE: FAX: 732.938.2521 CERTIFICATE OF AUTHORIZATION NO. 24GA28124300 PAUL RIPISH, N.J.P.E. LICENSE NUMBER 4515800 ALL DRAWINGS AND WRITTEN MATERIALS APPEARING HEREIN CONSTITUTE ORIGINAL AND UNPUBLISHED WORK OF THE ENGINEER. THE REPRODUCTION OF THIS DRAWING FOR THE PURPOSE OF COPYING THIS WORK OR REVISING SAID DRAWING SHALL BE CONSIDERED A VIOLATION OF BOTH THE PROFESSIONAL CODE OF ETHICS AND A THEFT OF COMPANY ASSETS, BOTH OF WHICH SHALL BE PROSECUTED TO THE FULLEST EXTENT OF CURRENT STATUTES.

KSI PROJECT #: 20100M\_04

PROJECT:

90% 9/18/20

KITCHEN **UPGRADES AND** CLASSROOM ALTERATIONS AT BRIGANTINE **ELEMENTARY** 

BRIGANTINE OF EDUCATION

301 E Evans Brigantine, NJ 0820

DD/MM/YYYY FOR CODE REVIEW: REVISIONS: DATE REVISION NAME

FOR BID:


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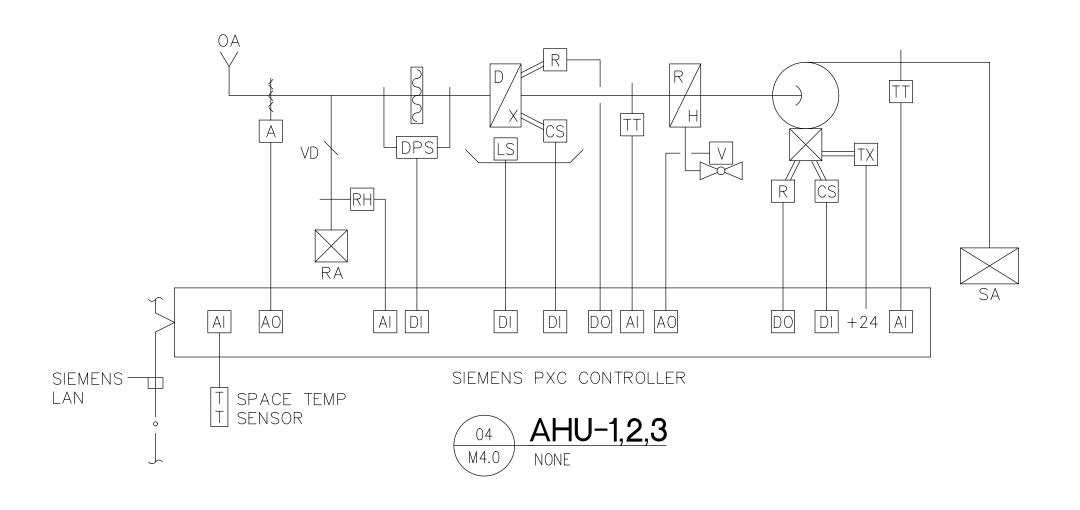
DRAWING TITLE: MECHANICAL DETAILS FOR KITCHEN MAKE-UP AIR UNIT (MUA-1)

COMMISSION NUMBER: 20K009

AGENCY NUMBER: DO NOT SCALE THE DRAWINGS

M3.5



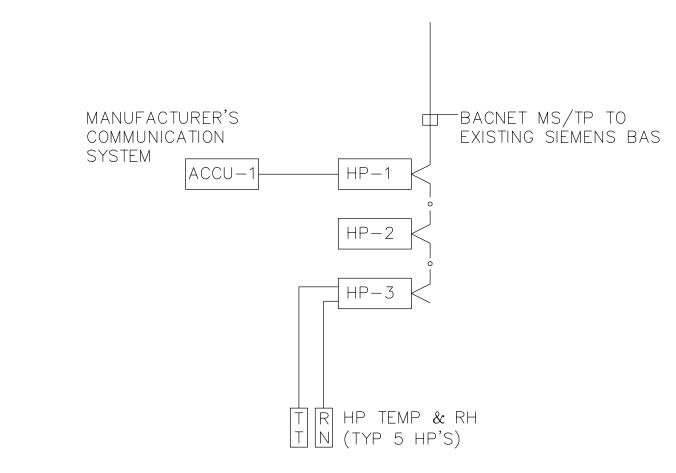

CODE REVIEW:

CERTIFICATE:



SPIEZLE ARCHITECTURAL GROUP INC. 1395 YARDVILLE HAMILTON SQUARE ROAD SUITE 2A HAMILTON, NJ 0869 I Phone: 609-695-7400

21Al01505400 21Al01674400 21Al01170100 21Al01564200 21AC00063000

SIGNATURE:
THOMAS S. PERRINO
SCOTT E. DOWNIE
STEVEN LEONE
STEVEN G. SIEGEL
SMEZLE ARCHITECTURAL GROUP, INC.

SEAL:

KSI CONSULTING ENGINEERS, LLC P.O. BOX 628 FARMINGDALE, NJ 07727 PHONE: FAX: 732.938.2666 732.938.2521 FAX: /32.938.2521
CERTIFICATE OF AUTHORIZATION NO. 24GA28124300
PAUL RIPISH, N.J.P.E. LICENSE NUMBER 4515800
ALL DRAWINGS AND WRITTEN MATERIALS APPEARING HEREIN CONSTITUTE
ORIGINAL AND UNPUBLISHED WORK OF THE ENGINEER. THE REPRODUCTION OF
THIS DRAWING FOR THE PURPOSE OF COPYING THIS WORK OR REVISING SAID
DRAWING SHALL BE CONSIDERED A VIOLATION OF BOTH THE PROFESSIONAL
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PROSECUTED TO THE FULLEST EXTENT OF CURRENT STATUTES.

DATE: KSI PROJECT #: 20100M\_04

90% 9/18/20

KITCHEN UPGRADES AND CLASSROOM ALTERATIONS AT BRIGANTINE **ELEMENTARY** 

BRIGANTINE OF EDUCATION

301 E Evans Brigantine, NJ 0820

FOR CODE REVIEW: DD/MM/YYYY REVISIONS: DATE REVISION NAME

FOR BID:

DD/MM/YYYY

DRAWING TITLE: MECHANICAL CONTROLS DETAILS

COMMISSION NUMBER: 20K009 AGENCY NUMBER:

DO NOT SCALE THE DRAWINGS

M4.1

#### PLUMBING GENERAL NOTES

- 1. DO NOT SCALE FROM THESE DRAWINGS.
- 2. DO NOT MAKE ANY CHANGES OR SUBSTITUTIONS WITHOUT SPECIFIC WRITTEN APPROVAL FROM THE ARCHITECT OR ENGINEER.
- 3. ALL INDICATED WORK SHALL BE PERFORMED BY THE PLUMBING CONTRACTOR UNLESS OTHERWISE NOTED.
- 4. REFER TO THE WRITTEN SPECIFICATIONS IN CONJUNCTION WITH THE PLANS FOR FULL PROJECT SCOPE.
- IT IS THE RESPONSIBILITY OF THE PLUMBING CONTRACTOR TO REVIEW THESE PLANS AND SPECIFICATIONS. AS WELL AS THE RELATED HVAC, FIRE PROTECTION, ELECTRICAL, STRUCTURAL, ARCHITECTURAL, INTERIOR DECOR AND SITE ENGINEERING DRAWING TO BECOME FAMILIAR WITH THE FULL PROJECT SCOPE. IN ADDITION. THIS CONTRACTOR MUST COORDINATE WITH AN OWNER REPRESENTATIVE TO FULLY UNDERSTAND ALL REQUIREMENTS WHICH MAY NOT BE SPECIFIED HEREIN AND WHICH THE OWNER MAY CONSIDER PART OF THIS CONTRACT. DURING THE COURSE OF CONSTRUCTION COORDINATION AND ACTUAL CONSTRUCTION, IT IS THE RESPONSIBILITY OF THE PLUMBING CONTRACTOR TO WORK CLOSELY WITH ALL ACCOMPANYING CONTRACTORS AND TRADESMEN IN ORDER TO ENSURE A SMOOTH RUNNING AND CAREFULLY COORDINATED INSTALLATION.
- . ANY DISCREPANCIES OR INADEQUACIES WITHIN THESE BID DOCUMENTS OR BETWEEN THESE BID DOCUMENTS AND THE RELATED HVAC, FIRE PROTECTION, ELECTRICAL, STRUCTURAL, ARCHITECTURAL, INTERIOR DECOR AND SITE ENGINEERING DRAWINGS, OR BETWEEN THESE BID DOCUMENTS AND FIELD CONDITIONS MUST BE BROUGHT TO THE ATTENTION OF THE OWNER, ARCHITECT AND ENGINEER PRIOR TO BID SUBMISSION.
- ALL WORK SHALL BE PERFORMED IN ACCORDANCE WITH ALL APPLICABLE REGULATIONS INCLUDING BUT NOT LIMITED TO NATIONAL, CITY, STATE, LOCAL CODES AND ORDINANCES WHICH MAY BE IN EFFECT. ALL PLUMBING MATERIALS, INSTALLATION PROCEDURES AND SYSTEM LAYOUTS SHALL BE APPROVED BY ALL APPLICABLE CODE ENFORCEMENT AUTHORITIES HAVING JURISDICTION, AND IT SHALL BE THE PLUMBING CONTRACTOR'S RESPONSIBILITY TO OBTAIN AND PAY FOR ALL NECESSARY PERMITS AND APPROVALS FOR THIS INSTALLATION.
- THE PLUMBING CONTRACTOR MUST VISIT THE SITE AND NOTE ALL EXISTING CONDITIONS AS WELL AS ALL CONDITIONS TO BE MET, PRIOR TO BID SUBMISSION. LACK OF A THOROUGH UNDERSTANDING OF THE PROJECT SCOPE AND CONDITIONS SHALL NOT CONSTITUTE AN EXCUSE FOR ERRORS OR OMISSIONS, NOR FOR A REQUEST FOR EXTRA COMPENSATION.
- 9. IT IS CRITICAL THAT THE PLUMBING CONTRACTOR FIELD VERIFIES ALL EXISTING INVERTS PRIOR TO BID SUBMISSION. IF ANY CONFLICTS EXIST BETWEEN THE NEW PLUMBING SYSTEMS AND THE EXISTING SITE LEVEL SYSTEMS, THEY SHOULD BE BROUGHT TO THE ATTENTION OF AN OWNER'S REPRESENTATIVE AND THE ENGINEER PRIOR TO BID SUBMISSION. EXTRA COMPENSATION WILL NOT BE ALLOWED FOR ANY EXTRA WORK WHICH RESULTS FROM AN INABILITY TO MEET THE INVERTS OF THE EXISTING SITE LEVEL PIPING SYSTEMS.
- 10. THE PLUMBING CONTRACTOR SHALL PROVIDE A COMPLETE SET OF RECORD "AS-BUILT" DRAWINGS INDICATING THE PRECISE LOCATION OF ALL SYSTEMS, EQUIPMENT CONCEALED OR EMBEDDED PIPING, PIPING CONNECTIONS AND ACCESS DOORS. THESE DRAWINGS SHALL ALSO INCLUDE ALL CHANGES AND DEVIATIONS FROM BID DOCUMENTS.
- 11. RUN ALL DOMESTIC, WASTE & VENT PIPING AS HIGH AS POSSIBLE THROUGHOUT ENTIRE BUILDING. INSTALL LONG RUNS OF PIPING WITHIN STEEL (JOIST) SPACE AND OTHER PIPING TIGHT TO BOTTOM OF STEEL. COORDINATE AND VERIFY WITH OTHER CONTRACTOR'S AS NOT TO INTERFERE WITH DUCTWORK, FIRE PROTECTION PIPING, LIGHTING
- 12. ALL EXPOSED HORIZONTAL AND VERTICAL PIPING SHALL BE INSTALLED IN A NEAT ARRANGEMENT IN LOCATIONS WHICH ARE THE MOST INCONSPICUOUS. VERTICAL DROPS SHALL BE KEPT TO AN ABSOLUTE MINIMUM AND THEIR FINAL LOCATIONS SHALL BE COORDINATED AND RUN WITHIN CHASES, WALLS, SOFFITS WITH OTHER MECHANICAL/ELECTRICAL FEEDS. ALL SUCH LOCATIONS ARE TO BE REVIEWED WITH A OWNER REPRESENTATIVE AND ARCHITECT PRIOR TO INSTALLATION.
- 13. ALL PLUMBING FIXTURES/APPLIANCES SHALL HAVE THEIR OWN INDEPENDENT SHUT-OFF VALVES, INSTALLED IN AN EASILY ACCESSIBLE AND CONVENIENT LOCATION.
- 14. ALL DOMESTIC WATER BRANCH LINES SHALL HAVE THEIR OWN RESPECTIVE SHUT-OFF VALVES.
- 15. DOMESTIC HOT WATER HEATER TEMPERATURE/PRESSURE RELIEF VALVES SHALL BE PIPED FULL SIZE TO THE NEAREST APPROVED STANDPIPE OR FLOOR DRAIN. THIS REQUIREMENT SHALL BE APPLICABLE TO ALL DOMESTIC WATER HEATERS EXCEPT INSTANTANEOUS WATER HEATERS.
- 16. ALL PLUMBING VENT LINES NOTED AS "V. UP" OR "VENT UP" SHALL BE CONNECTED TO THE NEAREST APPROVED "V.T.R." OR "VENT THRU ROOF."
- 17. PRIOR TO INSTALLING SYSTEMS, THE PLUMBING CONTRACTOR SHALL MEET WITH THE ARCHITECTS REPRESENTATIVE TO FIELD VERIFY THE EXACT LOCATION OF ALL PROPOSED EQUIPMENT WHICH MAY NOT BE CLEARLY INDICATED ON THE DRAWINGS.
- 18. PROVIDE C.O.'S AT THE BASE OF ALL SANITARY AND STORM STACKS.
- 19. SANITARY SEWER PIPING SHOWN IS BASED ON .25" PER FOOT FALL FOR ALL PIPING SMALLER THAN 4", AND .125" PER FOOT FALL FOR ALL PIPING 4" AND LARGER.
- 20. PROVIDE ALL SAW CUTTING AND PATCHING AS REQUIRED TO ACCOMMODATE ALL NEW PIPING AND FIXTURE INSTALLATION.
- 21. <u>LEAD FREE REQUIREMENT:</u> PRODUCTS DESIGNED FOR DISPENSING POTABLE WATER SHALL MEET NSF 61 AND NSF 372 TEST STANDARDS VIA THIRD—PARTY TESTING AND
- 22. COORDINATE ALL DECK PENETRATIONS WITH PLANK, USING ANY AND ALL EXCEPTED MEANS TO VERIFY STEEL PLACEMENT PRIOR TO CORE CUTS.

#### PLUMBING SYMBOLS

	SANITARY WASTE
	VENT LINE
G	NATURAL GAS
	COLD WATER
	HOT WATER
	HOT WATER RETURN
	STORM SEWER
CA	COMPRESSED AIR
AW	ACID WASTE
PD	PUMP DISCHARGE
	OIL WASTE
H	BALL VALVE
N	CHECK VALVE
H	BALANCING VALVE
	GAS PRESSURE REGULATOR
<b>o</b>	CLEAN OUT DECK PLATE
II .	HORIZONTAL CLEANOUT
<b>*</b>	GAS COCK
	GAS SOLENOID VALVE
	FLOOR DRAIN
U ►•	P TRAP
v	TRAP
<b>-</b> ⇒	PIPE DOWN, DROP & RISE
<b>—</b>	PIPE UP
<b>-\circ</b>	TEE PLAN UP
<del></del>	TEE PLAN DOWN
	KEY NOTE
	CONNECT TO EXISTING

#### NOTE: NOT ALL SYMBOLS ARE USED ON THIS PROJECT.

#### PLUMBING ABBREVIATIONS

A.F.W.H.	ANTI-FREEZE WALL HYDRANT
A.D.	ACCESS DOOR
A.F.F.	ABOVE FINISHED FLOOR
B.F.P.	BACK FLOW PREVENTOR
CA	COMPRESSED AIR
CO.	CLEAN OUT
C.O.D.P.	CLEAN OUT DECK PLATE
D.I.	DRAINAGE INLET
EXIST.	EXISTING
E.W.C.	ELECTRIC WATER COOLER
F.A.I.	FRESH AIR INLET
FD.	FLOOOR DRAIN
G.E.	GRADE ELEVATION
H.B.	HOSE BIBB
I.E.	INVERT ELEVATION
LAV.	LAVATORY
LDR.	LEADER
N.C.	NORMALLY CLOSED
N.I.C.	NOT IN CONTRACT
0.F.	OVERFLOW LEADER
O.R.D.	OVER-FLOW ROOF DRAIN
O.W.	OIL WASTE
R.D.	ROOF DRAIN
S.	SANITARY
SK.	SINK
S.S.	SERVICE SINK
ST	STORM DRAINAGE
T.E.	TOP ELEVATION
UR.	URINAL
VAC	VACUUM
V.B.	VACUUM BREAKER
V.T.R	VENT THRU ROOF
W.	WASTE
W.C.	WATER CLOSET
W.C.O.	WALL CLEAN OUT


NOTE: NOT ALL ABBREVIATIONS ARE USED ON THIS PROJECT.

	PLUMBI	ING FIXTURE S	SCHEDULE											
	NO.	FIXTURE	MFG.	TYPE AND	TRIM NO.	SUPPLY	TRAP NO.	SUPPORT		PI	PE SIZE	S		REMARKS
•				MODEL NO.		PIPE NO.		NO.	TRAP	WASTE	VENT	CW	HW	
	FD	FLOOR	JAY R. SMITH	2009C-06-B	_	_	'P'-TRAP	_		_	_	_		PROVIDE WITH SEDIMENT BUCKET, DEEP SEAL TRAP AND
•		DRAIN												6" STRAINER.
	F.S.	FLOOR	JAY R. SMITH	3001NB-12	_	_	'P'-TRAP	_	_	_	_	-	_	4" DEPTH WITH 1/2 GRATE AND DOME STRAINER.
•		SINK												


REFER TO THE ARCHITECTS DRAWINGS FOR LOCATION AND QUANTITIES OF HANDICAPPED FIXTURES. ALL HANDICAPPED FIXTURES SHALL BE INSTALLED AS PER CABO/ANSI A117.1 REQUIREMENTS.

- 2 PROVIDE McGUIRE PRO-WRAP INSULATING KIT ON TRAPS AND HOT AND COLD WATER SUPPLIES TO ALL HANDICAPPED LAVATORIES. SEE ARCHITECTURAL DRAWINGS FOR LOCATIONS OF HANDICAPPED FIXTURES.
- 3 PRIOR TO SUBMITTING SHOP DRAWINGS, THE CONTRACTOR SHALL COORDINATE FIXTURE TYPES AND COLORS WITH THE ARCHITECT.
- 4 ALL LAVATORIES & HANDWASH SINKS TO SHALL BE SUPPLIED WITH A THERMOSTATIC MIXING VALVE (ASSE 1070) LIMITING WATER TO 110° F MAX.


PLUMBIN	G EQUIPMENT SCI	HEDULE									
GENERAL					DESIGN DATA		ELECTRICAL	ı			REMARKS
ITEM	SERVICE	MFR.	NO.	LOCATION	CAPACITY	PUMP HEAD	H.P./K.W.	R.P.M.	VOLTS	PHASE	
G.I.	GREASE INTERCEPTOR	SCHIER	GB2	SEE DWG'S	50 G.P.M.	130 LBS GREASE CAPACITY					WITH INTEGRAL FLOW CONTROL DEVICE. PROVIDE RISER EXTENSION FOR RECESS INSTALLATION.

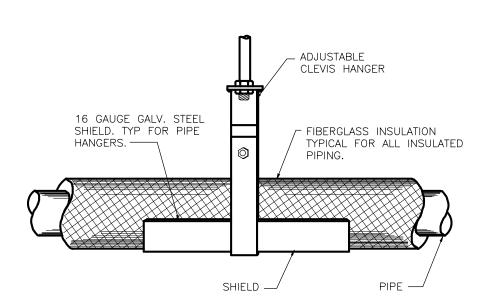



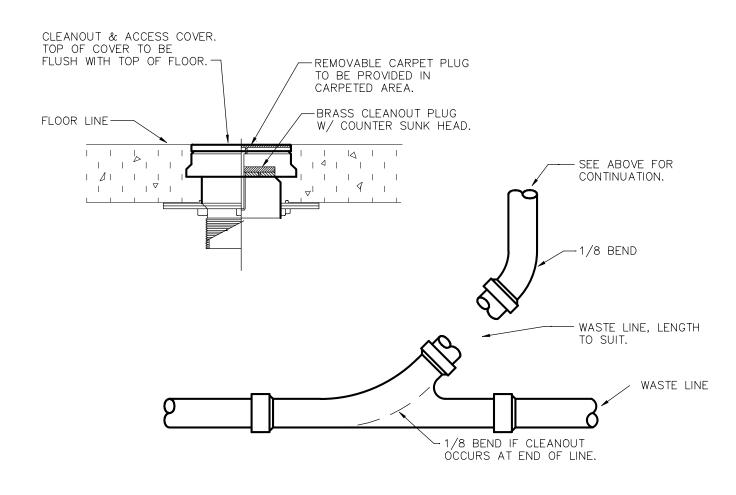

## TYPICAL FLOOR CLEANOUT DETAIL

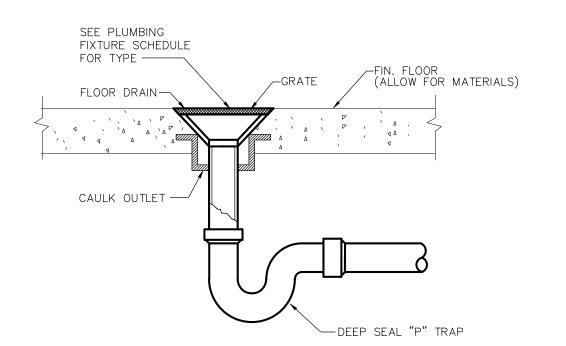



CODE REVIEW:

CERTIFICATE:

SPIEZLE ARCHITECTURAL GROUP INC. 1395 YARDVILLE HAMILTON SQUARE ROAD SUITE 2A HAMILTON, NJ 08691 Phone: 609-695-7400

21AI01505400

21AI01674400

21AI01564200

SIGNATURE: THOMAS S. PERRINO SCOTT E. DOWNIE STEVEN LEONE STEVEN G. SIEGEL SPIEZLE ARCHITECTURAL GROUP, INC. 21AC00063000

SEAL:

CONSULTANTS: KSI CONSULTING ENGINEERS, LLC P.O. BOX 628 FARMINGDALE, NJ 07727 PHONE: 732.938.2666 732.938.2521 CERTIFICATE OF AUTHORIZATION NO. 24GA28124300 PAUL RIPISH, N.J.P.E. LICENSE NUMBER 4515800 ALL DRAWINGS AND WRITTEN MATERIALS APPEARING HEREIN CONSTITUTE ORIGINAL AND UNPUBLISHED WORK OF THE ENGINEER. THE REPRODUCTION OF THIS DRAWING FOR THE PURPOSE OF COPYING THIS WORK OR REVISING SAID DRAWING SHALL BE CONSIDERED A VIOLATION OF BOTH THE PROFESSIONAL CODE OF ETHICS AND A THEFT OF COMPANY ASSETS, BOTH OF WHICH SHALL BE PROSECUTED TO THE FULLEST EXTENT OF CURRENT STATUTES.

KSI PROJECT #: 20100M\_04

PROJECT:

KITCHEN UPGRADES AND CLASSROOM ALTERATIONS AT BRIGANTINE ELEMENTARY FOR

> BRIGANTINE OF EDUCATION

301 E Evans Brigantine, NJ 0820

FOR CODE REVIEW: DD/MM/YYYY **REVISIONS:** DATE **REVISION NAME** ADDENDUM #1 10/05/20

FOR BID: 09/23/2020


DRAWING TITLE:

DRAWING NUMBER:

PLUMBING GENERAL INFORMATION

COMMISSION NUMBER: 20K009 AGENCY NUMBER: 01-0570-300-20-2000 01-0570-300-21-1000 DO NOT SCALE THE DRAWINGS

PO.I

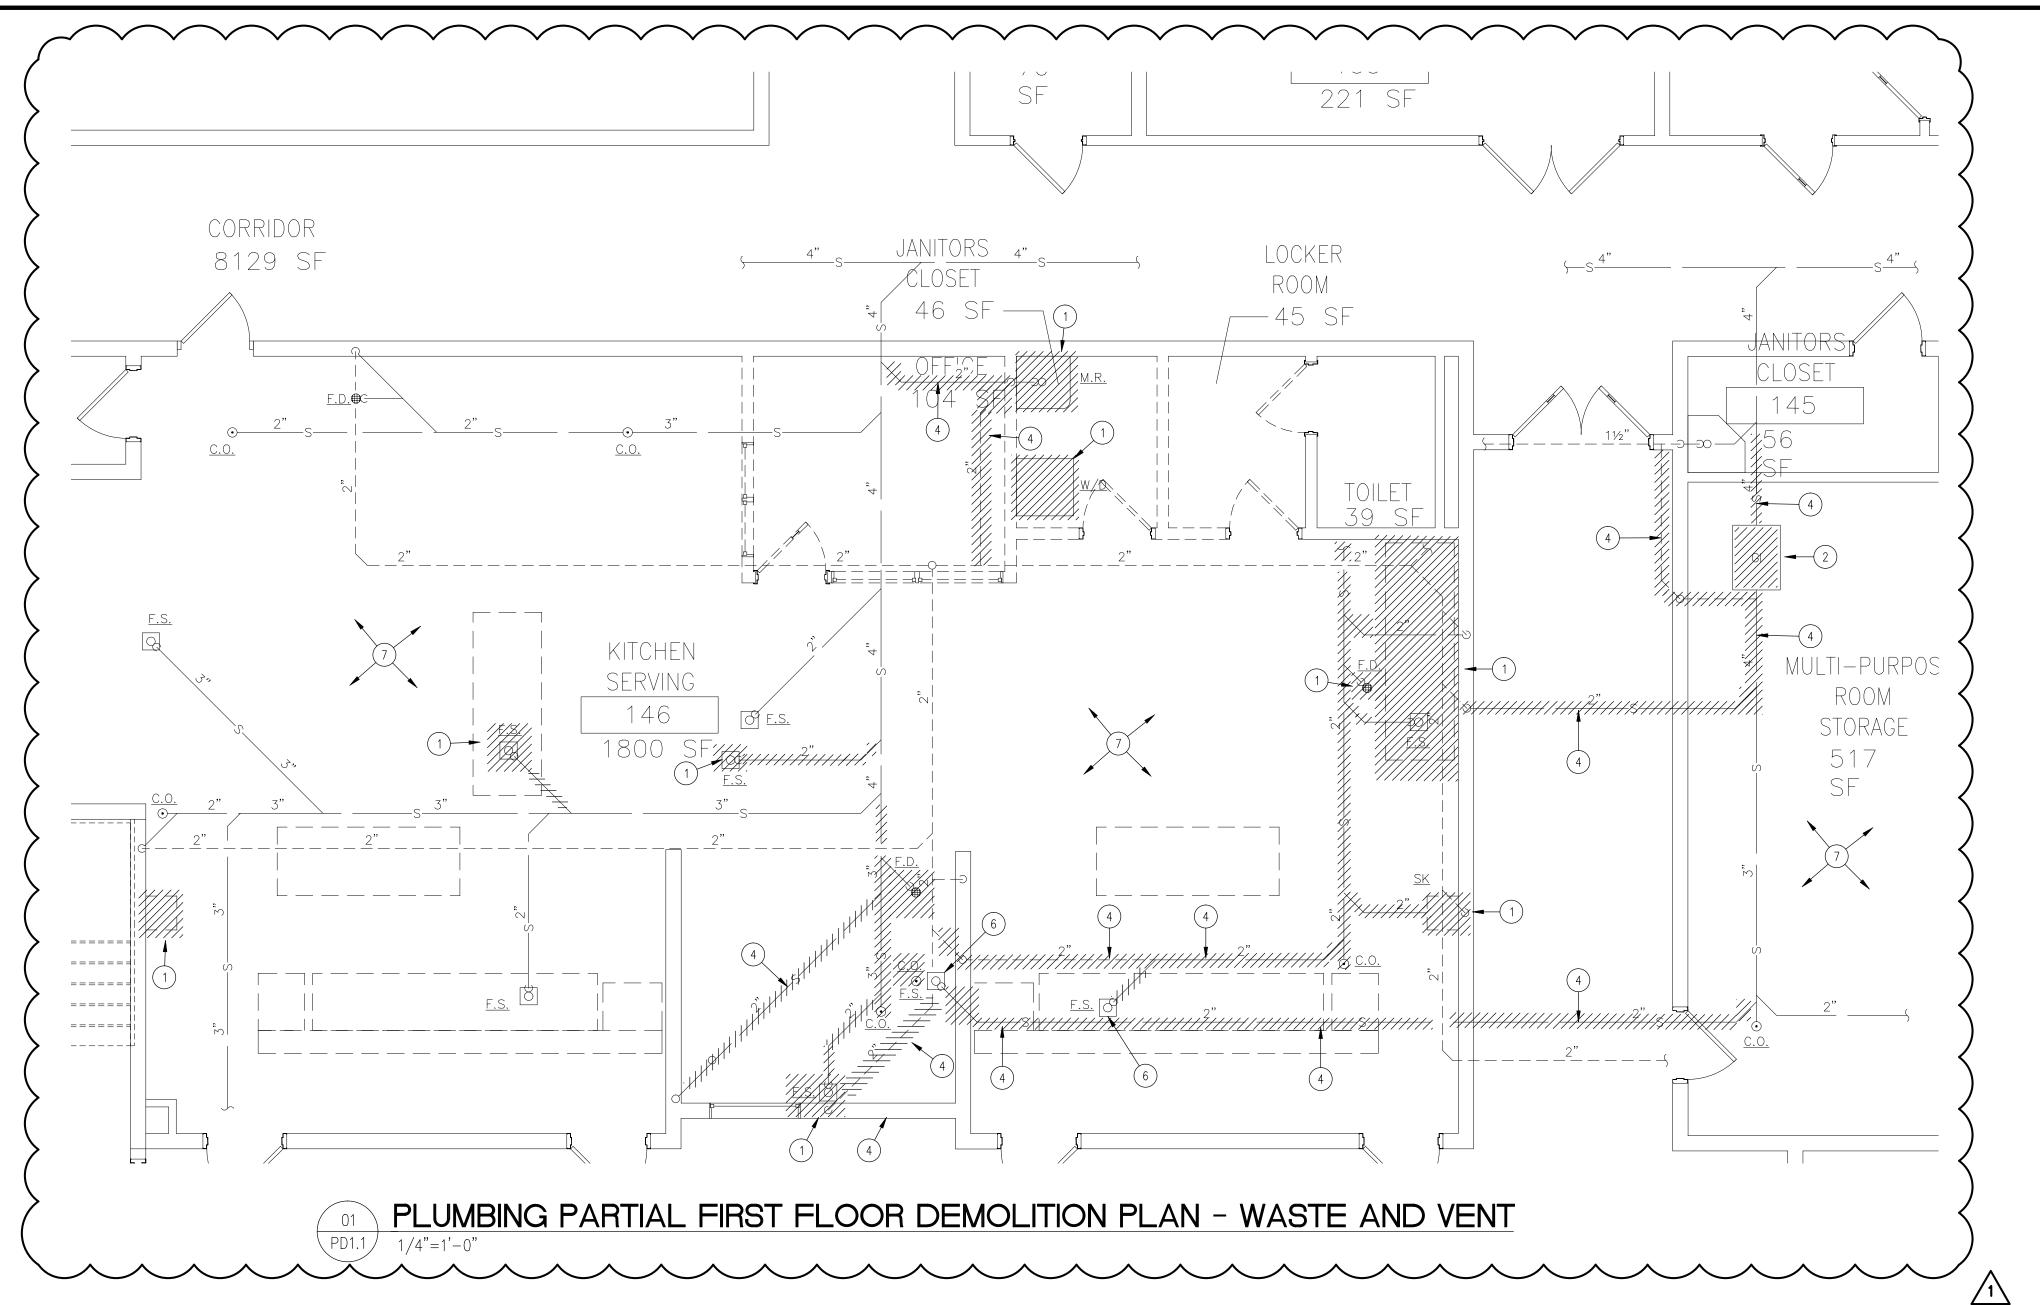

#### KEY NOTES

- 1. REMOVE EXISTING PLUMBING FIXTURE(S) AND ALL ASSOCIATED PIPING. PROVIDE A CLEAN FINISHED
- 2. EXISTING GREASE INTERCEPTOR TO BE REMOVED AND REPLACED. EXISTING ACCESS COVER SHALL REMAIN FOR ACCESS TO NEW UNIT INSTALLED IN CRAWL SPACE.
- 3. EXISTING SOLENOID VALVE AT THE CEILING SHALL BE REMOVED AND REPLACED WITH A SPOOL PIECE. A NEW SOLENOID VALVE WILL BE PROVIDED AT THE KITCHEN HOOD.
- 4. EXISTING PIPING SHALL BE REMOVED. CONTRACTOR TO VERIFY EXISTING IN FIELD.

REFER TO MECH. DRAWINGS FOR ADDITIONAL INFORMATION.

- 5. EXISTING WATER PIPING BELOW FLOOR TO BE CAPPED AND ABANDONED IN PLACE.
- 6. EXISTING FLOOR SINK TO REMAIN. REMOVE EXISTING WASTE PIPING. REFER TO NEW WORK PLAN FOR NEW PIPE ROUTING.
- 7. CRAWL SPACE BELOW CONCRETE PLANK.

#### **DEMOLITION NOTES**

- 1. ALL PIPING AND EQUIPMENT TO BE REMOVED SHALL BE REMOVED BACK TO NEAREST STACK, RISER, OR MAIN IN ACCORDANCE WITH ALL STATE AND LOCAL REGULATIONS/STANDARDS, CODES AND AUTHORITY HAVING
- 2. REMOVE ANY ABANDONED AND/OR UNUSED PIPING DISCOVERED DURING DEMOLITION. THERE SHALL BE NO DEAD-ENDS GREATER THAN 24 INCHES IN ANY PLUMBING PIPING SYSTEMS.
- 3. DURING DEMOLITION ANY DAMAGES DISCOVERED IN EXISTING PIPING TO REMAIN SHOULD BE BROUGHT TO THE ATTENTION OF THE ENGINEER.
- 4. ALL EXISTING PIPING AND APPURTENANCES TO REMAIN SHALL BE PROTECTED FROM DAMAGE DURING DEMOLITION. ANY DAMAGES INCURRED SHALL BE REPAIRED OR REPLACED AT NO COST BY THIS
- 5. THE CONTRACTOR SHALL COORDINATE, NOTIFY, AND SCHEDULE ALL REMOVALS WITH THE CONSTRUCTION MANAGER PRIOR TO PROCEEDING WITH THE WORK.
- 6. THIS CONTRACTOR SHALL INCLUDE ALL COSTS FOR REMOVAL AND RELOCATIONS IN THE CONTRACT.

7. THE CONTRACTOR PRIOR TO BID SHALL VISIT THE SITE, EXAMINE THE EXISTING CONDITIONS, DRAWINGS AND

- COORDINATE THE EXACT SCOPE OF WORK WITH THE ARCHITECT AND CONSTRUCTION MANAGER. 8. THE CONTRACTOR SHALL COORDINATE ALL SHUTDOWNS AND IDENTIFY ANY WORK WHICH MAY BE REQUIRED TO BE PERFORMED ON OVERTIME IN ORDER NOT TO DISTURB OCCUPIED SPACES WHICH ARE NOT WITHIN THE SCOPE OF THIS CONTRACT. OBTAIN WRITTEN APPROVAL OF THE CONSTRUCTION MANAGER PRIOR TO
- 9. REFER TO ARCHITECTURAL DRAWINGS FOR ADDITIONAL DEMOLITION INFORMATION AND PHASING SEQUENCE.

PERFORMING ANY SHUTDOWNS OR PERFORMING WORK ON ON OVERTIME.

10. PROVIDE ALL SAW CUTTING AND PATCHING.

CERTIFICATE:

CODE REVIEW:



SPIEZLE ARCHITECTURAL GROUP INC. 1395 YARDVILLE HAMILTON SQUARE ROAD SUITE 2A HAMILTON, NJ 08691

Phone:	609-695-7400
SIGNATURE:	
HOMAS S. PERRINO	2   AIO   505400
COTT E. DOWNIE	21 A10 1 674400
TEVEN LEONE	21A101170100
TEVEN G. SIEGEL	21AlO1564200
PIEZLE ARCHITECTURAL GROUP, INC.	21AC00063000



KSI PROJECT #: 20100M\_04

CONSULTANTS:

PROJECT:

KITCHEN UPGRADES AND CLASSROOM ALTERATIONS AT BRIGANTINE ELEMENTARY

BRIGANTINE OF EDUCATION

FOR

301 E Evans Brigantine, NJ 0820

FOR CO	DE REVIEW:	DI	D/MM/YYYY
REVISIO	NS:		
<b>#</b>	REVISION NAME		DATE
$\triangle$	ADDENDUM #1		10/05/20

FOR BID: 09/23/2020

DRAWING TITLE:

FIRST AND SECOND FLOOR DEMOLITION PARTIAL PLANS


COMMISSION NUMBER: 20K009 AGENCY NUMBER: 01-0570-300-20-2000 01-0570-300-21-1000

NUMBER: PDI.I

DRAWING

DO NOT SCALE THE DRAWINGS

PD1.1 FIRST FLOOR KEYPLAN
1/64"=1'-0"

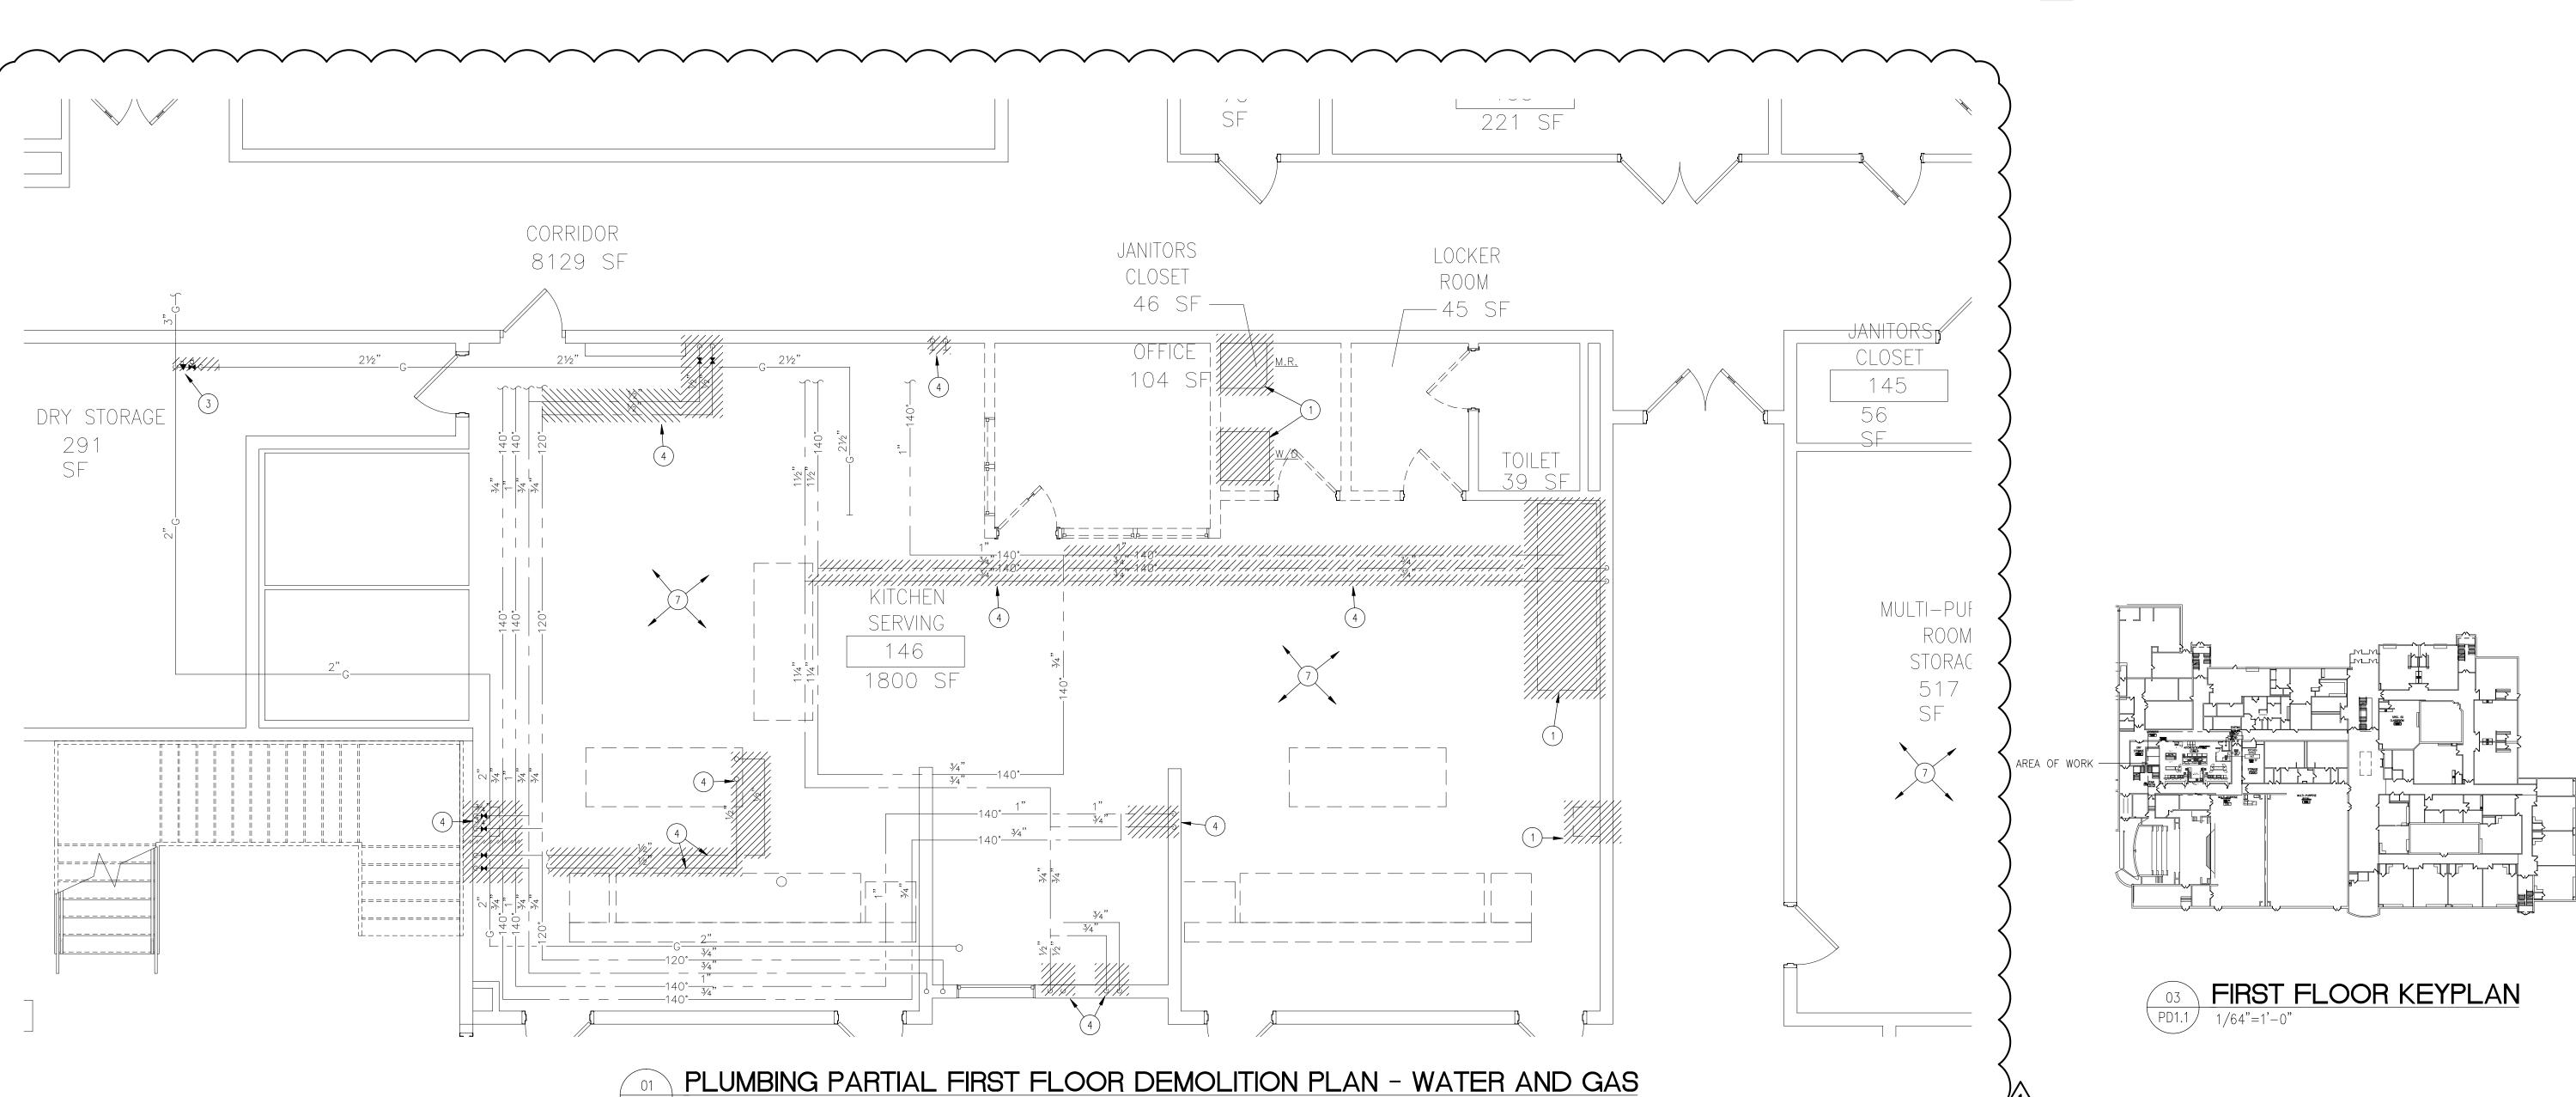

#### KEY NOTES

**DEMOLITION NOTES** 

THE ATTENTION OF THE ENGINEER.

10. PROVIDE ALL SAW CUTTING AND PATCHING.

MANAGER PRIOR TO PROCEEDING WITH THE WORK.

1. REMOVE EXISTING PLUMBING FIXTURE(S) AND ALL ASSOCIATED PIPING. PROVIDE A CLEAN FINISHED

1. ALL PIPING AND EQUIPMENT TO BE REMOVED SHALL BE REMOVED BACK TO NEAREST STACK, RISER, OR

2. REMOVE ANY ABANDONED AND/OR UNUSED PIPING DISCOVERED DURING DEMOLITION. THERE SHALL BE NO

3. DURING DEMOLITION ANY DAMAGES DISCOVERED IN EXISTING PIPING TO REMAIN SHOULD BE BROUGHT TO

4. ALL EXISTING PIPING AND APPURTENANCES TO REMAIN SHALL BE PROTECTED FROM DAMAGE DURING

DEMOLITION. ANY DAMAGES INCURRED SHALL BE REPAIRED OR REPLACED AT NO COST BY THIS

5. THE CONTRACTOR SHALL COORDINATE, NOTIFY, AND SCHEDULE ALL REMOVALS WITH THE CONSTRUCTION

7. THE CONTRACTOR PRIOR TO BID SHALL VISIT THE SITE, EXAMINE THE EXISTING CONDITIONS, DRAWINGS AND

8. THE CONTRACTOR SHALL COORDINATE ALL SHUTDOWNS AND IDENTIFY ANY WORK WHICH MAY BE REQUIRED TO BE PERFORMED ON OVERTIME IN ORDER NOT TO DISTURB OCCUPIED SPACES WHICH ARE NOT WITHIN THE SCOPE OF THIS CONTRACT. OBTAIN WRITTEN APPROVAL OF THE CONSTRUCTION MANAGER PRIOR TO

9. REFER TO ARCHITECTURAL DRAWINGS FOR ADDITIONAL DEMOLITION INFORMATION AND PHASING SEQUENCE.

6. THIS CONTRACTOR SHALL INCLUDE ALL COSTS FOR REMOVAL AND RELOCATIONS IN THE CONTRACT.

COORDINATE THE EXACT SCOPE OF WORK WITH THE ARCHITECT AND CONSTRUCTION MANAGER.

DEAD-ENDS GREATER THAN 24 INCHES IN ANY PLUMBING PIPING SYSTEMS.

PERFORMING ANY SHUTDOWNS OR PERFORMING WORK ON ON OVERTIME.

MAIN IN ACCORDANCE WITH ALL STATE AND LOCAL REGULATIONS/STANDARDS, CODES AND AUTHORITY HAVING

2. REMOVE EXISTING GREASE INTERCEPTOR AND REPLACE WITH SPOOL PIECE.

CODE REVIEW:

# CERTIFICATE:

SPIEZLE ARCHITECTURAL GROUP INC. 1395 YARDVILLE HAMILTON SQUARE ROAD

HAMILTON, NJ 08691

Phone: 609-695-7400

21Al01505400

21Al01674400

21Al01564200

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SIGNATURE: THOMAS S. PERRINO SCOTT E. DOWNIE

STEVEN LEONE STEVEN G. SIEGEL SPIEZLE ARCHITECTURAL GROUP, INC.

SEAL:

P.O. BOX 628 FARMINGDALE, NJ 07727 732.938.2666 732.938.2521 PHONE: FAX: 732.938.2521
CERTIFICATE OF AUTHORIZATION NO. 24GA28124300
PAUL RIPISH, N.J.P.E. LICENSE NUMBER 4515800
ALL DRAWINGS AND WRITTEN MATERIALS APPEARING HEREIN CONSTITUTE
ORIGINAL AND UNPUBLISHED WORK OF THE ENGINEER. THE REPRODUCTION OF
THIS DRAWING FOR THE PURPOSE OF COPYING THIS WORK OR REVISING SAID
DRAWING SHALL BE CONSIDERED A VIOLATION OF BOTH THE PROFESSIONAL
CODE OF ETHICS AND A THEFT OF COMPANY ASSETS, BOTH OF WHICH SHALL BE
PROSECUTED TO THE FULLEST EXTENT OF CURRENT STATUTES.

DATE: KSI PROJECT #: 20100M\_04

90% 9/18/20

KITCHEN **UPGRADES AND** CLASSROOM ALTERATIONS AT BRIGANTINE **ELEMENTARY** 

BRIGANTINE OF EDUCATION

301 E Evans Brigantine, NJ 0820

FOR CODE REVIEW: DD/MM/YYYY DATE REVISION NAME

SECOND FLOOR KEYPLAN

1/64"=1'-0"

FOR BID:


DRAWING TITLE:

PLUMBING SECOND FLOOR DEMOLITION PARTIAL PLANS

DD/MM/YYYY

COMMISSION NUMBER: 20K009 AGENCY NUMBER:

PD1.2

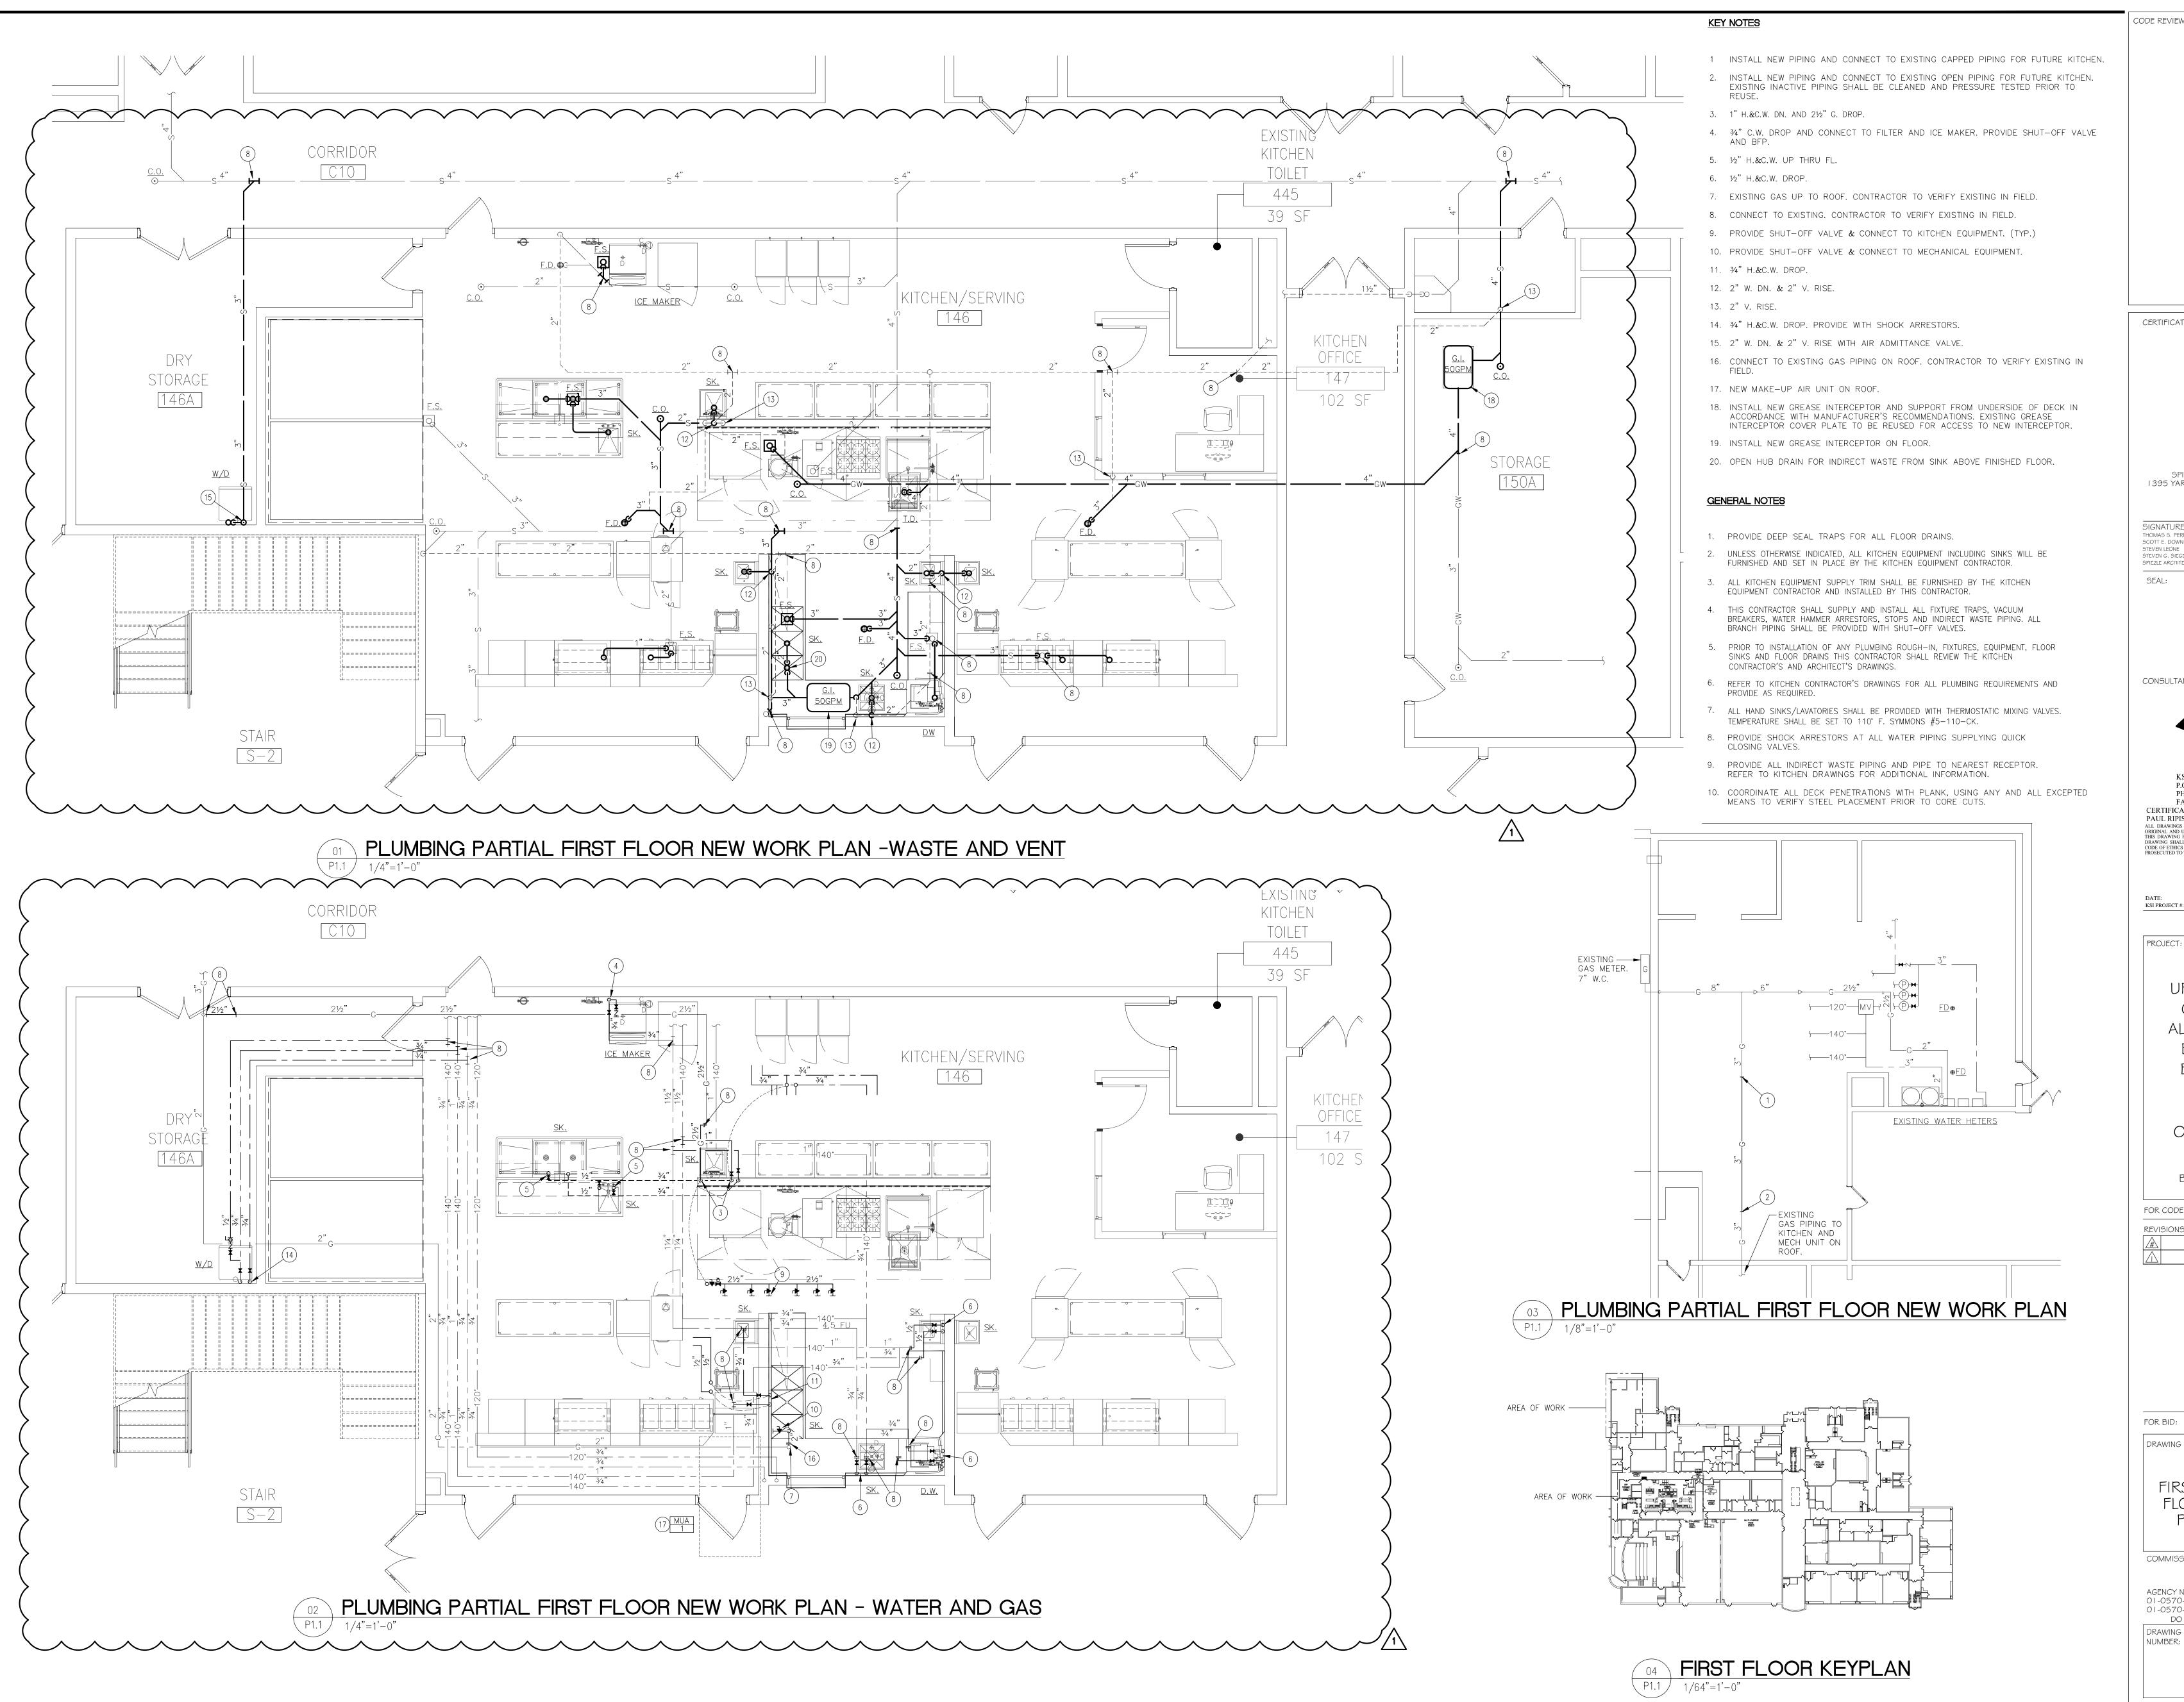

CODE REVIEW:

CERTIFICATE:



SPIEZLE ARCHITECTURAL GROUP INC. 1395 YARDVILLE HAMILTON SQUARE ROAD SUITE 2A HAMILTON, NJ 08691

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Phone: 609-695-7400 THOMAS S. PERRINO SCOTT E. DOWNIE STEVEN LEONE STEVEN G. SIEGEL

SEAL:

SPIEZLE ARCHITECTURAL GROUP, INC.

CONSULTANTS: P.O. BOX 628 FARMINGDALE, NJ 07727 732.938.2666 732.938.2521 CERTIFICATE OF AUTHORIZATION NO. 24GA28124300 PAUL RIPISH, N.J.P.E. LICENSE NUMBER 4515800

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KSI PROJECT #: 20100M\_04

PROJECT:

KITCHEN UPGRADES AND CLASSROOM ALTERATIONS AT BRIGANTINE ELEMENTARY

BRIGANTINE OF EDUCATION

FOR

301 E Evans Brigantine, NJ 0820

FOR CODE REVIEW: DD/MM/YYYY **REVISIONS:** REVISION NAME DATE

ADDENDUM #1

10/05/20


FOR BID: 09/23/2020 DRAWING TITLE:

FIRST AND SECOND FLOOR NEW WORK PARTIAL PLANS

COMMISSION NUMBER: 20K009 AGENCY NUMBER: 01-0570-300-20-2000 01-0570-300-21-1000

DO NOT SCALE THE DRAWINGS

NUMBER:

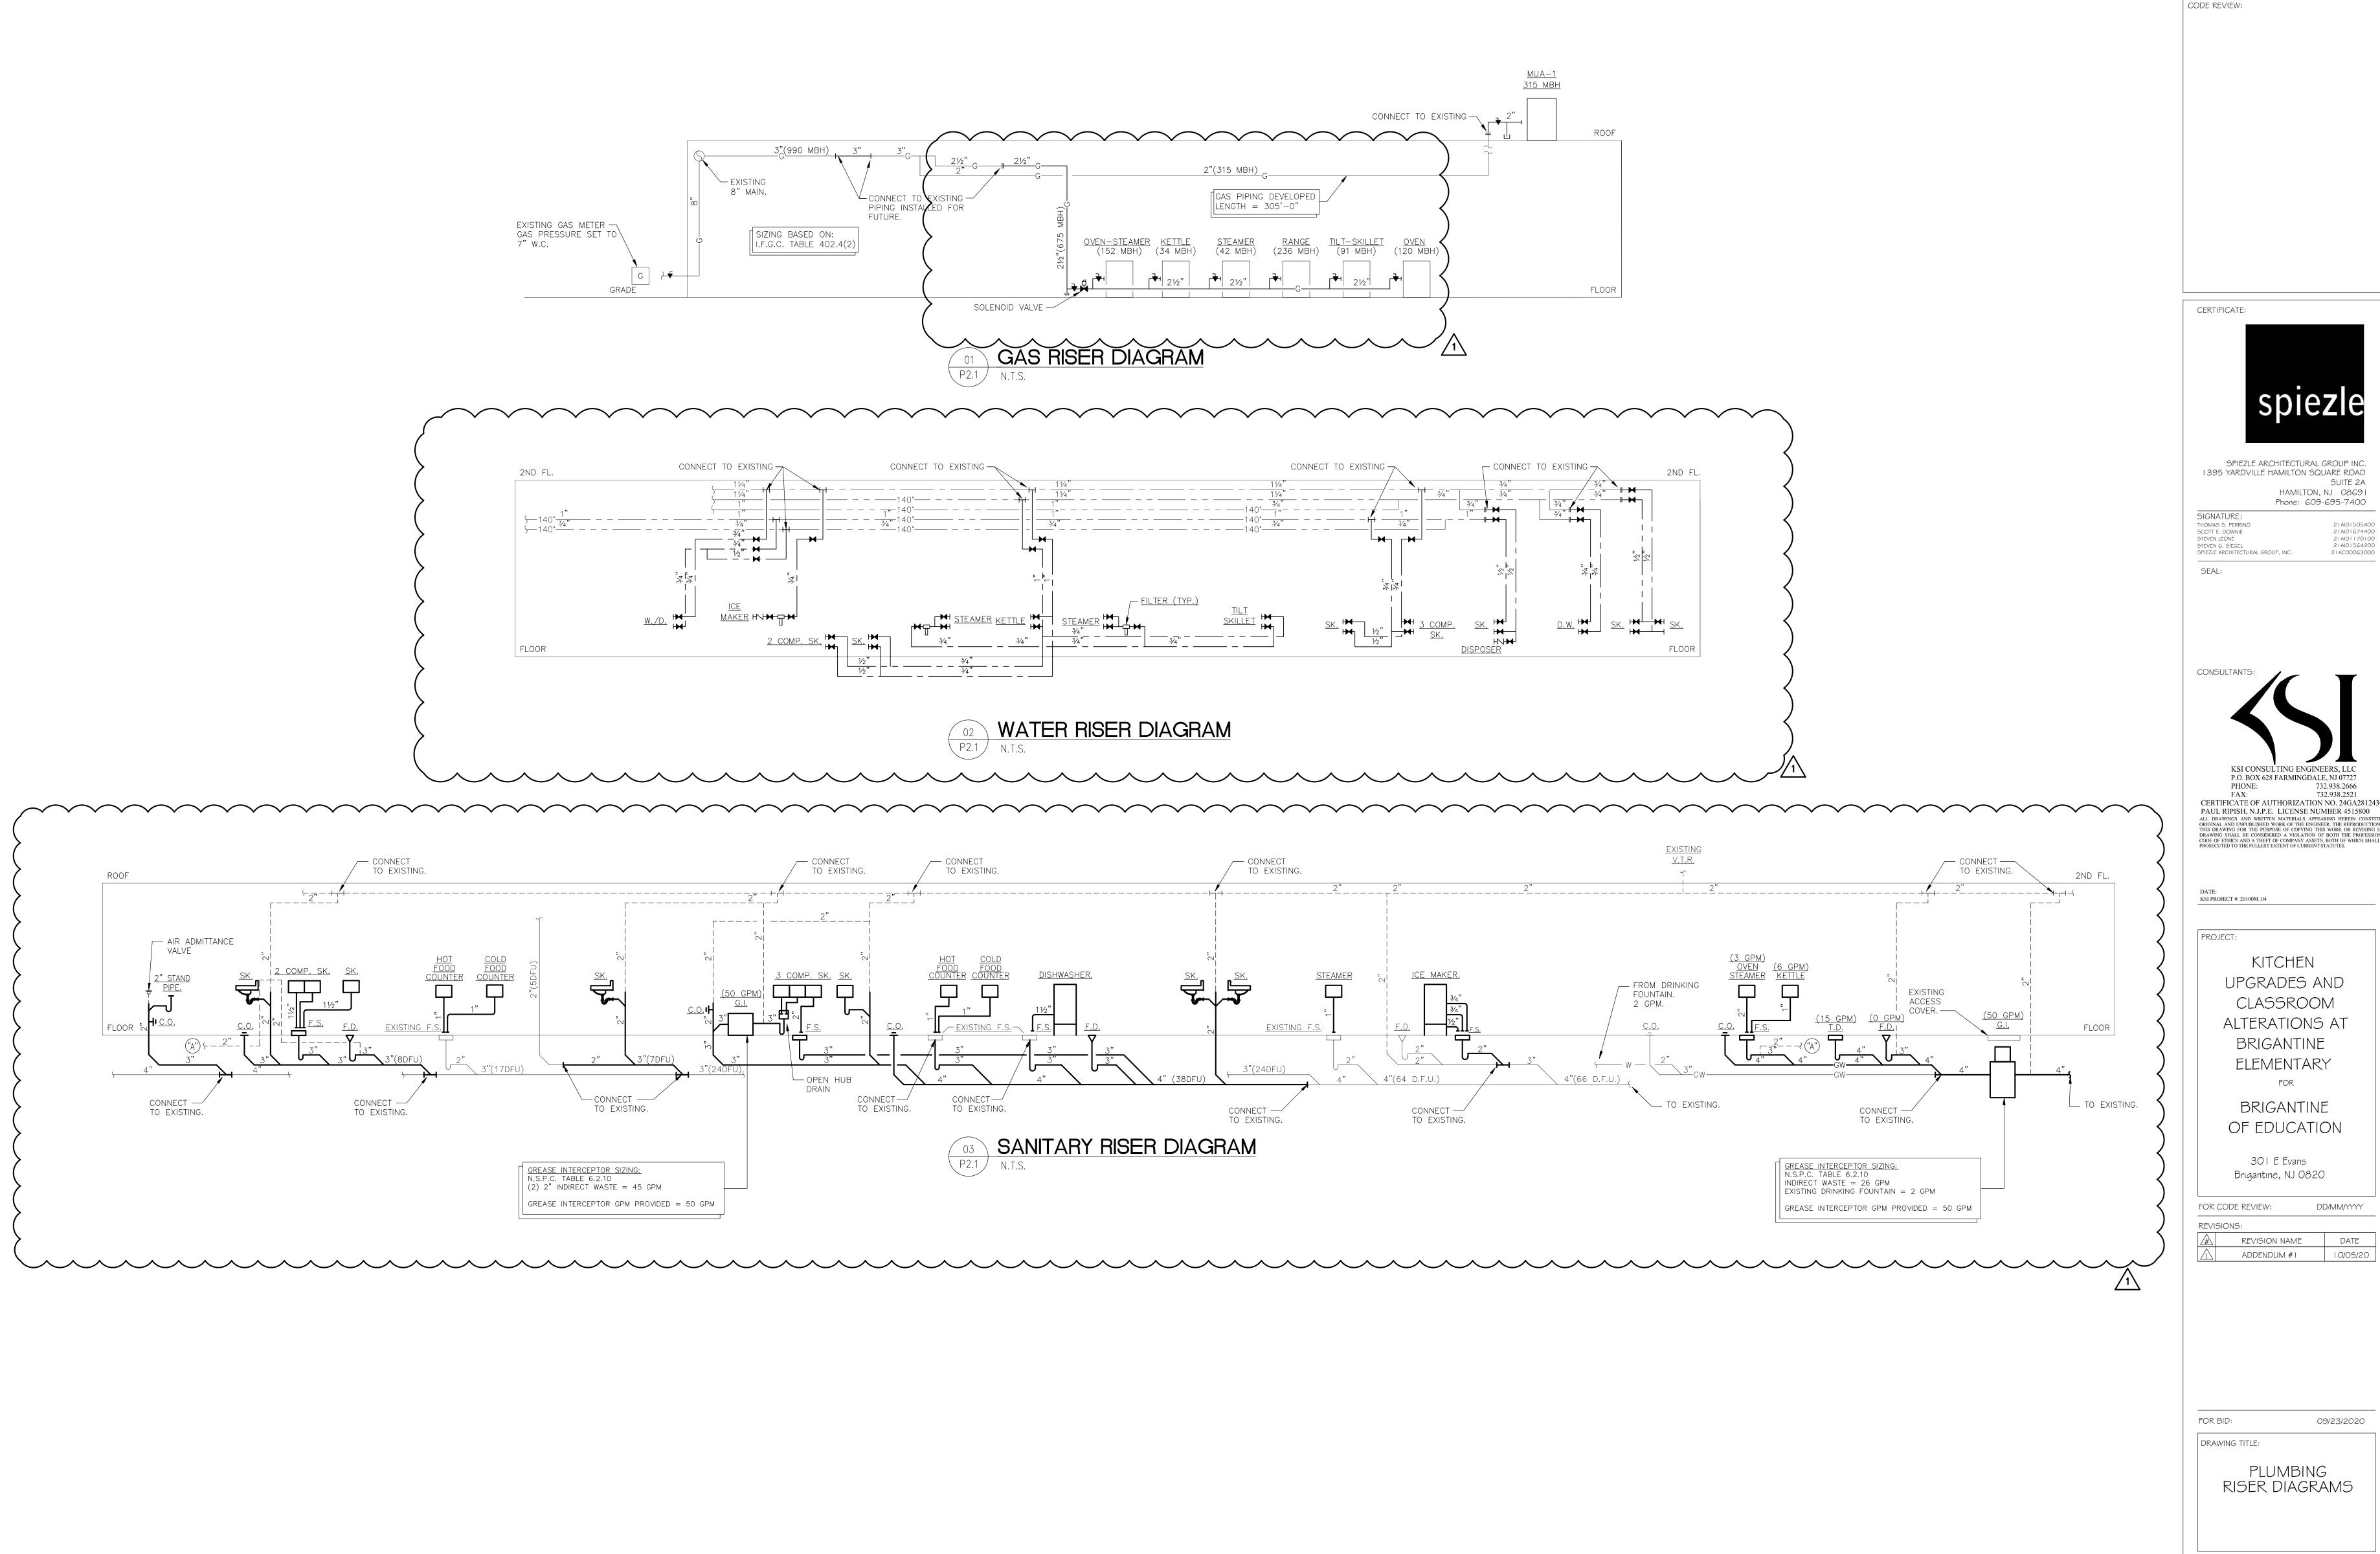

SPIEZLE ARCHITECTURAL GROUP INC. 1395 YARDVILLE HAMILTON SQUARE ROAD SUITE 2A HAMILTON, NJ 08691


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DATE 10/05/20

COMMISSION NUMBER: 20K009 AGENCY NUMBER: 01-0570-300-20-2000 01-0570-300-21-1000 DO NOT SCALE THE DRAWINGS

P2.1

DRAWING NUMBER:

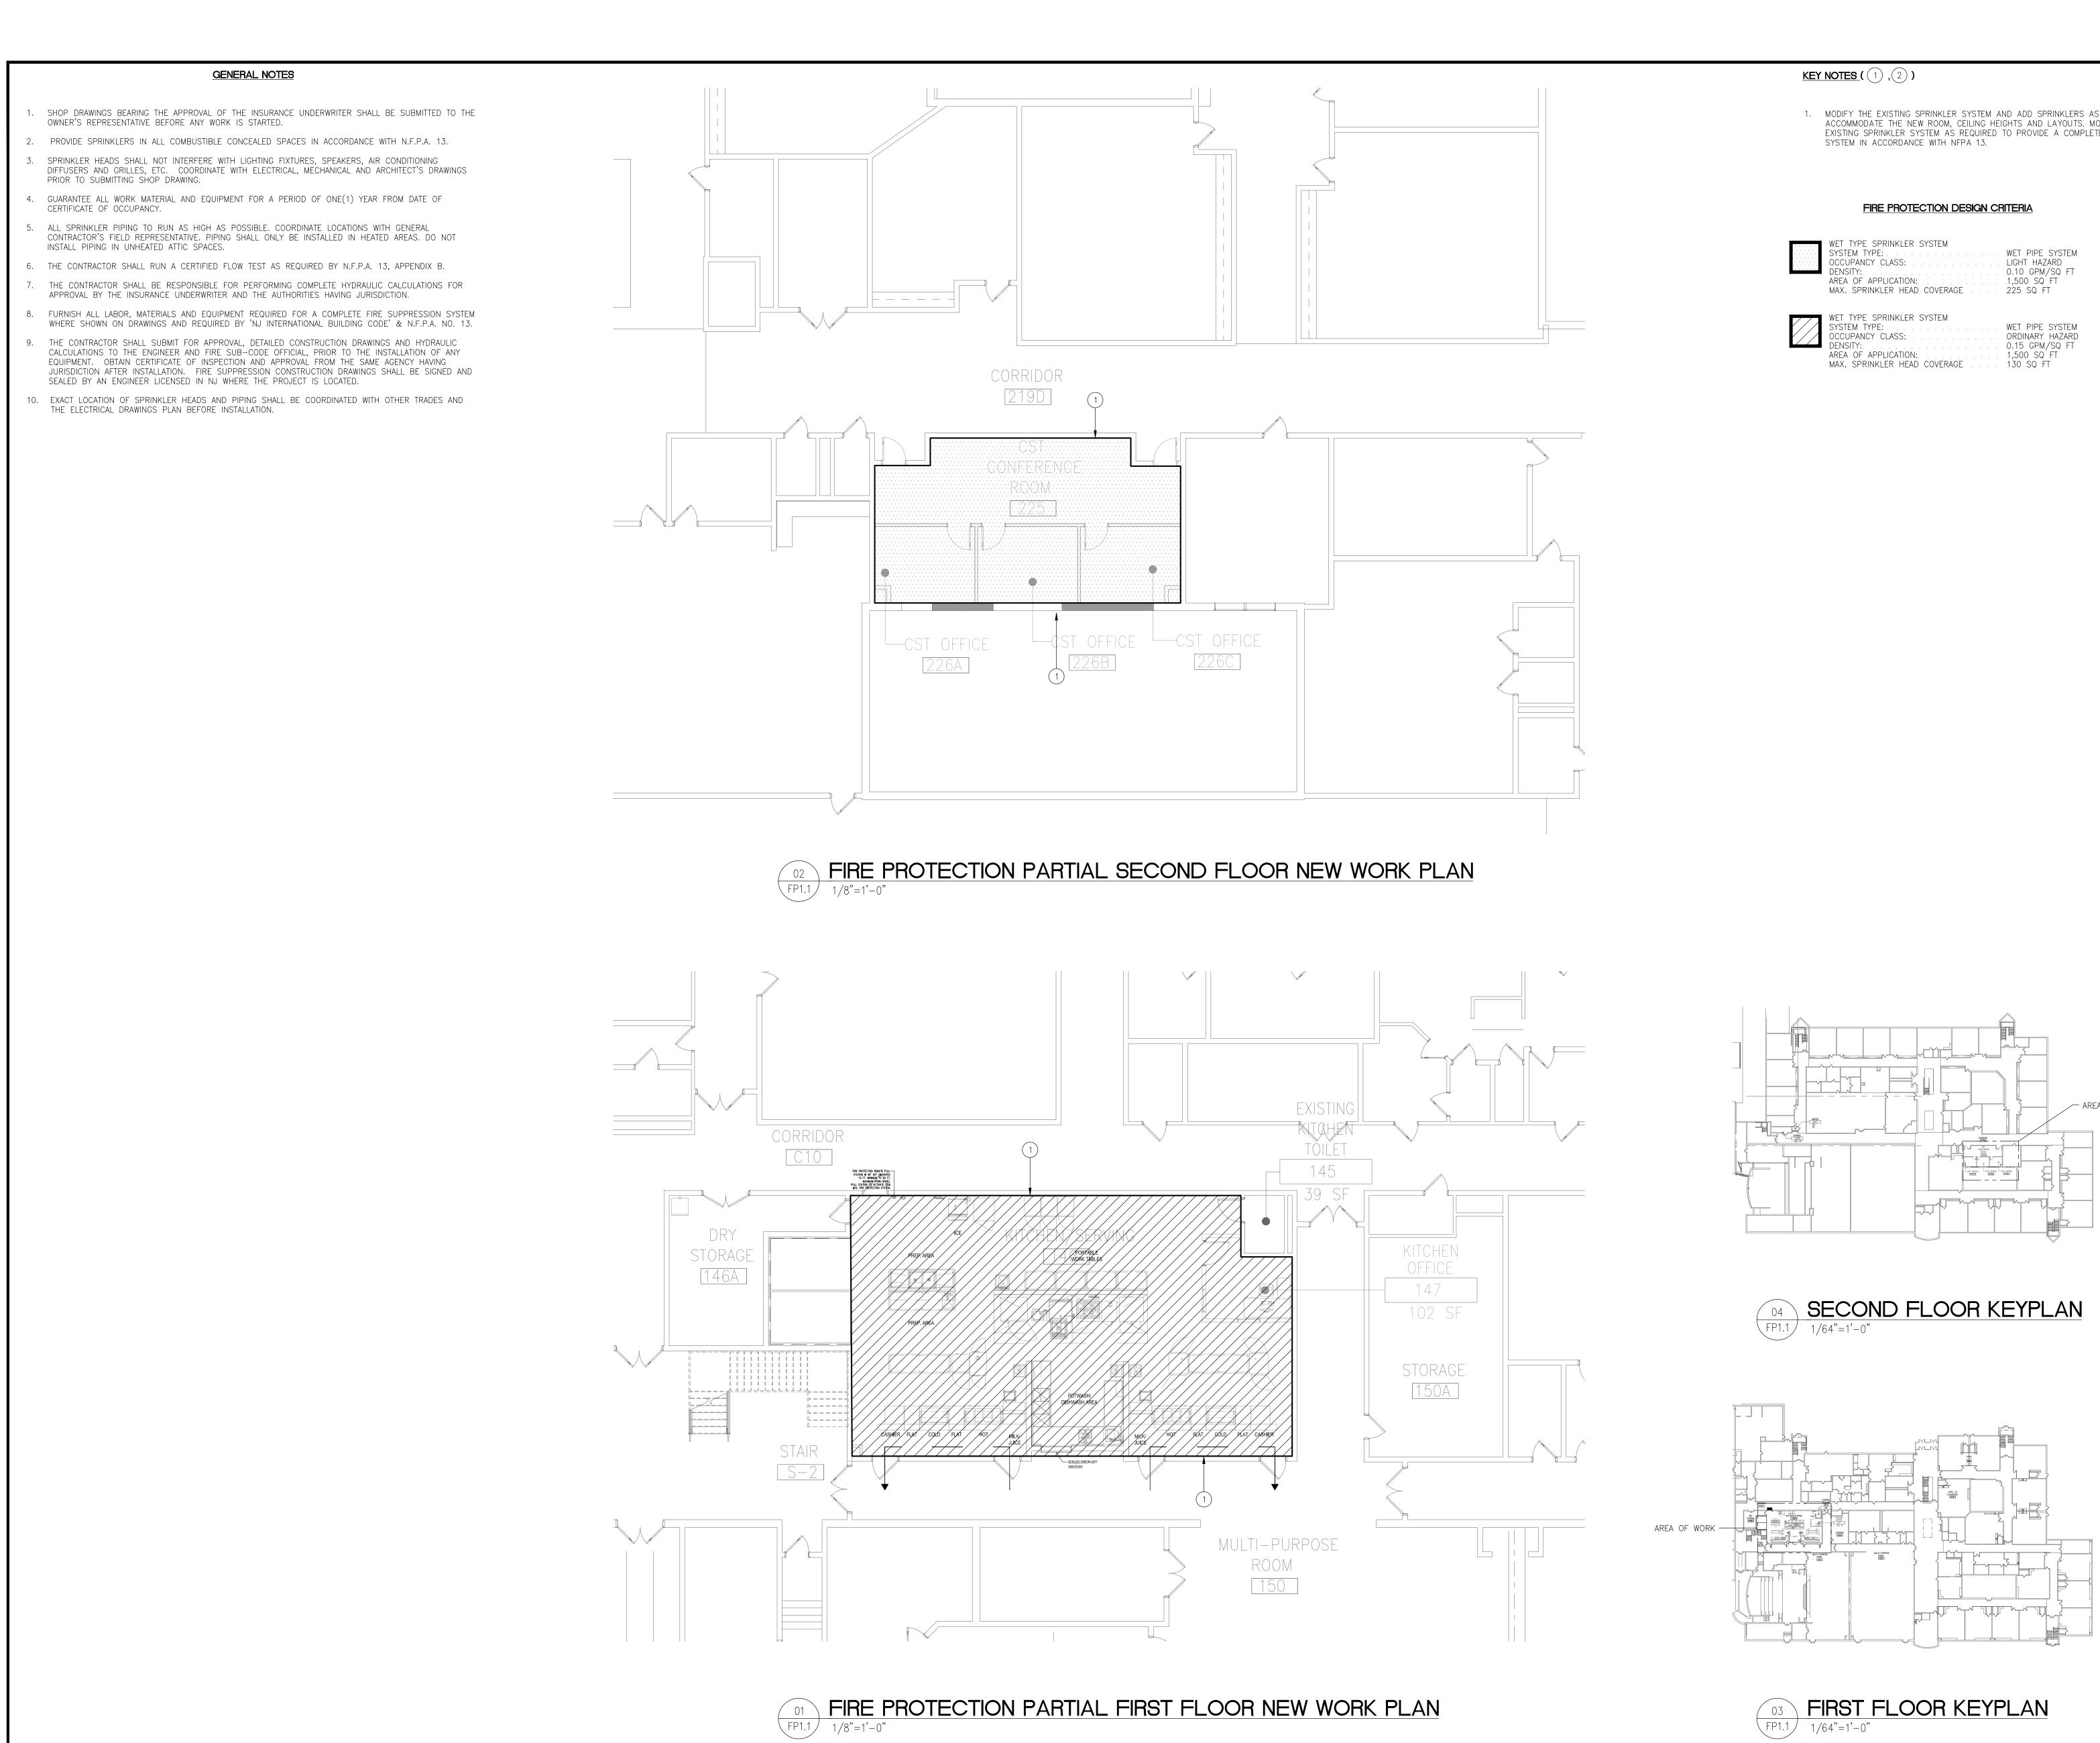

CODE REVIEW: 1. MODIFY THE EXISTING SPRINKLER SYSTEM AND ADD SPRINKLERS AS REQUIRED TO ACCOMMODATE THE NEW ROOM, CEILING HEIGHTS AND LAYOUTS. MODIFY THE EXISTING SPRINKLER SYSTEM AS REQUIRED TO PROVIDE A COMPLETE SPRINKLER WET PIPE SYSTEM LIGHT HAZARD .0.10 GPM/SQ FT .1,500 SQ´FT WET PIPE SYSTEM ORDINARY HAZARD 0.15 GPM/SQ FT 1,500 SQ FT SEAL: FOR BID: FP1.1 1/64"=1'-0"

CERTIFICATE: SPIEZLE ARCHITECTURAL GROUP INC. 1395 YARDVILLE HAMILTON SQUARE ROAD Phone: 609-695-7400 SIGNATURE: THOMAS S. PERRINO SCOTT E. DOWNIE STEVEN LEONE STEVEN G. SIEGEL SPIEZLE ARCHITECTURAL GROUP, INC. CONSULTANTS: P.O. BOX 628 FARMINGDALE, NJ 07727 CERTIFICATE OF AUTHORIZATION NO. 24GA28124300 PAUL RIPISH, N.J.P.E. LICENSE NUMBER 4515800

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HAMILTON, NJ 08691

21Al01505400 21Al01674400

21Al01564200

21AC00063000

732.938.2666 732.938.2521

DD/MM/YYYY

DD/MM/YYYY

DATE

DO NOT SCALE THE DRAWINGS FP1.1

#### **ELECTRICAL GENERAL NOTES**

- ALL ELECTRICAL WORK SHALL CONFORM TO THE LATEST ADOPTED EDITIONS OF THE NATIONAL ELECTRICAL CODE, THE NFPA, N.J.A.C. AND THE INTERNATIONAL BUILDING CODE.
- THE CONTRACTOR MUST HAVE THE H.V.A.C., FIRE PROTECTION AND PLUMBING DRAWINGS FOR LOCATIONS OF EQUIPMENT AND CONTROL WIRING REQUIREMENTS. ONLY POWER FEEDER TO MECHANICAL EQUIPMENT ARE SCHEDULED ON THE ELECTRICAL DRAWINGS. FURNISH AND INSTALL ALL CODE REQUIRED DISCONNECT SWITCHES FOR MECHANICAL EQUIPMENT UNLESS SPECIFIED ON MECHANICAL DRAWINGS TO BE SUPPLIED BY MANUFACTURER. PROVIDE FUSED SWITCHES WHEREVER MANUFACTURER REQUIRES THEM.
- 3. ALL TELEPHONE/DATA WIRING IS BY THE OWNER.
- I. CONDUCTOR SIZES(PHASE AND BOND) SHALL BE INCREASED DUE TO DERATING AND VOLTAGE DROP REQUIREMENTS AS NECESSARY. USE A MINIMUM #10 AWG FOR 20 AMPERE CIRCUITS AS FOLLOWS; 120V. -OVER 120', 208V. - OVER 210', 277V. - OVER 279', 480V. - OVER 484'(BASED ON LOAD AT MIDPOINT OF BRANCH CIRCUIT RUN @ 60% OF RATED LOAD). USE #8 FOR 20A. CIRCUITS @ 277V. FROM 211' TO 334', AND 20A CKTS @ 120V. FROM 191' TO 301', (FOR #8 PROVIDE AND INSTALL SPLICE/TAP J-BOX BEFORE CONNECTION TO LOAD AND TRANSFER TO #12AWG FOR CONNECTION TO DEVICE TERMINALS).
- . ALL NEW ELECTRICAL SYSTEMS, INCLUDING LIGHTING, CONDUIT, PANELS, ETC., SHALL BE SEISMICALLY BRACED IN ACCORDANCE WITH INTERNATIONAL BUILDING CODE.
- 6. PANELBOARD LOCKS SHALL BE KEYED IN ACCORDANCE TO OWNER REQUIREMENTS.
- $^7$ . SEPARATE NEUTRALS SHALL BE RUN FOR ALL CIRCUITS UTILIZING SWITCH MODE POWER SUPPLIES(EG. COMPUTERS, FLUORESCENT LIGHTING, ETC.).
- B. ALL RACEWAYS FEEDING ISOLATED GROUND DEVICES SHALL INCLUDE AN ISOLATED GROUND WIRE SIZED IN ACCORDANCE TO THE NEC.


9. AS-BUILTS SHALL BE PROVIDED WITHIN 30 DAYS OF SYSTEM ACCEPTANCE, INCLUDING BUT NOT LIMITED TO

- SINGLE-LINE OF ELECTRICAL DISTRIBUTION SYSTEM AND FLOOR PLAN WITH LOCATIONS OF DISTRIBUTION EQUIPMENT AND AREAS SERVED BY THAT EQUIPMENT.(ASHRAE/IESNA STANDARD 90.1-1999.) 10. O & M MANUALS MUST BE PROVIDED FOR THE ELECTRICAL DISTRIBUTION SYSTEM, INCLUDING BUT NOT LIMITED
- TO NAMEPLATE RATINGS, SCHEDULED MAINTENANCE, SPECIFIC EQUIPMENT SUPPLIED, NAMES AND ADDRESSES OF QUALIFIED SERVICE AGENCIES, COMPLETE NARRATIVE AND SCHEMATIC OF SYSTEM IN NORMAL OPERATION.(ASHRAE/IESNA STANDARD 90.1-1999.)
- 11. THE ELECTRICAL CONTRACTOR IS TO VERIFY CEILING TYPE AND SPACE LIMITATIONS PRIOR TO ORDERING FIXTURES.
- 12. FURNISH AND INSTALL ALL LABOR, PROGRAMMING, MATERIALS AND EQUIPMENT REQUIRED FOR A NEW INTERCOM/CLOCK SYSTEM, AS COVERED BY THESE SPECIFICATIONS, TO BE WIRED, CONNECTED AND LEFT IN FIRST CLASS OPERATING CONDITION. ALL EQUIPMENT SHALL BE UL LISTED.
- 13. INTERCOM SYSTEM SHALL INCLUDE BUT NOT BE LIMITED TO SYSTEM PHONES, SPEAKERS, CALL SWITCHES, AND CLOCKS.
- 14. EACH SPACE SHALL BE PROVIDED WITH BOTH A CALL SWITCH WITH A TALK BACK SPEAKER AND SYSTEM PHONE. PROVIDE A UNIQUE ADDRESS FOR EACH DEVICE IN EACH SPACE,. FOR A TOTAL OF TWO ADDRESSES PER SPACE WHERE A CALL SWITCH AND PHONE ARE LOCATED ON THE PLANS.
- 15. COMPLETELY REMOVE THE OLD INTERCOM SYSTEM, INCLUDING BUT NOT LIMITED TO PHONES, CALL SWITCHES, SPEAKERS, WIRING, RACKS, EQUIPMENT, ETC.

#### **ELECTRICAL SYMBOL LEGEND**

#### **DESCRIPTION**

CEILING OR PENDANT MOUNTED FLUORESCENT FIXTURE AND OUTLET.  $\alpha$  = SWITCH CONTROL. 3 = CIRCUIT NUMBER - TYPICAL FOR ALL FIXTURES.

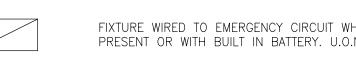

<u>SYMBOL</u>

FIXTURE WIRED TO EMERGENCY CIRCUIT WHERE EMERGENCY GENERATOR IS PRESENT OR WITH BUILT IN BATTERY. U.O.N.

LINEAR WALL WASH(UNSHADED SIDE DESIGNATES DIRECTION OF WASH) INDUSTRIAL OR STRIP FLUORESCENT FIXTURE.

LIGHTING FIXTURE WIRED TO EMERGENCY CIRCUIT OR WITH BUILT IN BATTERY.

WALL MOUNTED LIGHT FIXTURE, EMERGENCY CIRCUIT OR BATTERY BACK-UP.

CEILING MOUNTED EXIT SIGN, WALL MOUNTED EXIT SIGN. 90" TO BOTTOM OF SIGN OR CENTERED ON WALL AREA BETWEEN TOP OF DOOR AND CEILING. ARROWS AS INDICATED, SHADED AREA INDICATES FACE(S).

LED EXIT SIGN WITH BATTERY PAK AND LOCAL EMERGENCY HEADS.

BATTERY OPERATED EMERGENCY LIGHTING. 90" TO BOTTOM OF FIXTURE OR CENTERED ON WALL AREA BETWEEN TOP OF DOOR AND CEILING. (90 MINUTE MINIMUM CAPACITY)

LIGHT FIXTURE, A=LIGHTING FIXTURE TYPE, B=FOOTCANDLES AND X=CIRCUIT NUMBER SINGLE POLE 20A, TOGGLE TYPE SWITCH MOUNTED 4'-0" AFF TO TOP. SUBLETTER "a" DENOTES FIXTURE CONTROLLED. U.O.N.

THREE WAY SWITCH FOUR WAY SWITCH

DIMMER SWITCH-LUTRON MAESTRO SMART DIMMER, TYPE TO MATCH LAMP AND SINGLE OR MULTIPLE LOCATIONS. U.O.N.

MANUAL MOTOR STARTER(THERMAL ELEMENT)

SWITCH W/PILOT LIGHT SINGLE RECEPTACLE AS NOTED ON PLANS.

DUPLEX CONVENIENCE RECEPTACLE 20A. 125V. MOUNTED 1'-4" A.F.F. TO CENTER. U.O.N. 3-CIRCUIT NUMBER. CH=ABOVE COUNTER HEIGHT AT 44" MAX TO ABOVE COUNTERS WHICH ARE 20"-25" DEEP. U.O.N. CP=CHILD PROOF.

DUPLEX RECEPTACLE MOUNTED ABOVE COUNTER HEIGHT.

GROUND FAULT RECEPTACLE

DOUBLE DUPLEX RECEPTACLE (QUAD)

DUPLEX RECEPTACLE MOUNTED ABOVE COUNTER HEIGHT WITH GROUND. (GFI)

QUAD RECEPTACLE MOUNTED ABOVE COUNTER HEIGHT WITH GROUND. (GFI)

COMBINATION TELE/COMM OUTLET W/ 1" CDT. RUN TO ABOVE ACCESSIBLE CEILING SPACE 1'-4" AFF TO € OF DEVICE. PROVIDE PULLSTRING AND END

BUSHINGS(NUMBER REPRESENTS # OF KEYSTONES IF NOT TYPICAL). JUNCTION BOX, CEILING OR WALL MOUNTED AS NOTED, ELECTRICAL CONTRACTOR TO MAKE ALL REQUIRED CONNECTIONS TO DESIGNATED EQUIPMENT.

RECESSED CEILING SPEAKER, WALL MOUNTED SPEAKER(BACKBOX WHERE REQUIRED) WITH 3/4"CONDUIT TO NEAREST ACCESSIBLE CEILING, CREATING A COMPLETE PATH TO THE LOCAL HEAD END EQUIPMENT WITH PULLSTRING. (COORD. WITH A/V DWGS),

(S)H(S)

ITEMS TO BE DEMOLISHED AND REMOVED

COMPONENTS AND ACCESSORIES.

OCCUPANCY SENSOR

POWER POLE WITH POWER AND DATA RACEWAY, ACTIVATION

EXPOSED CONDUIT OR CABLE

CONCEALED CONDUIT OR CABLE \_ \_ \_ NON-FUSIBLE DISCONNECT SWITCH

PANEL BOARD (LIGHTING OR RECEPTACLE) SURFACE MOUNTED

PANEL BOARD (LIGHTING OR RECEPTACLE) RECESSED GROUND ROD •—

FIRE ALARM MANUAL PULL STATION - 48"A.F.F. TO TOP OF DEVICE.

COMBINATION FIRE ALARM HORN STROBE (ADA) AS PER SPECIFICATIONS - 80" A.F.F TO BOTTOM OF DEVICE 15/75 CD MINIMUM. U.O.N.(TYPICAL).

FIRE ALARM SPEAKER (ADA) - 80" AFF TO BOTTOM OF DEVICE (TYPICAL). FIRE ALARM STROBE (ADA) - 80" AFF TO BOTTOM OF DEVICE 15/75 CD MINIMUM. U.O.N.(TYPICAL).

FIRE ALARM SMOKE DETECTOR (PHOTOELECTRIC UNLESS OTHERWISE NOTED), (I= IONIZATION) (ADDRESSABLE) CEILING MOUNTED.

FIRE ALARM HEAT DETECTOR - FIXED TEMP/RATE TO RISE. U.O.N.

CARBON MONOXIDE DETECTOR 

RECESSED IN FLOOR POKE-THROUGH FITTING FOR POWER/TELE/DATA. WALKER #RCATCBK(BS-WHERE SHOWN ON PLANS)(COM-50) SERIES. DATA KEYSTONES AND WIRING BY OTHERS. FOLLOW CDT REQUIREMENT FOR TYPICAL DEVICE. (4" CORE)

NEW WALL MOUNTED COMBINATION CLOCK/INTERCOM TO MATCH EXISTING 

#### **ELECTRICAL ABBREVIATION LEGEND**

<u>ABBREVIATION</u> **DESCRIPTION** AMPERE ALTERNATING CURRENT ABOVE FINISHED FLOOR

AUTHORITY HAVING JURISDICTION AIR HANDLING UNIT ABOVE RAISED FLOOR AMERICAN WIRE GAGE

COMPUTER AIR HANDLING UNIT CB CIRCUIT BREAKER ABOVE COUNTER HEIGHT

CENTRAL OFFICE GROUND BUS COMPUTER ROOM AIR CONDITIONER

DIRECT CURRENT D/S DISCONNECT SWITCH

EXISTING

ELECTRICAL CONTRACTOR ELECTRICAL METALLIC TUBING EMERGENCY POWER OFF PUSHBUTTON

EXISTING TO BE RELOCATED FIRE ALARM CONTROL PANEL

FRAME GROUND BUS

GROUND FAULT CIRCUIT INTERRUPTER HORSE POWER

INTERMEDIATE DISTRIBUTION FRAME ISOLATED GROUND

JUNCTION BOX THOUSAND CIRCULAR MILS

KILOVOLT – AMPERE KILOWATT

LIGHTING PANEL MAIN CIRCUIT BREAKER

MAIN DISTRIBUTION FRAME

MAIN DISTRIBUTION PANEL MAIN DISTRIBUTION SWITCHGEAR MDS MGB MAIN GROUND BUS

MAIN LUGS ONLY NEW NORMALLY CLOSED

NOT IN CONTRACT NIGHT LIGHT NORMALLY OPEN

OFFICE PRINCIPAL GROUND POINT

PANEL PGB PRINCIPAL GROUND BUS PRINCIPAL GROUND POINT

POWER PANEL POLY VINYL CHLORIDE CONDUIT

RELOCATED IN NEW POSITION RAISED FLOOR GROUND BUS RIGID GALVANIZED STEEL CONDUIT

RECEPTACLE PANEL SWITCH SWITCHBOARD SWITCHGEAR

TELEPHONE BACKBOARD VERY EARLY SMOKE DETECTION ALARM

WEATHER PROOF (NEMA RATED)(WHILE IN USE)

XFER TRANSFER XFMR TRANSFORMER EXPLOSION PROOF


#### - DERANGEMENT SIGNAL LIGHT TEST BUTTON (IN FIXTURE) (IN FIXTURE) BLACK 120 OR 277 ELECTRONIC VOLTS ----MODULE MODULE BROWN WHITE ROOM SWITCH OR -─ 1.5HRS MINIMUM OTHER CONTROL DEVICE WHERE INDICATED

1. WHERE INDICATED ON DRAWINGS THAT A FIXTURE IS CONTROLLED BY A LOCAL SWITCH, FIXTURE SHALL BE WIRED TO SHUT OFF WHEN SWITCH IS OFF. BATTERY MODULE IS ALWAYS HOT.

2. REFER TO MANUFACTURER'S WIRING DIAGRAM FOR ACTUAL CONDUCTOR COUNTS.

3. WHERE LIGHTING CONTROL SYSTEM IS APPLIED, THE BATTERY BALLAST MUST BE WIRED AHEAD OF SYSTEM



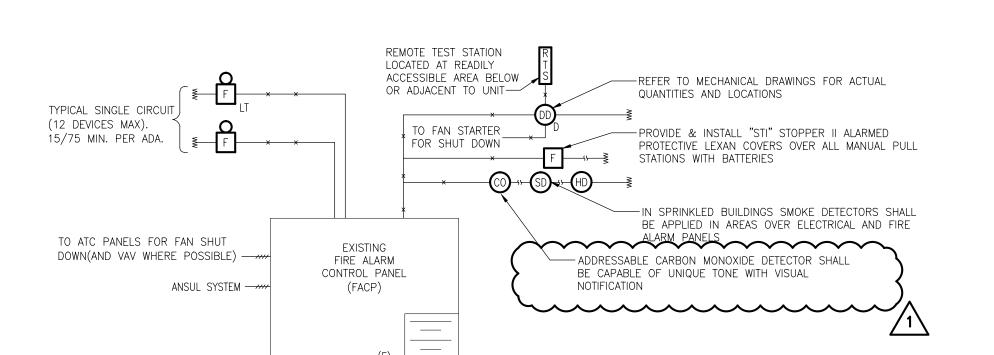

—×— 2#14 TWISTED SHIELDED, PLUS 2#14 AWG. ∫IN CONDUIT OR MC CABLE TREFER TO SPECIFICATIONS. — 2#14 AWG.

- 1. 120V, CIRCUIT DISCONNECTING MEANS SHALL HAVE A RED MARKING (RED TAPE) AND BE IDENTIFIED AS "FIRE ALARM CIRCUIT CONTROL" PER NFPA 72.
- 2. AUDIBLE ALARMS IN MECHANICAL ROOMS SHALL BE 90dBA IN ACCORDANCE WITH I.B.C. ARTICLE 907.9.2.
- 3. A/V LOCATION AND SPACING SHALL ADHERE TO NFPA 72-6-4.4.
- 4. INSTALLATION SHALL BE IN ACCORDANCE TO THE LATEST ADOPTED EDITION OF NFPA 72.
- 5. CONTRACTOR SHALL VERIFY OPERATION OF SMOKE DAMPERS AT THE KITCHEN WALLS AND IF NECESSARY VERIFY/REPROGRAM THE FIRE ALARM PANEL FOR PROPER OPERATION OF THE EXISTING SMOKE DAMPERS. REFER TO MECHANICAL PLANS FOR ADDITIONAL INFORMATION AND LOCATION OF THE SMOKE DAMPERS.





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SIGNATURE: THOMAS S. PERRINO SCOTT E. DOWNIE STEVEN G. SIEGEL SPIEZLE ARCHITECTURAL GROUP, INC.

SEAL:

CONSULTANTS: KSI CONSULTING ENGINEERS, LLC P.O. BOX 628 FARMINGDALE, NJ 07727 732.938.2666 PHONE: 732.938.2521 CERTIFICATE OF AUTHORIZATION NO. 24GA28124300 PAUL RIPISH, N.J.P.E. LICENSE NUMBER 4515800 ALL DRAWINGS AND WRITTEN MATERIALS APPEARING HEREIN CONSTITUTE ORIGINAL AND UNPUBLISHED WORK OF THE ENGINEER. THE REPRODUCTION OF THIS DRAWING FOR THE PURPOSE OF COPYING THIS WORK OR REVISING SAID DRAWING SHALL BE CONSIDERED A VIOLATION OF BOTH THE PROFESSIONAL CODE OF ETHICS AND A THEFT OF COMPANY ASSETS, BOTH OF WHICH SHALL BE PROSECUTED TO THE FULLEST EXTENT OF CURRENT STATUTES.

KSI PROJECT #: 20100M\_04

PROJECT:

KITCHEN UPGRADES AND CLASSROOM ALTERATIONS AT BRIGANTINE ELEMENTARY

> BRIGANTINE OF EDUCATION

> > 301 E Evans Brigantine, NJ 0820

FOR CODE REVIEW: DD/MM/YYYY **REVISIONS:** REVISION NAME DATE ADDENDUM #1 10/05/20


FOR BID:

DRAWING NUMBER:

09/23/2020 DRAWING TITLE:

> GENERAL INFORMATION


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## DE LECTRICAL PARTIAL SECOND FLOOR DEMOLITION PLAN

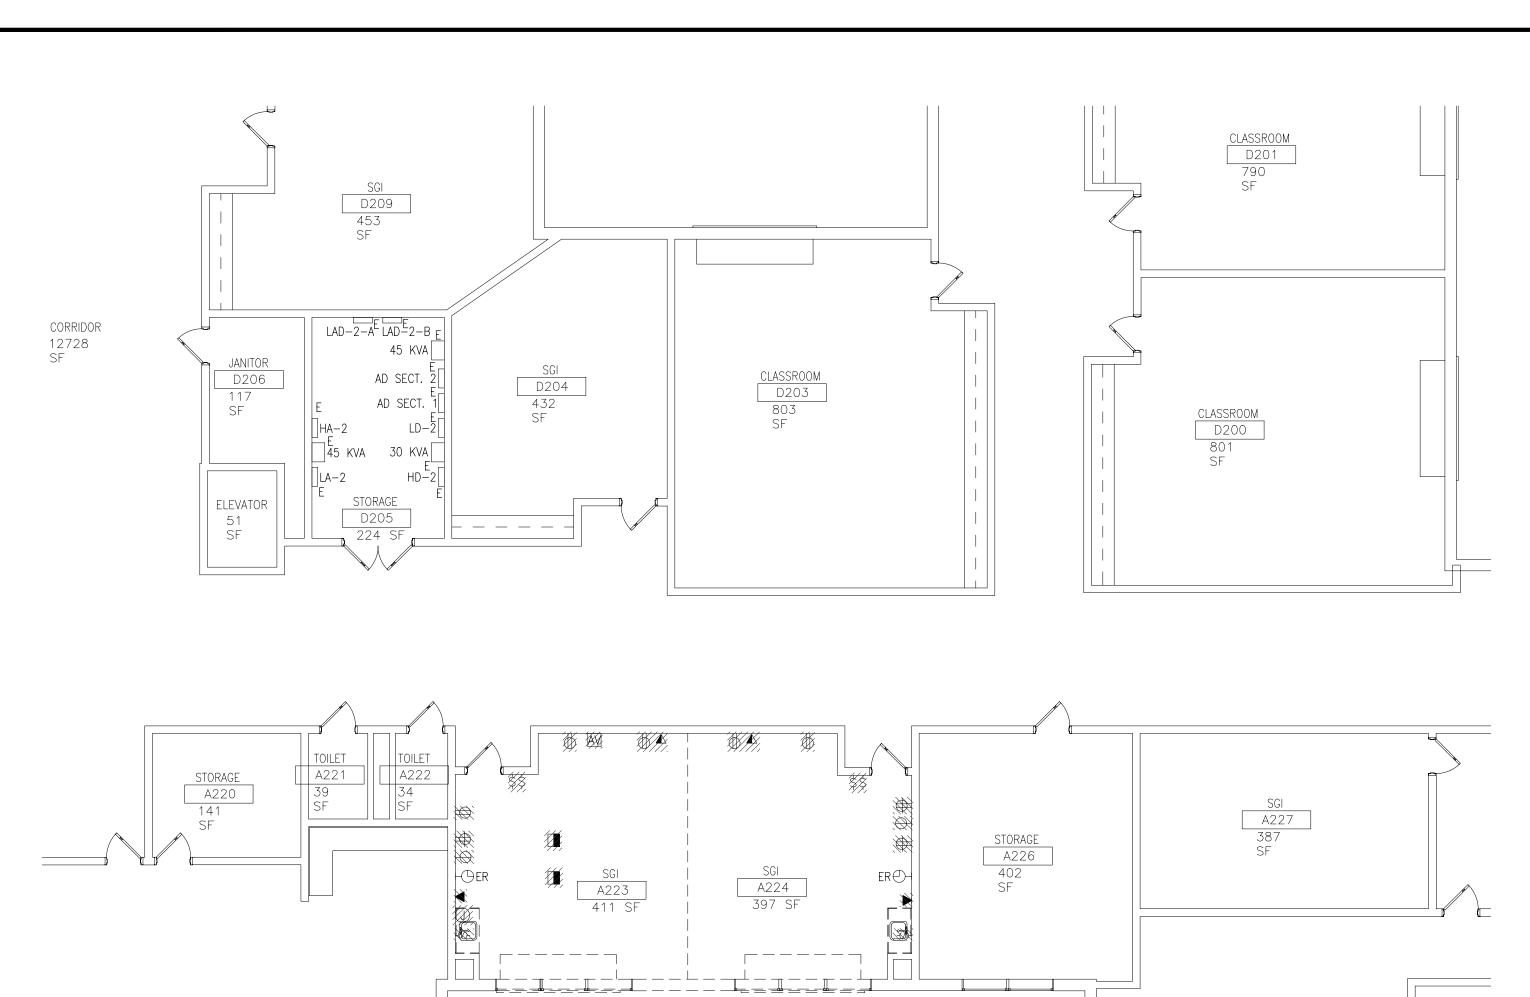
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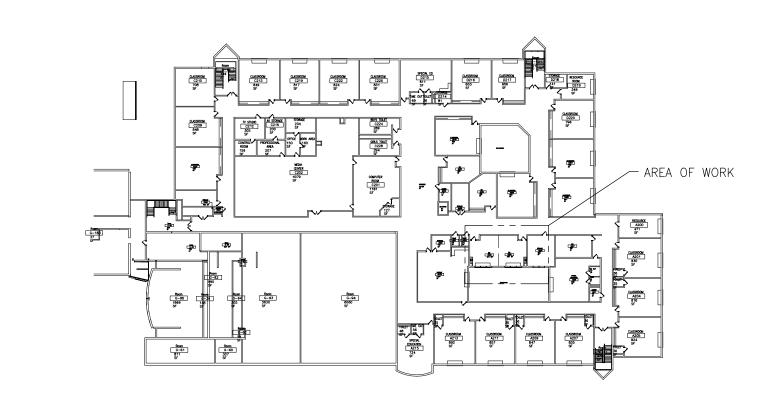


ED1.1 ELECTRICAL PARTIAL FIRST FLOOR DEMOLITION PLAN


[ED1.1] 1/8"=1'-0"

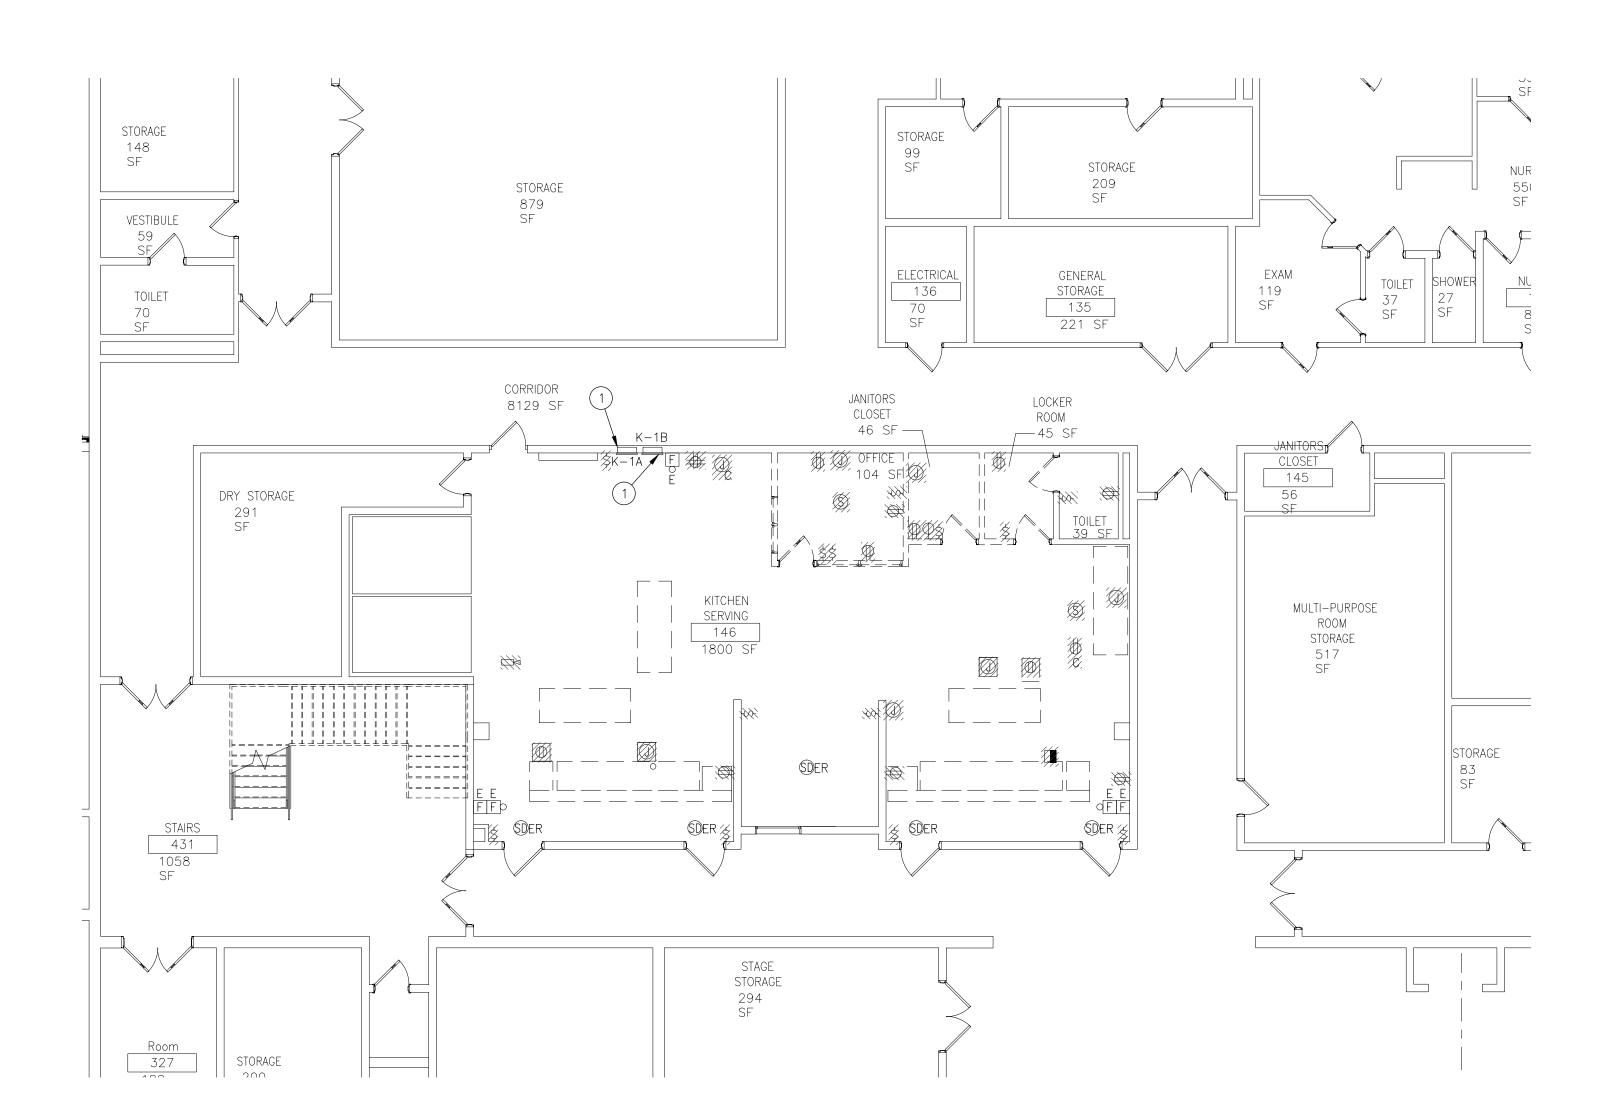

## 103 ELECTRICAL PARTIAL SECOND FLOOR DEMOLITION PLAN

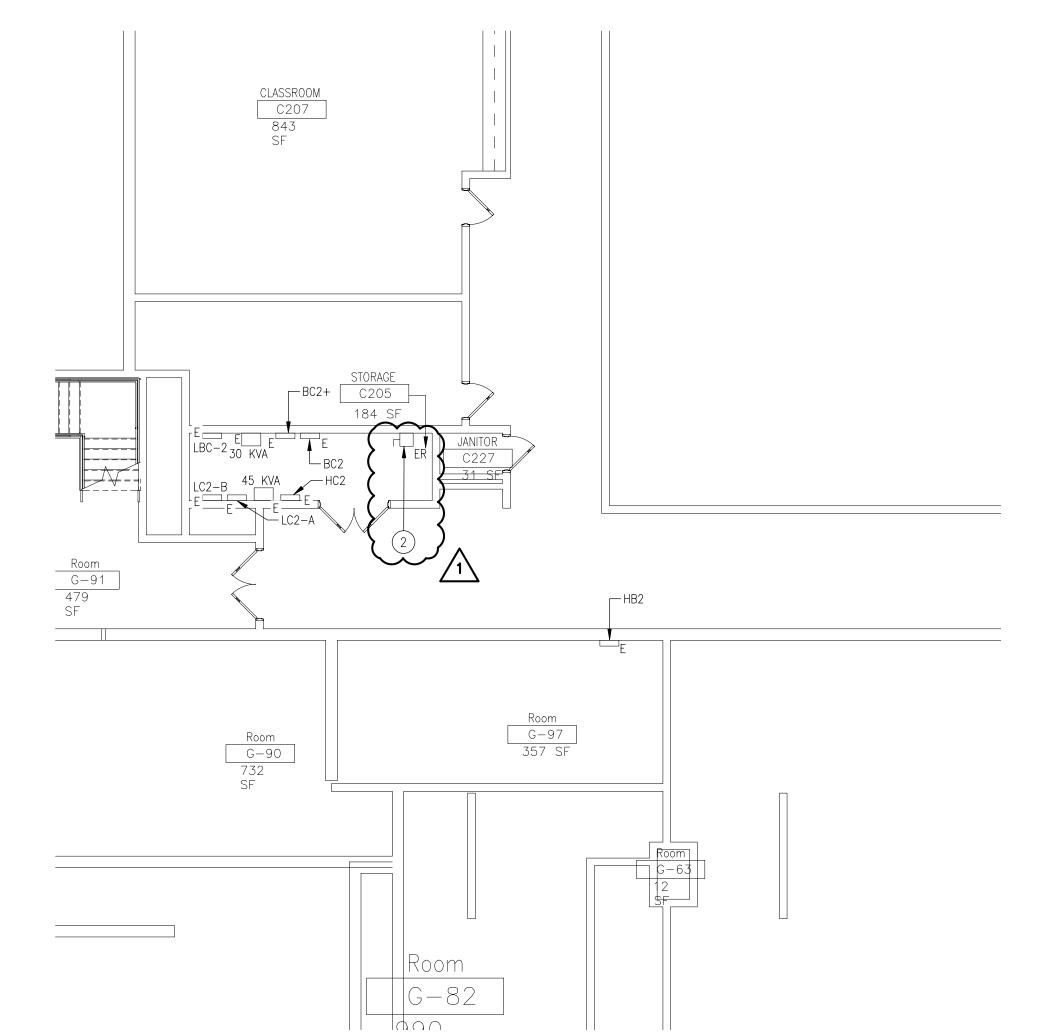



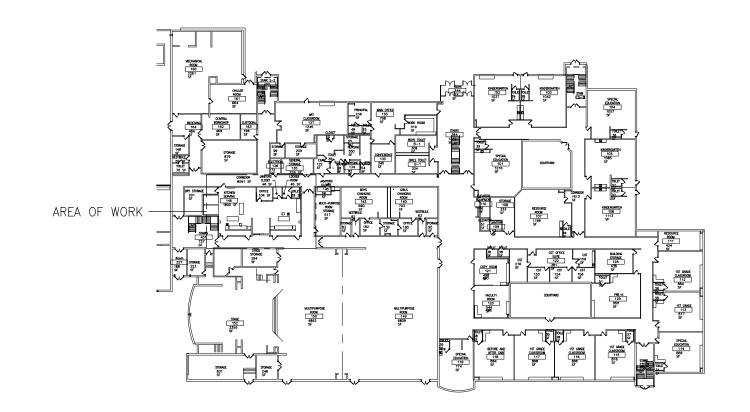

O4 FIRST FLOOR KEYPLAN

1/64"=1'-0"

KEY NOTES

1. EXISTING PANEL TO REMAIN. EXISTING FAN STARTER SHALL BE RELOCATED. DISCONNECT BOTH FEEDER AND BRANCH CONDUCTORS AND CONDUIT, MODIFY, EXTEND EXISTING TO ACCOMMODATE THE NEW LOCATION.



CODE REVIEW:

#### **DEMOLITION GENERAL NOTES**

- 1. CONTRACTOR SHALL VISIT THE SITE TO VERIFY EXISTING CONDITIONS PRIOR TO SUBMISSION OF BID. NO ADDITIONAL COMPENSATION SHALL BE CONSIDERED FOR FAILURE TO OBSERVE THIS REQUIREMENT.
- 2. THE CONTRACTOR SHALL DISCONNECT AND REMOVE ALL ELECTRICAL WIRING AND EQUIPMENT AS REQUIRED WITHIN ALL AREAS TO BE RENOVATED. THIS SHALL INCLUDE BUT NOT BE LIMITED TO FIXTURES, DEVICES, OUTLETS, SWITCHES, RECEPTACLES, STARTERS, DISCONNECTS, PANELS, FEEDERS,
- 3. THE CONTRACTOR SHALL DISCONNECT AND REMOVE ALL EXISTING CIRCUITS TO MECHANICAL EQUIPMENT BEING REMOVED. REFER TO ALL MECHANICAL DEMOLITION DRAWINGS OR NOTES FOR
- 4. WHERE ELECTRICAL ITEMS ARE REMOVED, ALL BRANCH DEVICE'S WIRING SHALL BE REMOVED BACK TO PANEL SERVICING THE EQUIPMENT. WHERE CIRCUITS SERVE ADDITIONAL DEVICES OR EQUIPMENT REMAINING, WIRING SHALL BE REMOVED BACK TO THE NEAREST ACTIVE JUNCTION BOX.
- 5. THE CONTRACTOR SHALL MAINTAIN CONTINUITY OF EXISTING CIRCUITS THAT ARE TO REMAIN IN OPERATION AND SCHEDULE FOR RE-FEEDING FROM NEW PANELS. FORWARD FINDINGS TO ENGINEER FOR REVIEW AND COORDINATION.
- 6. ALL UNUSED CIRCUITS REMAINING AFTER REMOVALS SHALL BECOME SPARE IN PANELS AND LABELED
- 7. THE CONTRACTOR SHALL REFER TO ARCHITECTURAL DEMOLITION DRAWINGS FOR ADDITIONAL INFORMATION AND SCOPE OF DEMOLITION.
- 8. ALL MATERIALS AND EQUIPMENT REMOVALS SHALL BE DISPOSED OF AS DIRECTED BY THE OWNER OR THE ARCHITECT.

SPIEZLE ARCHITECTURAL GROUP INC. 1395 YARDVILLE HAMILTON SQUARE ROAD SUITE 2A HAMILTON, NJ 08691

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Phone: 609-695-7400 THOMAS S. PERRINO SCOTT E. DOWNIE STEVEN LEONE STEVEN G. SIEGEL
SPIEZLE ARCHITECTURAL GROUP, INC. 21Al01564200 21AC00063000

SEAL:

CONSULTANTS: P.O. BOX 628 FARMINGDALE, NJ 07727 732.938.2666 732.938.2521 CERTIFICATE OF AUTHORIZATION NO. 24GA28124300 PAUL RIPISH, N.J.P.E. LICENSE NUMBER 4515800 ALL DRAWINGS AND WRITTEN MATERIALS APPEARING HEREIN CONSTITUTE ORIGINAL AND UNPUBLISHED WORK OF THE ENGINEER. THE REPRODUCTION OF THIS DRAWING FOR THE PURPOSE OF COPYING THIS WORK OR REVISING SAID DRAWING SHALL BE CONSIDERED A VIOLATION OF BOTH THE PROFESSIONAL CODE OF ETHICS AND A THEFT OF COMPANY ASSETS, BOTH OF WHICH SHALL BE PROSECUTED TO THE FULLEST EXTENT OF CURRENT STATUTES.

KSI PROJECT #: 20100M\_04

PROJECT:

KITCHEN UPGRADES AND CLASSROOM ALTERATIONS AT BRIGANTINE ELEMENTARY

BRIGANTINE OF EDUCATION

301 E Evans Brigantine, NJ 0820


FOR CODE REVIEW: DD/MM/YYYY **REVISIONS:** DATE REVISION NAME ADDENDUM #1 10/05/20

FOR BID: 09/23/2020


DRAWING TITLE: ELECTRICAL FIRST AND SECOND FLOOR DEMOLITION PARTIAL PLANS

COMMISSION NUMBER: 20K009 AGENCY NUMBER: 01-0570-300-20-2000 01-0570-300-21-1000 DO NOT SCALE THE DRAWINGS

EDI.I

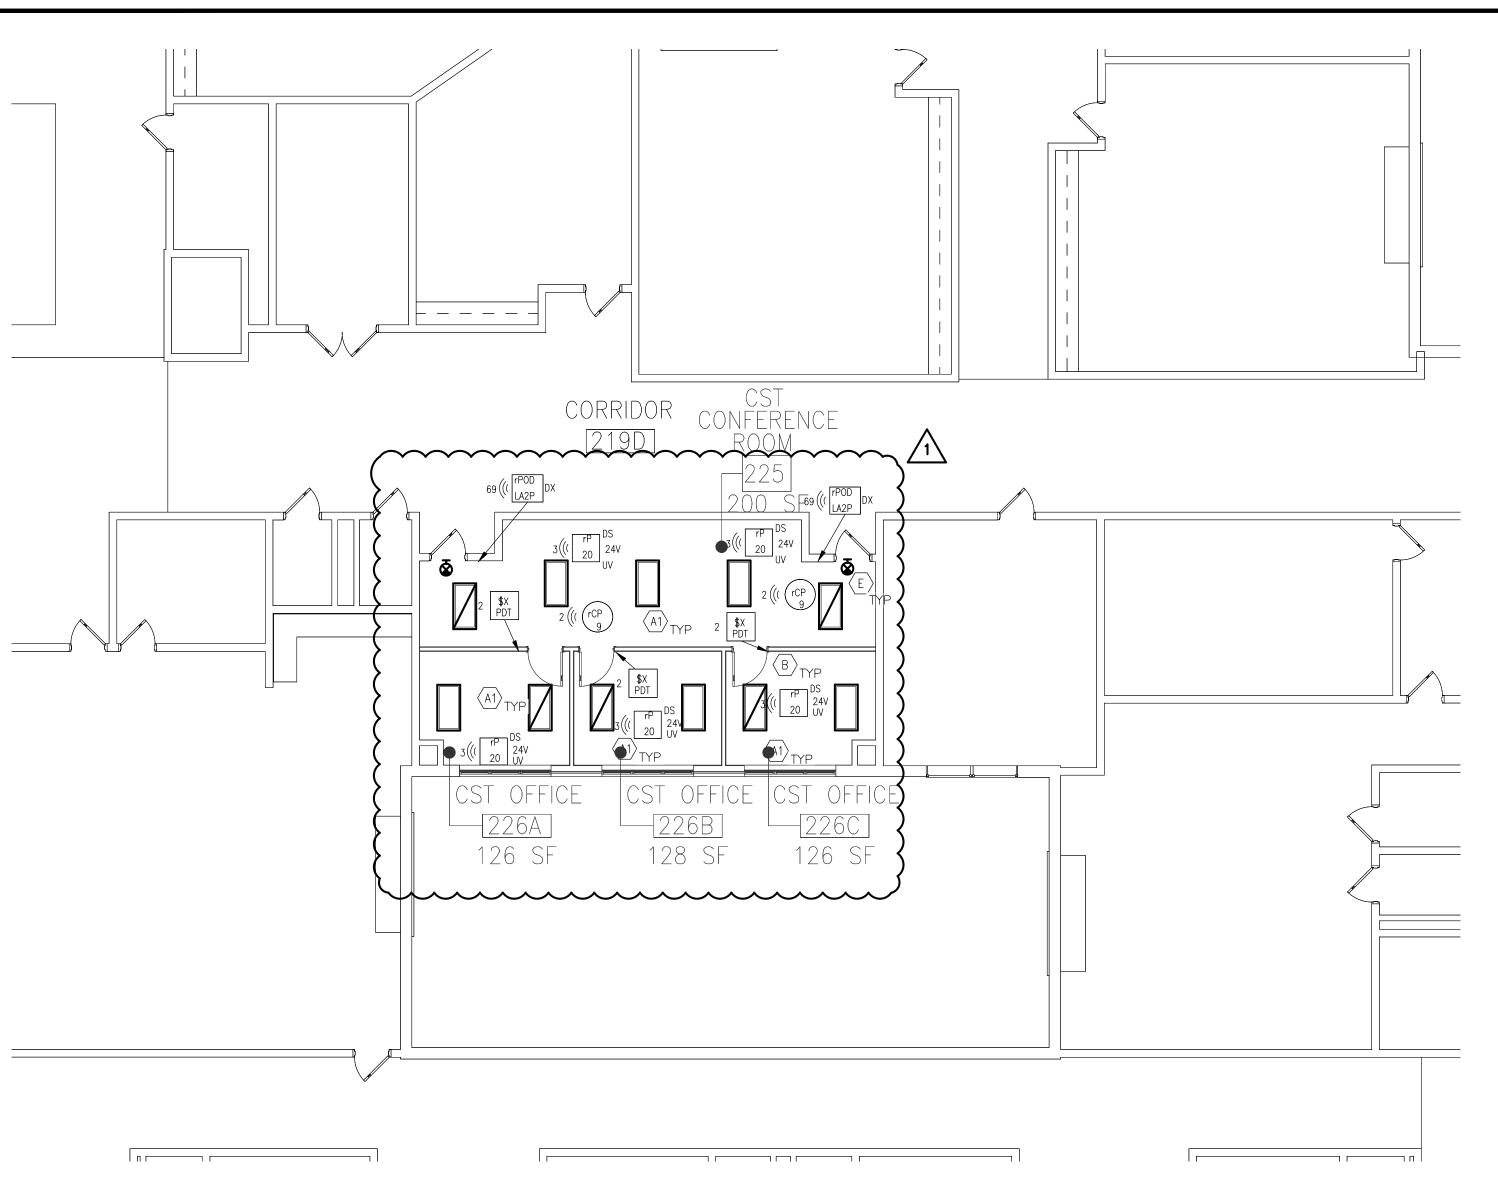

## ELECTRICAL PARTIAL SECOND FLOOR LIGHTING PLAN

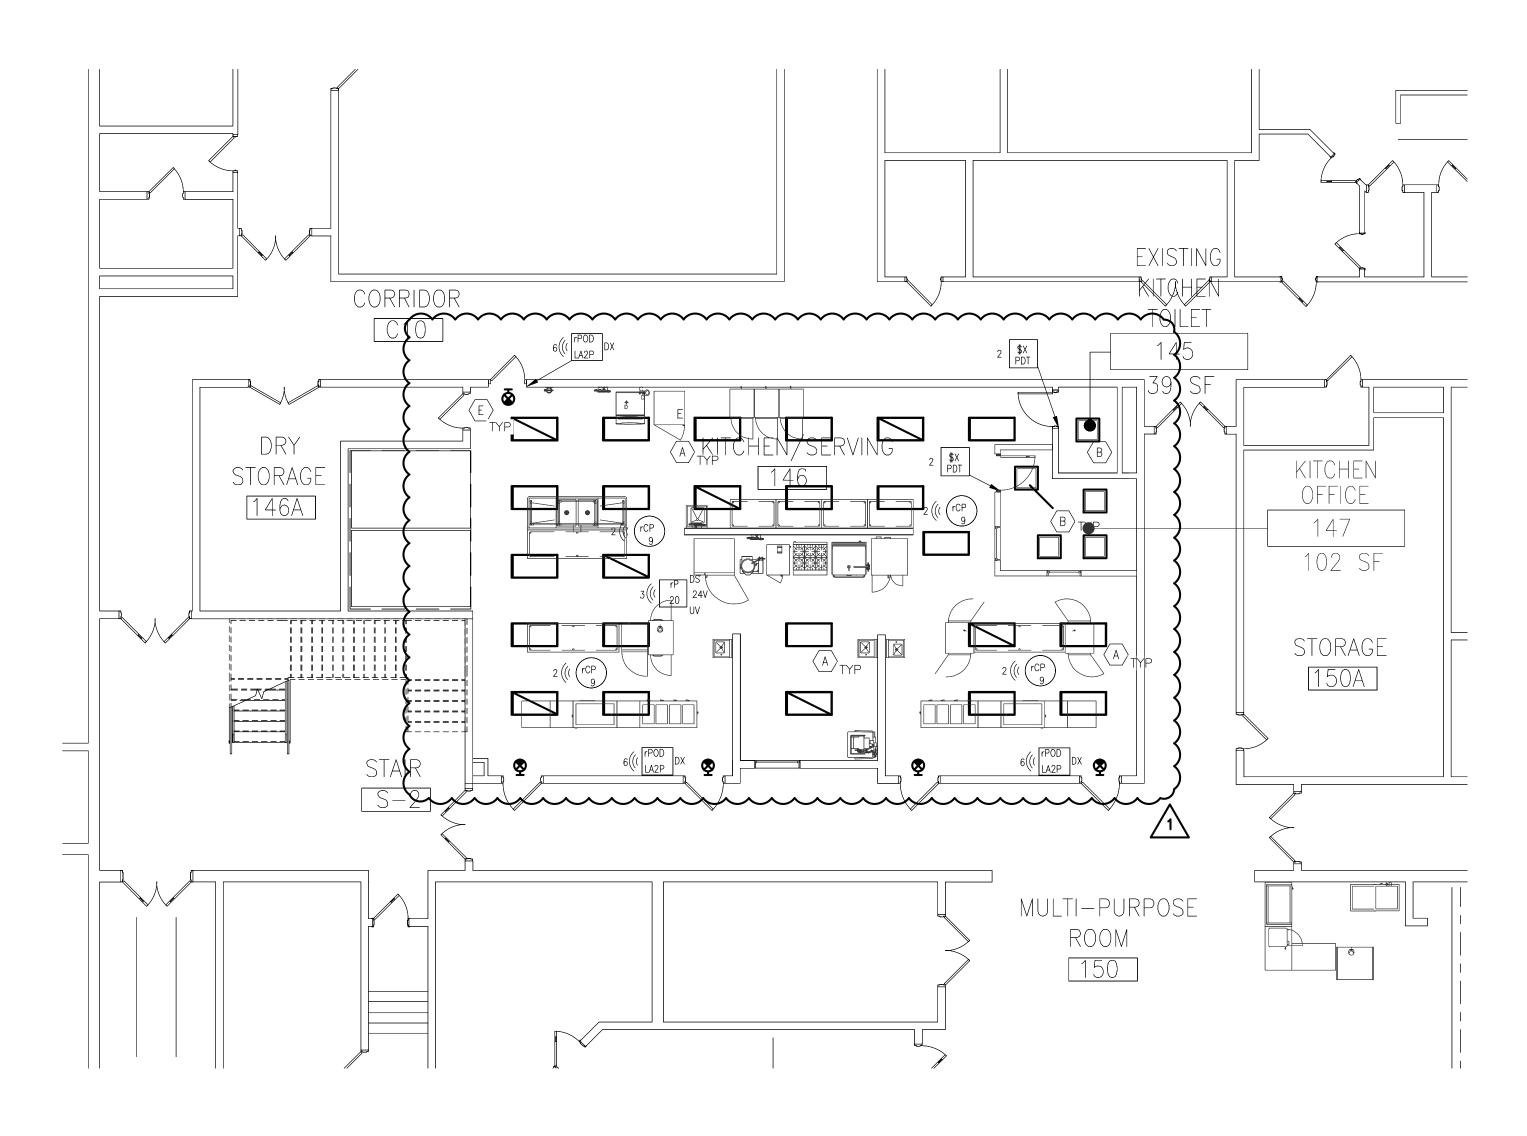

ELECTRICAL PARTIAL FIRST FLOOR LIGHTING PLAN

[E1.1] 1/8"=1'-0"

- 3 ((( rP 20 DS 24V EFP UVOLT H
  24V nLight Air Power/Relay Pack, Networked Version, Dimming Side Output, 24 volt output, External Fault Protection, 120-480VAC, Generation Two
- 2 ((( NECY DAIR H nLight Eclypse, nLight AIR adaptor for nECY, Generation Two
- 5 ((( rCP 10 Networked nLight AIR occupancy and daylight sensor, Passive Dual Technology, Large Motion / Extended Range 360\* Lens, Generation Two
- OS3
  RCMS PDT 9 H
  Networked nLight AIR occupancy and daylight sensor, Passive Dual Technology,
  Small Motion / Standard Range 360% Lens,
  Generation Two
- NECY MVOLT ENC GFXK
  nLight Eclypse, 120-277 VAC, 14 1/4"H x 14
  1/4"W x 4"D metal enclosure for ECLYPSE
  EnergySyte or nLight ECLYPSE., NGWY2
  GFX and PS 150 power supply with CAT5
  cable
- NCYD

  NCYD

  NCYD

  X150

  NCYD

  X150


  NCYD

  NCYD


  X150

  NCYD

  NCYD
- 2 \$X SO1 WSX PDT XX Wall Switch Sensor, Passive Dual Technology
- SW1
  RPODLA DX MVOLT XX H
  Aesthitic Line Powered Wall Switch,
  Raise/Lower Dimming Without Wires,
  120-277 VAC, Generation Two
- 6 (( rPOD LA2P DX MVOLT XX H
  Aesthitic Line Powered Wall Switch, 2-Pole,
  Raise/Lower Dimming Without Wires,
  120-277 VAC, Generation Two

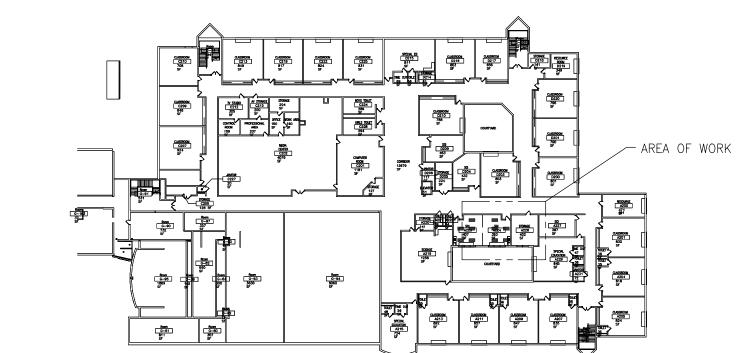



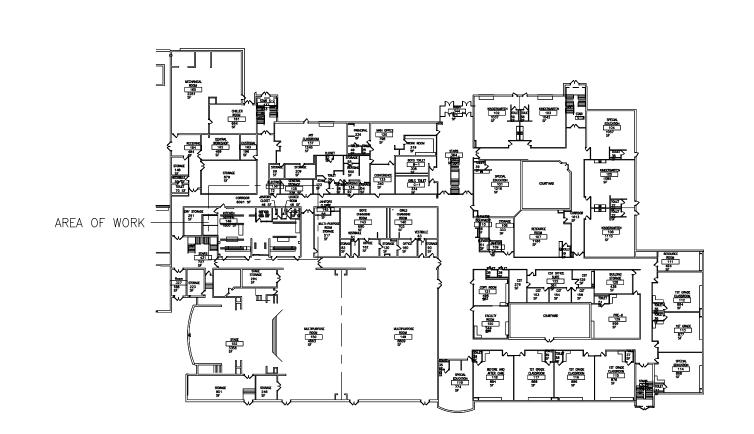

O4 FIRST FLOOR KEYPLAN
E1.1 1/64"=1'-0"

NLIGHT AIR SYMBOLS LEGEND

NO SCALE



- 1. CIRCUIT EMERGENCY BATTERY BALLAST WITHIN LIGHTING FIXTURE TO THE LOCAL LIGHTING CIRCUIT AHEAD OF SWITCHING WITH (2)#12+(1)#12G-3/4°C.
- 2. NEW LIGHTING FIXTURES SHALL BE CIRCUITED TO EXISTING LIGHTING CIRCUIT LEFT SPARE AFTER DEMOLITION PHASE WITH (2)#12 + (1)#12G IN  $\frac{3}{4}$ "C. DO NOT EXCEED 1,200 WATTS CONNECTED LOAD PER 20A CIRCUIT AT 120V OR 3,800 WATTS AT 277V.

CERTIFICATE:



SPIEZLE ARCHITECTURAL GROUP INC.
I 395 YARDVILLE HAMILTON SQUARE ROAD
SUITE 2A
HAMILTON, NJ 0869 I
Phone: 609-695-7400

21AI01505400 21AI01674400 21AI01170100

21Al01564200 21AC00063000

SIGNATURE:
THOMAS S. PERRINO
SCOTT E. DOWNIE
STEVEN LEONE
STEVEN G. SIEGEL
SPIEZLE ARCHITECTURAL GROUP, INC.

SEAL:



DATE: KSI PROJECT #: 20100M\_04

PROJECT:

KITCHEN
UPGRADES AND
CLASSROOM
ALTERATIONS AT
BRIGANTINE
ELEMENTARY

BRIGANTINE OF EDUCATION

FOR

301 E Evans Brigantine, NJ 0820

	FOR	CODE REVIEW: D	D/MM/YYYY
	REVI	SIONS:	
	<b>#</b>	REVISION NAME	DATE
	$\bigcirc$	ADDENDUM #1	10/05/20

FOR BID: 09/23/2020

ELECTRICAL
FIRST AND SECOND
FLOOR LIGHTING
PARTIAL PLANS

COMMISSION NUMBER:


20K009


AGENCY NUMBER:
01-0570-300-20-2000
01-0570-300-21-1000

DO NOT SCALE THE DRAWINGS

DRAWING
NUMBER:

= | . |

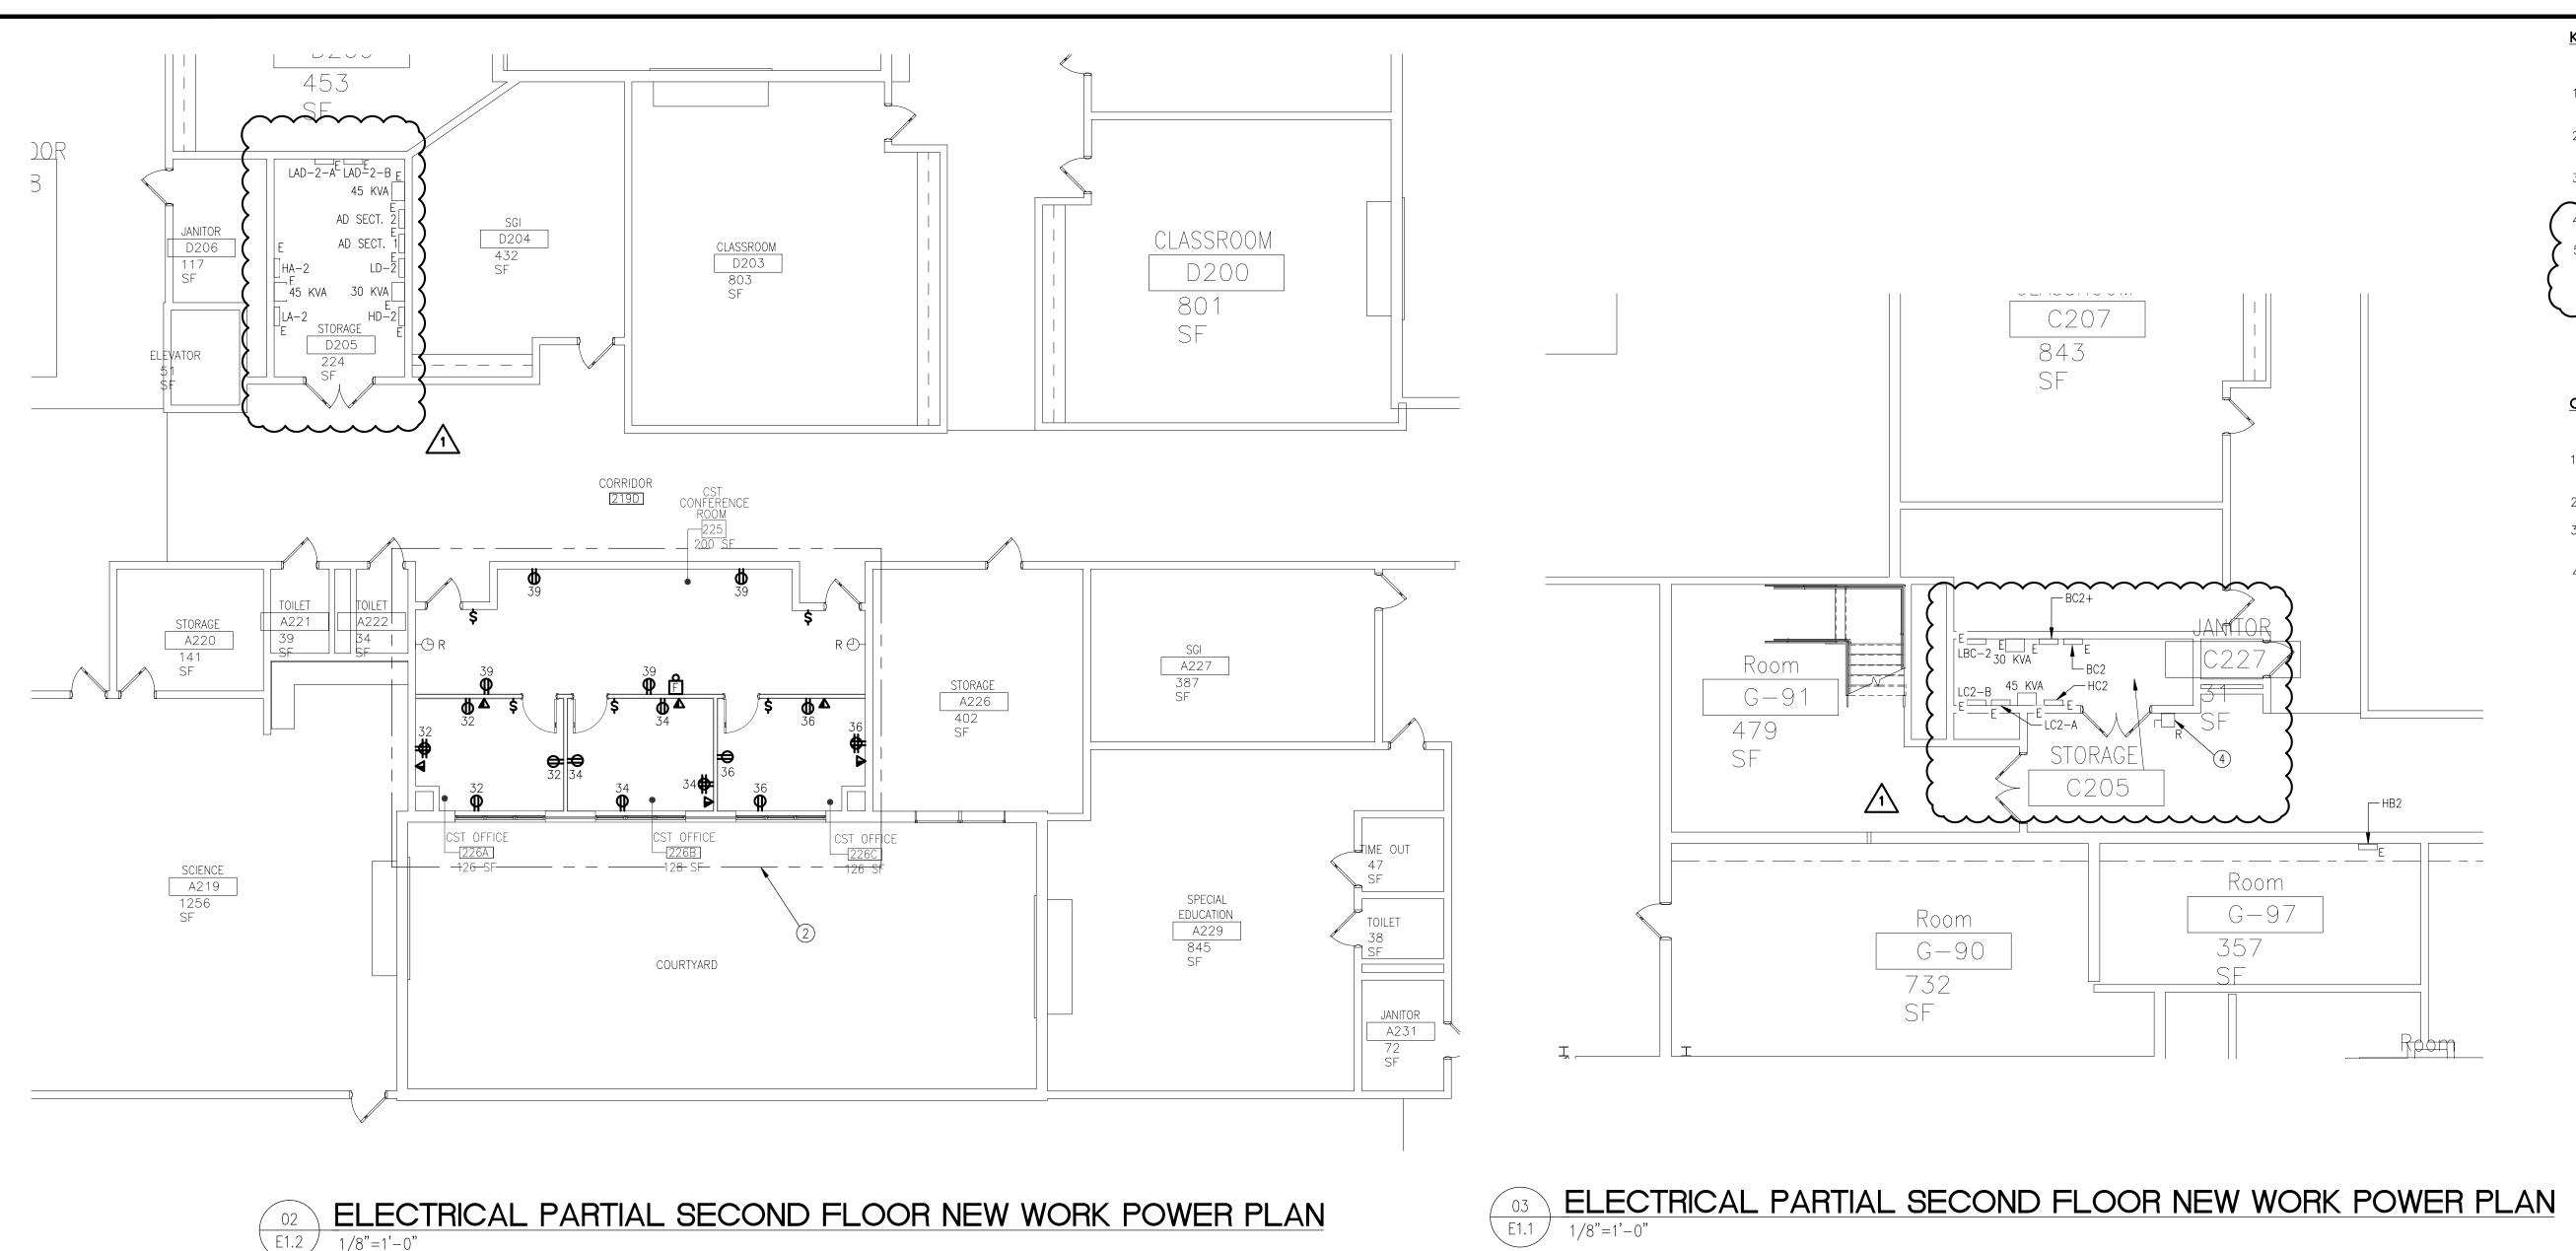

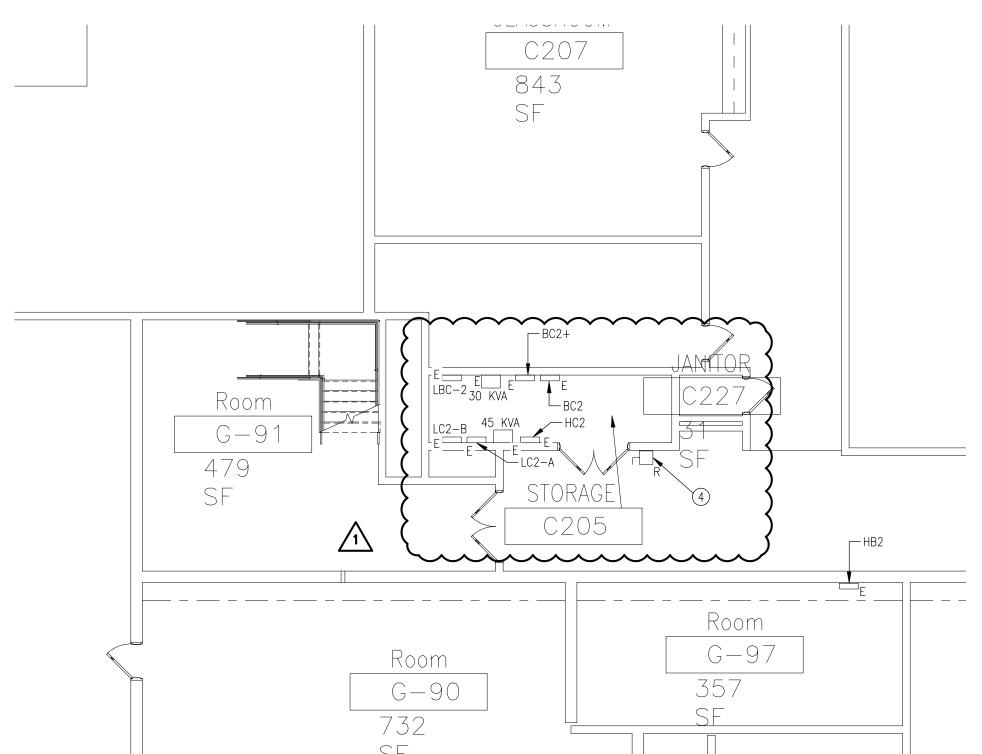

#### KEY NOTES

- 1. POWER POLE SHALL BE MODEL 30TP-2V AS MANUFACTURED BY LEGRAND LLC. OR APPROVED EQUAL. COORDINATE COLOR AND FINAL LOCATION WITH OWNER AND ARCHITECT. TYPICAL.
- 2. ALL ELECTRICAL DEVICES IN THIS AREA SHALL BE CIRCUITED TO PANEL LAD2-B UNLESS
- 3. ALL ELECTRICAL DEVICES IN THIS AREA SHALL BE CIRCUITED TO PANEL K-1B UNLESS OTHERWISE 4. PROPOSED LOCATION OF RELOCATED MOTOR STARTER. COORDINATE FINAL LOCATION IN THE FIELD
- PROVIDE AND INSTALL (2) NEW COMBINATION CLOCK/INTERCOM UNITS IN THE KITCHEN AS SHOWN. PROVIDE ALL NECESSARY HARDWARE AND WIRING AND PROGRAMMING FOR A COMPLETE AND OPERATIONAL INSTALLATION OF (2) ADDITIONAL CLOCK/INTERCOM UNITS THAT WILL CONNECT TO THE EXISTING CLOCK/INTERCOM SYSTEM. NEW CLOCK/INTERCOM UNITS SHALL MATCH EXISTING.

#### **GENERAL NOTES**

- 1. ALL CIRCUITS IN THE KITCHEN SHALL BE FED FROM ABOVE. NO RECEPTACLES SHALL BE MOUNTED RECESSED OR SURFACE MOUNTED ON THE FLOOR.
- 2. COORDINATE THE LOCATION OF ALL DEVICES WITH THE OWNER AND ARCHITECT PRIOR TO ROUGH-IN.
- 3. REFER TO FOOD SERVICE DRAWINGS FOR MOUNTING HEIGHTS OF RECEPTACLES AND JUNCTION BOXES WITHIN KITCHEN SPACE.
- 4. CIRCUIT NUMBERS ARE FOR GROUPING PURPOSES AND ACTUAL CIRCUIT NUMBERS SHALL DEPEND ON EXISTING CIRCUITS THAT REMAIN AND SPACES LEFT AFTER DEMOLITION IN PANELS K1—A &

CODE REVIEW:



SPIEZLE ARCHITECTURAL GROUP INC. 1395 YARDVILLE HAMILTON SQUARE ROAD SUITE 2A HAMILTON, NJ 08691

Phone: 609-695-7400

21AI01674400

21AI01564200

21AC00063000

THOMAS S. PERRINO SCOTT E. DOWNIE STEVEN LEONE STEVEN G. SIEGEL SPIEZLE ARCHITECTURAL GROUP, INC.

SEAL:

CONSULTANTS: P.O. BOX 628 FARMINGDALE, NJ 07727 732.938.2666 732.938.2521 CERTIFICATE OF AUTHORIZATION NO. 24GA28124300 PAUL RIPISH, N.J.P.E. LICENSE NUMBER 4515800 PAUL RIPISH, N.J.P.E. LICENSE NUMBER 4515800

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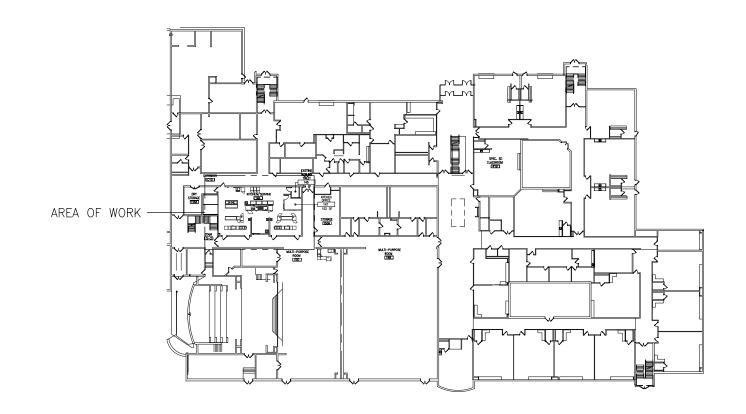
FOR CODE REVIEW: DD/MM/YYYY **REVISIONS: REVISION NAME** DATE ADDENDUM #1 10/05/20

FOR BID: 09/23/2020

DRAWING TITLE: ELECTRICAL FIRST AND SECOND FLOOR NEW WORK POWER PLANS


COMMISSION NUMBER: 20K009 AGENCY NUMBER: 01-0570-300-20-2000 01-0570-300-21-1000 DO NOT SCALE THE DRAWINGS







# ELECTRICAL PARTIAL SECOND FLOOR NEW WORK POWER PLAN

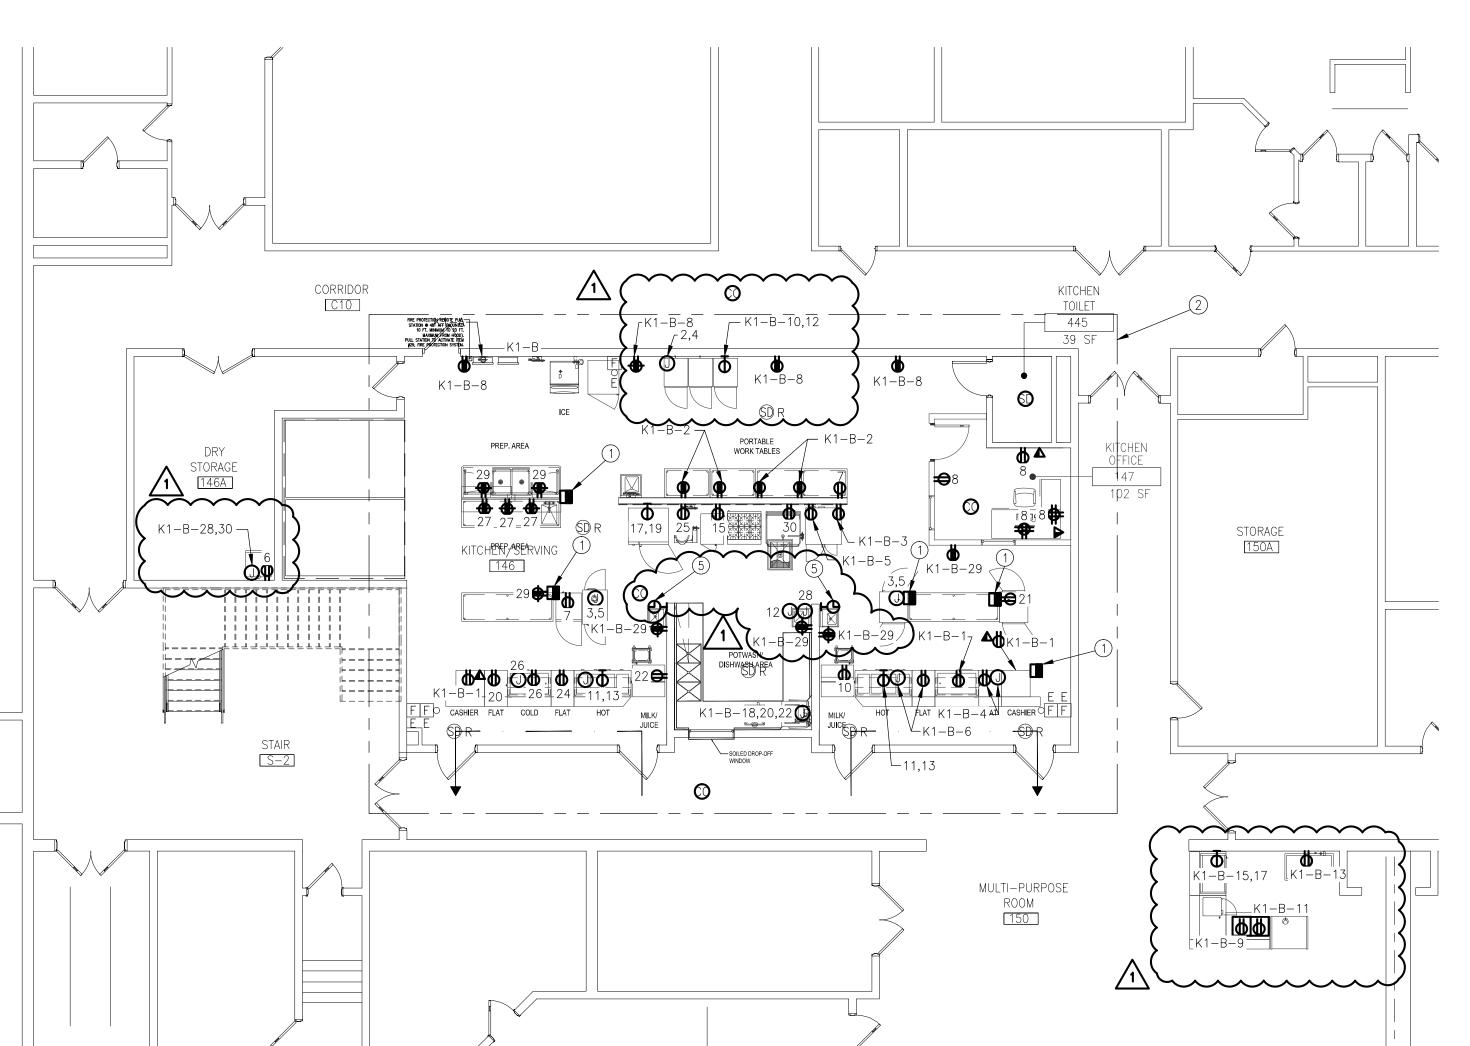

ELECTRICAL PARTIAL FIRST FLOOR NEW WORK POWER PLAN

1/8"=1'-0"

PANEI	_K1−A		SCHEDULE		_ сом	MENTS:	EXISTIN	IG PANE	L						1	50A	MAIN CIRCUIT BREAKER			_
PANEI	LOCA	TION	KITCHEN										NUMBER OF	POLES:	30					
208,	/120V		VOLTS, 3 PHASE, 4 WIRE			225A BUS SIZE PANEL SHORT CIR							PANEL SHORT CIRCUIT	RATING:	42	KAI				
C.B.	C.B.	C.B.	LOAD	CIR		FDR.DA	TA		PHASE	PHASE	PHASE		FDR.DA	TA		CIR	LOAD	C.B.	C.B.	C.B.
POLE	TRIP	LOAD	DESCRIPTION	NO					A	В	С					NO	DESCRIPTION	LOAD	TRIP	PC
NO.	AMPS	VA			No.	WIRE	GND	COND	1			No.	WIRE	GND	COND			VA	AMPS	l <sub>N</sub>
1	20		EXISTING LOAD	1	EXSTN	'G CONDU	CTORS &	COND.	1,456			2	12	12	3/4	2	ICE MACHINE	1,456	*20	*
*2	*20	749	REACH IN WARMER	3	2	12	12	3/4		2,205		1			'	4	(DIRECT WIRED)	1,456		
	1	749		5	1						1349	2	12	12	3/4	6	WASHER	600	*20	
*1	*20	1,440	REACH IN FRIDGE	7	2	12	12	3/4	2160			2	12	12	3/4	8	KITCHEN OFFICE RECS	720	*20	
*1	*20	840	COLD PAN	9	2	12	12	3/4		1200		2	12	12	3/4	10	MILK COOLER	360	*20	
*2	*30	1,997	HOT FOOD UNIT	11	2	10	10	3/4			2197	2	12	12	3/4	12	ANSUL SYSTEM CONTROL	200	**20	k
		1,997		13					1997							14				
*1	*20	240	TILT SKILLET	15	2	12	12	3/4		240		EXSTN	'G CONDU	CTORS &	COND.		EXISTING LOAD		50	
*2	*15	400	STEAM OVEN	17	2	12	12	3/4			400						EXISTING FREEZER			┷
		400		19					1840			2	12	12	3/4		FLAT TOP COUNTER 4	1,440	*1	*
*1	*20	1,440	REACH IN FRIDGE 2	21	2	12	12	3/4		1800		2	12	12	3/4		MILK COOLER 2	360	*20	
*1	*20	840	COLD PAN 2	23	2	12	12	3/4			2280	2	12	12	3/4		FLAT TOP COUNTER 3	1,440	*1	*
*1	*20	600	STEAM KETTLE	25	2	12	12	3/4	960			2	12	12	3/4		COLD FOOD COUNT/PROTEC	360	*1	*
*1	*20	720	PREP AREA RECS	27	2	12	12	3/4		920		2	12	12	3/4		HOOD CONTROL	200	***20	*:
*1	*20	720	PREP TABLE RECS	29	2	12	12	3/4			960	2	12	12	3/4	30	CONVECTION STEAMER	240	**20	*
NOU	NTING:		RECESSED		PH	-LOA[	)		8413	6365	7186	VA					PANEL TYPE : NEMA 1, N	WITH		
FED	FROM:		_		CON	NECTE	D LOAD	)		22	KVA		•	61	AMPS		GROUNDING TERMINAL 100	% NEUT	RAL	

\*NEW GFCI TYPE CIRCUIT BREAKER TO MATCH EXISTING

\*\*SHUNT TRIP TYPE CIRCUIT BREAKER.

\*NEW CIRCUIT BREAKER TO MATCH EXISTING.

PAN	1ELL	X1-B		SCHEDULE		СОМ	MENTS:	EXISTIN	IG PANE	L						6	225A	MLO		_	, !
PAN	NEL	LOCA	TION	KITCHEN														NUMBER OF	POLES:	30	
208	8/:	120V		VOLTS, 3 PHASE, 4 WIRE			225A	BUS	SIZE					•				PANEL SHORT CIRCUIT	RATING:	42	KAIC
с.в.	.	C.B.	C.B.	LOAD	CIR		FDR.DA	ТА		PHASE	PHASE	PHASE		FDR.DA	TA		CIR	LOAD	C.B.	C.B.	C.B.
POL	Ε	TRIP	LOAD	DESCRIPTION	NO					A	В	С					NO	DESCRIPTION	LOAD	TRIP	POLE
NO.	.   .	AMPS	VA			No.	WIRE	GND	COND				No.	WIRE	GND	COND			VA	AMPS	NO.
*1		*20	360	CASH REGISTER	1	2	12	12	3/4	720			2	12	12	3/4	2	GENERAL KITCHEN RECS 3	360	*1	*20
**1		**20	1,200	CONVECTION OVEN #1	3	2	12	12	3/4		2,640		2	12	12	3/4	4	FLAT TOP COUNTER/FOOD PROT	1,440	*1	*20
**1		**20	1,200	CONVECTION OVEN #2	5	2	12	12	3/4			2640	2	12	12	3/4	6	FLAT TOP COUN/FOOD PROT #2	1,440	*1	*20
**1		**20		GAS SOLENOID VALVE	7	2	12	12	3/4	1100			2	12	12	3/4	8	GENERAL KITCHEN RECS	900	*20	*1
	$ \uparrow$	<b>*</b> 20 <b>Y</b>	<b>7</b> ,752	REPRIGERATED DISPLAY	79	2	10	8	<b>434</b>		3208		2	12	12	3/4	10	BLAST CHILLER/FREEZER	1,456	*20	*2
*1		*20	1,752	HEATED DISPLAY	11	2	10	10	3/4			3208					18	(NEWA 18-20PRECERTACLE)	<b>1779</b>	$\sim$	
*1		*20	1,200	ICE CREAM MERCHANDISER	13	2	10	10	3/4	200								EXISTING SPARE		20	1
*2		*20		HEATED DISPLAY CASE #3	15	2	10	10	3/4	$\Box$	1261		2	12	12	3/4	148^		<b>₹</b>	<u> </u>	<u> </u>
	┸			(NEMA L14-20P)	17					1		3461					18		2,400	1	'
<u> – Ť</u>	ᄉ	*20	1,392	HEATER DISPLAY CASE #4	19/	2	18	10	3/4	3792			3	8	10	3/4		WARE WASHER	2,400	*50	*3
		1		EXISTING SPARE	21						2400						22		2,400		'
	_				23	_						0	4					EXISTING SPARE		4	'
		, l		EXISTING SPARE	25	1				0							26		<u> </u>		'
	_				27						1872		2	12	12	3/4		DRYER	1,872	*30	*2
***	1	***20	720	GENERAL KITCHEN RECS 4	29	2	12	12	3/4			2592					30	(NEMA 6-30P TYPE RECEPTACLE)	1,872		
МО	UN.	TING:		RECESSED		РН	-LOA[	)		6812	11381	11901	VA	]		<b>-</b> 1		PANEL TYPE : NEMA 1, V	NITH		ı
FFF	) F	ROM:		_			NNECTE	ם ו טענ	)		30	KVA		_	84	AMPS		GROUNDING TERMINAL 100	% NFLIT	RΔI	

\*NEW GFCI TYPE CIRCUIT BREAKER TO MATCH EXISTING.

\*\*NEW SHUNT TRIP TYPE CIRCUIT BREAKER TO MATCH EXISTING. CIRCUIT BREAKER SHALL BE TIED TO ANSUL SYSTEM.

\*\*\*NEW UTILIZING EXISTING SPARE BREAKER.

PANE	L LOCA	TION	STORAGE D205														NUMBER (	OF POLES:	42	
208,	/120V		VOLTS, 3 PHASE, 4 WIRE			150A	BUS	SIZE									PANEL SHORT CIRCU	IT RATING:	42	KAIC
C.B.	C.B.	C.B.	LOAD	CIR		FDR.DA	.ΤΔ		PHASE	PHASE	PHASE		FDR.DAT	ΓΔ		CIR	LOAD	C.B.	C.B.	C.B.
POLE	TRIP	LOAD	DESCRIPTION	NO		1 210.21			A	В	C		I DIVIDILI	•••		NO	DESCRIPTION	LOAD	TRIP	POLE
NO.	AMPS	VA		110	No	WIRE	GND	COND				No.	WIRE	GND	COND	110		VA	AMPS	NO.
1	20		EXISTING LOAD	1			ICTORS &		0				G CONDUC			2	EXISTING LOAD	,,,,	20	1
1	20		EXISTING LOAD	3	1		ICTORS &			0		1	G CONDUC			4	EXISTING LOAD		20	2
1	20		EXISTING LOAD	5	EXST	'G CONDU	ICTORS &	COND.			0					6				
1	20		EXISTING LOAD	7	EXST	'G CONDU	ICTORS &	COND.	0			EXSTN	G CONDUC	TORS &	COND.	8	EXISTING LOAD		20	1
1	20		EXISTING LOAD	9	EXST	'G CONDU	ICTORS &	COND.		0		EXSTN	G CONDUC	CTORS &	COND.		EXISTING LOAD		20	1
1	20		EXISTING LOAD	11	EXST	I'G CONDU	ICTORS &	COND.			0	EXSTN	G CONDUC	CTORS &	COND.		EXISTING LOAD		20	1
1	20		EXISTING LOAD	13	EXST	'G CONDU	ICTORS &	COND.	0			EXSTN	G CONDUC	CTORS &	COND.		EXISTING LOAD		20	1
1	20		EXISTING LOAD	15	EXST	G CONDU	ICTORS &	COND.		0		EXSTN	G CONDUC	TORS &	COND.	16	EXISTING LOAD		20	1
1	20		EXISTING LOAD	17	EXST	I'G CONDU	ICTORS &	COND.			0	EXSTN	G CONDUC	TORS &	COND.	18	EXISTING LOAD		20	1
1	20		EXISTING LOAD OFF	19	EXST	G CONDU	ICTORS &	COND.	0			EXSTN	G CONDUC	CTORS &	COND.	20	EXISTING LOAD		20	1
1	20		EXISTING LOAD OFF	21						0		EXSTN <sup>1</sup>	G CONDUC	TORS &	COND.		EXISTING LOAD		20	1
1	20		EXISTING LOAD OFF	23							0	EXSTN	G CONDUC	TORS &	COND.		EXISTING LOAD		20	1
1	20		EXISTING LOAD OFF	25					0			1				26			1	
1	20		EXISTING LOAD OFF	27						0		1				28	EXISTING LOAD		40	3
1	20		EXISTING LOAD OFF	29							0	ш				30				
**2	**45	-,	ACCU-1	31	2	8	10	1	4644			2	12	12	3/4		CST RECEPTION 226A RECS	900	**20	**1
		3,744		33						4644		2	12	12	3/4		CST OFFICE 226B RECS	900	**20	**1
**2	**15		HP-1. HP-2, HP-3, HP-4	35	2	12	12	3/4			1044	2	12	_12_	3/4	ĺ	CST_OFFICE_226C_RECS	900	**20	**1
		144		37					644			Y I	•	•		38		500	ľ	
**1	**20	720	CST RECEPTION 225 RECS	39	2	12	12	3/4		1220		2	12	12	3/4	40	EHC-1	500	**20	**3
**!	**20	1,500	ERV-1	41	2	10	10	3/4			2000					42		500		
MOU	NTING:		RECESSED		PH	-LOAI	)		5288	5864	3044	W		フ		一	PANEL TYPE NIPMANI,			
FFD	FROM:		PANEL HD2		100	INFCTF	D LOAD	)		14	KVA		Γ	39	AMPS		GROUNDING TERMINAL 10	00% NEUT	RAL	

	L LOCA		STORAGE D205													NUMBER OF	F POLES:	42	
480	/277V		VOLTS, 3 PHASE, 4 WIRE		225A	BUS	SIZE									PANEL SHORT CIRCUIT	RATING:	42	KAIC
C.B. POLE	C.B. TRIP	C.B. LOAD	LOAD DESCRIPTION	CIR NO	FDR.D#	TA		PHASE A	PHASE B	PHASE C		FDR.DA	·ΤΑ		CIR NO	LOAD DESCRIPTION	C.B. LOAD	C.B. TRIP	C.B. POLE
NO.	AMPS	VA			No. WIRE	GND	COND				No.	WIRE	GND	COND			VA	AMPS	NO.
3	20		EXISTING LOAD	1 3 5	EXSTN'G CONDU	ICTORS &	COND.	0	0	0	EXSTN	'G CONDU	ICTORS &	COND.	2 4 6	EXISTING LOAD		20	3
3	20		EXISTING LOAD	7 9 11	EXSTN'G CONDL	ICTORS &	COND.	0	0	0	EXSTN	'G CONDU	ICTORS &	COND.	8	EXISTING LOAD		20	3
3	20		EXISTING LOAD	13	EXSTN'G CONDL	ICTORS &	COND.	0	0	0	EXSTN	'G CONDU	ICTORS &	COND.	14	EXISTING LOAD		20	3
3	50		EXISTING LOAD	19 21 23	EXSTN'G CONDL	ICTORS &	COND.	0	0	0	EXSTN	'G CONDU	ICTORS &	COND.	20	EXISTING LOAD		20	3
3	45		EXISTING LOAD	19 21 23	EXSTN'G CONDL	ICTORS &	COND.	914	914	914	3	2	12	3/4	26	MUA-1	914 914	15	*3
3	20	2,105 2,105 2,105	KEF-1	13 15 17	3 12	12	3/4	5014	5014	5014	3	2	12	3/4	32 34 36	AHU-8	2,909 2,909 2,909	20	*3
MOU	NTING:	2,.55	RECESSED		PH-LOAI	<u>.                                      </u>	•	5928	5928	5928	VA	$\overline{}$	$\overline{}$	$\overline{}$	_	PANEL POPE - NEMANI		$\overline{}$	$\supset$
FFD	FROM:		PANEL HD2		CONNECTE	D LOAF	)		18	KVA			49	AMPS		GROUNDING TERMINAL 100	% NFUTI	RAI	

## O1 ELECTRICAL PANEL SCHEDULES E3.1 NONE

TYPE	DESCRIPTION	MANUFACTURER	CATALOG #		LAMP	MOUNTING	BALLAST/	CONTROL
			"	VOLT #	CATALOG #		DRIVER	
A	2'x4' LED FIXTURE WITH PRISMATIC LENS PROVIDE WITH EL14LSD OPTION WHERE SHOWN AS EMERGENCY FIXTURE ON THE PLANS.	LITHONIA	2TL4-40L-FW-A12- EZ1-LP840	MVOLT -	-	LAY—IN	ELECTRONIC	NLIGHT AIR
A1	2'X4' LED FIXTURE WITH ANGLED FROSTED ACRYLIC LENS PROVIDE WITH E10WLCP WHERE SHOWN AS EMERGENCY	MARK LIGHTING	WHSPR-2X4-3300-35K-80CRI-NDIM-MVOLT- SWC		-	LAY IN	ELECTRONIC	NLIGHT AIR
В	1'X4' LED STRIP LIGHT	LITHONIA	STL4-40L-LP840	MVOLT -	-	SURFACE	ELECTRONIC	NLIGHT AII
С	1'X2' LED STRIP LIGHT	LITHONIA	STL2-20L-EZ1-LP840	MVOLT -	_	SURFACE	ELECTRONIC	NLIGHT AII
D	2'x2' LED FIXTURE WITH PRISMATIC LENS PROVIDE WITH EL14LSD OPTION WHERE SHOWN AS EMERGENCY FIXTURE ON THE PLANS.	LITHONIA	2TL2-40L-FW-A12- EZ1-LP840	MVOLT -	-	LAY-IN	ELECTRONIC	NLIGHT AIR
Е	LED EXIT LIGHT WITH DUAL EMERGENCY HEADS AND INTEGRAL BATTERY COORDINATE COLOR AND LETTER COLOR WITH ARCHITECT	LITHONIA	LHQM-LED-X-X	120 –	_	AS SHOWN ON DRAWINGS	_	LOCAL LIGHTI CIRCUIT AHE OF SWITCHIN

EMERGENCY FIXTURES SHALL BE CAPABLE OF ILLUMINATION OF LAMPS FOR 90 MINUTES AND SHALL BE WIRED AHEAD OF LOCAL SWITCHING(BODINE BALLASTS WHERE APPLICABLE).
PROVIDE ALL NECESSARY MOUNTING HARDWARE.

PROVIDE ALL NECESSARY MOUNTING HARDWARE.
 PROVIDE UNIVERSAL MOUNT CANOPY WITH CEILING MOUNTED EXIT SIGNS.

PROVIDE ACCESSORIES FOR SEISMIC CONSIDERATIONS PER LOCAL CODES.
 PROVIDE EMERGENCY BALLAST OPTION FOR FIXTURES AS INDICATED IN DRAWINGS.
 CONFIRM ALLOWABLE MOUNTING SPACE ABOVE CEILING PRIOR TO ORDERING FIXTURES

ELECTRICAL LIGHTING FIXTURE SCHEDULE
NONE

Spiezle

SPIEZLE ARCHITECTURAL GROUP INC.
I 395 YARDVILLE HAMILTON SQUARE ROAD
SUITE 2A
HAMILTON, NJ 0869 I
Phone: 609-695-7400

21Al01505400 21Al01674400 21Al01170100

21AI01564200 21AC00063000

SIGNATURE:
THOMAS S. PERRINO
SCOTT E. DOWNIE
STEVEN LEONE
STEVEN G. SIEGEL
SPIEZLE ARCHITECTURAL GROUP, INC.

SEAL:

CODE REVIEW:

KSI CONSULTING ENGINEERS, LLC
P.O. BOX 628 FARMINGDALE, NJ 07727
PHONE: 732.938.2666
FAX: 732.938.2521
CERTIFICATE OF AUTHORIZATION NO. 24GA28124300
PAUL RIPISH, N.J.P.E. LICENSE NUMBER 4515800
ALL DRAWINGS AND WRITTEN MATERIALS APPEARING HEREIN CONSTITUTE ORIGINAL AND UNPUBLISHED WORK OF THE ENGINEER. THE REPRODUCTION OF THIS DRAWING FOR THE PURPOSE OF COPYING THIS WORK OR REVISING SAID DRAWING SHALL BE CONSIDERED A VIOLATION OF BOTH THE PROFESSIONAL CODE OF ETHICS AND A THEFT OF COMPANY ASSETS, BOTH OF WHICH SHALL BE PROSECUTED TO THE FULLEST EXTENT OF CURRENT STATUTES.

DATE: KSI PROJECT #: 20100M\_04

PROJECT:

KITCHEN
UPGRADES AND
CLASSROOM
ALTERATIONS AT
BRIGANTINE
ELEMENTARY

BRIGANTINE OF EDUCATION

301 E Evans Brigantine, NJ 0820

FOR	CODE REVIEW:	DI	D/MM/YYYY
REVI:	SIONS:		
<u>/</u> #\	REVISION NAME		DATE
	ADDENDUM #1		10/05/20

FOR BID: 09/23/2020


ELECTRICAL SCHEDULES & DETAILS

COMMISSION NUMBER:


20K009

AGENCY NUMBER:
01-0570-300-20-2000
01-0570-300-21-1000
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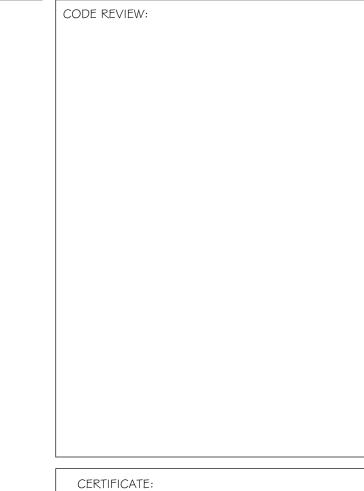
DRAWING
NUMBER:

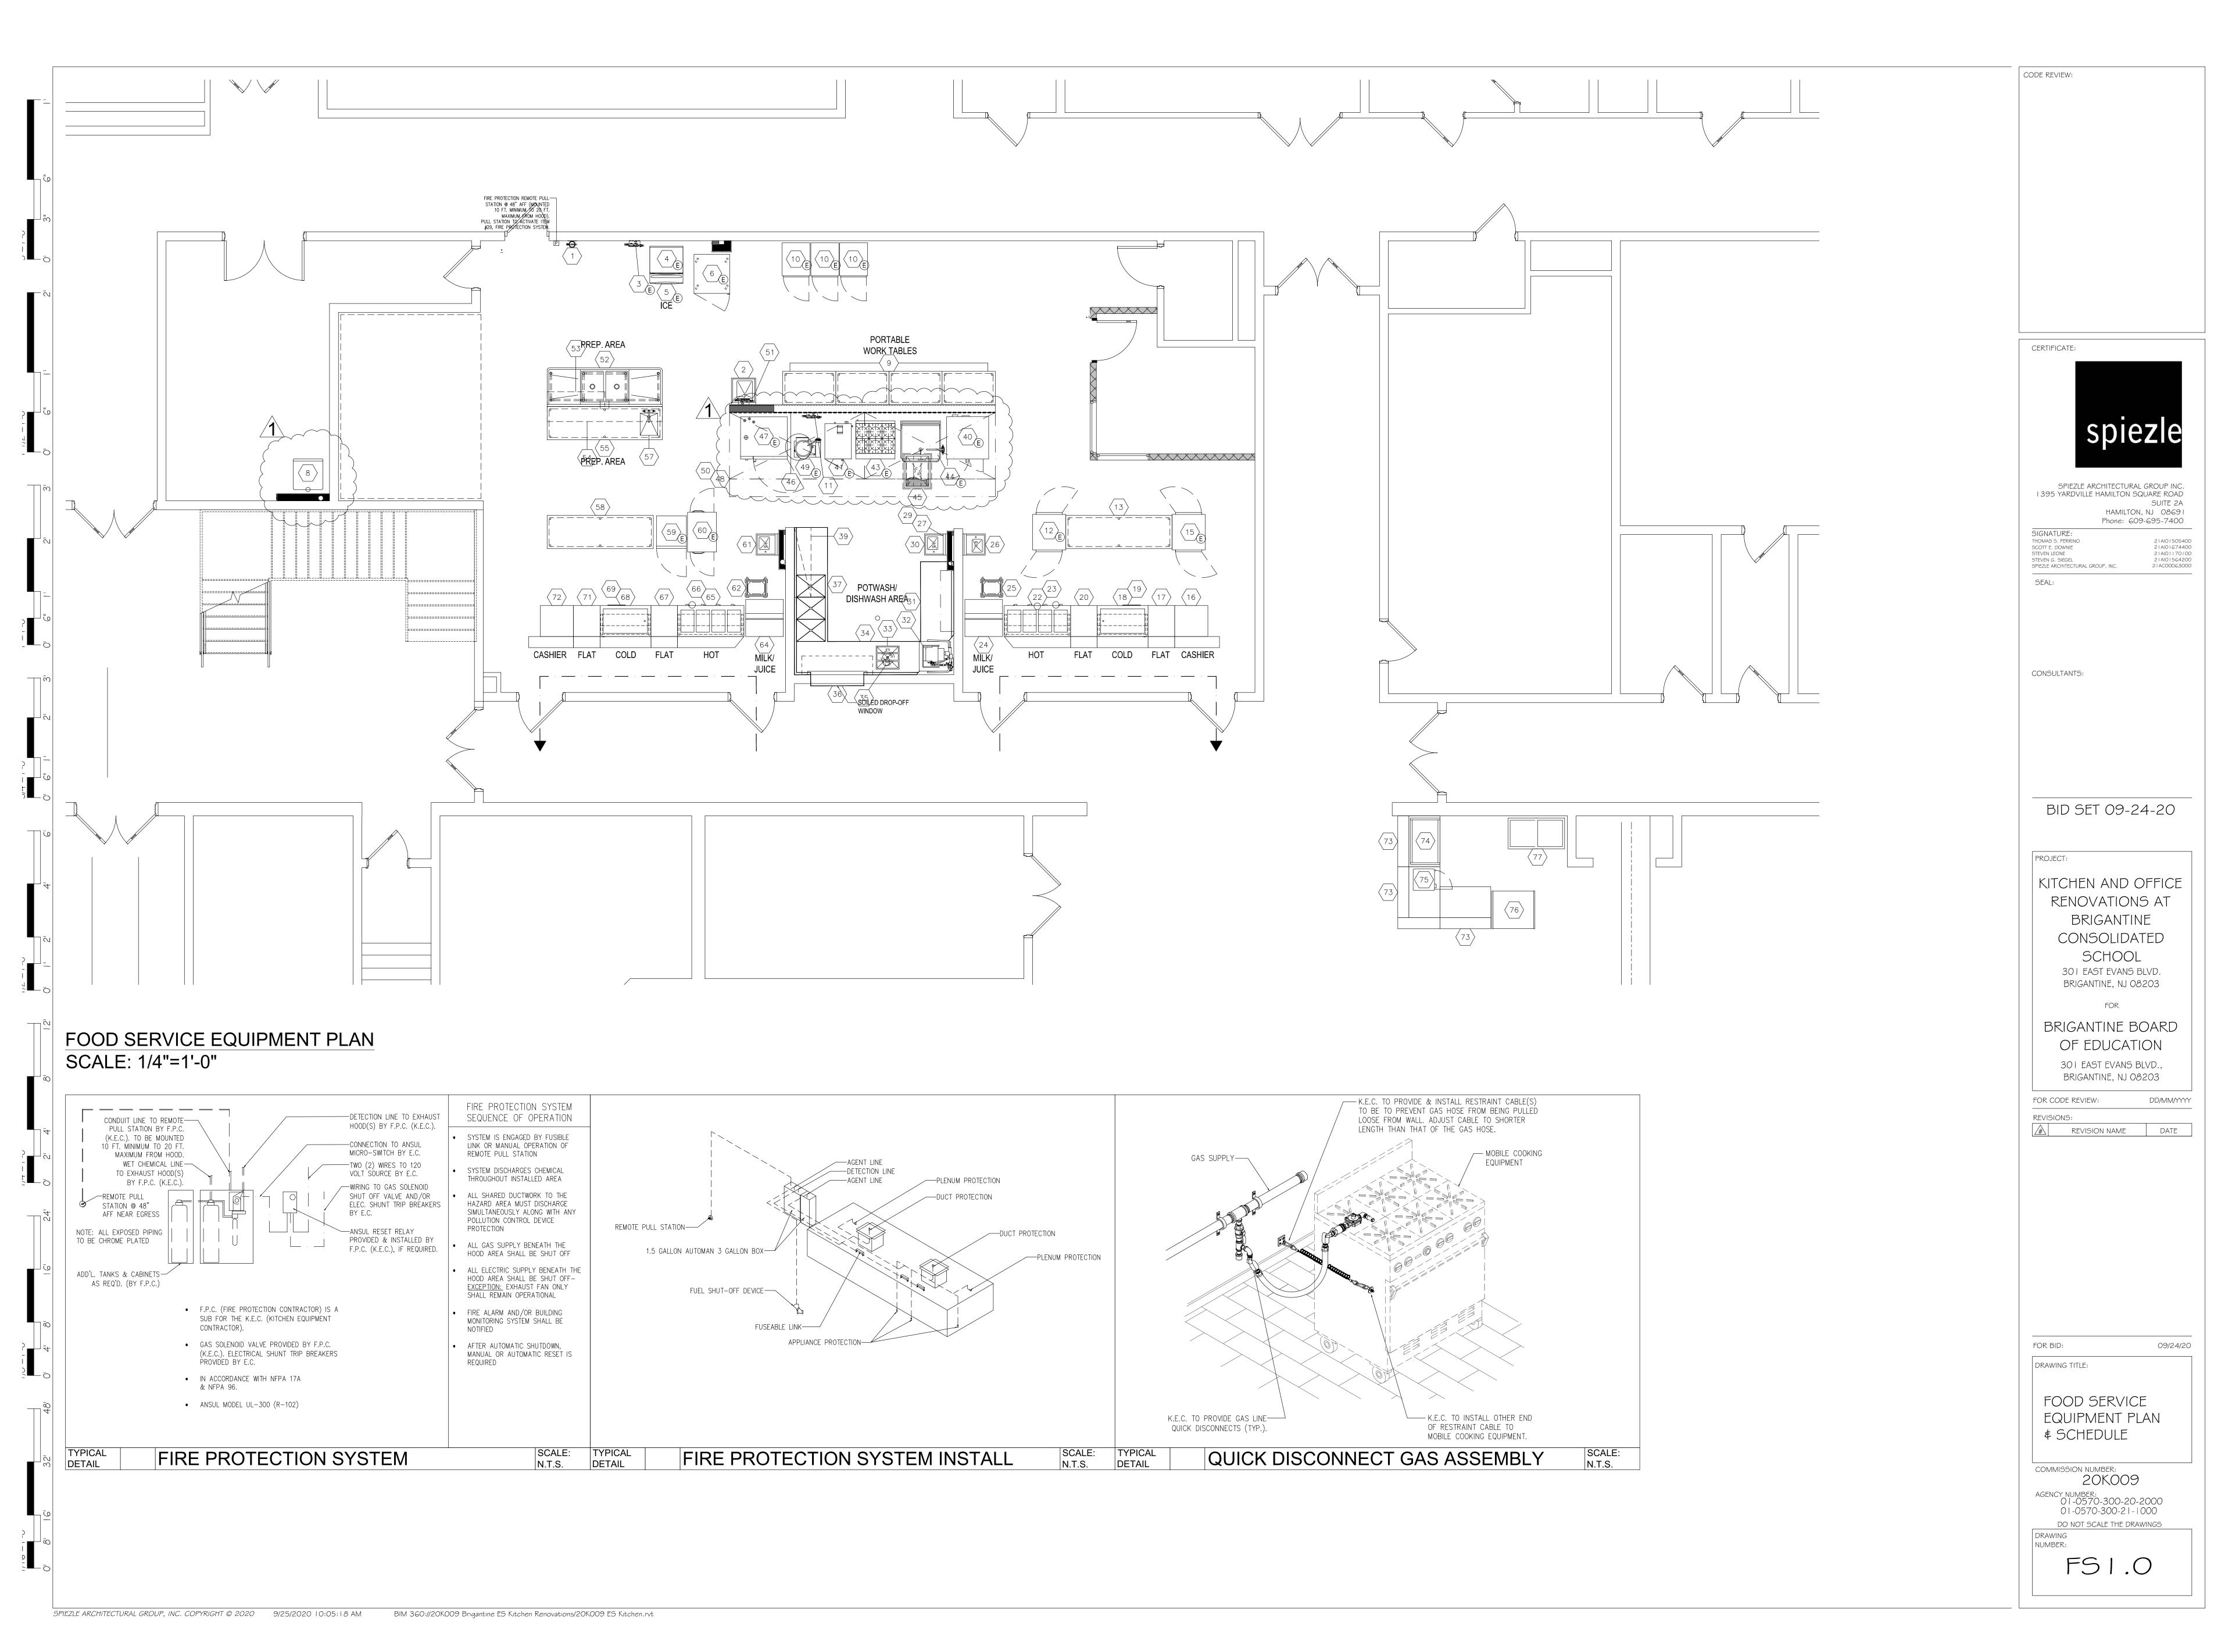


								k		T (	 : H E N				
						FΛU	ΙP						E D U L E		
		HOT WATER SIZE (IN)	COLD WATER SIZE (IN)	DIRECT DRAIN SIZE (IN)	INDIR DRAIN SIZE (IN)	Z Z	<u></u>	X	AMPS	PLUG DIRECT -		PHASE	¥ ₩ IJ MANUFACTURER	MODEL NUMBER K-CLASS	EQUIPMENT REMARKS
2	FIRE EXTINGUISHER, WALL MNTD. 1  ADA HAND SINK, WALL MNTD. 1  FILTER SYSTEM FOR ITEM #4 1  ICE MACHINE, COMPRESSED STYLE 1	1/2	1/2 3/4 3/8	1-1/2	1/2				5.0		120 1		CAPTIVE AIRE  5-15P IMC/TEDDY  EXISTING TO BE REMAIN  5-15P EXISTING TO BE REMAIN	ADA-WS  MANITOWOC ID0302A-161	TO REMAIN IN PLACE, NO WORK
5	ICE BIN 1 CHILLER/FREEZER, BLAST 1 SPARE NUMBER –				3/4				10.0		208 3		EXISTING TO BE REUSED  L15-20P EXISTING TO BE REUSED	MANITOWOC B570	TO REMAIN IN PLACE, NO WORK
8	WASHER/ DRYER, STACKED, ELEC. 1  WORK TABLE, PORTABLE 4	1/2	1/2		1				15.0	X	120 1 120/240 1	1	5-15P UNIMAC IMC/TEDDY	UTEE5ASP WT-3048	
10	HEATED CABINET(S), PORTABLE 3  FILTER SYSTEM FOR ITEM #41 1  CABINET, HEATED, PASS—THRU 1		3/4					1.5	16.6 7.8	X	120 1		5-20P EXISTING TO BE REUSED  MARKET FORGE  L14-20P EXISTING TO BE REUSED	VULCAN VHFA18  TRUH20  TRAULSEN RHT132WPTFHS	
14	WORK TABLE 1  SPARE NUMBER -  REFRIGERATOR, PASS—THRU 1						0.3		12.0 7.0	X	120 1		5-15R IMC/TEDDY  L5-20P EXISTING TO BE REUSED	WT-3096  TRAULSEN RHT132WUT-FHS	
17 18	CASHIER COUNTER, PORTABLE 1  FLAT TOP COUNTER, PORTABLE 1  COLD FOOD COUNTER, PORTABLE 1  FOOD PROTECTOR(S), ADJUSTABLE 1				1				12.0 12.0 6.3 1.0	X X X X	120 1 120 1 120 1 120 1	1	5-15P PIPER PRODUCTS  5-15P PIPER PRODUCTS  5-15P PIPER PRODUCTS  PIPER PRODUCTS	2-CD 2-ST 3-BCM CG	
21	FLAT TOP COUNTER, PORTABLE 1  SPARE NUMBER -  HOT FOOD COUNTER, PORTABLE 1  FOOD PROTECTOR(S), ADJUSTABLE 1				1			4.0	12.0 19.2 1.0	X	120 1 208 1 120 1		5-15P PIPER PRODUCTS  6-30P PIPER PRODUCTS  PIPER PRODUCTS	2-ST 4-HF CG	
24 25	MILK COOLER 1 DISPENSER, SELF-LEVELING TRAY 1 HAND SINK, WALL MNTD. 1	1/2	1/2	1-1/2	<u> </u>		0.2		3.0 5.0	+ + +	120 1		5-15P BEVERAGE-AIR PIPER PRODUCTS 5-15P IMC/TEDDY	SMF34HC-1-S PT/1014M0 WS	
28	EXHAUST HOOD, CONTROL PANEL 1  SPARE NUMBER -  FIRE PROTECTION SYSTEM 1								15.0 15.0		120 1	1	CAPTIVE AIRE  CAPTIVE AIRE	UL-300 (R-102)	
31	HAND SINK, WALL MNTD. 1  CLEAN DISH TABLE 1  WAREWASHER, DOOR TYPE, VENTLESS 1	1/2	1/2	1-1/2	1-1/2	2	2.0	7.2	5.0 45.4		208 3	3	5-15P IMC/TEDDY IMC/TEDDY HOBART US FOODSERVICE	WS SCDT-72 AM15VLT	SINGLE POINT ELEC. CONN.
34 35	PRE-WASH SINK, BUILT-IN 1 SOILED DISH TABLE 1 GARBAGE DISPOSAL 1	1/2	1/2	2	2				17.4	X	120 1	1	IMC/TEDDY IMC/TEDDY IN-SINK-ERATOR	CUSTOM SSDT-108 SS-200	
37	S.S. PASS—THRU SILL 1  3—COMPARTMENT SINK, POTWASH 1  SPARE NUMBER —	1/2	1/2		(2)2								IMC/TEDDY IMC/TEDDY	CUSTOM	
39	STORAGE SYSTEM, WALL MNTD. 1  OVEN, CONVECTION, GAS 1					3/4 120	0.8		9.8	X	120 1 120 1		EAGLE GROUP/ METAL MASTERS  5-15P EXISTING TO BE REUSED  5-15P	WAL-STOR GARLAND	
42	STEAMER, CONVECTION, GAS 1  SPARE NUMBER -  RANGE, RESTAURANT, GAS 1		(2)3/8	3	1	3/4 42 3/4 236			2.0	X	120 1	_	5-15P EXISTING TO BE REUSED  EXISTING TO BE REUSED	MARKET FORGE ST-5G  GARLAND	C.W. PIPED FROM ITEM #11
44 45	TILY SKILLET 1  FLOOR TROUGH, SHALLOW 1  S.S. WALL PANEL(S) LOT	)	1/2	4		3/4 91			1.8	X	120 1	1	5-15P EXISTING TO BE REUSED  IMC/TEDDY  CAPTIVE AIRE	CLEVELAND SGL-30-TR FT-2430-SG CUSTOM	
	OVEN-STEAMER, COMBINATION, GAS 1  EXHAUST HOOD, TYPE I 1		3/4 3/4 ALL	DATA	2 ON FA	3/4 152 NS, DUCTS, POWER, SWITC	CHES, [	ETC	3.8 BY M		208 1 4,000 C.F.M.	1	6-15P EXISTING TO BE REUSED  CAPTIVE AIRE	RATIONAL SCC WE 102G CUSTOM	C.W. PIPED FROM ITEM #51
50 51	SUPPLY PLENUM, MAKE—UP AIR 1 FILTER SYSTEM FOR ITEM #47 1		3/4	1	ON FA	3/4 34 NS, DUCTS, POWER, SWITC	CHES, E			.E.P.	3,500 C.F.M.		5-15P EXISTING TO BE REUSED  CAPTIVE AIRE  RATIONAL	CLEVELAND KGT-6-T CUSTOM 1900.1150US	
53 54	2-COMPARTMENT SINK, PREP. TABLE 1  OVERSHELF, SPLASH MNTD. 1  WORK TABLE 1	1/2	1/2		(2)2				12.0		120 1		5-15R IMC/TEDDY IMC/TEDDY IMC/TEDDY 5-15R IMC/TEDDY	TBV-1-1248 TBV-1-1296 WT-3096	
56 57	SPARE NUMBER –  ADA WORK SINK, BUILT-IN 1  WORK TABLE 1	1/2	1/2		2				12.0	X	120		IMC/TEDDY  5-15R IMC/TEDDY	CUSTOM WT-3096	
59 60	REFRIGERATOR, REACH—IN 1  CABINET, HEATED, PASS—THRU 1  HAND SINK, WALL MNTD. 1	1/2	1/2	1-1/2	) -			1.5	6.0 8.0 5.0	X X X	120 1 120/208 1 120 1	1	L5-20P EXISTING TO BE REUSED  L14-20P EXISTING TO BE REUSED  5-15P IMC/TEDDY	ARCTIC AIR AR23E  CONTINENTAL DL1W-SA-PT  WS	
63 64	DISPENSER, SELF-LEVELING TRAY 1 SPARE NUMBER - MILK COOLER 1						0.2		3.0		120 1	-	PIPER PRODUCTS  5-15P BEVERAGE-AIR	PT/1014M0 SMF34HC-1-S	
66 67	HOT FOOD COUNTER, PORTABLE 1  FOOD PROTECTOR(S), ADJUSTABLE 1  FLAT TOP COUNTER, PORTABLE 1  COLD FOOD COUNTER, PORTABLE 1				1			4.0	19.2 1.0 12.0 6.3	X	208 1 120 1 120 1 120 1	1	6-30P PIPER PRODUCTS  PIPER PRODUCTS  5-15P PIPER PRODUCTS  5-15P PIPER PRODUCTS	4-HF CG 2-ST 3-BCM	
69 70	FOOD PROTECTOR(S), ADJUSTABLE 1  SPARE NUMBER -  FLAT TOP COUNTER, PORTABLE 1								1.0	X	120 1	1	PIPER PRODUCTS  5-15P PIPER PRODUCTS	CG 2-ST	
73 74	CASHIER COUNTER, PORTABLE 1  FLAT TOP COUNTER, PORTABLE 3  DISPLAY CASE, HEATED 1							2.4	12.0	X	120 1	1	5-15P PIPER PRODUCTS PIPER PRODUCTS  L14-20P HATCO	2-CD 3-ST GR2SDS-36D	
76	DISPLAY CASE, HEATED 1  REFRIGERATED SELF—SERVICE CASE 1  ICE CREAM MERCHANDISER 1							1.4	11.6	X	120 120 130	1	5-15P HATCO  5-20P STRUCTURAL CONCEPTS  5-15P VENDOR SUPPLIED	FDWD-1 HMO3953R	

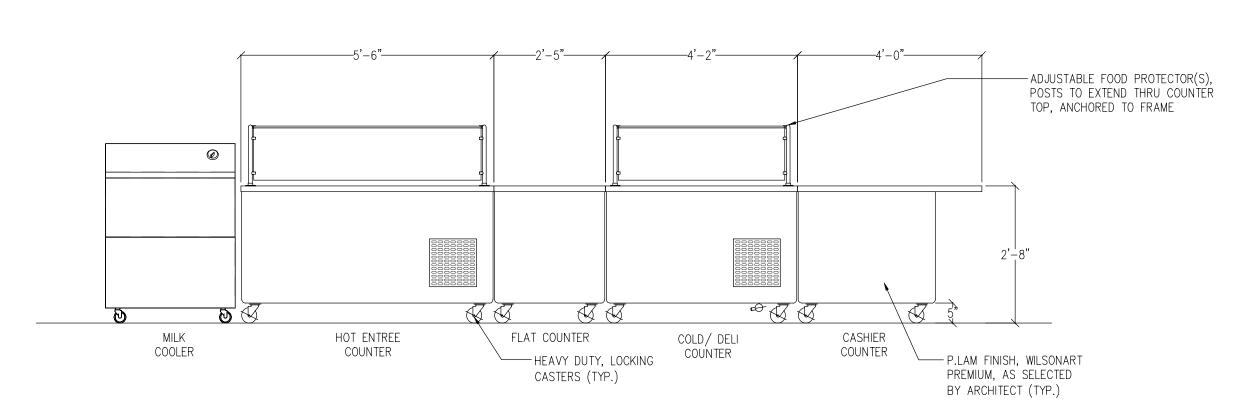

ELEVATION OF SERVING LINE SCALE: 1/2"=1'-0"



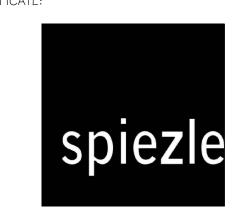

SPIEZLE ARCHITECTURAL GROUP INC. I 395 YARDVILLE HAMILTON SQUARE ROAD SUITE 2A HAMILTON, NJ 0869 I Phone: 609-695-7400

21AI01505400 21AI01674400 21AI01170100 21AI01564200 21AC00063000

SIGNATURE:
THOMAS S. PERRINO
SCOTT E. DOWNIE
STEVEN LEONE
STEVEN G. SIEGEL
SPIEZLE ARCHITECTURAL GROUP, INC. SEAL:

CONSULTANTS:

BID SET 09-24-20

PROJECT: KITCHEN AND OFFICE RENOVATIONS AT BRIGANTINE CONSOLIDATED

SCHOOL 301 EAST EVANS BLVD. BRIGANTINE, NJ 08203 FOR

OF EDUCATION 301 EAST EVANS BLVD., BRIGANTINE, NJ 08203

BRIGANTINE BOARD

FOR CODE REVIEW: DD/MM/YYYY **REVISIONS:** REVISION NAME DATE I ADDENDUM # I

FOR BID:

DRAWING TITLE:

09/24/20


FOOD SERVICE EQUIPMENT SCHEDULE

COMMISSION NUMBER: 20K009 AGENCY NUMBER: 01-0570-300-20-2000 01-0570-300-21-1000

DO NOT SCALE THE DRAWINGS

DRAWING
NUMBER:

FS2.0

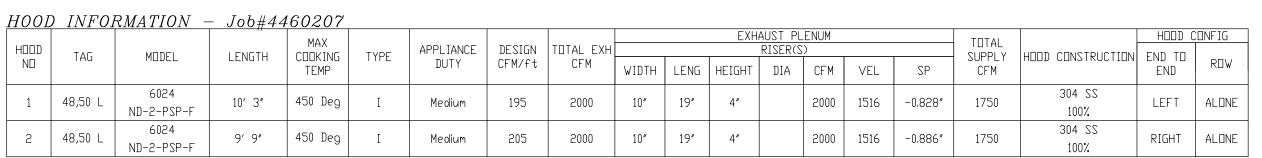

HOOD INFORMATION

				FILTER(S)	)			LIGHT(S)				UTILITY CABINET(S)				ПППП
HOOD NO	TAG	TYPE	OTV	HEIGHT	LENCTH	EFFICIENCY @ 7 MICRONS	OTV	TYPE WIRE	LOCATION	SIZE	F	IRE SYSTEM	ELECTRICAL	SWITCHES	FIRE SYSTEM	HANGIN
INLI		TIFE	WIT	HEIGHI	LENGIH	EFFICIENCE & MICKLINS	WII	GUARD	LUCATION	2175	TYPE	SIZE	MODEL #	QUANTITY	PIPING	WEIGHT
1	48,50 L	Captrate Solo Filter	7	16"	16"	85% See Filter Spec	3	Recessed NO							YES	623 LBS
2	48,50 L	Captrate Solo Filter	7	16"	16"	85% See Filter Spec	3	Recessed NO							YES	602 LBS

HOOD OPTIONS


$II \cup UL$	<i>O</i> 1 1 1 0	110
HOOD NO	TAG	OPTION
		FIELD WRAPPER 18.00" High Front, Left
		BACKSPLASH 80.00" High X 240.00" Long 304 SS Vertical
		BALANCE DAMPERS
1	48,50 L	STRUCTURAL FRONT PANEL
		RISER SENSOR INSTALL 6IN PLEN
		LEFT VERTICAL END PANEL 27" Top Width, 21" Bottom Width, 80" High Insulated 304 SS
		FIELD WRAPPER 18.00" High Front, Right
		BALANCE DAMPERS
2	48,50 L	STRUCTURAL FRONT PANEL
	10,00 L	RISER SENSOR INSTALL 6IN PLEN
		RIGHT VERTICAL END PANEL 27" Top Width 21" Rottom Width 80" High Insulated 304

PERFORATED SUPPLY PLENUM(S)

ПППП									K12FK()	5)	
HDDD ND	TAG	POS	LENGTH	WIDTH	HEIGHT	TYPE	WIDTH	LENG	DIA	CFM	SP
						MUA	12"	20"		583	0.184"
1	48,50 L	Front	123″	20″	6"	MUA	12"	20"		583	0.184"
						MUA	12"	20"		583	0.184"
						MUA	12"	20"		583	0.184"
2	48,50 L	Front	117"	20″	6"	MUA	12"	20"		583	0.184"
						MUA	12"	20"		583	0.184"


Fire System Information - Job#4460207

FIRE	_	, and the second	,,	FLOW	INSTALLAT	ION
SYSTEM NO	Tag	TYPE	SIZE	POINTS	SYSTEM	LOCATION ON HOOD
1	29	Ansul R102	3.0/3.0	7	Wall Mount Left	N/A

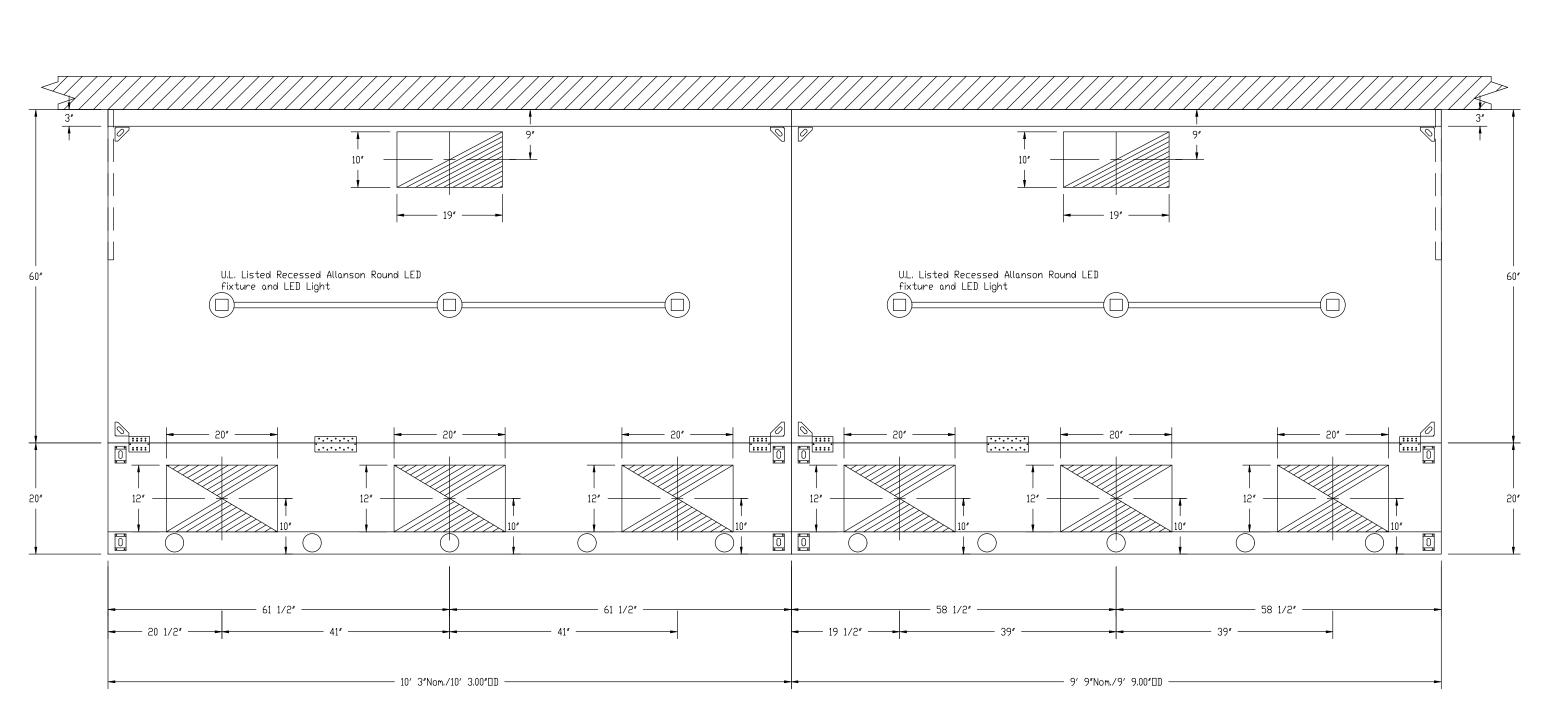

PLAN VIEW - Hood #1 (48,50 L) 10' 3.00" LONG 6024ND-2-PSP-F

<u> PLAN VIEW - Hood #2 (48,50 L)</u> 9' 9.00" LONG 6024ND-2-PSP-F

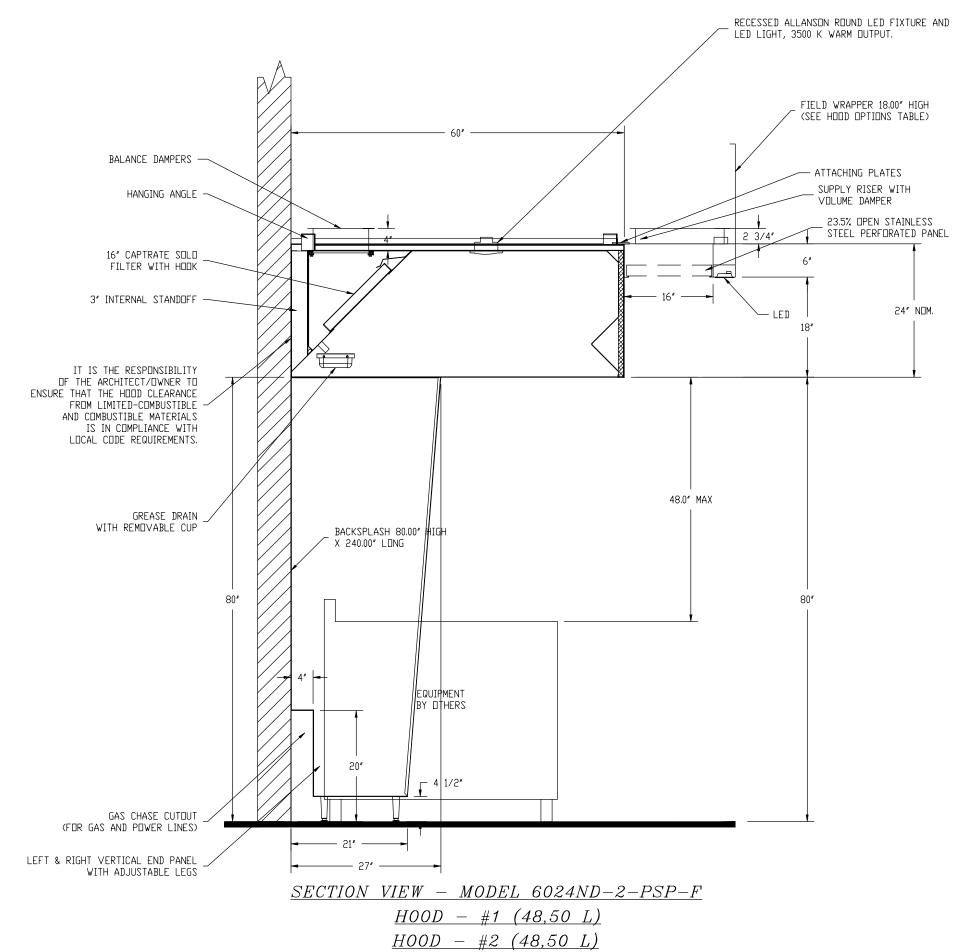

POSITIONING STUD / ENDPANEL REAR FLANGE-//INSULATION 1/4" THRU HOLES— ENDPANEL Chase for Utilities └ ADJUSTABLE LEGS Chase for \_\_\_/ Utilities ND-2 VERTICAL ENDPANEL

VERIFY CEILING HEIGHT Height required to verify hood will fit

and to size the enclosure panels (wrappers)

SPECIFICATION: CAPTRATE GREASE-STOP SOLO FILTER


THE CAPTRATE GREASE—STOP SOLO FILTER IS A SINGLE—STAGE FILTER FEATURING A UNIQUE S—BAFFLE DESIGN IN CONJUNCTION WITH A SLOTTED REAR BAFFLE DESIGN, TO DELIVER EXCEPTIONAL FILTRATION EFFICIENCY.

FILTER IS STAINLESS STEEL CONSTRUCTION, AND SIZED TO FIT INTO STANDARD 2-INCH DEEP HOOD CHANNEL(S).

UNITS SHALL INCLUDE STAINLESS STEEL HANDLES AND A FASTENING DEVICE TO SECURE THE TWO


COMPONENTS WHEN ASSEMBLED. GREASE EXTRACTION EFFICIENCY PERFORMANCE SHALL REMOVE AT LEAST 75% OF GREASE

PARTICLES FIVE MICRONS IN SIZE, AND 85% GREASE PARTICLES SEVEN MICRONS IN SIZE AND LARGER, WITH A CORRESPONDING PRESSURE DROP NOT TO EXCEED 1.0 INCHES OF WATER GAUGE. THE CAPTRATE GREASE-STOP SOLO WAS TESTED TO ASTM STANDARD ASTM F2519-05. MANUFACTURER APPROVED FOR USE IN SOLID FUEL APPLICATIONS AS A SPARK ARRESTER.

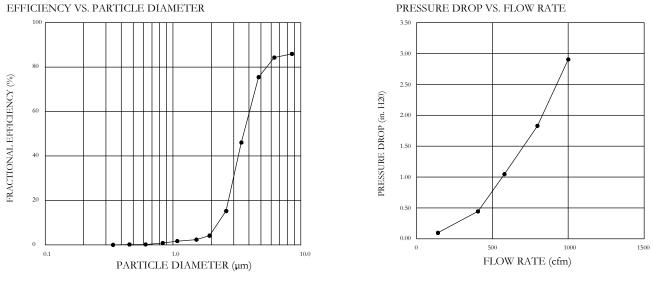


CAPTRATE FILTERS ARE BUILT IN COMPLIANCE WITH: NSF STANDARD #2 UL STANDARD #1046 INT, MECH, CODE (IMC)




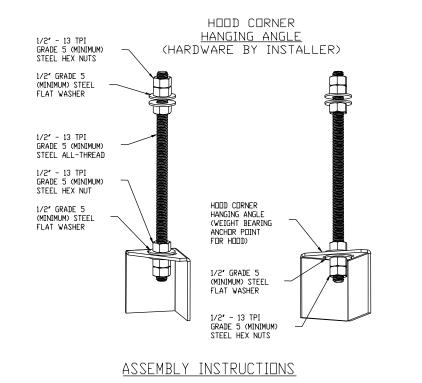

HANGING ANGLE MUST BE SUPPORTED WITH 1/2" - 13 TPI GRADE 5 (MINIMUM) ALL-THREAD, SANDWICH HANGING ANGLES AND CEILING ANCHOR POINTS WITH 1/2" GRADE 5 (MINIMUM) STEEL FLAT WASHERS AND 1/2" - 13 TPI GRADE 5 (MINIMUM) HEX NUTS AS SHOWN. MUST USE DOUBLED HEX NUT CONFIGURATION BENEATH HOOD HANGING ANGLES AND ABOVE CEILING ANCHORS, MAINTAIN 1/4" OF EXPOSED THREADS BENEATH BOTTOM HEX NUT. TORQUE ALL HEX NUTS TO 57 FT-LBS.

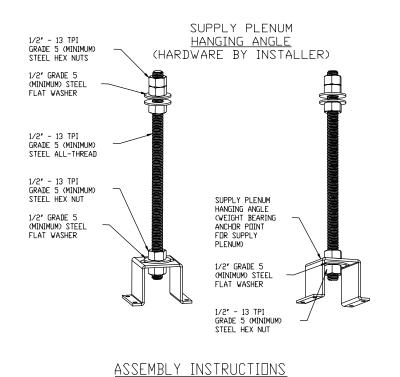

HANGING ANGLE MUST BE SUPPORTED WITH 1/2" - 13 TPI GRADE 5 (MINIMUM) ALL-THREAD. SANDWICH HANGING ANGLES AND CEILING ANCHOR POINTS WITH 1/2" GRADE 5 (MINIMUM) STEEL FLAT WASHERS AND 1/2" - 13 TPI GRADE 5 (MINIMUM) HEX NUTS AS SHOWN, MUST USE DOUBLED HEX NUT CONFIGURATION ABOVE CEILING ANCHORS. SINGLE HEX NUT BENEATH HANGING ANGLE IS ACCEPTABLE FOR PSP HANGING ANGLES. MAINTAIN 1/4" OF EXPOSED THREADS BENEATH BOTTOM HEX NUT. TORQUE ALL HEX NUTS TO 57 FT-LBS.

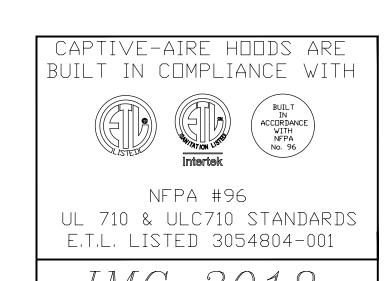

SECTIONS 506, 507, & 508

ETL LISTING DESCRIPTION BLOCK THE CAPTIVE AIRE MODEL ND-2 HAS BEEN E.T.L. TESTED, LISTED, AND APPROVED TO EXHAUST A MINIMUM OF 150 CFM PER LINEAR FOOT OVER 450 DEGREE COOKING EQUIPMENT

CERTIFICATE:

CODE REVIEW:



SPIEZLE ARCHITECTURAL GROUP INC. 1395 YARDVILLE HAMILTON SQUARE ROAD SUITE 2A HAMILTON, NJ 08691 Phone: 609-695-7400

21Al01505400 21Al01674400

21Al01564200

SIGNATURE: THOMAS S. PERRINO SCOTT E. DOWNIE STEVEN LEONE STEVEN G. SIEGEL SPIEZLE ARCHITECTURAL GROUP, INC.

SEAL:

CONSULTANTS:

BID SET 09-24-20

PROJECT:

KITCHEN AND OFFICE RENOVATIONS AT BRIGANTINE CONSOLIDATED SCHOOL

> 301 EAST EVANS BLVD. BRIGANTINE, NJ 08203

BRIGANTINE BOARD

OF EDUCATION 301 EAST EVANS BLVD., BRIGANTINE, NJ 08203

DD/MM/YYYY FOR CODE REVIEW: **REVISIONS: REVISION NAME** 

FOR BID:

DRAWING TITLE:

FOOD SERVICE EXHAUST HOOD

SCHEDULE & NOTES

09/24/20

COMMISSION NUMBER: 20K009

NUMBER:

AGENCY NUMBER: 01-0570-300-20-2000 01-0570-300-21-1000 DO NOT SCALE THE DRAWINGS DRAWING

FS3.0

ULC-S649

ELECTRICAL PACKAGE - Job#4460207

10	TAG	PACKAGE #	LOCATION	SWITCHE	25	OPTION	FAN:	CONTROLLEI	)			
				LOCATION	QUANTITY		FAN TAG	TYPE	ф	HP	VOLT	FLA
1	27	DCV/ 1111	Wall Mount In SS Box	08 - Ship Loose w/	1 Light	Smoot Controls DCV	KEF-1	Exhaust	3	5.000	208	15.8
1	۲/	DCV-1111	wall Mount In 33 Box	Prewire	1 Fan	Smart Controls DCV	MUA-1	Supply	3	3.000	208	9.5

JOB NO	MODEL NUMBER DCV-1111		DRAWN BY	SCHEMATIC TYPE	DESCRIPTION OF OPERATION	
446020/	JOB NAME Brigantine ES		DATE 8/10/2020	DWG NO	temperature: INVERTER DUTY 3 PHASE MOTOR REQUIRED FOR distance between VFD and Motor; additional cost could ap	JSE WITH VFD. Room temperature sensor shipped loose for field installation. Verify by if distance exceeds 50 feet.
JOB NO	JOB NAME  Brigantine ES  Y CONTROL PANEL  Ctrician  MAXIMUM ALLOWED  PRIMARY CONTROL PANEL  Hot ONIO  Ground OGNIO  WIRE REAKER.  CONTROL POWER.  CONTROL POWER.  LINE LINE L2  LINE L5  LINE L6  Ground OGNIO  CCTOR  FANS  FAN: 01 KEF-1  WIRE TO  DISCONNECT  INNO CONDUIT  INDUIT!  WIRE TO  DISCONNECT  WIRE TO  DISCONNECT  WIRE TO  DISCONNECT	CONTROL PANEL  TO FIRE SYSTEM OARIO MICROSWITCH  WIRE WIRE WIRE CONTROL PANEL  TO REMOTE MOUNTED SWITCHES  CONTROL PANEL  TO HODD LIGHTS GND 1400 W MAX  CONTROL PANEL  TO WORLD WIRE WIRE WIRE MOUNTED SWITCHES  CONTROL PANEL  CONTROL PANEL  TO WORLD WIRE MODU WEB  UDP OUTB  CONTROL PANEL  TO WORLD WIRE MODU UDP TO	DATE 8/10/2020  EL TO ACCE sibility: Elec  CI TO COMMON (I) AR1 TO NORMALLY O AR1 SHOULD HAV INUITY WHEN ARME  DIRECTLY TO COM 5 CONNECTION  ACCE END DE LINE	INSTALL  DWG NO ECP #1-1  SSSDRY ITEMS  trician  COMPO  MICROSW  1:C  O  CLOSED (2).  E  D.  1:C  O  TROL BOARD  HMI  PLUG EDL120A EDL120A  HOOD LI  BLACK  WHITE  GREEN  CETION  MUNICATION 1) DHCP 2)  DPCN FOR Y.  ECTION  IBT  TERMINAL  OWNERS  NSTRUCTIONS.  TROUTER  SEE MANUAL.	Demand Control Ventilation, w. control for 1 Exhaust Fan temperature. INVERTER BUTTS PHABES MIDTE REQUIRED FOR distance between VFD and Motor; additional cost could ap a control for 1 Exhaust Fan temperature. INVERTER BUTTS PHABEL MATCH HOUD TO LIGHTS  INENT LIGHTS  AND SAPE SIGNAL FOR ONLO EXTERNAL SIGNAL FOR ONLO EXTERNAL CONTROL PANEL OKS. SIGNAL FOR ONLO EXTERNAL CONTACTOR COIL  CONTROL PANEL OKS. SIGNAL FOR ONLO EXTERNAL CONTACTOR COIL  CONTROL PANEL OKS. SIGNAL FOR ONLO EXTERNAL CONTACTOR COIL  CONTROL PANEL OKS. SYSTEM DRY CONTACT OSFOIC ONLO DUTPUT OF ONLO DE	1 Supply Fan, Exhaust on in Fire, Lights out in Fire, Fans modulate bosed on duct its With Fire Room temperature sensor shipped loose for field installation/verify by if distance exceeds 50 feet.    HDT
20			TO CONTROL BOAR OR MOUNTED IN HO JME.	RD. ————————————————————————————————————	EXTERNAL SWITCH URE 1	SIGNAL SWITCH THROUGH BMS WILL ACTIVATE ZONE1 FANS AND LIGHTS
22 23			TO CONTROL BOAK OR MOUNTED IN HO JME.	RD	Z1-¬ 1Ī 2 URE 1	
24						

FOR QUESTIONS, CONTACT

SCOTT ADAMS OR BILLY GASTON

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### DEMAND CONTROL VENTILATION SYSTEM

Controls shall be capable of reducing exhaust and supply airflow quantities by using a modulating speed control system. High and Low speeds shall be adjustable by variable frequency drives. A temperature switch in the exhaust duct shall control airflow set point. A MAX airflow override button shall be supplied with an adjustable timer.


Control shall be used in kitchen exhaust applications to reduce exhaust and supply air volumes while cooking appliances are idling.


The Demand Control Ventilation System complies with IMC 507.1.1 by interlocking with cooking appliances through means of a heat sensor to automatically activate exhaust fans during cooking operations.


Demand control ventilation systems are capable of modulating exhaust and make up air fan speeds per the requirements outlined in IECC 403.2.8.

HOOD CONTROL PACKAGE INTERFACE with LCD Screen

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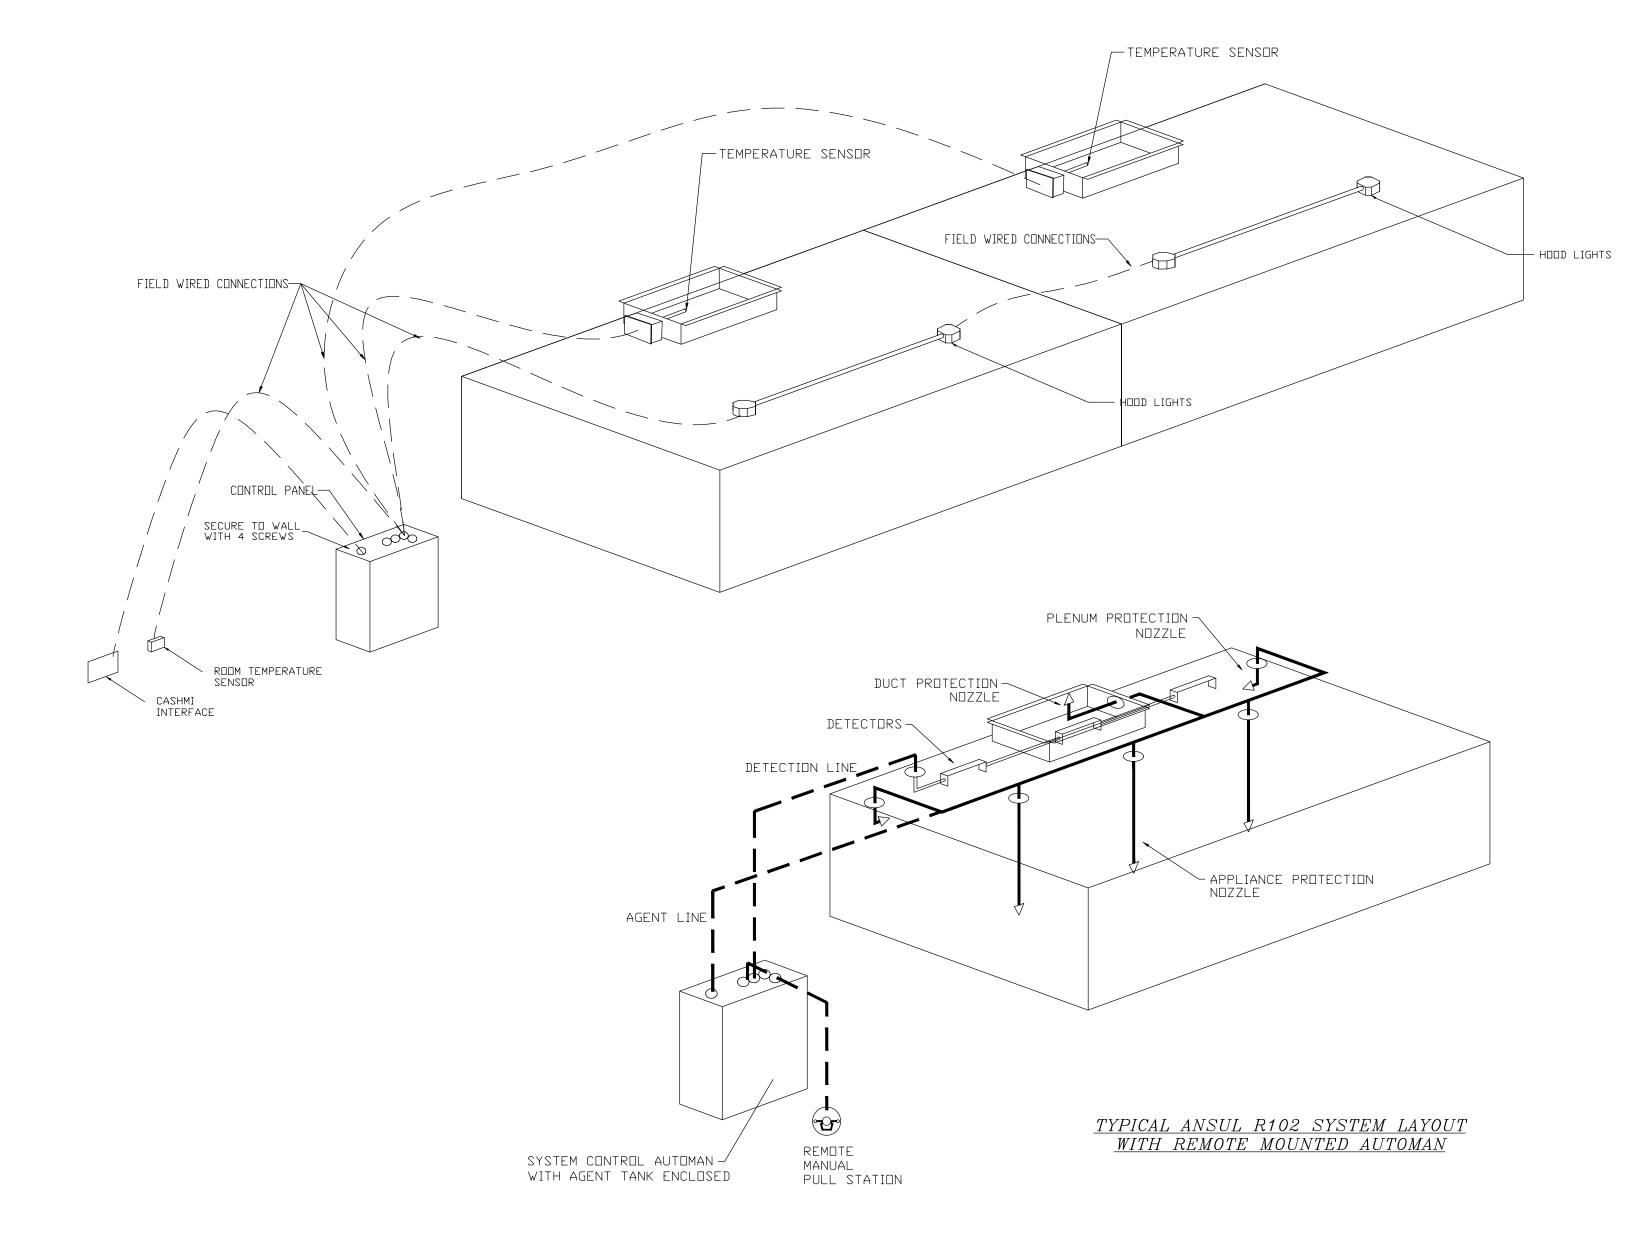

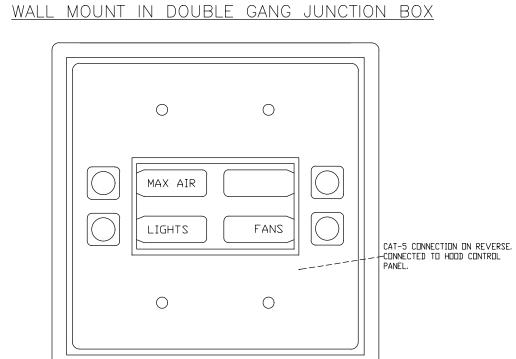
#### CASlink Monitor and Control

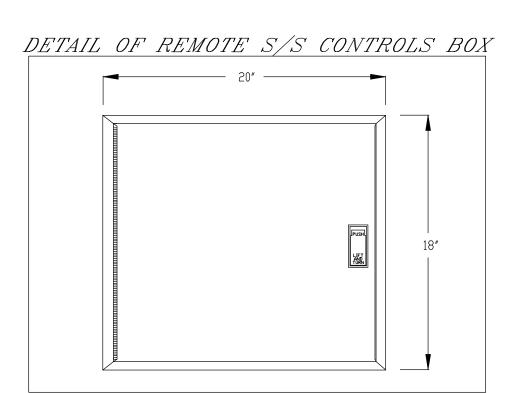Hood control panel to support communications to cloud-based Building Management System.
 Hood Control Panel to allow cloud-based Building Management System to monitor real time parameters outlined as MONITOR in the points list.
 Hood Control Panel to allow cloud-based Building Management System to control parameters outlined as CONTROL in the points list.
 Hood Control Panel to allow cloud-based Building Management System to implement SYSTEM ECONOMIZER control strategies for fully integrated Building
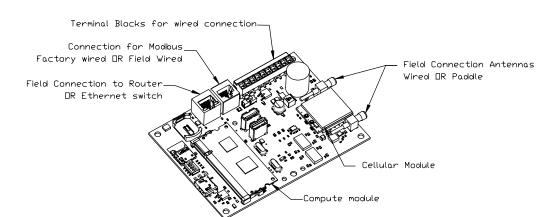
#### MONITORING AND CONTROL POINTS LIST

DCV Packages	Function
Room Temperature	MONITOR
Duct Temperature(s)	MONITOR
MUA Discharge Temperature	MONITOR
Kitchen RTU Discharge Temperature	MONITOR
Fan Speed	MONITOR
Fan Amperage	MONITOR
Fan Power	MONITOR
VFD Faults	MONITOR
Controller Faults	MONITOR
Fan Faults	MONITOR
Fan Status	MONITOR
PCU Faults	MONITOR
PCU Filter Clog Percentages	MONITOR
Fire Condition	MONITOR
CORE Fire System	MONITOR
Building Pressures	MONITOR
Prep Time Button	MONITOR & CONTROL
Fans Button	MONITOR & CONTROL
Lights Button	MONITOR & CONTROL
Wash Button	MONITOR & CONTROL



<u>SPECIFICATIONS</u>

THE RESTAURANT FIRE SUPPRESSION SYSTEM SHALL BE THE PRE-ENGINEERED TYPE WITH A FIXED NOZZLE AGENT DISTRIBUTION NETWORK. IT SHALL BE LISTED WITH UNDERWRITERS LABORATORIES, INC. (UL)

THE SYSTEM SHALL BE CAPABLE OF AUTOMATIC DETECTION AND ACTUATION WITH LOCAL OR REMOTE MANUAL ACTUATION. ACCESSORIES SHALL BE AVAILABLE FOR MECHANICAL OR ELECTRICAL GAS LINE SHUT-OFF APPLICATIONS.

THE EXTINGUISHING AGENT SHALL BE A POTASSIUM CARBONATE, POTASSIUM ACETATE-BASED FORMULATION DESIGNED FOR FLAME KNOCKDOWN AND SECUREMENT OF GREASE RELATED FIRES. IT SHALL BE AVAILABLE IN PLASTIC CONTAINERS WITH INSTRUCTIONS FOR LIQUID AGENT HANDLING AND USAGE.

THE REGULATED RELEASE MECHANISM SHALL BE COMPATIBLE WITH A FUSIBLE LINK DETECTION SYSTEM. THE FUSIBLE LINK SHALL BE SELECTED AND INSTALLED ACCORDING TO THE OPERATING TEMPERATURE IN THE VENTILATING SYSTEM. THE FUSIBLE LINK SHALL BE SUPPORTED BY A DETECTOR BRACKET/LINKAGE ASSEMBLY.

Sequence of Operations:

The hood control panel is capable of operating in one or more of the following states at any given time:

Automatic: The system operates based on the differential between room temperature and the temperature at the hood cavity or exhaust duct collar. Fans activate at a configurable temperature differential threshold. Depending on the job configuration each fan zone can be configured as static or dynamic. These terms refer to whether a variable motor (such as EC Motors or VFD driven motors) modulate with temperature. If the panel is equipped with variable speed fans and the zone is defined as "dynamic", these will modulate within a user-defined range based on the temperature differential. Panels equipped with variable speed fans and a fan zone defined as "static", fans will run at a set speed calculated for the drive. Demand control ventilation systems are capable of modulating exhaust and make up air fan speeds per the requirements outlined in IECC 403.2.8.

- <u>Manual:</u> The system operates based on human input from an HMI.

- <u>Schedule:</u> A weekly schedule can be set to run fans for a specified period throughout the day. There are three occupied times per day to allow for the user to set up a time that is suitable to their needs. Any time that is within the defined occupied time, the system will run at modulation mode and follow the fan procedure algorithm based on temperature during this time. During unoccupied time, the system will have an extra offset to prevent unintended activation of the system during a time where the system is not being occupied.

Other: The system operates based on the input from an external source (DDC, BMS or hard-wired interlock) CODE REVIEW:

spiezle

SPIEZLE ARCHITECTURAL GROUP INC. 1395 YARDVILLE HAMILTON SQUARE ROAD SUITE 2A HAMILTON, NJ 0869 I Phone: 609-695-7400

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 21AC00063000

CONSULTANTS:

BID SET 09-24-20

PROJECT:

KITCHEN AND OFFICE RENOVATIONS AT BRIGANTINE CONSOLIDATED SCHOOL

> 301 EAST EVANS BLVD. BRIGANTINE, NJ 08203

BRIGANTINE BOARD

OF EDUCATION
301 EAST EVANS BLVD.,

FOR CODE REVIEW: DD/MM/YYYY

REVISIONS:

REVISION NAME DATE

BRIGANTINE, NJ 08203

FOR BID:

DRAWING TITLE:

FOOD SERVICE EXHAUST HOOD SCHEDULE & NOTES CONTINUED

09/24/20

COMMISSION NUMBER: 20K009 AGENCY NUMBER: 01-0570-300-20-2000 01-0570-300-21-1000

DO NOT SCALE THE DRAWINGS

FS4.0

#### <u>EXHAUST FAN INFORMATION - Job#4460207</u> WEIGHT (LBS) DISCHARGE VELOCITY MOTOR ENCL ESP HP BHP Ø VOLT FLA FAN UNIT MODEL # CFM RPM 4000 | 1.750 | 941 | DDP,PREMIUM | 5.000 | 2.3480 | 3 | 208 | 15.8 | 909 FPM 1 | KEF-1 | 1 | DU240HFA

MUA	FAN	INFO	RMATION - Job#4460207	7															
FAN UNIT NI	TAG	QTY	FAN UNIT MODEL #	BLOWER	HDUSING	MIN CFM	DESIGN CFM	ESP	RPM	MOTOR ENCL	HP	BHP	ø	VOLT	FLA	MCA	MOCP	WEIGHT (LBS)	SONES
2	MUA-1	1	A2-IBT-400-20D	20MF-2-MDD	A2-IBT-400	2500	3500	0.750	1413	ODP,PREMIUM	3.000	1.8270	3	208	9.5	11.9A	20A	1223	13.2


GAS	FIRED	MAKE-	UP AIR	UNIT(S)			
FAN UNIT NO	TAG	INPUT BTUs	DUTPUT BTUs	TEMP RISE	REQUIRED INPUT GAS PRESSURE	GAS TYPE	BURNER EFFICIENCY(%)
2	MUA-1	315705	252564	60 deg F	7 in. w.c. – 14 in. w.c.	Natural	80

	MOH I	31370	232364	oo acg i	/ IFI. W.C. 14 IFI. W.C.	Nu car ut	00	
$\overline{FAN}$	OPTIO1	VS						
FAN UNIT NO	TAG	QTY			Description			
1	KEF-1	1	Grease Box					
		1	Single Module.	If a Non-DCV 1 E2" Option Prev	n (main and control panel) for Stand Prewire is used on the IBT Heater, r vire must be selected. Do not pro	the #28, #47,		
		1	Motorized Back	draft Damper f	for A2-I Housing			
2	MUA-1	1	Inlet Pressure	Gauge, 0-35"				
		1	Manifold Pressu	ire Gauge, O to	) 10″ wc, 1 Furnace	·		

Separate 120V Wiring Package (Required and used only for DCV or Prewire with

<u>CUI</u>	CURB ASSEMBLIES						
ND	□N FAN	TAG	WEIGHT	ITEM	SIZE		
1	# 1	KEF-1	48 LBS	Curb	31.500"W x 31.500"L x 20.000"H Right Vented Hinged		
2	# 2	MUA-1	107 LBS	Curb	31.000"W x 79.000"L x 20.000"H Right Insulated		
	# 2			Rail	6.000"W x 31.000"L x 20.000"HRight		

#### <u>FAN #1 DU240HFA - EXHAUST FAN (KEF-1)</u>

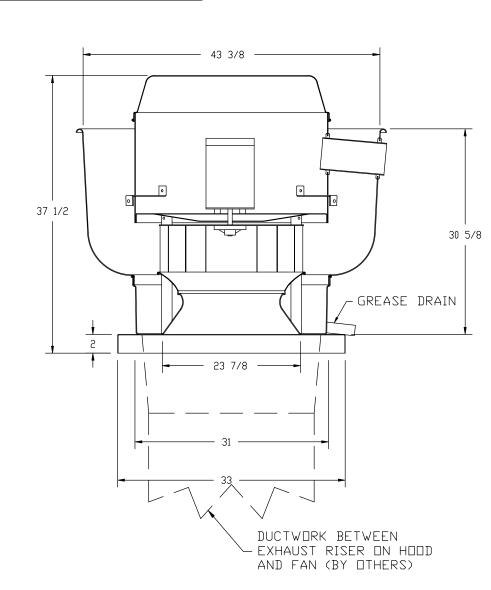

#### <u>FEATURES:</u>

- DIRECT DRIVE CONSTRUCTION (NO BELTS/PULLEYS) - ROOF MOUNTED FANS
- RESTAURANT MODEL - UL705 AND UL762 AND ULC-S645 - VARIABLE SPEED CONTROL
- INTERNAL WIRING

- GREASE CLASSIFICATION TESTING

WOULD CAUSE UNSAFE OPERATION.


- WEATHERPROOF DISCONNECT - THERMAL OVERLOAD PROTECTION (SINGLE PHASE) - HIGH HEAT OPERATION 300°F (149°C)
- NORMAL TEMPERATURE TEST EXHAUST FAN MUST OPERATE CONTINUOUSLY WHILE EXHAUSTING AIR AT 300°F (149°C) UNTIL ALL FAN PARTS HAVE REACHED THERMAL EQUILIBRIUM, AND WITHOUT ANY
- ABNORMAL FLARE-UP TEST EXHAUST FAN MUST OPERATE CONTINUOUSLY WHILE EXHAUSTING BURNING GREASE VAPORS AT 600°F (316°C) FOR A PERIOD OF 15 MINUTES WITHOUT THE FAN BECOMING

DAMAGED TO ANY EXTENT THAT COULD CAUSE

DETERIORATING EFFECTS TO THE FAN WHICH

<u>DPTIONS</u> GREASE BOX.

AN UNSAFE CONDITION.

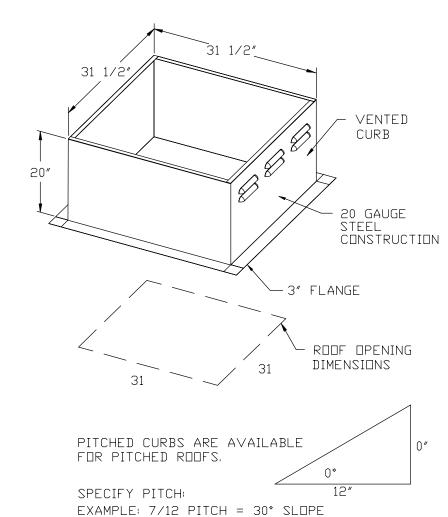

4460207 - Briga...

SHIP DATE 8/10/2020 MODEL A2-IBT-400-20D

CERTIFICATE:

CODE REVIEW:



21Al01674400 21Al01170100 21Al01564200 21AC00063000

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CONSULTANTS:

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301 EAST EVANS BLVD. BRIGANTINE, NJ 08203

## BRIGANTINE BOARD

OF EDUCATION 301 EAST EVANS BLVD., BRIGANTINE, NJ 08203

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FOOD SERVICE EXHAUST HOOD SCHEDULE & NOTES

CONTINUED COMMISSION NUMBER: 20K009

**AGENCY NUMBER:** 01-0570-300-20-2000 01-0570-300-21-1000 DO NOT SCALE THE DRAWINGS DRAWING NUMBER:

FS5.0

FAN #2 A2-IBT-400-20D - HEATER (MUA-1)
1. INDIRECT BENT TUBE GAS FIRED HEATER WITH 20" DIRECT DRIVE FAN, 1 FURNACE, ELECTRONIC FULL MODULATION, CONSTANT 80% EFFICIENCY, AND 6:1 MAX
TURNDOWN FOR NG, (5:1 MAX TURNDOWN FOR LP). STAINLESS STEEL BURNER AND HEAT EXCHANGER.
2. INTAKE HOOD WITH EZ FILTERS
O OTHE DIOCHARGE ATD FURLY DIGHT A LEFT

- 4. SEPARATE 120V ELECTRICAL CONNECTION FOR ALL IBT HEATERS WITH 1 MODULE FOR STANDING POWER. 120V MUST BE RUN BY ELECTRICIAN FROM BUILDING PANEL TO MUA SWITCH.

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IBT Size 1 & 2 Side Discharge

VFD) - Three Phase Only

PANEL TO MUA SWITCH.

5. MOTORIZED BACK DRAFT DAMPER 22.75" X 24" FOR SIZE 2 STANDARD & MODULAR HEATER UNITS W/EXTENDED SHAFT, STANDARD GALVANIZED CONSTRUCTION, 3/4" REAR FLANGE, LOW LEAKAGE, LF120S ACTUATOR INCLUDED

6. GAS PRESSURE GAUGE, 0-35", 2.5" DIAMETER, 1/4" THREAD SIZE

7. GAS PRESSURE GAUGE, 0 TO +10 INCHES WC., 2.5" DIAMETER, 1/8" THREAD SIZE, REAR THREAD

8. USED WITH SIZE 1 AND SIZE 2 SIDE DISCHARGE IBT MODULES.


9. SEPARATE 120VAC WIRING PACKAGE FOR MAKE-UP AIR UNITS. OPTION MUST BE SELECTED WHEN MOUNTING VFD IN PREWIRE PANEL OR WITH DCV PACKAGE. PROVIDES SEPARATE 120VAC INPUT TO SUPPLY FAN. THIS 120V SIGNAL MUST BE RUN BY ELECTRICIAN FROM DCV TO MUA SWITCH. 10. HINGED DOUBLE WALL INSULATED DOOR ASSEMBLY (BURNER/BLOWER SECTION)
IBT - US Patent 877119 B2


\*NOTE: SUPPLY DUCT MUST BE INSTALLED TO MEET SMACNA STANDARDS. A MINIMUM STRAIGHT DUCT LENGTH MUST BE MAINTAINED DOWNSTREAM OF UNIT DISCHARGE AS DUTLINED IN AMCA PUBLICATION 201. WHEN USING RECTANGULAR DUCTWORK, ELBOWS MUST BE RADIUS THROAT, RADIUS BACK WITH TURNING VANES. FLEXIBLE DUCTWORK AND SQUARE THROAT/SQUARE BACK ELBOWS SHOULD NOT BE USED. ANY TRANSITION AND/OR TURNS IN THE DUCTWORK WILL CAUSE SYSTEM EFFECT. SYSTEM EFFECT WILL DRASTICALLY INCREASE STATIC PRESSURE AND REDUCE AIRFLOW. DO NOT RELY ON UNIT TO SUPPORT DUCT IN ANY WAY, FAILURE TO PROPERLY SIZE DUCTWORK MAY CAUSE SYSTEM EFFECTS AND REDUCE PERFORMANCE OF THE EQUIPMENT. SUGGESTED STRAIGHT DUCT SIZE IS 26" x 26"


CURB DUTER WALL —


SUPPLY SIDE HEATER INFORMATION: WINTER TEMPERATURE = 15°F. TEMP. RISE = 60°F. BTUs CALCULATED DFF ACTUAL AIR DENSITY DUTPUT BTUs AT ALTITUDE DF 0.0 ft. = 252710 INPUT BTUS AT ALTITUDE OF 0.0 ft. = 315888 OUTPUT BTUS AT ALTITUDE OF 16 ft. = 252564 INPUT BTUs AT ALTITUDe DF 16 ft. = 315705

AIRFLOW

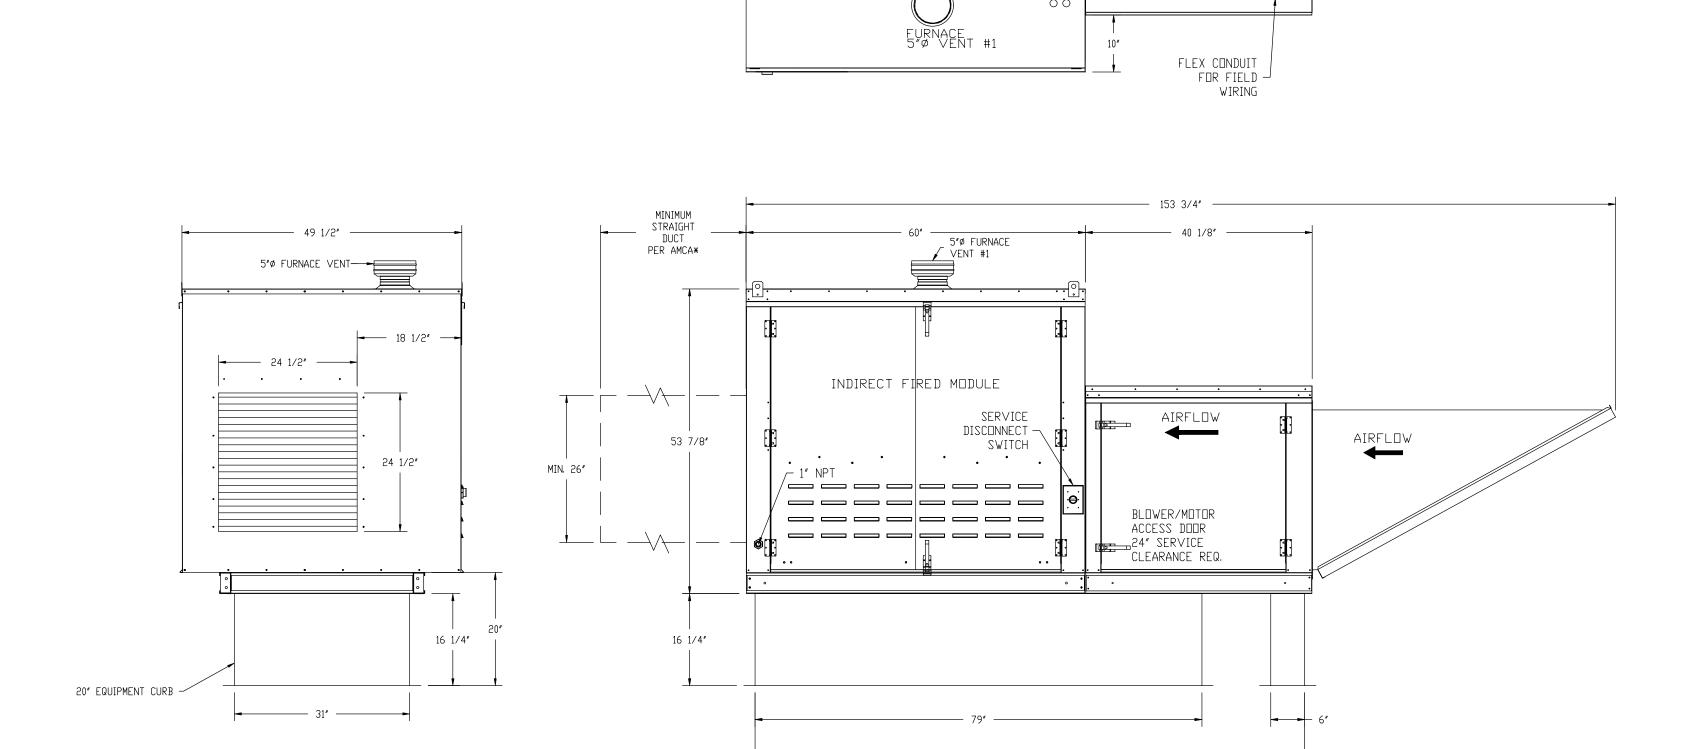

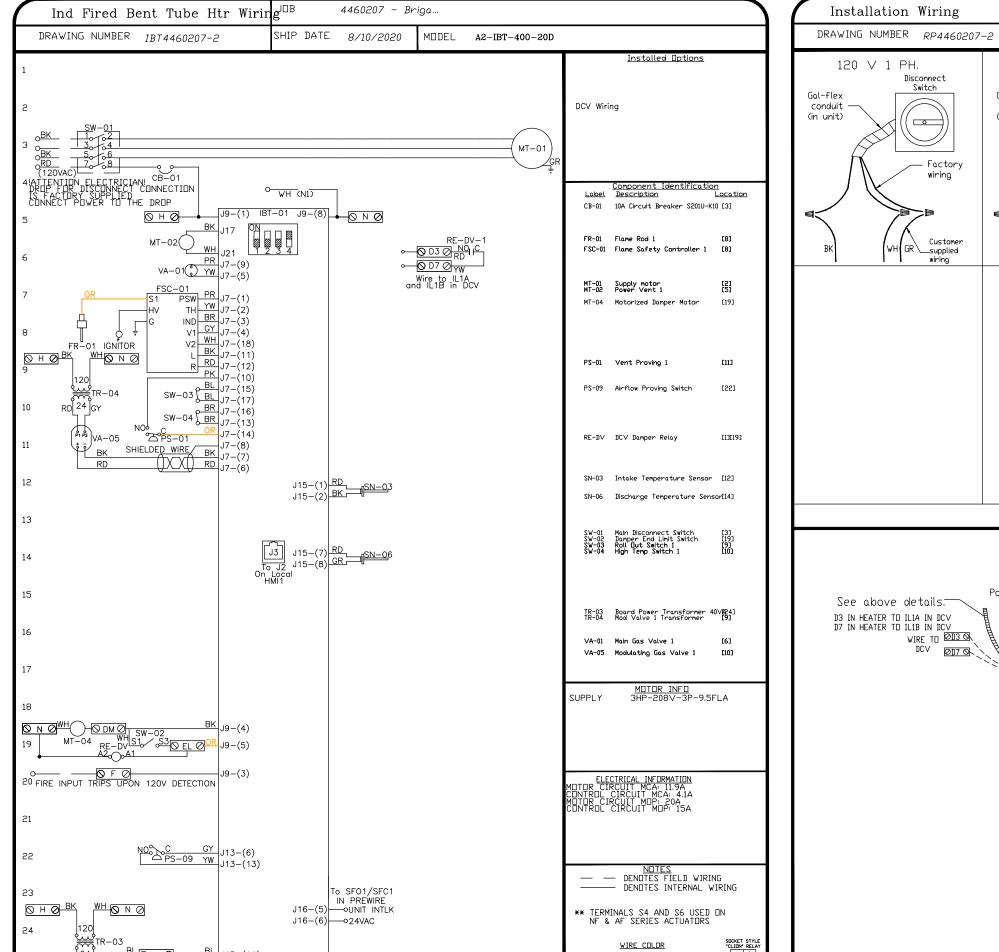

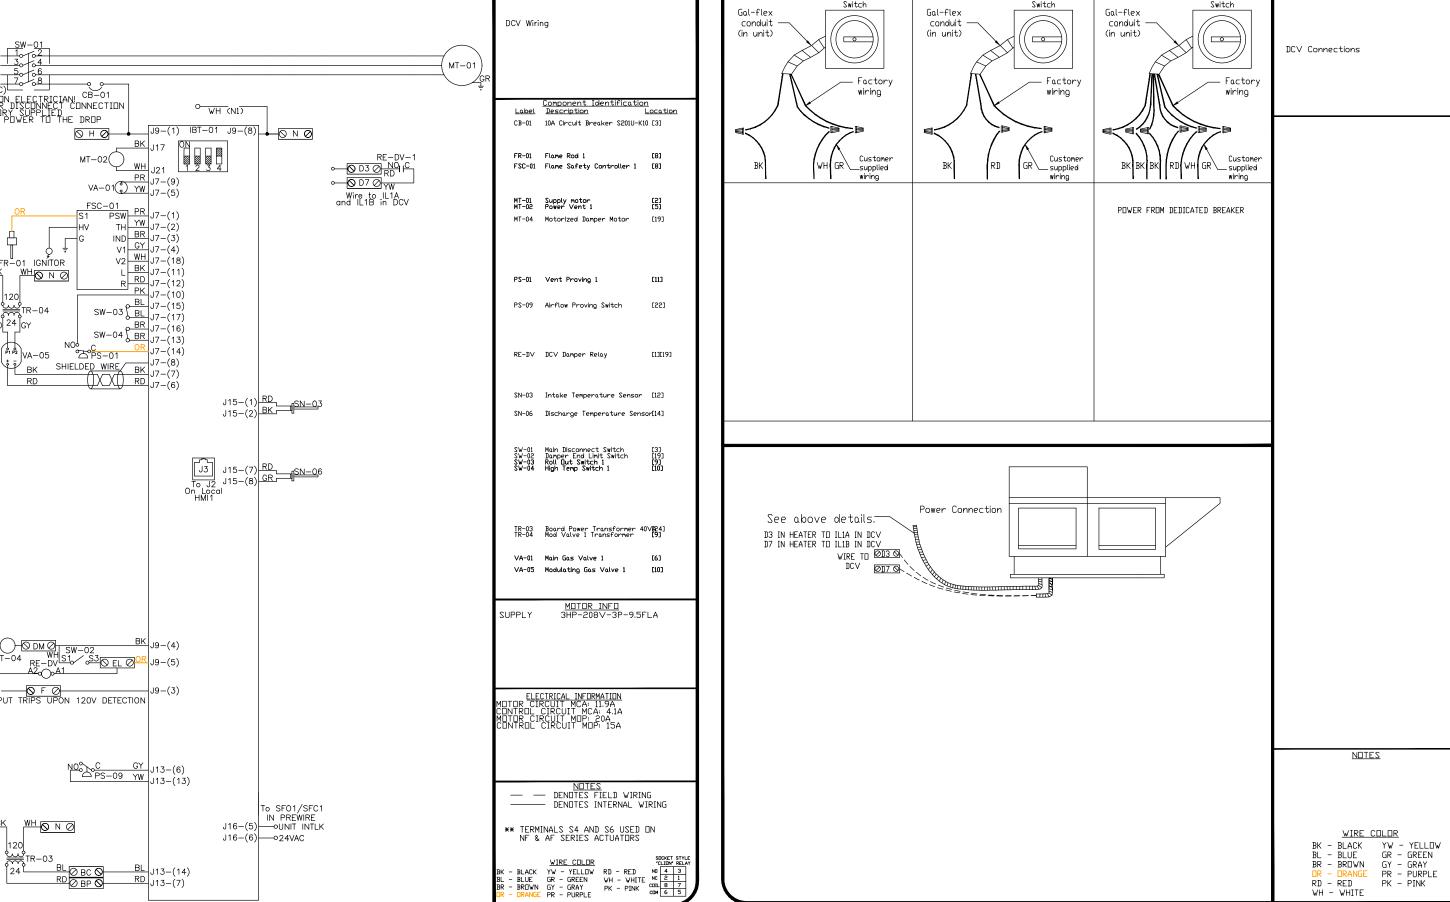

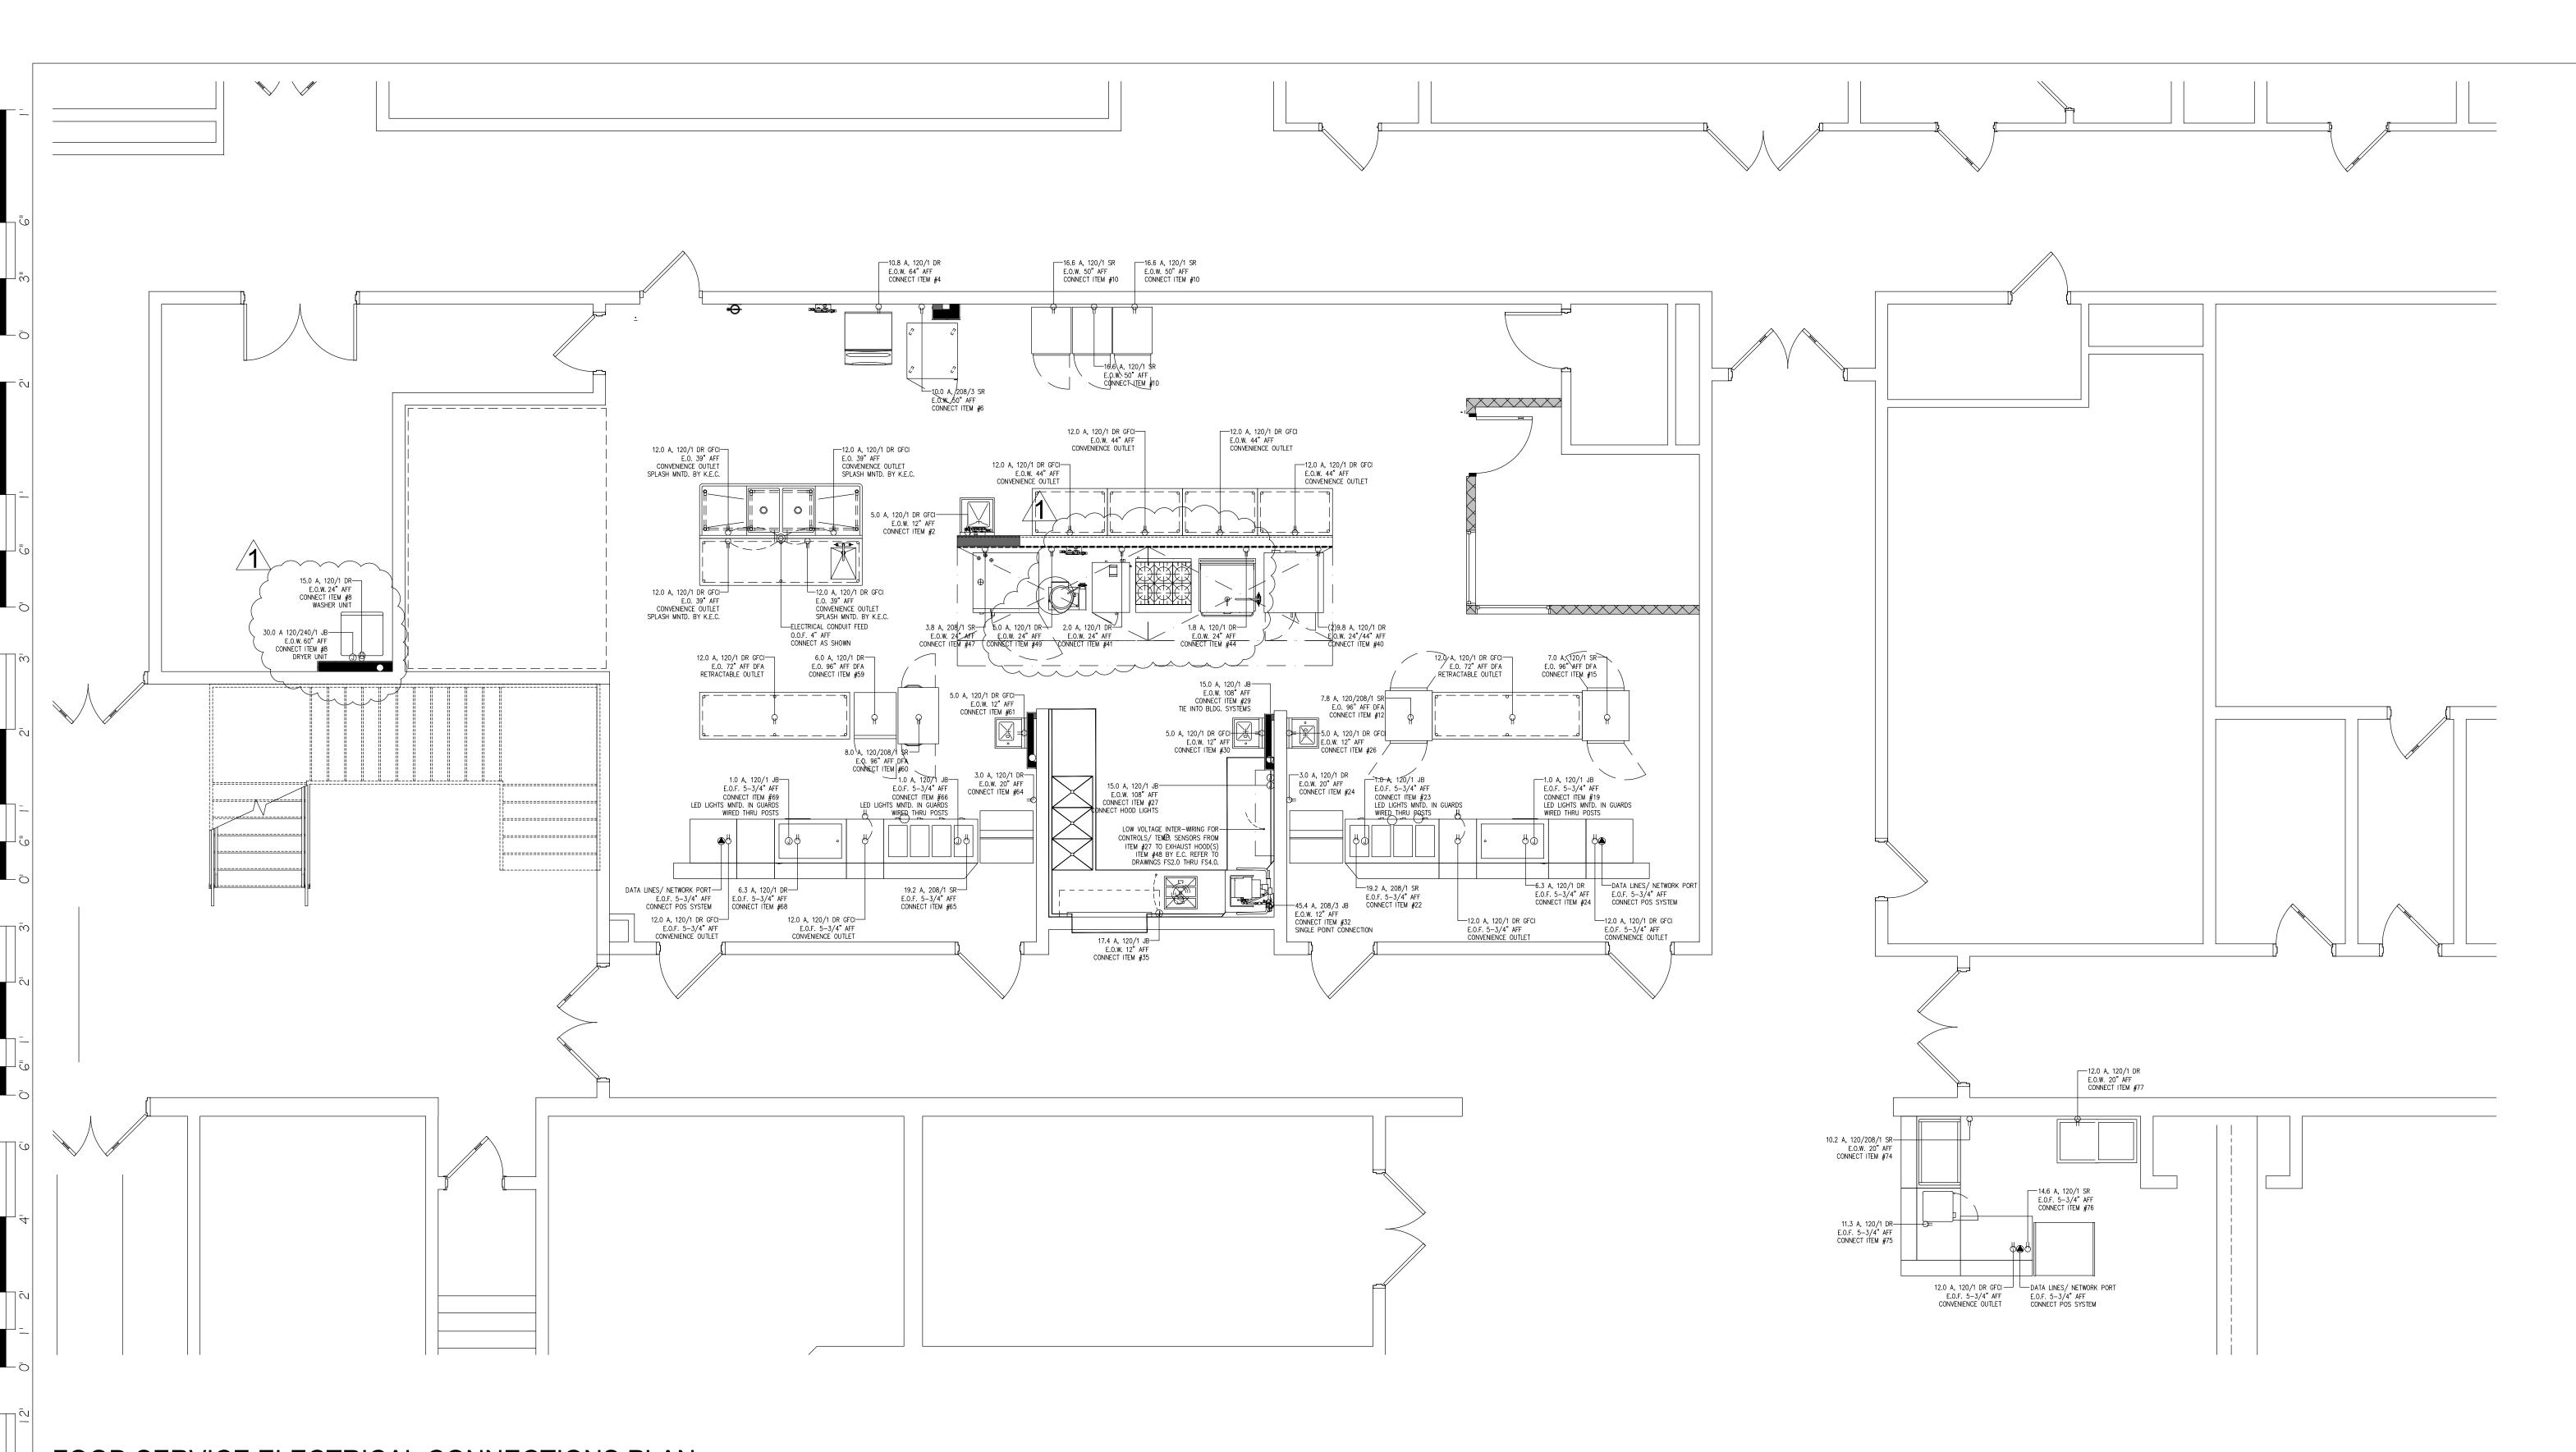

FOOD SERVICE ELECTRICAL CONNECTIONS PLAN

SCALE: 1/4"=1'-0"

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ELECTRICAL LEGEND				
JB	JUNCTION BOX			
DR	DUPLEX RECEPTACLE			
SR	SIMPLEX RECEPTACLE			
E.O.W.	ELECTRICAL OUT OF WALL			
E.O.F.	ELECTRICAL OUT OF FLOOR			
D.F.A.	DOWN FROM ABOVE			
AFF	ABOVE FINISHED FLOOR			
BTC	BRANCH TO CONNECTION			
А	AMPS			
HP	HORSEPOWER			
kW	KILOWATT			
E.C.	ELECTRICAL CONTRACTOR			

VERIFY ALL DIMENSIONS PRIOR TO WORK.

ELECTRICAL CONTRACTOR NOTES:

- 1. ELECTRICAL CONTRACTOR TO PROVIDE REQUIRED CONVENIENCE RECEPTACLES AS PER LOCAL CODE HAVING JURISDICTION AND PER OWNERS REQUESTS/ NEEDS.
- 2. ELECTRICAL CONTRACTOR TO VERIFY IF CONVENIENCE RECEPTACLES ARE TO BE GFCI PER LOCAL CODE HAVING JURISDICTION.
- 3. MOUNTING HEIGHTS GIVEN ARE TO CENTERLINE OF DEVICE UNLESS OTHERWISE NOTED.
- 4. FLOOR MOUNTED DEVICES ARE TO BE MOUNTED WITH A 5 3/4" MAXIMUM HEIGHT TO TOP OF BOX.
- 5. ALL RECEPTACLES, J-BOXES, SWITCHES, INTER-WIRING, DISCONNECT SWITCHES, MOTOR STARTERS AND/OR TRANSFORMERS OR ANY OTHER ELECTRICAL DEVICE REQUIRED TO MAKE EQUIPMENT OPERATIONAL IS TO BE SUPPLIED BY ELECTRICAL CONTRACTOR AND IS NOT PART OF THE KITCHEN EQUIPMENT CONTRACTORS SCOPE OF WORK UNLESS OTHERWISE SPECIFIED.
- 6. ALL POWER CONNECTION POINTS UNDER EXHAUST HOODS ARE TO BE SHUT DOWN UPON FIRE SUPPRESSION SYSTEM ACTIVATION PER NFPA 96. ELECTRICAL CONTRACTOR TO FURNISH AND INSTALL SHUNT-TRIP BREAKERS FOR THESE CIRCUITS.
- 7. ELECTRICAL CONTRACTOR TO VERIFY, FURNISH AND INSTALL REQUIRED ELECTRICAL ROUGH-INS FOR ALL EQUIPMENT BEING SUPPLIED.

CERTIFICATE:



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SIGNATURE:	
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SCHOOL 301 EAST EVANS BLVD. BRIGANTINE, NJ 08203

FOR

BRIGANTINE BOARD OF EDUCATION 301 EAST EVANS BLVD., BRIGANTINE, NJ 08203

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I	ADDENDUM # I	10/05/20			

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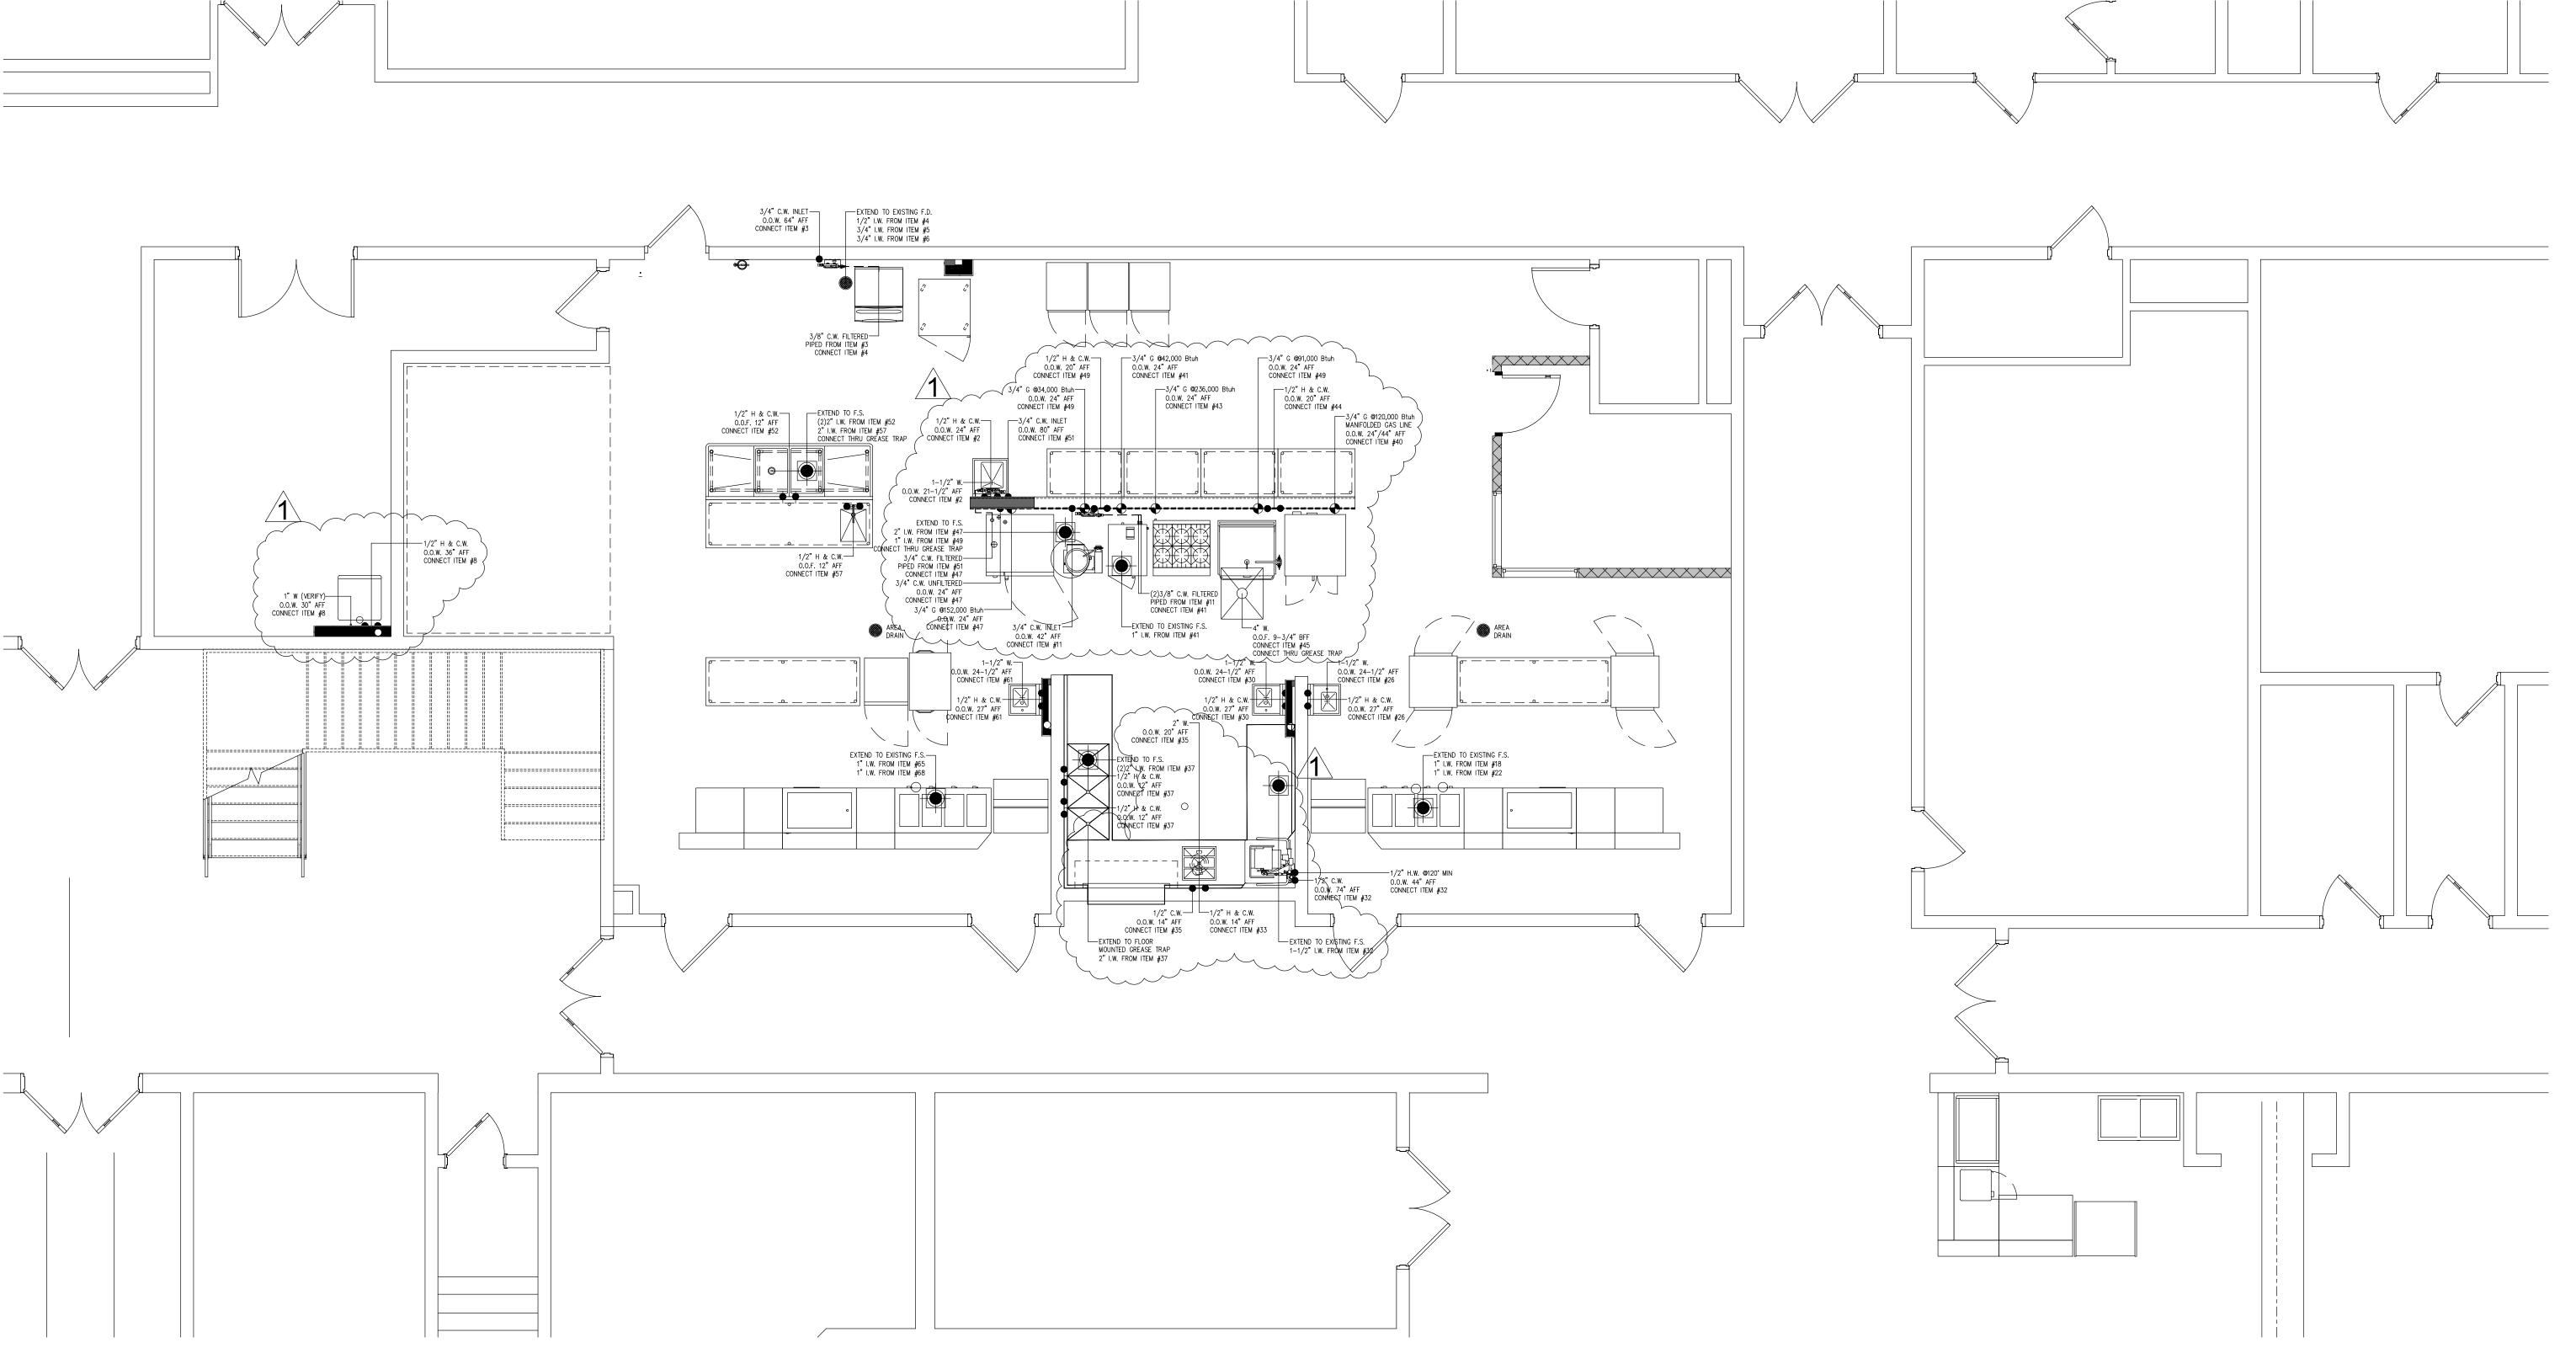
FOOD SERVICE ELECTRICAL CONNECTIONS PLAN ₽ NOTES

COMMISSION NUMBER: 20K009

AGENCY NUMBER: 01-0570-300-20-2000 01-0570-300-21-1000 DO NOT SCALE THE DRAWINGS

FS6.0

C.	ELECTRICAL CONTRACTOR
ECTRICAL N	OTES:
ALL WALL	OUTLETS ARE FROM AFF TO OX.
E.C. TO (	CHECK ALL CONDITIONS AND



FOOD SERVICE PLUMBING CONNECTIONS PLAN SCALE: 1/4"=1'-0"

	PLUMBING LEGEND
H.W.	HOT WATER
C.W.	COLD WATER
W	DIRECT WASTE
I.W.	INDIRECT WASTE
F.D.	FLOOR DRAIN
F.S.	FLOOR SINK
G	GAS
O.O.W.	OUT OF WALL
0.0.F.	OUT OF FLOOR
AFF	ABOVE FINISHED FLOOR
ВТС	BRANCH TO CONNECTION
P.C.	PLUMBING CONTRACTOR

## PLUMBING NOTES:

1) P.C. TO PROVIDE HUB DRAINS FOR ALL INDIRECT WASTE LINES AND RETAIN AIR GAPS AS REQUIRED.

2) P.C. TO CHECK ALL CONDITIONS AND VERIFY ALL DIMENSIONS PRIOR TO WORK.

### PLUMBING CONTRACTOR NOTES:

- 1. SHUT-OFF VALVES ON THE INLET SIDE OF THE COLD AND HOT WATER LINES SERVING EACH PIECE OF EQUIPMENT ARE TO BE FURNISHED AND INSTALLED BY THE PLUMBING CONTRACTOR.
- 2. IF WATER PRESSURE AT THE EQUIPMENT AREA EXCEEDS 50 POUNDS FLOW PRESSURE OWNER OR HIS CONTRACTOR MUST INSTALL A PRESSURE REDUCING VALVE ON BOTH THE MAIN HOT WATER AND COLD WATER SUPPLY LINES SERVICING THE AREA.
- 3. FLOW PRESSURE TO DISHWASHER (OR ITS AUXILIARY HOT WATER BOOSTER HEATER IF ONE IS USED) MUST NOT EXCEED 25 POUNDS.
- 4. OWNER OR HIS CONTRACTOR MUST PROVIDE AN ADEQUATE SUPPLY OF 110° F HOT WATER, MINIMUM, TO ALL COOKING EQUIPMENT, DISHWASHER, BOOSTER HEATER, WORK SINKS, HAND SINKS, ETC...
- DISCHARGES HOT WATER SUCH AS STEAMERS & DISHWASHERS MAY CAUSE THE P.V.C. PIPING TO SOFTEN OR CRACK. IT IS RECOMMENDED THAT METAL (COPPER OR GALVANIZED) PIPING BE USED.

5. USING PVC PIPING FOR DRAIN LINES FROM EQUIPMENT THAT

- 6. CHECK WITH LOCAL CODES TO DETERMINE WHAT EQUIPMENT IS TO BE PIPED THROUGH A GREASE TRAP. EQUIPMENT NOTED ON FOOD SERVICE CONTRACT DRAWINGS ARE REQUIRED/ RECOMMENDED AND SHOULD BE VERIFIED FOR COMPLIANCE BY THE PLUMBING CONTRACTOR (GREASE TRAP(S) TO BE PROVIDED BY PLUMBING CONTRACTOR).
- 7. PLUMBING CONTRACTOR TO INSTALL MECHANICAL GAS SHUT-OFF VALVE IN GAS MAIN FEEDING ALL COOKING EQUIPMENT PRIOR TO ANY TEES OR GAS LOOP FEEDING COOKING EQUIPMENT. MECHANICAL SHUT-OFF VALVE IS RECOMMENDED TO BE INSTALLED IN ACCESSIBLE CEILING SPACE OR BELOW FLOOR WITH ACCESS TO VALVE.
- 8. PLUMBING CONTRACTOR TO PROVIDE FLOOR DRAINS AND/OR FLOOR SINKS AS PER LOCAL CODE HAVING JURISDICTION AND OWNERS
- 9. PLUMBING CONTRACTOR IS TO REVIEW ALL CATALOG DATA PROVIDED AS PART OF THE FOOD SERVICE CONTRACT DOCUMENTS TO ESTABLISH THE NECESSARY GAS PRESSURE TO THE KITCHEN EQUIPMENT. IF GAS PRESSURE TO KITCHEN EQUIPMENT IS HIGHER THAN REQUIRED, A PRESSURE REGULATOR IS TO BE PROVIDED BY THE PLUMBING CONTRACTOR OR BY THE GAS COMPANY. THE GAS PRESSURE REGULATOR MUST BE INSTALLED PRIOR TO THE GAS FEEDING ANY KITCHEN EQUIPMENT. EXCESSIVE GAS PRESSURE TO THE EQUIPMENT CAN DAMAGE THE EQUIPMENT AND CAUSE PERSONAL INJURY.
- 10. PLUMBING CONTRACTOR TO VERIFY, FURNISH AND INSTALL REQUIRED PLUMBING ROUGH-INS FOR ALL EQUIPMENT BEING SUPPLIED.

CERTIFICA

CODE REVIEW:



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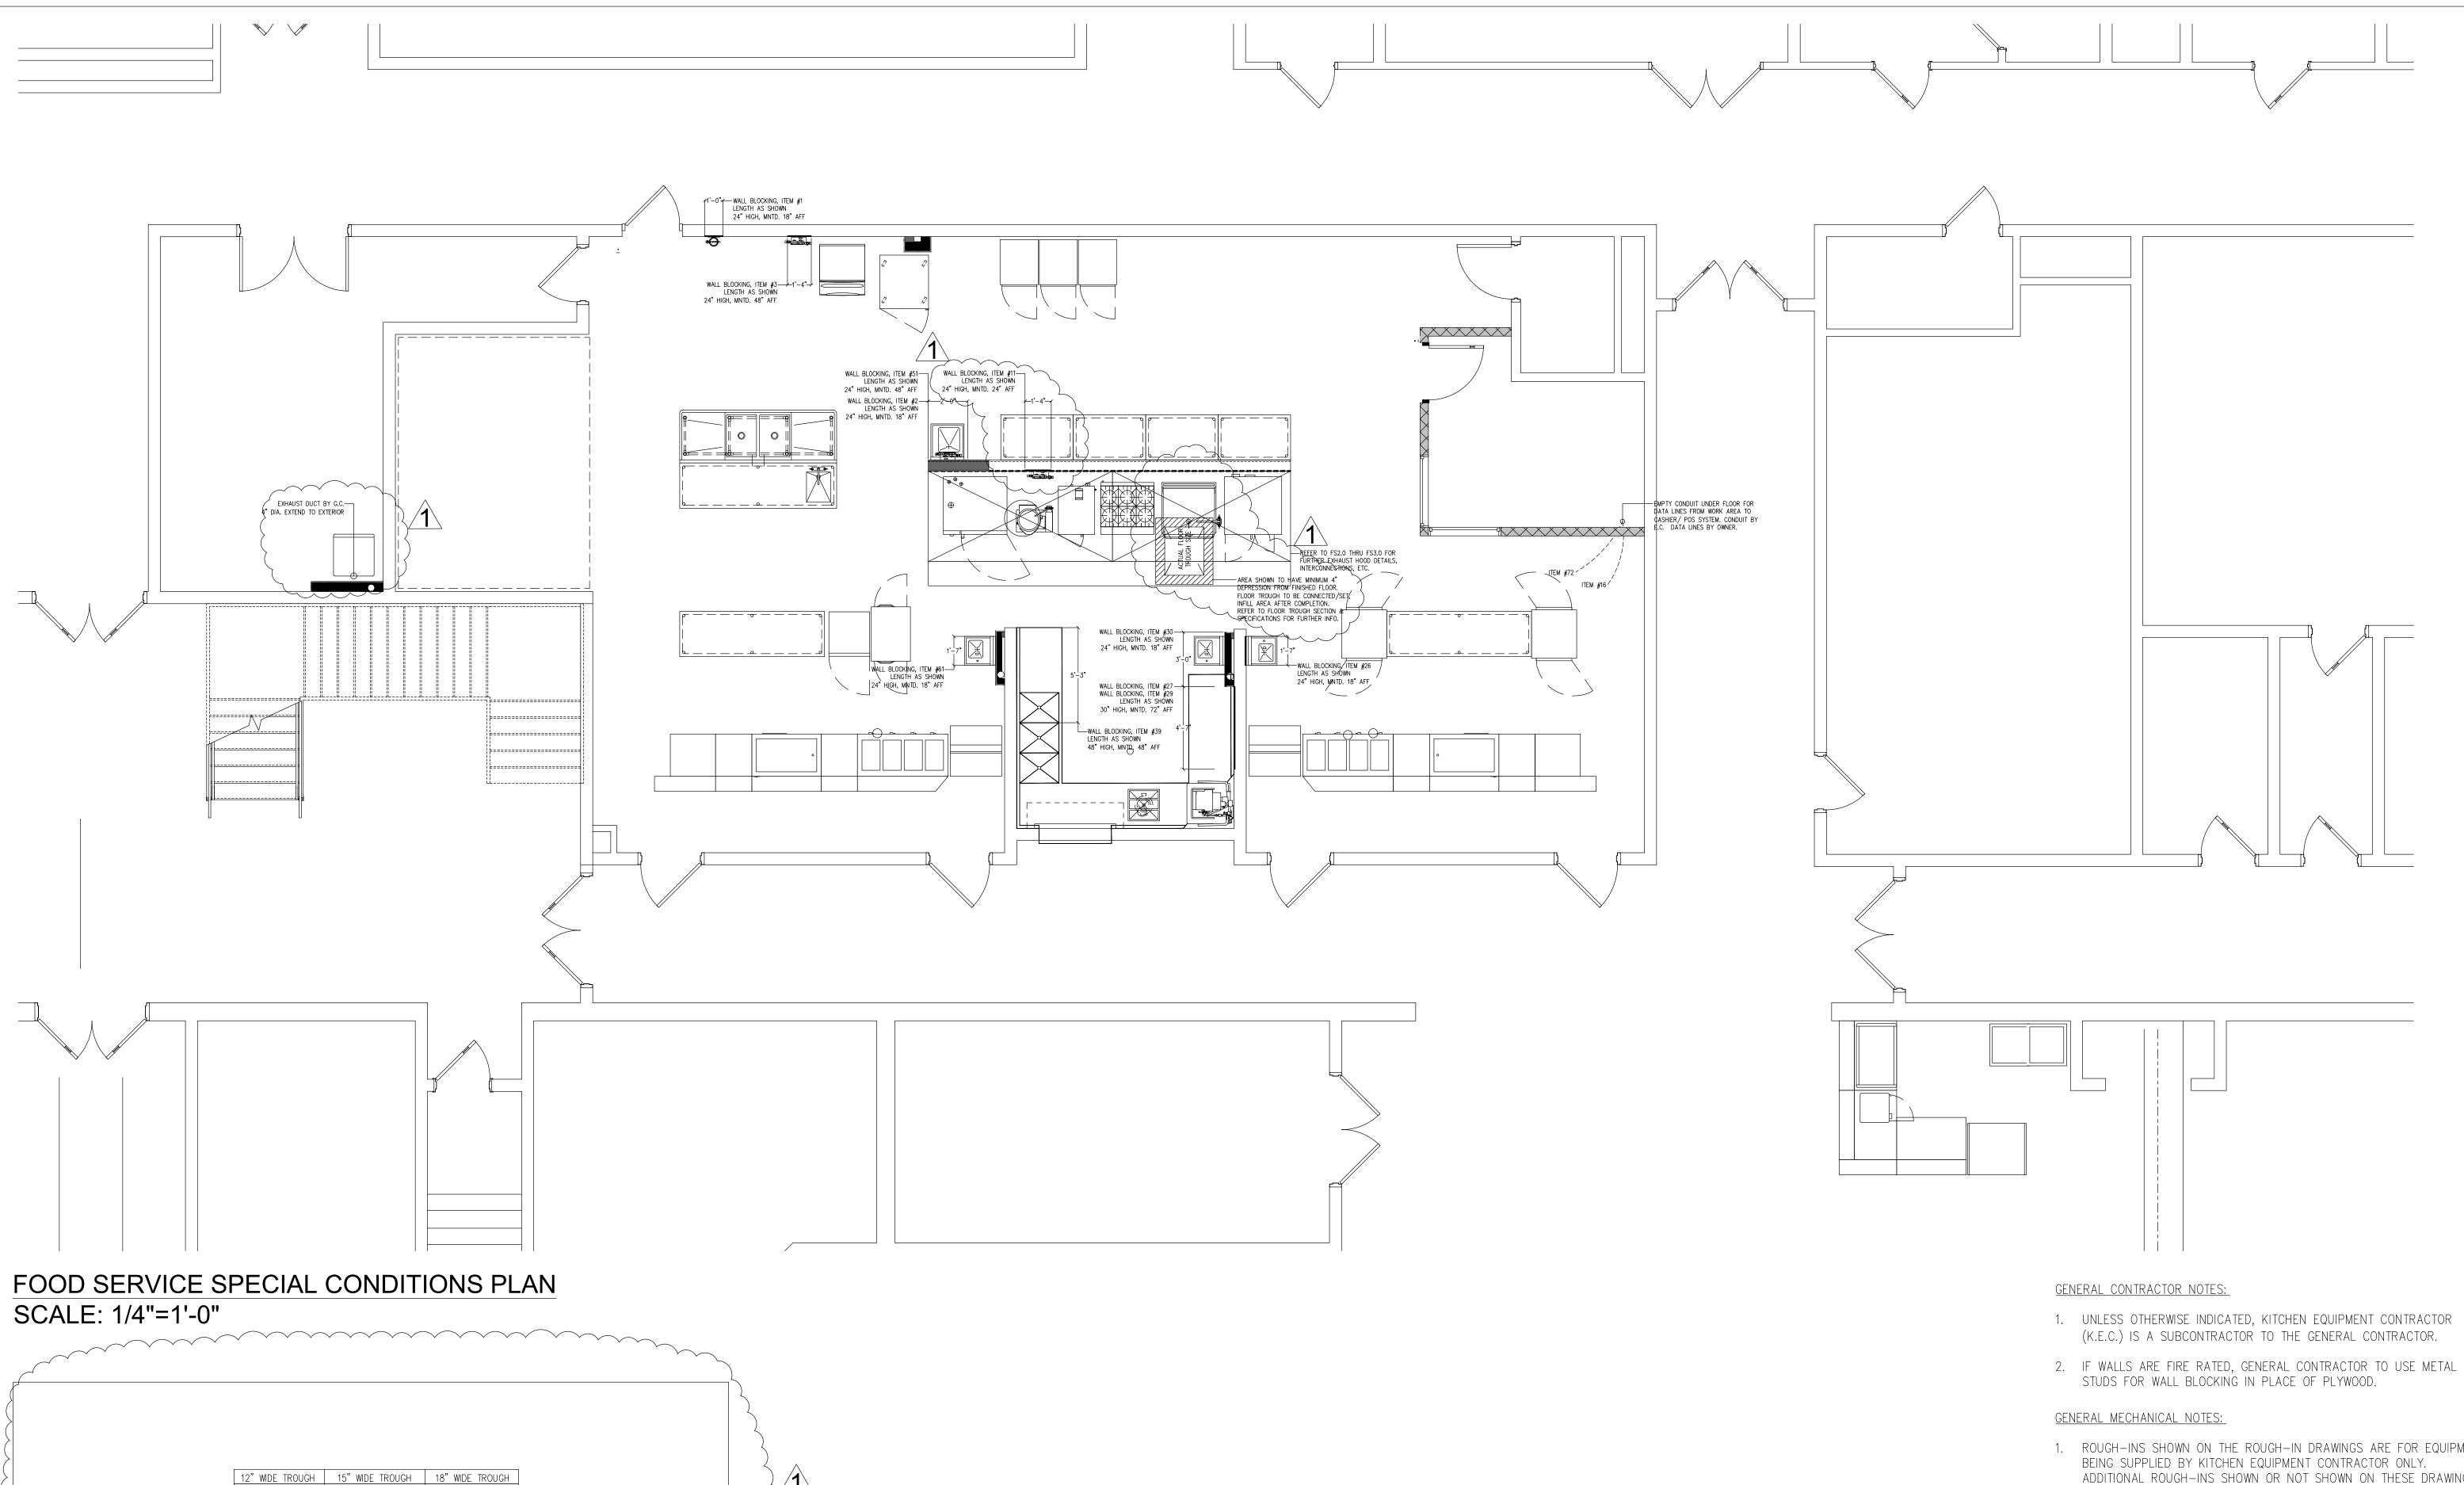
FOOD SERVICE
PLUMBING
CONNECTIONS PLAN
\$ NOTES

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> DRAWING NUMBER:

> > FS7.0

DO NOT SCALE THE DRAWINGS



DIM. A= 17"

DIM. D= 7" DIM. D= 10" DIM. D= 13"

DIM. B= 18"

DIM. C= 15"

-FIBERGRATE ADA STYLE GRATING,

-G.C. TO ACCOMMODATE ADDITIONAL FILL BASED ON

FINISH FLOOR MATERIAL

PROOF MEMBRANE

EXISTING PRE-CAST

CONCRETE PLANK \_#14 GA. S.S. SLEEVE FOR

-WET CEMENT & GROUT BY

\_#14 GA. ANTI-SPLASH S.S. PAN. PITCHED TO DRAIN

G.C. SUGGEST USE OF WATER

1" X 3/4" SQUARE TOP, MICRO-MESH. REFER TO ELEVATION/ ISO DETAIL

SCALE: 1-1/2"=1'-0"

DIM. B= 12" DIM. B= 15"

DIM. C= 9" DIM. C= 12"

FLOOR TROUGH- SECTION VIEW

ANCHOR STRAPS ——

SECURE TO SLAB

(VERIFY IN FIELD)

3" I.D. MINIMUM—

4" CONCRETE TOPPING-

PERFORATED WASTE CUP

4"ø S.S. DRAIN W/ REMOVABLE-

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TYPICAL DETAIL

- 1. ROUGH-INS SHOWN ON THE ROUGH-IN DRAWINGS ARE FOR EQUIPMENT ADDITIONAL ROUGH-INS SHOWN OR NOT SHOWN ON THESE DRAWINGS FOR EQUIPMENT BEING RELOCATED, RE-USED OR SUPPLIED BY OTHERS WILL HAVE TO BE VERIFIED BY GENERAL CONTRACTOR PRIOR TO ROUGH-INS BEING INSTALLED.
- 2. THE MECHANICAL PLANS, IF APPLICABLE, ARE PREPARED AS AN ACCOMMODATION AND GUIDE ONLY, TO INDICATE MECHANICAL REQUIREMENTS NECESSARY TO OPERATE THE EQUIPMENT. DEVIATIONS FROM THE MECHANICAL WORK SHOWN ON THESE PLANS AND EXECUTION OF SUCH WORK IS WITHOUT RESPONSIBILITY OF RAYMOND/ RAYMOND ASSOCIATES. DATA ON THIS SHEET IS TO BE REVIEWED BY OWNER AND/OR ARCHITECT AND IS TO BE INCORPORATED INTO THE BUILDING MECHANICAL PLANS IN ACCORDANCE WITH LOCAL CODES AT THE SITE.
- 3. OWNER AND/OR ARCHITECT IS TO SUBMIT THIS PLAN SET TO LOCAL HEALTH DEPARTMENT FOR APPROVAL UNLESS OTHERWISE SPECIFIED.
- 4. ALL EQUIPMENT DESIGNED AND SPECIFIED, PER THIS SET OF PLANS, BY RAYMOND / RAYMOND ASSOCIATES, HAS THE UNDERWRITERS' LABORATORIES AND NATIONAL SANITATION FOUNDATION SEALS OF APPROVAL. AND IS TO BE FURNISHED AS SUCH BY THE KITCHEN EQUIPMENT CONTRACTOR.
- 5. KITCHEN EQUIPMENT CONTRACTOR TO SET IN PLACE, EQUIPMENT AT THE SITE IN ACCORDANCE WITH THESE PLANS AND TERMS OF CONTRACT WITH OWNER.
- 6. ALL PLUMBING, ELECTRICAL AND VENTILATION WORK, INCLUDING "ROUGH-INS, INTERCONNECTIONS BETWEEN COUNTERS, CONTROLS, SWITCHES, ETC..." AND "FINAL CONNECTIONS" TO THE EQUIPMENT, IS TO BE PERFORMED BY APPROPRIATE TRADES. IT IS NOT PART OF THE KITCHEN EQUIPMENT CONTRACTORS SCOPE OF WORK UNLESS OTHERWISE SPECIFIED.
- 7. TO EXPEDITE AND INSURE PROPER INSTALLATION OF COOKING EQUIPMENT, IT IS RECOMMENDED THAT "ALL FINAL CONNECTIONS" ARE TO BE PERFORMED BY APPROPRIATE TRADES AT THE SAME TIME THE KITCHEN EQUIPMENT CONTRACTOR IS SETTING THE EQUIPMENT IN PLACE.

CERTIFICATE:



SPIEZLE ARCHITECTURAL GROUP INC. I 395 YARDVILLE HAMILTON SQUARE ROAD SUITE 2A HAMILTON, NJ 08691 Phone: 609-695-7400

THOMAS S. PERRINO SCOTT E. DOWNIE	21A101505400 21A101674400
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CONSULTANTS:

BID SET 09-24-20

KITCHEN AND OFFICE RENOVATIONS AT BRIGANTINE CONSOLIDATED

SCHOOL 301 EAST EVANS BLVD. BRIGANTINE, NJ 08203

BRIGANTINE BOARD OF EDUCATION

FOR

301 EAST EVANS BLVD., BRIGANTINE, NJ 08203

FOR CODE REVIEW:		DD/MM/YYYY
REVI:	SIONS:	
<b>#</b>	REVISION NAME	DATE
1	ADDENDUM #1	10/05/20

FOR BID: 09/24/20

DRAWING TITLE:

FOOD SERVICE SPECIAL CONDITIONS PLAN & NOTES

COMMISSION NUMBER: 20K009

AGENCY NUMBER: 01-0570-300-20-2000 01-0570-300-21-1000 DO NOT SCALE THE DRAWINGS

DRAWING NUMBER:

FS8.0