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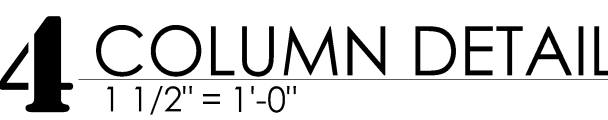
ACIA TENANT
IMPROVEMENTS

600 AVIATION RESEARCH
BLVD.
EGG HARBOR TWP, NJ 0823


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Scale	As indicated
Drawn by	MD
Date	9.23.2

Commission no. 22041



DOOR SCHEDULE								
NUMBER	WIDTH	HEIGHT	DOOR MATERIAL	DOOR TYPE	FRAME MATERIAL	RATING	HARDWARE	NOTES
101	3'-0"	7'-11"	GL	A	AL	-	1	
102	3'-0"	7'-0"	WD	B	HM	-	2	
103	3'-0"	7'-0"	WD	B	HM	-	2	
104	3'-0"	7'-11"	GL	A	AL	-	1	REUSE EX'G CARD READER

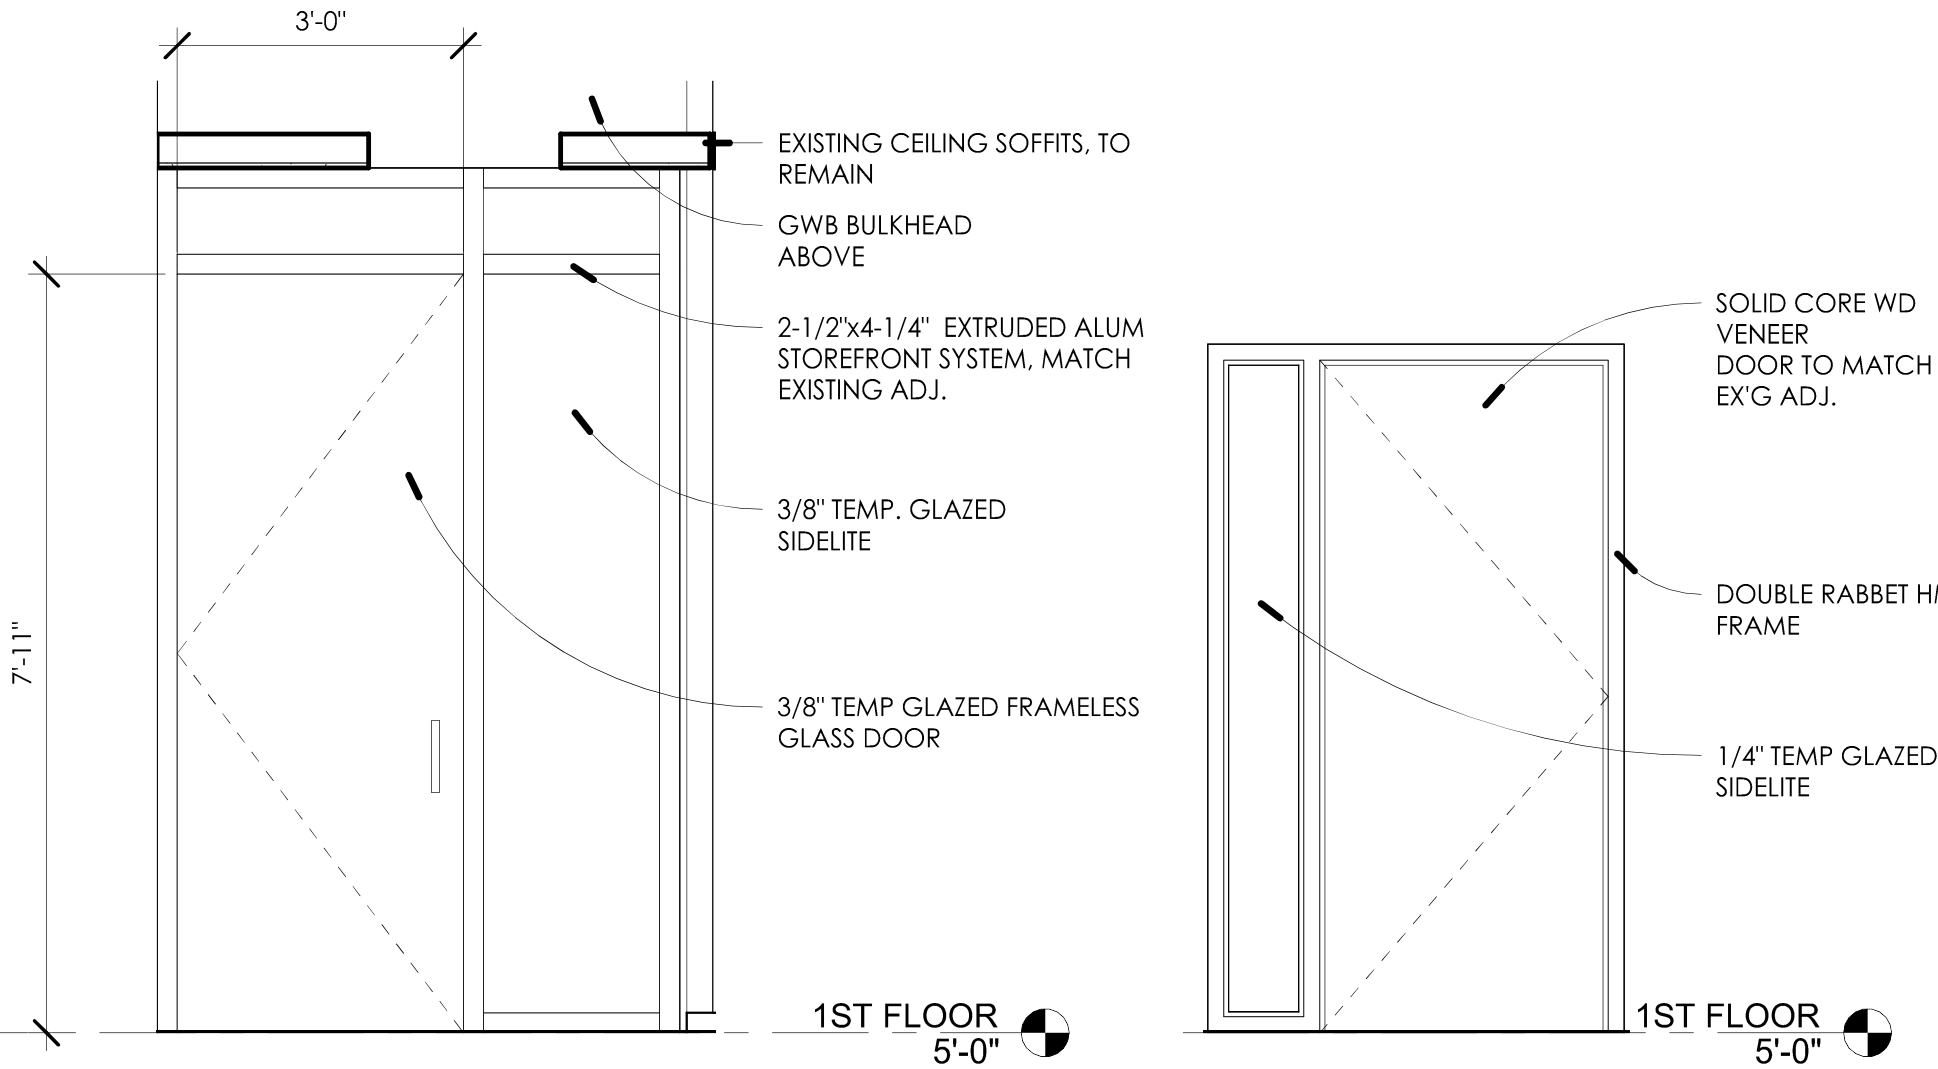


5 DOOR TYPES

HARDWARE SCHEDULE

TYPE 1 - ENTRY
LOCKSET: ASSA ABLOY M32 SERIES MAGNA-LOCK WITH HID
GLOBAL WALL MOUNT RFID CARD READER ACTUATOR
CLOSER: LCN 2030 HEAD MOUNTED CONCEALED CLOSER
HINGES: CENTER SET TOP AND BOTTOM PIVOTS
PUSH/PULL: KAWNEER STANDARD
STOP: IVES CONCAVE WALL MOUNTED
SEALS: PEMKO S773/544 W/ACP112 CORNER PADS
DOOR BOTTOM: PEMKO STC411_PK


TYPE 2 - OFFICE
LOCKSET: SCHLAGE OFFICE FUNCTION FULL MORTISE LOCKSET
WITH ADA COMPLIANT LEVER HANDLE TO MATCH EXISTING
ADJACENT US26D
CLOSER: NONE
HINGES: STANLEY 5 KNUCKLE BALL BEARING HINGES, (2) PAIR
US26D
STOP: IVES CONCAVE WALL MOUNTED
SEALS: PEMKO S773/544 W/ACP112 CORNER PADS
DOOR BOTTOM: PEMKO STC411_PK

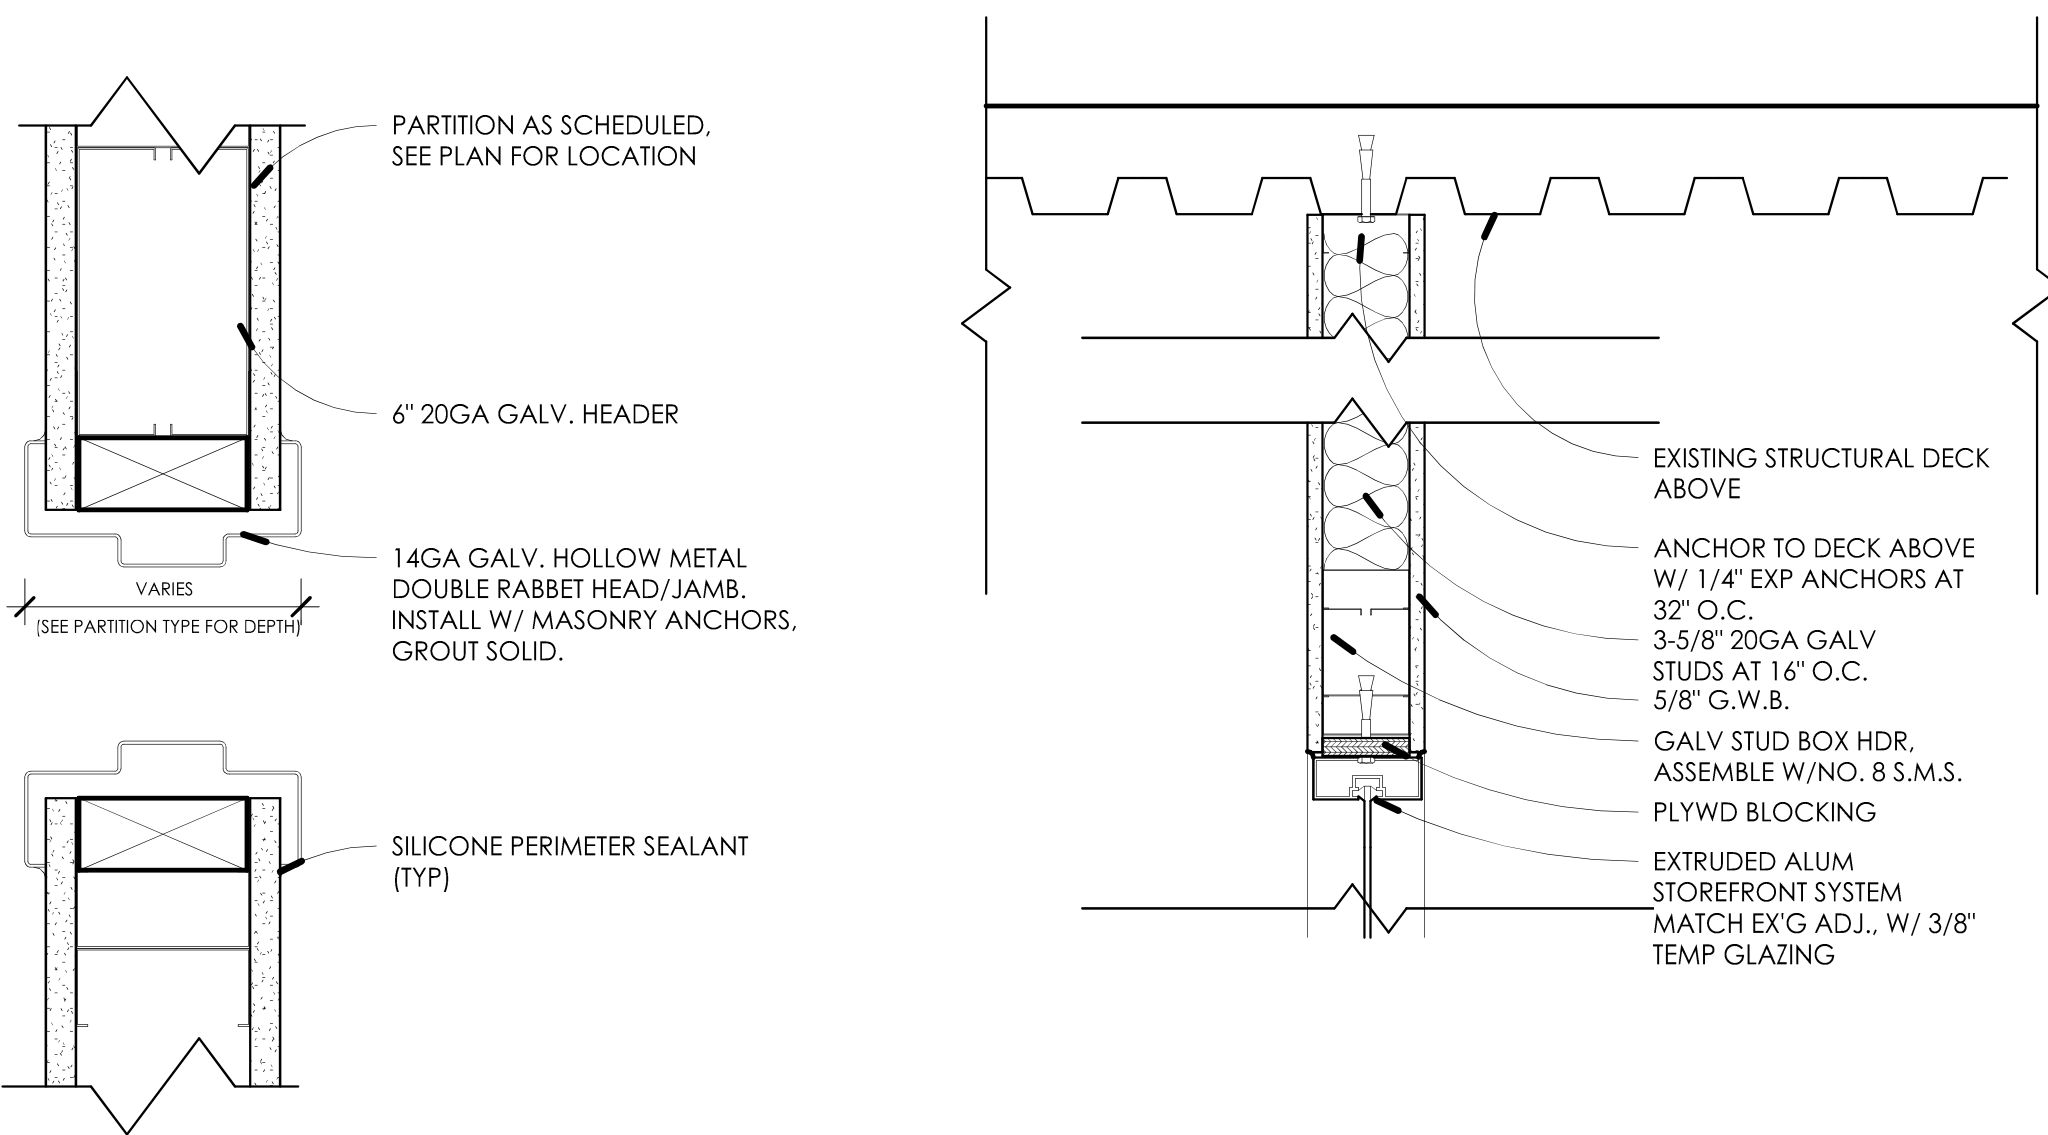


4 DOOR HEAD JAMB DETAIL

3 BULKHEAD DETAIL


REFLECTED CEILING LEGEND

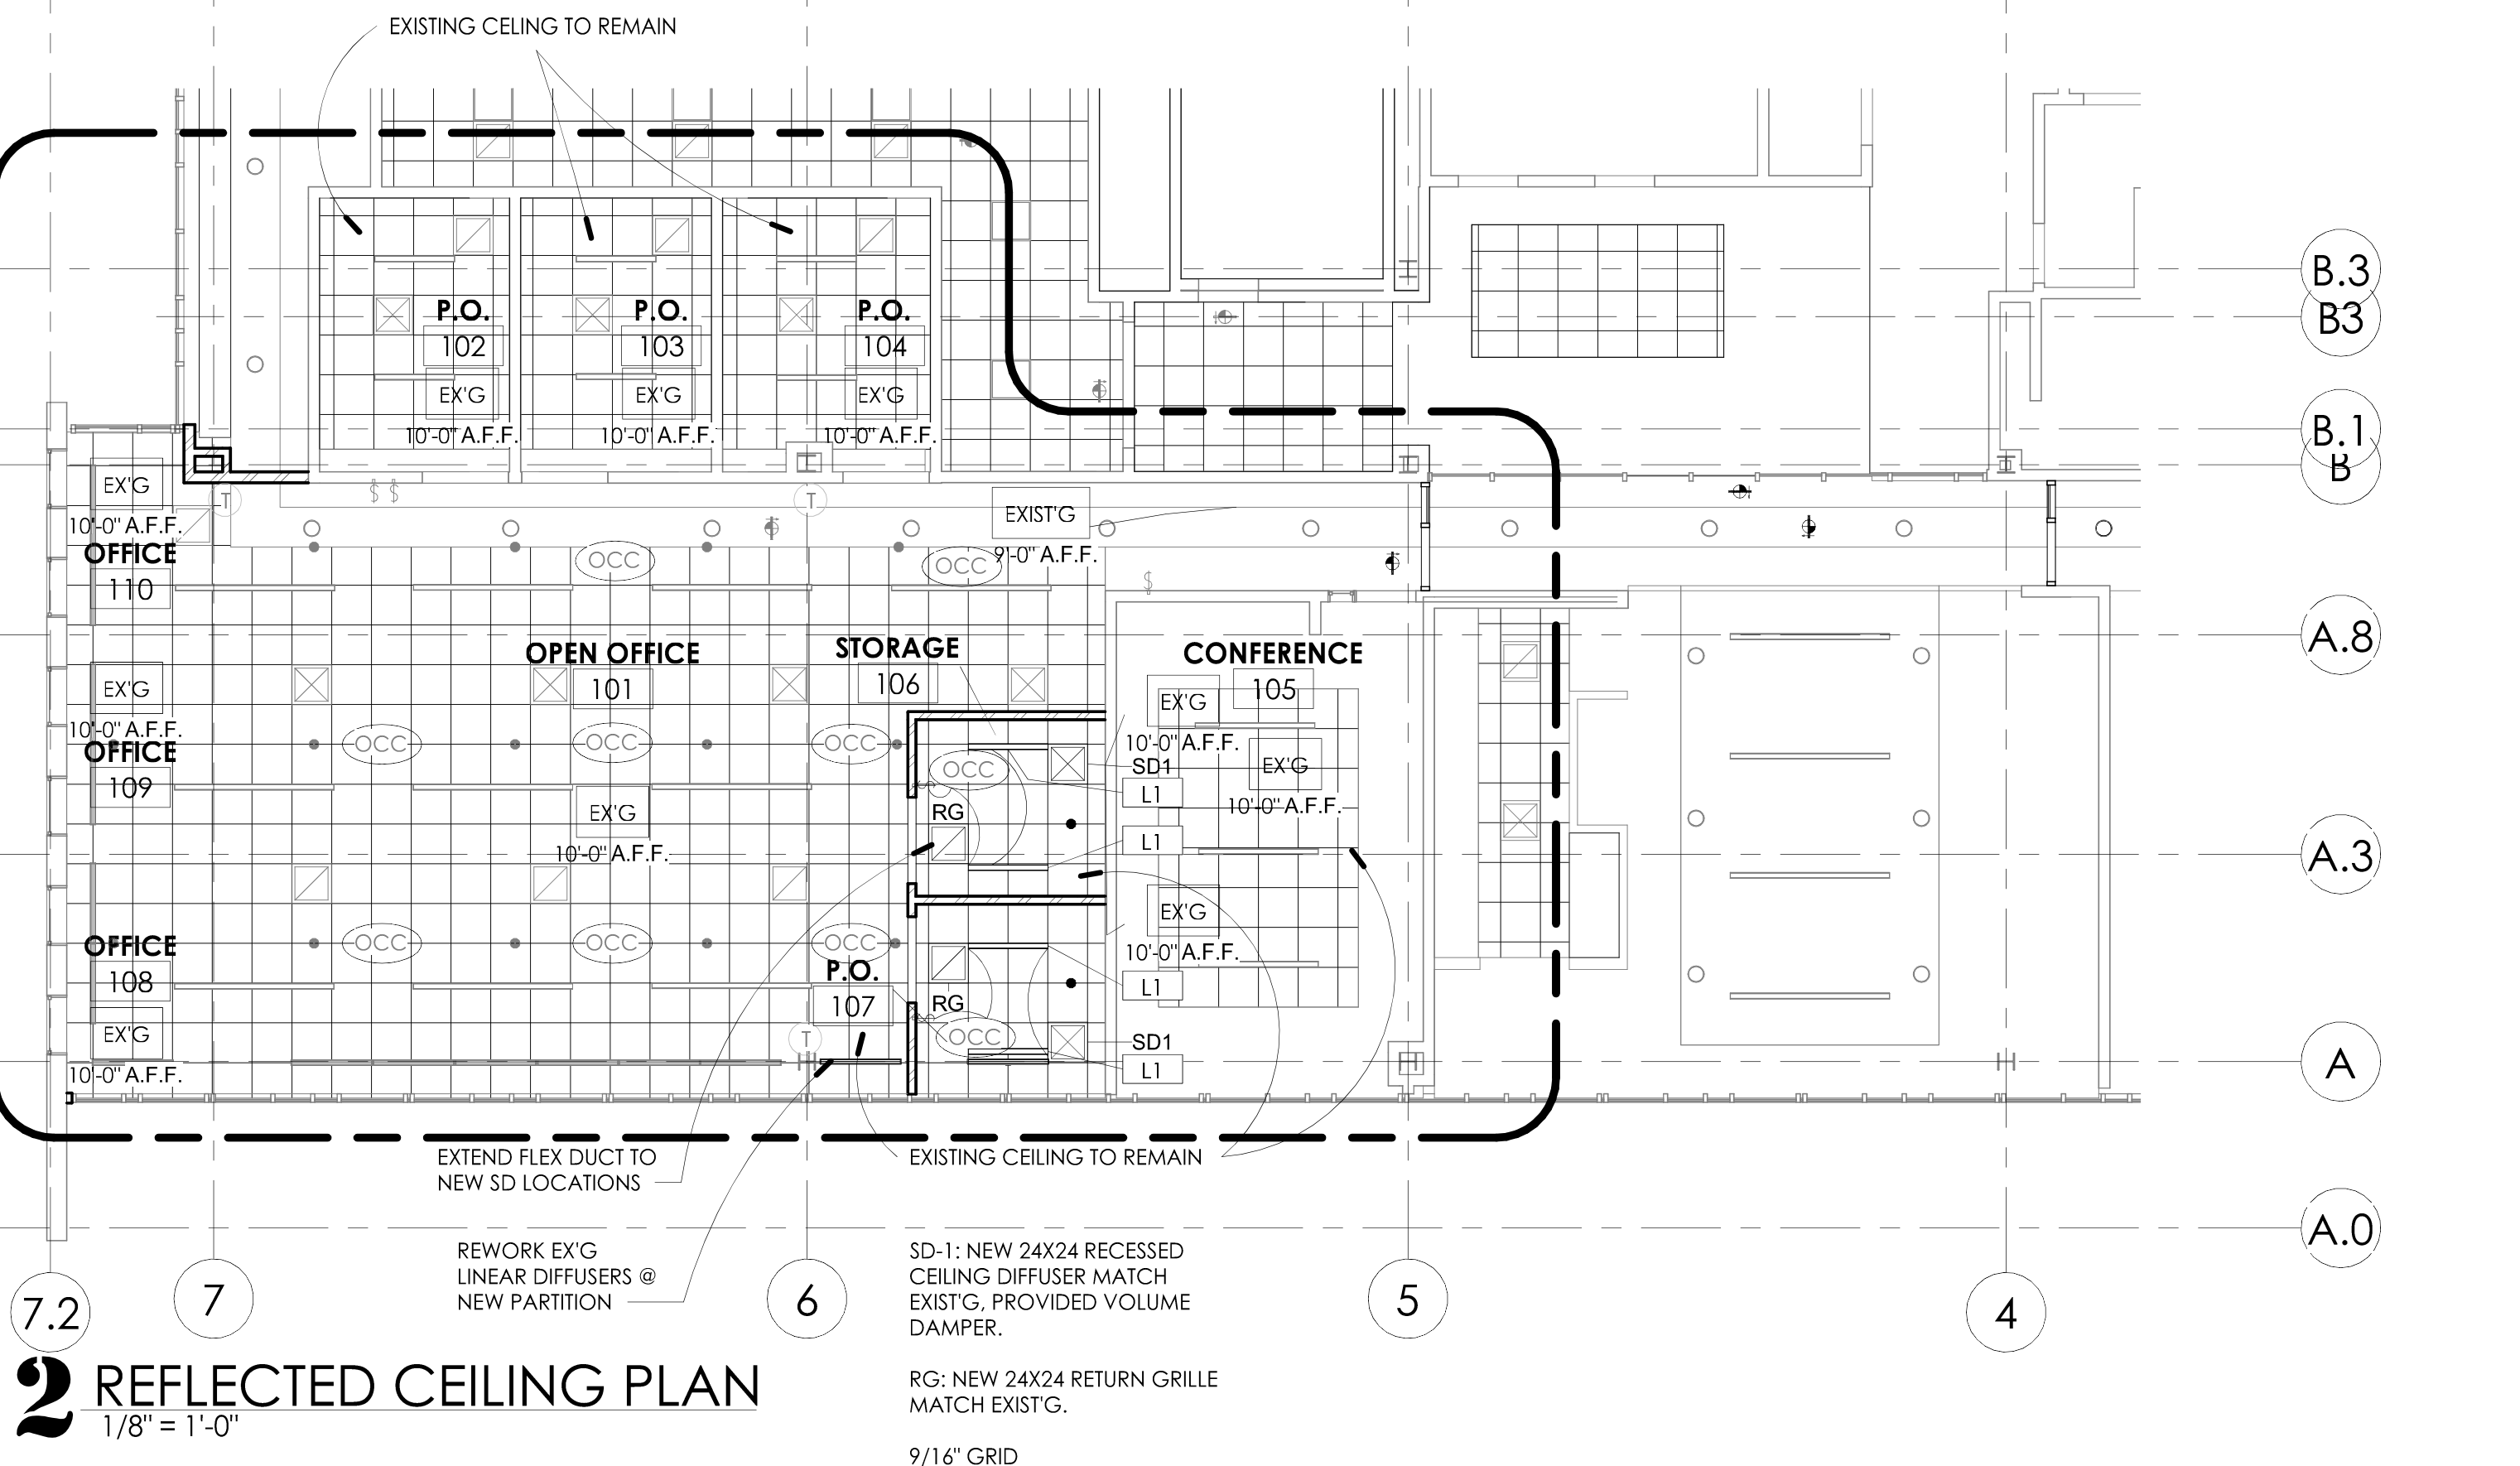

2 REFLECTED CEILING PLAN

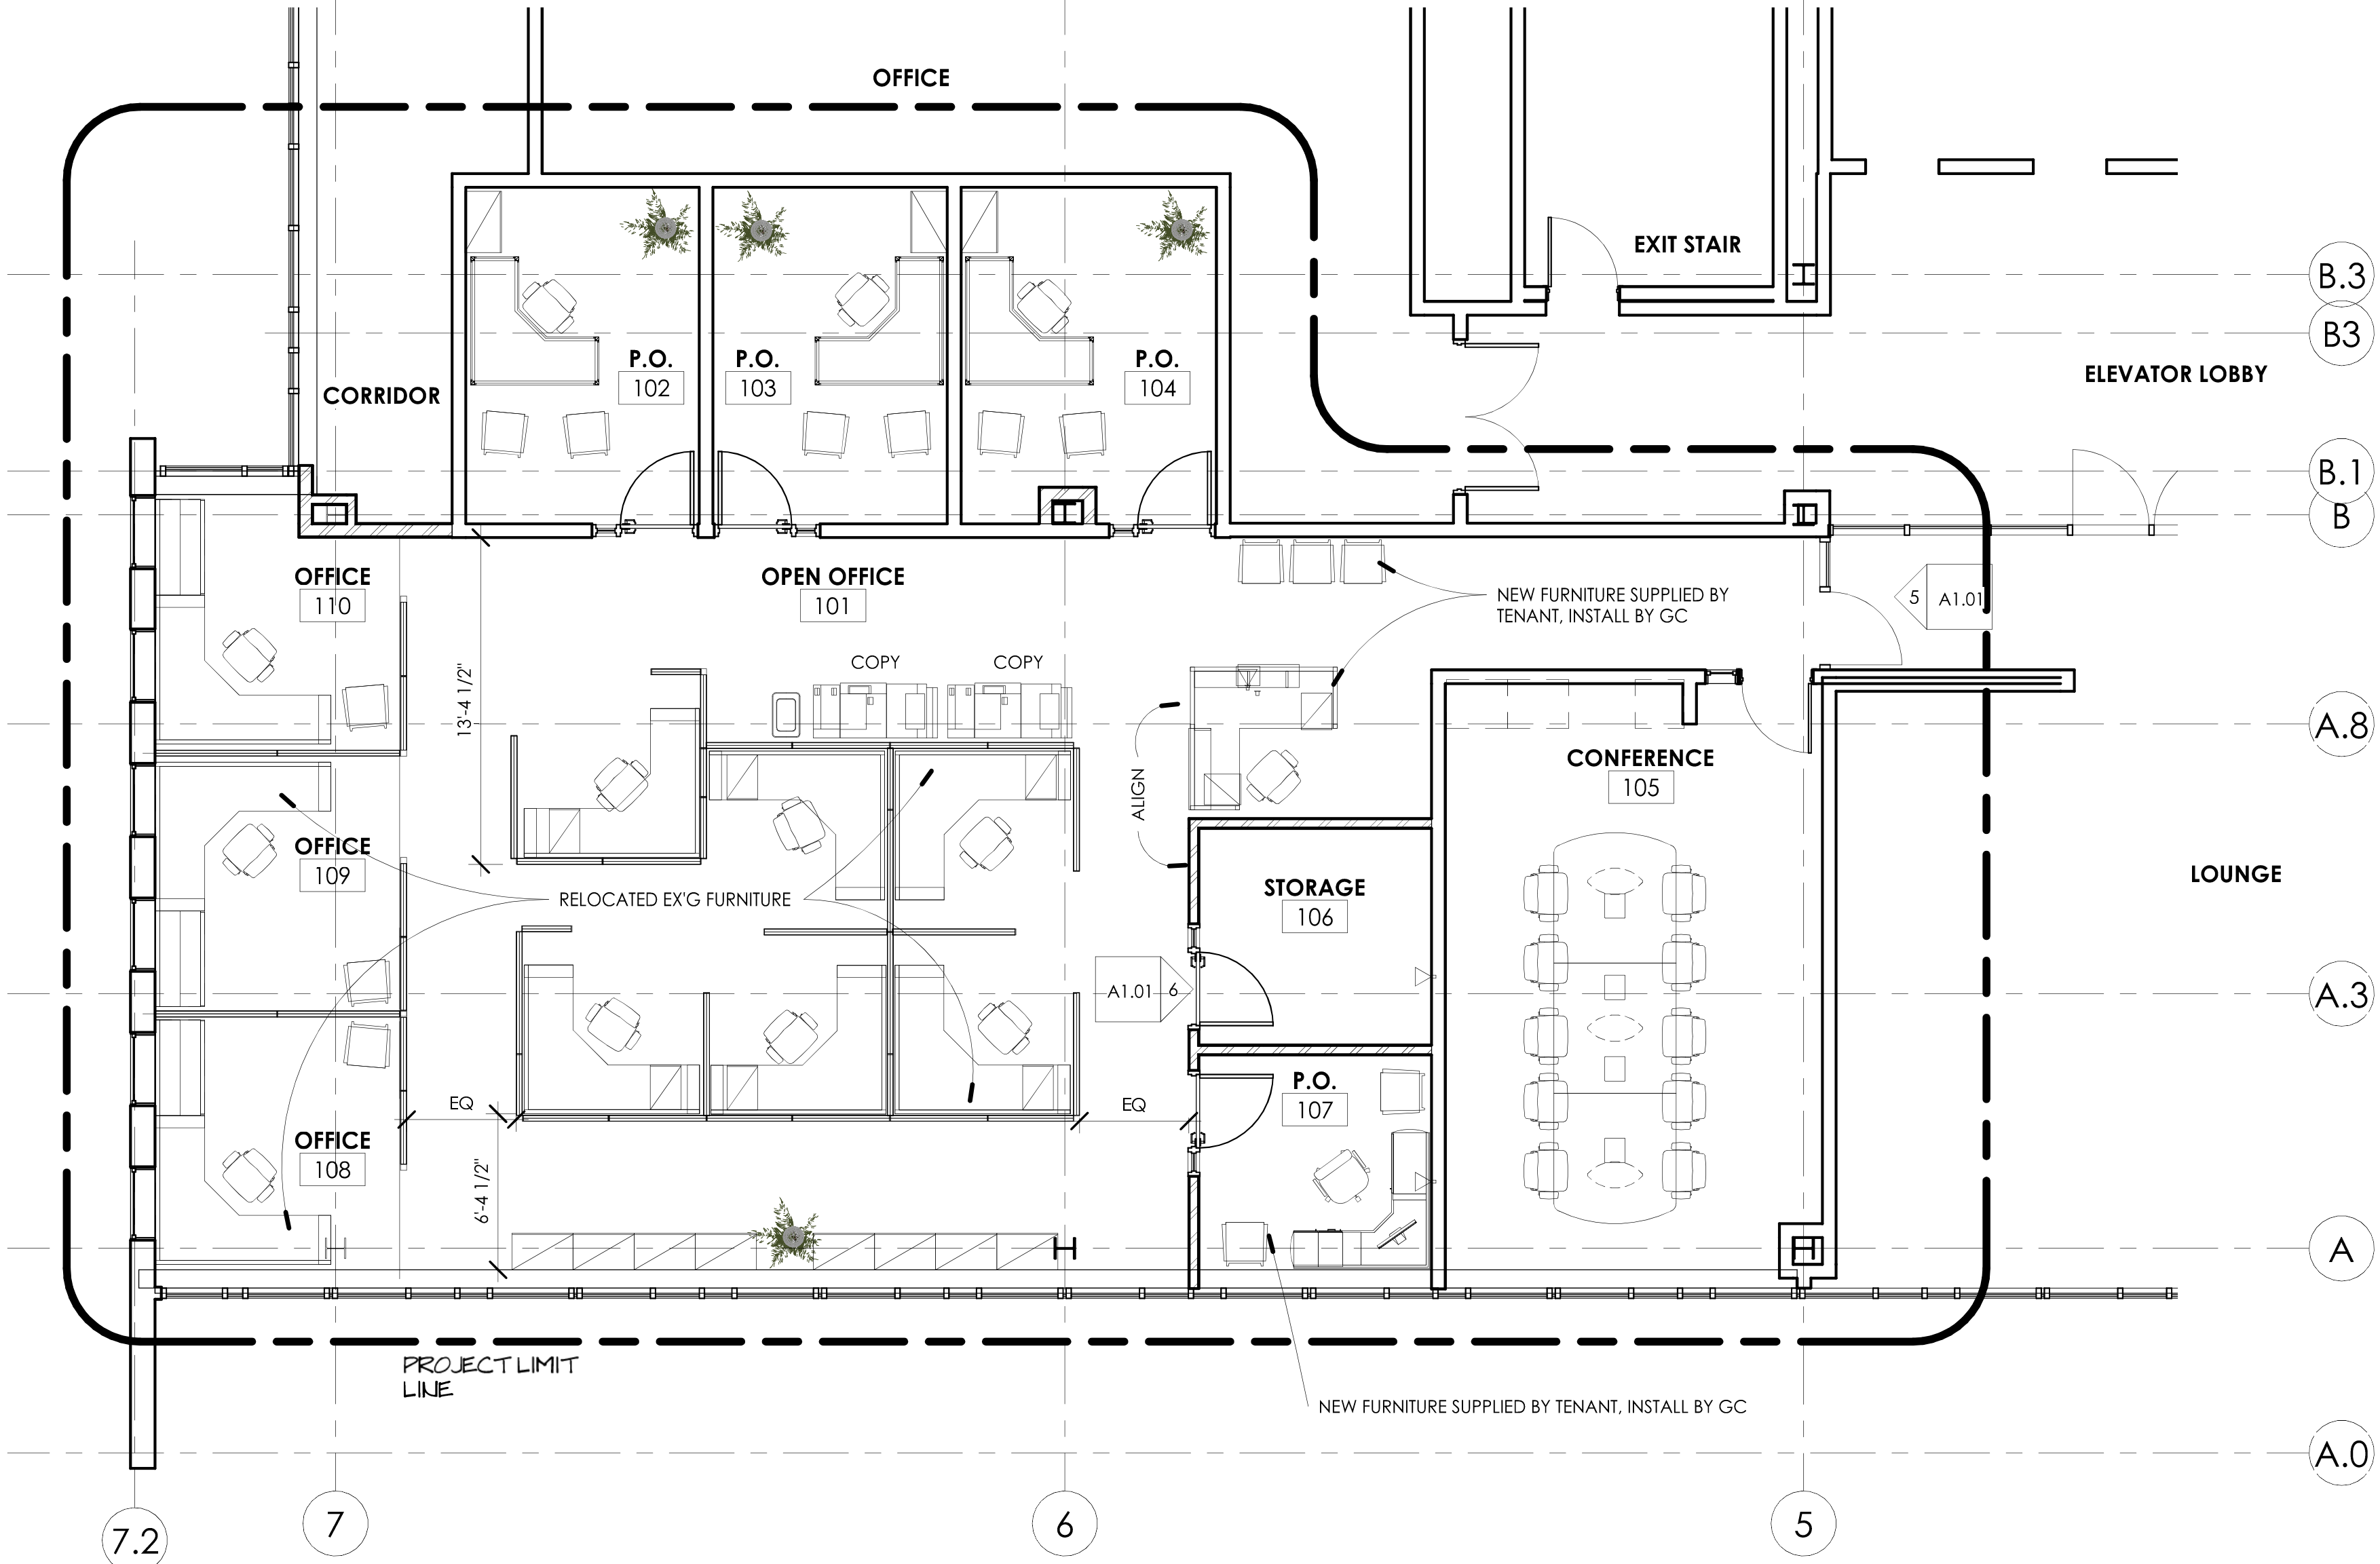

1 FF&E FLOOR PLAN

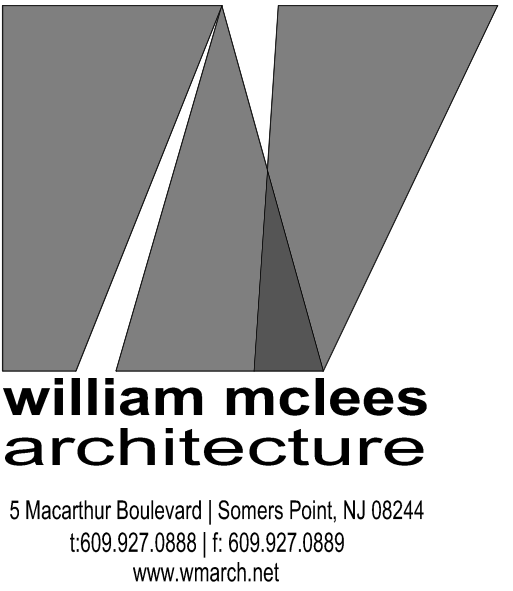

William C. McLees AIA, LEED AP

New Jersey State License
Pennsylvania State License

AI 14054
RA403479

William McLees Architecture, LLC
New Jersey State Certificate of Authorization #
21AC00055500

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ACIA TENANT
IMPROVEMENTS
600 AVIATION RESEARCH
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EGG HARBOR TWP, NJ 08234

NOT FOR CONSTRUCTION

No.	Description	Date

FF&E FLOOR PLAN

Scale As indicated
Drawn by MC
Date 9.23.22

A1.01

Comission no. 22041A

William C. McLees
AIA, LEED AP

New Jersey State License
Pennsylvania State License

AI 14054
RA403479

William McLees Architecture, LLC

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21AC00055500

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600 AVIATION RESEARCH
BLVD.
EGG HARBOR TWP, NJ 08234

NOT FOR CONSTRUCTION

No.	Description	Date

ELECTRICAL POWER PLAN

Scale As indicated
Drawn by MC
Date 9.23.22

E1.00

Comision no. 22041A

ELECTRICAL NOTES

GENERAL

1. ALL ELECTRICAL WORK TO BE INSTALLED IN ACCORDANCE WITH THE 2017 EDITION OF THE NATIONAL ELECTRICAL CODE, ADOPTED BY THE UNIFORM CONSTRUCTION CODE - STATE OF NEW JERSEY AND ANY OTHER PARTY HAVING JURISDICTION.

2. ALL ELECTRICAL MATERIALS AND EQUIPMENT FOR THE PROJECT SHALL BE NEW AND APPROVED BY UNDERWRITERS LABORATORY (U.L.) OR ANY OTHER NATIONALLY RECOGNIZED TESTING AGENCY UNLESS NOTED OTHERWISE ON DRAWINGS.

3. ALL NECESSARY PERMITS, INSPECTIONS, AND LICENSES SHALL BE PROCURED AND ALL FEES PAID BY THE CONTRACTOR. SUBMIT TO THE OWNER DUPLICATE CERTIFICATES OF INSPECTION FROM THE APPROVED INSPECTION AGENCY.

4. UPON COMPLETION OF THE WORK, THE ENTIRE WIRING SYSTEM SHALL BE FREE FROM GROUNDS, SHORT CIRCUITS, OPEN, OVERLOADS AND IMPROPER VOLTAGES.

5. PRIOR TO FINAL ACCEPTANCE OF THE WORK, A WRITTEN STATEMENT SHALL BE SUBMITTED TO THE OWNER GUARANTEEING ALL EQUIPMENT AND SYSTEMS AGAINST DEFECTIVE MATERIAL AND WORKMANSHIP FOR ONE (1) YEAR FROM THE DATE OF ACCEPTANCE. UPON NOTICE ALL DEFECTIVE EQUIPMENT, MATERIALS AND SYSTEMS SHALL BE PROMPTLY REPAIRED AT NO EXPENSE TO THE OWNER.

6. THIS SET OF DRAWINGS IS DIAGRAMMATIC IN NATURE AND INDICATES THE GENERAL ARRANGEMENT OF THE VARIOUS SYSTEMS AND APPROXIMATE LOCATIONS OF THE EQUIPMENT. IT SHALL BE THE RESPONSIBILITY OF THE CONTRACTOR TO DETERMINE THAT THERE IS ADEQUATE SPACE AT THE LOCATIONS INDICATED FOR ALL EQUIPMENT PRIOR TO INSTALLATION OF SAME. THE CONTRACTOR SHALL BE RESPONSIBLE TO VERIFY ALL DIMENSIONS IN THE FIELD, PRIOR TO THE COMMENCEMENT OF CONSTRUCTION.

7. ELECTRICAL CONTRACTOR SHALL SECURE SHOP DRAWINGS FROM OTHER CONTRACTORS AND VERIFY EXACT ELECTRICAL CHARACTERISTICS OF EQUIPMENT TO BE WIRED PRIOR TO ROUGH-IN. IF DISCREPANCIES ARE NOTED BETWEEN THE ELECTRICAL CONTRACT DRAWINGS AND OTHER CONTRACTOR SHOP DRAWINGS, ELECTRICAL CONTRACTOR IS TO NOTIFY ENGINEER AT ONCE. FAILURE TO PERFORM THIS DUTY WILL NOT RELIEVE THE ELECTRICAL CONTRACTOR OF THE RESPONSIBILITY TO CORRECT WIRING DEFICIENCIES AT NO EXPENSE TO THE OWNER.

8. ALL DEVICES OR EQUIPMENT SHOWN IN SYMBOL FORM SHALL BE WIRED TO ITS RESPECTIVE PANEL.

9. THE GENERAL CONTRACTOR SHALL PROVIDE AND INSTALL AN ARC FLASH WARNING PLACARD THAT SHALL BE LOCATED SO AS TO BE CLEARLY VISIBLE TO QUALIFIED PERSONS BEFORE EXAMINATION, ADJUSTMENT, SERVICING, OR MAINTENANCE OF SWITCHBOARDS, PANELBOARDS, INDUSTRIAL CONTROL PANELS, AND MOTOR CONTROL CENTERS IN ACCORDANCE WITH ARTICLE 110.14 OF THE 2017 NEC.

10. ALL INTERIOR WIRING SHALL BE INSTALLED IN ELECTRICAL NONMETALLIC TUBING OR NONMETALLIC CABLE AND CONCEALED IN WALLS OR IN HUNG CEILING SPACE. ENT SHALL CONFORM TO ARTICLE 362 AND NM CABLE SHALL CONFORM TO ARTICLE 334 OF THE 2017 EDITION OF THE NATIONAL ELECTRICAL CODE. WHERE WIRING CANNOT BE CONCEALED IN FINISHED AREAS, IT SHALL BE RUN EXPOSED IN A NEAT MANNER VIA SURFACE RACEWAY. MINIMUM CONDUIT SIZE SHALL BE 3/4" UNLESS NOTED OTHERWISE.

11. ALL WIRING, CONNECTIONS AND DEVICES SHALL BE PROVIDED TO COMPLY WITH THE GROUNDING REQUIREMENTS OF THE NATIONAL ELECTRICAL CODE AND THE DRAWINGS UNLESS NOTED OTHERWISE. ALL EXPOSED NON-CURRENT CARRYING ELECTRICAL EQUIPMENT METALLIC PARTS, RACEWAY SYSTEMS AND WIRING SYSTEM GROUNDING CONDUCTORS SYSTEM SHALL BE GROUNDED.

12. PROVIDE A SEPARATE, GREEN-COLORED, INSULATED EQUIPMENT GROUNDING CONDUCTOR WITHIN EACH FEEDER AND BRANCH CIRCUIT RACEWAY. THIS CONDUCTOR SHALL BE SEPARATE FROM THE ELECTRICAL SYSTEM NEUTRAL CONDUCTOR. TERMINATE EACH END OF THIS GROUNDING CONDUCTOR ON A U.L. LISTED LUG, BUS OR BUSHING. THE GROUNDING CONDUCTOR SIZE SHALL BE IN ACCORDANCE WITH NEC, TABLE 250.122.

13. ALL CUTTING AND PATCHING REQUIRED FOR THE ELECTRICAL WORK SHALL BE THE RESPONSIBILITY OF THE ELECTRICAL CONTRACTOR.

14. PANEL BOARD DIRECTORIES SHALL BE TYPED, AND UPDATED INDICATING NEW CIRCUITING AND DEVICE DESCRIPTION AS SHOWN ON DRAWINGS.

15. EXISTING EQUIPMENT FIXTURES, COMPONENTS, AND ALL OTHER RELATED APPURTENANCES WHICH ARE NO LONGER REQUIRED AS INDICATED ON DRAWINGS SHALL BE REMOVED AND BECOME PROPERTY OF THE OWNER.

16. ALL COMPONENTS OF EXISTING SYSTEMS REQUIRED TO BE MODIFIED, EXTENDED OR REUSED SHALL BE INSPECTED AND RETURNED TO A FIRST-CLASS OPERATING CONDITION. COMPONENTS SHALL BE CLEANED AND REPAINTED IF NECESSARY.

17. ALL DEMOLISHED MATERIALS SHALL BE CAREFULLY REMOVED FROM THE PREMISES BY THE MOST DIRECT PATH. ANY DAMAGE INCURRED BY THE REMOVAL PROCESS SHALL BE REPAIRED TO MATCH THE SURROUNDING WORK AND LEFT IN SATISFACTORY CONDITION. ALL AREAS SHALL BE CLEANED OF ALL DIRT AND DEBRIS RESULTING FROM DEMOLITION.

18. ALL HOLES OR VOIDS CREATED TO ROUTE CONDUIT OR METAL CLAD CABLE THROUGH FIRE RATED FLOORS AND WALLS SHALL BE SEALED WITH AN INTUMESCENT MATERIAL CAPABLE OF EXPANDING UP TO 8 TO 10 TIMES WHEN EXPOSED TO A TEMPERATURE OF 250 DEGREES FAHRENHEIT AND ABOVE. ACCEPTABLE SEALING MATERIAL, SUCH AS 3M FIRE BARRIER CAULK, PUTTY, STRIP AND SHEET FORM, SHALL HAVE I.C.B.O. AND BOCA APPROVED RATING OF 3 HOURS PER ASTM E-814 (U.L. 1479) AS PER NEC ARTICLE 300.21.

19. THE ELECTRICAL WORK RELATING TO THE PROJECT IS SHOWN. OTHER EXISTING ELECTRICAL AND SYSTEMS COMPONENTS HAVE BEEN LEFT OFF THE DRAWING OR CLARITY.

20. TWO OR THREE POLE CIRCUIT BREAKERS SHALL BE COMMON TRIP TYPE. SINGLE POLE BREAKERS WITH YOKED HANDLE WILL NOT BE PERMITTED.

21. THE ELECTRICAL CONTRACTOR SHALL NOT UTILIZE A "COMMON NEUTRAL" ON MULTIPLE BRANCH CIRCUITS. EACH SUCH CIRCUIT SHALL BE RUN WITH ITS OWN DEDICATED NEUTRAL WIRE.

22. WHERE CONDUIT RUNS CROSS STRUCTURAL EXPANSION JOINTS, LIQUID-TIGHT FLEXIBLE METAL CONDUIT SHALL BE USED TO TRANSITIONAL CONDUIT SYSTEM FROM ONE STRUCTURAL SECTION TO THE OTHER.

23. THERMAL OVERLOAD PROTECTION SHALL BE IN COMPLIANCE WITH MOTOR MANUFACTURER'S SPECIFICATIONS.

24. WHERE CIRCUIT BREAKERS OR FUSES ARE APPLIED IN COMPLIANCE WITH THE SERIES COMBINATION RATINGS MARKED ON THE EQUIPMENT BY THE MANUFACTURER, THE EQUIPMENT ENCLOSURES SHALL BE LEGIBLY MARKED IN THE FIELD TO INDICATE THE EQUIPMENT HAS BEEN APPLIED WITH A SERIES COMBINATION DEVICE RATING. THE MARKING SHALL BE READILY VISIBLE AND CONFORM TO ARTICLE 110.22 OF THE 2017 EDITION OF THE NATIONAL ELECTRICAL CODE.

25. PROVIDE NECESSARY COMMON GROUNDS BETWEEN THE ELECTRICAL SERVICE, TELEPHONE SERVICE, UNDERGROUND METALLIC PIPING, CONDUIT, AND FOUNDATION/FOOTING REBAR PER NEC ARTICLES 250.50 & 250.52.

26. CONTRACTOR TO PROVIDE RECEPTACLES TO MATCH PLUGS FURNISHED WITH EQUIPMENT.

27. ALL LIGHTING AND POWER PANELS SHALL HAVE THEIR TOPS AT 6'-6" ABOVE FINISHED FLOOR.


28. PANEL BOARDS SHALL BE DEAD-FRONT, SAFETY-TYPE AND SHALL CONTAIN MAIN LUG RATINGS, BRANCH CIRCUIT BREAKERS, SPACES AND BUSES AS INDICATED ON THE DRAWINGS.

29. PANEL BOARDS SHALL BE SUITABLE FOR FLUSH MOUNTING OR SURFACE MOUNTED INSTALLATION AS REQUIRED.

30. ELECTRICAL CONTRACTOR SHALL LOCATE LIGHTING FIXTURES TO SUIT STRUCTURAL AND ARCHITECTURAL CONDITIONS IN THOSE ROOMS WHERE BEAMS, DROPPED SOFFITS, ACCESS PANELS OR SIMILAR OBSTRUCTIONS REQUIRE A CHANGE IN LIGHTING FIXTURE LAYOUT.

31. ELECTRICAL CONTRACTOR SHALL COORDINATE PLACEMENT OF ALL ELECTRICAL DEVICES WITH MILLWORK, CONSTRUCTOR AND ARCHITECT PRIOR TO ROUGH-IN.

32. ALL LIGHTING CIRCUITS SHALL BE EQUIPPED WITH A DEVICE FOR DIMMING CONTROL. THE ELECTRICAL CONTRACTOR SHALL COORDINATE WITH THE OWNER, THE ARCHITECT, AND THE LIGHTING MANUFACTURER THE MEANS OF DIMMING.

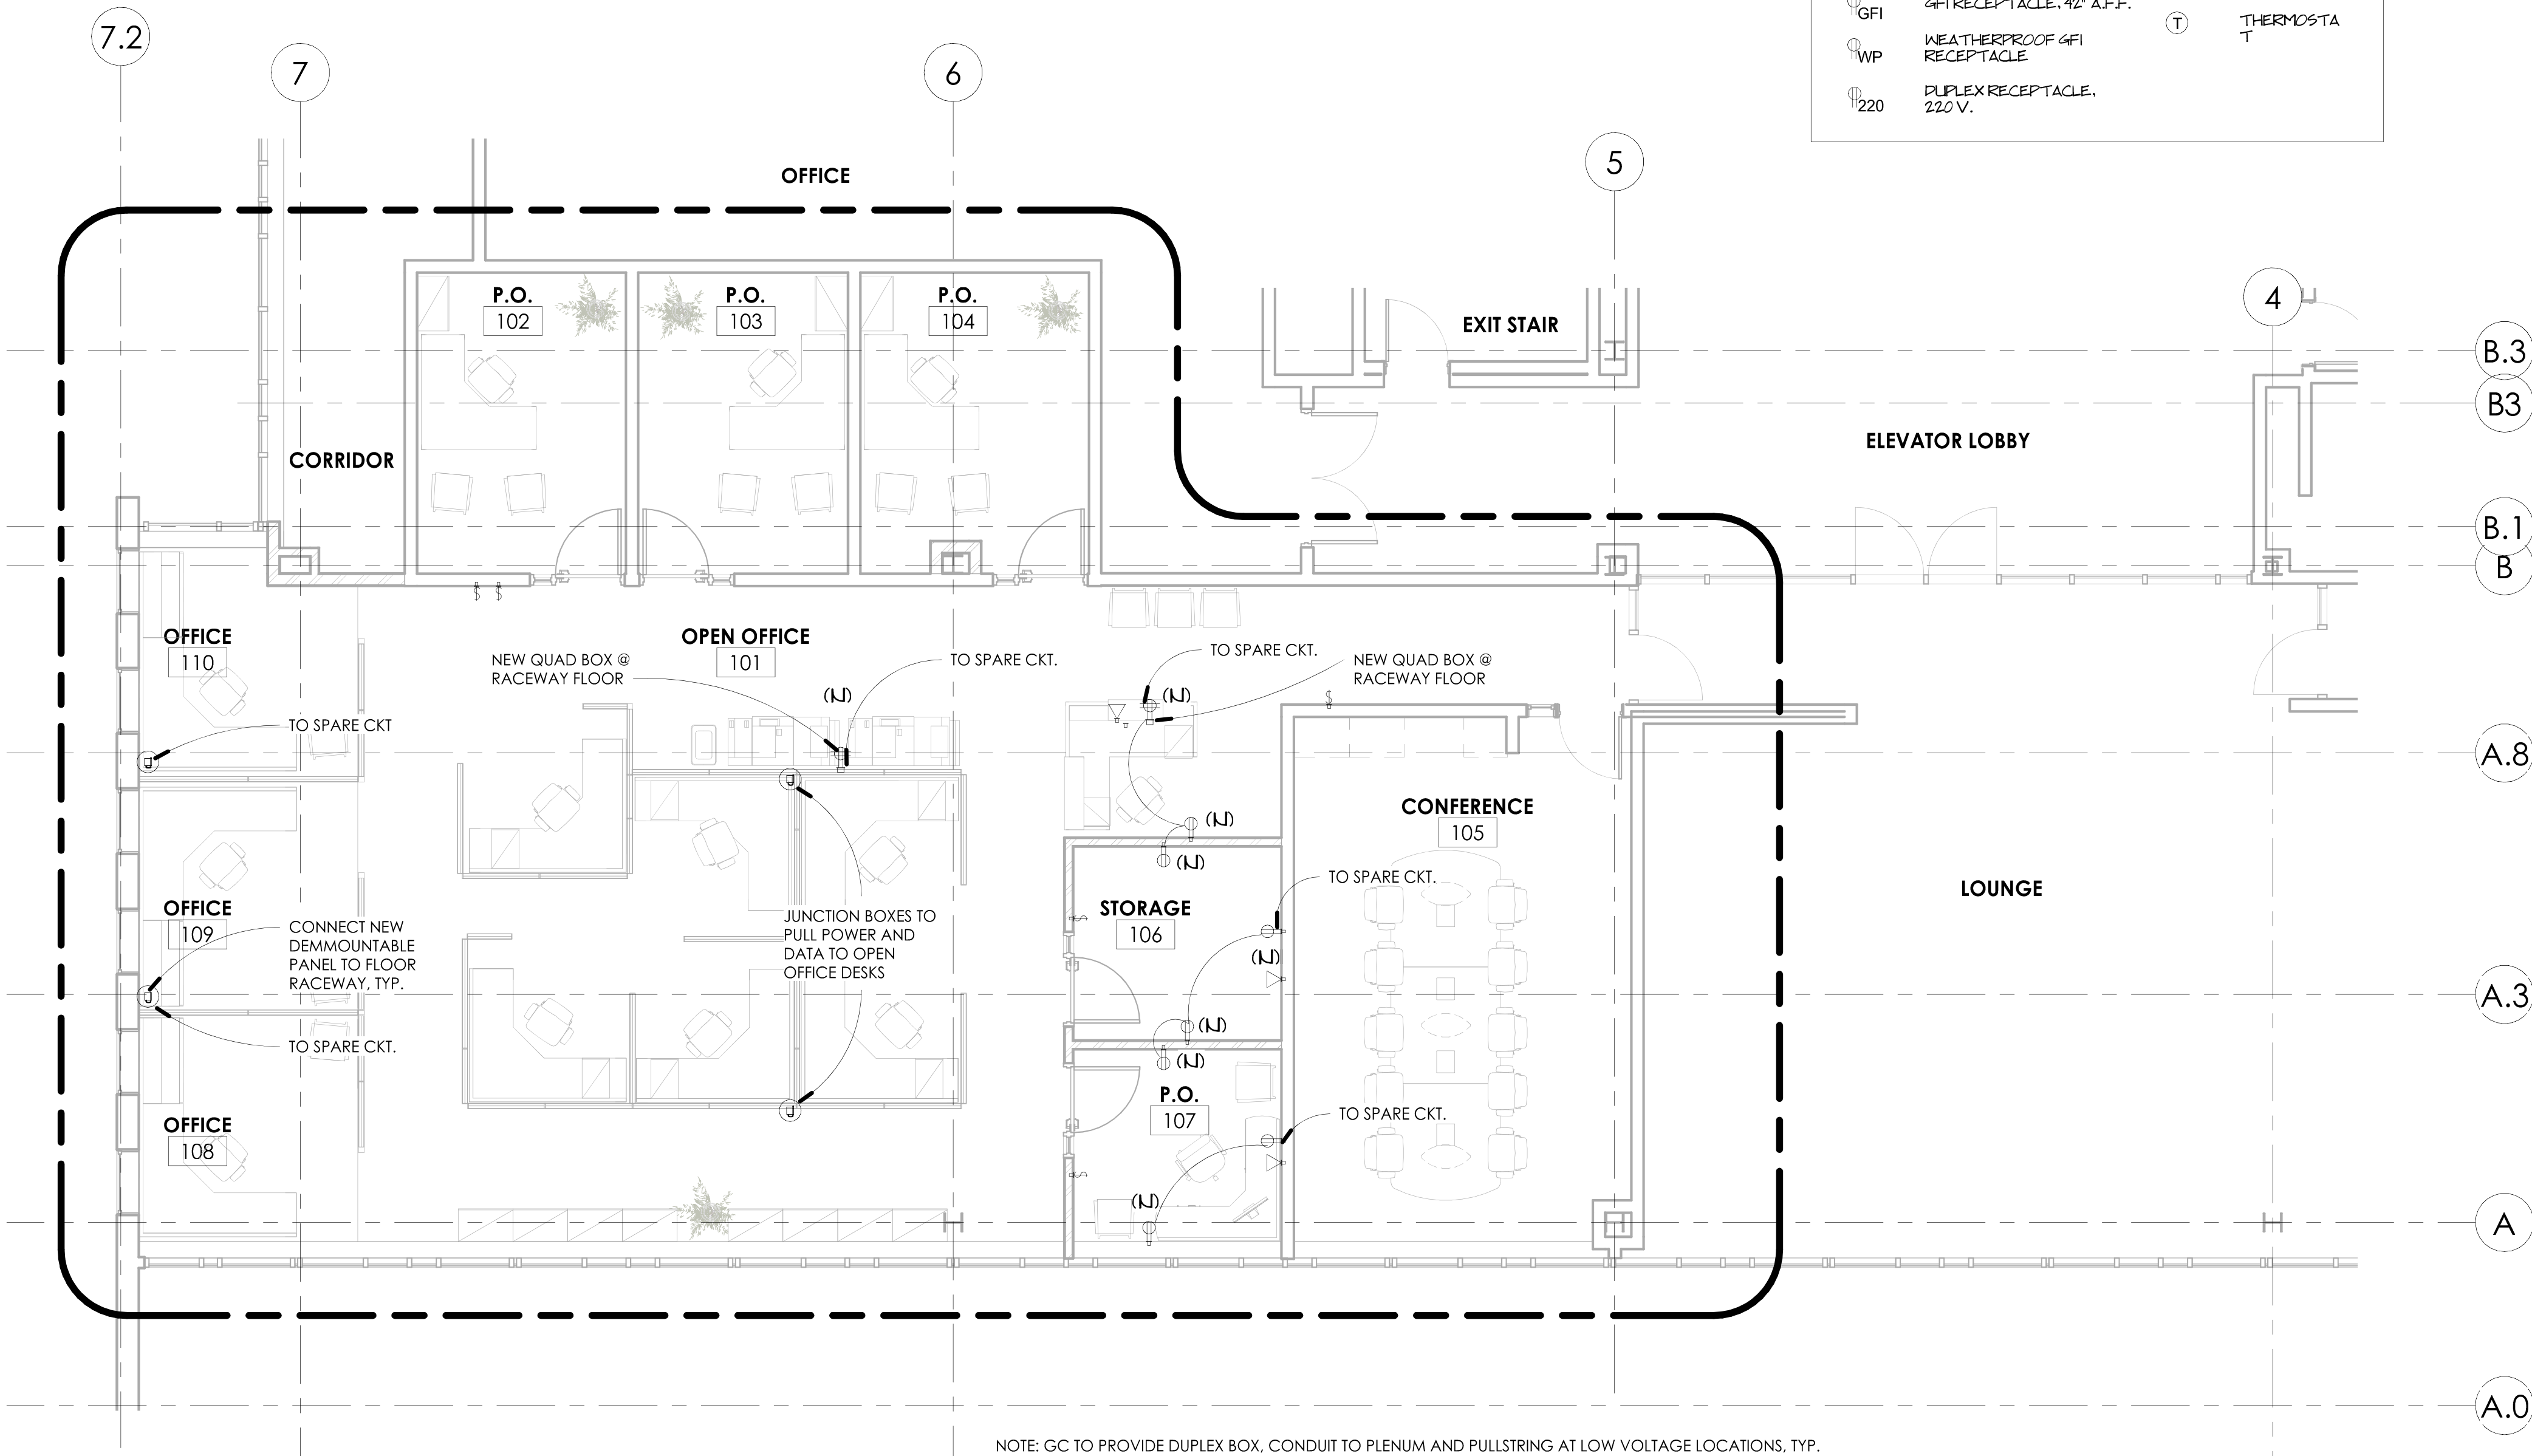


NOTE: GC TO PROVIDE DUPLEX BOX, CONDUIT TO PLENUM AND PULLSTRING AT LOW VOLTAGE LOCATIONS, TYP.

ELECTRICAL PLAN
3/16" = 1'-0"



ALL ELEVATOR PITS (WHERE APPLICABLE) SHALL BE PROVIDED WITH SUMP PUMP CONNECTED TO THE BUILDING STORM WATER SYSTEM. THE PIT SHALL BE PROVIDED WITH A GALV. STEEL ACCESS LADDER MOUNTED IN AN OSHA COMPLIANT LOCATION WITH WORK LIGHT AND SWITCH ACCESSIBLE FROM THE POINT OF ENTRY. ALL ELEVATOR DOORS SHALL BE PROVIDED WITH STRUCTURAL STEEL SILL ANGLES AS REQUIRED BY THE MANUFACTURER.

Total Tenant Area:	Enclosed
Building Footprint:	2500 S.F.
Use Group:	22,909 S.F.
Construction Class:	B
	II B

DRAWING LIST						
SHEET NUMBER	SHEET NAME	ISSUE DATE	CURRENT REVISION	REVISION DATE	Drawn By	
G0.00	COVER SHEET	9.23.22			MC	
A1.00	FLOOR PLANS	9.23.22			MC	
A1.01	FF&E FLOOR PLAN	9.23.22			MC	
E1.00	ELECTRICAL POWER PLAN	9.23.22			MC	

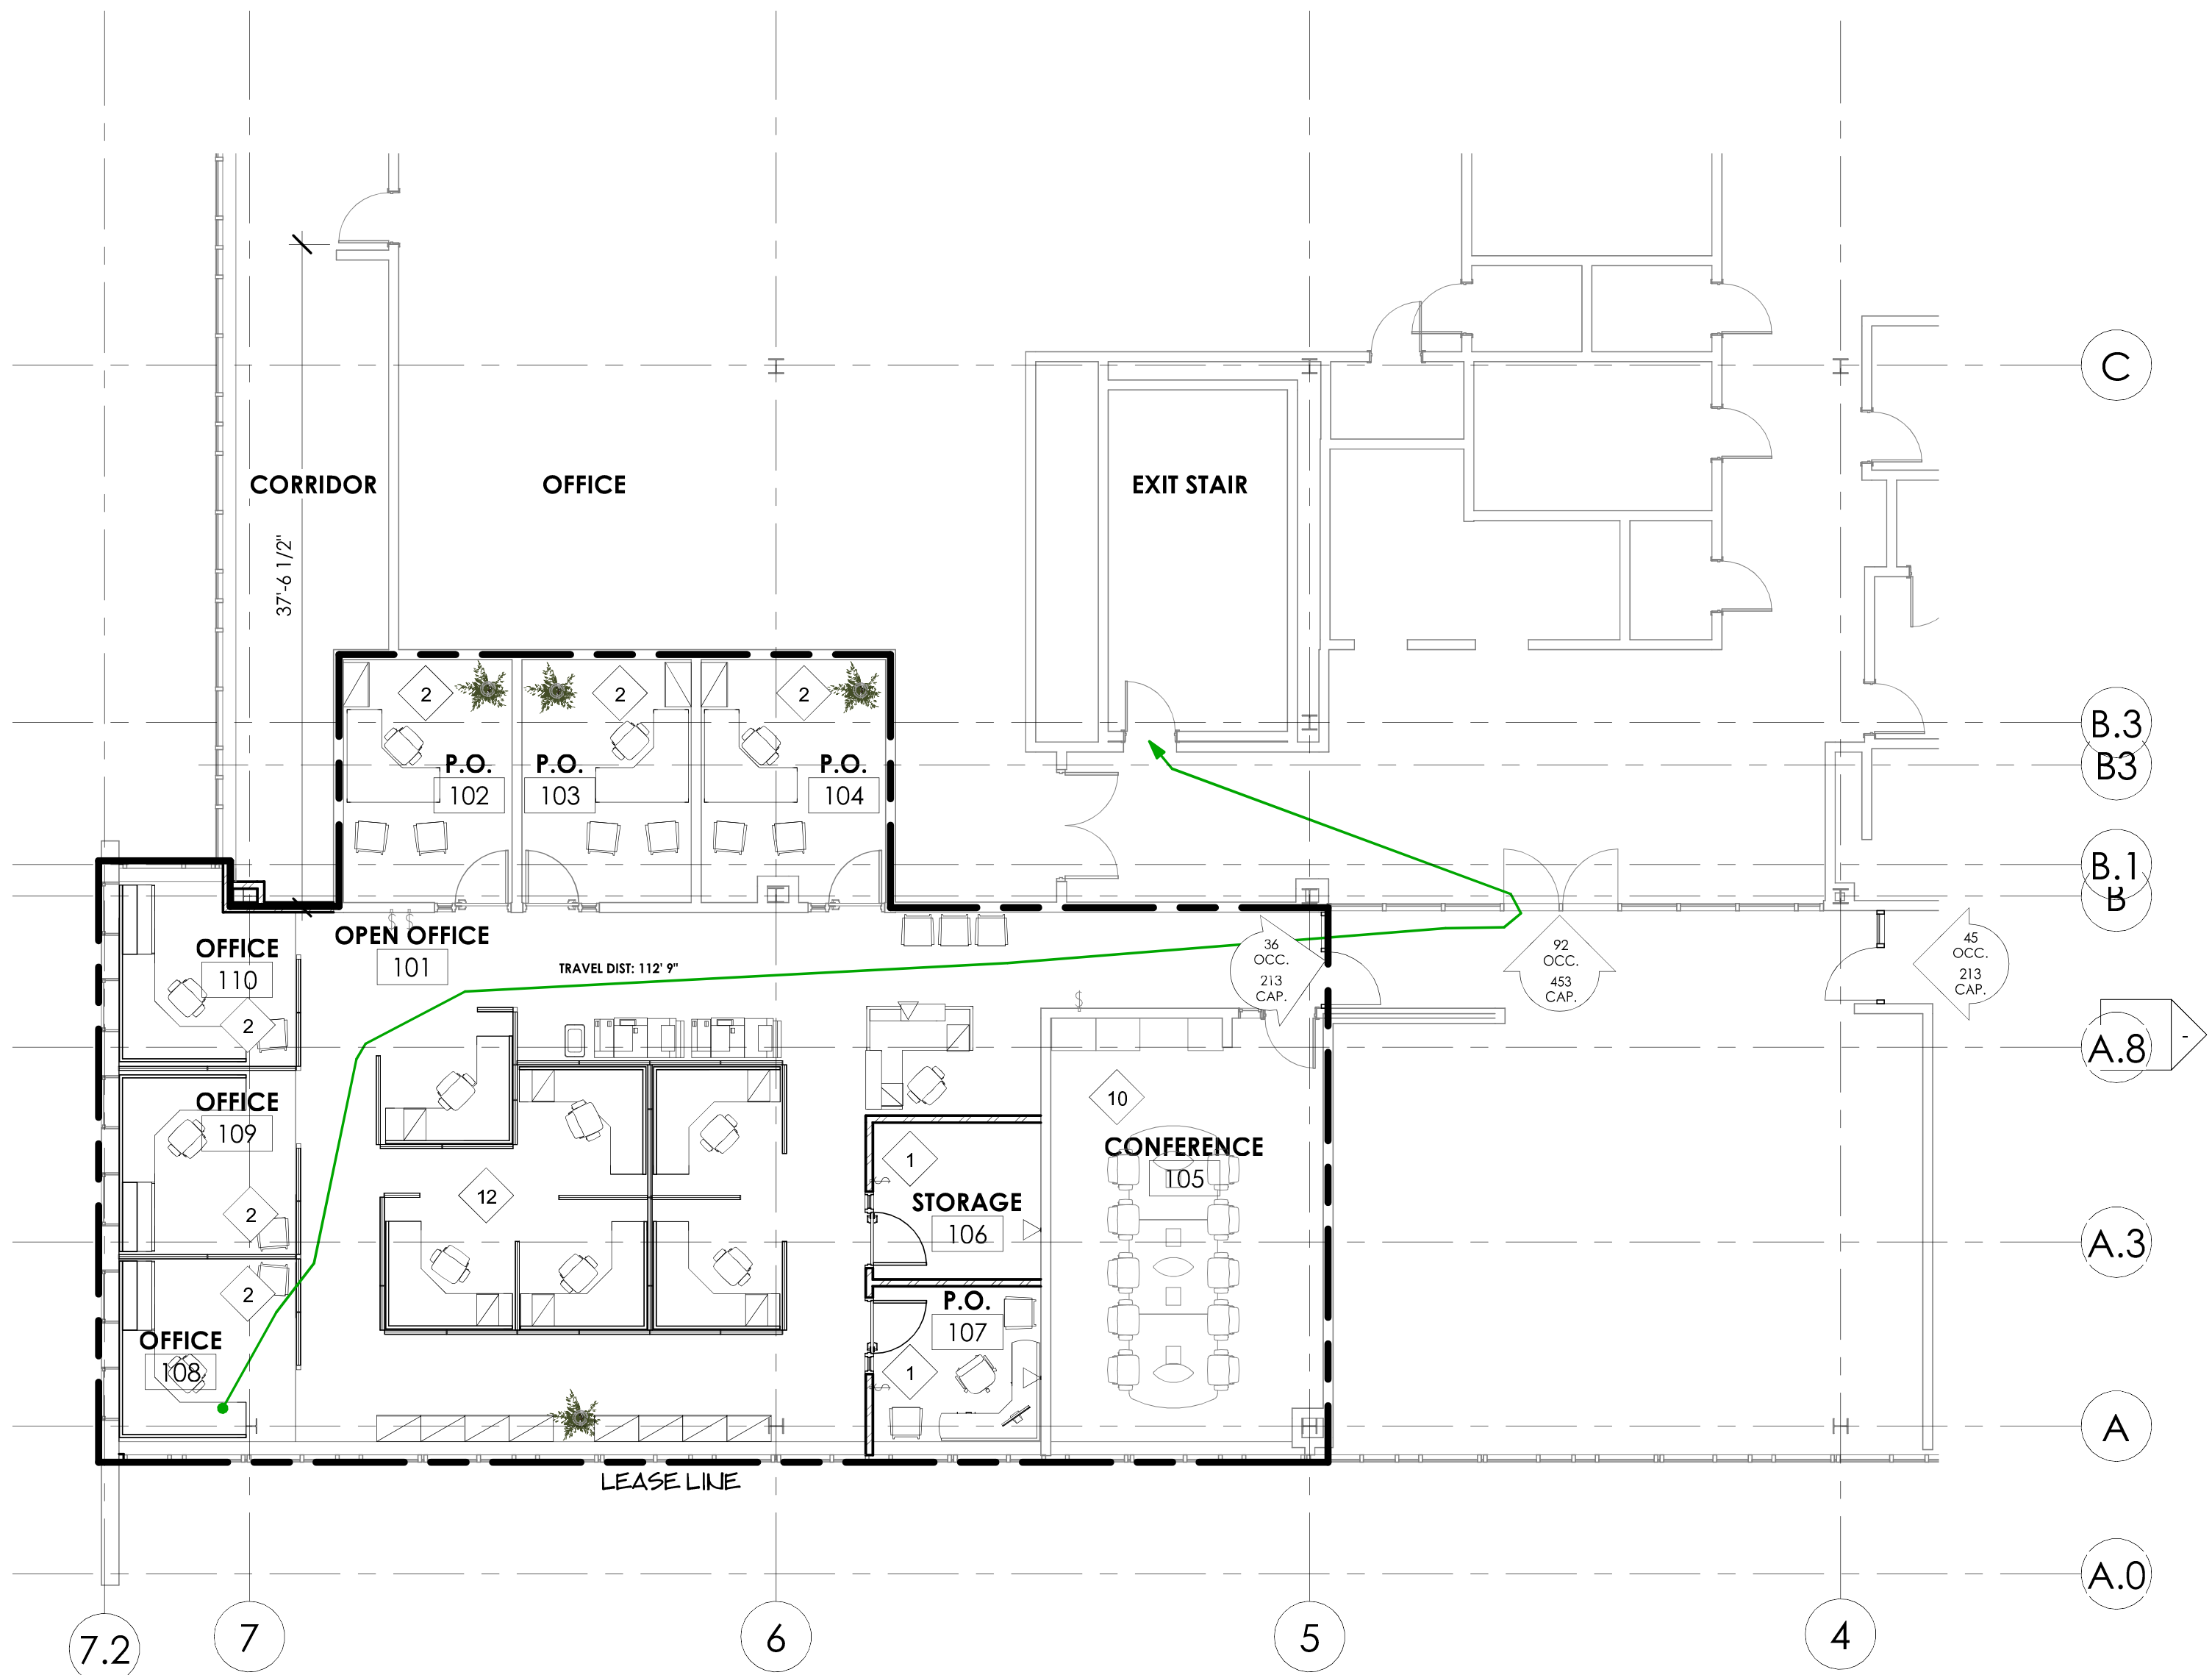

1 KEY PLAN

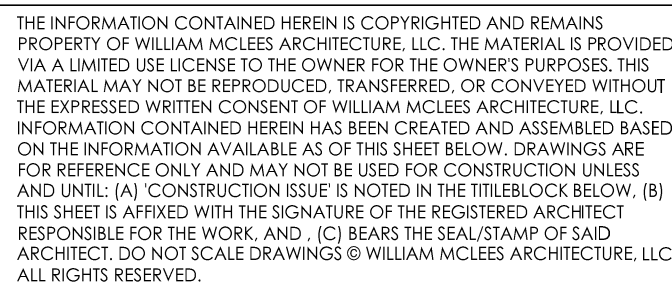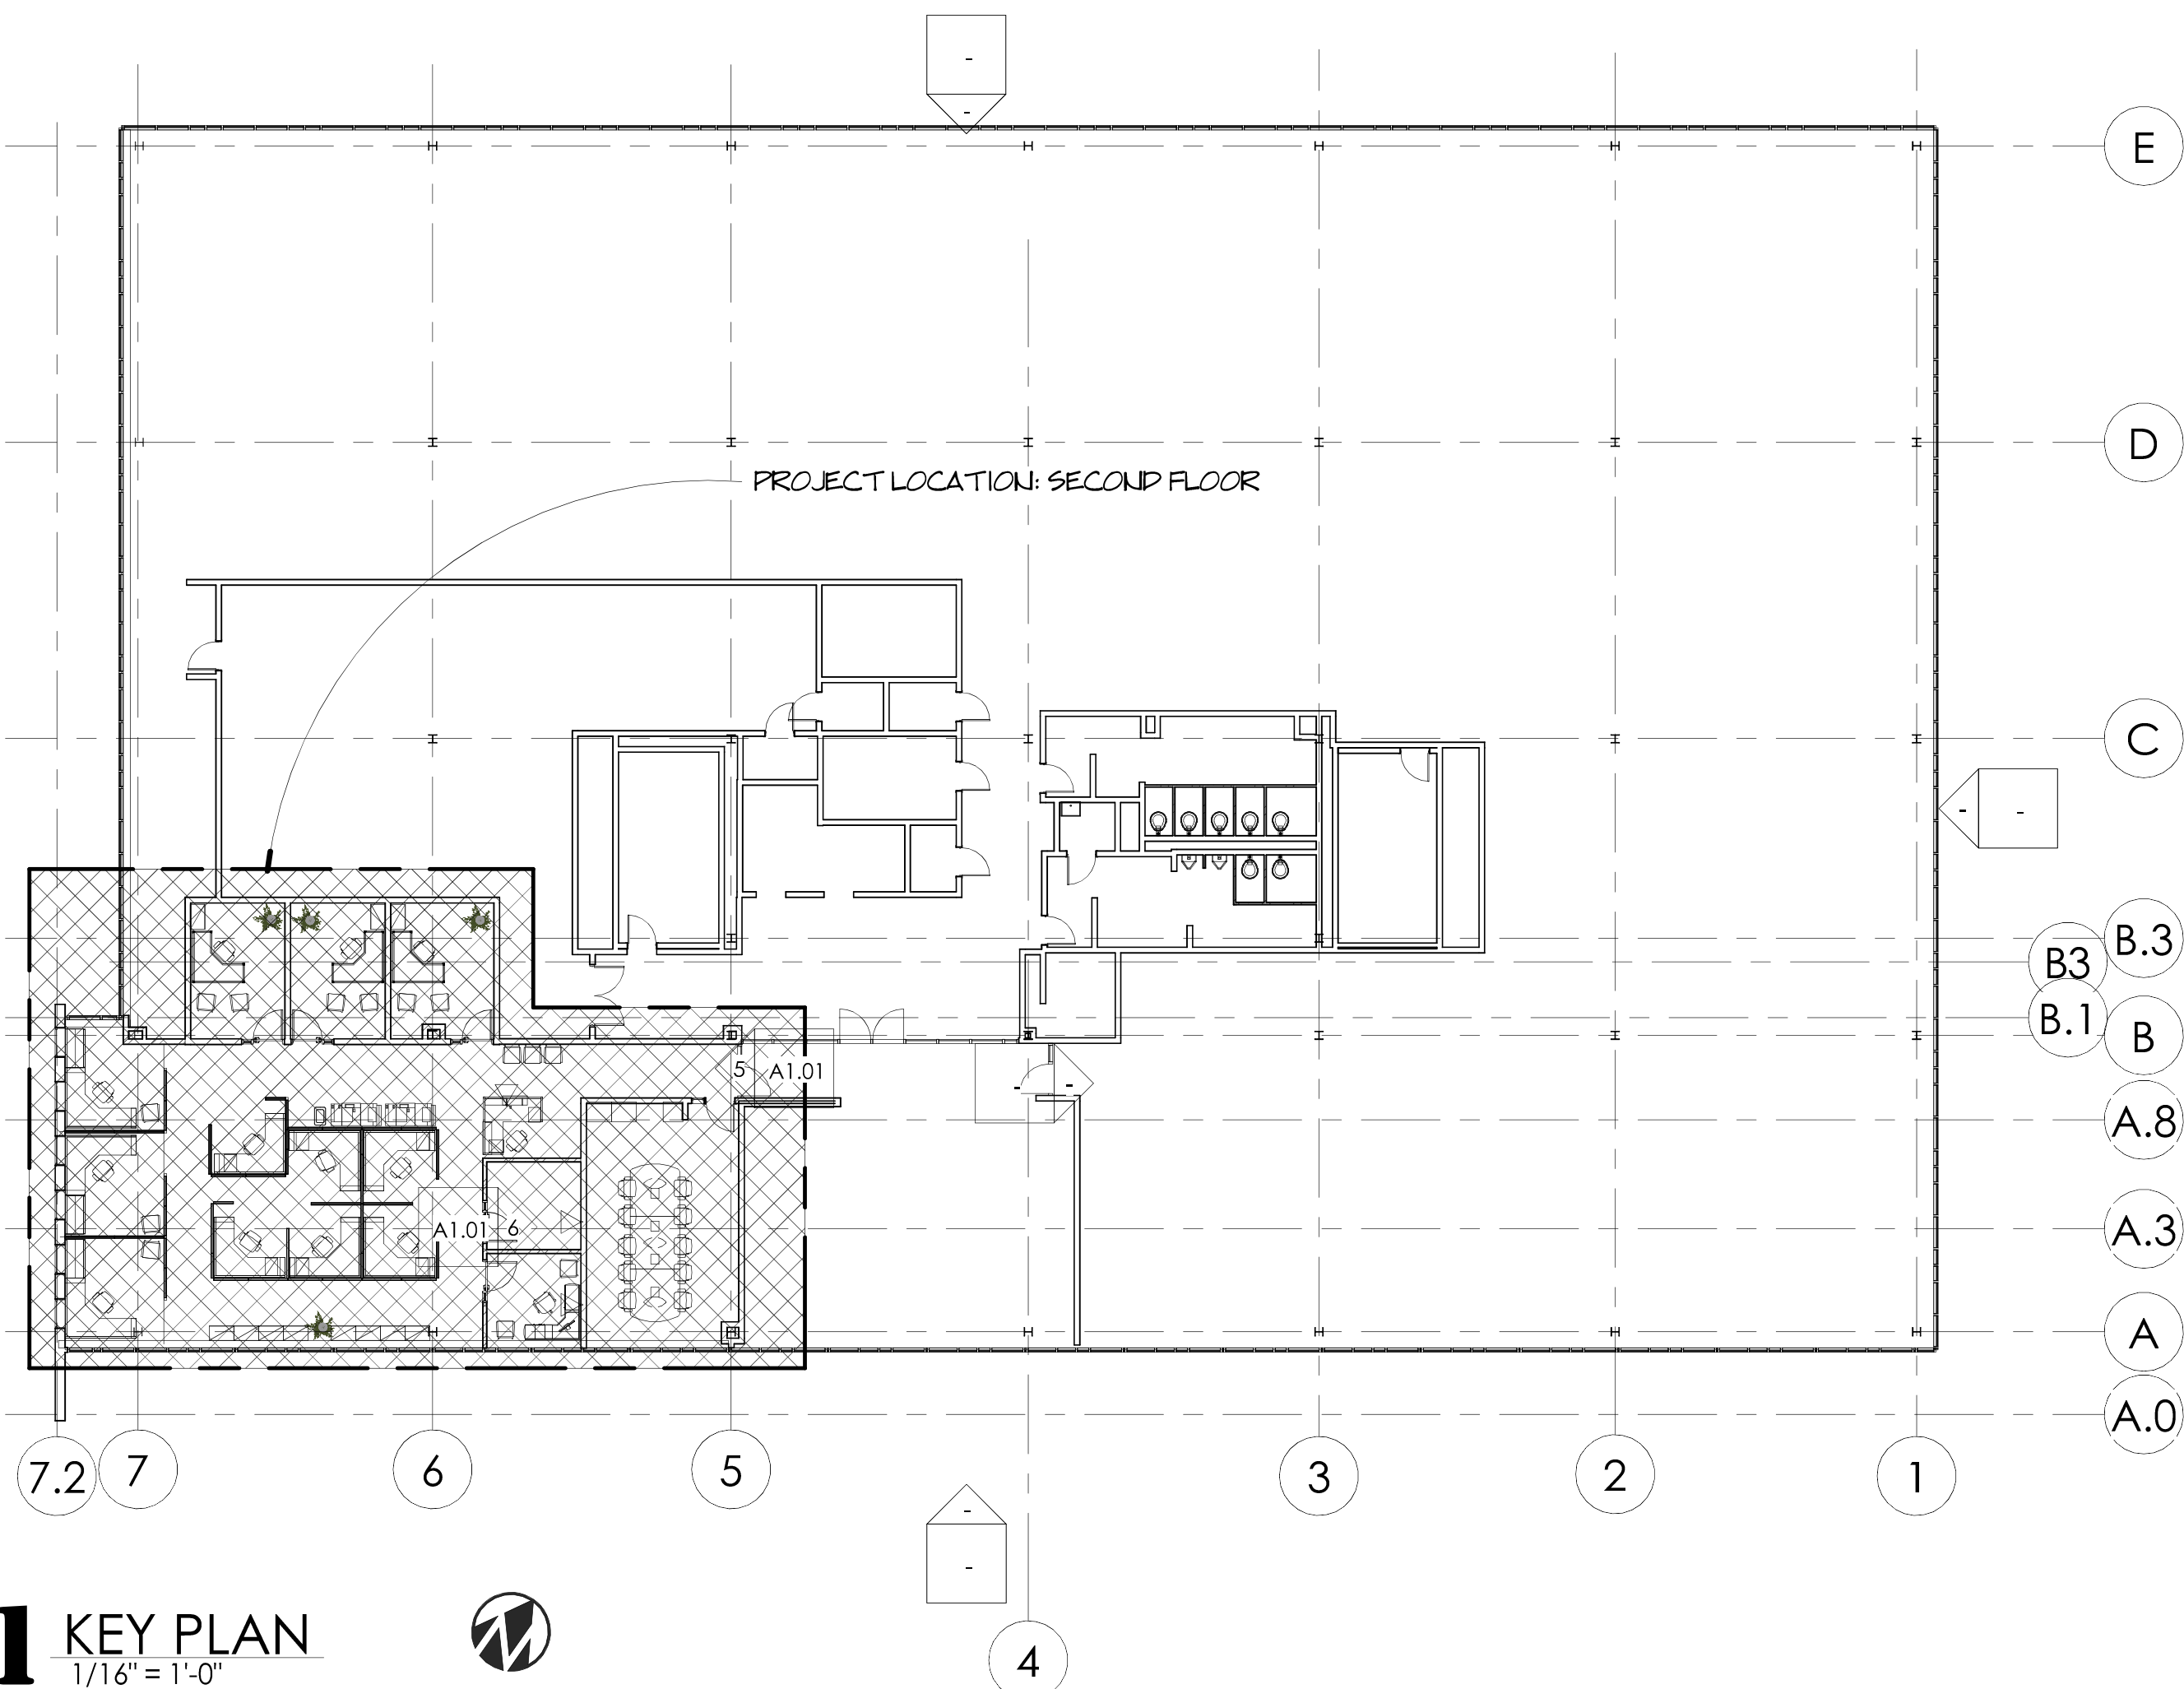

NOT FOR CONSTRUCTION

[illegible]

COVER SHEET

Scale	As indicated
Drawn by	MC
Date	9.23.22

GO.00

Comission no. 22041 A

