Sheet Number	Sheet Name	Sheet Issue Date	Current Revision Date
A0	TABLE OF CONTENTS	07/29/2022	
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L2	TREE SURVEY	07/27/2022	
L3	MATERIALS	07/27/2022	
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A20	Architectural Site Plan	07/29/2022	
A21	Architectural Zoning Chart	07/29/2022	
A22	Bicycle Parking Plan	07/29/2022	
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A24	GFA (Zoning) Diagrams	07/29/2022	
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A28	Unit & Common Areas	07/29/2022	
A29	Unit & Common Areas	07/29/2022	
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A100	1st Floor Plan	07/29/2022	
A101	2nd & 3rd Floor Plans	07/29/2022	
A102	4th-6th Floor Plans	07/29/2022	
A103	7th Floor & Roof Plan	07/29/2022	
A300	Bishop Allen Drive Elevation	07/29/2022	
A301	Douglass Street Elevation	07/29/2022	
A302	Southwest Elevation	07/29/2022	
A303	Southeast Elevation	07/29/2022	
A320	Building Materials	07/29/2022	
AV1A	Neighborhood Photos	07/29/2022	
AV1D	Neighborhood Photos	07/29/2022	
AV1E	Neighborhood Photos	07/29/2022	
AV1B	Neighborhood Photos	07/29/2022	
AV1C	Neighborhood Photos	07/29/2022	
AV2	Perspectives	07/29/2022	
AV3	Rendering 1	07/29/2022	
AV3A	Rendering 1 - Existing	07/29/2022	
AV4	Rendering 2	07/29/2022	
AV4A	Rendering 2 - Existing	07/29/2022	
AV4A AV5	Rendering 2 - Existing Rendering 3	07/29/2022	
AV5 AV5A		07/29/2022	
C0	Rendering 3 - Existing Existing Topographic Site Plan	5/31/2019	
C1	Topographic Site Plan	11/24/2021	



PROJECT: BISHOP ALLEN @ DOUGLASS RESIDENCES

PROJECT ADDRESS: 50 BISHOP ALLEN DRIVE CAMBRIDGE, MA

ARCHITECT:

KHALSA DESIGN INC.

17 IVALOO STREET, SUITE 400 SOMERVILLE, MA 02143 617-591-8682

LEGAL:

HOPE LEGAL LAW OFFICES

907 MASSACHUSETTS AVENUE, SUITE 300 CAMBRIDGE, MA 02139

CLIENT:

FIRST CAMBRIDGE REALTY CORP

907 MASSACHUSETTS AVENUE CAMBRIDGE, MA 02139 T. 617-547-6559

LANDSCAPE:

VERDANT LANDSCAPE ARCHTIECTURE

318 HARVARD STREET SUITE 25 BROOKLINE, MA 02446

CIVIL:


VTP ASSOCIATES, INC

132 ADAMS STREET, 2ND FLOOR SUITE 3 NEWTON, MA 02458

SPECIAL PERMIT GRAPHICS 07/29/2022

Project number	18132	Drawn by	ERS
Date	2/18/2022	Checked by	JSK
		Scale	




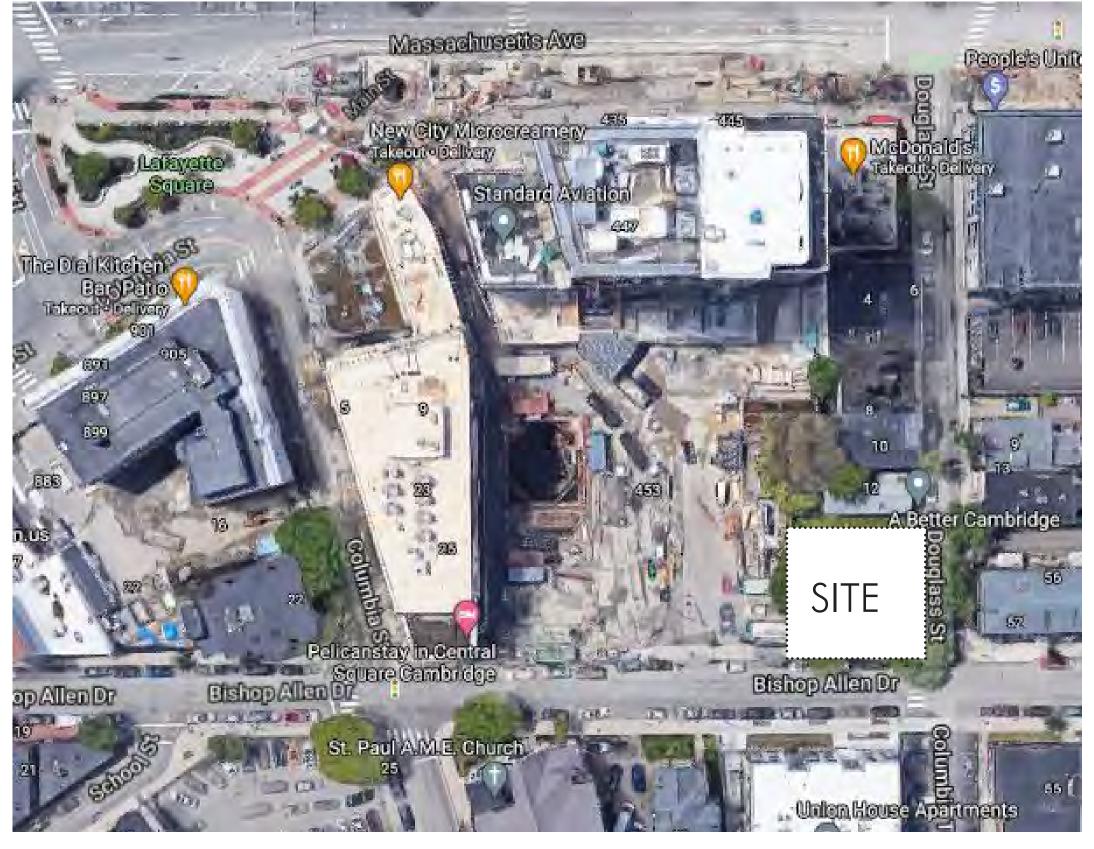

Locus

Projec	t number	Drawn by
Date	07.27.22	Checked by
		Scale

locus | landscape series **L1**

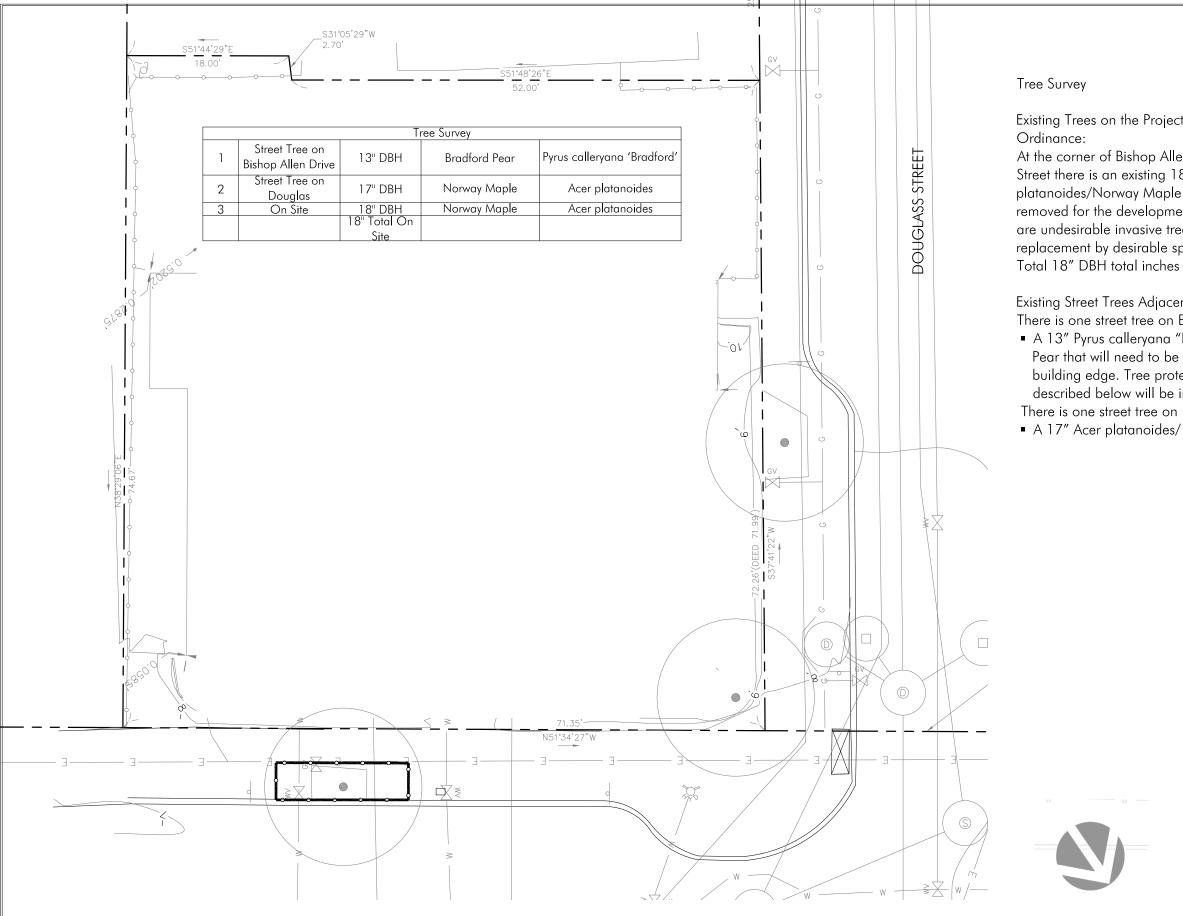

Existing Trees on the Project Site subject to

At the corner of Bishop Allen Drive and Douglass Street there is an existing 18" DBH Acer platanoides/Norway Maple which must be removed for the development. Acer platanoides are undesirable invasive trees and will be replacement by desirable species.


Existing Street Trees Adjacent to the Project Site: There is one street tree on Bishop Allen Drive:


■ A 13" Pyrus calleryana "Bradford'/Bradford Pear that will need to be pruned back from the building edge. Tree protection measures as described below will be implemented.

There is one street tree on Douglass Street:

A 17" Acer platanoides/ Norway Maple

Project number Drawn by **Date** 07.27.22 Checked by Scale

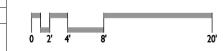

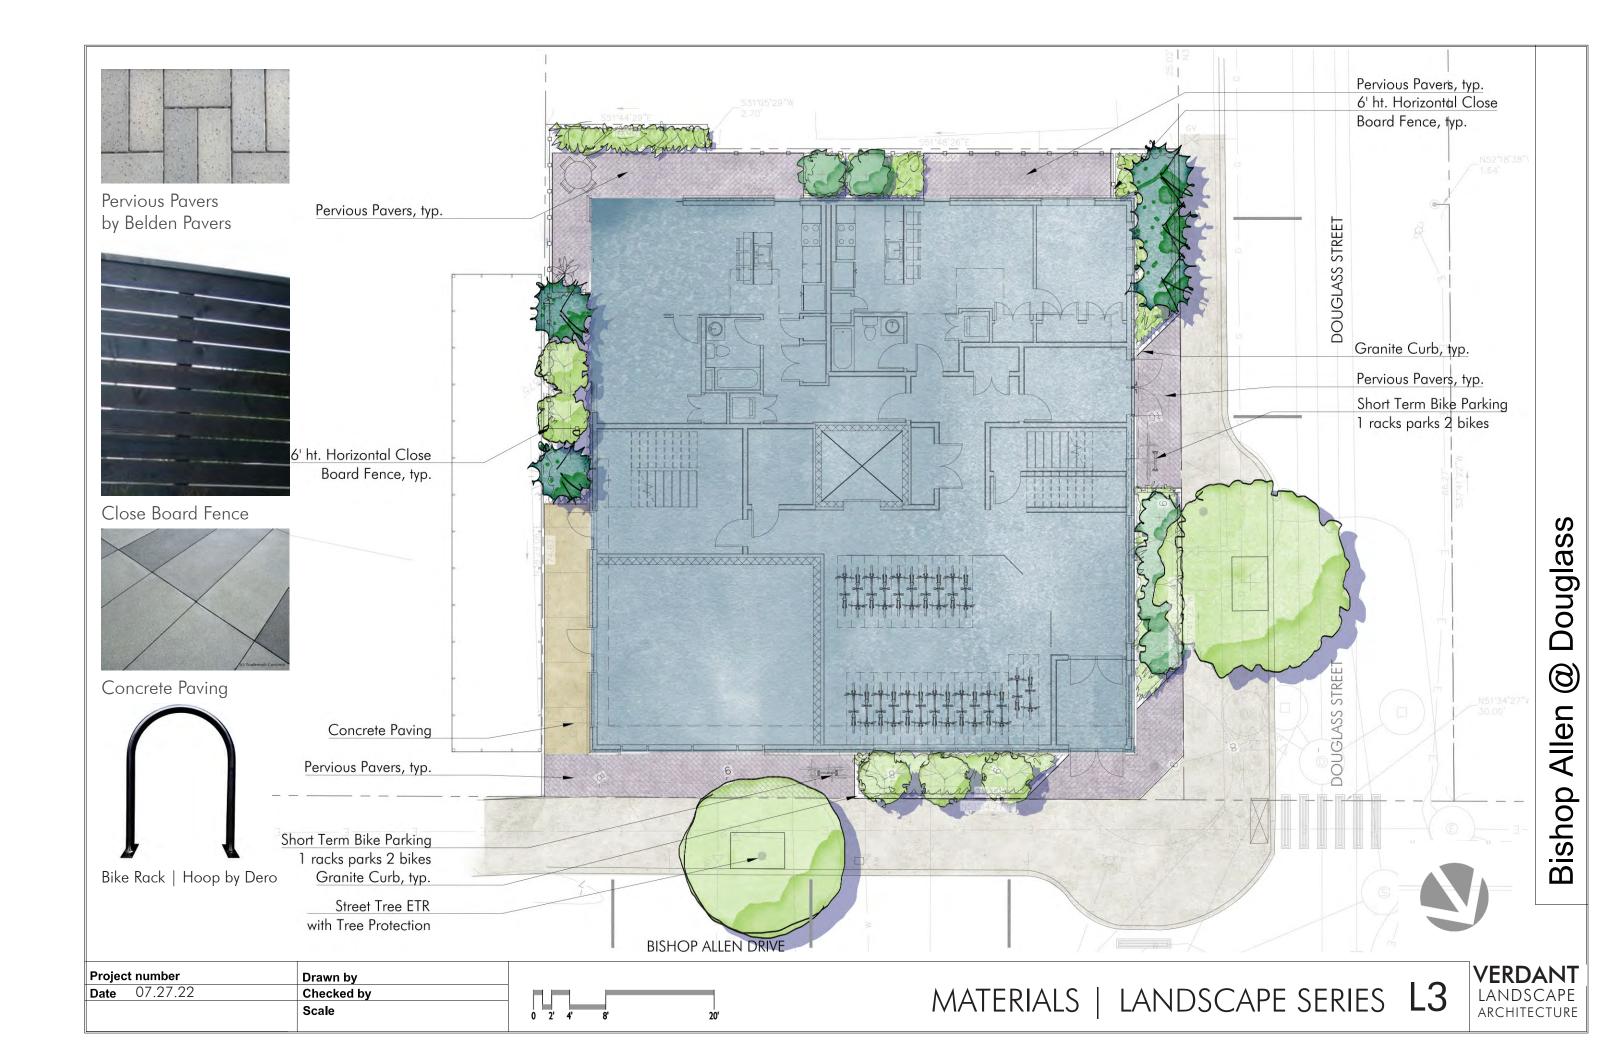

Bishop Allen @ Douglass

TB-3

ср-40

DOUGLASS STREET

览UA-1

KL-4

cp-40

CONCEPT

PLANTINGS FOR URBAN CONDITIONS

Support Biodiversity, Sustainability

and Water Management Using wildlife friendly plantings & practices with a range of trees, shrubs, perennials and groundcovers, helps support biodiversity in the neighborhood

Tree Mitigation				
	Caliper of Trees To Be Removed	Total Caliper of Proposed Trees		
Existing Acer platanoides (DBH)	18"			
Juniperus virginiana 'Taylor'		6"		
Liquidambar styraciflua		15"		
Total	18	21"		

DBH = Diameter at Breast Height = trunk diameter measured 4 $\frac{1}{2}$ feet from the ground

CAL = Caliper = Diameter at Breast Height = trunk diameter measured

$4\frac{1}{2}$ feet from ground

BISHC)P ALI	.EN @ DOUGLASS PLANT LIST					1	
KEY	QTY	BOT. NAME	CC	DMMON NAME	MIN.	SIZE	NOTES	
Trees:								
JV	2	Juniperus virginiana 'Taylor'		Taylor Eastern Red Ceda	r	4/5'=3"cal.	B&B	
LS	5	Liquidambar styraciflua		Slender Silhouette Sweets	gum	2.5-3" cal.	B&B	
UA	1	Ulmus americana 'Valley Forge'		American Elm		3-3.5" cal.	B&B	
Shrubs	s:							
KL	4	Kalmia latifolia		Mountain Laurel		7 gal.		
TB	3	Taxus baccata 'Erecta'		Columnar English Yew		4/5'	B&B	
_								
Perenr	nials:							
at	13	Asclepias tuberosa		Butterfly Weed		2 gal.	18" oc	Ī
ср	115	Carex pensylvanica		Oak Sedge		1 gal.	18" oc	
cd	31	Carex dolichostachya 'Kaga Nishiki	1	Gold Fountains Sedge		2 gal.	18" ос	
ер	13	Echinacea purpurea		Purple Coneflower		2 gal.	18" oc	
mf	13	Monarda fistulosa		Wild Bergamont		1 gal.	18" oc	
pv	13	Panicum virgatum		Switchgrass		2 gal.	18" oc	
				•		O		

Projec	t number	Drawn by
Date	07.27.22	Checked by
		Scale



at-4 ep-4

mf-4

pv-4

JV-1

at-9

ер-9

mf-9 pv-9

LS-2

JV-1



LS-3

ср-35

BISHOP ALLEN DRIVE

KL-1


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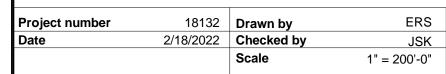
KL-1


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VERDANT LANDSCAPE ARCHITECTURE







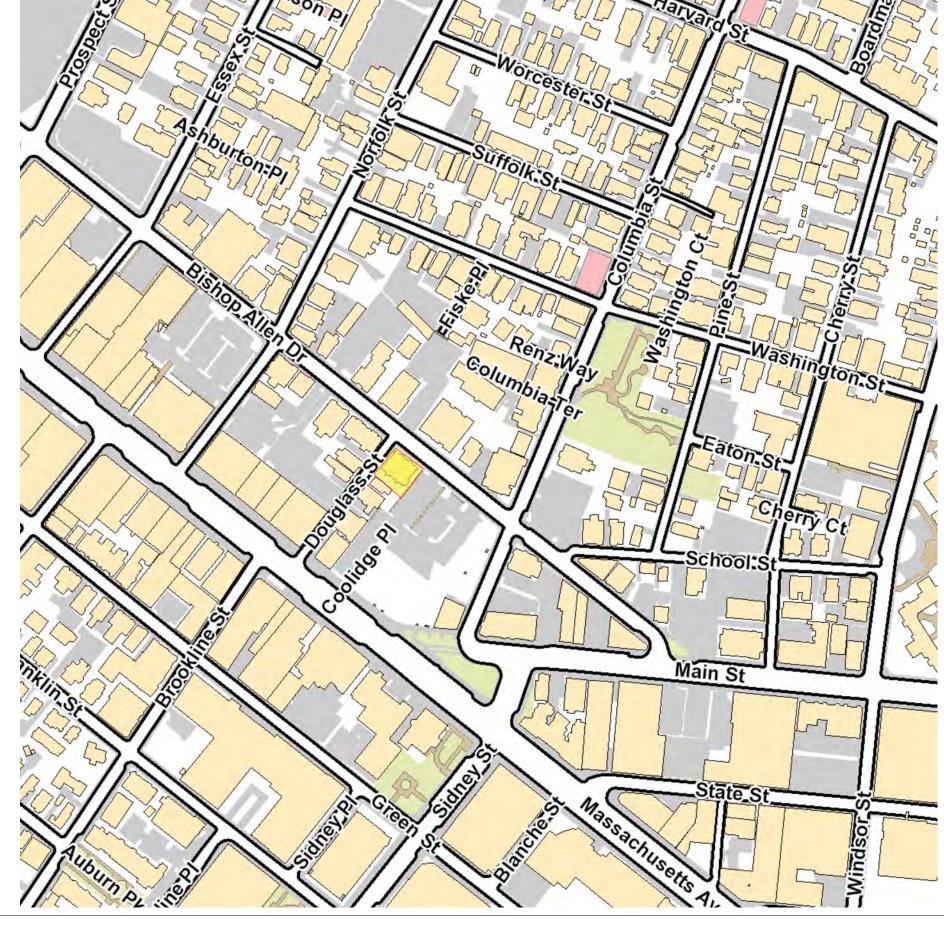

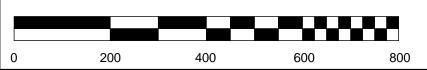LOCUS PLAN





FRONT OF 50 BISHOP ALLEN DRIVE



RIGHT SIDE OF BUILDING (DOUGLASS ST)



FRONT LEFT SIDE OF BUILDING (BISHOP ALLEN DRIVE)




FRONT RIGHT SIDE OF BUILDING (BISHOP ALLEN DRIVE)






Existing Site Plan
3/32" = 1'-0"

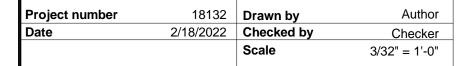





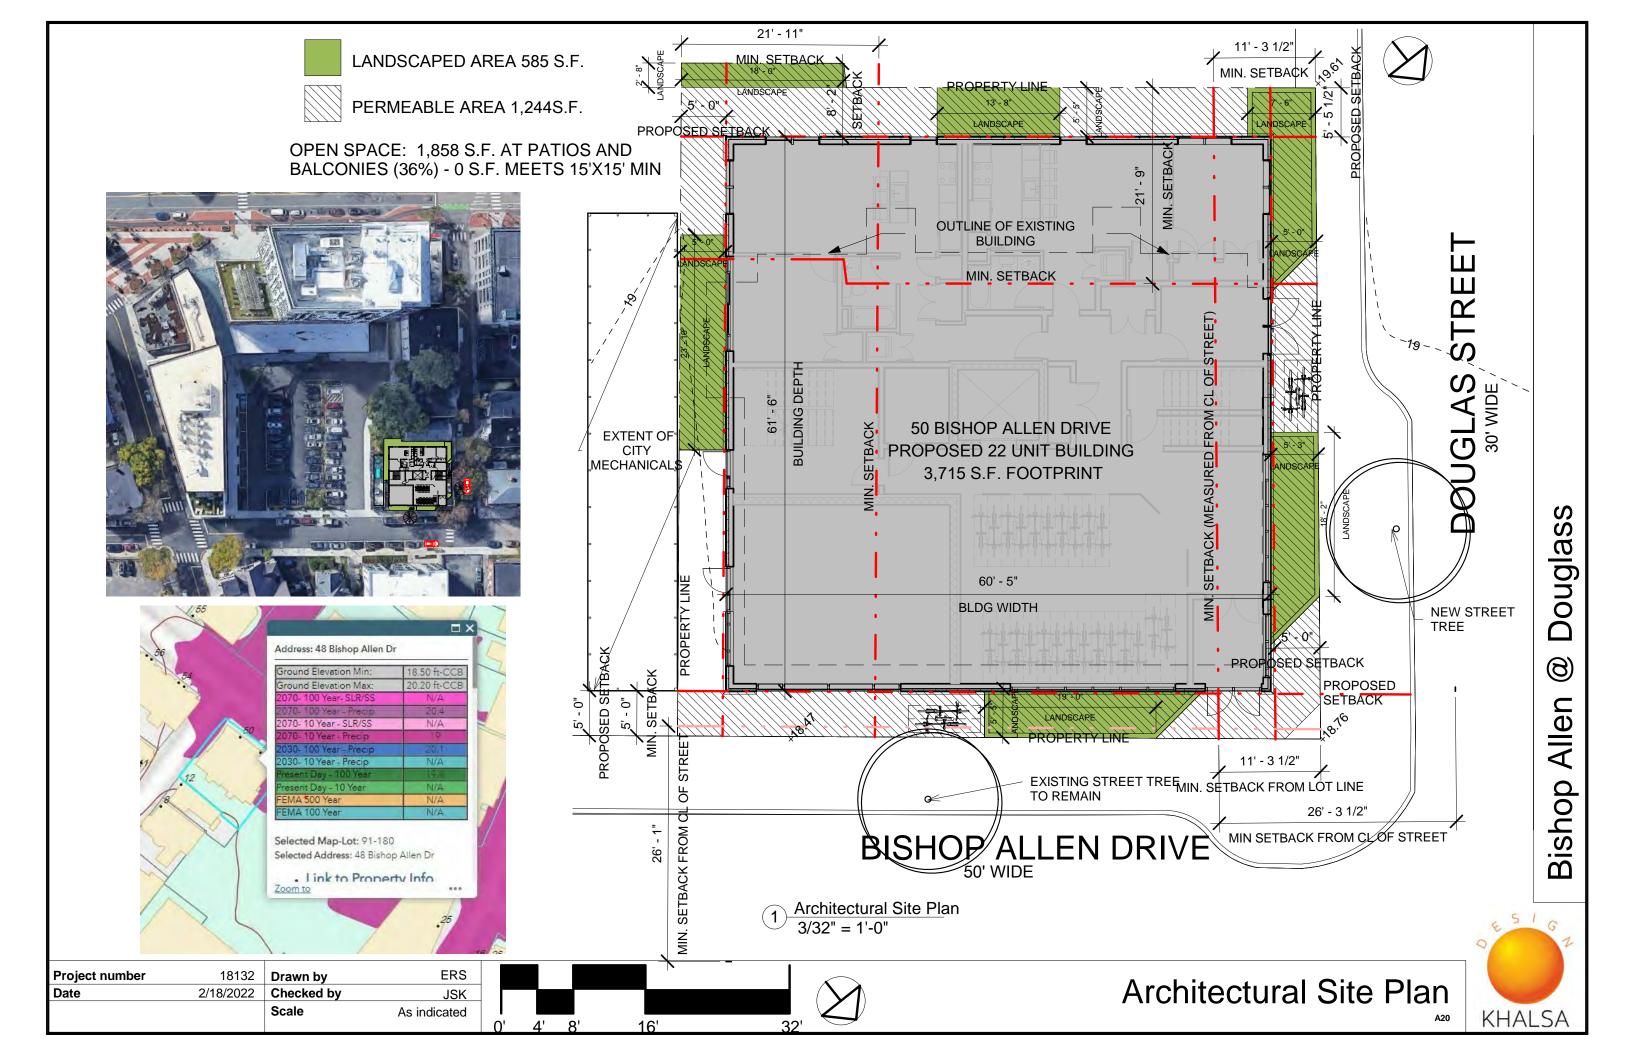


		ZONING CHART			
BB ZONE 5,150 SF SITE	REQUIRED IN BASE ZONE (BB)	CENTRAL SQUARE OVERLAY (SUPERSEDES BB) REFER TO 20.300	EXISTING	PROPOSED	REMARKS
FAR	3.0 / 15,450 S.F.	4.0 / 20,600 SEE NOTES BELOW +15% INCLUSIONARY BONUS +15% INCENTIVE 26,780 (5.52)	1.1 / 6,093 PER DATABASE	4.68 / 24,123 SF	COMPLIES
MIN. LOT SIZE	NO RESTRICTION	N/A	5,150 SF	5,150 SF	COMPLIES
LOT AREA/DU	300 SF / DU (17 DU) 15% INCLUSIONARY HOUSING +15% INCENTIVE 22 DU	N/A	643 SF / DU (8 DUs)	303 S.F. / DU (17 DU) BASE + 5 DU INCLUSIONARY & INCENTIVE BONUSES	COMPLIES
MIN. LOT WIDTH	NO RESTRICTION	N/A	71.35'	71.35'	COMPLIES
MIN. FRONT SETBACK	RES IN BB ZONE = RES C-3				
BISHOP ALLEN DRIVE	(H+L)/5=(60.5+70)/5=130.5/5=26.1 5' MIN.	20.304.4 (BELOW)	+/-8'	5' (30' FROM CL OF STREET)	COMPLIES
DOUGLAS STREET	(H+L)/5=(61.5+70)/5=131.5/5=26.3 5' MIN.	20.304.4 (BELOW)	+/-6.7'	5' (20' FROM CL OF STREET)	SPECIAL PERMIT
MIN. SIDE SETBACK (LEFT)	(H+L)/6=(61.5+70)/6=131.5/6=21.9	20.304.4 (BELOW)	+/-2.7'	5'	SPECIAL PERMIT
MIN. SIDE SETBACK (RIGHT)	(H+L)/6=(60.5+70)/6=130.5/6=21.75	20.304.4 (BELOW)	+/-13.2'	5'	SPECIAL PERMIT
MAX HEIGHT (IN FEET)	80'	SEE NOTES BELOW:	+/-36' (3 STORIES)	69'-11" (7 STORIES W/ BULK CONTROL PLANE)	COMPLIES
MIN. RATIO OF PRIVATE OPEN SPACE TO LOT AREA	RES IN BB ZONE = RES C-3 10% (515 S.F.)	PER BASE ZONING	+/-1,002 S.F. (19%)	1,858 S.F. AT PATIOS AND BALCONIES (36%) NO S.F. MEETS 15'X15' MIN	SPECIAL PERMIT
PARKING	1/DU (22 REQUIRED)	0.75/DU (17 SPACES) (SEE NOTES BELOW)	0 SPACES	0 SPACES	SPECIAL PERMIT
BICYCLE PARKING	LONG TERM: 1/DU FOR 1ST 20 DU + 1.05 FOR ADD DU (23 REQUIRED) SHORT TERM: 0.10 / DU (3 REQUIRED)	PER BASE ZONING	0 SPACES	24 LONG TERM SPACES + 4 SHORT TERM SPACES	COMPLIES


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Date	2/18/2022	Checked by	JSK
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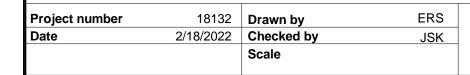


20'

CENTRAL SQUARE ACTION PLAN: "CENTRAL TO MIT" DISTRICT



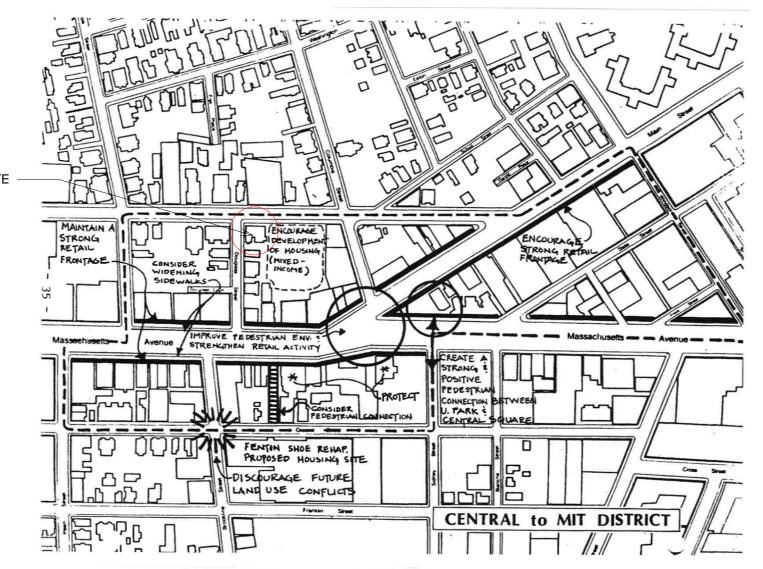

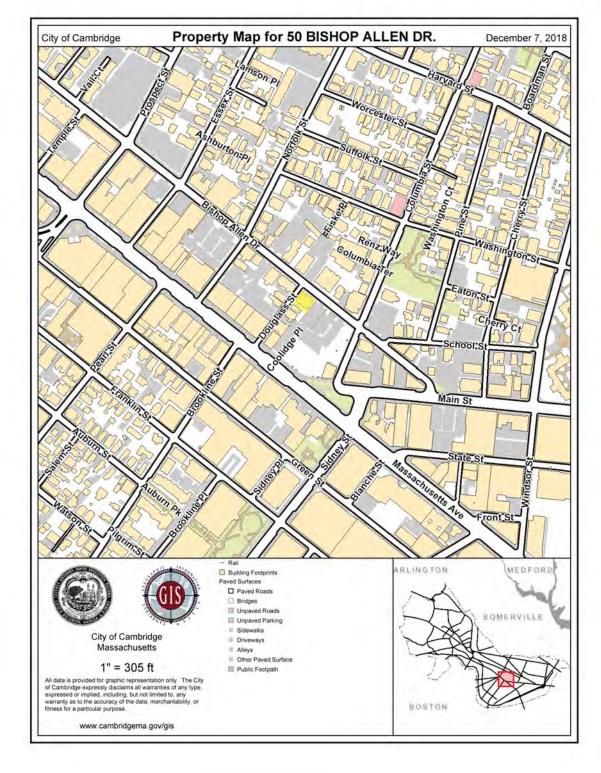



16'


64'

Gross Floor Area (Per Zoning)				
Area Name Level				

2500 SF	GFA	1st Floor Level
3205 SF	GFA	2nd Floor
3813 SF	GFA	3rd Floor
3813 SF	GFA	4th Floor
3813 SF	GFA	5th Floor
3529 SF	GFA	6th Floor
2931 SF	GFA	7th Floor


23603 SF


GROSS FLOOR AREA CALCULATED PER THE CITY OF CAMBRIDGE ZONING CODE

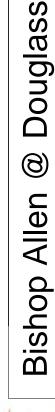





GFA (Zoning) Diagrams

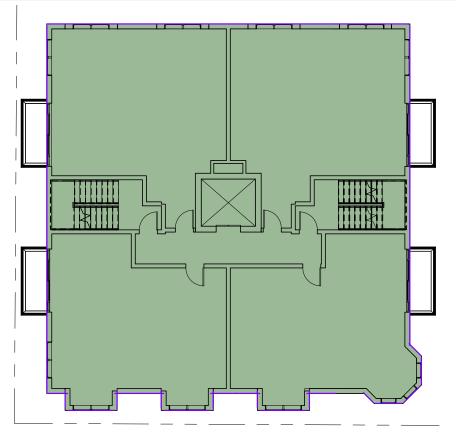

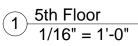

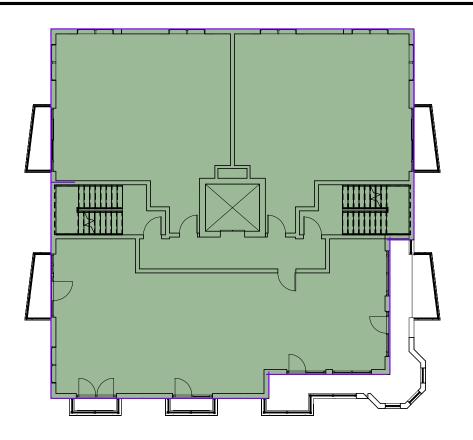

6th Floor					
2	1/16" = 1'-0"				

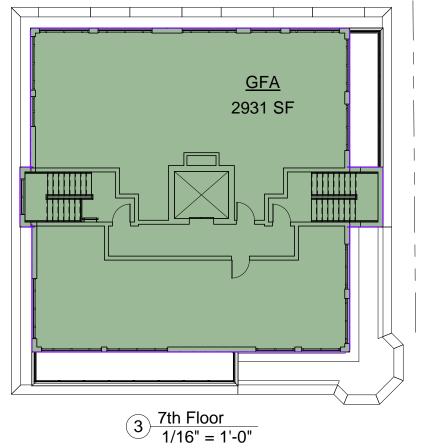


Gross Floor Area (Per Zoning)				
Area Name Level				

2500 SF	GFA	1st Floor Level
3205 SF	GFA	2nd Floor
3813 SF	GFA	3rd Floor
3813 SF	GFA	4th Floor
3813 SF	GFA	5th Floor
3529 SF	GFA	6th Floor
2931 SF	GFA	7th Floor

23603 SF

GROSS FLOOR AREA CALCULATED PER THE CITY OF CAMBRIDGE ZONING CODE

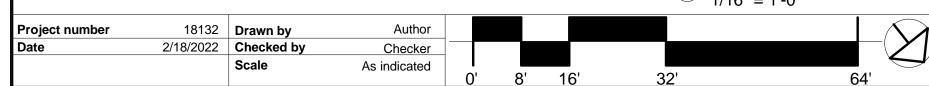





GRO	GROSS FLOOR AREA PER IBC					
Area	Area Name Level					


3716 SF	Gross Floor Area	1st Floor Level
3739 SF	Gross Floor Area	2nd Floor
3813 SF	Gross Floor Area	3rd Floor
3813 SF	Gross Floor Area	4th Floor
3813 SF	Gross Floor Area	5th Floor
3529 SF	Gross Floor Area	6th Floor
2930 SF	Gross Floor Area	7th Floor


25352 SF


TOTAL AREA OF ALL FLOORS WITH NO EXCLUSIONS



GFA (IBC) Diagrams

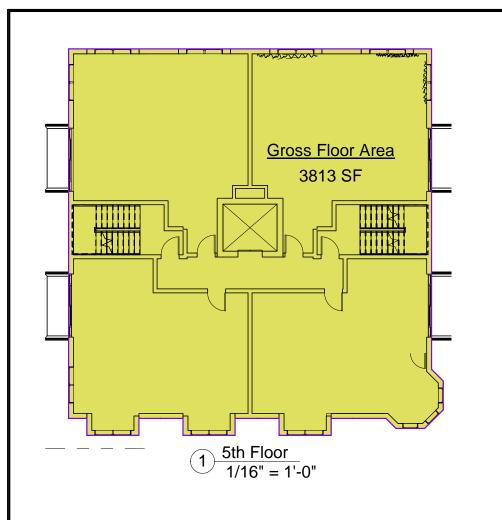

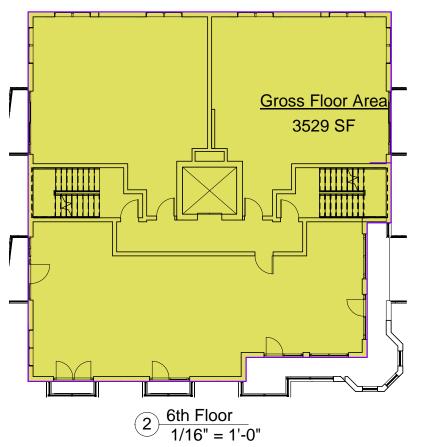

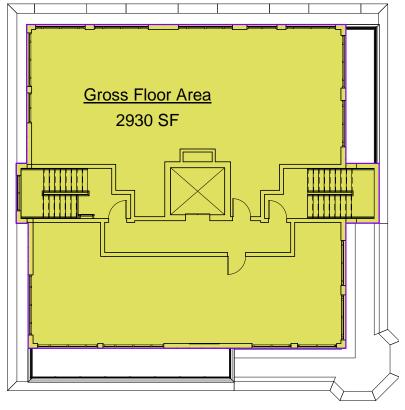

GRO	GROSS FLOOR AREA PER IBC				
Area Name Level					

3716 SF	Gross Floor Area	1st Floor Level	
3739 SF	Gross Floor Area 2nd Floor		
3813 SF	Gross Floor Area	3rd Floor	
3813 SF	Gross Floor Area	4th Floor	
3813 SF	Gross Floor Area	5th Floor	
3529 SF	Gross Floor Area	6th Floor	
2930 SF	Gross Floor Area	7th Floor	
	•		


25352 SF

TOTAL AREA OF ALL FLOORS WITH NO EXCLUSIONS

3 7th Floor 1/16" = 1'-0"


64'


Project number	18132	Drawn by	Author			
Date	2/18/2022	Checked by	Checker			
		Scale	As indicated	<u> </u>		
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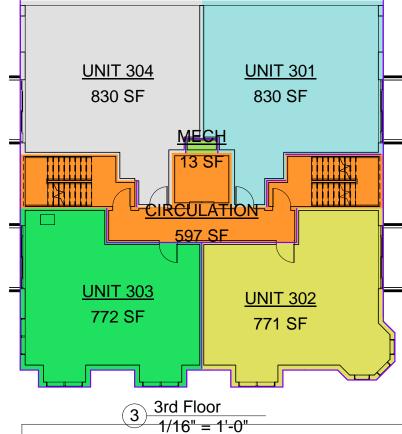


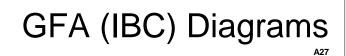2nd Floor 1/16" = 1'-0"

Level

Unit Areas 1-3

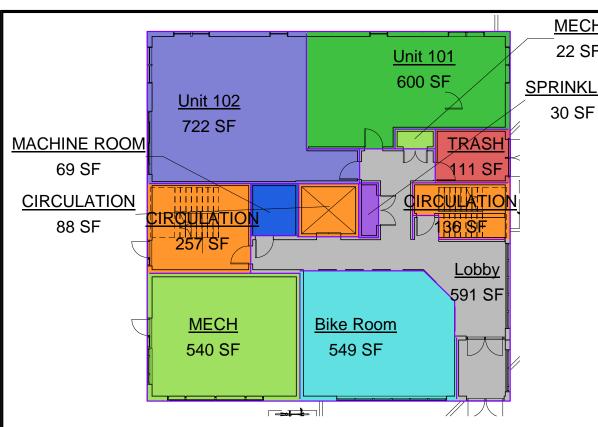Name

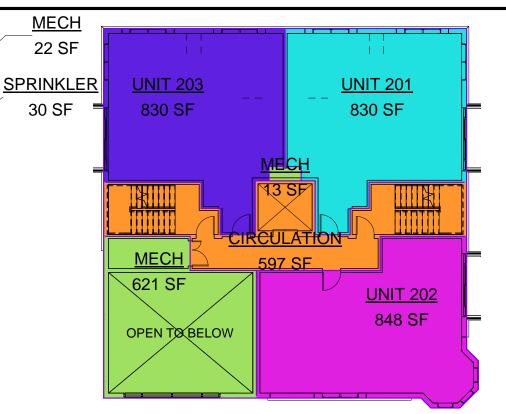

1st Floor Level 1/16" = 1'-0"

Unit Areas 1-3			
Area	Name	Level	

2nd Floor

2nd Floor

Area

549 SF	Bike Room	1st Floor Level	597 SF	CIRCULATION	2nd Floor
481 SF	CIRCULATION	1st Floor Level	634 SF	MECH	2nd Floor
591 SF	Lobby	1st Floor Level	1231 SF T	OTAL 2ND FLOOR	COMMON AREA
69 SF	MACHINE ROOM	1st Floor Level			
562 SF	MECH	1st Floor Level			
30 SF	SPRINKLER	1st Floor Level		Unit Areas 1	I-3
111 SF	TRASH	1st Floor Level			

Level

3rd Floor

Area

597 SF	CIRCULATION	3rd Floor
13 SF	MECH	3rd Floor

Unit Areas 1-3

Unit Areas 1-3

Level

Level

610 SF TOTAL 3RD FLOOR COMMON AREA 4234 SFTOTAL COMMON AREA FLOORS 1-3

Name

Name

Unit Areas 1-3				
Area	Name	Level		

830 SF	UNIT 201	2nd Floor
848 SF	UNIT 202	2nd Floor
830 SF	UNIT 203	2nd Floor

2509 SF TOTAL 2ND FLOOR LEASABLE AREA

3rd Floor

Area

830 SF	UNIT 301	3rd Floor
771 SF	UNIT 302	3rd Floor
772 SF	UNIT 303	3rd Floor
830 SF	UNIT 304	3rd Floor

3203 SF TOTAL 3RD FLOOR LEASABLE AREA 7034 SF TOTAL LEASABLE AREA FLOORS 1-3 11267 SF TOTAL AREA FLOORS 1-3

1st Floor Level

Area

1st Floor Level

600 SF	Unit 101	1st Floor Level	
722 SF	Unit 102	1st Floor Level	

2393 SF TOTAL 1ST FLOOR COMMON AREA

Unit Areas 1-3

1322 SF TOTAL 1ST FLOOR LEASABLE AREA


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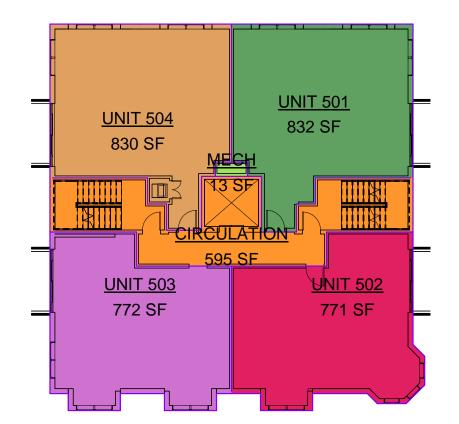
Name






Unit & Common Areas



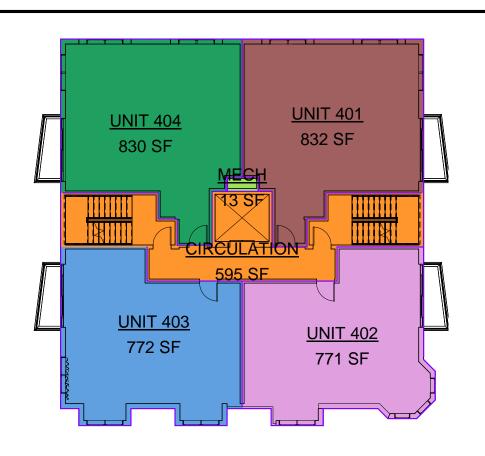

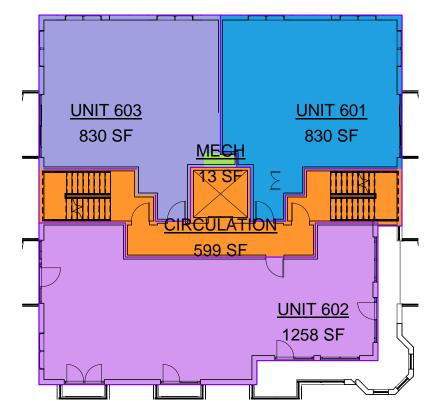

3 6th Floor 1/16" = 1'-0"

Unit Areas 4-6		
Area	Name	Level

6th Floor

6th Floor

5th Floor

Area

595 SF	CIRCULATION	5th Floor	
13 SF	MECH	5th Floor	
608 SE TOTAL 5TH FLOOR COMMON AREA			

Unit Areas 4-6

Name

2 5th Floor 1/16" = 1'-0"

Name

Unit Areas 4-6

Level

Level

1827 SFTOTAL COMMON AREA FLOORS 4-6				
	Unit Areas 4-6			
	Area	Name	Level	

611 SF TOTAL 6TH FLOOR COMMON AREA

CIRCULATION

MECH

6th Floor

6th Floor

599 SF

13 SF

830 SF	UNIT 601	6th Floor
1258 SF	UNIT 602	6th Floor
830 SF	UNIT 603	6th Floor

2918 SF TOTAL 6TH FLOOR LEASABLE AREA 9328 SF TOTAL LEASABLE AREA FLOORS 4-6 11155 SF TOTAL AREA FLOORS 4-6

1 4th Floor 1/16" = 1'-0"

Unit Areas 4-6		
Area	Name	Level

4th Floor

595 SF	CIRCULATION	4th Floor
13 SF	MECH	4th Floor

608 SF TOTAL 4TH FLOOR COMMON AREA

Unit Areas 4-6		
Area	Name	Level

4th Floor

832 SF	UNIT 401	4th Floor
771 SF	UNIT 402	4th Floor
772 SF	UNIT 403	4th Floor
830 SF	UNIT 404	4th Floor

3205 SF TOTAL 4TH FLOOR LEASABLE AREA

5th Floor

Area

832 SF	UNIT 501	5th Floor
771 SF	UNIT 502	5th Floor
772 SF	UNIT 503	5th Floor
830 SF	UNIT 504	5th Floor


3205 SFTOTAL 5TH FLOOR LEASABLE AREA

Project number	18132	Drawn by	Author
Date	2/18/2022	Checked by	Checker
		Scale	As indicated





Unit & Common Areas

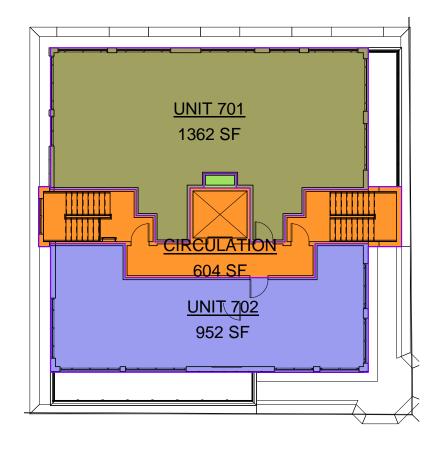

Unit Areas 7			
Area	Name	Level	

7th Floor

604 SF	CIRCULATION	7th Floor
13 SF	MECH	7th Floor

617 SF TOTAL 7TH FLOOR COMMON AREA 7th Floor

1362 SF	UNIT 701	7th Floor
952 SF	UNIT 702	7th Floor

2314 SF TOTAL 7TH FLOOR LEASABLE AREA 2931 SF TOTAL 7TH FLOOR AREA

Project number	18132	Drawn by	Author					
Date	2/18/2022	Checked by	Checker					(
		Scale	As indicated					
1				0'	8'	16'	32'	64'



Requirements for Customer Alcove Containing Eversource Distribution Equipment

Alcove to be located on an outside wall of the customer building that is exposed to natural air circulation, and will continue to be exposed to natural air circulation after construction is complete. Alcove to be located such that any future customer construction or adjacent property construction will not restrict access or reduce the amount of natural air circulation.

Alcove size is dependent upon the number, type, and layout of equipment housed. All minimum clearances for unobstructed work space around equipment shall be maintained. A minimum unobstructed ceiling height of 15-feet is required. These minimum clearances may require increasing for adequate equipment cooling and access.

Padmount equipment shall be positioned within the alcove such that removal of any one piece of equipment will not require disturbing, relocating or removing another piece of equipment.

Padmount transformers and transclosures to be set on a poured concrete housekeeping pad with the top surface 4-inches above the floor. Padmount switches, and primary metering enclosures to be set on the appropriate fiberglass base also installed with the top surface 4-inches above the floor.

Poured concrete floor and ceiling, with poured concrete or cement block walls, all having a 3 hour fire rating. Floors pitched to drain storm water out and away from the alcove. Floors to be even with finished grade level.

One metal 36-inch wide, 80-inch tall, three hinge passage door that provides egress directly to the outside at finished grade level. Door to open out or away from the alcove, have interior panic opening hardware and exterior lock keyed to Eversource "M" standard.


Locking overhead metal "screen" roll up door(s) or hinged metal gate(s) that provide access directly to the outside at finished grade level. Door(s) and gate(s) must be sized and located to allow unrestricted installation, maintenance, and removal of equipment without altering any building structure or trim, and provide adequate natural ventilation. The minimum door or gate opening height is 15-feet, and minimum opening width is 10-feet.


Interior lighting required, with control switch(es) located inside the alcove adjacent to and accessible from the passage door when open.

No foreign systems, or storage of any type allowed within the alcove.

Customer to own, clean, re-lamp and maintain the alcove, and the associated lighting and its electric source and control, passage and equipment doors and gates and their related locking, opening and operating systems.

Customer to provide Eversource a scale drawing of alcove for approval <u>prior to construction</u>. Drawing to include dimensions, clearances, lighting, door and gate openings, and the footprint(s) and orientation(s) of all required distribution equipment housed.

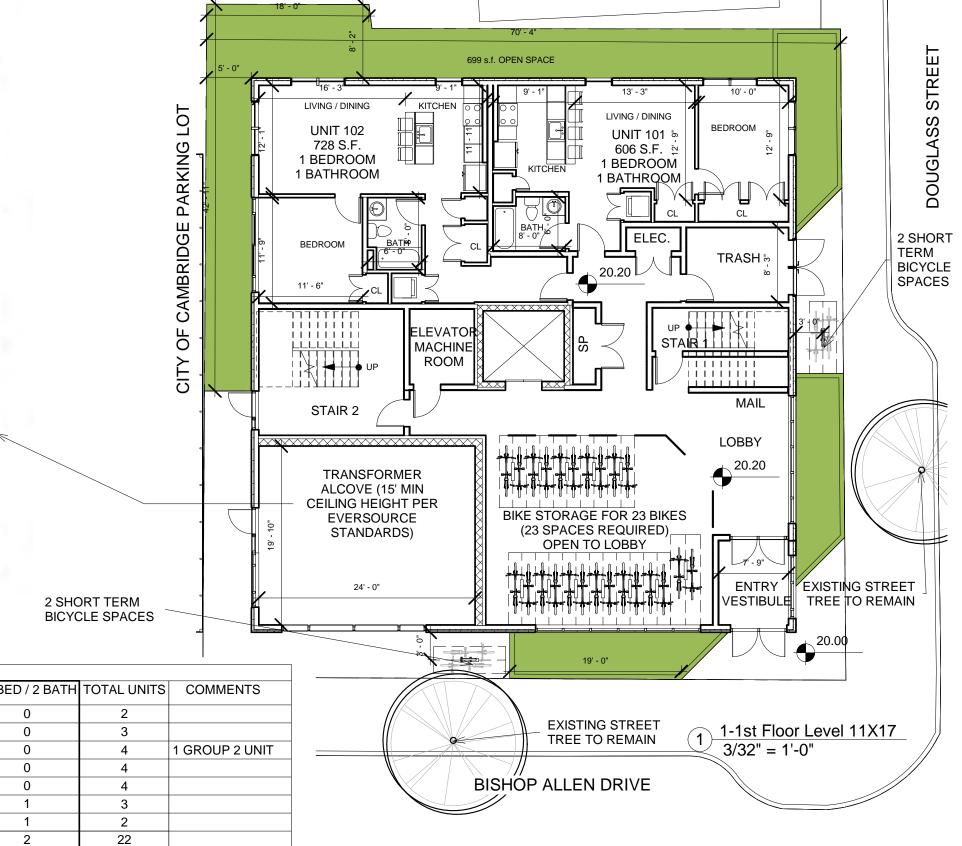

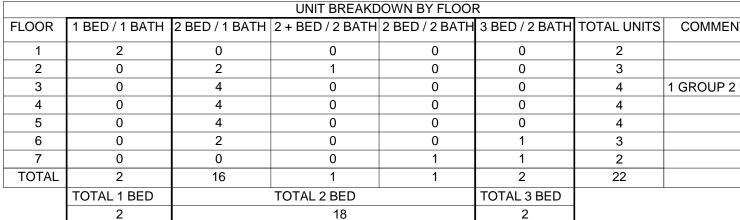

Project number18132Drawn byAuthorDate2/18/2022Checked byCheckerScaleAs indicated



1st Floor Plan




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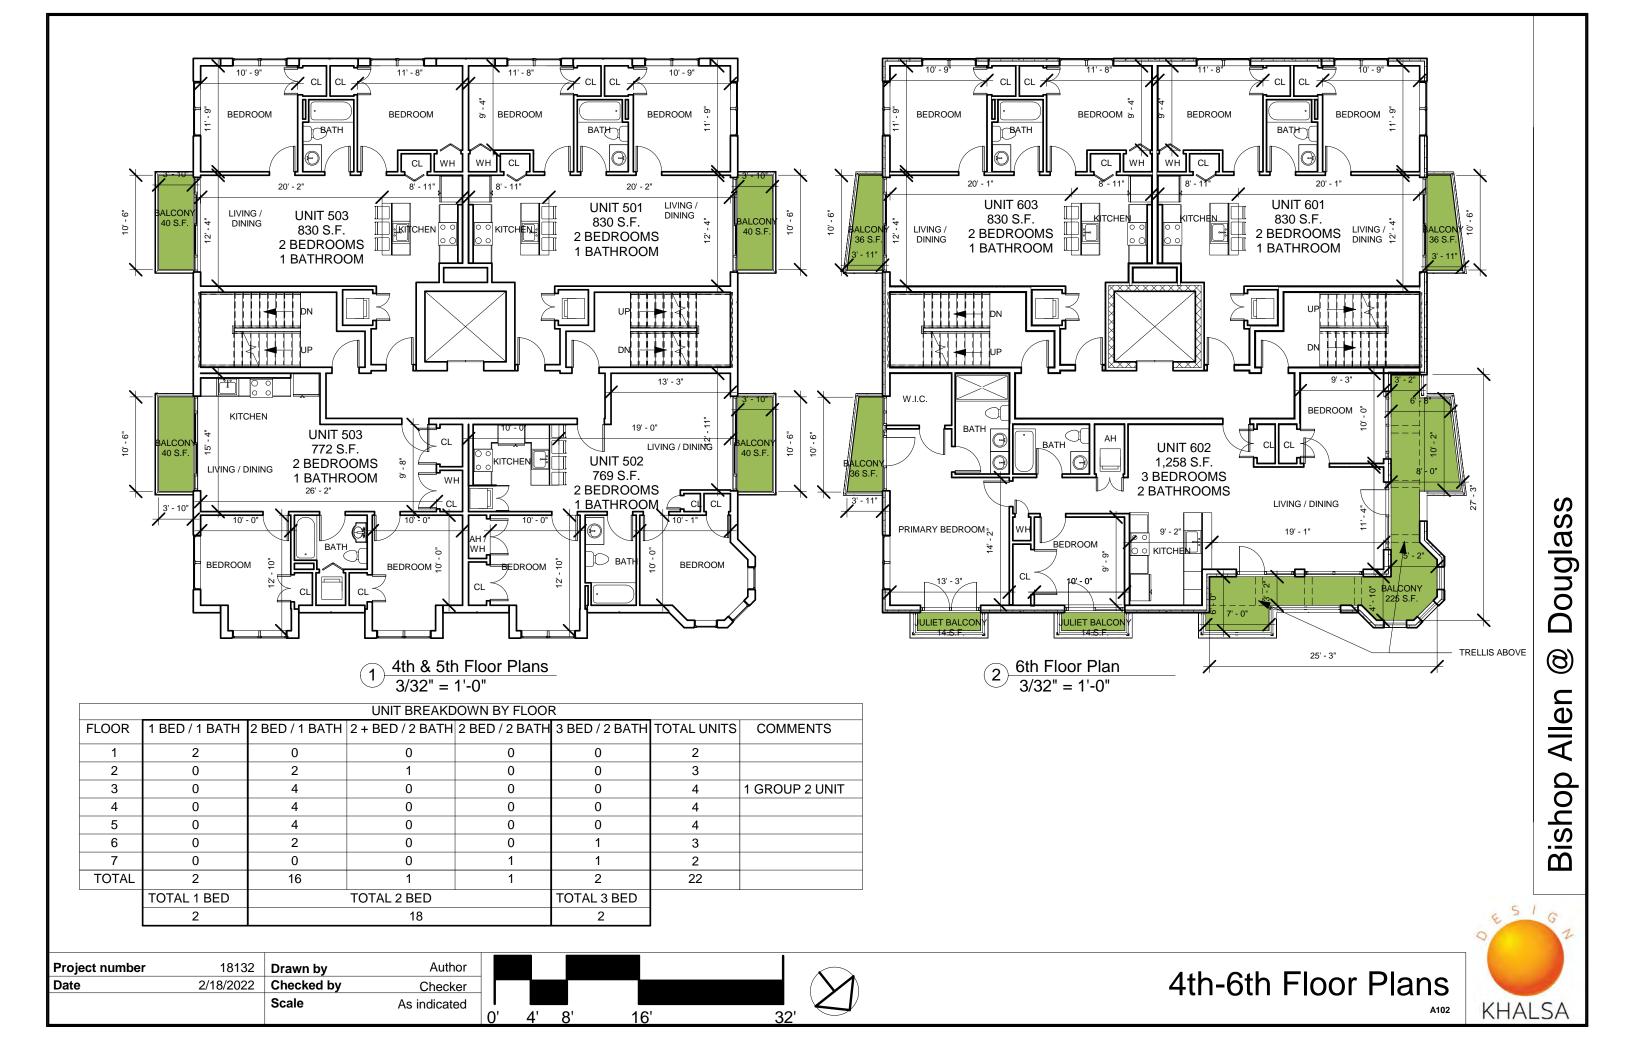
ouglas


(B)


Alle

Bishop



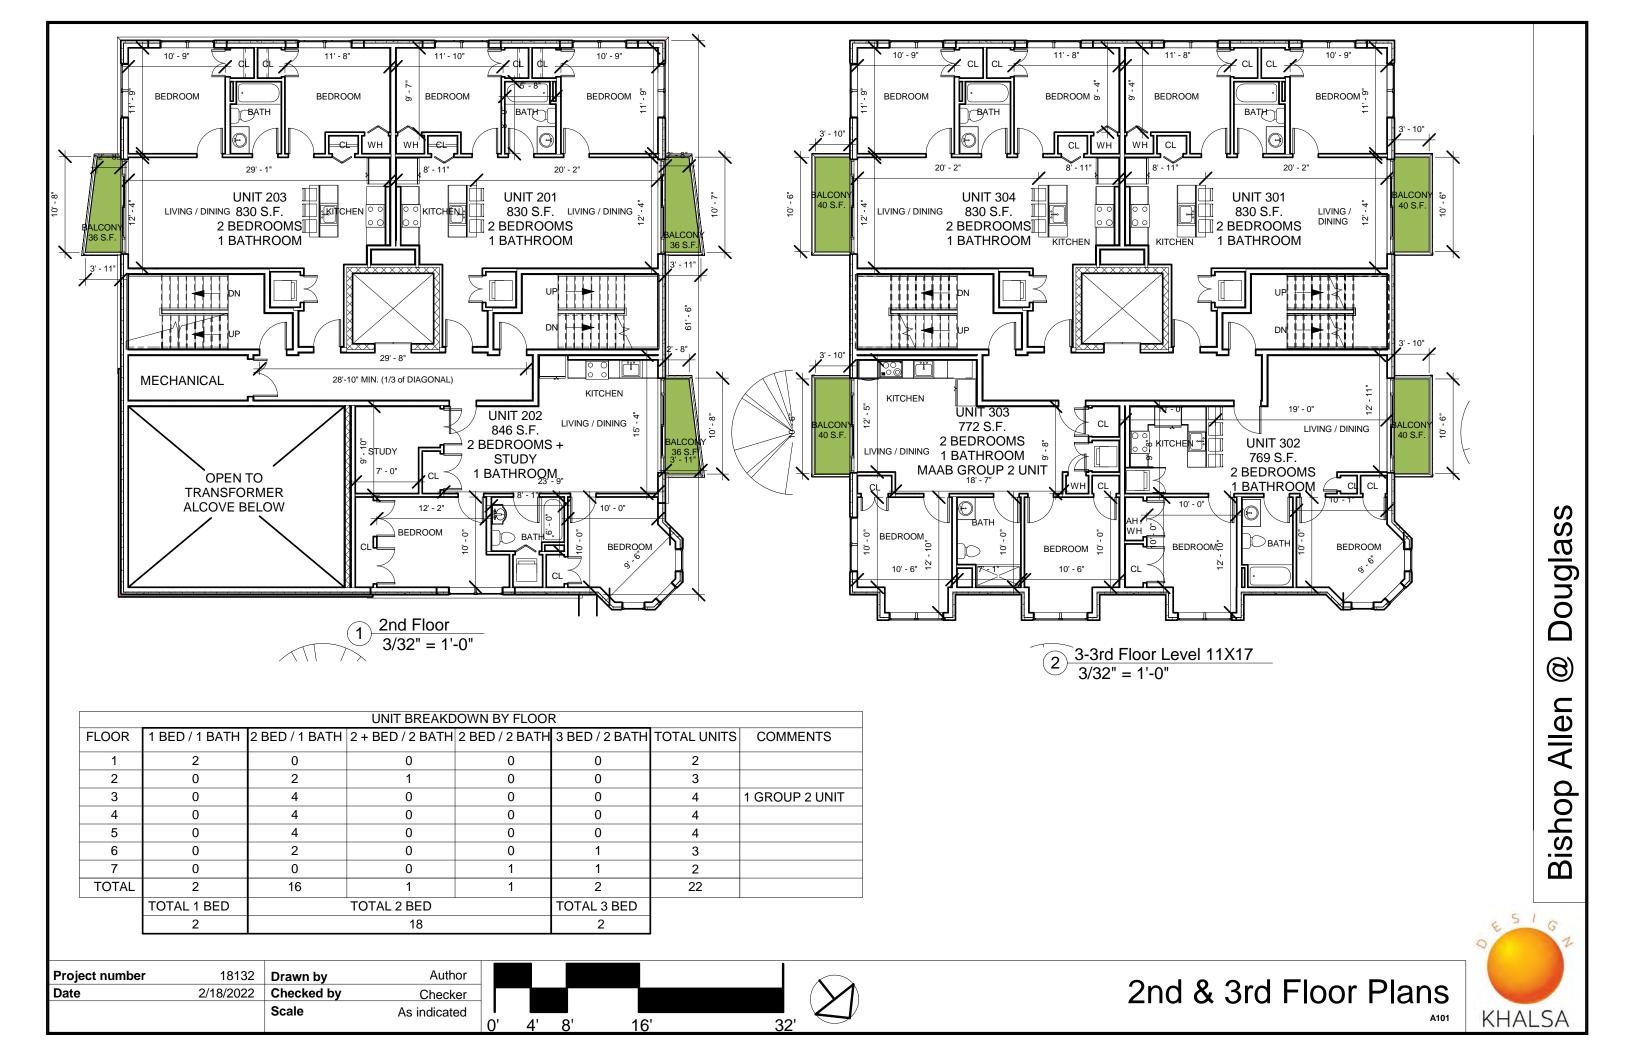

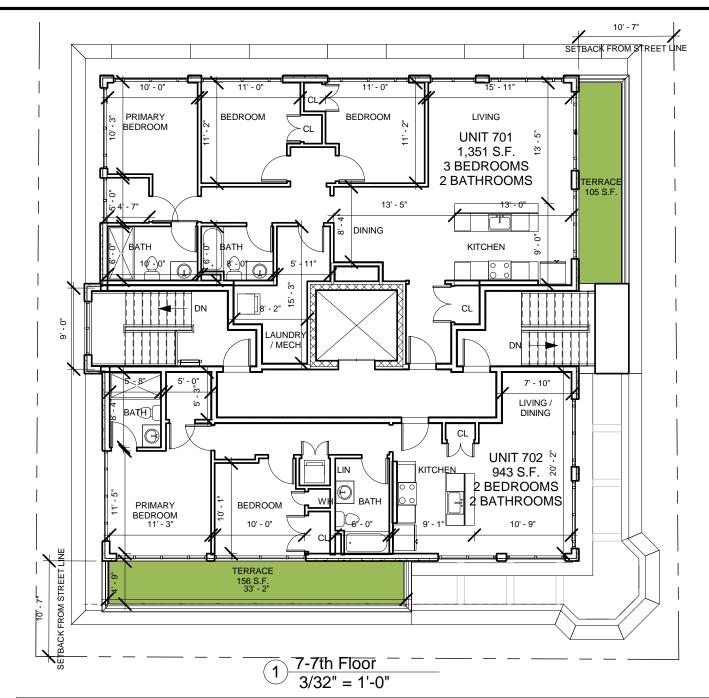


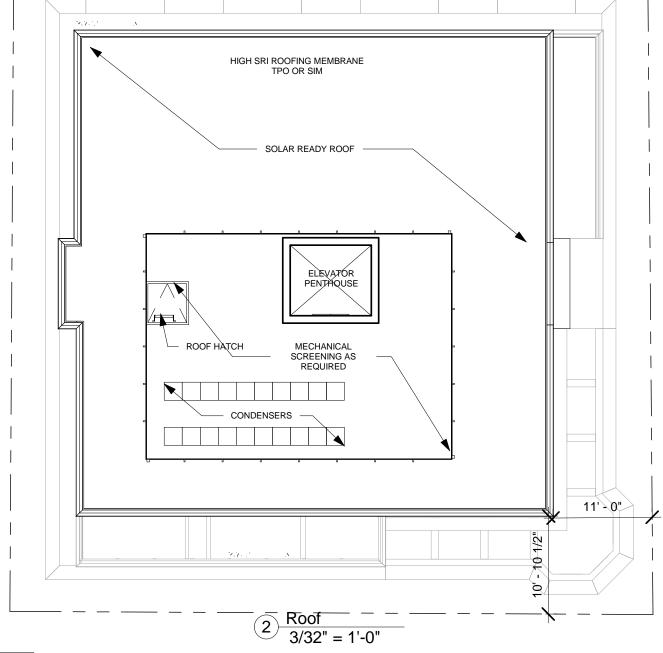

UNIT BREAKDOWN BY FLOOR							
FLOOR	1 BED / 1 BATH	2 BED / 1 BATH	2 + BED / 2 BATH	2 BED / 2 BATH	3 BED / 2 BATH	TOTAL UNITS	COMMENTS
1	2	0	0	0	0	2	
2	0	2	1	0	0	3	
3	0	4	0	0	0	4	1 GROUP 2 UNIT
4	0	4	0	0	0	4	
5	0	4	0	0	0	4	
6	0	2	0	0	1	3	
7	0	0	0	1	1	2	
TOTAL	2	16	1	1	2	22	
	TOTAL 1 BED		TOTAL 2 BED		TOTAL 3 BED		

18

Project number	18132	Drawn by	Author
Date	2/18/2022	Checked by	Checker
		Scale	As indicated

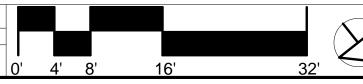

2




7th Floor & Roof Plan






Project number 18132 **Drawn by** ERS 2/18/2022 Checked by JSK Scale As indicated

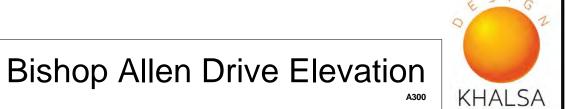



1 Douglass Street (Northwest) Elevation 1/16" = 1'-0"

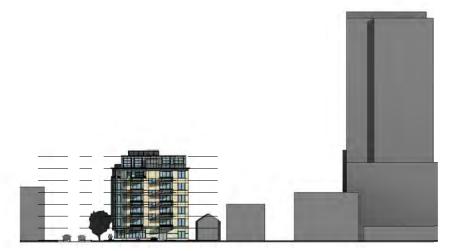

Project number	18132	Drawn by	Author
Date	2/18/2022	Checked by	Checker
		Scale	As indicated







Project number	18132	Drawn by	Author
Date	2/18/2022	Checked by	Checker
		Scale	As indicated





Left Side (Southeast) Elevation
1/16" = 1'-0"



Project number	18132	Drawn by	Author
Date	2/18/2022	Checked by	Checker
		Scale	As indicated



1. CEMENTICIOUS PANELS WITH REGLETS


JSK

As indicated

Scale




FRONT LEFT SIDE OF BUILDING (BISHOP ALLEN DRIVE)

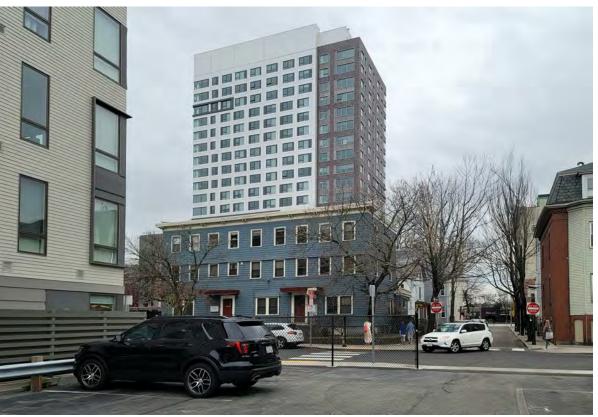


FRONT OF 50 BISHOP ALLEN DRIVE



RIGHT SIDE OF BUILDING (DOUGLASS ST)

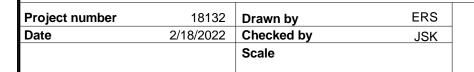

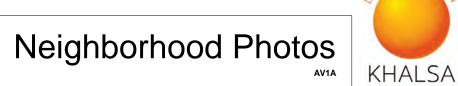



1. VIEW OF SITE

18132 **Drawn by**

Scale

2/18/2022 Checked by


Project number



ERS

JSK

4. VIEW UP BISHOP ALLEN DRIVE (BETWEEN DOUGLASS & NORFOLK STREETS)

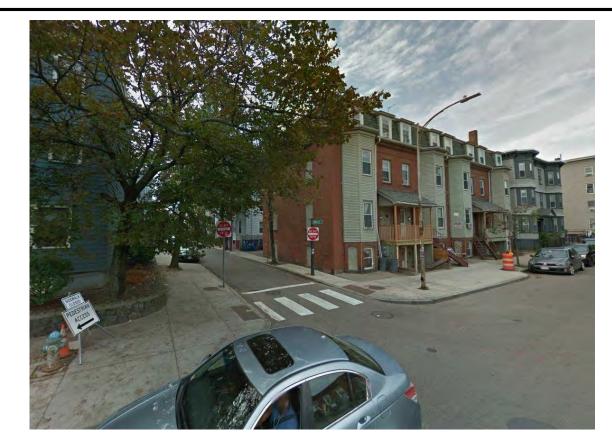

2. VIEW TO RIGHT OF SITE



5. VIEW UP DOUGLASS ST (TOWARD BISHOP ALLEN DR)



PRIMARY MARKET CENTRAL STRUCTURE: 195'

B:

(CORNER OF BISHOP ALLEN DRIVE & COLUMBIA STREET): 70'


C: 47 BISHOP ALLEN DRIVE AKA UNION HOUSE APARTMENTS: 45'









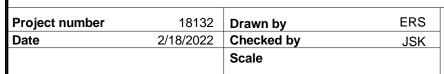









NEW BUILDING ON OPPOSITE CORNER


SITE

Project number	18132	Drawn by	ERS
Date	2/18/2022	Checked by	JSK
		Scale	







MARKET CENTRAL PROJECT FROM MASSACHUSETTS AVENUE AT SIDNEY ST

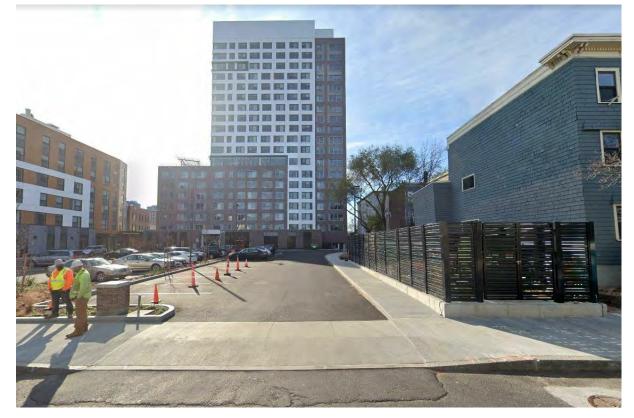

MARKET CENTRAL PROJECT FROM BISHOP ALLEN DRIVE

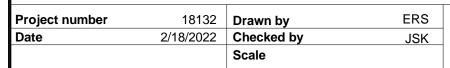

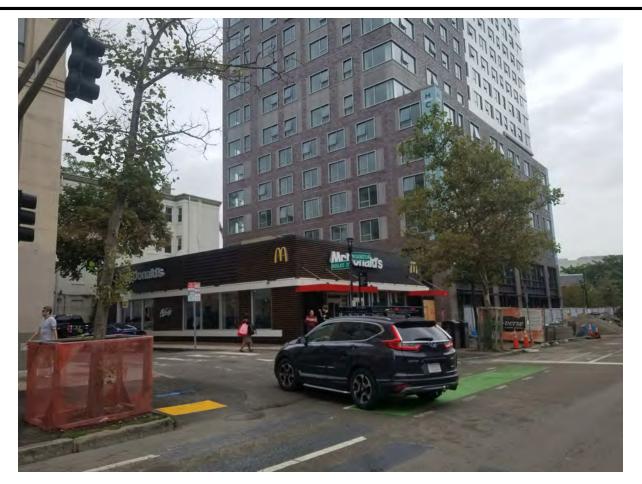

MARKET CENTRAL PROJECT FROM MASSACHUSETTS AVENUE AT BROOKLINE ST



10 ESSEX ST





1. VIEW LOOKING UP BISHOP ALLEN DRIVE






3. VIEW TOWARD DOUGLASS ST FACADE



4. VIEW FROM MASSACHUSETTS AVENUE LOOKING TOWARDS BISHOP ALLEN DR

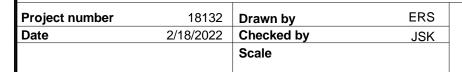






 Project number
 18132
 Drawn by
 ERS

 Date
 2/18/2022
 Checked by
 JSK

 Scale
 1" = 100'-0"

Rendering 1

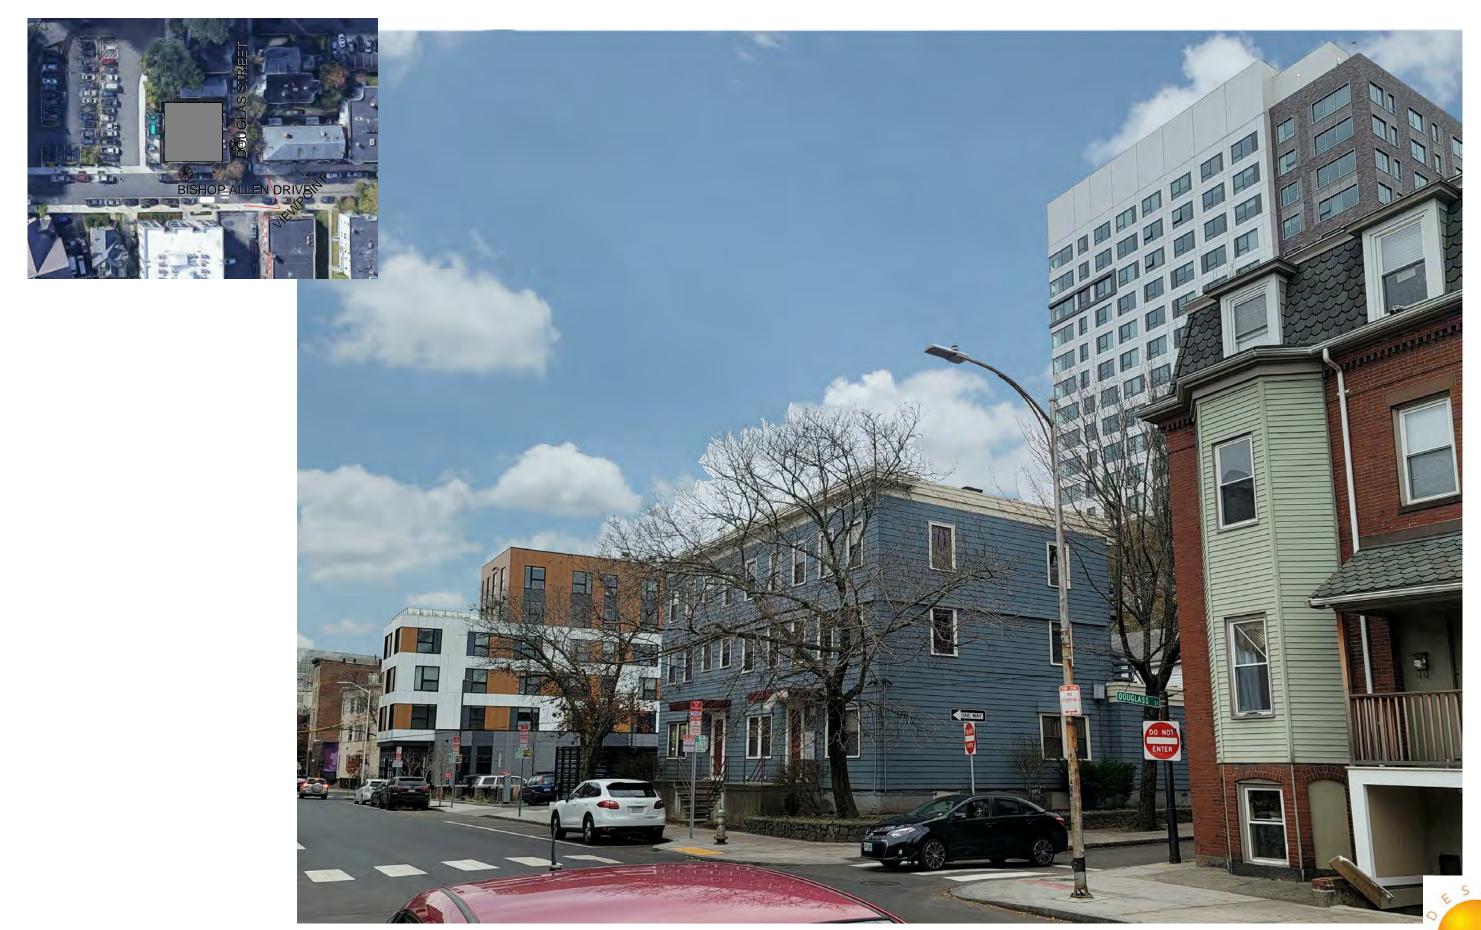


 Project number
 18132
 Drawn by
 ERS

 Date
 2/18/2022
 Checked by
 JSK

 Scale
 1" = 100'-0"

Rendering 1 - Existing

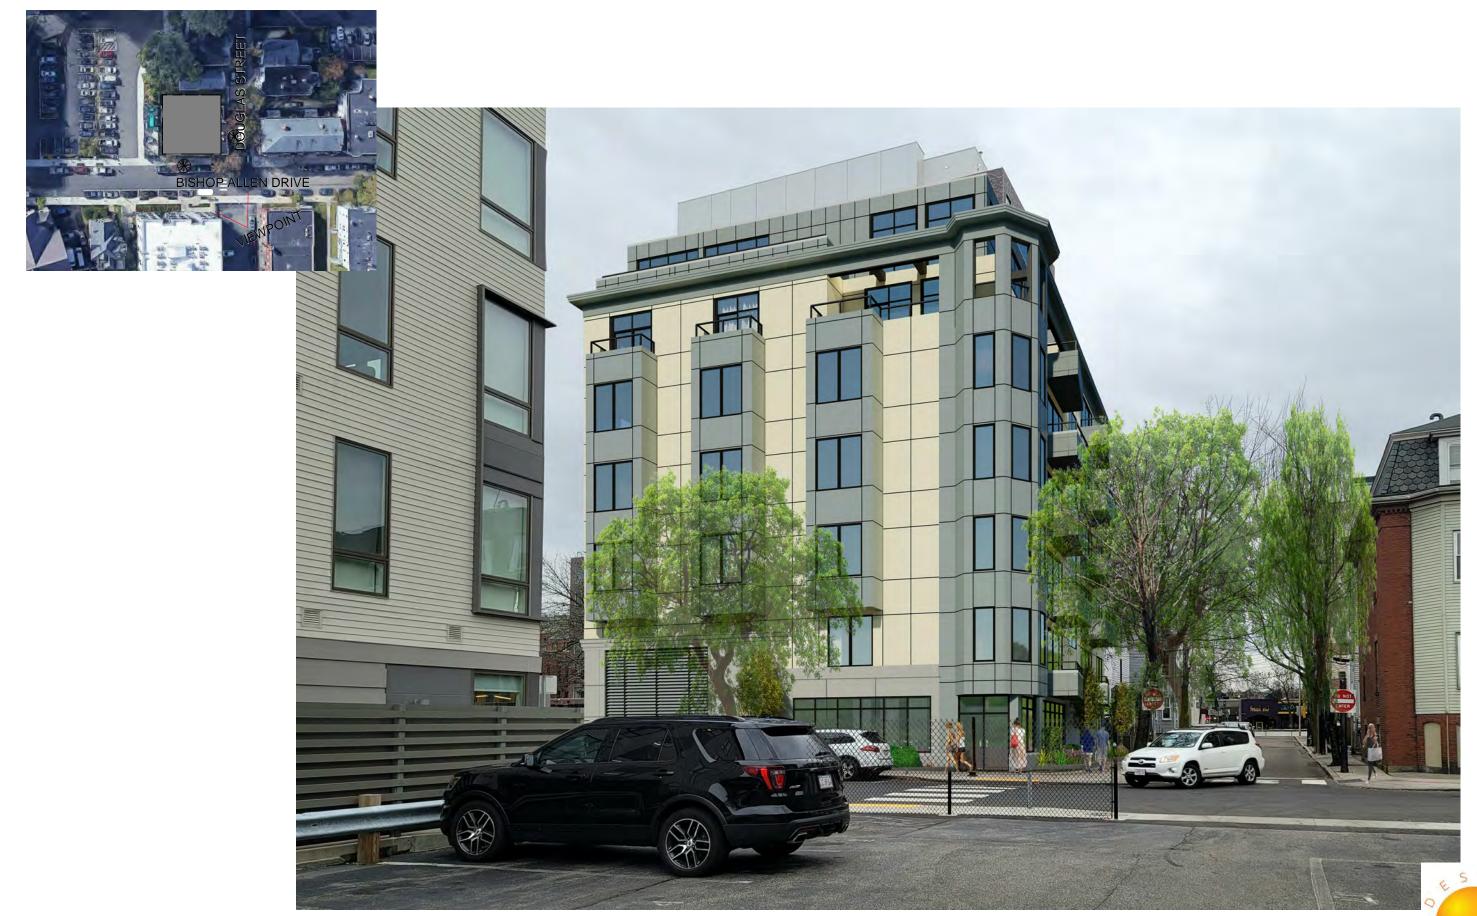


 Project number
 18132
 Drawn by
 ERS

 Date
 2/18/2022
 Checked by
 JSK

 Scale
 1" = 100'-0"

Rendering 2

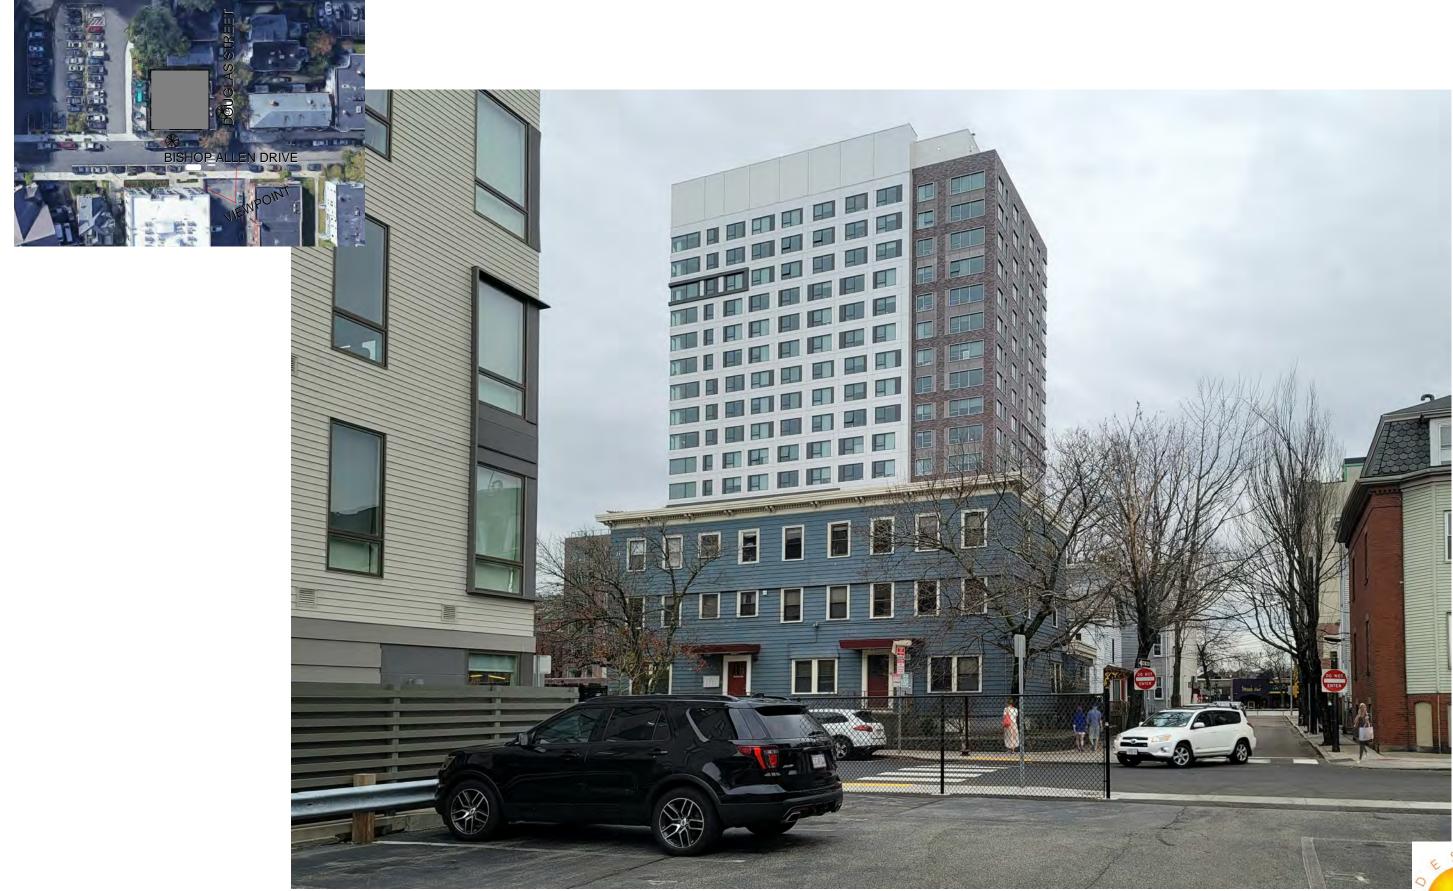


 Project number
 18132
 Drawn by
 ERS

 Date
 2/18/2022
 Checked by
 JSK

 Scale
 1" = 100'-0"

Rendering 2 - Existing



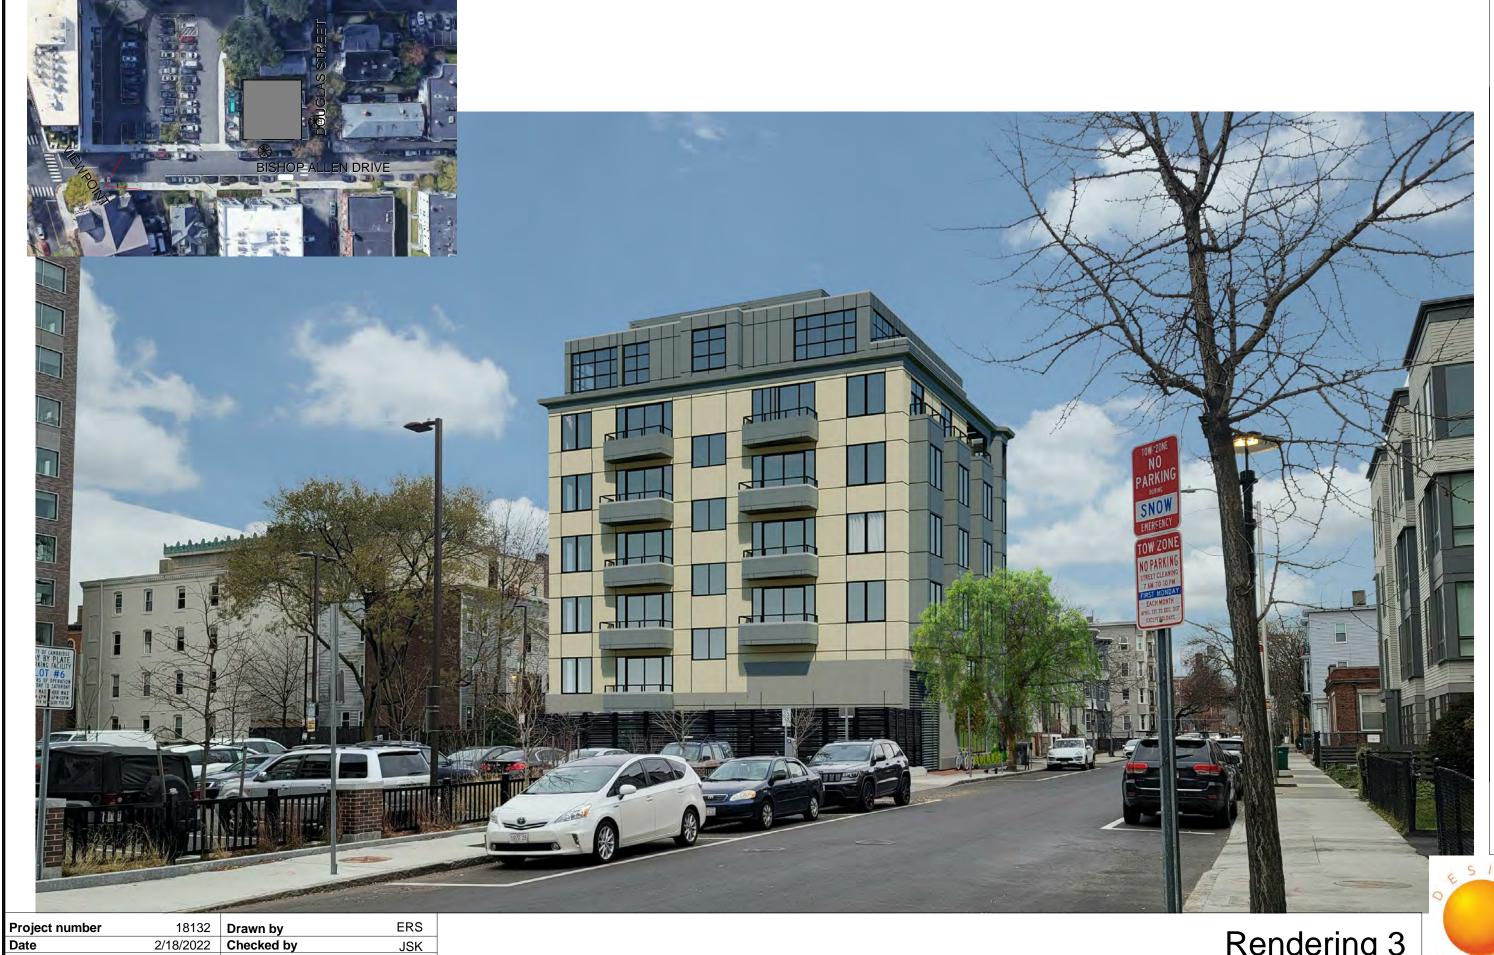

JSK

1" = 100'-0"

Scale

Rendering 3



JSK 1" = 100'-0"

Scale

Rendering 3 - Existing

DEED DESCRIPTION 48-50 BISHOP ALLEN DRIVE

A CERTAIN PARCEL OF LAND WITH THE BUILDINGS THEREON SITUATED IN CAMBRIDGE, BEING NOW NUMBERED 44 1/2-50 INCLUSIVE AUSTIN STREET AND BEING SHOWN AS LOT B ON A PLAN ENTITLED 'SUBDIVISION OF LAND IN CAMBRIDGE BELONGING TO LUCY A. KAULBACK" DATED DECEMBER 17, 1946, BY DONALD J. REARDON, SURVEYOR, RECORDED BOOK 7080, PAGE 467, BEING BOUNDED AND DESCRIBED S FOLLOW:

NORTHEASTERLY: BY SAID AUSTIN STREET, SEVENTY—ONE AND $\frac{35}{600}(71.35)$ FEET;

NORTHWESTERLY: BY DOUGLAS STREET, SEVENTY—ONE AND #8 (71.99) FEET;

SOUTHWESTERLY: BY LOT a ON SAID PLAN, FIFTY-TWO (52) FEET;

NORTHWESTERLY: AGAIN BY SAID LOT A, TWO AND 元 (2.7) FEET;

SOUTHWESTERLY: AGAIN BY LOT A, EIGHTEEN (18) FEET; AND

SOUTHEASTERLY: BY LAND OF OWNERS UNKNOWN, SEVENTY FOUR AND $\frac{67}{60}$ (74.67)

CONTAINING 5150 SQUARE FEET OF LAND.

FOR TITLE SEE DEED OF GEORGE ROTHMAN AND JAMES M. CURRAN DATED DECEMBER 27, 1985 RECORDED WITH MIDDLESEX SOUTH REGISTRY OF DEEDS IN BOOK 16669,

SURVEYOR'S DESCRIPTION 48-50 BISHOP ALLEN DRIVE

NORTHWESTERLY: BY BISHOP ALLEN DRIVE, SEVENTY—ONE AND \(\frac{35}{60}\)(71.35) FEET;

SOUTHWESTERLY: BY DOUGLAS STREET, SEVENTY-TWO AND 766 (72.26) FEET;

SOUTHEASTERLY: BY LAND NOW OR FORMERLY FULLER AND MCAVINNEY, FIFTY-TWO (52) FEET;

SOUTHEASTERLY: AGAIN BY LAND NOW OR FORMERLY FULLER AND MCAVINNEY, TWO AND $\frac{7}{10}$ (2.7) FEET;

SOUTHWESTERLY: AGAIN BY LAND NOW OR FORMERLY FULLER AND MCAVINNEY, EIGHTEEN (18) FEET; AND


NORTHEASTERLY: BY LAND NOW OR FORMERLY CITY OF CAMBRIDGE, SEVENTY FOUR AND 📆 (74.67) FEET.

CONTAINING 5158 SQUARE FEET OF LAND.

GENERAL NOTE:


- NO EVIDENCE OF CEMETERIES.
- LEGAL DESCRIPTION FORMS MATHEMATICALLY CLOSED FIGURE WITH OUT GAPS, GORES OR OVERLAPS.
- THE PROPERTY HAS DIRECT ACCESS FROM THE NORTH, TO BISHOP ALLEN DRIVE A DEDICATED PUBLIC STREET AND THE WEST TO DOUGLAS STREET A DEDICATED PUBLIC
- NO OBSERVED EVIDENCE OF CURRENT EARTH MOVING WORK, BUILDING CONSTRUCTION OR BUILDING ADDITIONS.
- NO PROPOSED CHANGES IN STREET RIGHT OF WAY LINES. NO OBSERVED EVIDENCE OF RECENT STREET OR SIDEWALK CONSTRUCTION OR REPAIRS.
- NO OBSERVED EVIDENCE OF SIDE USE AS A SOLID WASTE DUMP, SUMP OR SANITARY LANDFILL.
- BENCHMARK: CITY OF CAMBRIDGE DATUM
- PARCEL ID MAP 91-LOT 180

EASEMENTS:

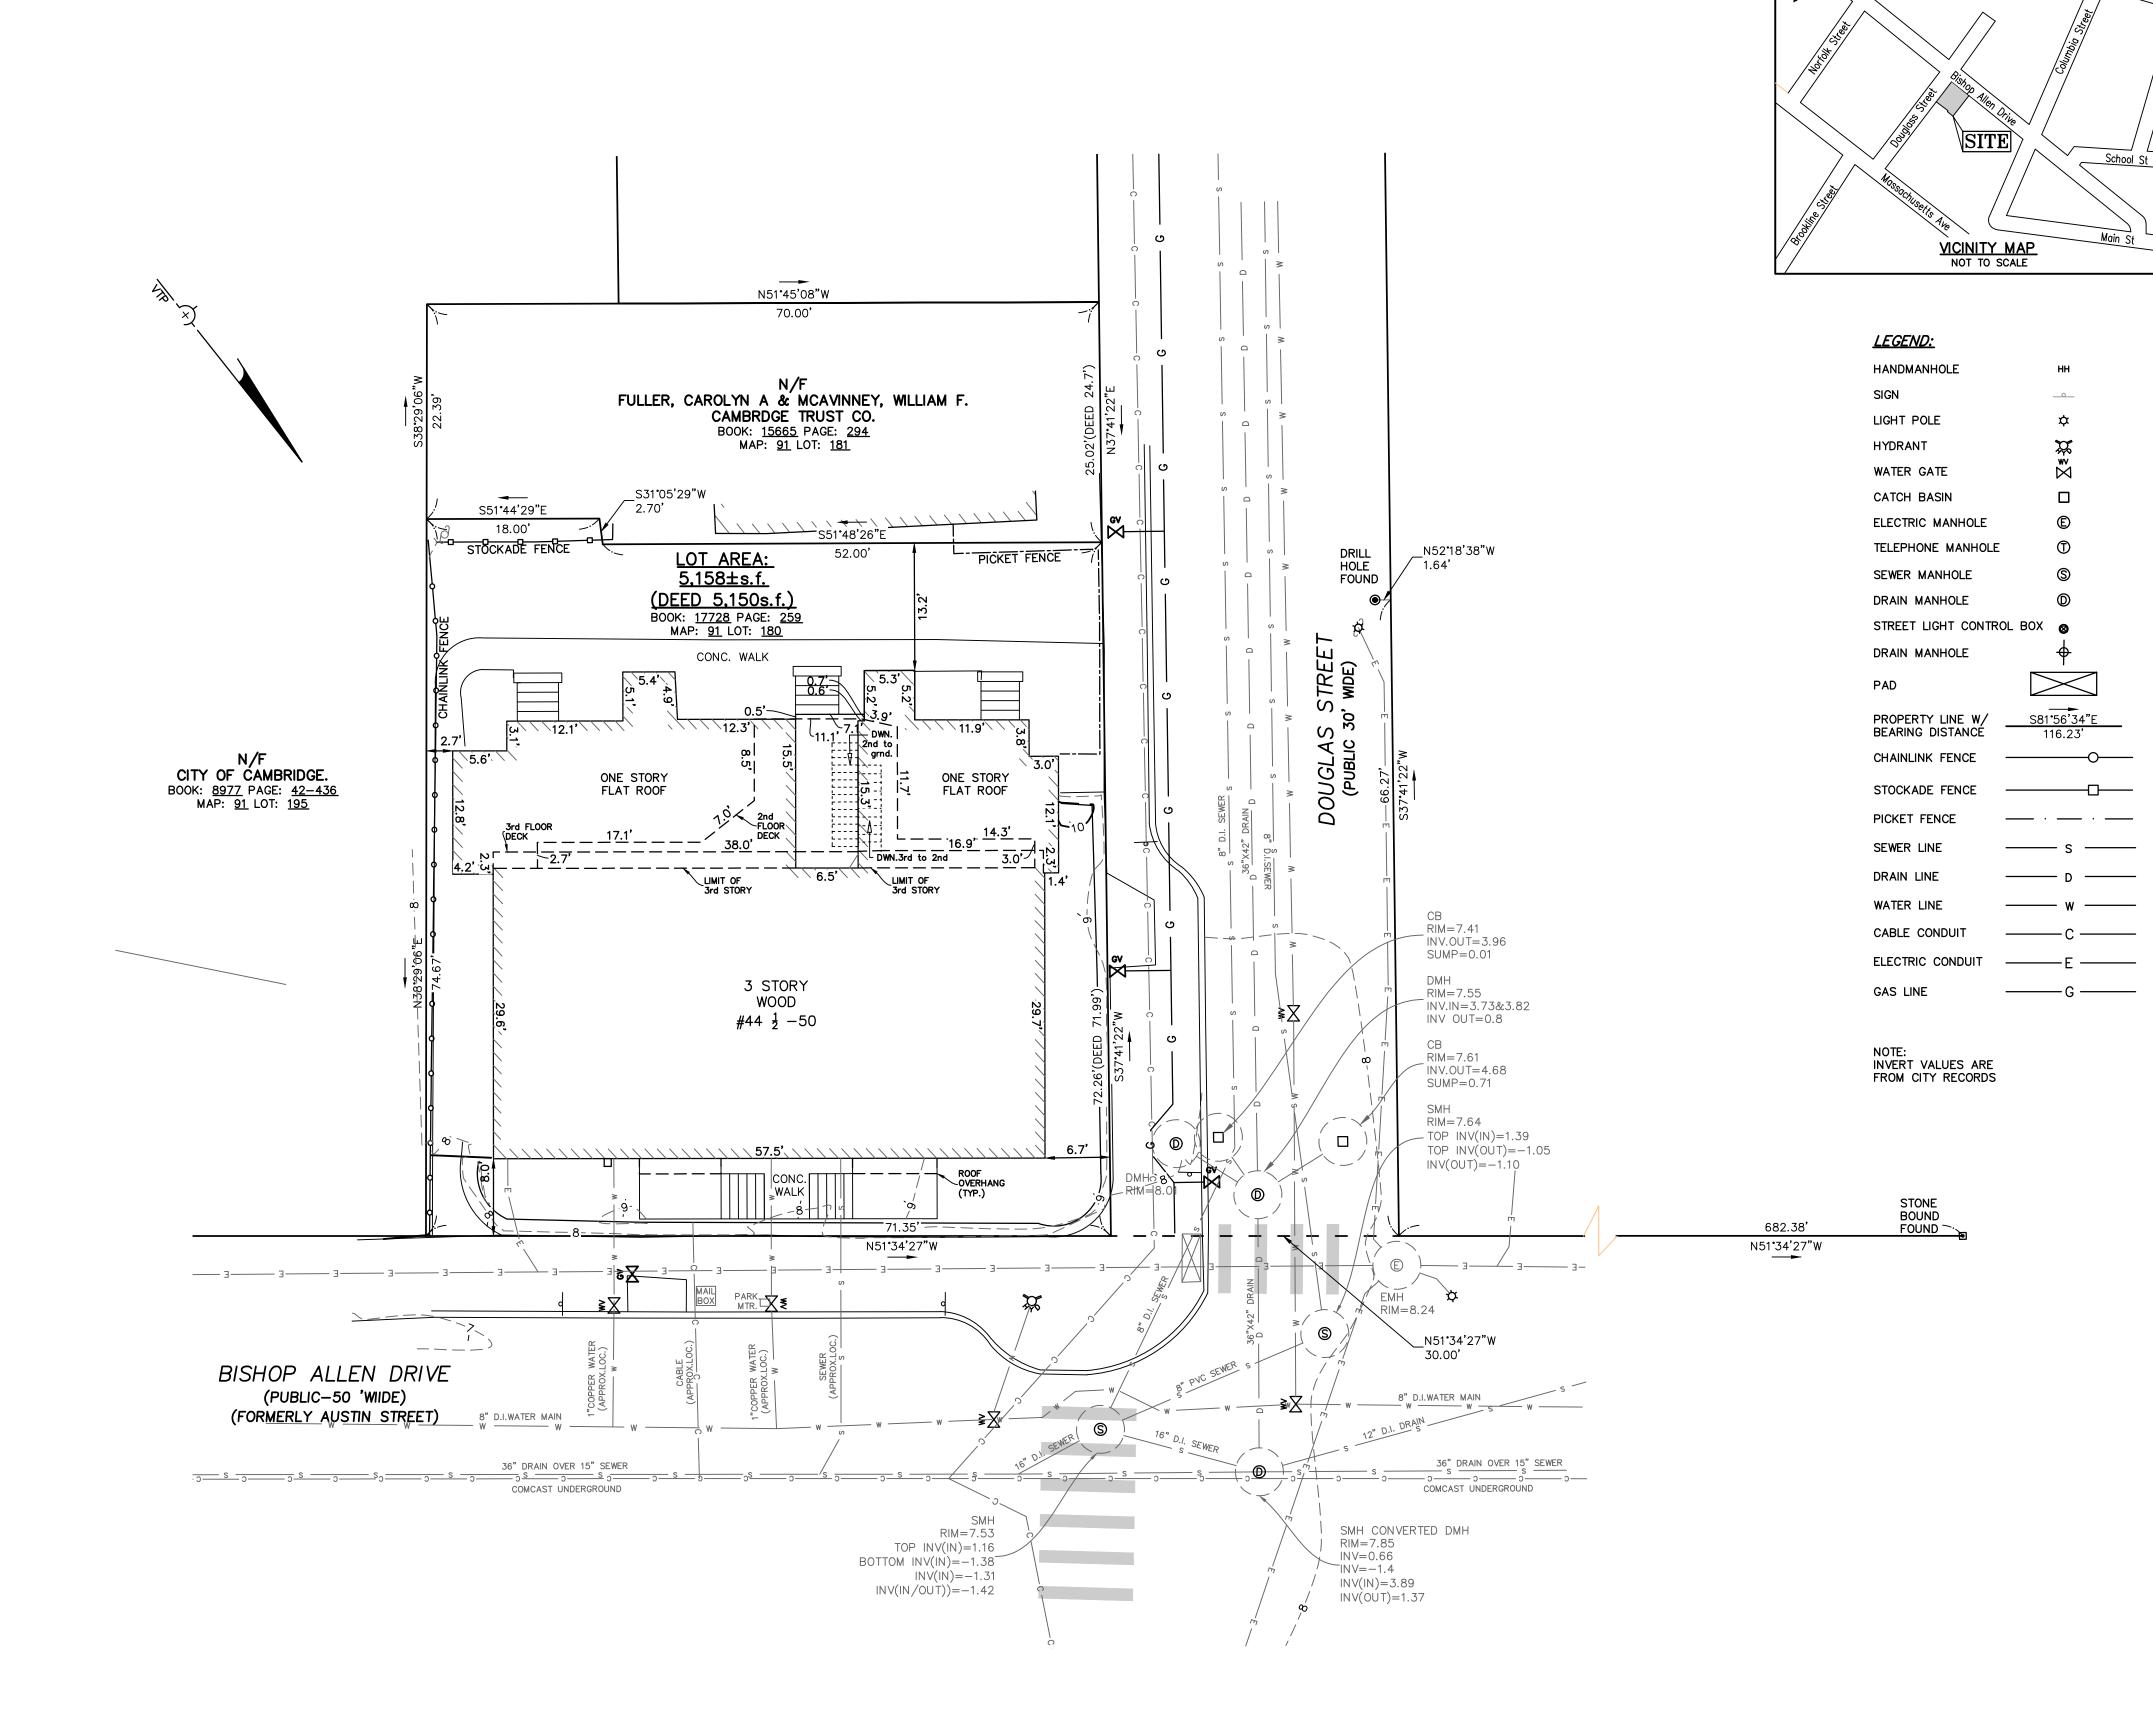

FLOOD ZONE:

SAID DESCRIBED PROPERTY IS LOCATED WITHIN AN AREA HAVING A ZONE DESIGNATION "ZONE X" DETERMINED FROM F.E.M.A. ON FLOOD INSURANCE RATE MAP No. <u>25017C0576E</u>, EFFECTIVE JUNE 4, 2010.

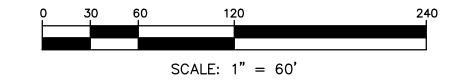

UTILITY NOTE:

UNDERGROUND LOCATIONS AS SHOWN HEREON ARE TAKEN FROM AVAILABLE RECORD INFORMATION AND ARE APPROXIMATE ONLY. BEFORE PLANNING ANY CONSTRUCTION THE VARIOUS UTILITY COMPANY ENGINEERING DEPARTMENTS SHOULD BE CONSULTED.

TOPOGRAPHIC SITE PLAN

 $44 \frac{1}{2} -50$ BISHOP ALLEN DRIVE CAMBRIDGE, MASSACHUSETTS

OWNER: GEORGE ROTHMAN & STUART J. ROTHMAN, TRUSTEES OF STU-LIN FAMILY TRUST CAMBRIDGE, MASSACHUSETTS

<u>DATE:</u> 09/27/2018 <u>REVISED:</u> 05/31/2019 <u>SCALE:</u> 1"=10' <u>PROJECT:</u> 218169 <u>SHEET:</u> 1 OF 1

VTP ASSOCIATES, INC. LAND SURVEYORS — CIVIL ENGINEERS 132 ADAMS STREET 2ND FLOOR SUITE 3 NEWTON, MA. 02458 (617) 332–8271 FAX: (617) 969–2330

RESERVED FOR REGISTRY USE

<u>Required</u>

300/DU*

None

None

None

None None

*Lot Size-min area/DU-minimum allowed

ratio of parcels lot area, expressed in feet,

divided by the number of dwelling units on

2.75/3.0

PLAN REFERENCE:

DEED REFERENCE:

BB- BUSINESS B

Max. Height Stories

Min. Front Setback

Min. Side Yard

Min. Rear Yard

Min. Usable Open space

Lot Size

Lot Width

Max. F.A.R.

PARCEL BLOCK MAP: 91

BOOK: <u>17728</u> PAGE: <u>259</u>

ZONING REQUIREMENTS:

PLAN BOOK: <u>7080</u> PAGE: <u>467</u>

