# HARBOR ISLAND CONDOS L+M OCEANSIDE EXTERIOR RENOVATIONS





# HARBOR ISLAND CONDOS

BUILDING L+M OCEANSIDE EXTERIOR RENOVATIONS

I HARBOR DR. N, ST HELENA ISLAND, SC 29920

Р	REV#	DESCRIPTION	DATE
	1	Addendum #1	9/24/2024
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М		STEVEN STOWERS Beaufort, SC No.9596 8 29 2 4  STEVEN STOWERS No.101308	) )

FOR CONSTRUCTION

#### PROPERTY INFORMATION

ADDRESS: 1 Harbor Dr N, St Helena Island, SC 29920 PIN: R300 020 00A 121A 0000 (L), R300 020 00A 121B 0000 (M)

Zoning: PUD (Existing Planned Unit Development)

#### DRAWING INDEX Sheet Number Sheet Issue Date Sheet Name GENERAL 09/24/24 COVER SHEET 09/24/24 SITE PLAN G002 PROJECT NOTES 09/24/24 GENERAL - BUILDING L COVER SHEET 09/24/24 09/24/24 BUILDING L 3D VIEWS DEMOLITION - BUILDING L DEMO PLANS - BUILDING L 09/24/24 09/24/24 DEMO ELEVATIONS - BUILDING L STRUCTURAL - BUILDING L S001 STRUCTURAL NOTES 09/24/24 PORCH FRAMING PLANS - BUILDING L 09/24/24 PORCH SECTIONS - BUILDING L 09/24/24 ARCHITECTURAL - BUILDING L WALL, DOOR, AND WINDOW TYPES - BUILDING L 09/24/24 FLOOR PLANS - BUILDING L - FIRST FLOOR 09/24/24 09/24/24 FLOOR PLANS - BUILDING L - 2ND & 3RD FLOOR 09/24/24 BUILDING L ELEVATIONS WALL SECTIONS - DECK TYPE 1 - BUILDING L 09/24/24 WALL SECTIONS - DECK TYPE 2 - BUILDING L 09/24/24 WALL SECTIONS - DECK TYPE 3 - BUILDING L 09/24/24 WINDOW, WALL, AND DOOR DETAILS 09/24/24 GENERAL - BUILDING M 09/24/24 COVER SHEET BUILDING M 3D VIEWS 09/24/24 DEMOLITION - BUILDING M DEMO PLANS - BUILDING M 09/24/24 DEMO ELEVATIONS - BUILDING M 09/24/24 $\sim$ STRUCTURAL - BUILDING M STRUCTURAL NOTES 09/24/24 PORCH FRAMING PLANS - BUILDING M \$101 09/24/24 S301 PORCH SECTIONS - BUILDING M 09/24/24 09/24/24 WALL, DOOR, AND WINDOW TYPES 09/24/24 FLOOR PLANS - BUILDING M - FIRST FLOOR A102 FLOOR PLANS - BUILDING M - SECOND & THIRD 09/24/24 09/24/24 BUILDING M ELEVATIONS WALL SECTIONS - DECK TYPE 1 - BUILDING M 09/24/24 WALL SECTIONS - DECK TYPE 2 - BUILDING M 09/24/24 SECTION DETAILS - BUILDING M 09/24/24 A504 WINDOW, WALL, AND DOOR DETAILS 09/24/24

# Project Location

VICINITY MAP

LOCATION MAP

# CONTACT INFORMATION ARCHITECT - Architecture 101

Contact: Morgan Cleek Role: Project Manager Phone: (937)-416-9160 Email: morgan@a101.design

STRUCTURAL - 29e6

Contact: Andy Richardson, P.E. Email: andy@29e6.co

CONTRACTOR - TBD Contact: TBD Role: TBD

#### ABBREVIATIONS



•	, , , , , , , , , , , , , , , , , , , ,
AFF	ABOVE FINISH FLOOR
A/C	AIR CONDITIONING
AHU	AIR HANDLING UNIT
CJ	CONTROL JOINT
CL	CENTERLINE
CLG	CEILING
CMU	CONCRETE MASONRY UNIT
CONT	CONTINUOUS
CT	CERAMIC TILE
DIA	DIAMETER
DIM	DIMENSION
DN	DOWN
DS	DOWNSPOUT
DW	DISHWASHER
EA	EACH
EQ	EQUAL
EQUIP	EQUIPMENT
EXT	EXTERIOR
FD	FLOOR DRAIN
FF	FINISH FLOOR
FFE	FINISH FLOOR ELEV.
FIN	FINISH
FT	FEET
GA	GAUGE
GWB	GYPSUM WALLBOARD
НВ	HOSE BIBB
INT	INTERIOR

MANUFACTURER MISCELLANEOUS MASONRY OPENING NOT APPLICABLE NOT IN CONTRACT ON CENTER OPPOSITE HAND ORIENTED STRAND B PERFORATED PRESSURE TREATED REQUIRED SQUARE FEET SPECIFICATION STANDARD TO BE DETERMINED TONGUE & GROOVE TEMPORARY TELEVISION TYPICAL **UNDER COUNTER** WASHER/DRYER WOOD WATER HEATER



#### COVER SHEET

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#### PROJECT NOTES

#### **GENERAL CONDITIONS:**

- A. Haul off all construction debris to an approved landfill at regular intervals. Do not allow construction debris to accumulate on site. Dumpsters may be used within tenced in areas, but must be fully covered at all times. 1
- Water can be used from hose bibbs on Building L or M. Coordinate connections with Architect. C. Electricity can be used by building's house panel and general service receptacles. Do not used tenant's receptacles for
- construction activities. A temporary panel may be provided at the GC's expense.
- D. Provide construction site coordination plan indicating locations and dates of affected construction areas, including
- parking. If a temporary construction office will be located onsite, provide location, fencing, and screening on plan. E. Provide a moisture protection plan indicating how unit openings will be protected from inclement weather during
- Use of Owner's existing toilet facilities is not permitted. Provide temporary toilets, wash facilities, and drinking water for construction personnel
- Provide one Project Identification Sign. No unauthorized signs are permitted.
- Project site security is the Contractor's responsibility.
- Provide a hard copy and digital binder with all maintenance and warranty information for all products installed as part of this project.
- General Contractor will provide a one-year warranty of all work installed as part of this project. This warranty stands above
- all other warranties on individual products and assemblies. General Contractor should include all expenses for Contractor Gate passes in base bid. Passes are \$10 / day + \$25 for

- PAYMENT PROCEDURES: A. Applications for progress payments will be made by the 25th of each month utilizing the AIA G702/G703 Standard Application for Payment form.
- Owner will withhold 10% retainage on each progress payment. Once the project has reached fifty percent of the contract value, no further retainage will be withheld if the Owner agrees that the project is on schedule.

#### UNIT PRICING: THE FOLLOWING UNIT PRICES ARE IN AFFECT FOR THIS PROJECT

- A. REPLACEMENT OF DAMAGED SHEATHING: a. The Contractor is instructed to replace all existing sheathing at all walls requiring siding replacement.
  - REPLACEMENT OF DAMAGED SHEATHING, STUDS, AND INSULATION: a. The Contractor is instructed to include 300 SF of damaged areas where the sheathing, studs, and insulation must be replaced for both Building's L & M.
- b. Additional sheathing, wall studs, and insulation requiring replacement will be compensated at \$6/SF.

#### **CONSTRUCTION PROGRESS:** A. General Contractor will make diligent progress on the construction to meet the Owner's required completion date of April

- Allowed working hours within the Community are 7:30 AM 6:00 PM, Monday Friday. No construction activities are allowed on Sundays and limited hours may be allowed on Saturday within the Community.
- CATCH UP: Should at any point in the project, the Architect and Owner agree that the progress of the work is more than two weeks behind the Contractor's Proposed Schedule, the Contractor will be required to work additional hours / days to bring the progress of the work back in compliance with the proposal progress schedule.

#### **CONSTRUCTION PROGRESS DOCUMENTATION:**

- A. Gantt Chart Schedule: Submit a comprehensive, fully developed, horizontal, Gantt-chart-type, Contractor's construction schedule within 30 days of date established for the Notice to Proceed. Base schedule on the startup construction schedule and additional information received since the start of Project.
- Include critical milestones for start of construction, critical path, initiation and completion of construction for each group of units, and completion of all units, along with any additional milestones that are critical to project delivery.

Punch List and Final Completion: Include not more than 30 days for completion of punch list items and final completion.

6. **SUBMITTALS**: A. Digital submittals are required to be submitted for Architect's approval for the following products:

- a. PRODUCT DATA:
  - Windows and Doors
  - Metal Flashing Flexible Flashing
  - Fluid-Applied Waterproofing
  - Fiber-Cement Siding and Trim Paint and Stains
  - Composite Decking Products Insect Screens
  - Gutters and Downspouts
  - Electrical Fixtures
  - b. SHOP DRAWINGS: Timber Railings
  - Windows and Doors
  - Gutters and Downspouts
  - c. DELEGATED DESIGN (SIGNED AND SEALED ENGINEERING WILL BE PROVIDED BY CONTRACTOR) Timber Railings
  - d. QUALIFICATIONS DATA (INSTALLER MUST SUBMIT QUALIFICATIONS FOR EACH PRODUCT LISTED BELOW):
  - Fluid-Applied Waterproofing
  - Windows and Doors
  - Composite Decking Products
  - Fiber-Cement Siding
  - . Minimum 2 years' experience with installation of similar products.
  - e. WARRANTY (PROVIDE SAMPLE WARRANTIES FOR APPROVAL FOR THE FOLLOWING PRODUCTS):
- Windows and Doors Fiber-Cement Siding and Trim
- **SUBSTITUTIONS:**

#### A. All named products included in this project are considered to be "or approved equal".

- Submit all substitution requests to Architect in writing for approval prior to bid.
- Note all details affected by substitution in submission and any additional building elements affected by substitution. Following the Bid, General Contractor will indicate all cost ramifications for substitutions within submissions.

#### <u>SITEWORK:</u> Take special precautions and care during construction with all landscaping.

- Provide cyclone fencing with screening around all staging and storage areas.

#### **TERMITE CONTROL:**

#### A. Treat all soil areas under modified portions of the building against termite infestation.

#### 10. **WOOD FRAMING:** A. Sheath all exterior walls with 1/2" CDX plywood. Roof sheathing to be 3/4" CDX plywood.

#### All exterior wood framing to be pressure treated.

- 11. SIDING AND TRIM: Provide Primed HardiePlank HZ10 Lap Siding. Exposure to match existing. Wood grain finish.
- Install HardiePlank Lap Siding in accordance with Manufacturer's written installation instructions and ICC-ES ESR 2290. Soffit panels - Hardie Soffit HZ10 Vented Panels unless noted otherwise.
- Field prime all cut joints prior to installation.
- Provide stainless steel fasteners throughout. 12. <u>DECKING:</u>
- Duxxback Dekk Composite Decking, 5/4" x 7 1/4".
- Install Duxxback Dekk in accordance with Manufacturer's written installation instructions.
- Duxxback must be installed with Manufacturer's minimum slope requirements. Color selected by Architect from Manufacture's full color line.

#### 13. FLUID-APPLIED VAPOR BARRIER:

- Provide W.R. Meadows Air-Shield LMP Fluid-Applied Air/Liquid Moisture Barrier system at all exterior wall locations. Install Air-Shield LMP in accordance with Manufacturer's written installation instructions.
- Use only compatible flashing products in association with Air-Shield LMP.

#### A. All metal flashing to be factory coated aluminum flashing. Provide self-adhering flashing at top leg of all flashing locations.

15. <u>WINDOWS:</u> Windows to be low-E 366 thermopane, MI v3000 Series vinyl impact-rated windows.

#### Exteriors will be medium bronze and interiors will be white. 16. EXTERIOR DOORS AND DOOR HARDWARE:

A. Sliding Doors will be Andersen A-Series Fiberglass Gliding French Door / Wood Interior with screens. Exterior will be medium bronze and interiors will be white.

#### 17. <u>INTERIOR WOOD TRIM:</u>

A. All interior wood trim to be clear, paint-grade poplar. Prime and painted "trim white" with low-VOC acrylic semi-gloss paint. Thresholds will be clear, paint-grade white oak. Prime and painted "trim white" with low-VOC acrylic semi-gloss paint.

#### 18. **EXTERIOR PAINTING AND STAIN:**

- A. Primed exterior siding and trim to be painted with two coats of Sherwin Williams Exterior Emerald Rain Refresh, Satin Finish. Rough carpentry at decks designed to be left exposed (without trim) to be stained with two coats of Sherwin Williams 9600
  - solid deck stain.
- Maximum Moisture Content of Substrates:
- Fiber Cement Board: 12 Percent Wood: 15 Percent
- All excess paint and stain to be labeled, sealed and to remain on site. Coordinate storage of paint with Owner.
- Siding to be painted to match color on existing end walls. Paint 4'x4' sample of color for Architect's approval prior to painting remaining siding.
- F. Stain color to match decking.

#### HARBOR ISLAND CONDOS

#### BUILDING L+M OCEANSIDE EXTERIOR RENOVATIONS

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	1	Revision 1		09/09/2024
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FOR CONSTRUCTION



#### PROJECT NOTES

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# BUILDING 'L' OCEANSIDE RENOVATIONS



# HARBOR ISLAND CONDOS

BUILDING L+M OCEANSIDE EXTERIOR RENOVATIONS

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•		STOWERS OF Beaufort, SC	, P

FOR CONSTRUCTION

PROPERTY INFORMATION

ADDRESS: 1 Harbor Dr. N, St. Helena Island, SC 29920

PIN: R300 020 00A 121A 0000 ZONING: PUD (Existing Planned Unit Development)

DRAWING INDEX CONTACT INFORMATION





VICINITY MAP

ARCHITECT - Architecture 101 Contact: Morgan Cleek Role: Project Manager Phone: (937)-416-9160 Email: morgan@a101.design

STRUCTURAL - 29e6 Contact: Andy Richardson, P.E. Email: andy@29e6.co

ABBREVIATIONS



ABOVE FINISH FLOOR MANUFACTURER AIR CONDITIONING MISCELLANEOUS MASONRY OPENING AIR HANDLING UNIT CONTROL JOINT NOT APPLICABLE NOT IN CONTRACT NOT TO SCALE CONCRETE MASONRY UNIT ON CENTER **CONTINUOUS** OPPOSITE HAND DIAMETER ORIENTED STRAND BD. PERFORATED PRESSURE TREATED DOWNSPOUT REQ'D REQUIRED SQUARE FEET SPECIFICATION STANDARD EXTERIOR TO BE DETERMINED FLOOR DRAIN TONGUE & GROOVE TEMPORARY FINISH FLOOR ELEV TELEVISION TYPICAL UNDER COUNTER WASHER/DRYER GYPSUM WALLBOARD WOOD WATER HEATER HOSE BIBB INTERIOR



COVER SHEET

Α		2023.32
	C	9/24/2024
	Drawn By	MNC
	Checked By	SGS


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I HARBOR DR N, ST HELENA ISLAND, SC 29920

DESCRIPTION



FOR CONSTRUCTION


A1 BUILDING L - OCEANSIDE - BACK RIGHT

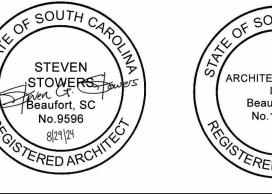



#### BUILDING L 3D **VIEWS**

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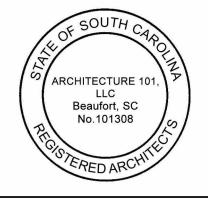
I HARBOR DR N, ST HELENA ISLAND, SC 29920
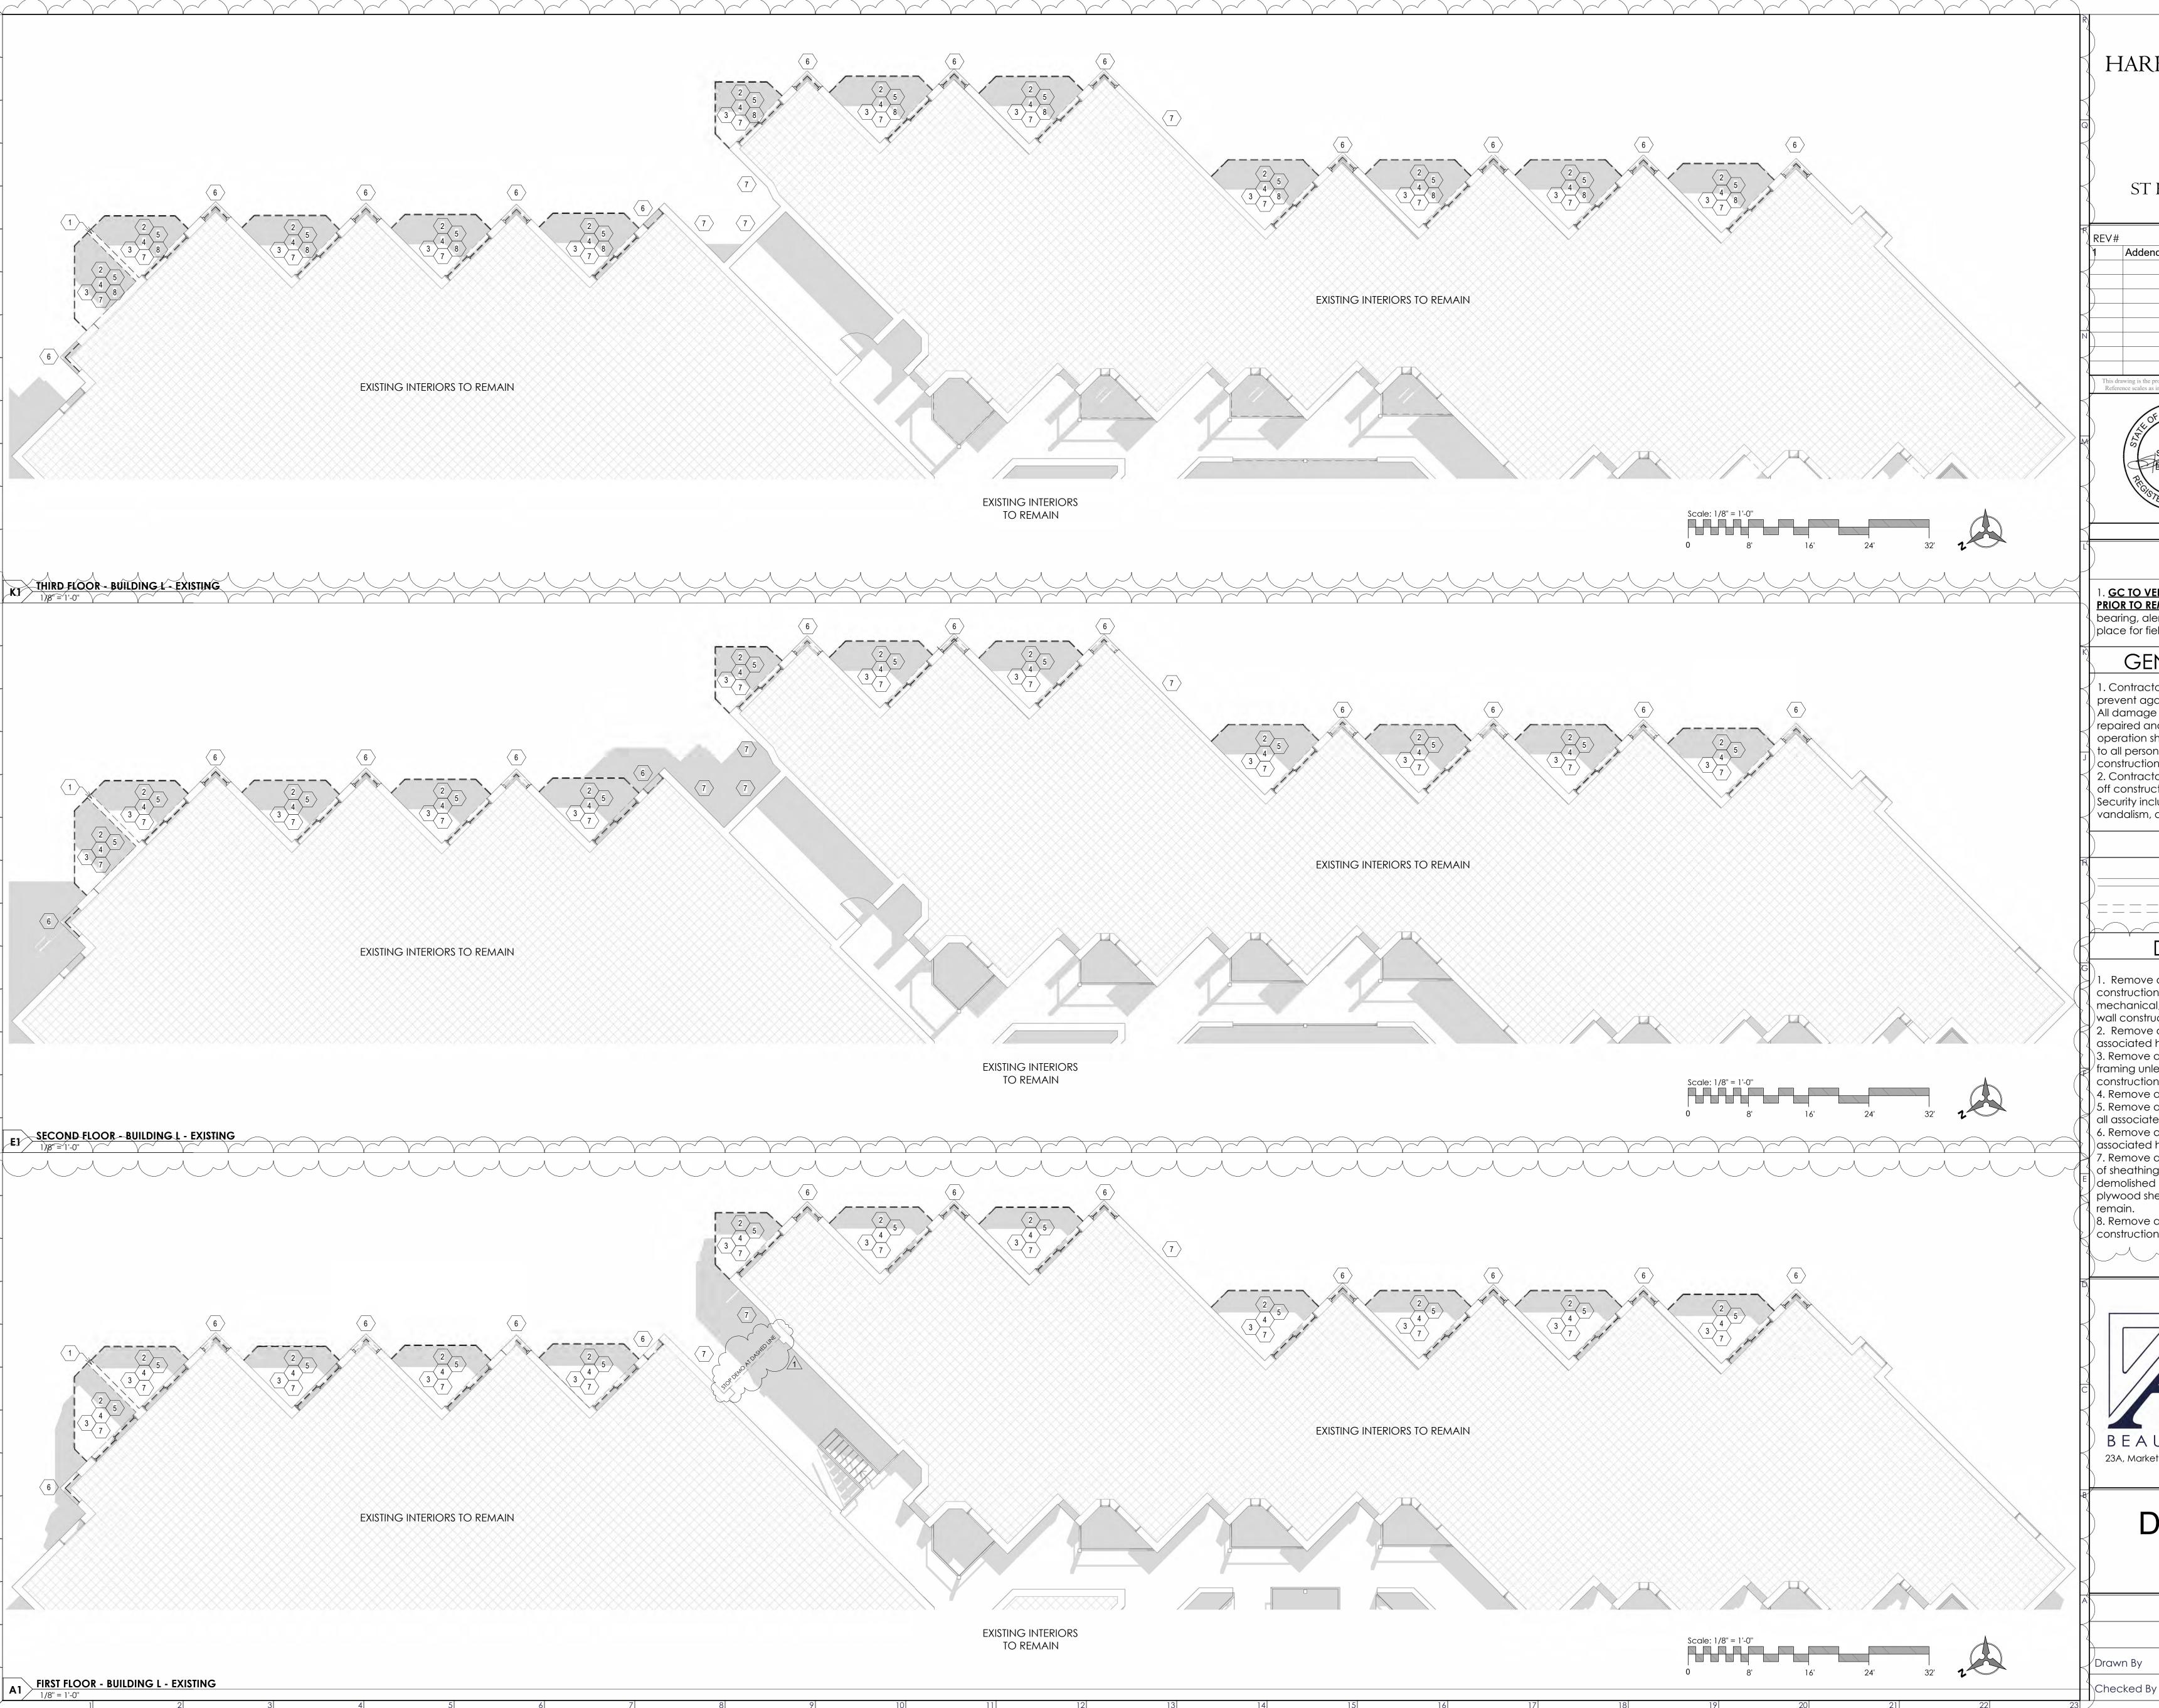
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FOR CONSTRUCTION

#### GENERAL NOTES

1. GC TO VERIFY THAT ALL WALLS ARE NON-LOAD BEARING PRIOR TO REMOVAL. Should a wall be determined as load bearing, alert architect immediately and leave wall in place for field verification.

#### GENERAL DEMO. NOTES

1. Contractor to conduct demolition operations as to prevent against damaging existing construction to remain.
All damage created by the demolition operation shall be repaired and prepared to receive new finishes. Demolition operation shall be conducted as to prevent personal injury to all persons on site during the life of the demolition and construction phases of the project.

2. Contractor to ensure the security of the building during off construction hours thru-out the life of the project.
Security includes but is not limited to prevention from theft, vandalism, and damage by weather conditions.

#### LEGEND

BUILDING COMPONENT TO REMAIN

BUILDING COMPONENT TO BE DEMOLISHED

#### DEMOLITION NOTES

1. Remove and dispose of existing partition wall construction. Included but not limited to all electrical, mechanical, and plumbing hidden within. Prepare for new wall construction as drawn.

2. Remove and dispose of existing sliding door and all

associated hardware. Existing door frame to remain.

3. Remove and dispose of existing deck and all associated framing unless noted otherwise. Prepare for new deck construction as drawn.

4. Remove and dispose of existing railing.
5. Remove and dispose of existing screen around deck and

all associated framing.

6. Remove and dispose of existing window, frame, and all associated hardware.

7. Remove and dispose of existing Hardi siding. If any type of sheathing BESIDES plywood sheathing exists, it is to be demolished and replaced with new plywood sheathing. If plywood sheathing exists and is not water damaged, it is to

8. Remove and dispose of existing ceiling. All roof construction above to remain.

RCHITECTURE

BEAUFORT - SAVANNAH

#### DEMO PLANS -BUILDING L

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#### **GENERAL DEMOLITION NOTES**

- 1. REMOVAL AS DESCRIBED HEREIN SHALL BE ACCOMPLISHED WITHOUT STORING EXCESSIVE QUANTITIES OF ANY MATERIALS, RUBBISH, DIRT, DEBRIS OR WASTE OF ANY SORT RESULTING FROM THE REMOVAL OPERATIONS IN THE DEMOLITION AREA.
- 2. ALL DEBRIS AND RUBBISH SHALL BE REMOVED FROM THE CONSTRUCTION SITE AS REQUIRED. CONTRACTOR TO COORDINATE ALL RECYCLING AND DISPOSAL OF ALL DEMOLISHED MATERIAL AND EQUIPMENT WITH THE APPROPRIATE WASTE MANAGEMENT AGENCY PRIOR TO REMOVAL AND DEMOLITION WORK.
- 3. THE CONTRACTOR SHALL TAKE ALL PRECAUTIONS TO MAINTAIN PROTECTION FROM ACCESS OF THE PUBLIC THROUGH THE AREAS OF WORK.
- 4. ALL DEMOLITION WORK SHALL BE PERFORMED IN ACCORDANCE WITH THE BEST MANAGEMENT PRACTICES.
- 5. THE CONTRACTOR SHALL REVIEW WITH THE OWNER AND ARCHITECT, ANY AND ALL ITEMS OF POSSIBLE DEMOLITION, NOT IMPLIED OR SPECIFIED ON THE DRAWINGS OR SPECIFICATIONS, THAT MAY PREVENT COMPLETION OF DEMO WORK IN ORDER TO COMPLETE THE DEMOLITION PHASE OF WORK.
- 6. JOBSITE SAFETY IS THE SOLE RESPONSIBILITY OF THE CONTRACTOR AND SHALL FOLLOW OSHA STANDARDS DURING THE ENTIRE CONSTRUCTION PROJECT.
- 7. PROVIDE ALL LABOR, MATERIAL, EQUIPMENT AND SERVICES AND PERFORM ALL OPERATIONS REQUIRED FOR COMPLETE EXTERIOR DEMOLITION AND RELATED WORK AS DESCRIBED AND SPECIFIED HEREIN, AND AS MAY BE REASONABLY IMPLIED AS NECESSARY TO COMPLETE THE WORK IN ALL RESPECTS.
- 8. WORK SHALL CONFORM TO THE LATEST EDITION OF ALL APPLICABLE REFERENCE SPECIFICATIONS AND TO THE GOVERNING BUILDING CODES AND REQUIREMENTS OF AUTHORITIES HAVING JURISDICTION.
- 9. JOBSITE INSPECTION MUST BE CONDUCTED TO EXAMINE EXISTING CONDITIONS, TO DETERMINE NATURE AND SCOPE OF WORK OR ANY DISCREPANCIES THAT MIGHT ARISE AT TIME OF WORK. IN ADDITION, EXAMINE ALL WORK THAT IS INTENDED TO REMAIN AS PART OF THE COMPLETED PROJECT AND REPORT ALL UNSATISFACTORY CONDITIONS TO THE OWNER AND ARCHITECT PRIOR TO COMMENCEMENT OF WORK. EXERCISE EXTREME CARE DURING DEMOLITION SO AS NOT TO DAMAGE CONSTRUCTION, OTHER STRUCTURES OR FURNISHINGS THAT ARE INTENDED TO REMAIN. ANYTHING DAMAGED AT TIME OF WORK IS TO BE REPAIRED AND/OR REPLACED TO MATCH EXISTING AT CONTRACTOR'S EXPENSE.
- 10. DURING DEMOLITION, SHOULD ANY WORK AFFECT THE INTEGRITY OF THE STRUCTURE, WORK MUST STOP IMMEDIATELY AND THE OWNER AND ARCHITECT SHALL BE NOTIFIED. UNDER NO CIRCUMSTANCES SHALL REINFORCING OF ANY KIND BE DAMAGED, CUT OR BROKEN.
- 11. FIRE ALARM AND LIFE SAFETY COMPONENTS TO REMAIN OPERATIONAL DURING DEMOLITION AND CONSTRUCTION.12. ALL SHORING NECESSARY FOR TEMPORARY SUPPORT OF EXISTING WALLS DURING DEMOLITION SHALL BE PROVIDED AND DESIGNED BY THE CONTRACTOR.
- 13. IT IS UNDERSTOOD THAT THE EXISTING BUILDING MAY CONTAIN ASBESTOS OR OTHER HAZARDOUS & TOXIC MATERIAL. THE ARCHITECT'S SERVICES DO NOT INCLUDE ANY SERVICES RELATED TO ASBESTOS OR OTHER HAZARDOUS & TOXIC MATERIAL. IN THE EVENT ANY PARTY ENCOUNTERS SUSPECTED ASBESTOS OR OTHER HAZARDOUS & TOXIC MATERIAL AT THE JOB SITE, OR SHOULD IT BECOME KNOWN IN ANY WAY THAT SUCH MATERIALS MAY BE PRESENT AT THE JOB SITE OR ANY ADJACENT AREAS THAT MAY AFFECT THE PERFORMANCE OF THE WORK, THE OWNER AND THE ARCHITECT MUST BE NOTIFIED IMMEDIATELY IN WRITING. THE ARCHITECT MAY, AT THEIR DISCRETION AND WITHOUT LIABILITY FOR CONSEQUENTIAL OR ANY OTHER DAMAGES, SUSPEND SERVICES UNTIL THE OWNER RETAINS THE APPROPRIATE SPECIALIST CONSULTANTS OR CONTRACTORS TO IDENTIFY, ABATE AND/OR REMOVE ASBESTOS OR OTHER HAZARDOUS & TOXIC MATERIALS AND WARRANT THE JOB SITE IS IN FULL COMPLIANCE WITH APPLICABLE LAWS AND REGULATIONS.

# HARBOR ISLAND CONDOS Building L + M

I HARBOR DR N, ST HELENA ISLAND, SC 29920

RE\	/# DESCRIPTION	DATE
1	Addendum #1	09/24/2024
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FOR CONSTRUCTION

#### LEGEND

BUILDING COMPONENT TO REMAIN

#### BUILDING COMPONENT TO BE DEMOLISHED

Remove and dispose of existing partition wall construction. Included but not limited to all electrical, mechanical, and plumbing hidden within. Prepare for new

DEMOLITION NOTES

wall construction as drawn.

2. Remove and dispose of existing sliding door and all associated hardware. Existing door frame to remain.

3. Remove and dispose of existing deck and all associated framing unless noted otherwise. Prepare for new deck

construction as drawn.
4. Remove and dispose of existing railing.

5. Remove and dispose of existing screen around deck and all associated framing.

6. Remove and dispose of existing window, frame, and all associated hardware.
7) Remove and dispose of existing Hardi siding. If any type

of sheathing BESIDES plywood sheathing exists, it is to be demolished and replaced with new plywood sheathing. If plywood sheathing exists and is not water damaged, it is to remain

8. Remove and dispose of existing ceiling. All roof construction above to remain.



BEAUFORT - SAVANNAH
23A, Market, Ste.1 - Beaufort, South Carolina - www.A101.Design

# DEMO ELEVATIONS - BUILDING L

2023.32
09/24/2024
Drawn By MNC
Checked By SGS

D102

BUILDING L - DEMO - OCEANSIDE ELEVATION

CEANSIDE ELEVATION

2 3 4 5 6 7 8 9 10 11 12 13 14 15 16 17 20 21 22 23

THIS IS A STRUCTURAL PACKAGE INTENDED TO BRING THIS STRUCTURE TO THE REQUIREMENTS AS SET FORTH IN THE APPLICABLE BUILDING CODE. ANY ITEMS NOT SPECIFIED HEREIN SHALL FOLLOW THE REQUIREMENTS OF THE INTERNATIONAL BUILDING CODE'S PRESCRIPTIVE REQUIREMENTS. SUCH ITEMS MAY INCLUDE DETAILING OF FRAMING CONNECTIONS, SIZES OF MEMBERS. MATERIAL SPECIFICATIONS. AND OTHER REQUIREMENTS RELATED TO THE STRUCTURE. WHERE MANUFACTURED PRODUCTS ARE USED, THE DETAILING AS ESTABLISHED BY THE MANUFACTURER SHALL BE USED.

#### STRUCTURAL DESIGN SPECIFICATIONS

- REFERENCE CODE
  - A. 2021 INTERNATIONAL BUILDING CODE WITH APPLICABLE STATE AMENDMENTS
- MINIMUM DESIGN LOADS FOR BUILDINGS AND OTHER STRUCTURES DURING CONSTRUCTION ARE REQUIRED PER ASCE STANDARD NO.37-02 "DESIGN LOADS ON STRUCTURES DURING CONSTRUCTION"

15 PSF

#### BUILDING DESIGN LOADS

- A. LIVE LOAD INFORMATION 1. FLOOR LIVE LOAD:
- FLOOR DEAD LOAD:

DEAD LOAD INFORMATION

- WIND LOAD INFORMATION DESIGN WIND SPEED = 145 MPH
- WIND IMPORTANCE FACTOR  $(I_W) = 1.0$ 
  - RISK CATEGORY = II WIND EXPOSURE = D
  - INTERNAL PRESSURE COEFFICIENT = +/- 0.18
  - COMPONENTS AND CLADDING = AS FOLLOWS WIND PRESSURES ARE REPORTED AT ASD LEVEL.
  - SEE ALSO FIGURE 1 (THIS PAGE).
  - a. ROOF ZONE 1 -57 PSF -79 PSF ZONE 2: ZONE 3:
  - WALLS ZONE 4 -20 PSF ZONE 5 -23 PSF
- SEISMIC DESIGN INFORMATION RISK CATEGORY = II
- SEISMIC IMPORTANCE FACTOR ( $I_E$ ) = 1.0
- 0.2 SECOND SPECTRAL RESPONSE ACCELERATION (S<sub>S</sub>) = 0.842 1 SECOND SPECTRAL RESPONSE ACCELERATION ( $S_1$ ) = 0.263
- SITE CLASS = D 0.2 SECOND DESIGN SPECTRAL RESPONSE ACCELERATION (SDS) =
- 1 SECOND DESIGN SPECTRAL RESPONSE ACCELERATION (S<sub>D1</sub>) =
- 0.364 SEISMIC DESIGN CATEGORY = D
- LATERAL FORCE RESISTING SYSTEM / RESPONSE MODIFICATION COEFFICIENT (R)
- LIGHT FRAMED WOOD WALLS SHEATHED WITH WOOD STRUCTURAL PANELS (6.5)
- DESIGN BASE SHEAR  $(V_C) = W^*C_S$
- SEISMIC RESPONSE COEFFICIENT (C<sub>S</sub>) = 0.104
- ANALYTICAL PROCEDURE = EQUIVALENT LATERAL FORCE


#### **GENERAL**

- 1. THE INTENT OF THESE DRAWINGS IS TO SHOW ALL ITEMS NECESSARY TO COMPLETE THE STRUCTURE. FOR ITEMS, METHODS, AND/OR MATERIALS NOT SHOWN, THE MINIMUM REQUIREMENTS OF THE REFERENCE CODE SHALL GOVERN. ALL WORK AND CONSTRUCTION SHALL COMPLY WITH ALL OTHER APPLICABLE BUILDING CODES, SOIL REPORTS, REGULATIONS, AND SAFETY REQUIREMENTS.
- THROUGHOUT THESE DRAWINGS, THE TERM ENGINEER REFERS TO THE ENGINEER OF RECORD FOR THIS PROJECT. OTHER ENGINEERING DISCIPLINES WILL BE EXPLICITLY DESCRIBED. THE TERM ARCHITECT REFERS TO THE ARCHITECT OF RECORD FOR THIS PROJECT.
- PLAN NORTH IS EXPLICITLY CALLED OUT ON THE SHEETS. TRUE NORTH IS TO BE INDICATED ON THE SPECIFIC PLANS WHERE APPLICABLE PER AN APPROVED SITE PLAN. PLAN NORTH IS FOR COORDINATION PURPOSES AND NOT FOR BUILDING LOCATION.
- 4. METHODS, MEANS, AND MATERIALS ARE EXPLICITLY CALLED OUT IN THESE NOTES. ANY DEVIATION OR PROPOSED CHANGE IS TO BE COMMUNICATED IMMEDIATELY TO THE ENGINEER. NO DEVIATION OR CHANGE IS ACCEPTABLE WITHOUT WRITTEN APPROVAL BY THE ENGINEER.
- IT SHALL BE THE CONTRACTOR'S SOLE RESPONSIBILITY TO DESIGN AND PROVIDE ADEQUATE SHORING, BRACING, FORMWORK, ETC. AS REQUIRED FOR THE PROTECTION OF LIFE AND PROPERTY DURING THE CONSTRUCTION OF THE BUILDING. SHORING AND TEMPORARY BRACING SHALL REMAIN IN PLACE UNTIL FLOORS, ROOF, AND LATERAL BRACING SYSTEMS HAVE BEEN ENTIRELY CONSTRUCTED, OR UNTIL THE PARTIALLY BUILT STRUCTURE IS PROVEN SAFE AND STABLE BY A REGISTERED ENGINEER ENGAGED BY THE CONTRACTOR. SHORING DRAWINGS AND CALCULATIONS SHALL BE SEALED BY A REGISTERED ENGINEER AND SUBMITTED TO THE ARCHITECT / ENGINEER FOR REVIEW. MINIMUM DESIGN LOADS FOR BUILDINGS AND OTHER STRUCTURES DURING CONSTRUCTION SHALL BE MAINTAINED PER ASCE STANDARD NO. 37-02 "DESIGN LOADS ON STRUCTURES DURING CONSTRUCTION."
- THE CONTRACTOR SHALL CHECK AND VERIFY ALL DIMENSIONS WITH THE ARCHITECTURAL, CIVIL, ELECTRICAL, AND MECHANICAL DRAWINGS BEFORE PREPARING SHOP DRAWINGS, FABRICATION, OR CONSTRUCTION. SEE ARCHITECTURAL, CIVIL, ELECTRICAL, AND MECHANICAL DRAWINGS FOR SIZE AND LOCATIONS OF PIPES, SLEEVES, PITS, VENTS, DUCTS, ROOF OPENINGS, TRENCHES, EQUIPMENT PADS, MISCELLANEOUS IRON, AND/OR ANY DETAILS NOT SHOWN ON THE STRUCTURAL DRAWINGS.
- CONSTRUCTION MATERIALS SHALL BE SPREAD OUT IF PLACED ON FRAMED ROOF OR FLOOR. THE LOAD SHALL NOT EXCEED THE DESIGN LOADS PER SQUARE FOOT. PROVIDE ADEQUATE SHORING AND/OR BRACING WHERE STRUCTURE HAS NOT ATTAINED DESIGN STRENGTH.
- ALL DRAWINGS ARE CONSIDERED TO BE A PART OF THE CONTRACT DOCUMENTS. DRAWINGS ARE NOT CONSIDERED ISSUED FOR CONSTRUCTION UNTIL THE ENGINEER HAS SIGNED AND SEALED EACH SHEET. THE CONTRACTOR SHALL BE RESPONSIBLE FOR THE REVIEW AND COORDINATION OF ALL DRAWINGS AND SPECIFICATIONS PRIOR TO THE START OF CONSTRUCTION. ANY DISCREPANCIES THAT OCCUR SHALL BE BROUGHT TO THE ATTENTION OF THE ARCHITECT PRIOR TO START OF CONSTRUCTION SO THAT A CLARIFICATION CAN BE ISSUED. ANY WORK PERFORMED IN CONFLICT WITH THE CONTRACT DOCUMENT OR ANY CODE REQUIREMENTS SHALL BE CORRECTED BY THE CONTRACTOR AT THEIR OWN EXPENSE AND AT NO EXPENSE TO THE OWNER, ARCHITECT, OR ENGINEER.
- NOTES AND DETAILS ON DRAWING SHALL TAKE PRECEDENCE OVER GENERAL NOTES AND TYPICAL DETAILS. WHERE NO NOTE OR DETAIL IS GIVEN, CONSTRUCTION SHALL BE PER TYPICAL STRUCTURAL, MANUFACTURER, OR ARCHITECTURAL DETAIL.
- 10. OPENINGS, POCKETS, ETC. LARGER THAN 6" SHALL NOT BE PLACED IN CONCRETE SLABS, DECKS, OR WALLS UNLESS SPECIALLY DETAILED ON THE STRUCTURAL DRAWINGS. NOTIFY THE ENGINEER WHEN DRAWINGS BY OTHERS SHOW OPENINGS, POCKETS, ETC. LARGER THAN 6" THAT ARE NOT SHOWN ON THE STRUCTURAL DRAWINGS BUT ARE LOCATED IN STRUCTURAL MEMBERS. FOR ANY FURTHER RESTRICTIONS ON OPENINGS IN STRUCTURAL ELEMENTS, SEE APPLICABLE SECTIONS BELOW.


#### GENERAL NOTES (CONT.)

- 11. PIPES LARGER THAN 1-1/2" DIAMETER SHALL NOT BE EMBEDDED IN STRUCTURAL CONCRETE EXCEPT WHERE SPECIFICALLY APPROVED.
- 12. ALL CONTRACTOR DESIGNED ELEMENTS SHALL BE DESIGNED BY A LICENSED PROFESSIONAL ENGINEER. CONTRACTOR SHALL SUBMIT CALCULATIONS CERTIFYING THAT ELEMENTS ARE DESIGNED FOR THE STATED UNFACTORED LOADS.
- 13. ALL TESTING AND INSPECTION OF WELDS SHALL BE DONE BY AN INDEPENDENT TESTING SERVICE ACCEPTABLE TO THE ENGINEER AND SHALL CONFORM TO THE LATEST EDITION OF ANSI/AWS 01.1. WELD INSPECTORS ARE TO BE AWS CERTIFIED.
- 14. ANY SLOPE SHALL BE CONSTRUCTED AT A MAXIMUM GRADIENT OF 2:1 (HORIZONTAL TO VERTICAL). FILL AND CUT SLOPES SHOULD BE VEGETATED AS SOON AS POSSIBLE TO MINIMIZE EROSION OF SOIL.
- 15. ANY VERTICAL SOIL CUTS MUST BE PROVIDED WITH PROPER SHORING TO PROTECT WORKERS AND ADJACENT PROPERTY. THE CONTRACTOR SHALL BE SOLELY RESPONSIBLE FOR ALL EXCAVATION PROCEDURES INCLUDING LAGGING, SHORING, AND THE PROTECTION OF ADJACENT PROPERTY.
- 16. SHOP DRAWINGS PREPARED BY SUPPLIERS AND SUBCONTRACTORS SHALL BE REVIEWED BY THE GENERAL CONTRACTOR PRIOR TO SUBMITTING TO THE ENGINEER.
- 17. CONTRACTOR SHALL PROVIDE SHOP DRAWINGS SHOWING SIZE, METHOD OF ANCHORAGE, AND WEIGHT OF ALL EQUIPMENT THAT IS TO BE SUPPORTED BY THE STRUCTURE FOR REVIEW BY THE ENGINEER. THIS IS TO DETERMINE ADEQUACY OF THE STRUCTURE PRIOR TO ORDERING.
- 18. THE CONTRACTOR SHALL BE RESPONSIBLE FOR THE DESIGN AND DETAIL OF SIMPLE (SHEAR ONLY) CONNECTIONS NOT SHOWN ON DRAWINGS.
- 19. SHOP DRAWINGS AND OTHER ITEMS SHALL BE SUBMITTED TO THE ENGINEER FOR REVIEW PRIOR TO FABRICATION. ALL SHOP DRAWINGS SHALL BE REVIEWED BY THE GENERAL CONTRACTOR BEFORE SUBMITTAL. THE ENGINEER'S REVIEW IS INTENDED TO REVIEW FOR CONFORMANCE WITH THE DESIGN CONCEPT AND GENERAL COMPLIANCE WITH THE RELEVANT CONTRACT DOCUMENTS. THE ENGINEER'S REVIEW DOES NOT RELIEVE THE CONTRACTOR OF THE SOLE RESPONSIBILITY TO REVIEW, CHECK, AND COORDINATE THE SHOP DRAWINGS PRIOR TO SUBMISSION. THE CONTRACTOR REMAINS SOLELY RESPONSIBLE FOR ERRORS AND OMISSIONS ASSOCIATED WITH THE PREPARATION OF SHOP DRAWINGS AS THEY PERTAIN TO MEMBER SIZES, DETAILS, DIMENSIONS, ETC. REPRODUCTIONS OF CONTRACT DOCUMENTS SHALL NOT BE USED TO PREPARE SHOP DRAWINGS. SHOP DRAWINGS AND SUBMITTALS SHALL BE SUBMITTED "CONTRACTOR APPROVED."

- STRUCTURAL LUMBER SHALL BE SOUTHERN YELLOW PINE #2, SPRUCE PINE FIR #2 OR BETTER, UNLESS NOTED OTHERWISE
- ALL STRUCTURAL WOOD USED IN THE CONSTRUCTION OF EXTERIOR COMPONENTS (E.G. STEPS, PORCHES, AND DECKS), EXPOSED TO WEATHER, AND / OR IN CONTACT WITH CONCRETE / SOIL SHALL BE PRESSURE TREATED OR EQUALLY ROT RESISTANT.
- 3. ALL STRUCTURAL WOOD COMPONENTS (E.G. PLYWOOD AND ALL LUMBER) BELOW FLOOD ELEVATION SHALL BE PRESSURE TREATED OR EQUALLY ROT
- ALL FASTENERS AND CONNECTORS (HARDWARE) SHALL BE GALVANIZED OR STAINLESS STEEL. ALL HARDWARE SHALL BE INSTALLED PER MANUFACTURER'S INSTRUCTIONS.
- REPLACEMENT WALL SHEATHING: 15/32" MINIMUM 24/16 APA-RATED PLYWOOD, WITH 0.131" DIAMETER X 2.5" LONG (8D COMMON) NAILS AT 3" ON CENTER AT ALL PANEL EDGES / BOUNDARIES, AND 12" ON CENTER IN THE FIELD. BLOCK ALL EDGES OF PLYWOOD UNLESS NOTED OTHERWISE.

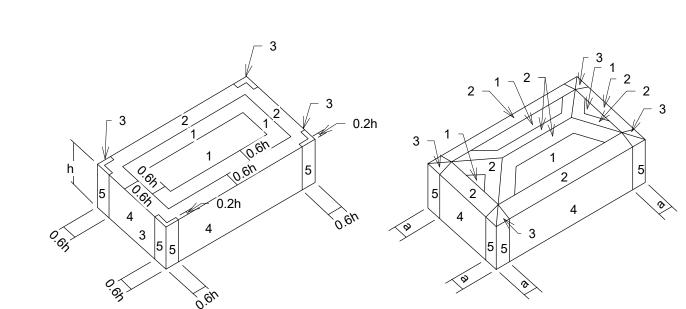

FLAT/HIP/GABLE (0:12  $\leq$  SLOPE  $\leq$  1.5:12) HIP ROOF  $(1.5:12 \le SLOPE \le 12:12)$ 

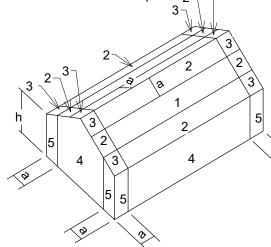

GABLE ROOF  $(1.5:12 \le SLOPE \le 12:12)$ 

FIG. 1: WIND PRESSURE DIAGRAMS (REFER TO ITEM C7 UNDER DESIGN CRITERIA)

STRUCTUR	AL ABBREVIATIONS
A.B. ADD/L AFF ARCH BFF B.N. CA C.I.P. CJ CL CLR CONC CONC CONN CONST CONST COORD. DET. DIA	- ANCHOR BOLT - ADDITIONAL - ABOVE FINISHED FLOOR - ARCHITECT/ARCHITECTURAL - BELOW FINISHED FLOOR - BOUNDARY NAILING - COLUMN ABOVE - CAST IN PLACE - CONTROL JOINT - CENTER LINE - CLEAR - COLUMN - CONCRETE - CONNECTION - CONSTRUCTION - CONTINUOUS
EA EJ	- EACH - EXPANSION JOINT

- ELEVATION

**ENGR** - ENGINEER EOD - EDGE OF DECK EOS - EDGE OF SLAB EQ - EQUAL **EQUIP** - EQUIPMENT EW - EACH WAY

EXP - EXPANSION EXT - EXTERIOR F.F. - FINISHED FLOOR FDN - FOUNDATION FFE - FINISHED FLOOR ELEVATION

FIN. - FINISH(ED) FLR. - FLOOR FT - FOOT / FEET FTG. - FOOTING - GAUGE

GALV. - GALVANIZE (D) (ING) - HIGH **HORIZ** - HORIZONTAL JBE - JOIST BEARING ELEVATION


MFR - MANUFACTURER - NEW O.C. - ON CENTER PSF

- POUNDS PER SQUARE FOOT - PRESSURE TREATED **REINF** - REINFORCEMENT SYP - SOUTHERN YELLOW PINE

- UNLESS NOTED OTHERWISE U.N.O. **VERT**  VERTICAL - VERIFY IN FIELD V.I.F. - WITH - WELDED WIRE FABRIC







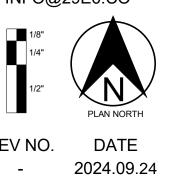

HARBOR ISLAND CONDOS BUILDING L + M 1 HARBOR DR. N ST HELENA ISLAND, SC 29920 **PROJECT NO: 20-012** 

STRUCTURAL NOTES

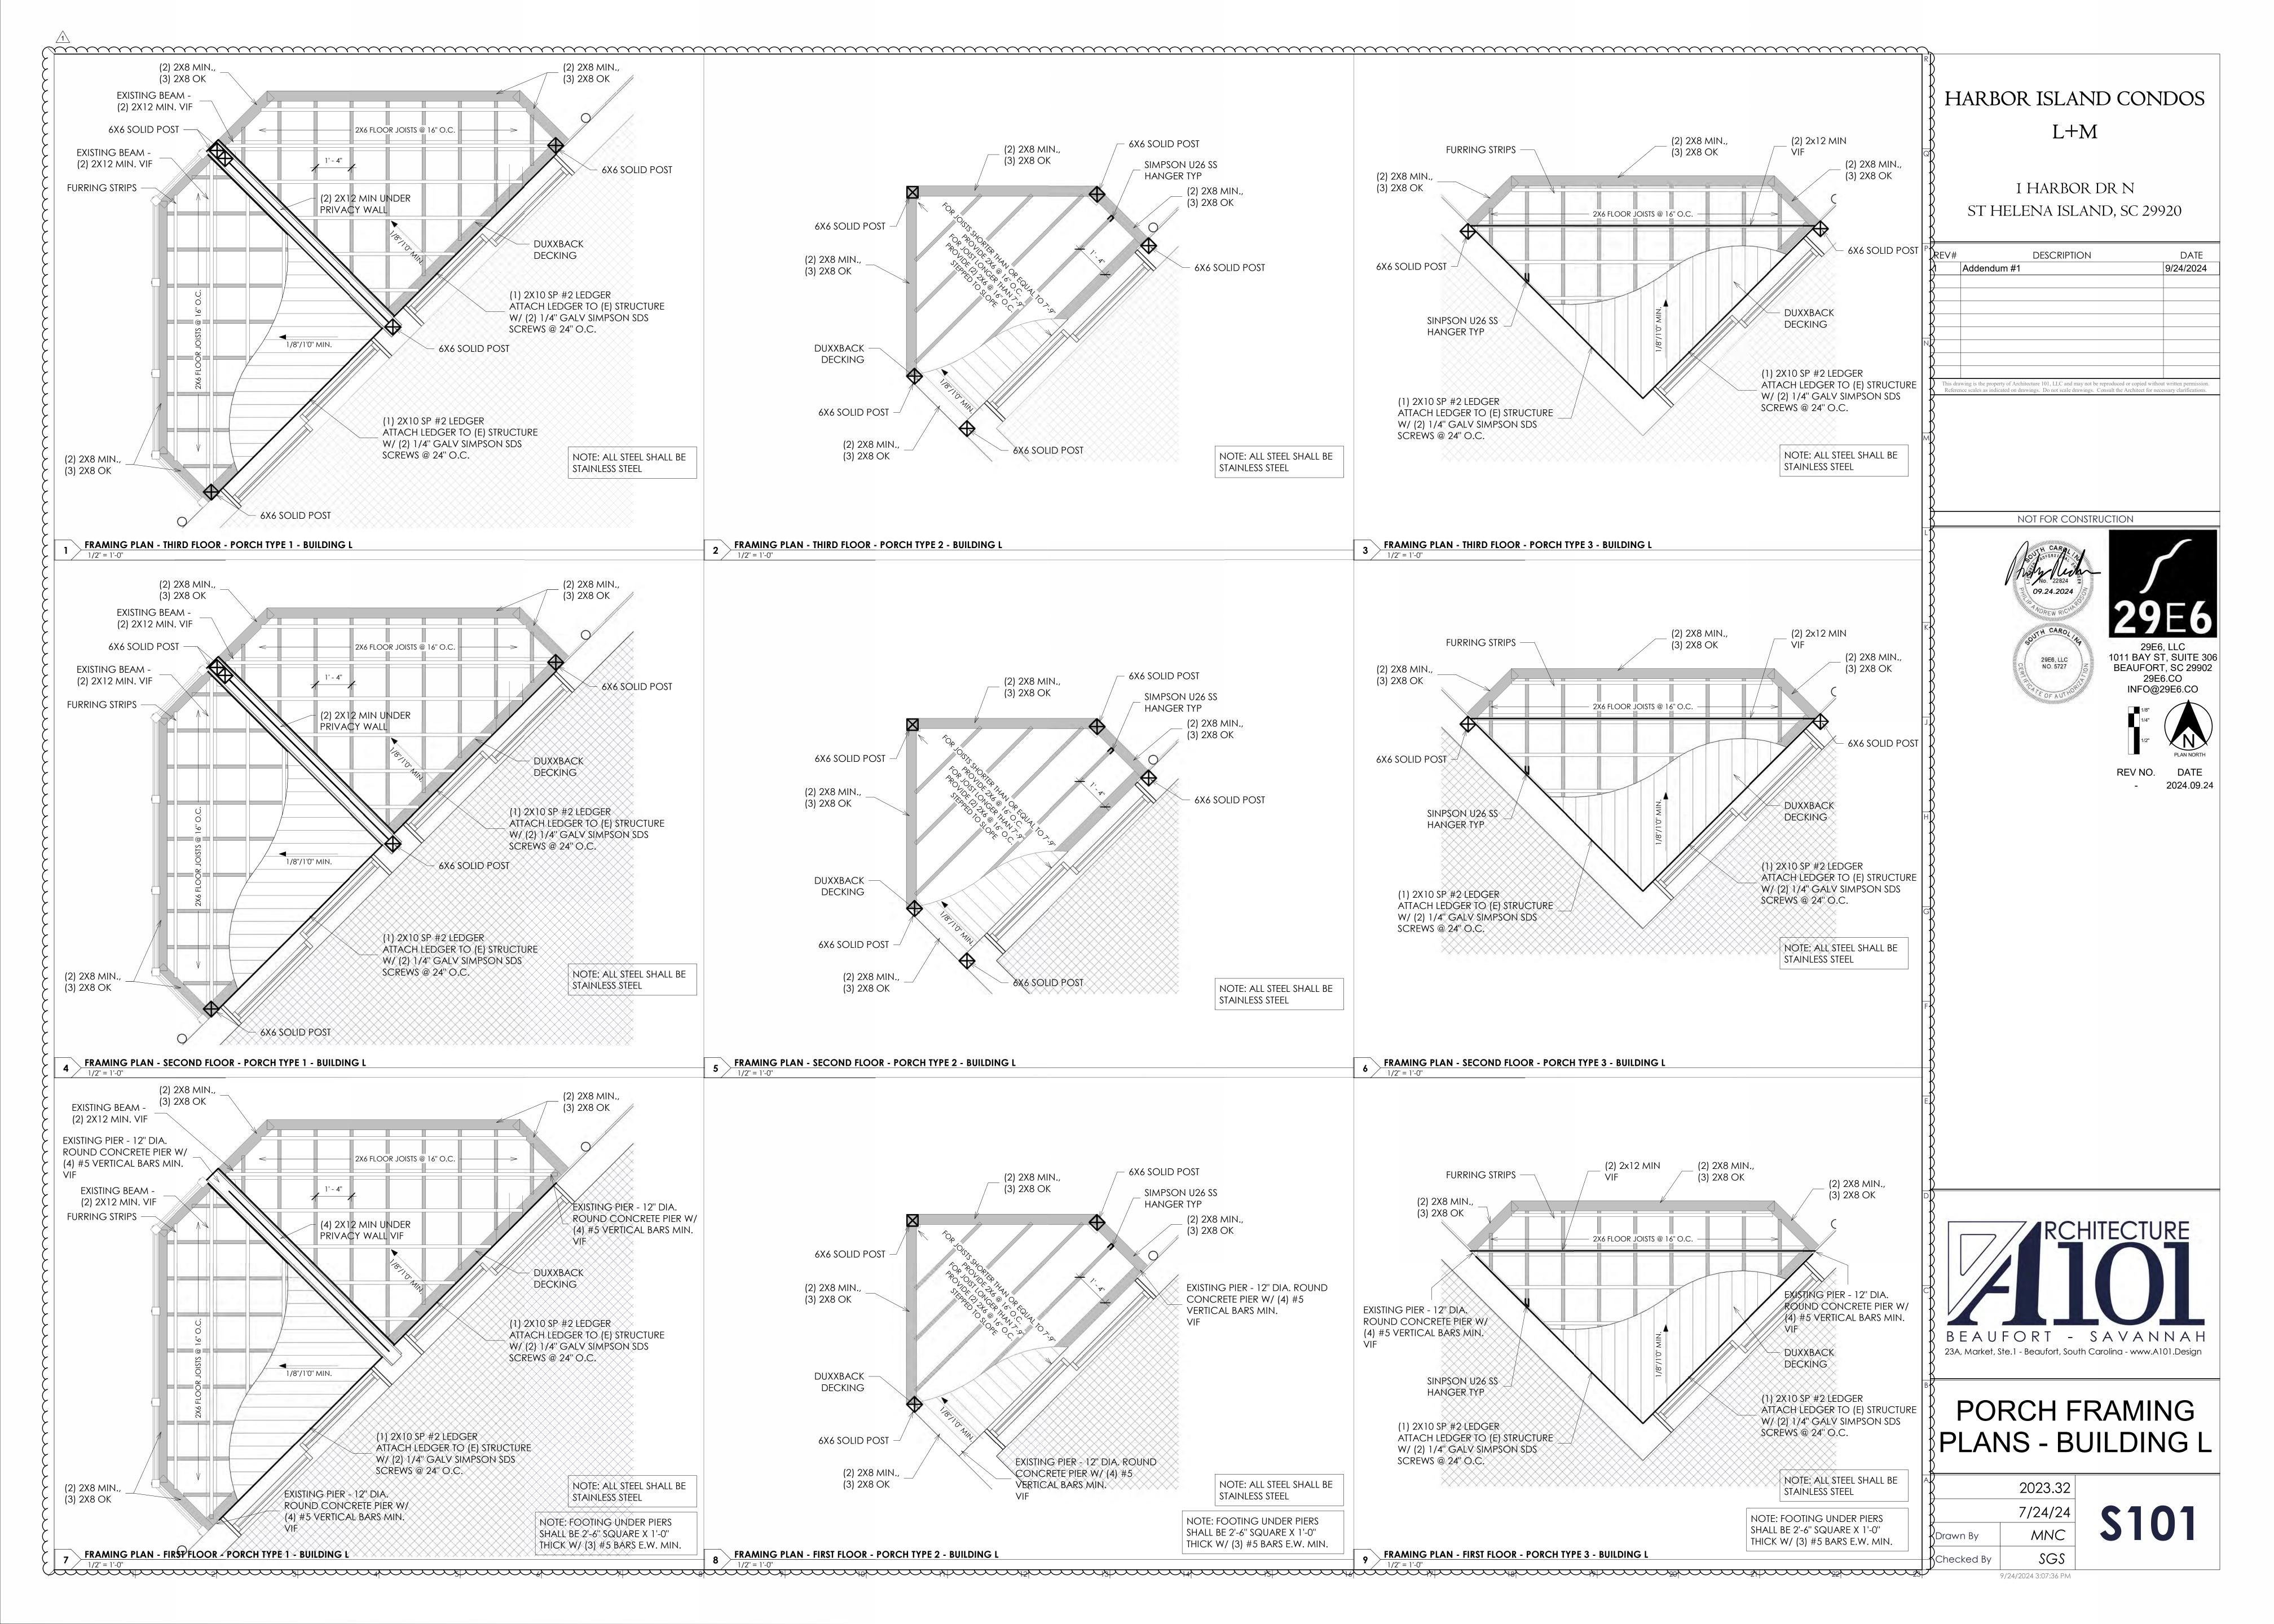

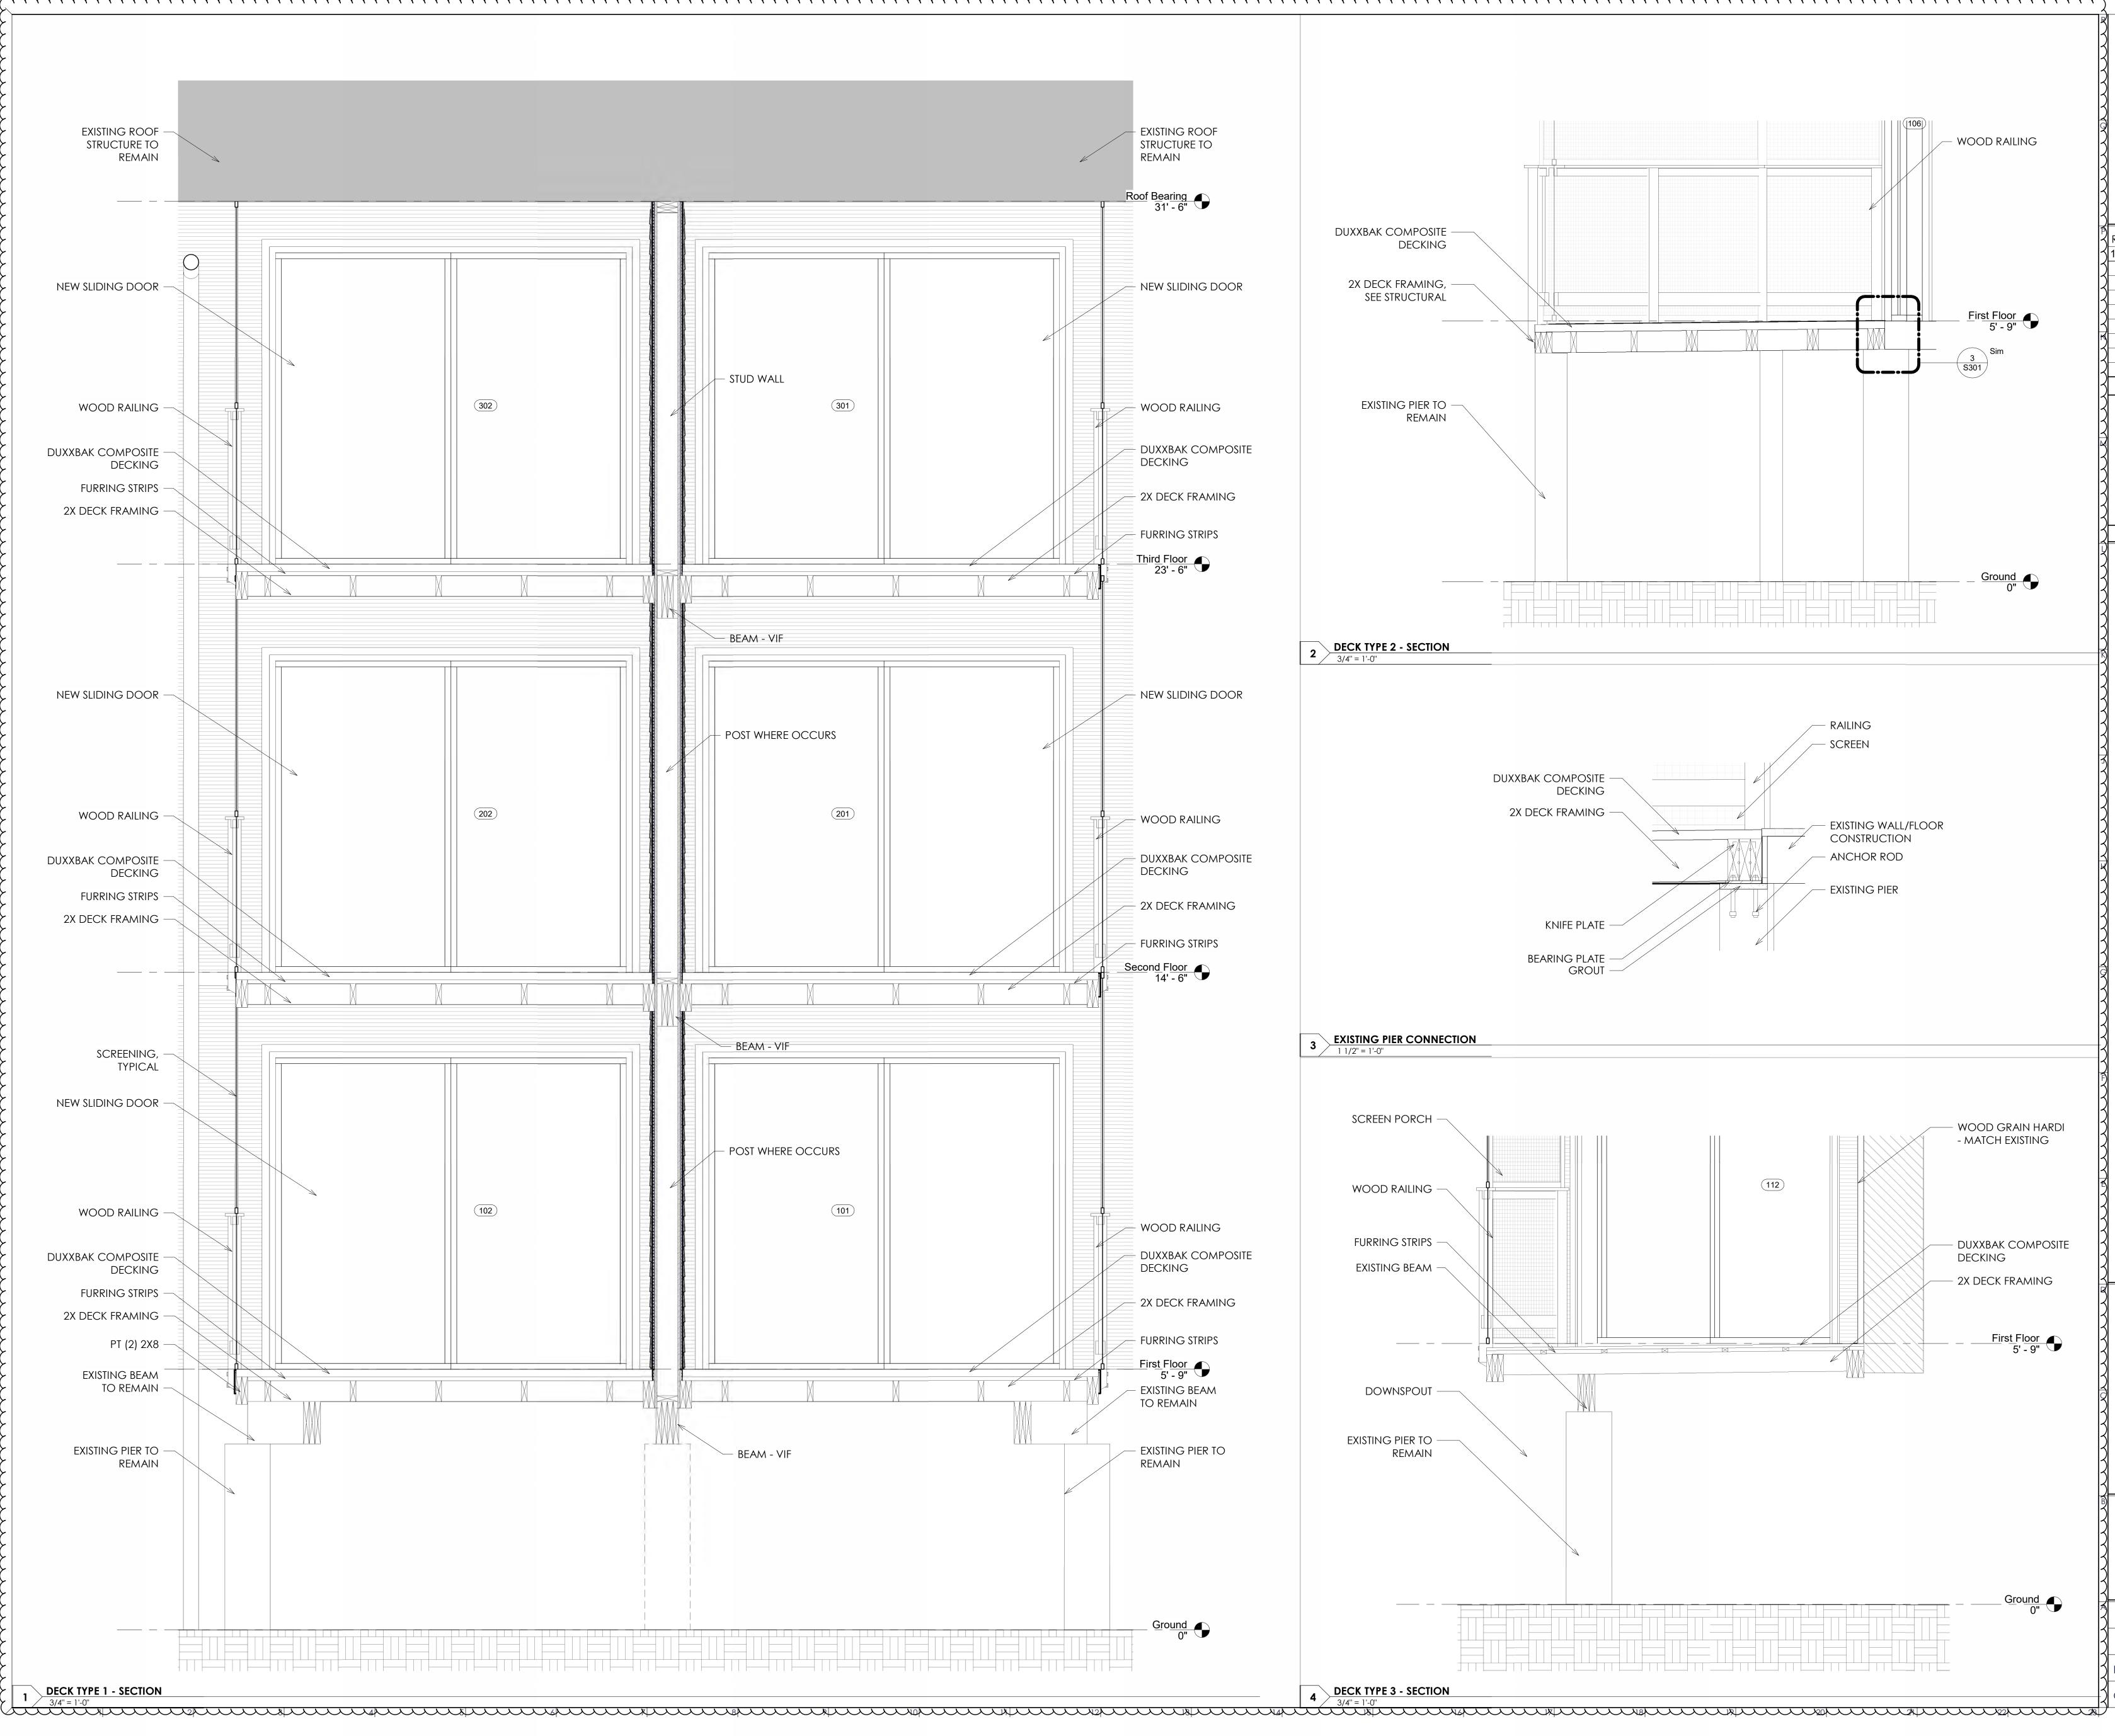

#### HARBOR ISLAND CONDOS L+M

I HARBOR DR N ST HELENA ISLAND, SC 29920

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1/4"
1/2"

EV NO. DATE
- 2024.09.24

RCHITECTURE

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#### PORCH SECTIONS -BUILDING L

2023.32 7/24/24 Drawn By MNC Checked By SGS

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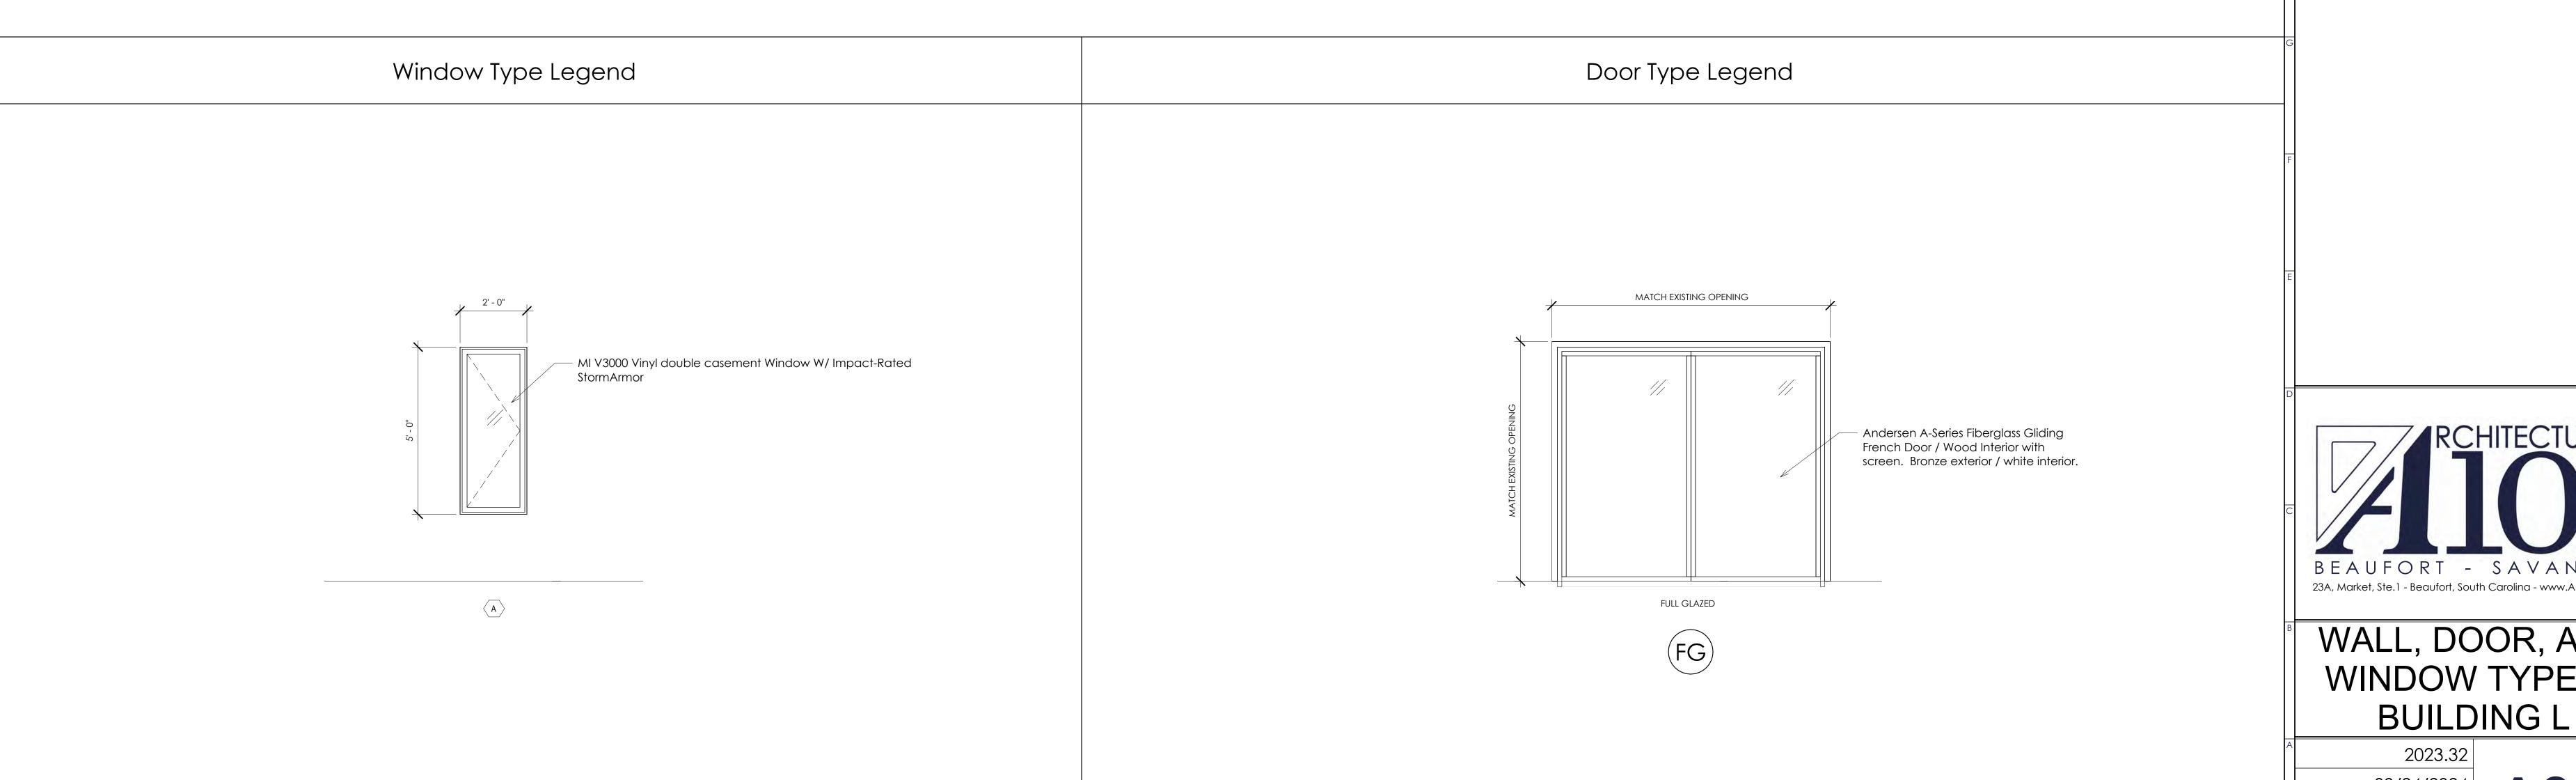
**S30**1

	Door Schedule					
Mark	Width	Height Fire rating	Door Type	Frame Type	Comments	
101	8' - 0"	7' - 0"	FG	FBG	Verify and match existing opening/height in field, Integrated Pull Handle w/ Lock	
102	8' - 0"	7' - 0"	FG	FBG	Verify and match existing opening/height in field, Integrated Pull Handle w/ Lock	
103	8' - 0"	7' - 0"	FG	FBG	Verify and match existing opening/height in field, Integrated Pull Handle w/ Lock	
104	8' - 0"	7' - 0"	FG	FBG	Verify and match existing opening/height in field, Integrated Pull Handle w/ Lock	
105	8' - 0"	7' - 0"	FG	FBG	Verify and match existing opening/height in field, Integrated Pull Handle w/ Lock	
106	8' - 0"	7' - 0"	FG	FBG	Verify and match existing opening/height in field, Integrated Pull Handle w/ Lock	
107	8' - 0"	7' - 0"	FG	FBG	Verify and match existing opening/height in field, Integrated Pull Handle w/ Lock	
108	8' - 0"	7' - 0"	FG	FBG	Verify and match existing opening/height in field, Integrated Pull Handle w/ Lock	
109	8' - 0"	7' - 0"	FG	FBG	Verify and match existing opening/height in field, Integrated Pull Handle w/ Lock	
110	8' - 0"	7' - 0"	FG	FBG	Verify and match existing opening/height in field, Integrated Pull Handle w/ Lock	
111	8' - 0"	7' - 0"	FG	FBG	Verify and match existing opening/height in field, Integrated Pull Handle w/ Lock	
112	8' - 0"	7' - 0"	FG	FBG	Verify and match existing opening/height in field, Integrated Pull Handle w/ Lock	
201	8' - 0"	7' - 0"	FG	FBG	Verify and match existing opening/height in field, Integrated Pull Handle w/ Lock	
202	8' - 0"	7' - 0"	FG	FBG	Verify and match existing opening/height in field, Integrated Pull Handle w/ Lock	
203	8' - 0"	7' - 0"	FG	FBG	Verify and match existing opening/height in field, Integrated Pull Handle w/ Lock	
204	8' - 0"	7' - 0"	FG	FBG	Verify and match existing opening/height in field, Integrated Pull Handle w/ Lock	
205	8' - 0"	7' - 0"	FG	FBG	Verify and match existing opening/height in field, Integrated Pull Handle w/ Lock	
206	8' - 0"	7' - 0"	FG	FBG	Verify and match existing opening/height in field, Integrated Pull Handle w/ Lock	
207	8' - 0"	7' - 0"	FG	FBG	Verify and match existing opening/height in field, Integrated Pull Handle w/ Lock	
208	8' - 0"	7' - 0"	FG	FBG	Verify and match existing opening/height in field, Integrated Pull Handle w/ Lock	
209	8' - 0"	7' - 0"	FG	FBG	Verify and match existing opening/height in field, Integrated Pull Handle w/ Lock	
210	8' - 0"	7' - 0"	FG	FBG	Verify and match existing opening/height in field, Integrated Pull Handle w/ Lock	
211	8' - 0"	7' - 0"	FG	FBG	Verify and match existing opening/height in field, Integrated Pull Handle w/ Lock	
212	8' - 0"	7' - 0"	FG	FBG	Verify and match existing opening/height in field, Integrated Pull Handle w/ Lock	
301	8' - 0"	7' - 0"	FG	FBG	Verify and match existing opening/height in field, Integrated Pull Handle w/ Lock	
302	8' - 0"	7' - 0"	FG	FBG	Verify and match existing opening/height in field, Integrated Pull Handle w/ Lock	
303	8' - 0"	7' - 0"	FG	FBG	Verify and match existing opening/height in field, Integrated Pull Handle w/ Lock	
304	8' - 0"	7' - 0"	FG	FBG	Verify and match existing opening/height in field, Integrated Pull Handle w/ Lock	
305	8' - 0"	7' - 0"	FG	FBG	Verify and match existing opening/height in field, Integrated Pull Handle w/ Lock	
306	8' - 0"	7' - 0"	FG	FBG	Verify and match existing opening/height in field, Integrated Pull Handle w/ Lock	
307	8' - 0"	7' - 0"	FG	FBG	Verify and match existing opening/height in field, Integrated Pull Handle w/ Lock	
308	8' - 0"	7' - 0"	FG	FBG	Verify and match existing opening/height in field, Integrated Pull Handle w/ Lock	
309	8' - 0"	7' - 0"	FG	FBG	Verify and match existing opening/height in field, Integrated Pull Handle w/ Lock	
310	8' - 0"	7' - 0"	FG	FBG	Verify and match existing opening/height in field, Integrated Pull Handle w/ Lock	
311	8' - 0"	7' - 0"	FG	FBG	Verify and match existing opening/height in field, Integrated Pull Handle w/ Lock	
312	8' - 0"	7' - 0"	FG	FBG	Verify and match existing opening/height in field, Integrated Pull Handle w/ Lock	

#### **DOOR SCHEDULE NOTES:**

- Door hardware finish shall match existing. Key all doors to Owner's requirements. Conduct Preinstallation conference with Owner to determine keying requirements.
- Coordinate access control with Owner.
  All door hardware to be 2010 ADA compliant.
- GC Shall field verify all existing door and window opening sizes and dimensions prior to ordering.

DOOR LEGEND:
FG: Full Glazed
FBG: Fiber Glass



#### HARBOR ISLAND CONDOS

#### BUILDING L+M OCEANSIDE EXTERIOR RENOVATIONS

I HARBOR DR. N, ST HELENA ISLAND, SC 29920

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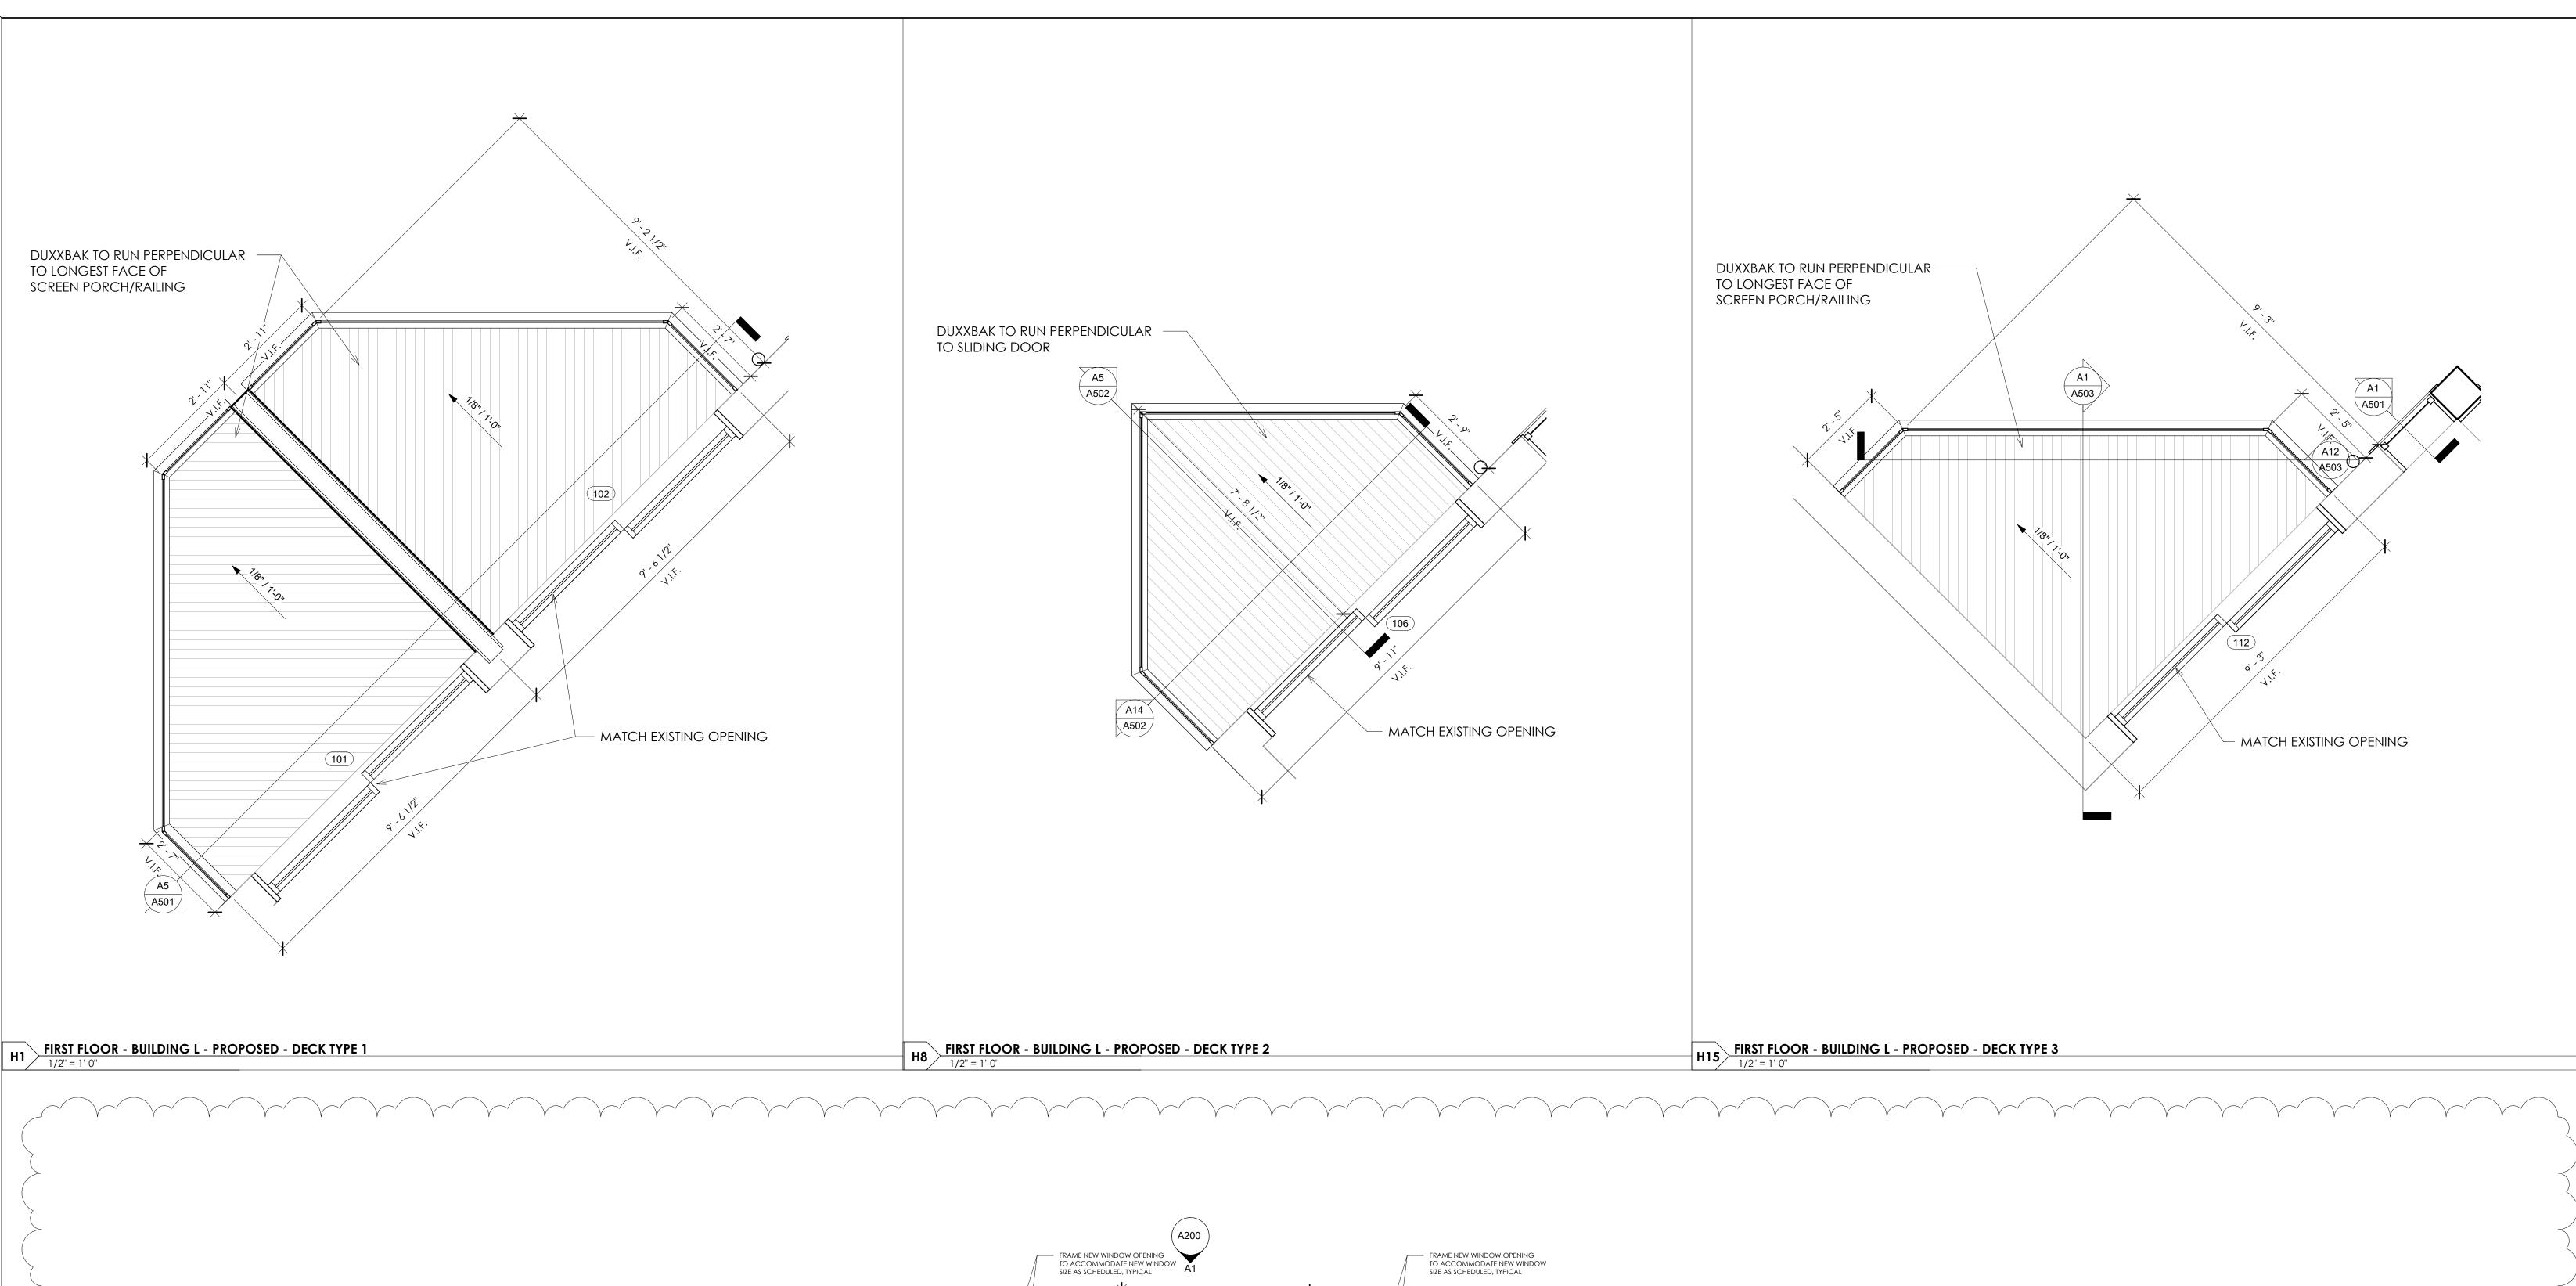


ARCHITECTURE 101 LLC Beaufort, SC No.101308

FOR CONSTRUCTION

WALL, DOOR, AND WINDOW TYPES -

A		2023.32
	C	)9/24/2024
	)rawn By	MNC
	Checked By	SGS



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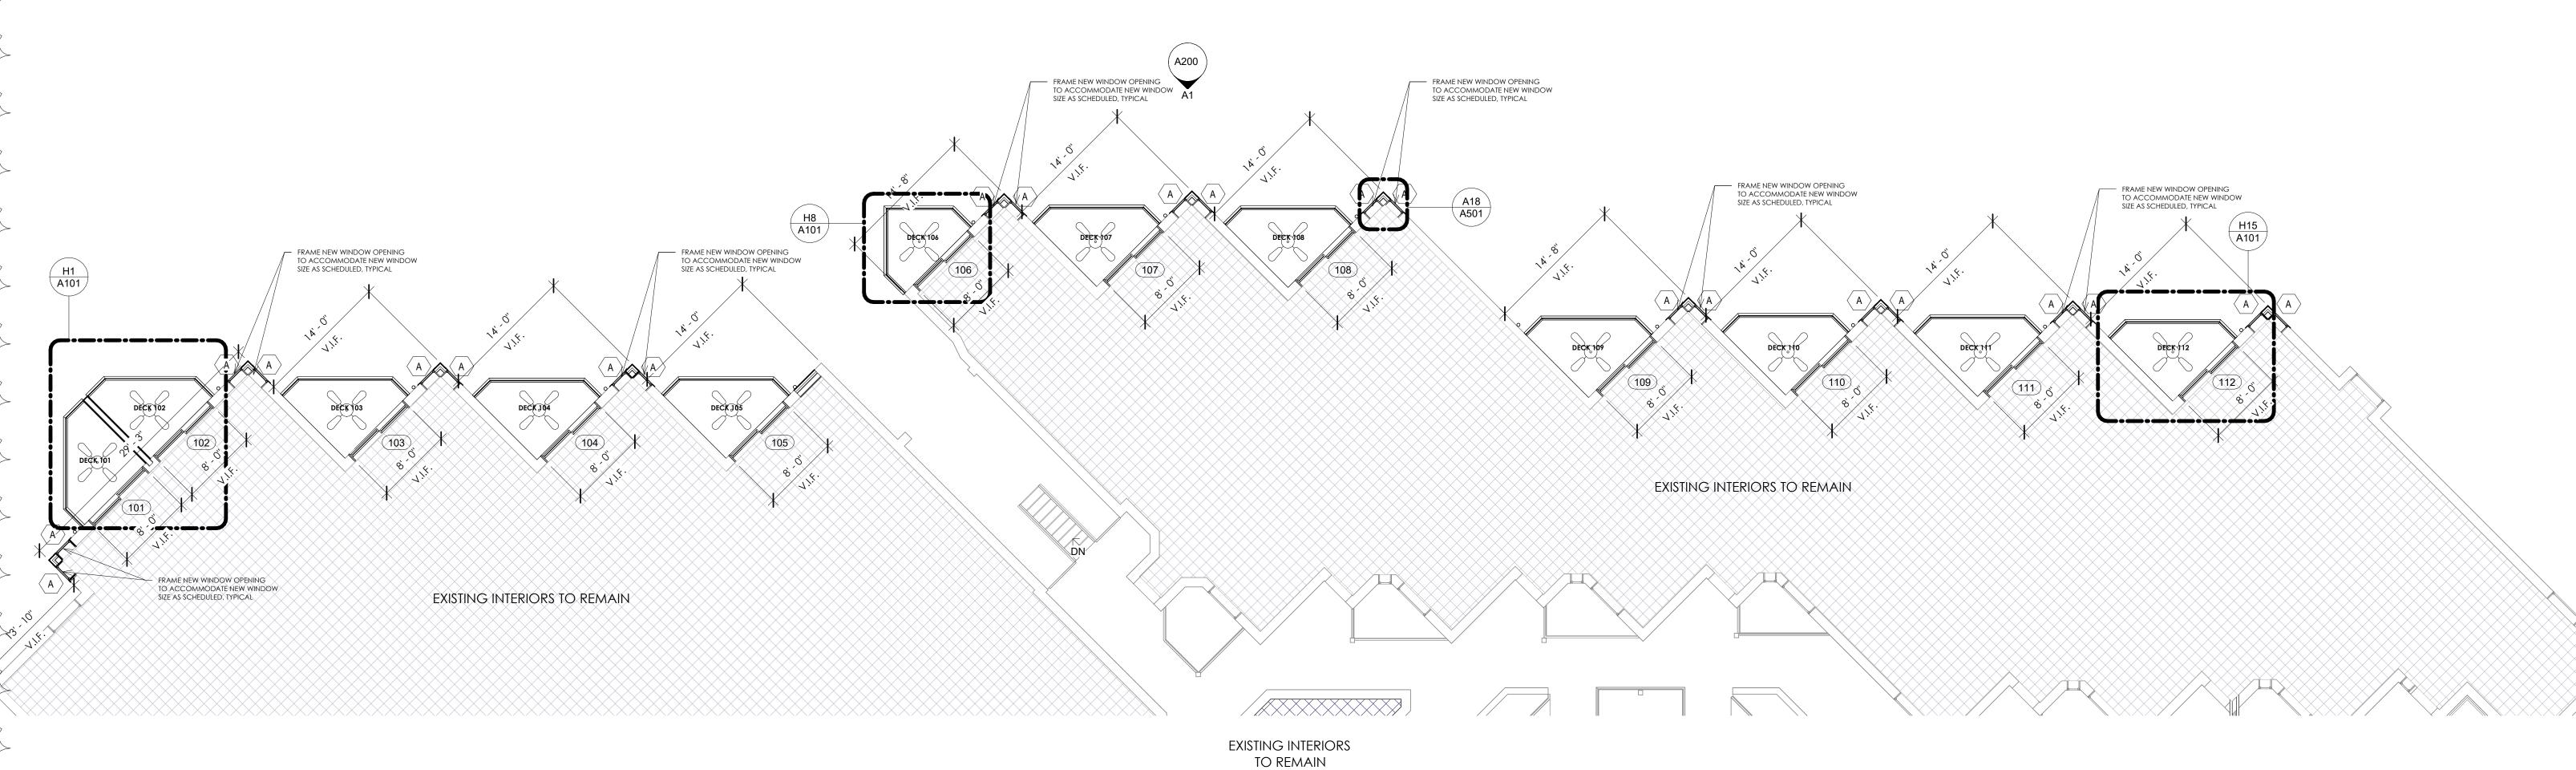
#### GENERAL NOTES

1. All dimensions are to face of stud unless noted otherwise.

2. All door openings are 4" from adjacent wall unless noted otherwise.

#### SHEET NOTES

NOTE 1: PROVIDE NEW CONDUIT TO CEILING FAN LOCATION AT THE CENTER OF EACH PORCH ROUTED TO EXISTING PORCH RECEPTACLE LOCATION. CONDUIT SHALL BE NEATLY RUN IN FURRING SPACE WITH BLOCKING PROVIDED BETWEEN JOISTS TO ANCHOR J-BOX. NO SWITCH WILL BE PROVIDED (PULL CHAIN OPERATED FANS ONLY). FANS TO BE PROVIDED BY UNIT OWNERS. PAINT CONDUIT TO MATCH FRAMING.



FIRST FLOOR - BUILDING L - PROPOSED



# FLOOR PLANS BUILDING L - FIRST FLOOR


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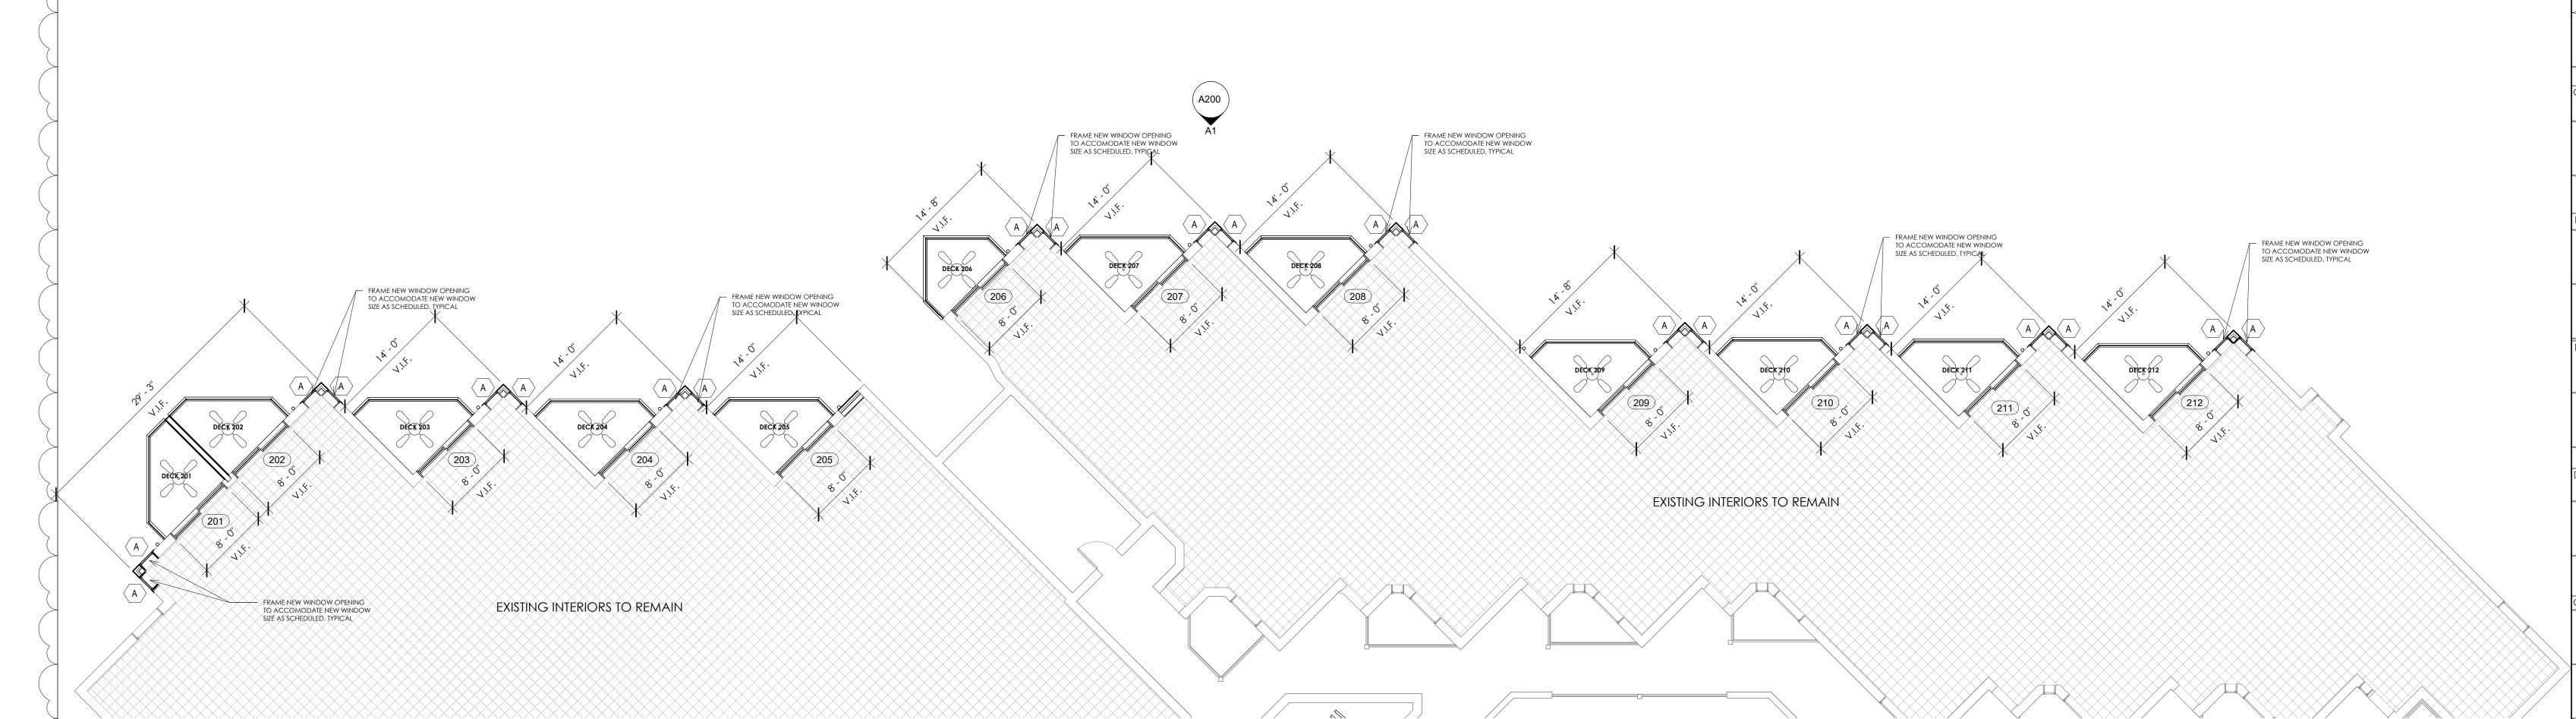
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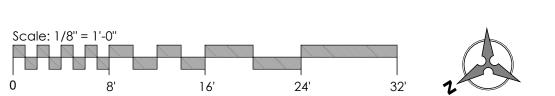
A101



# cale: 1/8" = 1'-0"

#### THIRD FLOOR - BUILDING L. PROPOSED



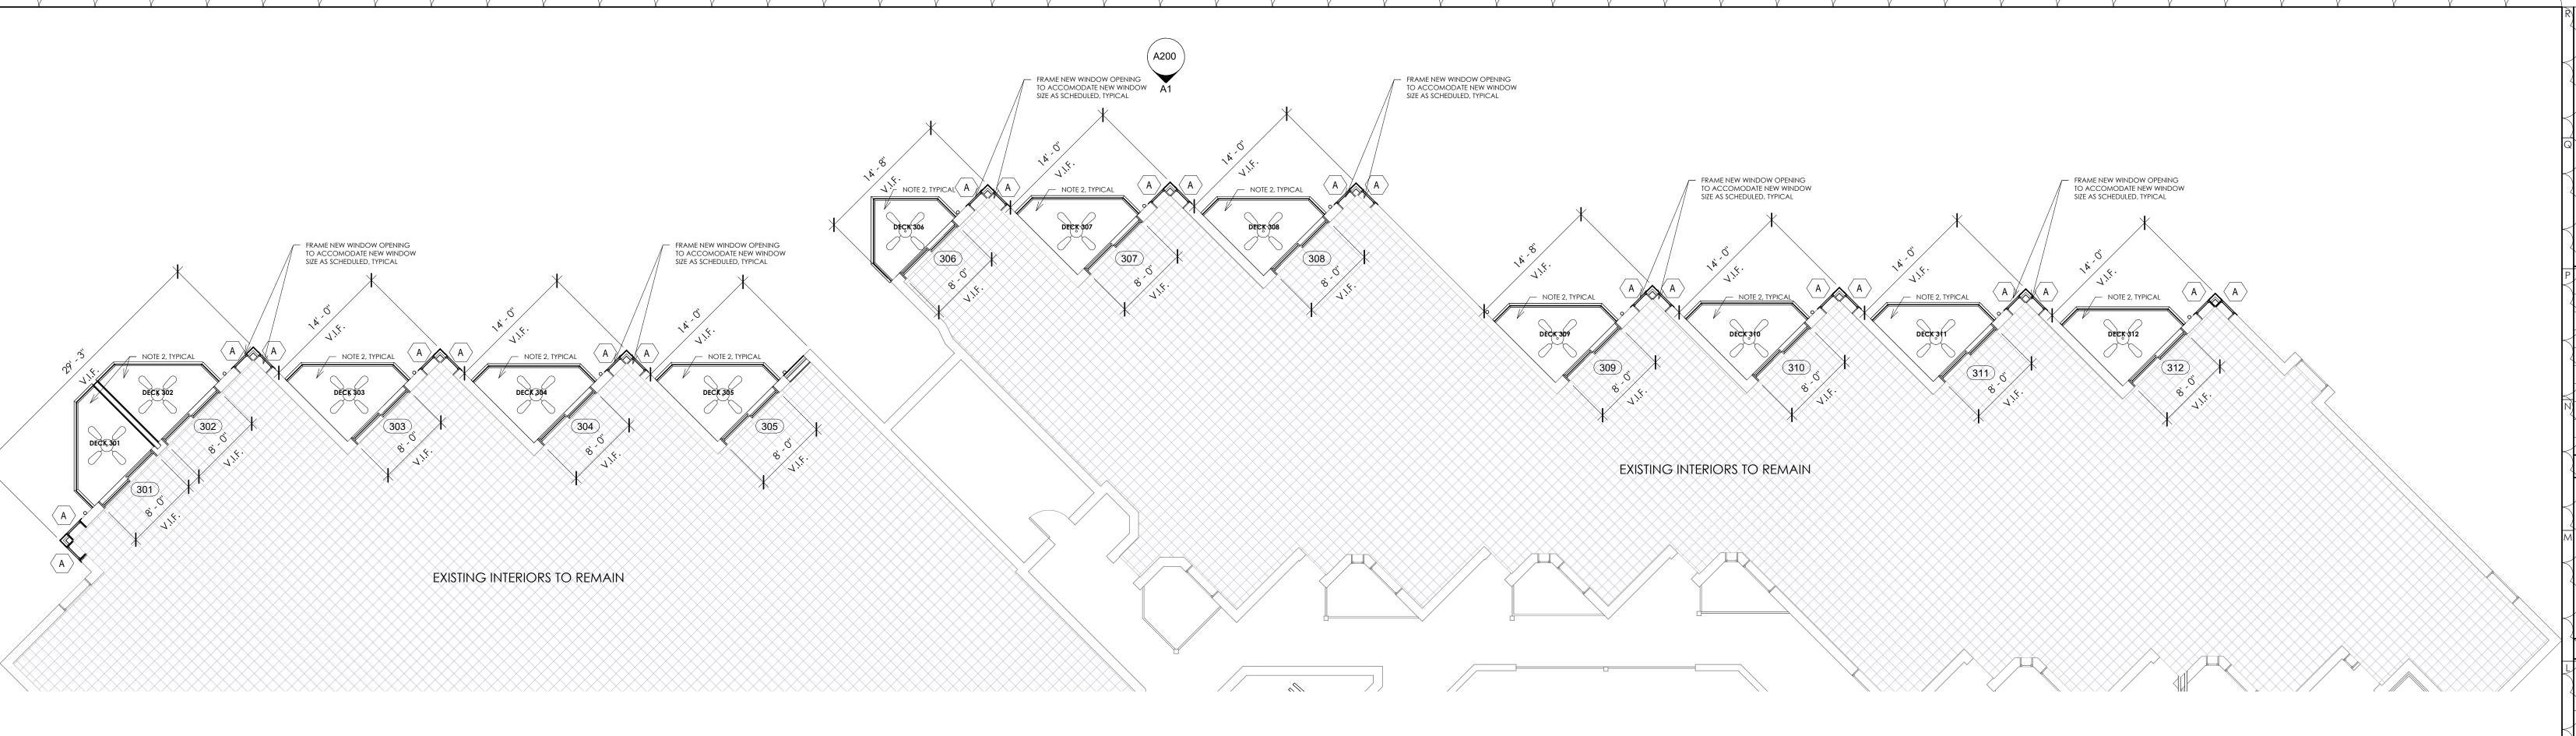

# HARBOR ISLAND CONDOS Building L + M

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#### GENERAL NOTES

1. All dimensions are to face of stud unless noted otherwise.

2. All door openings are 4" from adjacent wall unless noted otherwise.

#### SHEET NOTES

NOTE 1: PROVIDE NEW CONDUIT TO CEILING FAN LOCATION AT THE CENTER OF EACH PORCH ROUTED TO EXISTING PORCH RECEPTACLE LOCATION. CONDUIT SHALL BE NEATLY RUN IN EURRING SPACE WITH BLOCKING PROVIDED BETWEEN JOISTS TO ANCHOR J-BOX. NO SWITCH WILL BE PROVIDED (PULL CHAIN OPERATED FANS ONLY). FANS TO BE PROVIDED BY UNIT OWNERS. PAINT CONDUIT TO MATCH FRAMING.

NOTE 2: NEW HARDI SOFFIT AND CEILING AT THIRD FLOOR PORCHES.

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FLOOR PLANS -BUILDING L - 2ND & 3RD FLOOR

SGS

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A102

SECOND FLOOR - BUILDING L - PROPOSED




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FOR CONSTRUCTION

#### GENERAL NOTES

1. GC TO VERIFY THAT ALL WALLS ARE NON-LOAD BEARING PRIOR TO REMOVAL. Should a wall be determined as load bearing, alert architect immediately and leave wall in place for field verification.

#### SHEET NOTES

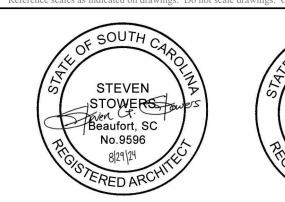**NOTE 1:** GC to provide temporary shoring (as necessary) to provide temporary support to roof structure during work on the porches.





#### BUILDING L ELEVATIONS


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09/24/2024
Drawn By MNC
Checked By SGS


A200

BUILDING L - PROPOSED - OCEANSIDE ELEVATION

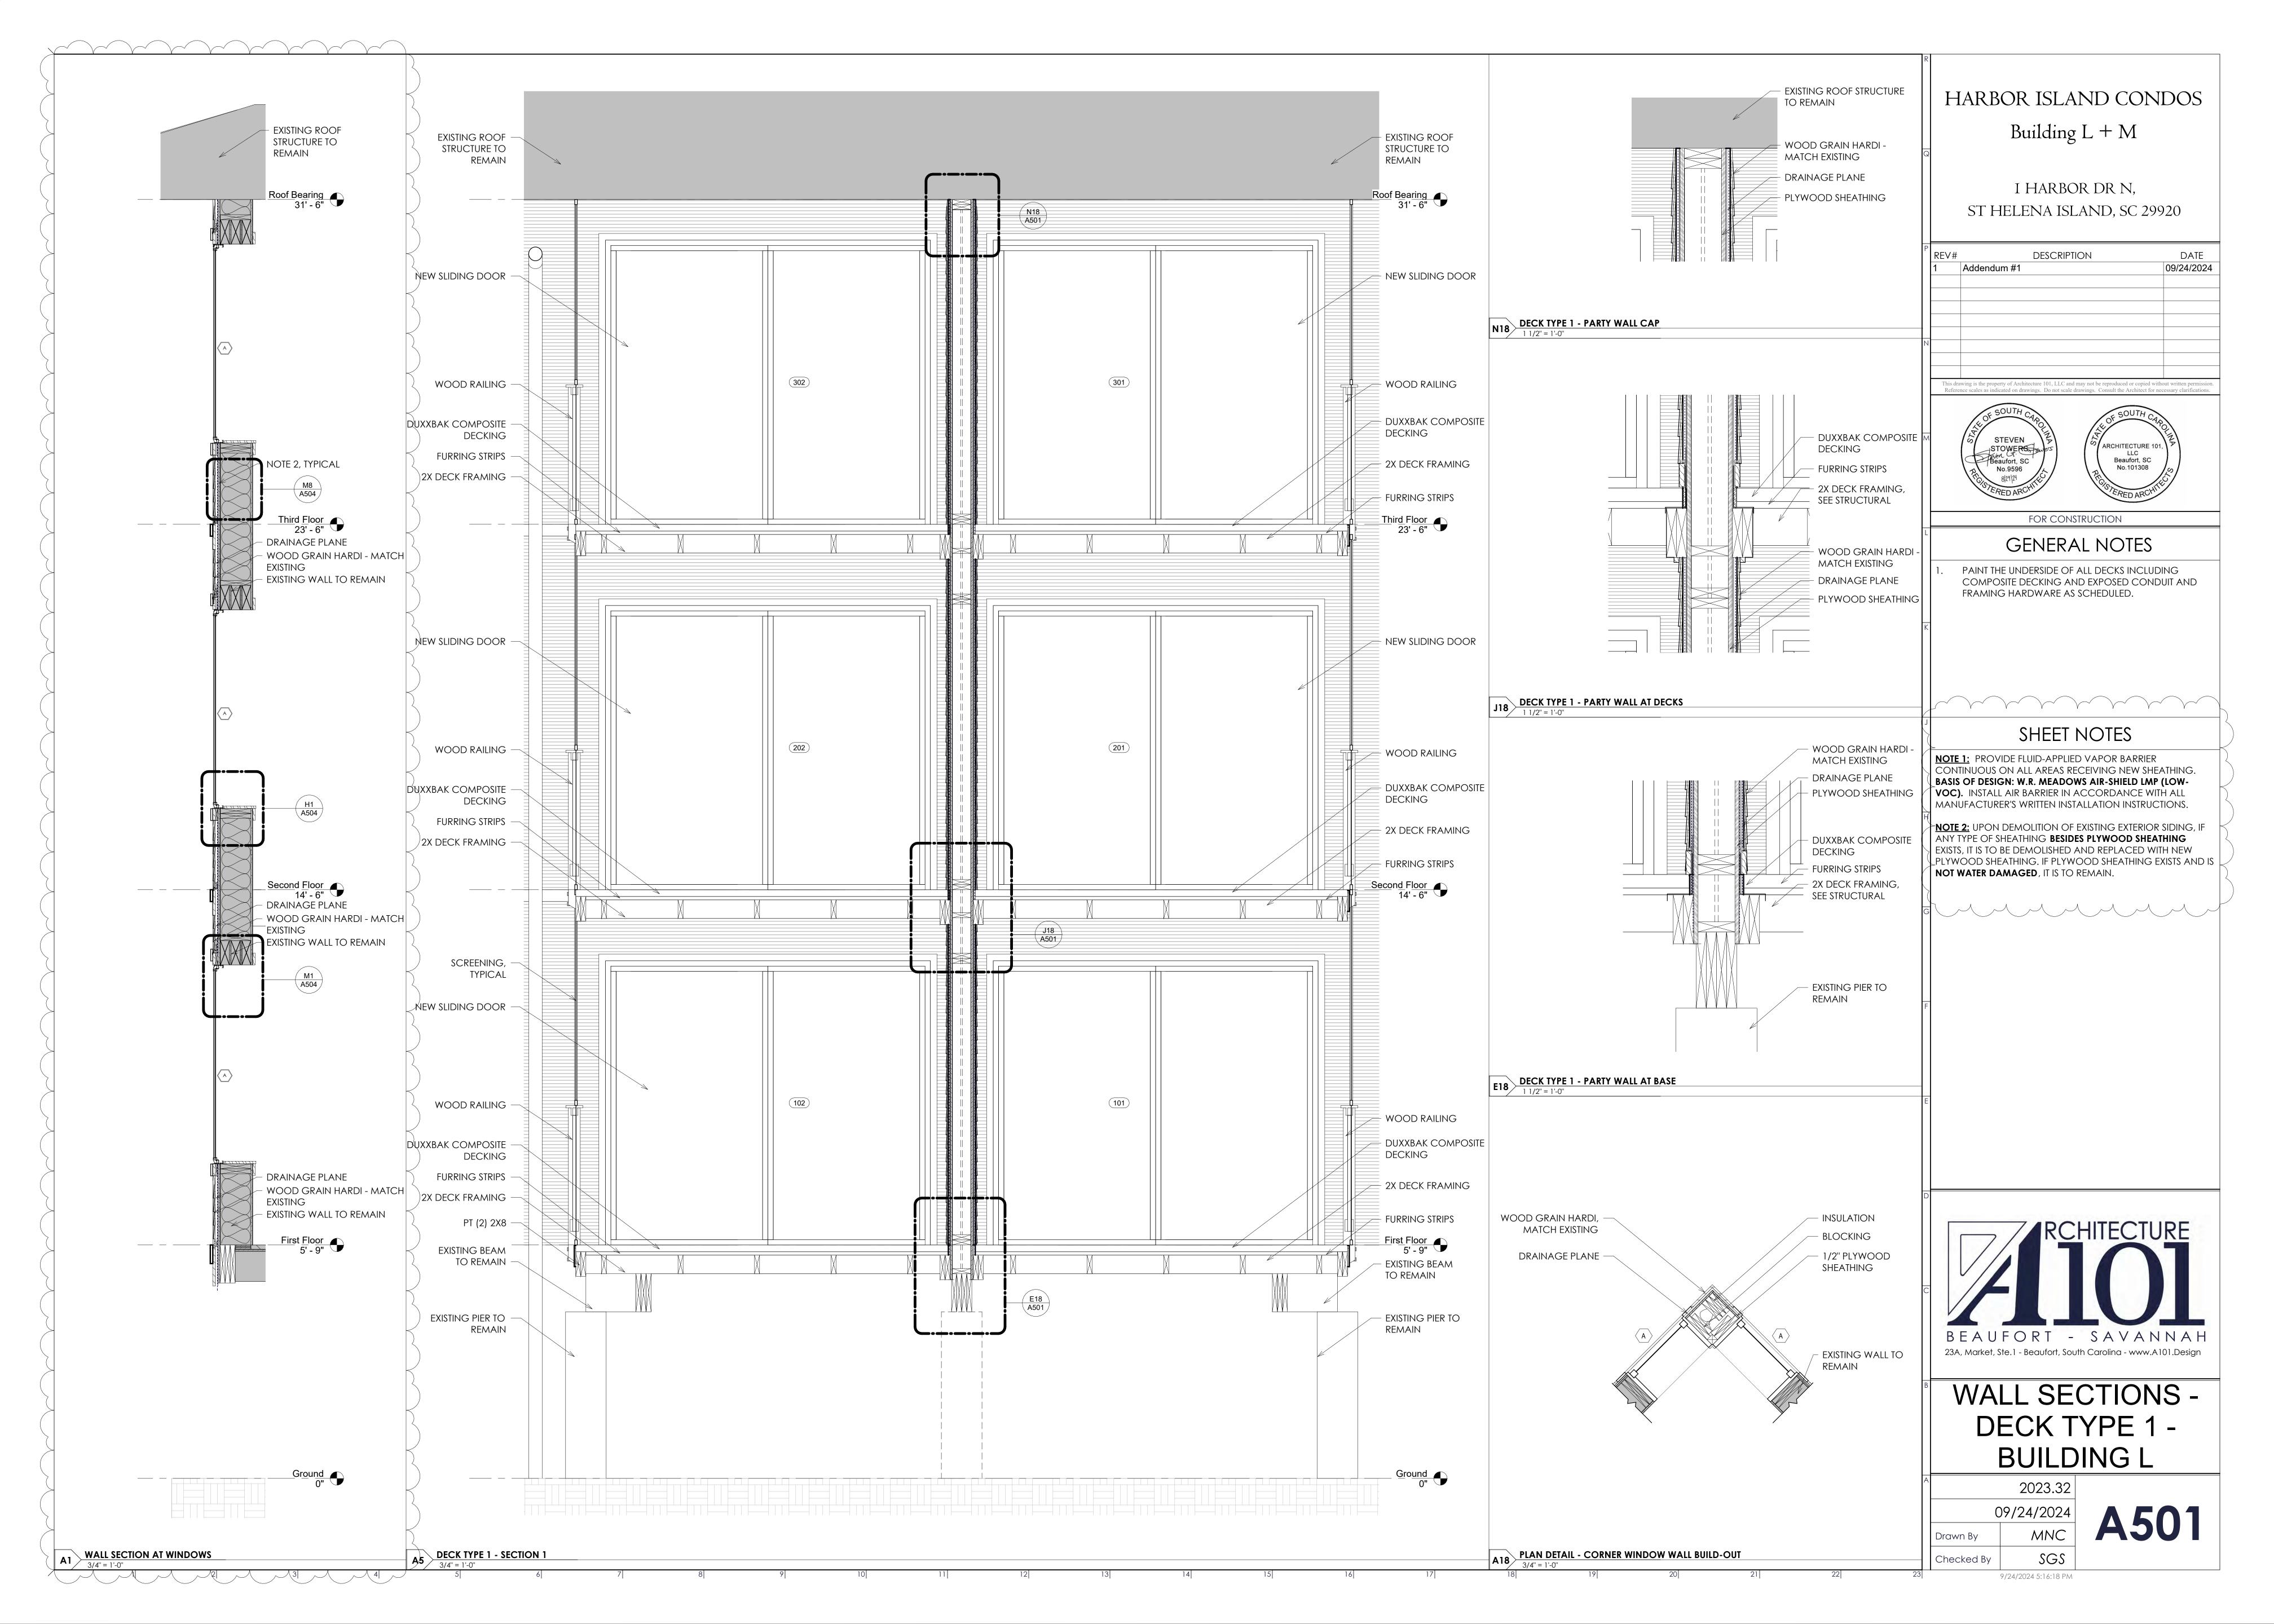

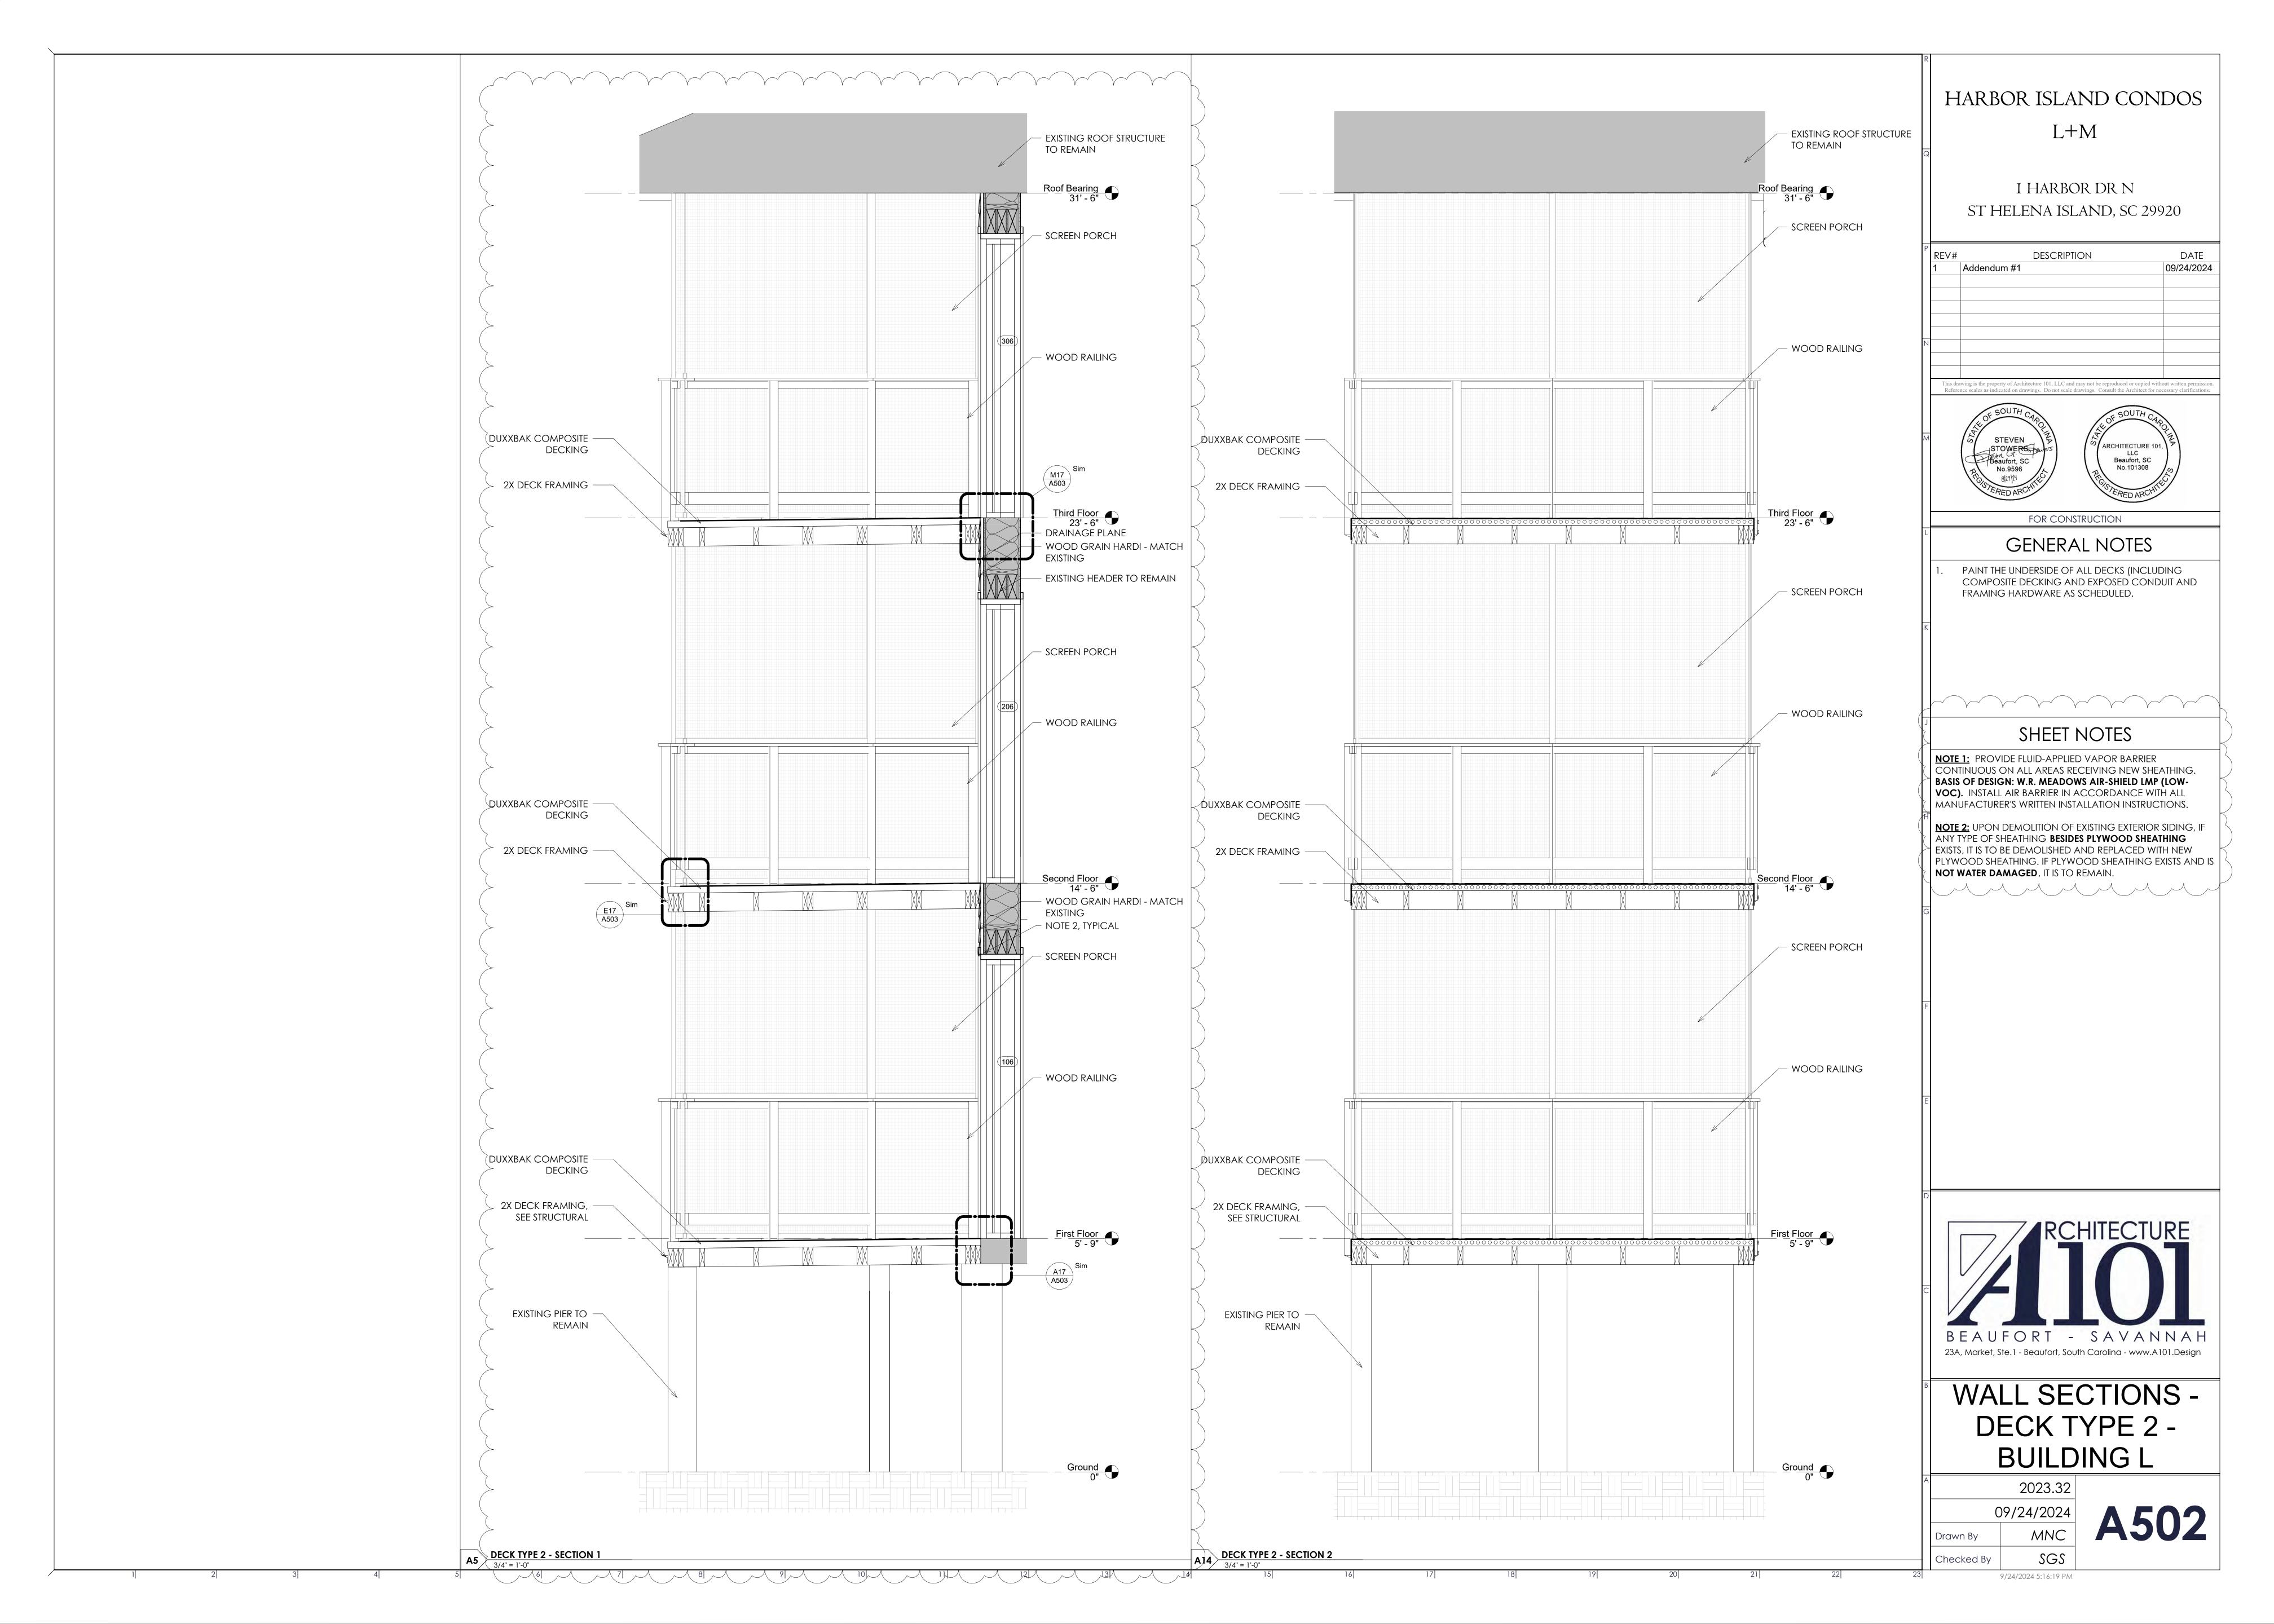

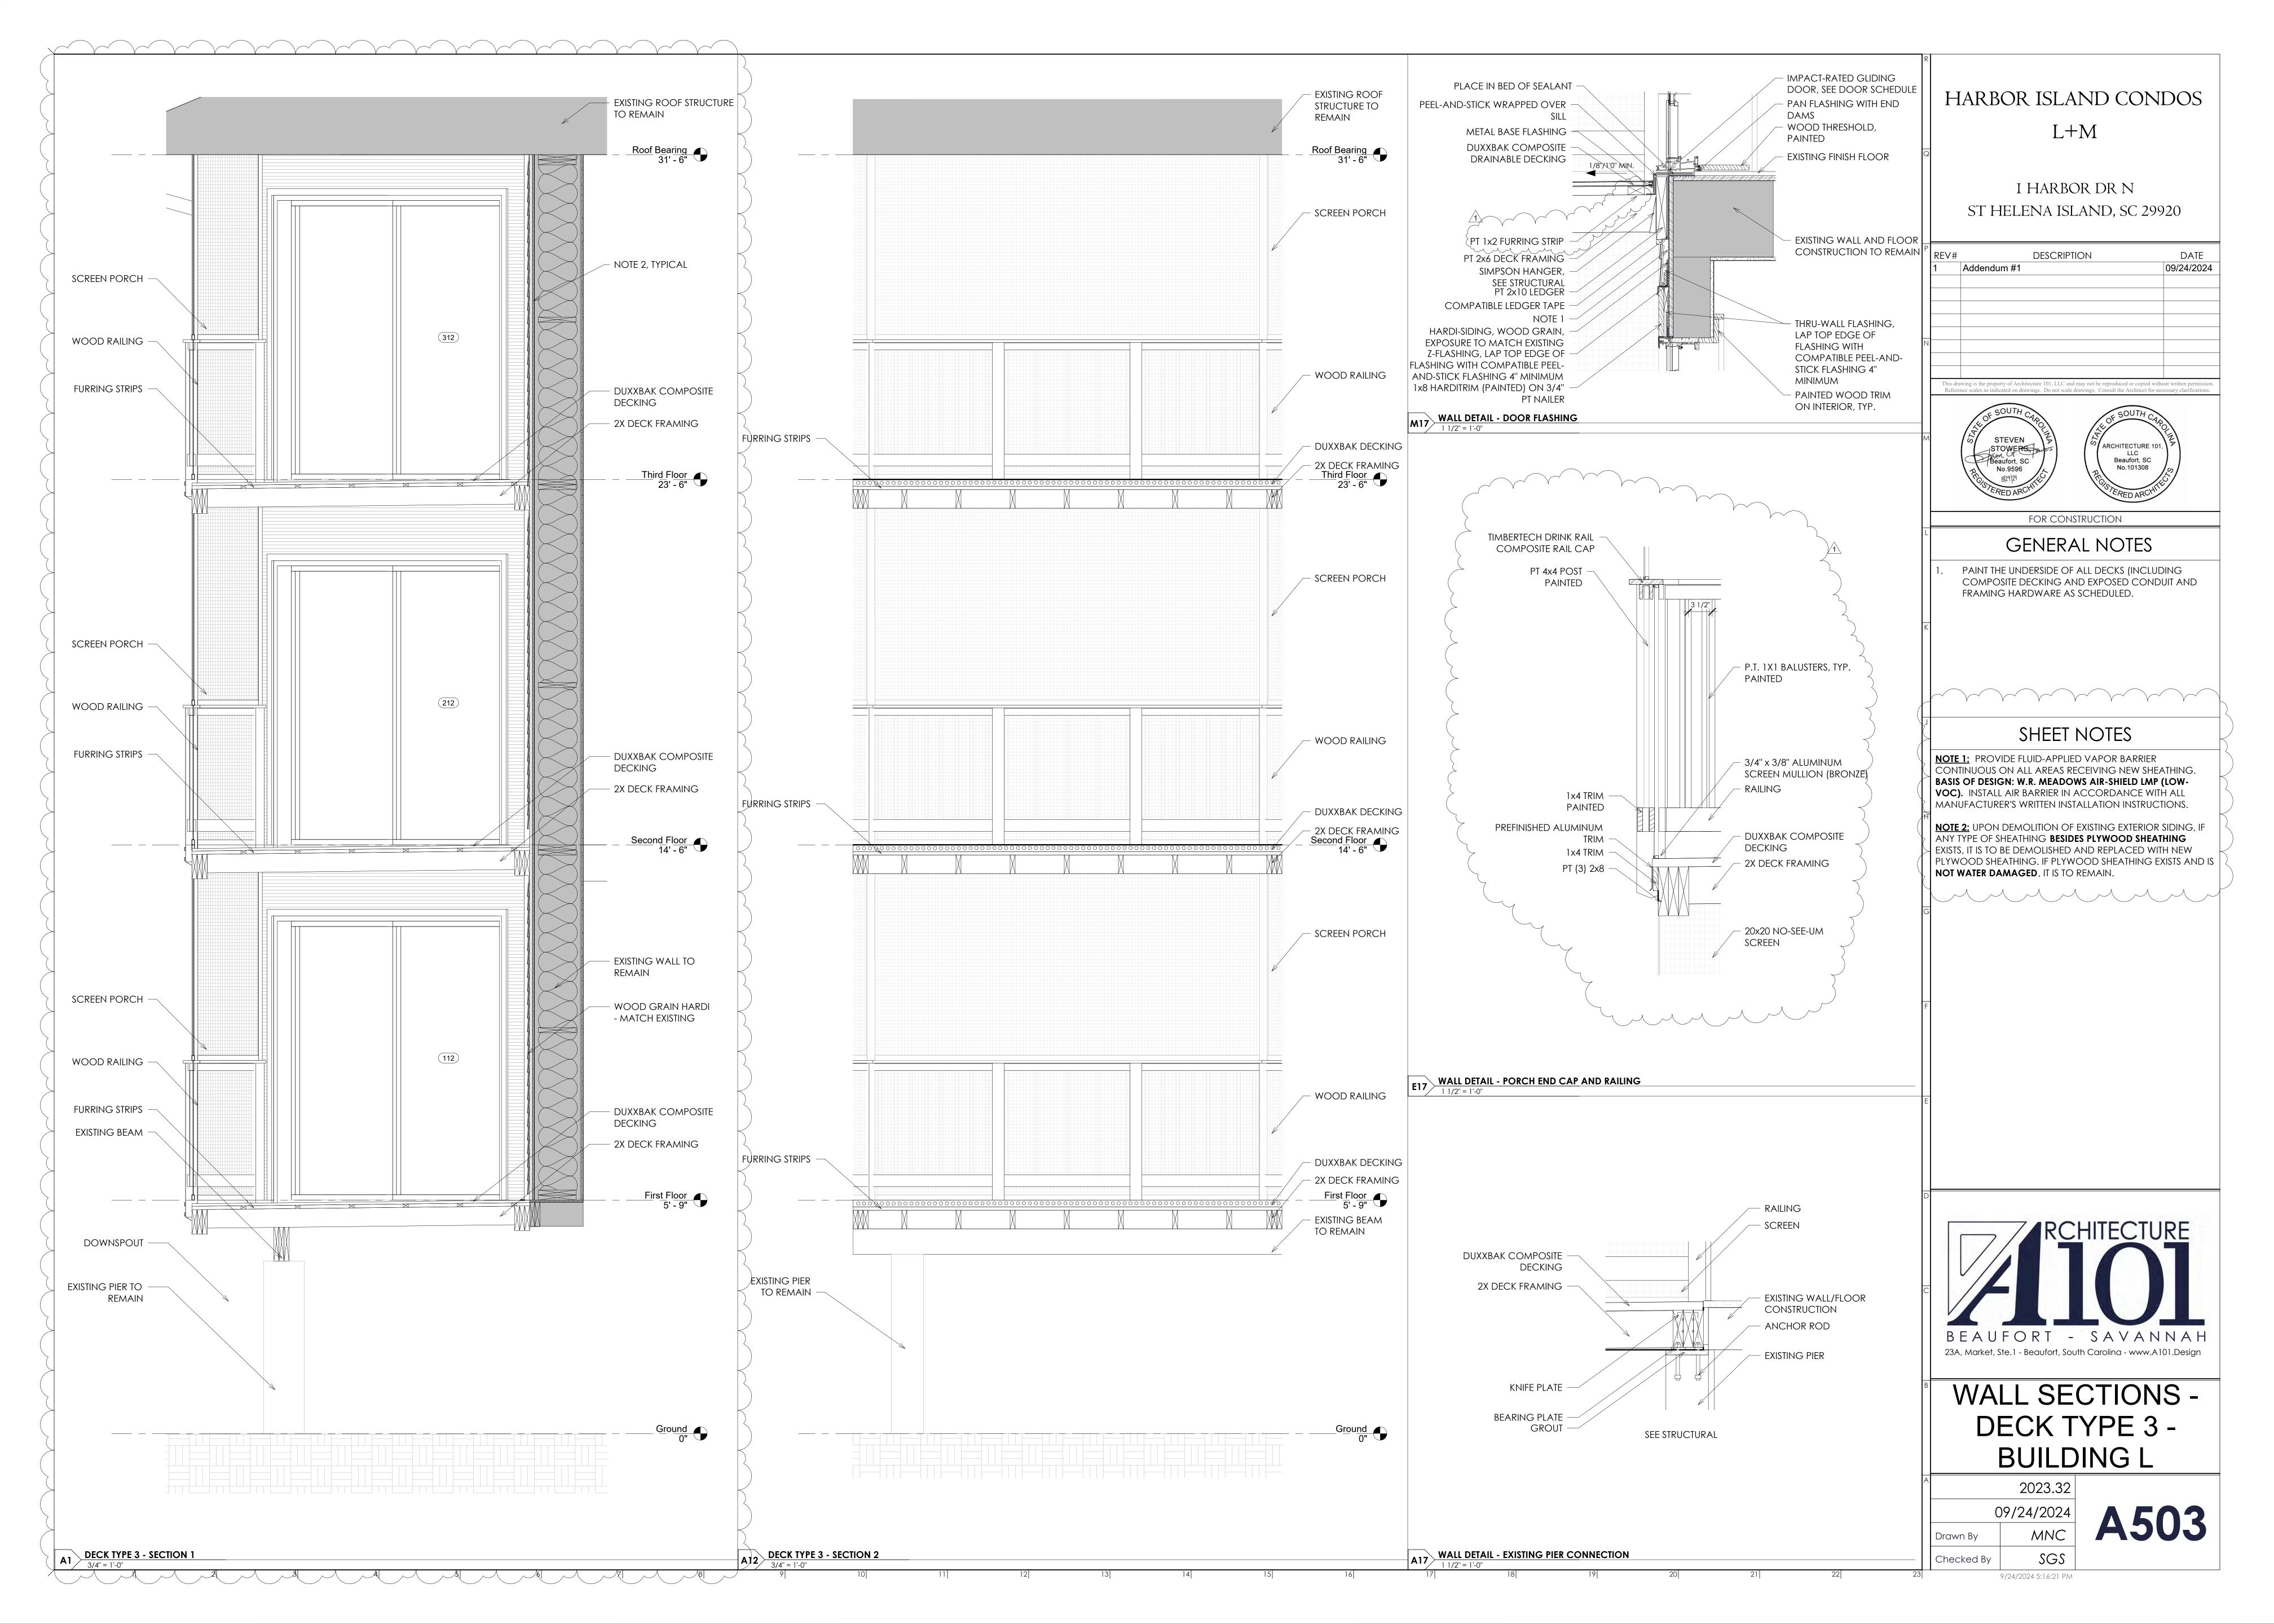

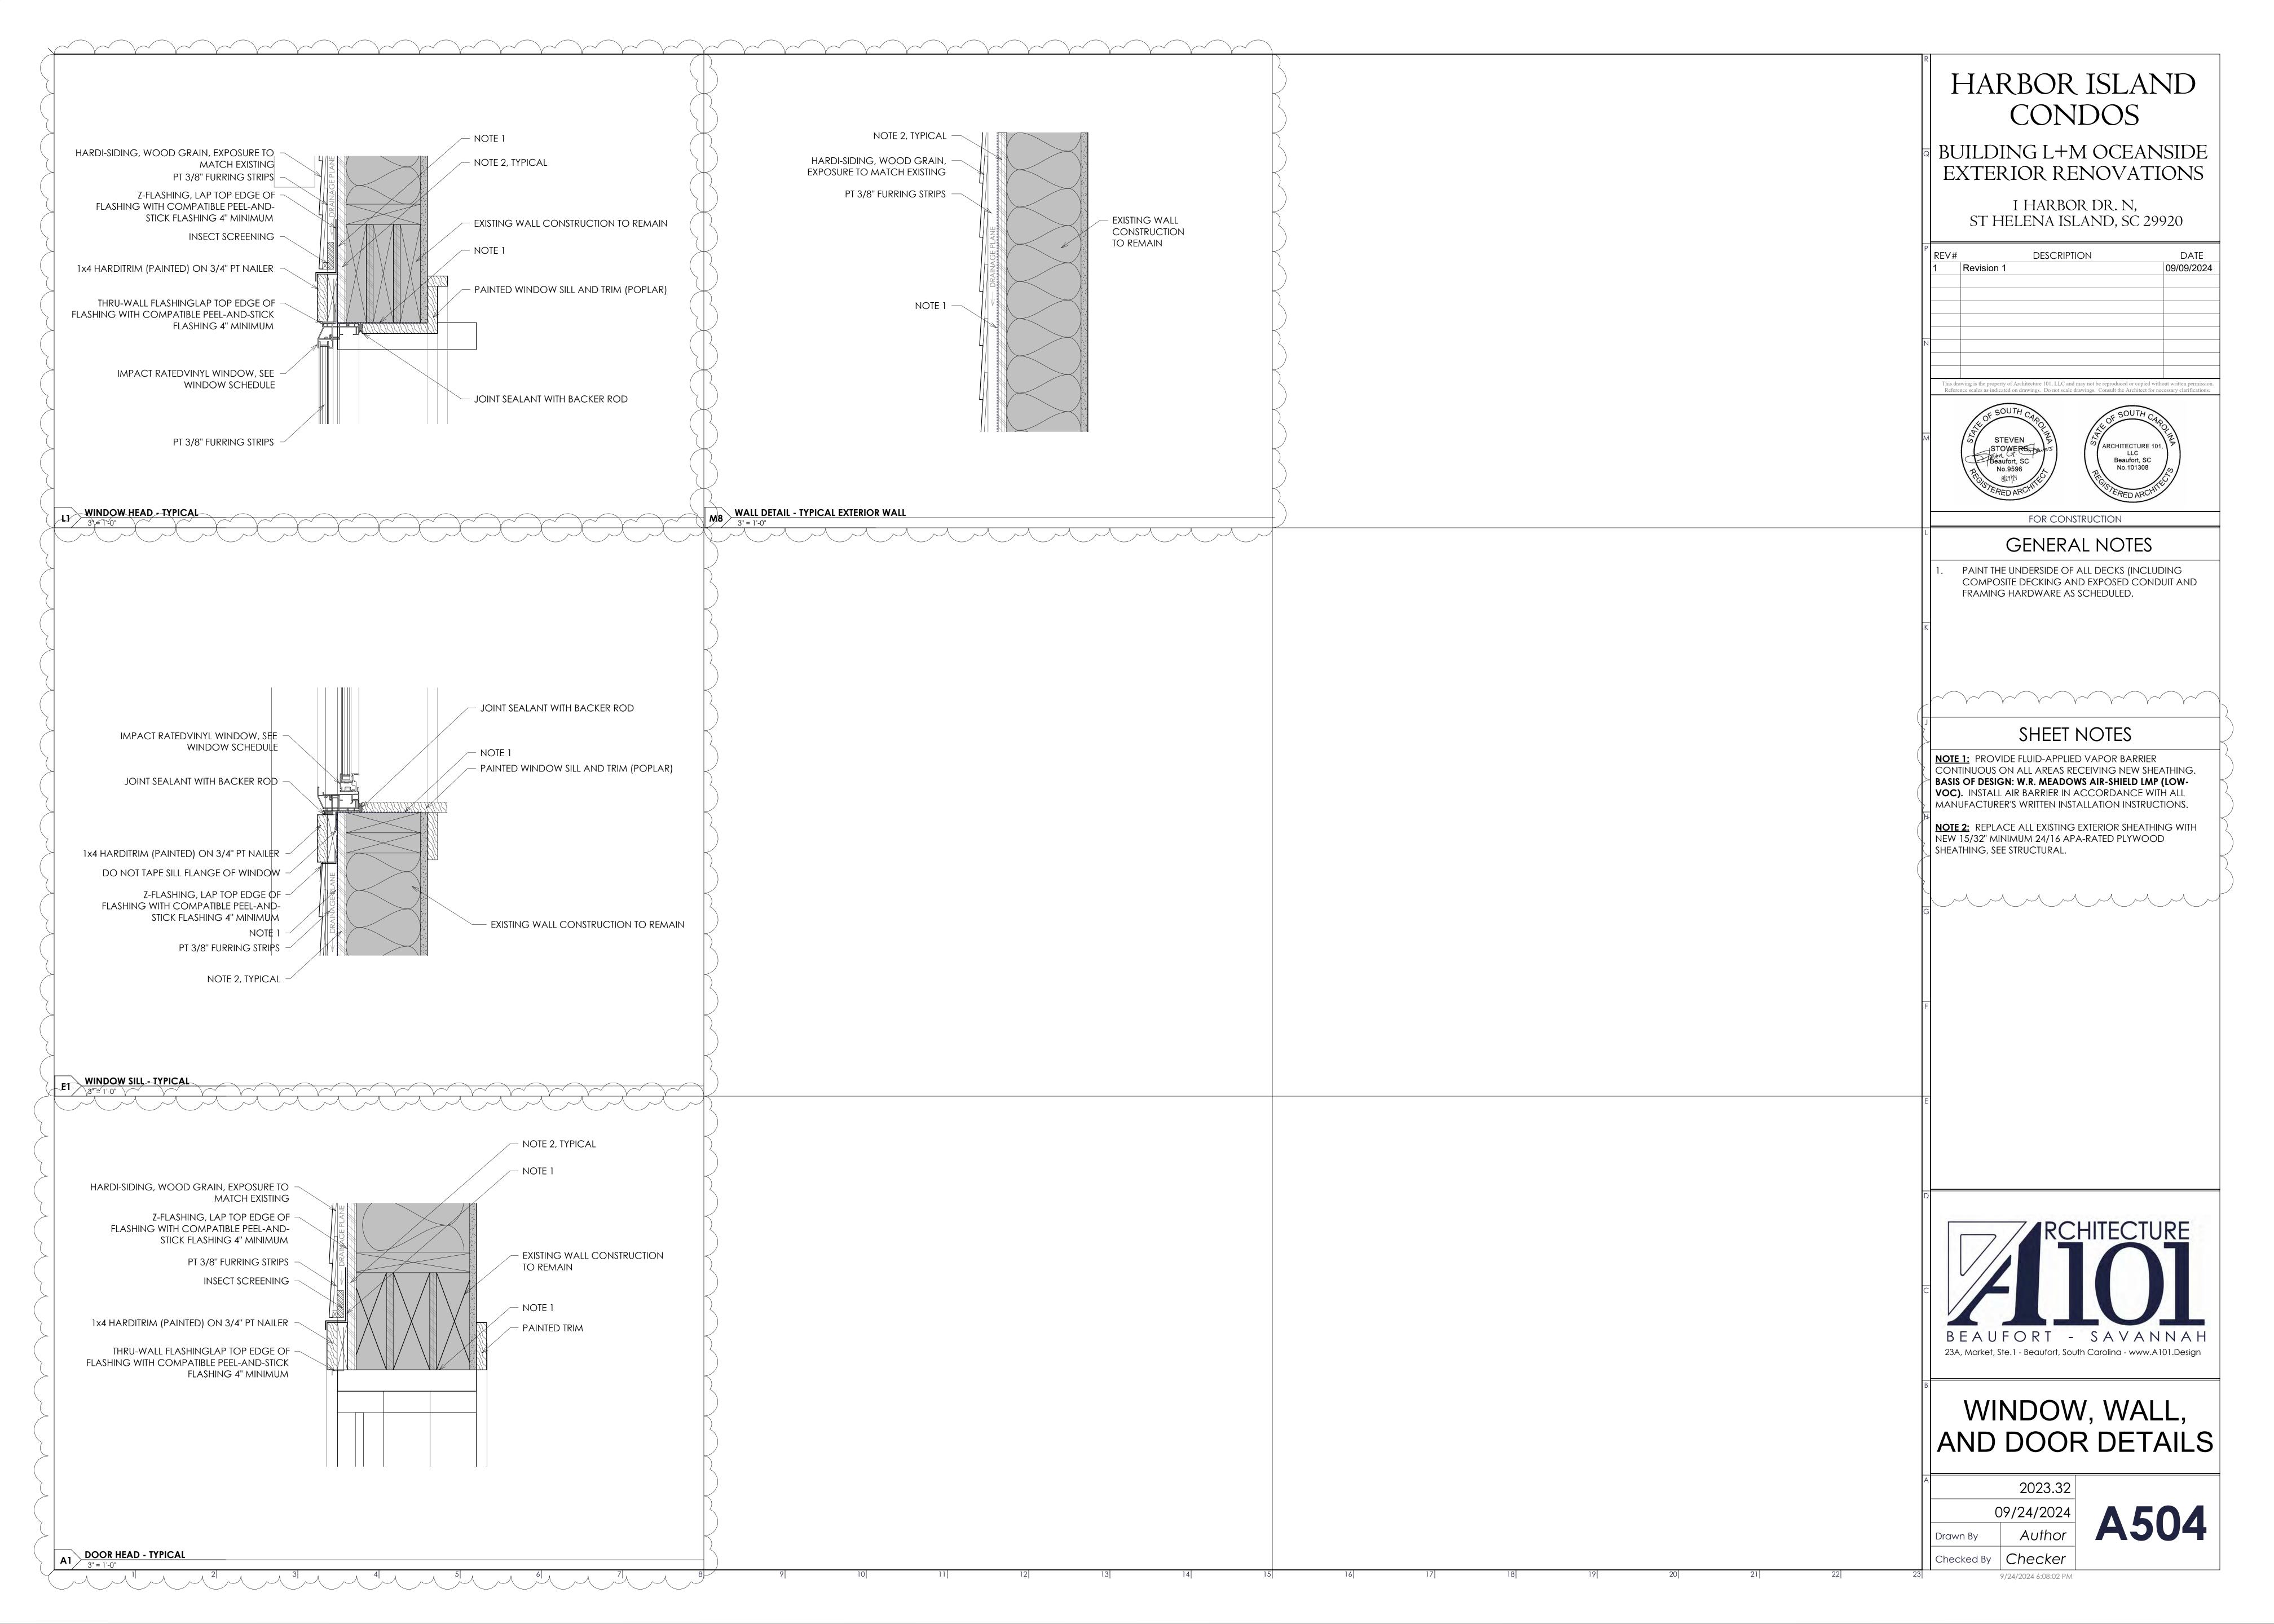

# BUILDING 'M' OCEANSIDE RENOVATIONS



#### HARBOR ISLAND CONDOS

BUILDING L+M OCEANSIDE EXTERIOR RENOVATIONS

I HARBOR DR. N, ST HELENA ISLAND, SC 29920

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1		





FOR CONSTRUCTION

PROPERTY INFORMATION

ADDRESS: 1 Harbor Dr. N, St. Helena Island, SC 29920

PIN: R300 020 00A 121B 0000 ZONING: PUD (Existing Planned Unit Development)

#### DRAWING INDEX BUILDING LOCATION MAP CONTACT INFORMATION


Sheet Num	mber Sheet Name	Sheet Issue Date
		·
GENERAL -	- BUILDING M	
G000	COVER SHEET	09/24/24
G101	BUILDING M 3D VIEWS	09/24/24
DEMOLITIO	DN - BUILDING M	
D101	DEMO PLANS - BUILDING M	09/24/24
D102	DEMO ELEVATIONS - BUILDING M	09/24/24
$\overline{\gamma}$	$\sim$	
STRUCTURA	AL - BUILDING M $\int_{-\infty}^{\infty}$	
S001	STRUCTURAL NOTES 2	09/24/24
\$101	PORCH FRAMING PLANS - BUILDING M	09/24/24
S301	PORCH SECTIONS - BUILDING M	09/24/24
ARCHITECT	TURAL - BUILDING M	
A001	WALL, DOOR, AND WINDOW TYPES	09/24/24
A101	FLOOR PLANS - BUILDING M - FIRST FLOOR	09/24/24
A102	FLOOR PLANS - BUILDING M - SECOND & THIRD	09/24/24
A200	BUILDING M ELEVATIONS	09/24/24
A501	WALL SECTIONS - DECK TYPE 1 - BUILDING M	09/24/24
A502	WALL SECTIONS - DECK TYPE 2 - BUILDING M	09/24/24
A503	SECTION DETAILS - BUILDING M	09/24/24
A504	WINDOW, WALL, AND DOOR DETAILS	09/24/24



ARCHITECT - Architecture 101 Contact: Morgan Cleek Role: Project Manager Phone: (937)-416-9160 Email: morgan@a101.design

STRUCTURAL - 29e6 Contact: Andy Richardson, P.E. Email: andy@2936.co

#### ABBREVIATIONS

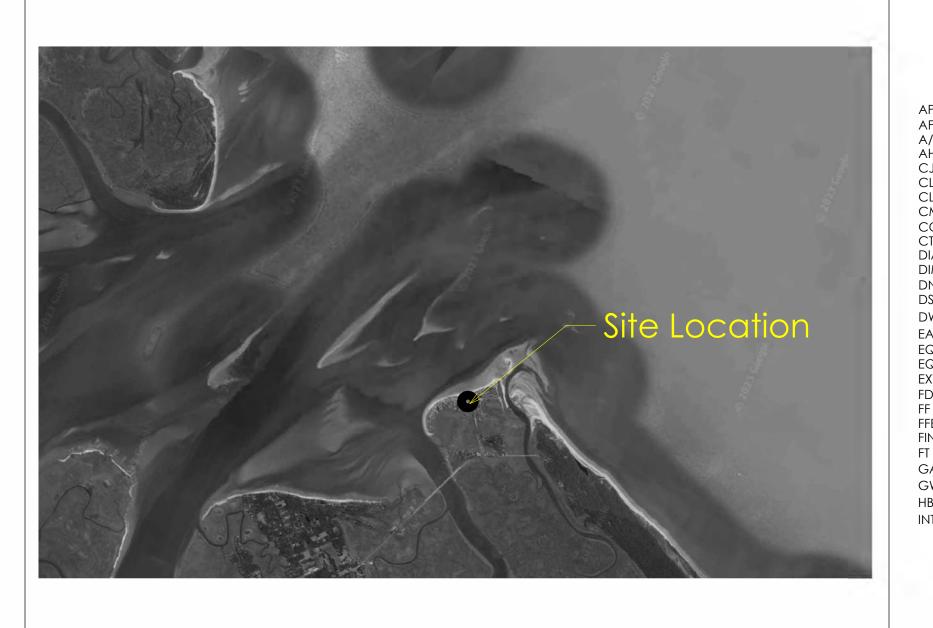

AIR CONDITIONING AIR HANDLING UNIT CONTROL JOINT CONCRETE MASONRY UNIT DOWNSPOUT EXTERIOR FLOOR DRAIN FINISH FLOOR ELEV. GYPSUM WALLBOARD HOSE BIBB INTERIOR

MANUFACTURER MINIMUM MINIMUM
MISCELLANEOUS
MASONRY OPENING
NOT APPLICABLE
NOT IN CONTRACT NOT TO SCALE ON CENTER
OPPOSITE HAND
ORIENTED STRAND BD. PERFORATED PRESSURE TREATED REQUIRED SQUARE FEET SPECIFICATION STANDARD TO BE DETERMINED TONGUE & GROOVE TEMPORARY TELEVISION TYPICAL UNDER COUNTER WASHER/DRYER WOOD WATER HEATER



#### **COVER SHEET**

Α		2023.32
	C	9/24/2024
	Drawn By	MNC
	Checked By	SGS

9/24/2024 5:52:53 PM




I HARBOR DR N, ST HELENA ISLAND, SC 29920

REV#	DESCRIPTION	DATE
N		

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FOR CONSTRUCTION

H1 Building M - Ocenside Right Corner

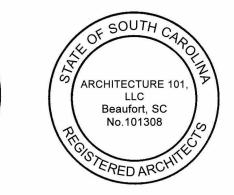



#### BUILDING M 3D VIEWS

Α		2023.32
	C	09/24/2024
	Drawn By	MNC
	Checked By	SGS

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G101

A1 Building M - Oceanside Left Corner




#### HARBOR ISLAND CONDOS

#### BUILDING L+M OCEANSIDE EXTERIOR RENOVATIONS

I HARBOR DR. N, ST HELENA ISLAND, SC 29920

DESCRIPTION



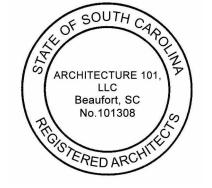

FOR CONSTRUCTION

#### GENERAL NOTES

1. GC TO VERIFY THAT ALL WALLS ARE NON-LOAD BEARING PRIOR TO REMOVAL. Should a wall be determined as load bearing, alert architect immediately and leave wall in place for field verification.

#### GENERAL DEMO. NOTES

1. Contractor to conduct demolition operations as to prevent against damaging existing construction to remain. All damage created by the demolition operation shall be repaired and prepared to receive new finishes. Demolition operation shall be conducted as to prevent personal injury to all persons on site during the life of the demolition and construction phases of the project.

2. Contractor to ensure the security of the building during off construction hours thru-out the life of the project. Security includes but is not limited to prevention from theft, vandalism, and damage by weather conditions.

#### LEGEND

BUILDING COMPONENT TO REMAIN

#### BUILDING COMPONENT TO BE DEMOLISHED

#### DEMOLITION NOTES

1. Remove and dispose of existing wall construction. Included but not limited to all electrical, mechanical, and plumbing hidden within. Prepare for new wall construction

2. Remove and dispose of existing sliding door and all associated hardware. Existing door frame to remain. 3. Remove and dispose of existing deck and all associated framing aside from beams and posts indicated. Prepare for

new deck construction as drawn. 4. Remove and dispose of existing railing. 5. Remove and dispose of existing window and all


associated hardware. Existing window frame to remain. 6. Remove and dispose of existing hardi siding. Sheathing behind hardi siding to remain unless water damaged.



#### DEMO PLANS -**BUILDING M**

2023.32 Drawn By SGS

Checked By

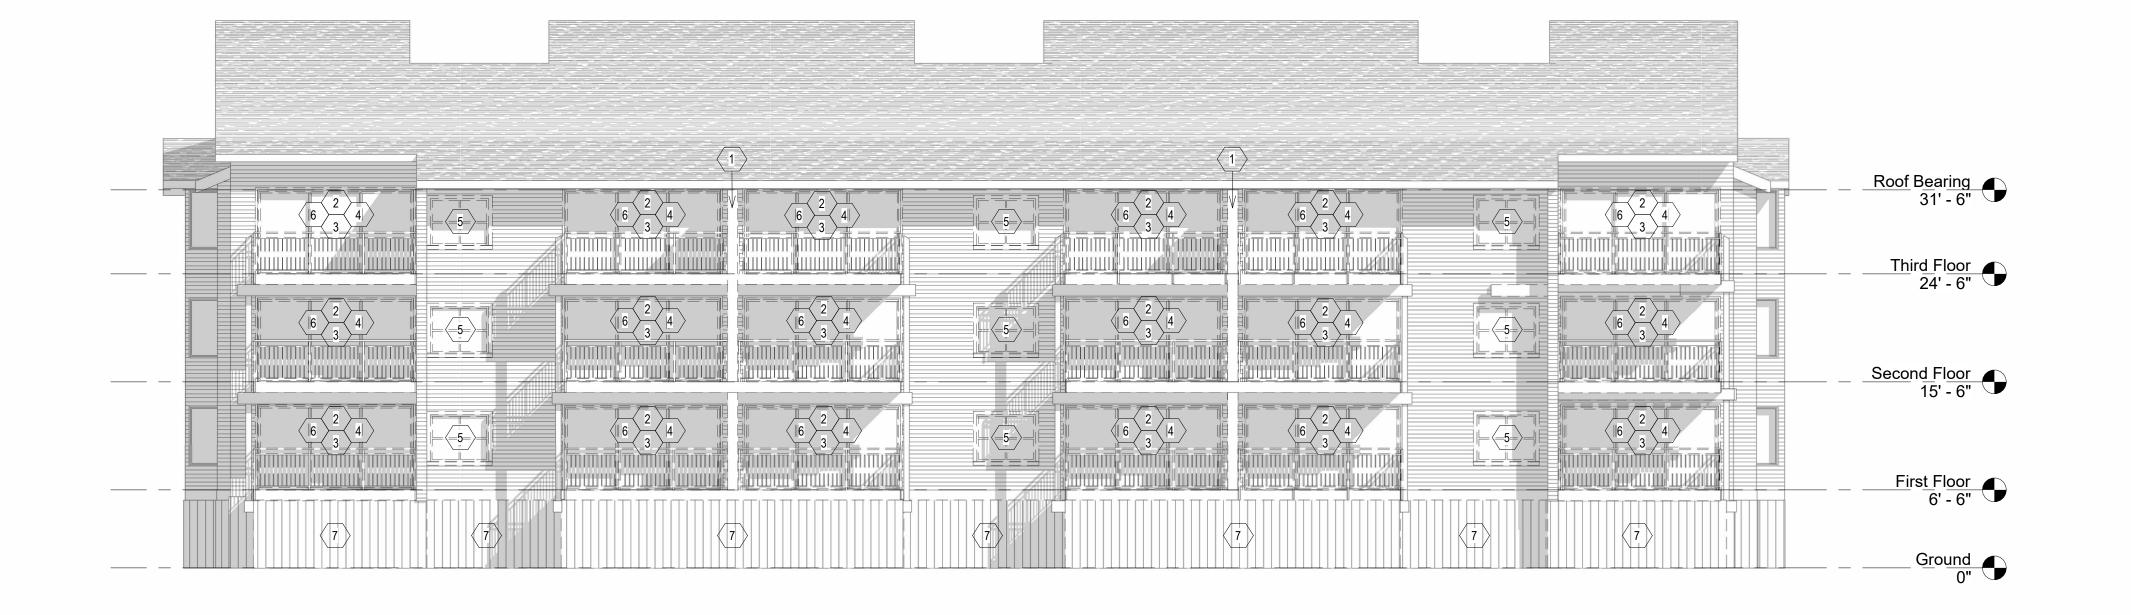

#### **GENERAL DEMOLITION NOTES**

- REMOVAL AS DESCRIBED HEREIN SHALL BE ACCOMPLISHED WITHOUT STORING EXCESSIVE QUANTITIES OF ANY MATERIALS, RUBBISH, DIRT, DEBRIS OR WASTE OF ANY SORT RESULTING FROM THE REMOVAL OPERATIONS IN THE DEMOLITION AREA.
- 2. ALL DEBRIS AND RUBBISH SHALL BE REMOVED FROM THE CONSTRUCTION SITE AS REQUIRED. CONTRACTOR TO COORDINATE ALL RECYCLING AND DISPOSAL OF ALL DEMOLISHED MATERIAL AND EQUIPMENT WITH THE APPROPRIATE WASTE MANAGEMENT AGENCY
- EQUIPMENT WITH THE APPROPRIATE WASTE MANAGEMENT AGENCY PRIOR TO REMOVAL AND DEMOLITION WORK.

  3. THE CONTRACTOR SHALL TAKE ALL PRECAUTIONS TO MAINTAIN PROTECTION FROM ACCESS OF THE PUBLIC THROUGH THE AREAS OF
- 4. ALL DEMOLITION WORK SHALL BE PERFORMED IN ACCORDANCE WITH THE BEST MANAGEMENT PRACTICES.
- 5. THE CONTRACTOR SHALL REVIEW WITH THE OWNER AND ARCHITECT, ANY AND ALL ITEMS OF POSSIBLE DEMOLITION, NOT IMPLIED OR SPECIFIED ON THE DRAWINGS OR SPECIFICATIONS, THAT MAY PREVENT COMPLETION OF DEMO WORK IN ORDER TO COMPLETE THE DEMOLITION PHASE OF WORK.
- 6. JOBSITE SAFETY IS THE SOLE RESPONSIBILITY OF THE CONTRACTOR AND SHALL FOLLOW OSHA STANDARDS DURING THE ENTIRE CONSTRUCTION PROJECT.
- 7. PROVIDE ALL LABOR, MATERIAL, EQUIPMENT AND SERVICES AND PERFORM ALL OPERATIONS REQUIRED FOR COMPLETE EXTERIOR DEMOLITION AND RELATED WORK AS DESCRIBED AND SPECIFIED HEREIN, AND AS MAY BE REASONABLY IMPLIED AS NECESSARY TO COMPLETE THE WORK IN ALL RESPECTS.
- 8. WORK SHALL CONFORM TO THE LATEST EDITION OF ALL APPLICABLE REFERENCE SPECIFICATIONS AND TO THE GOVERNING BUILDING CODES AND REQUIREMENTS OF AUTHORITIES HAVING JURISDICTION.
- 9. JOBSITE INSPECTION MUST BE CONDUCTED TO EXAMINE EXISTING CONDITIONS, TO DETERMINE NATURE AND SCOPE OF WORK OR ANY DISCREPANCIES THAT MIGHT ARISE AT TIME OF WORK. IN ADDITION, EXAMINE ALL WORK THAT IS INTENDED TO REMAIN AS PART OF THE COMPLETED PROJECT AND REPORT ALL UNSATISFACTORY CONDITIONS TO THE OWNER AND ARCHITECT PRIOR TO COMMENCEMENT OF WORK. EXERCISE EXTREME CARE DURING DEMOLITION SO AS NOT TO DAMAGE CONSTRUCTION, OTHER STRUCTURES OR FURNISHINGS THAT ARE INTENDED TO REMAIN. ANYTHING DAMAGED AT TIME OF WORK IS TO BE REPAIRED AND/OR REPLACED TO MATCH EXISTING AT CONTRACTOR'S EXPENSE.
- 10. DURING DEMOLITION, SHOULD ANY WORK AFFECT THE INTEGRITY OF THE STRUCTURE, WORK MUST STOP IMMEDIATELY AND THE OWNER AND ARCHITECT SHALL BE NOTIFIED. UNDER NO CIRCUMSTANCES SHALL REINFORCING OF ANY KIND BE DAMAGED, CUT OR BROKEN.
- DURING DEMOLITION AND CONSTRUCTION.

  12. ALL SHORING NECESSARY FOR TEMPORARY SUPPORT OF EXISTING

11. FIRE ALARM AND LIFE SAFETY COMPONENTS TO REMAIN OPERATIONAL

- WALLS DURING DEMOLITION SHALL BE PROVIDED AND DESIGNED BY THE CONTRACTOR.
- 13. IT IS UNDERSTOOD THAT THE EXISTING BUILDING MAY CONTAIN ASBESTOS OR OTHER HAZARDOUS & TOXIC MATERIAL. THE ARCHITECT'S SERVICES DO NOT INCLUDE ANY SERVICES RELATED TO ASBESTOS OR OTHER HAZARDOUS & TOXIC MATERIAL. IN THE EVENT ANY PARTY ENCOUNTERS SUSPECTED ASBESTOS OR OTHER HAZARDOUS & TOXIC MATERIAL AT THE JOB SITE, OR SHOULD IT BECOME KNOWN IN ANY WAY THAT SUCH MATERIALS MAY BE PRESENT AT THE JOB SITE OR ANY ADJACENT AREAS THAT MAY AFFECT THE PERFORMANCE OF THE WORK, THE OWNER AND THE ARCHITECT MUST BE NOTIFIED IMMEDIATELY IN WRITING. THE ARCHITECT MAY, AT THEIR DISCRETION AND WITHOUT LIABILITY FOR CONSEQUENTIAL OR ANY OTHER DAMAGES, SUSPEND SERVICES UNTIL THE OWNER RETAINS THE APPROPRIATE SPECIALIST CONSULTANTS OR CONTRACTORS TO IDENTIFY, ABATE AND/OR REMOVE ASBESTOS OR OTHER HAZARDOUS & TOXIC MATERIALS AND WARRANT THE JOB SITE IS IN FULL COMPLIANCE WITH APPLICABLE LAWS AND REGULATIONS.

# HARBOR ISLAND CONDOS

## BUILDING L+M OCEANSIDE EXTERIOR RENOVATIONS

I HARBOR DR. N, ST HELENA ISLAND, SC 29920

ST TIEBEL WILD, SC 27720					
REV#	DESCRIPTION	DATE			

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FOR CONSTRUCTION

#### GENERAL NOTES

ARCHITECTURE 101

Beaufort, SC

No.101308

1. GC TO VERIFY THAT ALL WALLS ARE NON-LOAD BEARING PRIOR TO REMOVAL. Should a wall be determined as load bearing, alert architect immediately and leave wall in place for field verification.

#### LEGEND

BUILDING COMPONENT TO REMAIN

 $\equiv$   $\equiv$   $\equiv$  BUILDING COMPONENT TO BE DEMOLISHED

#### DEMOLITION NOTES

- 1. Remove and dispose of existing wall construction. Included but not limited to all electrical, mechanical, and plumbing hidden within. Prepare for new wall construction as drawn.
- 2. Remove and dispose of existing sliding door and all associated hardware. Existing door frame to remain.
  3. Remove and dispose of existing deck and all associated framing aside from beams and posts indicated. Prepare for new deck construction as drawn.
- 4. Remove and dispose of existing railing.
  5. Remove and dispose of existing window and all associated hardware. Existing window frame to remain.
  6. Remove and dispose of existing hardi siding. Sheathing behind hardi siding to remain unless water damaged.
  7. Remove and dispose of existing hog board.



# DEMO ELEVATIONS - BUILDING M

A 2023.32

09/24/2024

Drawn By MNC

Checked By SGS

D102

Building M - Demo - Oceanside Elevation

THIS IS A STRUCTURAL PACKAGE INTENDED TO BRING THIS STRUCTURE TO THE REQUIREMENTS AS SET FORTH IN THE APPLICABLE BUILDING CODE. ANY ITEMS NOT SPECIFIED HEREIN SHALL FOLLOW THE REQUIREMENTS OF THE INTERNATIONAL BUILDING CODE'S PRESCRIPTIVE REQUIREMENTS. SUCH ITEMS MAY INCLUDE DETAILING OF FRAMING CONNECTIONS. SIZES OF MEMBERS. MATERIAL SPECIFICATIONS. AND OTHER REQUIREMENTS RELATED TO THE STRUCTURE. WHERE MANUFACTURED PRODUCTS ARE USED, THE DETAILING AS ESTABLISHED BY THE MANUFACTURER SHALL BE USED.

#### STRUCTURAL DESIGN SPECIFICATIONS

- REFERENCE CODE
  - A. 2021 INTERNATIONAL BUILDING CODE WITH APPLICABLE STATE AMENDMENTS
- MINIMUM DESIGN LOADS FOR BUILDINGS AND OTHER STRUCTURES DURING CONSTRUCTION ARE REQUIRED PER ASCE STANDARD NO.37-02 "DESIGN LOADS ON STRUCTURES DURING CONSTRUCTION"

15 PSF

#### BUILDING DESIGN LOADS

- A. LIVE LOAD INFORMATION 1. FLOOR LIVE LOAD:
- FLOOR DEAD LOAD:

DEAD LOAD INFORMATION

- WIND LOAD INFORMATION DESIGN WIND SPEED = 145 MPH
- WIND IMPORTANCE FACTOR  $(I_W) = 1.0$ 
  - RISK CATEGORY = II WIND EXPOSURE = D
  - INTERNAL PRESSURE COEFFICIENT = +/- 0.18
  - COMPONENTS AND CLADDING = AS FOLLOWS WIND PRESSURES ARE REPORTED AT ASD LEVEL.
  - SEE ALSO FIGURE 1 (THIS PAGE).
  - a. ROOF ZONE 1 -79 PSF ZONE 2: ZONE 3
  - WALLS ZONE 4 -20 PSF ZONE 5 -23 PSF
- SEISMIC DESIGN INFORMATION RISK CATEGORY = II
- SEISMIC IMPORTANCE FACTOR ( $I_E$ ) = 1.0
- 0.2 SECOND SPECTRAL RESPONSE ACCELERATION (S<sub>S</sub>) = 0.8421 SECOND SPECTRAL RESPONSE ACCELERATION ( $S_1$ ) = 0.263
- SITE CLASS = D 0.2 SECOND DESIGN SPECTRAL RESPONSE ACCELERATION (SDS) =
- 1 SECOND DESIGN SPECTRAL RESPONSE ACCELERATION (S<sub>D1</sub>) =
- 0.364 SEISMIC DESIGN CATEGORY = D
- LATERAL FORCE RESISTING SYSTEM / RESPONSE MODIFICATION COEFFICIENT (R)
- LIGHT FRAMED WOOD WALLS SHEATHED WITH WOOD STRUCTURAL PANELS (6.5)
- DESIGN BASE SHEAR  $(V_C) = W^*C_S$
- SEISMIC RESPONSE COEFFICIENT (C<sub>S</sub>) = 0.104
- ANALYTICAL PROCEDURE = EQUIVALENT LATERAL FORCE

#### **GENERAL**


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- 1. THE INTENT OF THESE DRAWINGS IS TO SHOW ALL ITEMS NECESSARY TO COMPLETE THE STRUCTURE. FOR ITEMS, METHODS, AND/OR MATERIALS NOT SHOWN, THE MINIMUM REQUIREMENTS OF THE REFERENCE CODE SHALL GOVERN. ALL WORK AND CONSTRUCTION SHALL COMPLY WITH ALL OTHER APPLICABLE BUILDING CODES, SOIL REPORTS, REGULATIONS, AND SAFETY REQUIREMENTS.
- THROUGHOUT THESE DRAWINGS, THE TERM ENGINEER REFERS TO THE ENGINEER OF RECORD FOR THIS PROJECT. OTHER ENGINEERING DISCIPLINES WILL BE EXPLICITLY DESCRIBED. THE TERM ARCHITECT REFERS TO THE ARCHITECT OF RECORD FOR THIS PROJECT.
- PLAN NORTH IS EXPLICITLY CALLED OUT ON THE SHEETS. TRUE NORTH IS TO BE INDICATED ON THE SPECIFIC PLANS WHERE APPLICABLE PER AN APPROVED SITE PLAN. PLAN NORTH IS FOR COORDINATION PURPOSES AND NOT FOR BUILDING LOCATION.
- 4. METHODS, MEANS, AND MATERIALS ARE EXPLICITLY CALLED OUT IN THESE NOTES. ANY DEVIATION OR PROPOSED CHANGE IS TO BE COMMUNICATED IMMEDIATELY TO THE ENGINEER. NO DEVIATION OR CHANGE IS ACCEPTABLE WITHOUT WRITTEN APPROVAL BY THE ENGINEER.
- IT SHALL BE THE CONTRACTOR'S SOLE RESPONSIBILITY TO DESIGN AND PROVIDE ADEQUATE SHORING, BRACING, FORMWORK, ETC. AS REQUIRED FOR THE PROTECTION OF LIFE AND PROPERTY DURING THE CONSTRUCTION OF THE BUILDING. SHORING AND TEMPORARY BRACING SHALL REMAIN IN PLACE UNTIL FLOORS, ROOF, AND LATERAL BRACING SYSTEMS HAVE BEEN ENTIRELY CONSTRUCTED, OR UNTIL THE PARTIALLY BUILT STRUCTURE IS PROVEN SAFE AND STABLE BY A REGISTERED ENGINEER ENGAGED BY THE CONTRACTOR. SHORING DRAWINGS AND CALCULATIONS SHALL BE SEALED BY A REGISTERED ENGINEER AND SUBMITTED TO THE ARCHITECT / ENGINEER FOR REVIEW. MINIMUM DESIGN LOADS FOR BUILDINGS AND OTHER STRUCTURES DURING CONSTRUCTION SHALL BE MAINTAINED PER ASCE STANDARD NO. 37-02 "DESIGN LOADS ON STRUCTURES DURING CONSTRUCTION."
- THE CONTRACTOR SHALL CHECK AND VERIFY ALL DIMENSIONS WITH THE ARCHITECTURAL, CIVIL, ELECTRICAL, AND MECHANICAL DRAWINGS BEFORE PREPARING SHOP DRAWINGS, FABRICATION, OR CONSTRUCTION. SEE ARCHITECTURAL, CIVIL, ELECTRICAL, AND MECHANICAL DRAWINGS FOR SIZE AND LOCATIONS OF PIPES. SLEEVES. PITS. VENTS. DUCTS. ROOF OPENINGS. TRENCHES, EQUIPMENT PADS, MISCELLANEOUS IRON, AND/OR ANY DETAILS NOT SHOWN ON THE STRUCTURAL DRAWINGS.
- CONSTRUCTION MATERIALS SHALL BE SPREAD OUT IF PLACED ON FRAMED ROOF OR FLOOR. THE LOAD SHALL NOT EXCEED THE DESIGN LOADS PER SQUARE FOOT. PROVIDE ADEQUATE SHORING AND/OR BRACING WHERE STRUCTURE HAS NOT ATTAINED DESIGN STRENGTH.
- ALL DRAWINGS ARE CONSIDERED TO BE A PART OF THE CONTRACT DOCUMENTS. DRAWINGS ARE NOT CONSIDERED ISSUED FOR CONSTRUCTION UNTIL THE ENGINEER HAS SIGNED AND SEALED EACH SHEET. THE CONTRACTOR SHALL BE RESPONSIBLE FOR THE REVIEW AND COORDINATION OF ALL DRAWINGS AND SPECIFICATIONS PRIOR TO THE START OF CONSTRUCTION. ANY DISCREPANCIES THAT OCCUR SHALL BE BROUGHT TO THE ATTENTION OF THE ARCHITECT PRIOR TO START OF CONSTRUCTION SO THAT A CLARIFICATION CAN BE ISSUED. ANY WORK PERFORMED IN CONFLICT WITH THE CONTRACT DOCUMENT OR ANY CODE REQUIREMENTS SHALL BE CORRECTED BY THE CONTRACTOR AT THEIR OWN EXPENSE AND AT NO EXPENSE TO THE OWNER, ARCHITECT, OR ENGINEER.
- NOTES AND DETAILS ON DRAWING SHALL TAKE PRECEDENCE OVER GENERAL NOTES AND TYPICAL DETAILS. WHERE NO NOTE OR DETAIL IS GIVEN, CONSTRUCTION SHALL BE PER TYPICAL STRUCTURAL, MANUFACTURER, OR ARCHITECTURAL DETAIL.
- 10. OPENINGS, POCKETS, ETC. LARGER THAN 6" SHALL NOT BE PLACED IN CONCRETE SLABS, DECKS, OR WALLS UNLESS SPECIALLY DETAILED ON THE STRUCTURAL DRAWINGS. NOTIFY THE ENGINEER WHEN DRAWINGS BY OTHERS SHOW OPENINGS, POCKETS, ETC. LARGER THAN 6" THAT ARE NOT SHOWN ON THE STRUCTURAL DRAWINGS BUT ARE LOCATED IN STRUCTURAL MEMBERS. FOR ANY FURTHER RESTRICTIONS ON OPENINGS IN STRUCTURAL ELEMENTS, SEE APPLICABLE SECTIONS BELOW.


#### GENERAL NOTES (CONT.)

- 11. PIPES LARGER THAN 1-1/2" DIAMETER SHALL NOT BE EMBEDDED IN STRUCTURAL CONCRETE EXCEPT WHERE SPECIFICALLY APPROVED.
- 12. ALL CONTRACTOR DESIGNED ELEMENTS SHALL BE DESIGNED BY A LICENSED PROFESSIONAL ENGINEER. CONTRACTOR SHALL SUBMIT CALCULATIONS CERTIFYING THAT ELEMENTS ARE DESIGNED FOR THE STATED UNFACTORED LOADS.
- 13. ALL TESTING AND INSPECTION OF WELDS SHALL BE DONE BY AN INDEPENDENT TESTING SERVICE ACCEPTABLE TO THE ENGINEER AND SHALL CONFORM TO THE LATEST EDITION OF ANSI/AWS 01.1. WELD INSPECTORS ARE TO BE AWS CERTIFIED.
- 14. ANY SLOPE SHALL BE CONSTRUCTED AT A MAXIMUM GRADIENT OF 2:1 (HORIZONTAL TO VERTICAL). FILL AND CUT SLOPES SHOULD BE VEGETATED AS SOON AS POSSIBLE TO MINIMIZE EROSION OF SOIL.
- 15. ANY VERTICAL SOIL CUTS MUST BE PROVIDED WITH PROPER SHORING TO PROTECT WORKERS AND ADJACENT PROPERTY. THE CONTRACTOR SHALL BE SOLELY RESPONSIBLE FOR ALL EXCAVATION PROCEDURES INCLUDING LAGGING, SHORING, AND THE PROTECTION OF ADJACENT PROPERTY.
- 16. SHOP DRAWINGS PREPARED BY SUPPLIERS AND SUBCONTRACTORS SHALL BE REVIEWED BY THE GENERAL CONTRACTOR PRIOR TO SUBMITTING TO THE ENGINEER.
- 17. CONTRACTOR SHALL PROVIDE SHOP DRAWINGS SHOWING SIZE, METHOD OF ANCHORAGE, AND WEIGHT OF ALL EQUIPMENT THAT IS TO BE SUPPORTED BY THE STRUCTURE FOR REVIEW BY THE ENGINEER. THIS IS TO DETERMINE ADEQUACY OF THE STRUCTURE PRIOR TO ORDERING.
- 18. THE CONTRACTOR SHALL BE RESPONSIBLE FOR THE DESIGN AND DETAIL OF SIMPLE (SHEAR ONLY) CONNECTIONS NOT SHOWN ON DRAWINGS.
- 19. SHOP DRAWINGS AND OTHER ITEMS SHALL BE SUBMITTED TO THE ENGINEER FOR REVIEW PRIOR TO FABRICATION. ALL SHOP DRAWINGS SHALL BE REVIEWED BY THE GENERAL CONTRACTOR BEFORE SUBMITTAL. THE ENGINEER'S REVIEW IS INTENDED TO REVIEW FOR CONFORMANCE WITH THE DESIGN CONCEPT AND GENERAL COMPLIANCE WITH THE RELEVANT CONTRACT DOCUMENTS. THE ENGINEER'S REVIEW DOES NOT RELIEVE THE CONTRACTOR OF THE SOLE RESPONSIBILITY TO REVIEW, CHECK, AND COORDINATE THE SHOP DRAWINGS PRIOR TO SUBMISSION. THE CONTRACTOR REMAINS SOLELY RESPONSIBLE FOR ERRORS AND OMISSIONS ASSOCIATED WITH THE PREPARATION OF SHOP DRAWINGS AS THEY PERTAIN TO MEMBER SIZES, DETAILS, DIMENSIONS, ETC. REPRODUCTIONS OF CONTRACT DOCUMENTS SHALL NOT BE USED TO PREPARE SHOP DRAWINGS. SHOP DRAWINGS AND SUBMITTALS SHALL BE SUBMITTED "CONTRACTOR APPROVED."

- STRUCTURAL LUMBER SHALL BE SOUTHERN YELLOW PINE #2, SPRUCE PINE FIR #2 OR BETTER, UNLESS NOTED OTHERWISE
- ALL STRUCTURAL WOOD USED IN THE CONSTRUCTION OF EXTERIOR COMPONENTS (E.G. STEPS, PORCHES, AND DECKS), EXPOSED TO WEATHER, AND / OR IN CONTACT WITH CONCRETE / SOIL SHALL BE PRESSURE TREATED OR EQUALLY ROT RESISTANT.
- 3. ALL STRUCTURAL WOOD COMPONENTS (E.G. PLYWOOD AND ALL LUMBER) BELOW FLOOD ELEVATION SHALL BE PRESSURE TREATED OR EQUALLY ROT
- ALL FASTENERS AND CONNECTORS (HARDWARE) SHALL BE GALVANIZED OR STAINLESS STEEL. ALL HARDWARE SHALL BE INSTALLED PER MANUFACTURER'S INSTRUCTIONS.
- REPLACEMENT WALL SHEATHING: 15/32" MINIMUM 24/16 APA-RATED PLYWOOD, WITH 0.131" DIAMETER X 2.5" LONG (8D COMMON) NAILS AT 3" ON CENTER AT ALL PANEL EDGES / BOUNDARIES, AND 12" ON CENTER IN THE FIELD. BLOCK ALL EDGES OF PLYWOOD UNLESS NOTED OTHERWISE.

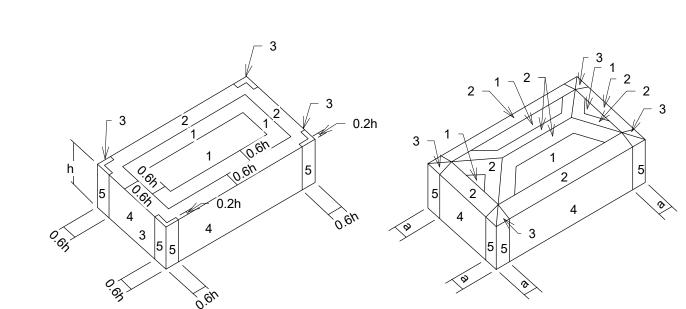


FLAT/HIP/GABLE (0:12  $\leq$  SLOPE  $\leq$  1.5:12) HIP ROOF  $(1.5:12 \le SLOPE \le 12:12)$ 

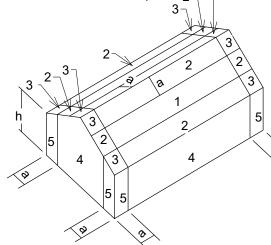

GABLE ROOF  $(1.5:12 \le SLOPE \le 12:12)$ 

FIG. 1: WIND PRESSURE DIAGRAMS (REFER TO ITEM C7 UNDER DESIGN CRITERIA)


STRUCTURAL ABBREVIATIONS - ANCHOR BOLT ADD/L - ADDITIONAL AFF - ABOVE FINISHED FLOOR **ARCH** BFF B.N. - BOUNDARY NAILING - COLUMN ABOVE C.I.P. - CAST IN PLACE - CONTROL JOINT - CENTER LINE CLR - CLEAR COL. - COLUMN CONC CONCRETE CONN - CONNECTION CONST - CONSTRUCTION CONT. - CONTINUOUS **COORD**  COORDINATE DET. - DETAIL DIA - DIAMETER DIAG DIAGONAL DIM - DIMENSION DWG - DRAWING - EXISTING (E)

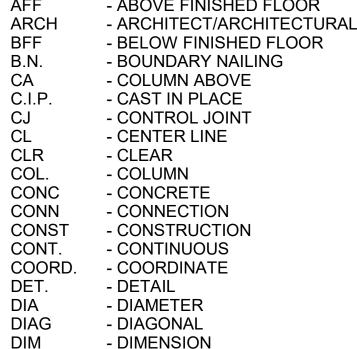

- EACH - EXPANSION JOINT - ELEVATION **ENGR** - ENGINEER
- EOD - EDGE OF DECK EOS - EDGE OF SLAB EQ - EQUAL
- **EQUIP** - EQUIPMENT EW - EACH WAY
- EXP - EXPANSION EXT - EXTERIOR
- F.F. - FINISHED FLOOR FDN - FOUNDATION FFE - FINISHED FLOOR ELEVATION
- FIN. - FINISH(ED) FLR. - FLOOR - FOOT / FEET
- FTG. - FOOTING - GAUGE
- GALV. - GALVANIZE (D) (ING) - HIGH **HORIZ**
- HORIZONTAL - JOIST BEARING ELEVATION
- JBE MFR - MANUFACTURER - NEW
- ON CENTER PSF
- POUNDS PER SQUARE FOOT - PRESSURE TREATED
- **REINF** - REINFORCEMENT SYP
  - SOUTHERN YELLOW PINE
- UNLESS NOTED OTHERWISE U.N.O. **VERT**
- VERTICAL V.I.F. - VERIFY IN FIELD
- WITH
- WELDED WIRE FABRIC






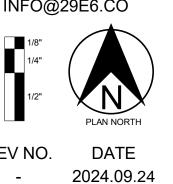

HARBOR ISLAND CONDOS BUILDING L + M 1 HARBOR DR. N ST HELENA ISLAND, SC 29920 **PROJECT NO: 20-012** 

STRUCTURAL NOTES

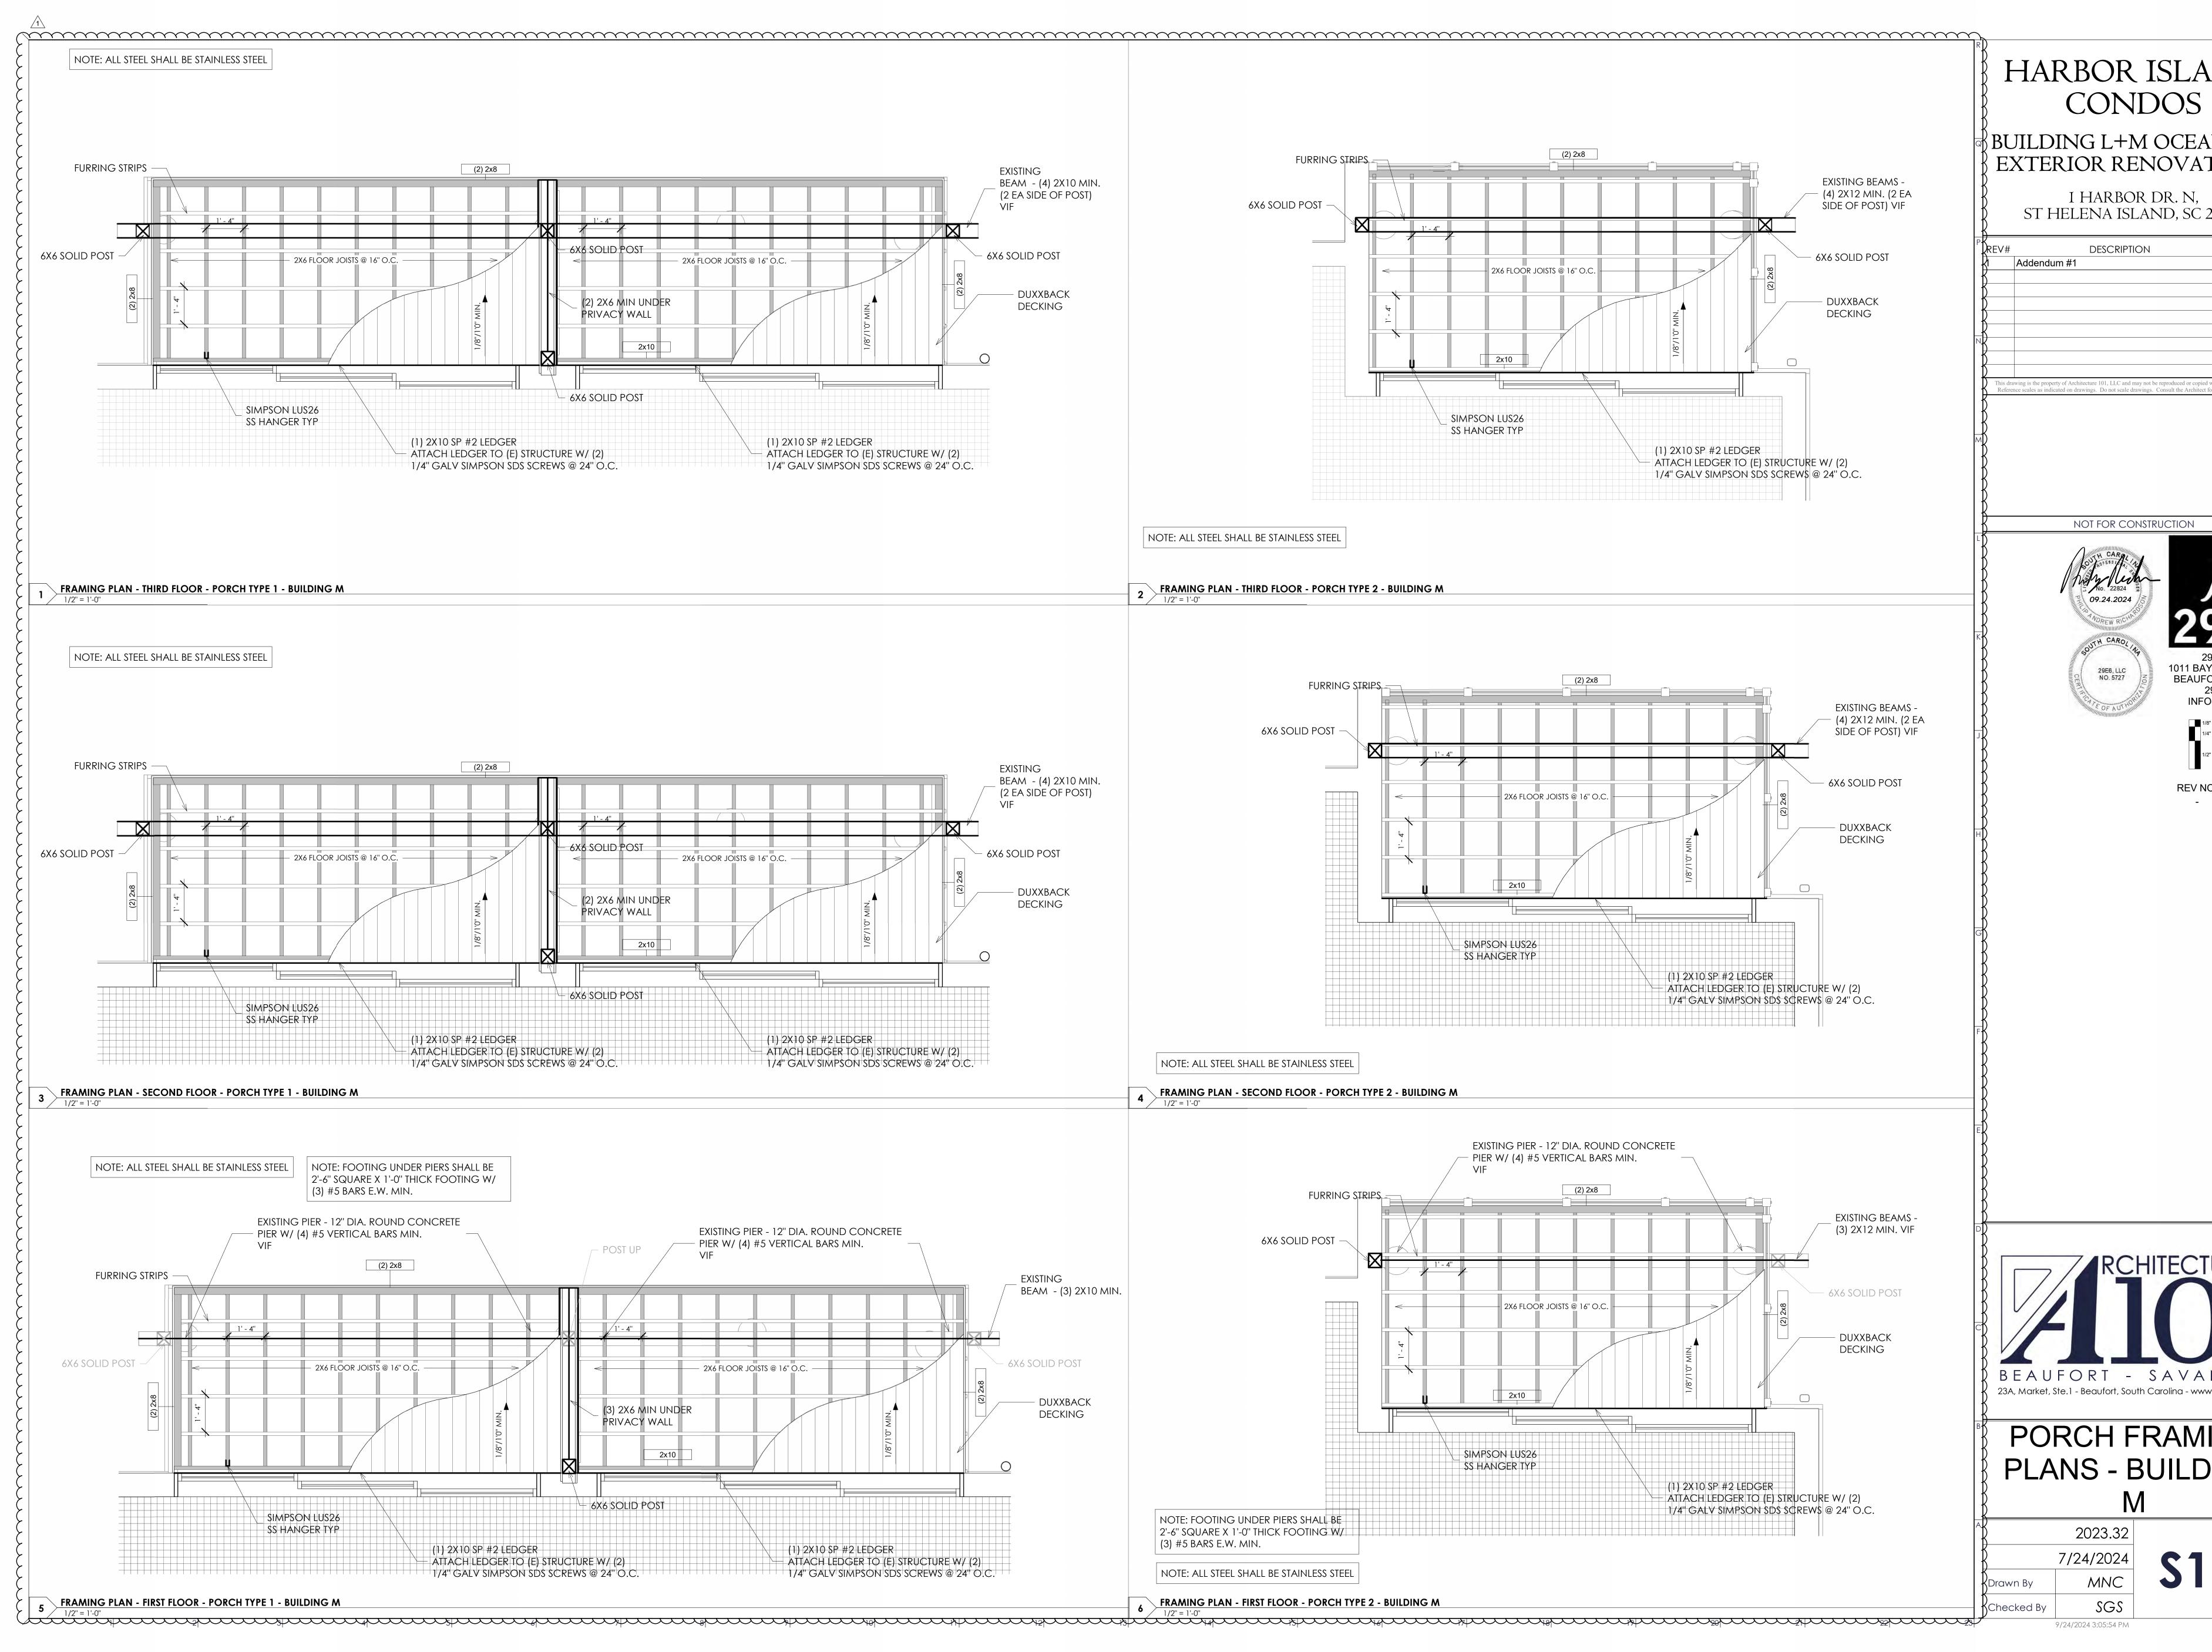


# HARBOR ISLAND

#### BUILDING L+M OCEANSIDE EXTERIOR RENOVATIONS

I HARBOR DR. N, ST HELENA ISLAND, SC 29920


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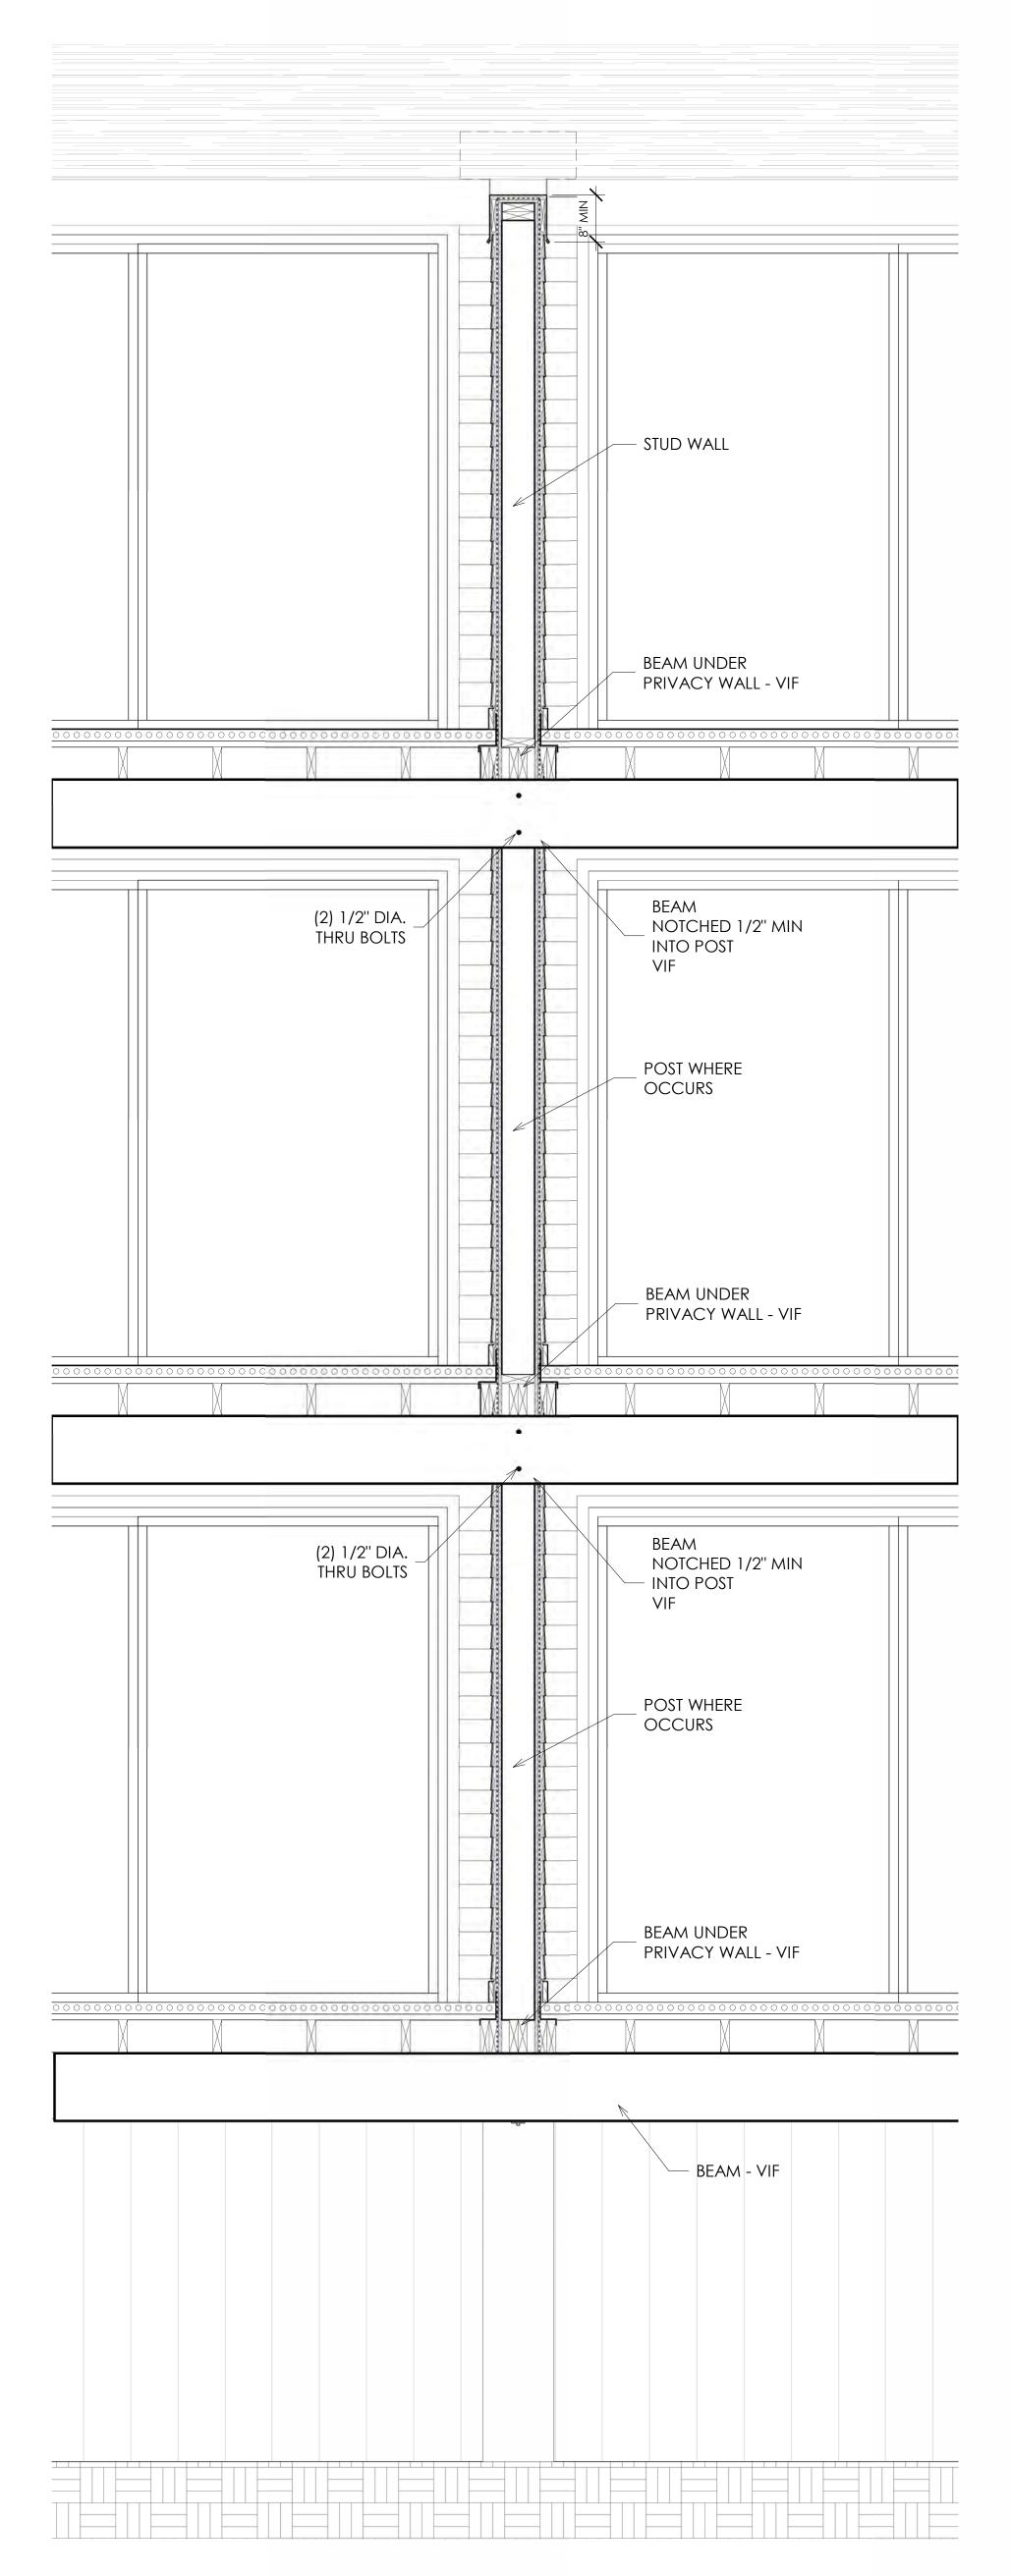
29E6, LLC 1011 BAY ST, SUITE 306 BEAUFORT, SC 29902 29E6.CO INFO@29E6.CO

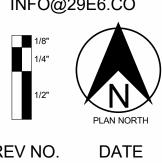

2024.09.24

### PORCH FRAMING PLANS - BUILDING



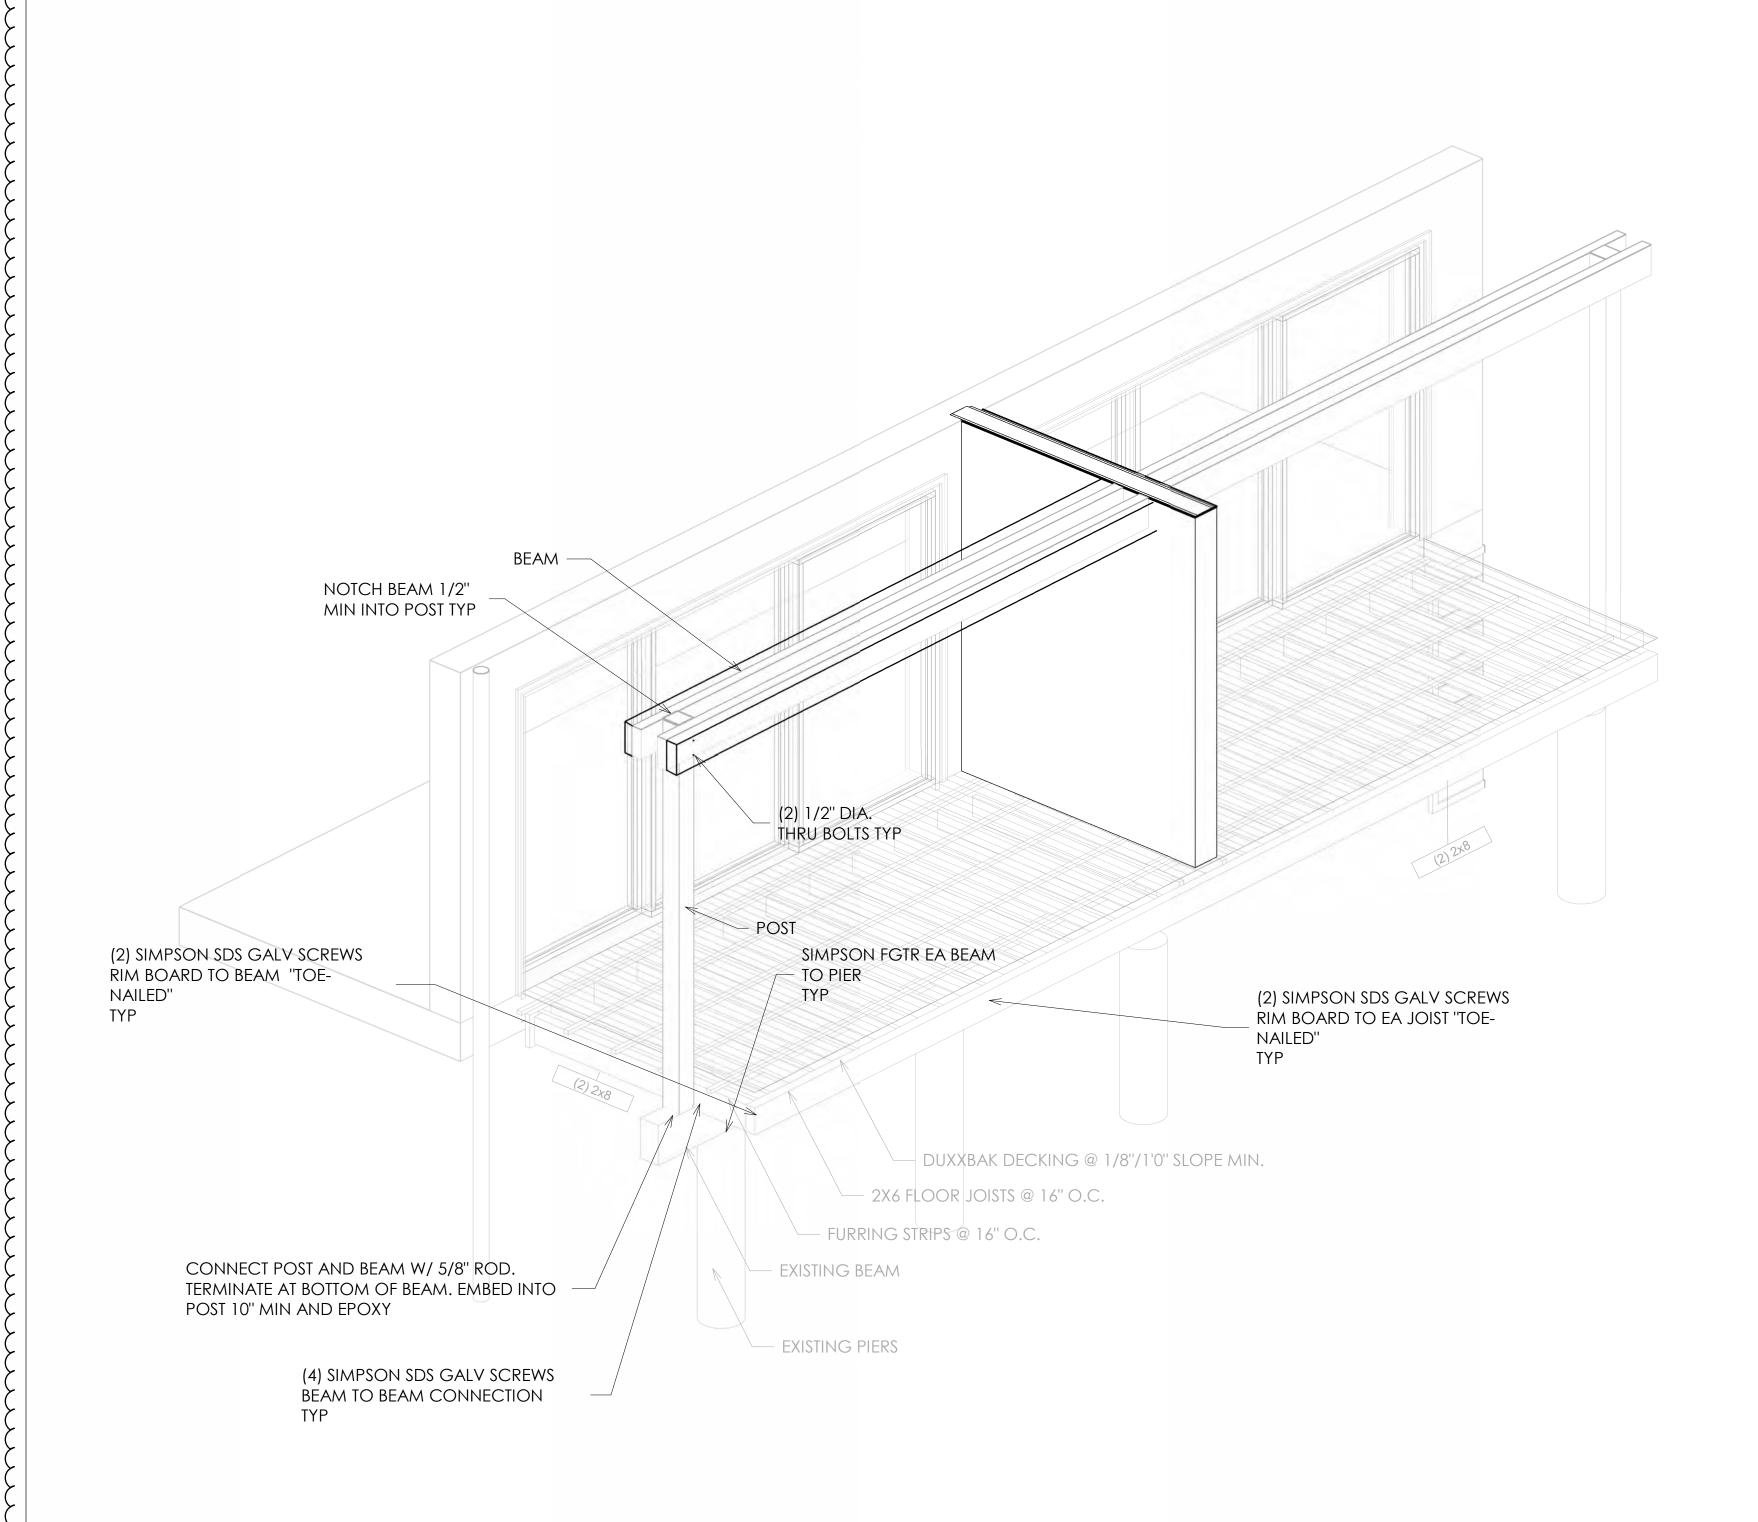


#### HARBOR ISLAND CONDOS

## BUILDING L+M OCEANSIDE EXTERIOR RENOVATIONS

I HARBOR DR. N, ST HELENA ISLAND, SC 29920

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NOT FOR CONSTRUCTION

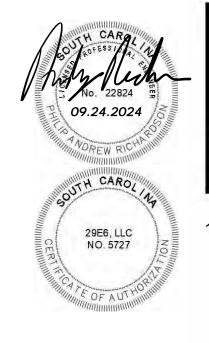

29E6, LLC
1011 BAY ST, SUITE 306
BEAUFORT, SC 29902
29E6.CO
INFO@29E6.CO

1/4"
1/2"
PLAN NORTH

REV NO. DATE
2024.09.24

RCHITECTURE

CONTROL

BEAUFORT - SAVANNAH


CONTROL

CONTR

#### PORCH SECTIONS -BUILDING M

2023.32 7/24/2024 Drawn By MNC Checked By SGS

S301

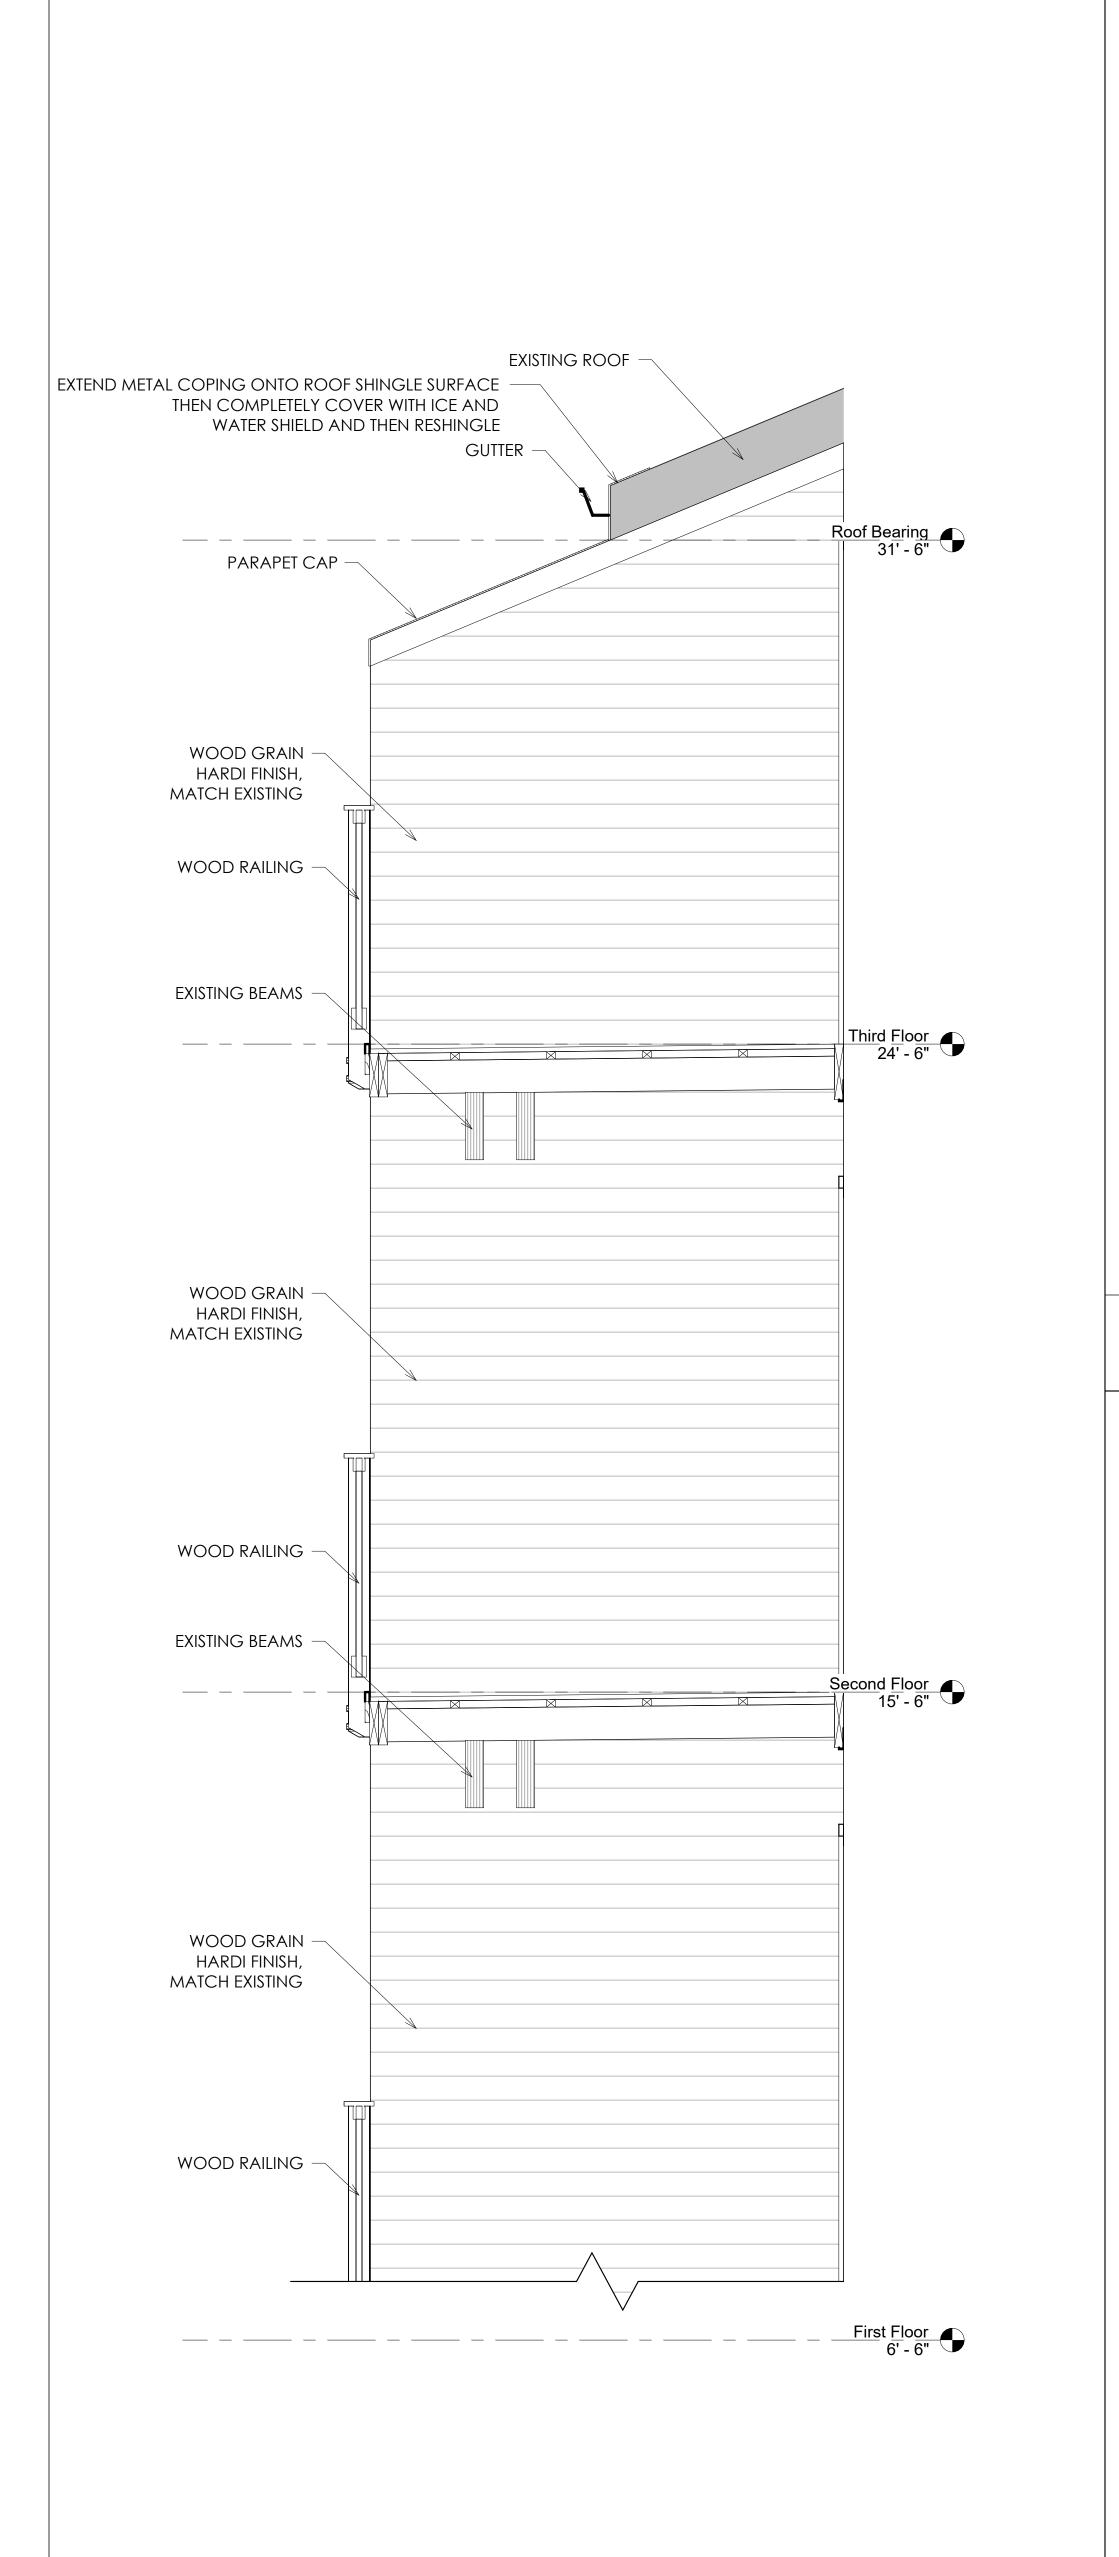

A1 ELEVATION - DECK PARTITION WALL

3/4" = 1'-0"

Door Schedule						
Mark	Width	Height	Fire rating Door Type	Frame Type	Comments	
113	13' - 0"	7' - 0"	FG	FBG	Verify and match existing opening/height in field,Integrated Pull Handle w/ Lock	
114	13' - 0"	7' - 0"	FG	FBG	Verify and match existing opening/height in field,Integrated Pull Handle w/ Lock	
115	13' - 0"	7' - 0"	FG	FBG	Verify and match existing opening/height in field,Integrated Pull Handle w/ Lock	
116	13' - 0"	7' - 0"	FG	FBG	Verify and match existing opening/height in field,Integrated Pull Handle w/ Lock	
117	13' - 0"	7' - 0"	FG	FBG	Verify and match existing opening/height in field,Integrated Pull Handle w/ Lock	
118	13' - 0"	7' - 0"	FG	FBG	Verify and match existing opening/height in field,Integrated Pull Handle w/ Lock	
213	13' - 0"	7' - 0"	FG	FBG	Verify and match existing opening/height in field,Integrated Pull Handle w/ Lock	
214	13' - 0"	7' - 0"	FG	FBG	Verify and match existing opening/height in field,Integrated Pull Handle w/ Lock	
215	13' - 0"	7' - 0"	FG	FBG	Verify and match existing opening/height in field,Integrated Pull Handle w/ Lock	
216	13' - 0"	7' - 0"	FG	FBG	Verify and match existing opening/height in field,Integrated Pull Handle w/ Lock	
217	13' - 0"	7' - 0"	FG	FBG	Verify and match existing opening/height in field,Integrated Pull Handle w/ Lock	
218	13' - 0"	7' - 0"	FG	FBG	Verify and match existing opening/height in field,Integrated Pull Handle w/ Lock	
313	13' - 0"	7' - 0"	FG	FBG	Verify and match existing opening/height in field,Integrated Pull Handle w/ Lock	
314	13' - 0"	7' - 0"	FG	FBG	Verify and match existing opening/height in field,Integrated Pull Handle w/ Lock	
315	13' - 0"	7' - 0"	FG	FBG	Verify and match existing opening/height in field,Integrated Pull Handle w/ Lock	
316	13' - 0"	7' - 0"	FG	FBG	Verify and match existing opening/height in field,Integrated Pull Handle w/ Lock	
317	13' - 0"	7' - 0"	FG	FBG	Verify and match existing opening/height in field,Integrated Pull Handle w/ Lock	
318	13' - 0"	7' - 0"	FG	FBG	Verify and match existing opening/height in field,Integrated Pull Handle w/ Lock	

DOOR SCHEDULE NOTES:

- Door hardware finish shall match existing.
   Key all doors to Owner's requirements. Conduct Preinstallation conference with Owner to determine keying requirements.
- 3. Coordinate access control with Owner.4. All door hardware to be 2010 ADA compliant.
- 5. GC Shall field verify all existing door and window opening sizes and dimensions prior to ordering.

DOOR LEGEND: FG: Full Glazed FBG: Fiber Glass

# Window Type Legend Door Type Legend Access Advisor Decision Contained Cont

#### HARBOR ISLAND CONDOS

BUILDING L+M OCEANSIDE EXTERIOR RENOVATIONS

I HARBOR DR. N, ST HELENA ISLAND, SC 29920

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Reference scales as indicated on drawings. Do not scale drawings. Consult the Architect for necessary clarifications.





FOR CONSTRUCTION



WALL, DOOR, AND WINDOW TYPES

Α		2023.32
	C	9/24/2024
	Drawn By	MNC
	Checked By	252

A001

