

Architectural Review Board Checklist

Please initial all items below to verify that your submittal includes all requirements:

The following items shall be submitted via email to aquinn@cityofladue-mo.gov by 11:00 am, no later than 7 days prior to the regularly scheduled meeting.

Your combined PDF should contain the following:

N/A Signatures of Subdivision trustees if home is part of an HOA (If in question, please check with the building department to verify before submitting). These signatures can be on the digital plans OR you can submit one signed hard copy to our offices. **If these are not included, your project will not be placed on the agenda until that is obtained.**

X Completed ARB application

X Schematic site plan at a scale of not less than one-inch equals 20 feet including the following:

- X Dimensioned property lines,
- X Building setback lines,
- X Easements identified,
- X Existing and proposed area of work,
- X Location of driveways and parking areas,
- X Topographic contours of the existing grades and proposed finished grades at two-foot interval minimums for a distance 25 feet from the face of the existing and proposed area of work with an indication of direction of flow of storm water. (For new residence and home additions only)
- X Location of proposed landscape material (New residence only)
- X Landscape material proposed to be removed (New residence only), and
- X Identifying any accessory structures proposed or existing.
- X Hardscape and greenspace coverage calculations for existing and proposed front, rear, side and overall lot.

X Schematic floor plans (at a minimum scale of one-quarter inch equals one foot) showing overall building dimensions. Plans may be printed in half-size.

X Building elevations (at a minimum scale of one-quarter inch equals one foot) showing vertical dimensions, fenestration, proposed materials and colors, and any existing construction where an addition or modification is proposed. All existing and proposed building materials shall be indicated on the existing building elevations. Plans may be printed in half-size

X Color photographs of the main building located on adjoining property. Color photographs of all building elevations of existing structures for projects involving remodeling or additions.



Application for Architectural Review Board

**** This application must be filled out completely and signed before submittals are placed on the ARB agenda.***

The purpose of Architectural Review Board shall be to two-fold; to develop architectural and design guidelines for the City of Ladue in accordance with section 110-70 and to apply those guidelines in reviewing projects within the City as to whether or not the project adheres to such guidelines.

APPLICANT INFORMATION

Name of Applicant: Dominion Homes, LLC

Phone #: (314) 220-7733

Email address of Applicant (for review comments): doug@dominionhomesstl.com

PROJECT PROPERTY INFORMATION

Address for proposed work: 18 Midpark Lane

If this ARB application is amending a project that is currently under construction, list permit #: _____

Zoning District: E-1 Sq. Footage of improvements: 3,619

DESCRIPTION OF PROPOSED PROJECT: a new, single-family residence

Additional Information:

- Professionally sealed plans are not required for ARB review.
- Plans for projects involving alterations and repairs, which do not affect the outward appearance of a building, and existing decks, fences, window replacements and roofing shingle replacements shall not require approval of the Architectural Review Board.
- Revised plans with any changes predicated by the ARB will need to be submitted with the building permit application to the Department of Planning and Development with final trustee approval (if applicable.)
- Projects approved by ARB should be submitted for building permits within 180 days or the ARB approval may become void.

By signing this application, you acknowledge that by submitting an incomplete application, your petition will not be added to the meeting agenda.

x Douglas J Mullenix Date: August 14, 2025

** This application and review for City of Ladue building permitted purposes only. Please be aware of any additional covenants and indentures which may be recorded with your subdivision. Approval of this ARB proposal does not waive any other permit or other authorization by the City that may be required for you to fully complete your proposed project.*



18 Midpark Lane, Subject property



16 Midpark Lane,
Adjacent home, west side



20 Midpark Lane,
Adjacent home, east side


A SITE PLAN FOR
18 MIDPARK LANE
A TRACT OF LAND BEING LOT 46 IN BLOCK 3 OF
CLAYTON ROAD PARK,
PLAT BOOK 21, PAGE 51,
ST. LOUIS COUNTY, MISSOURI

DEVELOPMENT NOTES:

- Site Address:
18 Midpark Lane
Ladue, MO
Loc.#19M320753
- Owner Information:
Equity RE Investment Partners LLC
8077 Maryland Avenue
St. Louis, MO 63105
Deed Doc No. 202506200281
- Area of Tract: 7,164 Square feet or 0.16 Acres, more or less.
- Present Zoning: E-1 Residential District (Ladue)
E-1 Residential District Dimensional Requirements

Front Yard Setback:	25 Feet
Side Yard Setback:	10 Feet
Rear Yard Setback:	30 Feet
Minimum Site Area:	10,000 Square feet
Minimum Lot Width:	70 Feet
Maximum Lot Coverage:	40%
- Utility Provider Districts:

Water:	Missouri American Water	Site Served
Sewer:	MSD	Yes
Telephone:	AT&T Distribution	No
Gas:	Spiral Missouri East	Yes
Electric:	Ameren Missouri Electric	Yes
Fire District:	West County EMS and Fire	
School District:	Parkway	
- According to the FIRM Flood Insurance Rate Map 29189C0194K Dated February 4, 2015, this development is located in Zone X unshaded, Areas determined to be outside the 0.2% chance annual floodplain.
- Existing utilities shown hereon are per field collected evidence and available utility maps and should be considered approximate only.
- This is not a boundary survey. Boundary information shown hereon is per the survey performed by THD Design Group, Inc. during August, 2025.
- Area of Disturbance:
9. A grinder pump is required to provide sanitary sewer relief to the basement floor of the proposed residence. Basement Floor = 501.87, Lateral = 502.16 (Contractor to verify lateral elevation prior to connecting to existing cleanout).

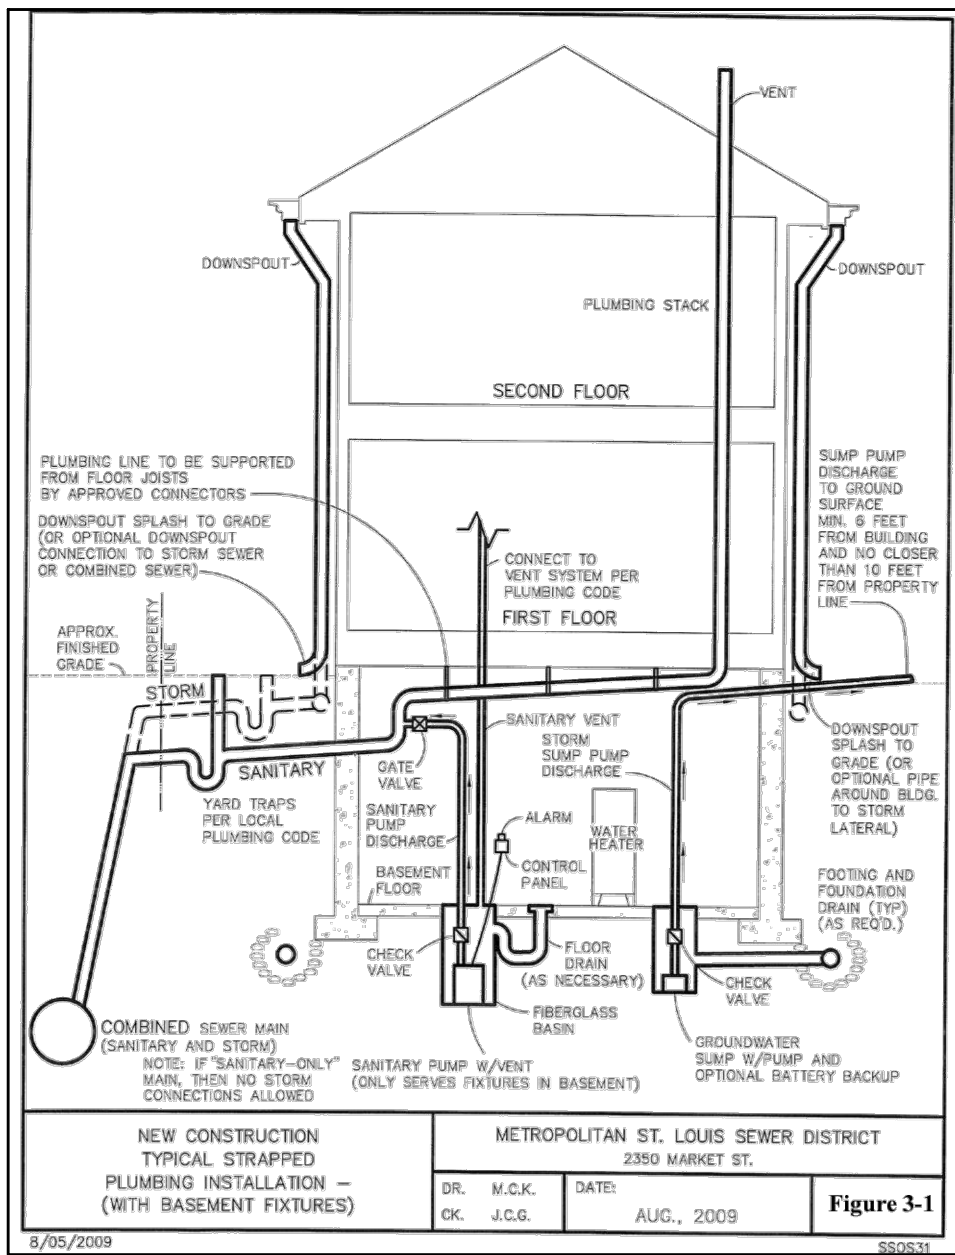

Differential Runoff Calculations - Parcel 1				
Existing	Area (s.f.)	Area (Ac)	PI	Q
Building	1,748	0.040	3.54	0.14 cfs
Pavement	2,987	0.069	3.54	0.24 cfs
Green Space	2,449	0.056	1.7	0.10 cfs
Total	7,184	0.165		0.48 cfs
Proposed				
Building	2,093	0.048	3.54	0.17 cfs
Pavement	1,027	0.024	3.54	0.08 cfs
Paver Patio	100	0.002	2.58	0.01
Green Space	4,064	0.093	1.7	0.16 cfs
Total	7,284	0.167		0.42 cfs
Differential Runoff =				-0.06 cfs

*Runoff volumes shown hereon are per the component rational method
* Time of concentration is assumed at 20min for the 15yr-20min rainfall
*Runoff differential shown above is for the area of the property only and does not include offsite drainage areas.

Coverage Calculations			
Existing	Impervious Area (sq.ft.)	Percentage	
Building	1,748	24.3%	
Pavement	2,987	41.6%	
Green Space	2,449	34.1%	
Total	7,184		
Existing Impervious Coverage		65.9%	
Proposed	Impervious Area (sq.ft.)	Percentage	
Building	2,093	29.1%	
Pavement	727	10.1%	
Paver Patio	64	0.7%	
Green Space	4,364	60.7%	
Total	7,248		
Proposed Impervious Coverage		39.9%	

* The percentage of impervious are for the paver patio has been calculated to provide a 25% greenspace credit as per City of Ladue Zoning Ordinance Section VII, G-3(a)


City of Ladue - Yard Area Coverage Calculation Table					
Yard	Area (sq.ft.)	Impervious Area	% Coverage Allowed	% Coverage Provided	Code Compliant
Front Yard	1,495	251	30.0%	16.8%	Yes
Rear Yard	1,793	64	30.0%	2.7%	Yes
Rgh Side Yard	630	153	25.0%	24.3%	Yes
Left Side Yard	630	0	25.0%	0.0%	Yes

* Right and Left yard setback are identified by orientation of the house face as viewed from the street
* Rear yard paver patio impervious area has been calculated to provide 25% greenspace credit

ABBREVIATIONS

AC	ACRE	XSEC	CROSS SECTION	DAI	DOUBLE AREA INLET	GI	GRATE INLET	PVMT	PAVEMENT	TBP	TO BE PROTECTED
AI	AREA INLET	XING	CROSSING	DS	DOWNSPOUT	HOPEIGH	DENSITY POLYETHYLENE	PDE	PERMANENT DRAINAGE	TBR	TO BE REMOVED
ATG	ADJUST TO GRADE	CFS	CUBIC FEET PER SECOND	ESMT	EASEMENT	HW	HIGH WATER	PVC	POLYVINYL CHLORIDE	TBR&R	TO BE REMOVED & RELOCATED
APPROX	APPROXIMATELY	CI	CURB INLET	ELEV	ELEVATION	HGL	HYDRAULIC GRADE LINE	PCC	PORTLAND CEMENT CONCRETE	TW	TOP OF WALL ELEVATION
ASPH	ASPHALT	CO	CLEANOUT	EP	END OF PIPE	HYD	HYDRANT	PC	PRECAST CONCRETE	TYP	TYPICAL
BW	BASE OF WALL ELEVATION	C&G	CURB & GUTTER	EX	EXISTING	IMP	IMPROVEMENT	PROP	PROPOSED	UIP	USE IN PLACE
BM	BENCHMARK	CO	CLEANOUT	FPS	FEET PER SECOND	IP	IRON PIPE OR PIN	RR	RAILROAD	VCP	VITRIFIED CLAY PIPE
BMP	BEST MANAGEMENT PRACTICE	CMP	CORROGATED METAL PIPE	FF	FINISH FLOOR	LS	LAND SURVEYOR	RCP	REINFORCED CONCRETE PIPE	WV	WATER VALVE
BLDG	BUILDING	CONC	CONCRETE	FH	FIRE HYDRANT	MH	MANHOLE	ROW	RIGHT-OF-WAY	YD	YARD DRAIN
CATV	CABLE TELEVISION	DCI	DOUBLE CURB INLET	FE	FLARED END	MSD	METROPOLITAN ST. LOUIS SEWER DISTRICT	SCH	SCHEDULE		
CALC	CALCULATED	DIP	DUCTILE IRON PIPE	FBD	FLAT BOTTOM DITCH	NTS	NOT TO SCALE	SWPPP	STORMWATER POLLUTION PREVENTION PLAN		
CIP	CAST IRON PIPE	DIA	DIAMETER	FD	FLOOR DRAIN	OC	ON CENTER	TBA	TO BE ABANDONED		
CL	CENTERLINE	Q	DISCHARGE	FL	FLOW LINE	OH	OVERHEAD				
CP	CLAY PIPE			FTG	FOOTING						

SHEET INDEX
1. SITE DEVELOPMENT PLAN
2. EXISTING CONDITIONS & DEMO PLAN

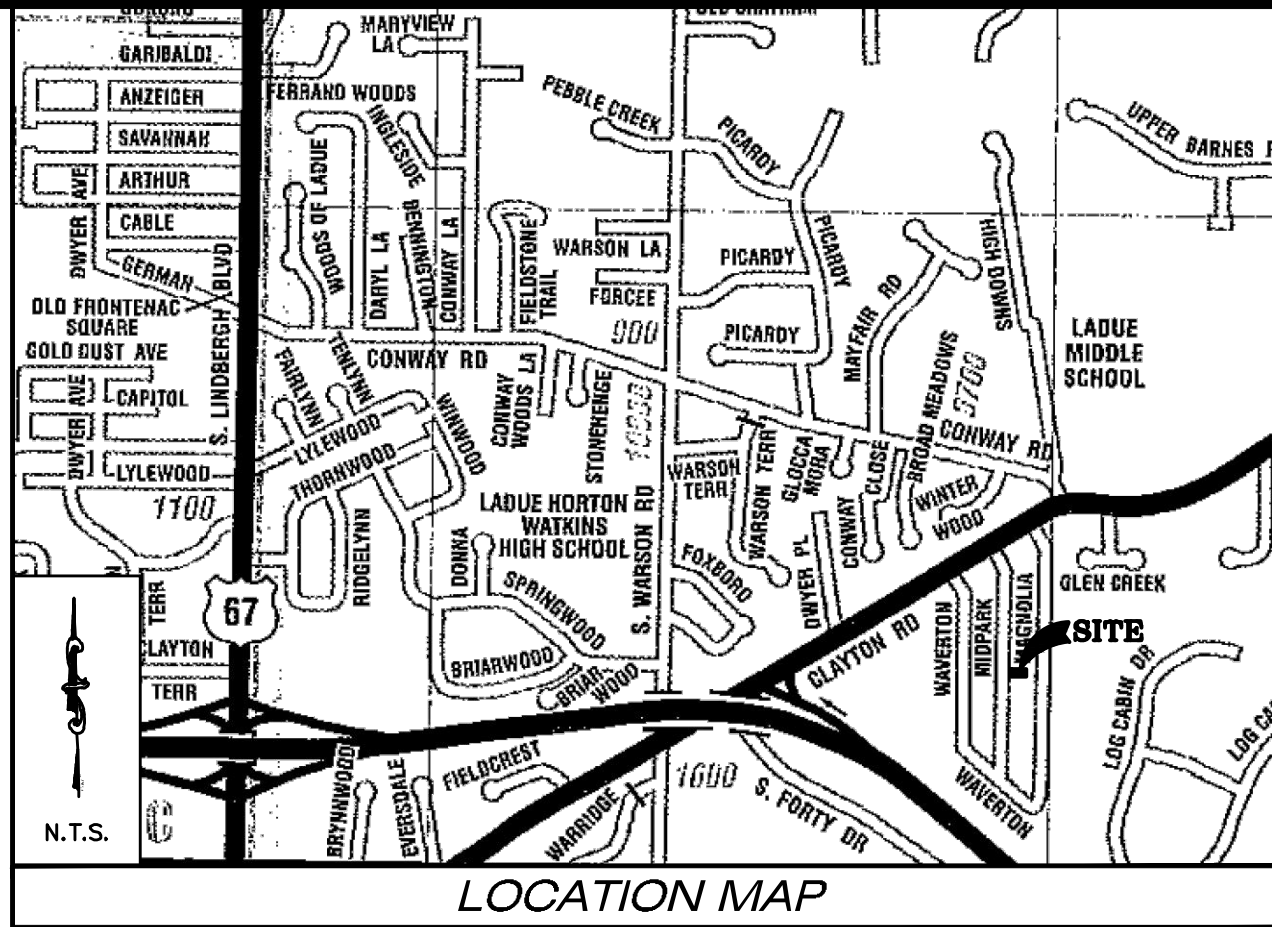

- PROPOSED 6" PVC SEWER LATERAL, MIN. 2% PIPE SLOPE, CONTRACTOR TO VERIFY EX. CLEAN OUT CONDITION PRIOR TO CONNECTION WITH NEW LATERAL
- PROPOSED 1" WATER SERVICE LINE
- PROPOSED GAS SERVICE LINE
- PROPOSED ELECTRIC SERVICE LINE

PROJECT BENCHMARK:

This project was performed with the use of Global Positioning System (GPS) equipment and the use of a Continuous Operating Reference Station (CORS) as part of the Missouri Department of Transportation (MoDOT) Virtual Reference System (VRS) Network. Data was obtained with the use of a Trimble R10 GPS Receiver and a TSC7 Data Collector.

Horizontal Datum is Grid North, Missouri State Plane Coordinate System NAD'83 (2401), East Zone
Vertical Datum is NAVD'88. Horizontal and Vertical data observation tolerance is 0.10 feet, horizontal and vertical Control point (CORS).

SITE BENCHMARK:

Description: Sanitary Sewer Manhole (19M3-140S)

Collected Elev. = 507.50 feet

Location: Approximately 25.5 feet North 20.0 feet West of the Northwestern corner of subject parcel.

SYMBOL LEGEND


EXISTING	PROPOSED	EXISTING	PROPOSED
FOUND CROSS	FOUND IRON PIPE	CABLE TV BOX	CABLE TV BOX
SET IRON ROD	BENCHMARK	CLEAN OUT	CLEAN OUT
SPOT GRADE	TRAFFIC SIGNAL BOX	SANITARY MANHOLE	SANITARY MANHOLE
PHONE BOX	UTILITY MANHOLE	SAMPLING TEE	SAMPLING TEE
MAILBOX	BOLLARD	STORM SEWER MANHOLE	STORM SEWER MANHOLE
SIGN	POST	GRATE INLET	GRATE INLET
SHRUB	DEODOROUS TREE	AREA INLET	AREA INLET
EVERGREEN TREE	ELECTRIC BOX	DOWNSPOUT	DOWNSPOUT
ELECTRIC METER	UTILITY POLE	DRAINAGE SWALE	DRAINAGE SWALE
GUY WIRE	GAS METER	SURFACE CONTOUR	SURFACE CONTOUR
GAS VALVE	WATER METER	TREE LINE	TREE LINE
WATER METER	WATER VALVE	SAN. SEWER	SAN. SEWER
HYDRANT	HYDRANT	STORM SEWER	STORM SEWER
WATER SHUT OFF	WATER SHUT OFF	OVERHEAD ELECTRIC LINE	OVERHEAD ELECTRIC LINE
SPRINKLER HEAD	IRRIGATION VALVE BOX	UNDERGROUND ELECTRIC	UNDERGROUND ELECTRIC
WELL	TEST HOLE	GAS LINE	GAS LINE
		WATER LINE	WATER LINE
		TELEPHONE LINE	TELEPHONE LINE
		FIBER OPTIC LINE	FIBER OPTIC LINE
		CABLE TV	CABLE TV
		GUARDRAIL	GUARDRAIL
		WIRE FENCE	WIRE FENCE
		WROUGHT IRON FENCE	WROUGHT IRON FENCE
		CHAIN LINK FENCE	CHAIN LINK FENCE
		MH A	MH A
		CI 204	CI 204

THD DESIGN GROUP, INC.
"your solution for engineering and surveying"

A THD DESIGN GROUP PROJECT

SITE PLAN

SITE DEVELOPMENT PLAN

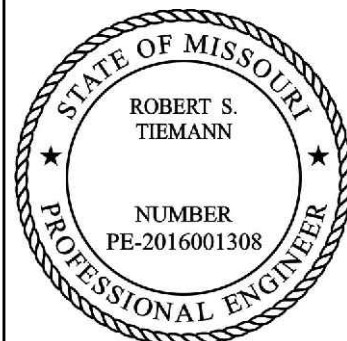




Date: Aug 13, 2025
Robert Tiemann
License No. PE-2016001308
Civil Engineer

PROJECT NUMBER: 25-5070

DATE: 08/13/2025

DRAWN BY: MLP


1 OF 2

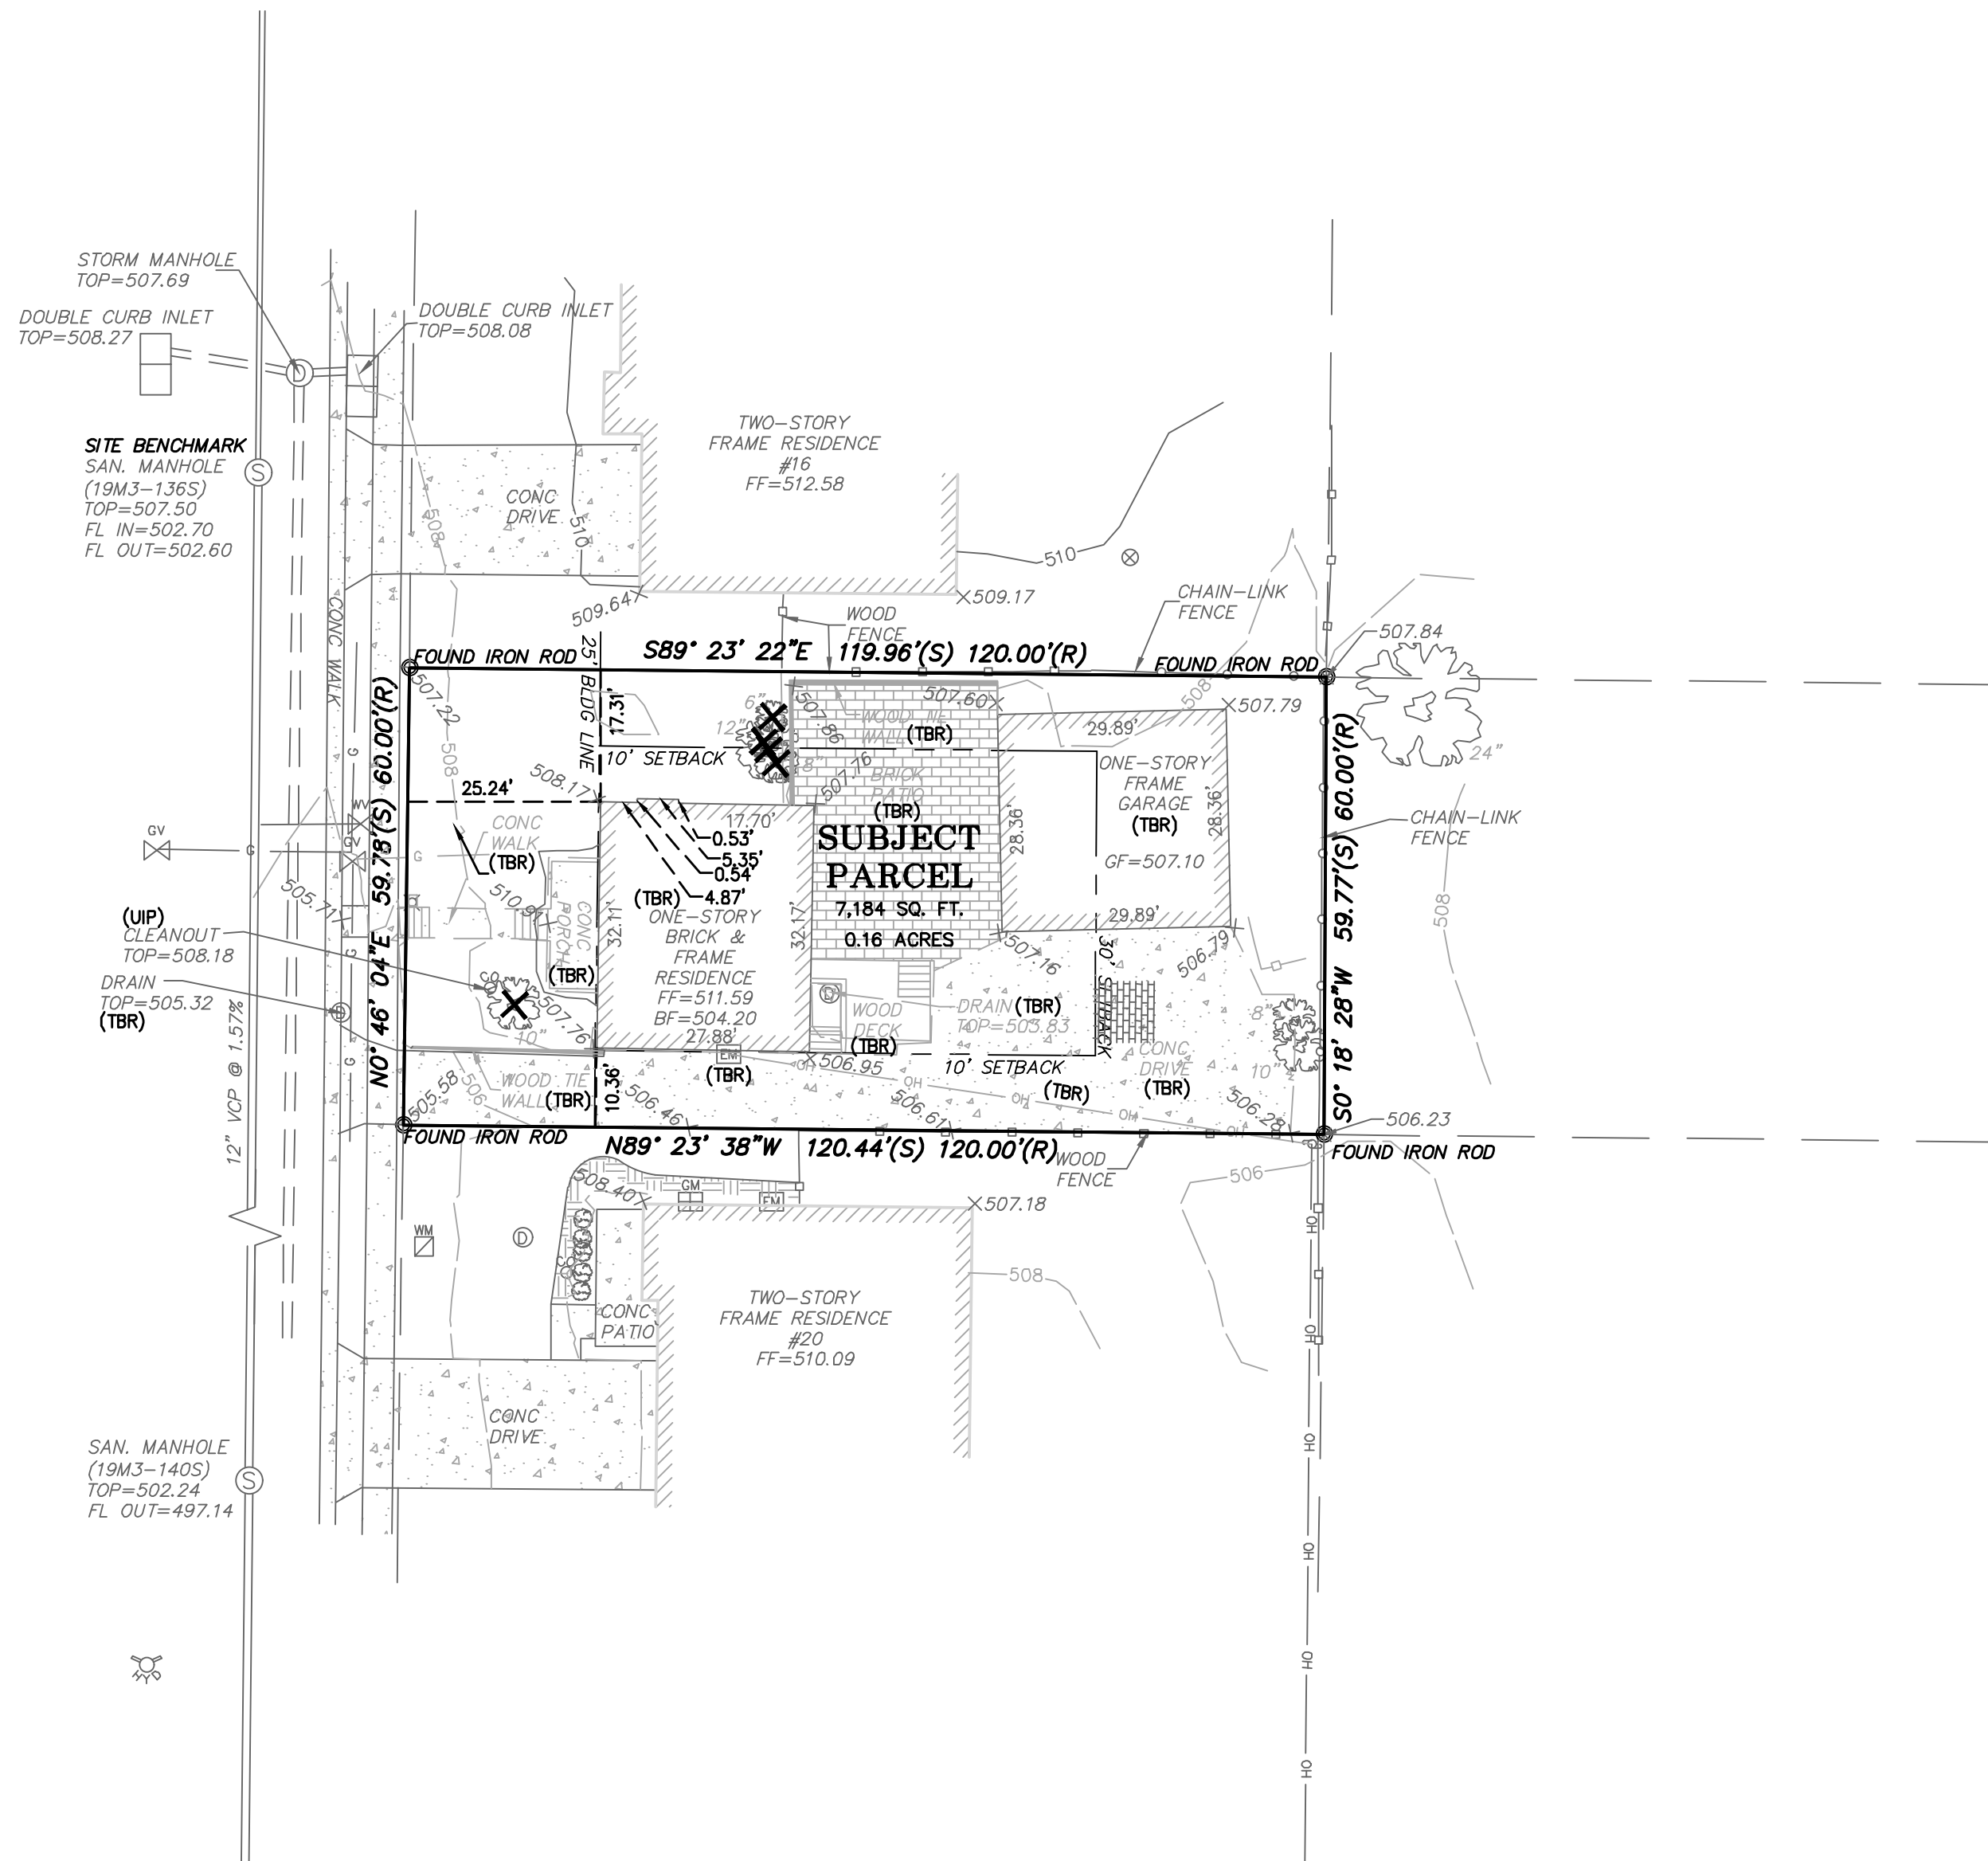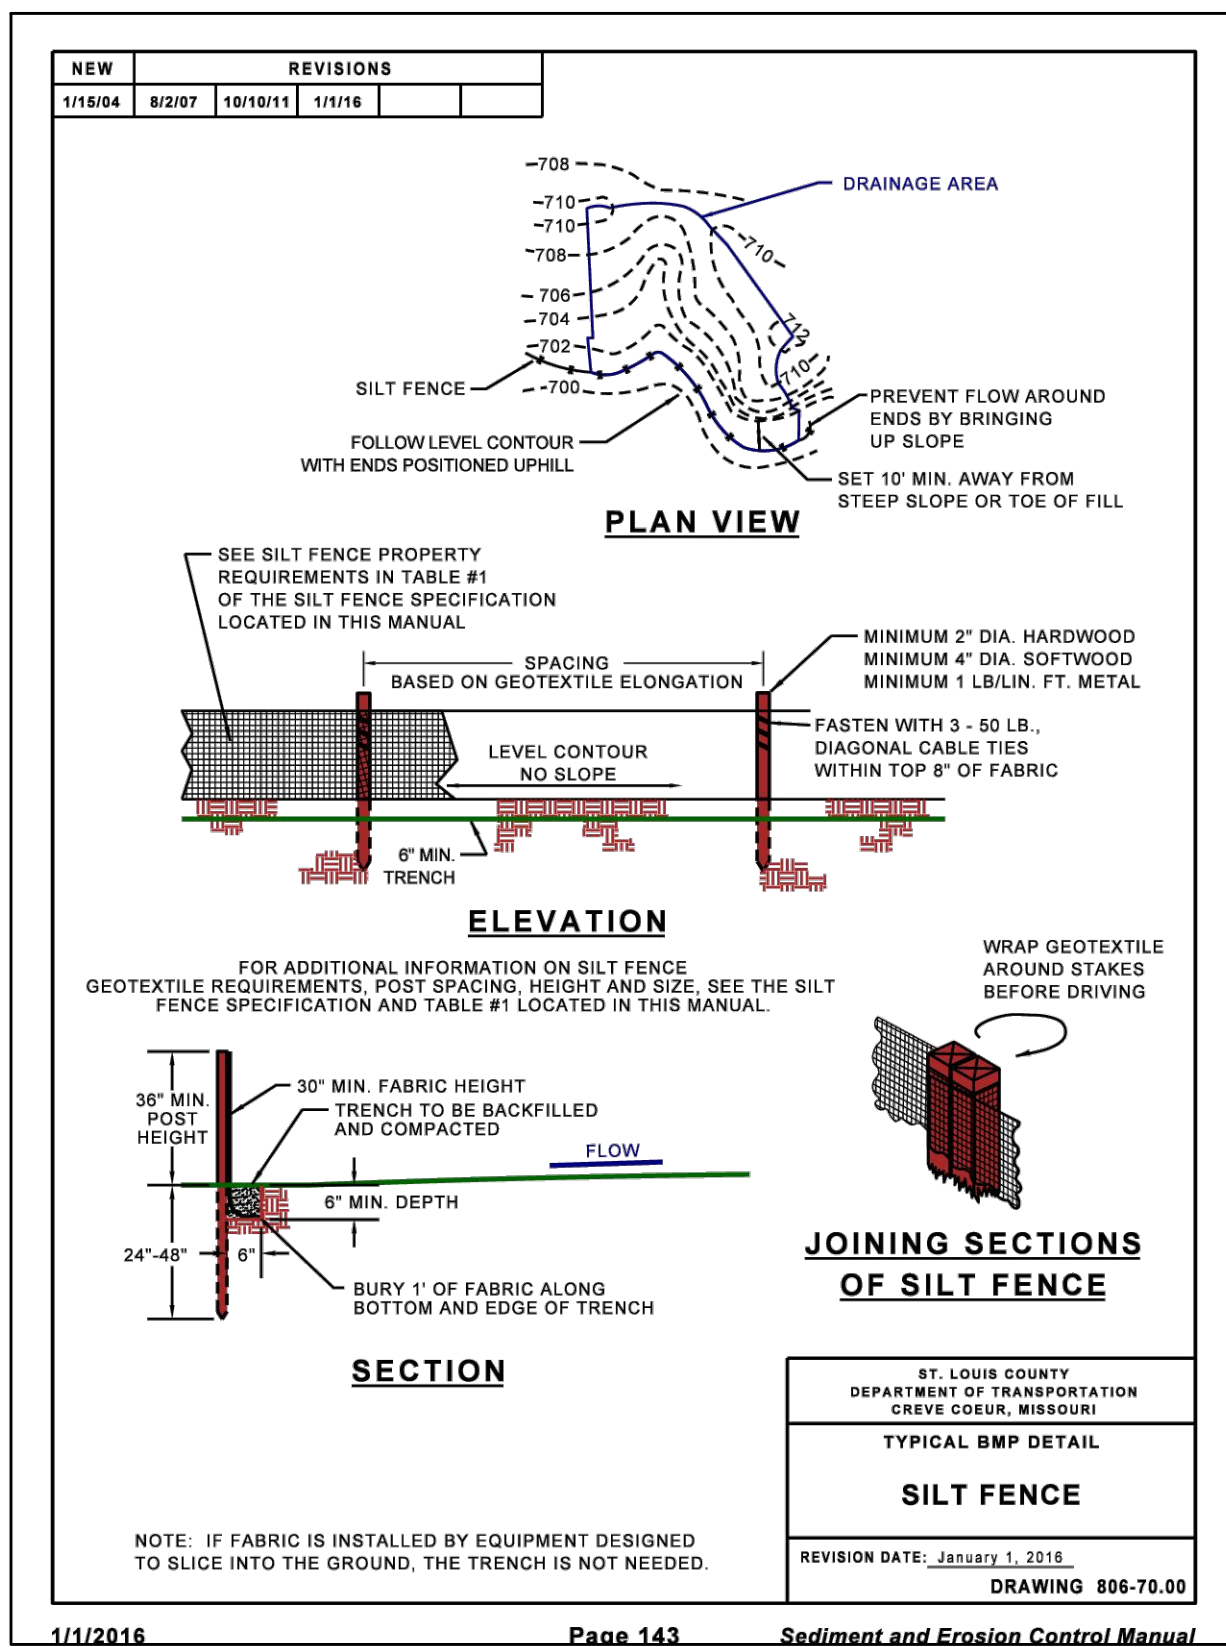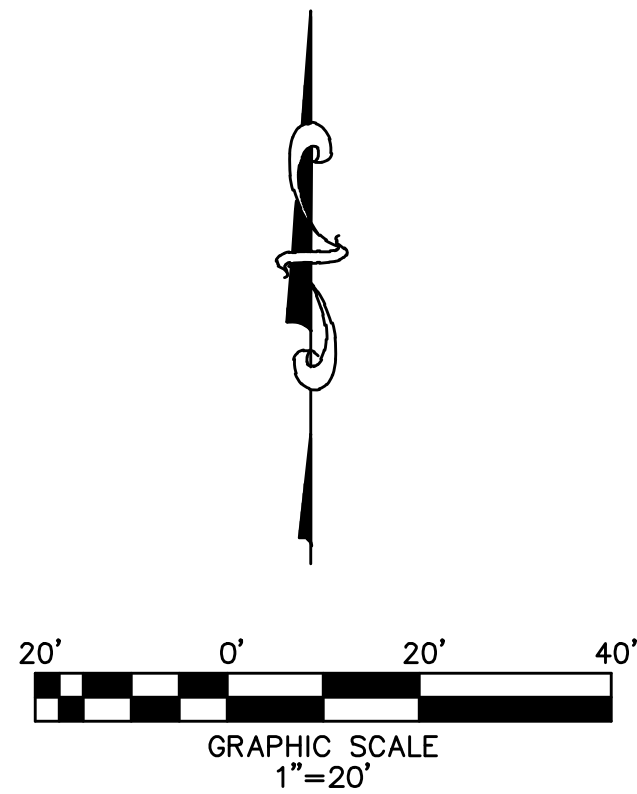

UNDERGROUND UTILITIES HAVE BEEN PLOTTED FROM AVAILABLE INFORMATION AND THEREFORE THEIR LOCATIONS SHALL BE CONSIDERED APPROXIMATE ONLY. THE VERIFICATION OF THE LOCATION OF ALL UNDERGROUND UTILITIES, EITHER SHOWN OR NOT SHOWN ON THESE PLANS, SHALL BE THE RESPONSIBILITY OF THE CONTRACTOR, AND SHALL BE LOCATED PRIOR TO ANY GRADING AND/OR CONSTRUCTION OF IMPROVEMENTS.

THD DESIGN GROUP, INC.
"your solution for engineering and surveying"
148 CHESTERFIELD INDUSTRIAL BLVD STE E, CHESTERFIELD, MO 63005
TEL 636-294-2972
FAX 636-294-2973
WEB: www.thdgroup.com
Corporate Certificate of Authority #2011004415

A THD DESIGN GROUP PROJECT
SITE PLAN
EXISTING CONDITIONS & DEMO PLAN

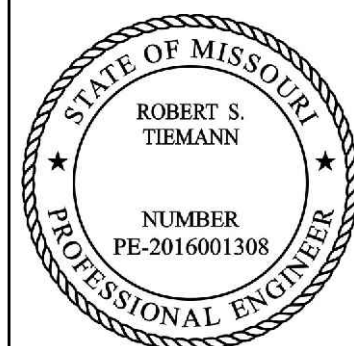

Date: Aug 13, 2025
Robert Tiemann
License No. PE-2016001308
Civil Engineer

PROJECT NUMBER: 25-5070

DATE: 08/13/2025

DRAWN BY: MLP

2 OF 2



Front

Grading plan to govern all grades. Scale: 1/4"=1'-0"



Right Side

Grading plan to govern all grades. Scale: 1/4"=1'-0"



Left Side

Grading plan to govern all grades. Scale: 1/4"=1'-0"

ARCHITECT
Thompson
Design Group LLC

452 Junge Station Rd.
St. Charles MO 63303-6243 (314) 283 8135

18 Midpark Lane

Ladue, MO, 63124 Saint Louis County

Dominion Homes, LLC



Doug@dominionhomesatl.com (314) 220-1133

REVISIONS:

A3 of 3

8/13/25


Job#: 010925

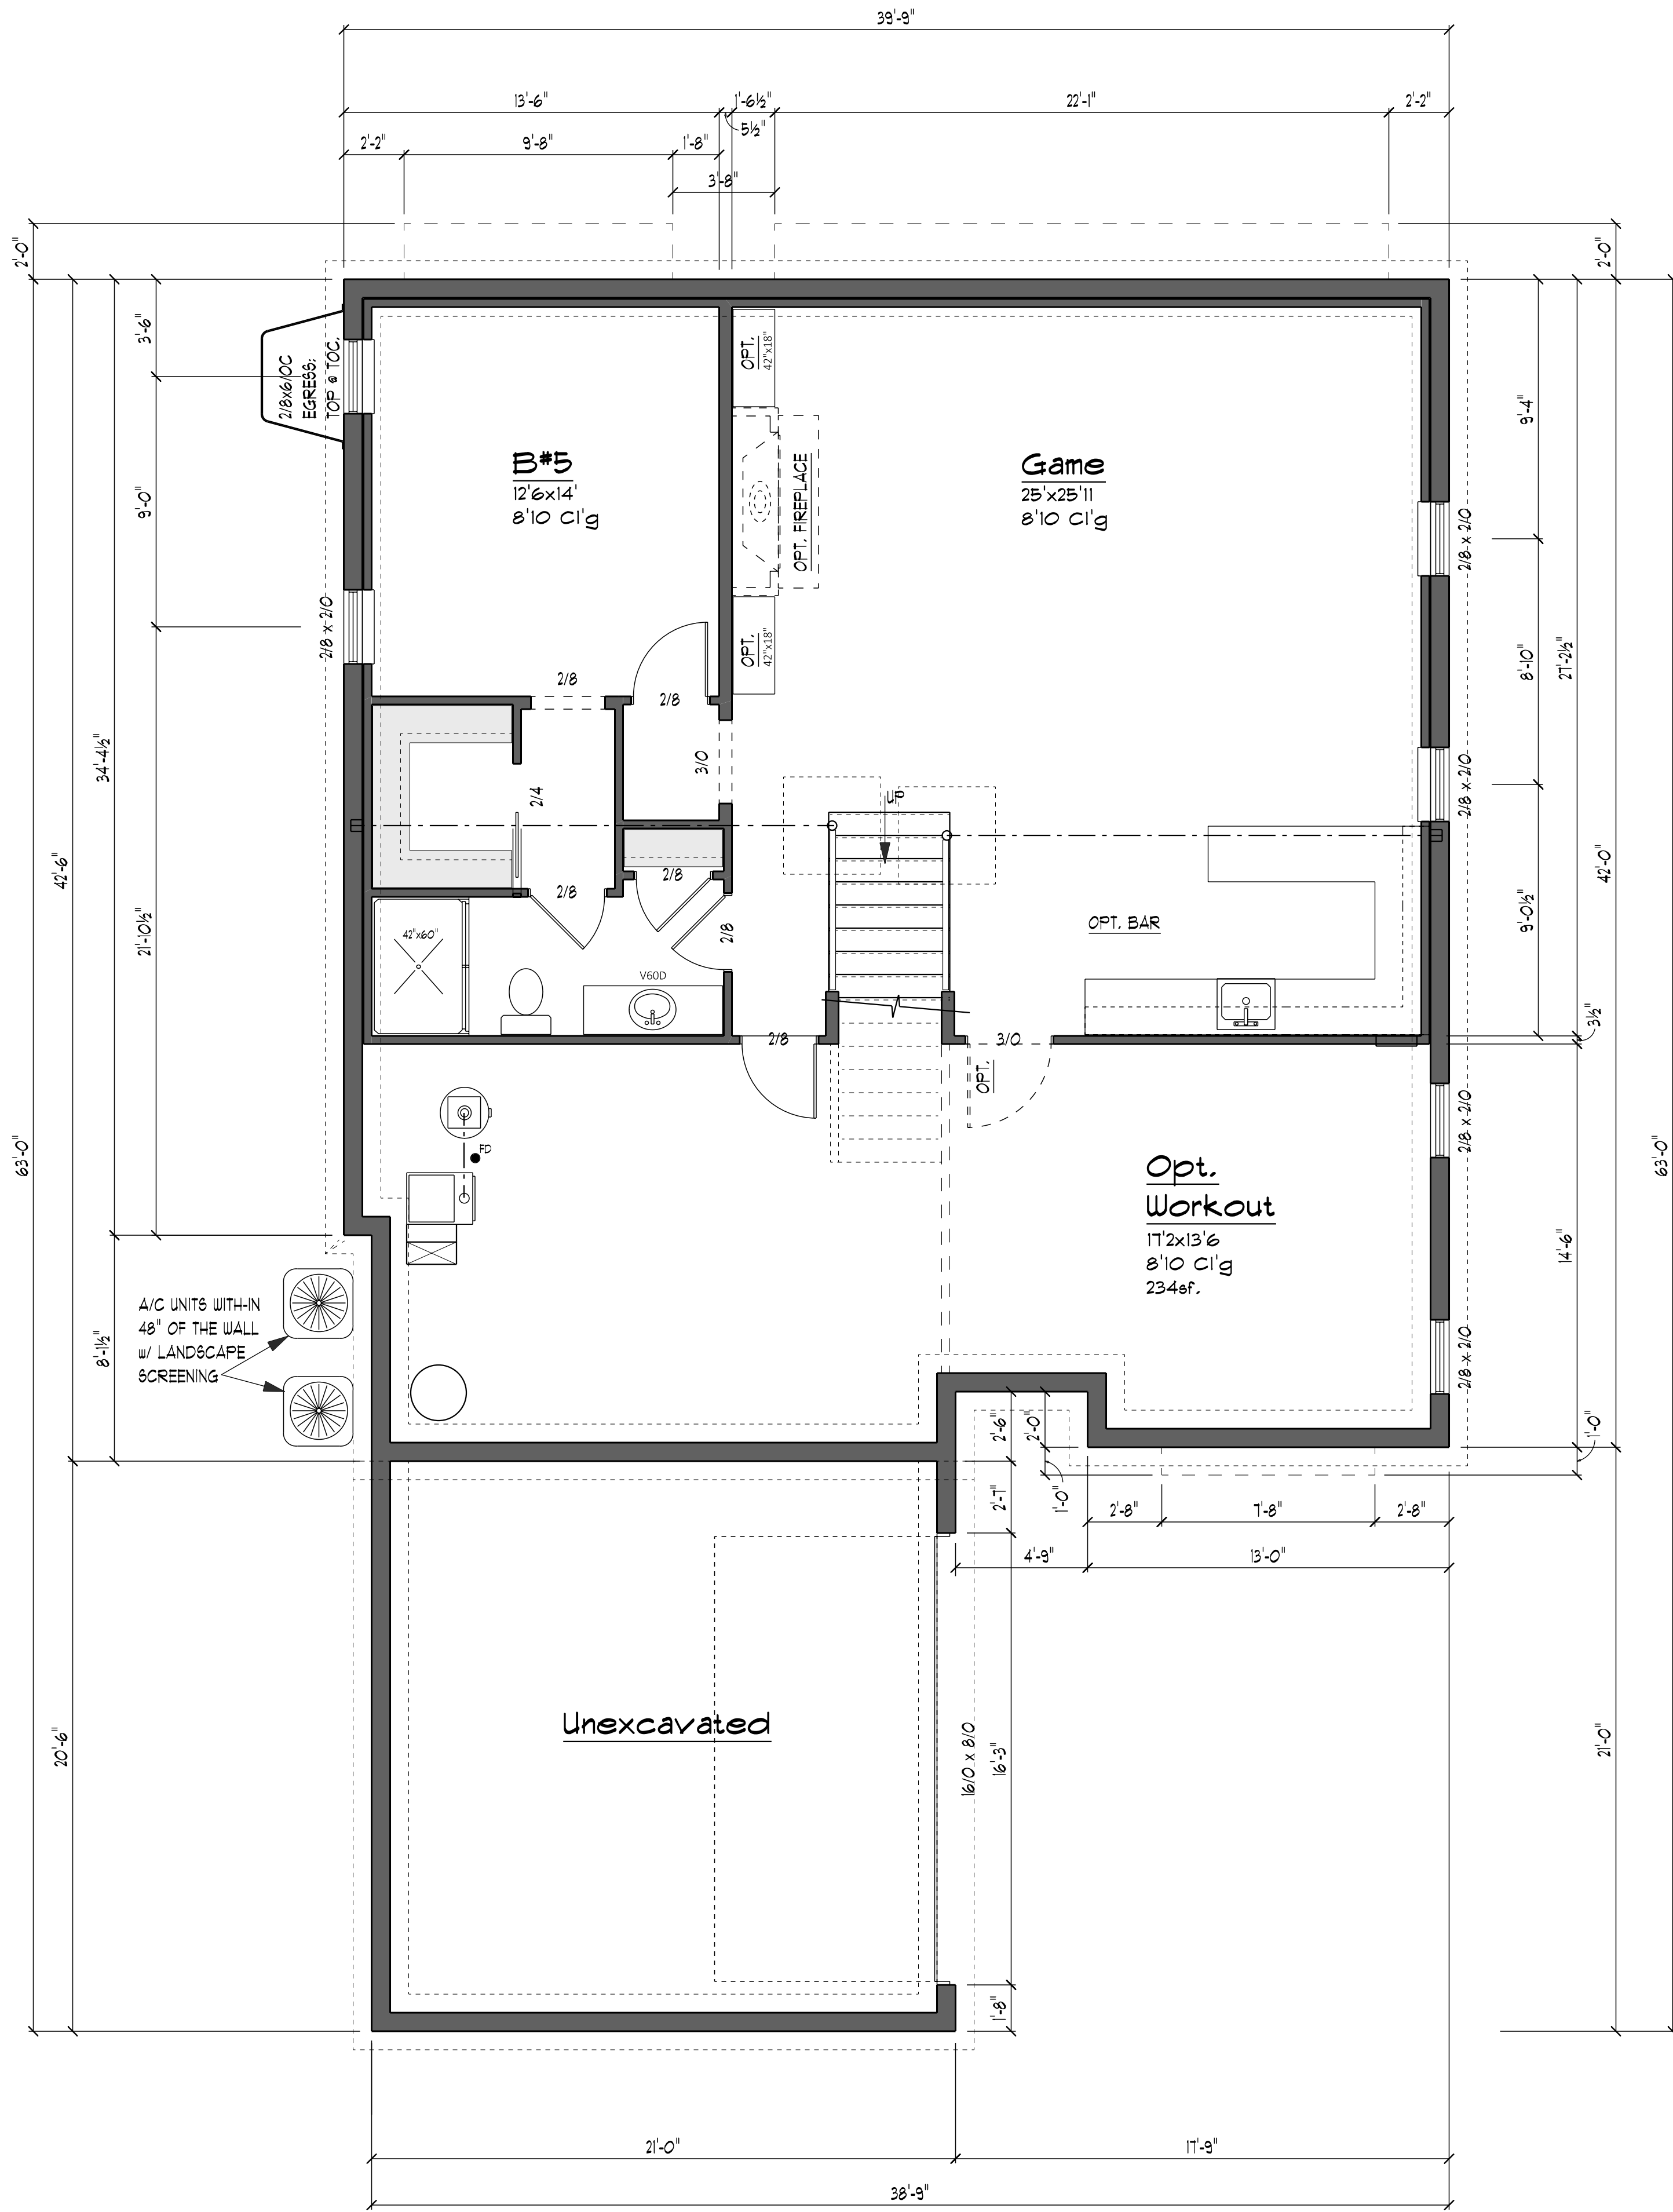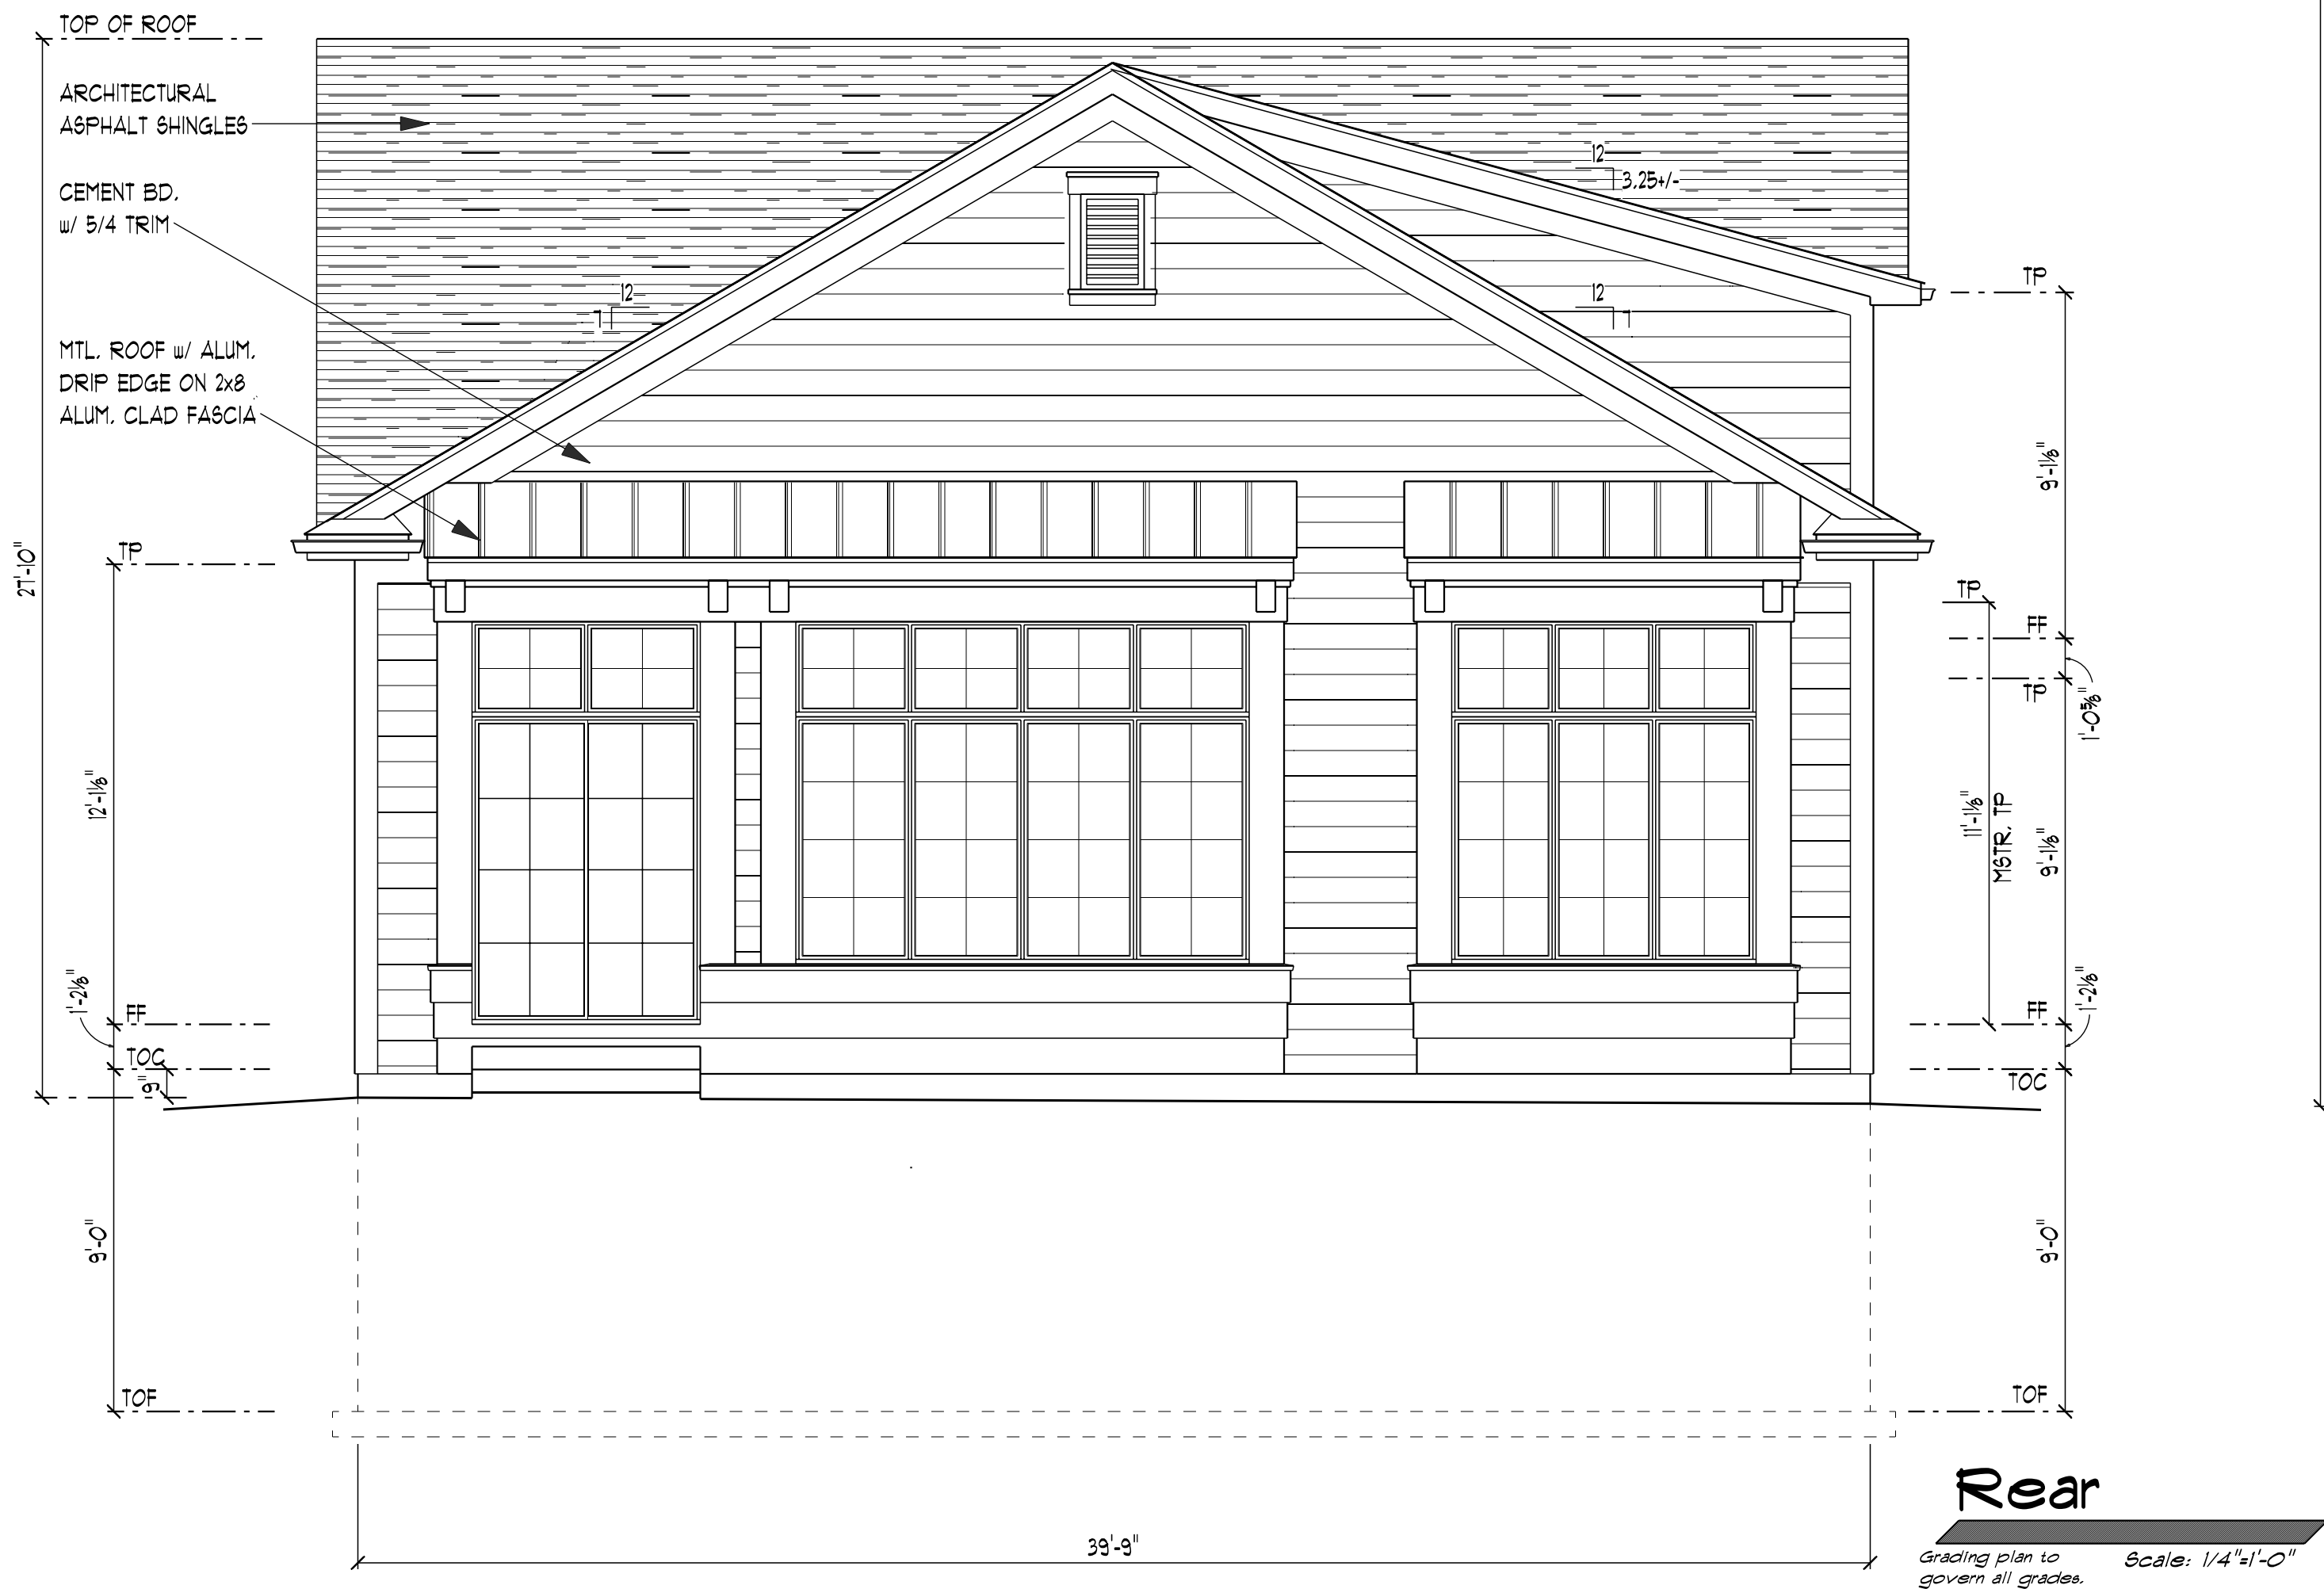

REVISIONS:

18 Midpark Lane
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Dominion Homes, LLC
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St. Charles MO 63303-6243 (314) 283 8735

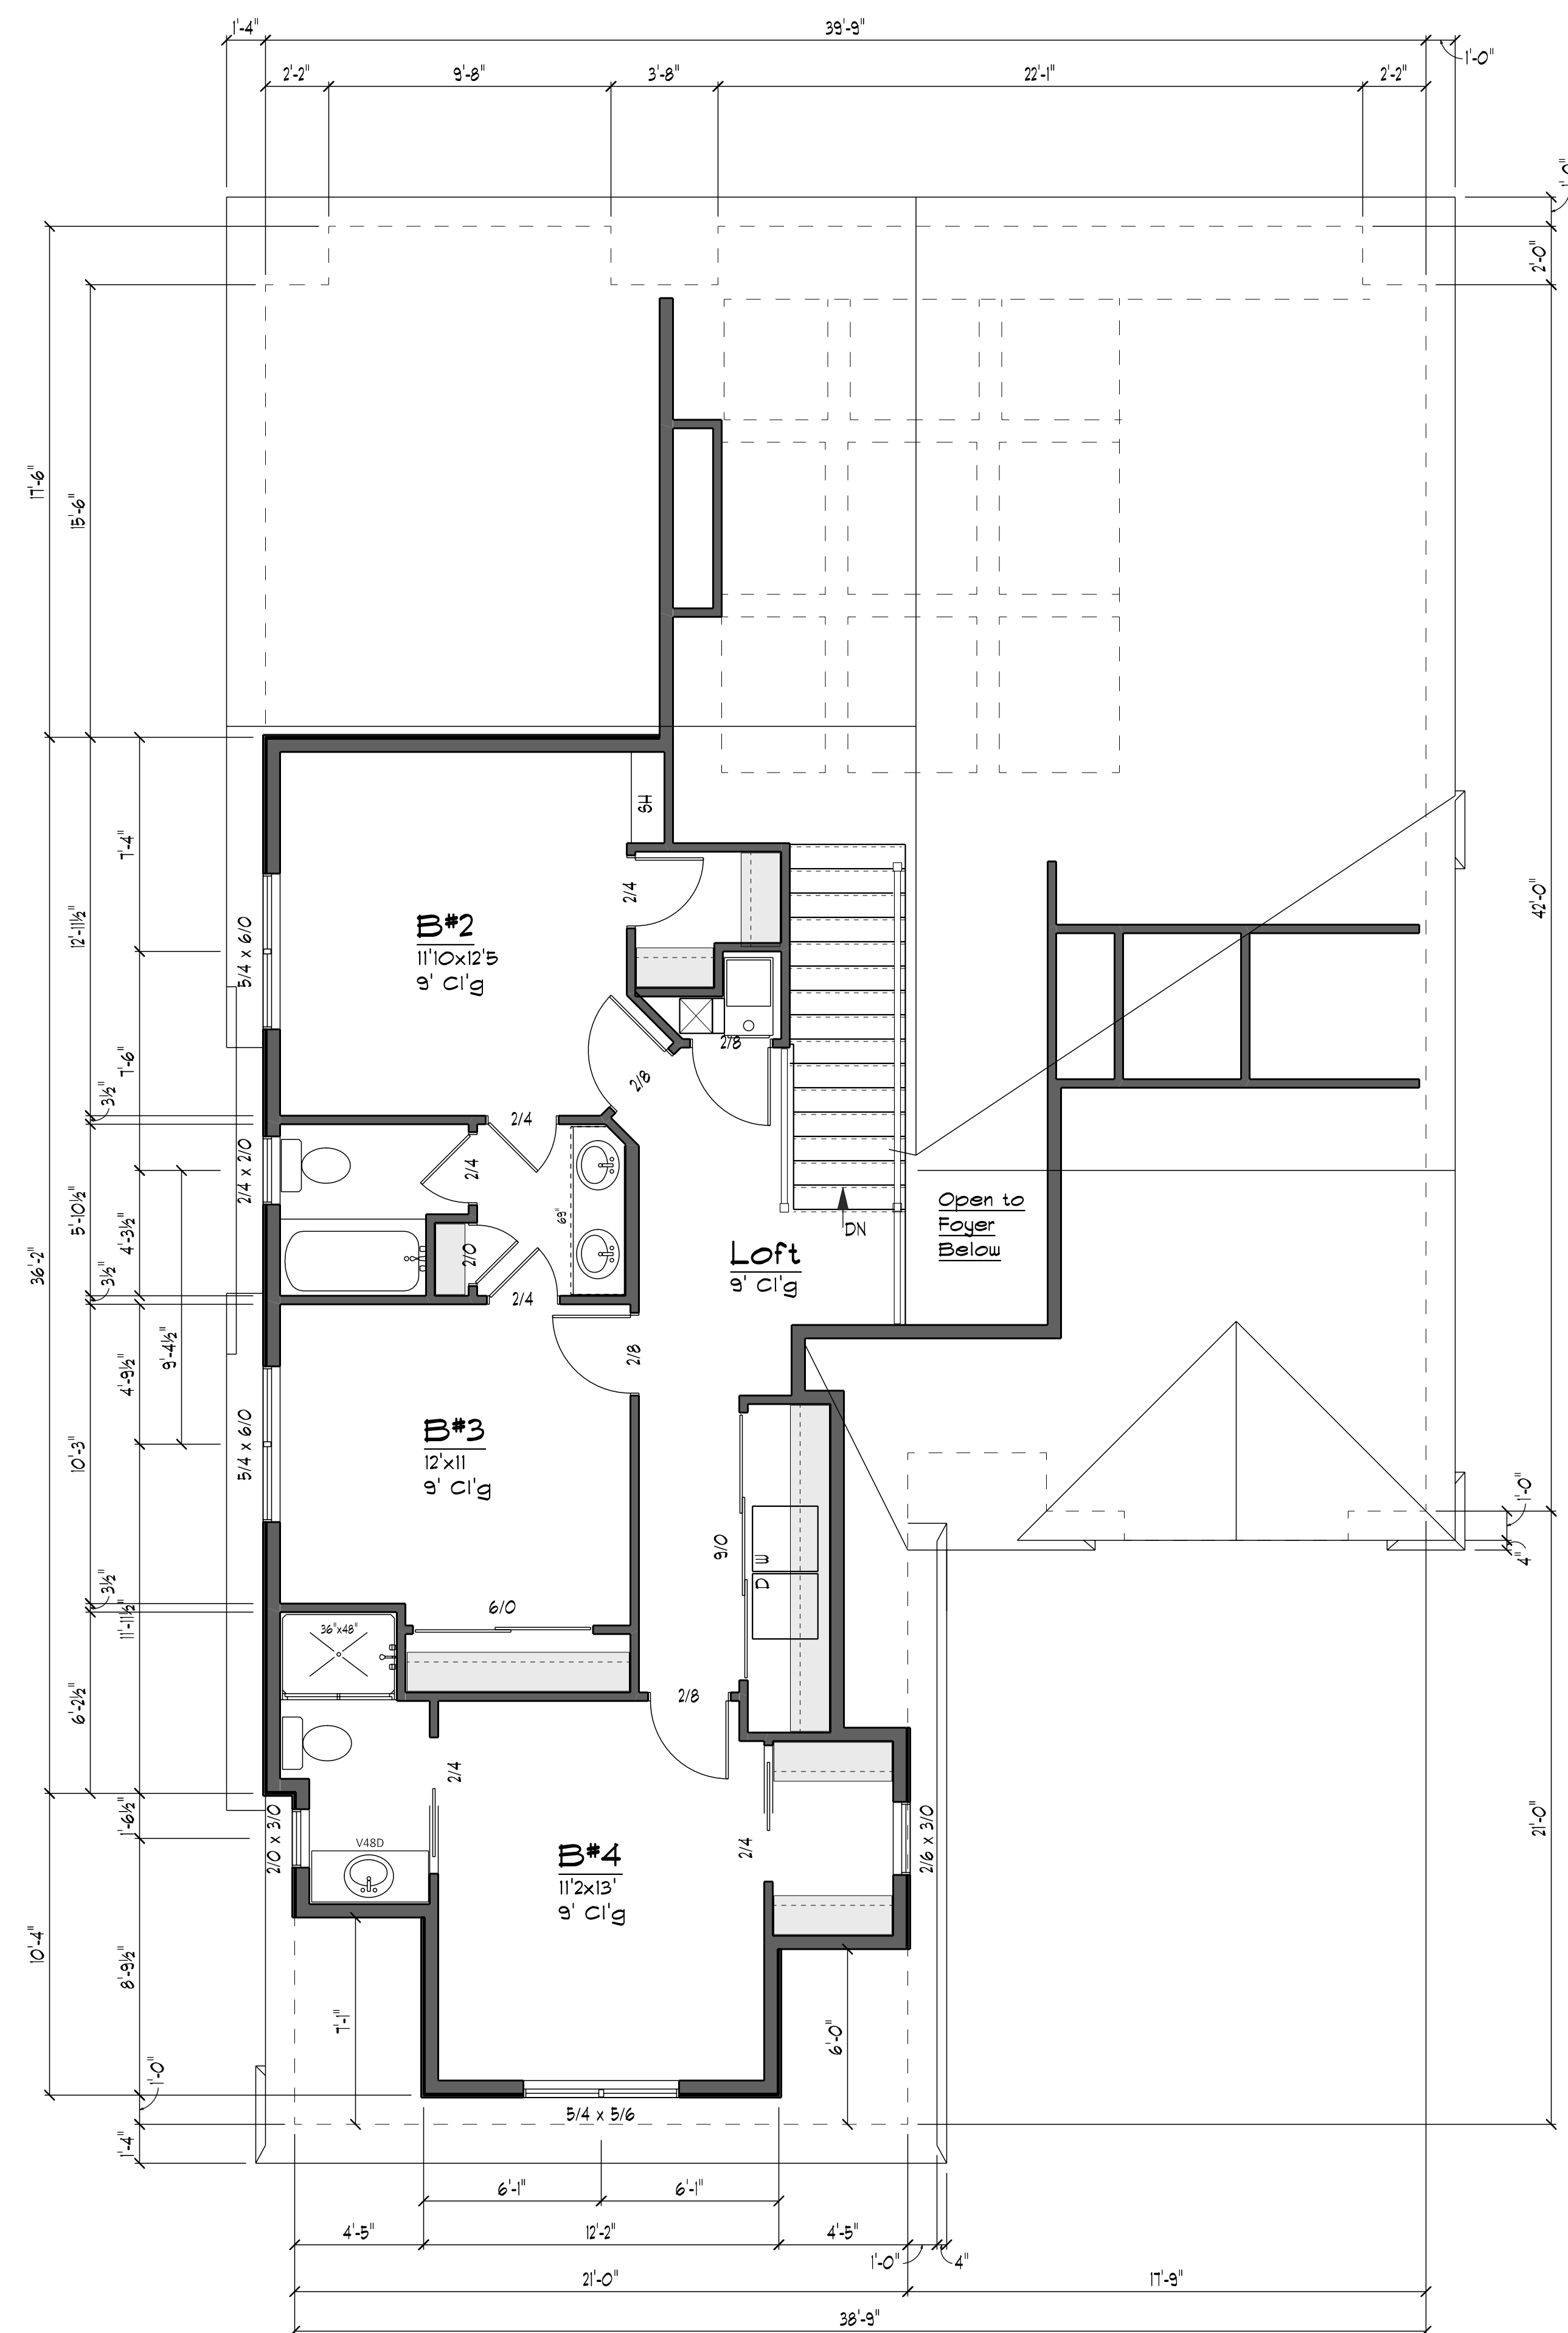


Dominion Homes

All room dimensions and square footages are approximate.

2nd Floor

1,734sf. + 850sf. 2nd flr. = 2,584sf.

18 MidPark, Ladue

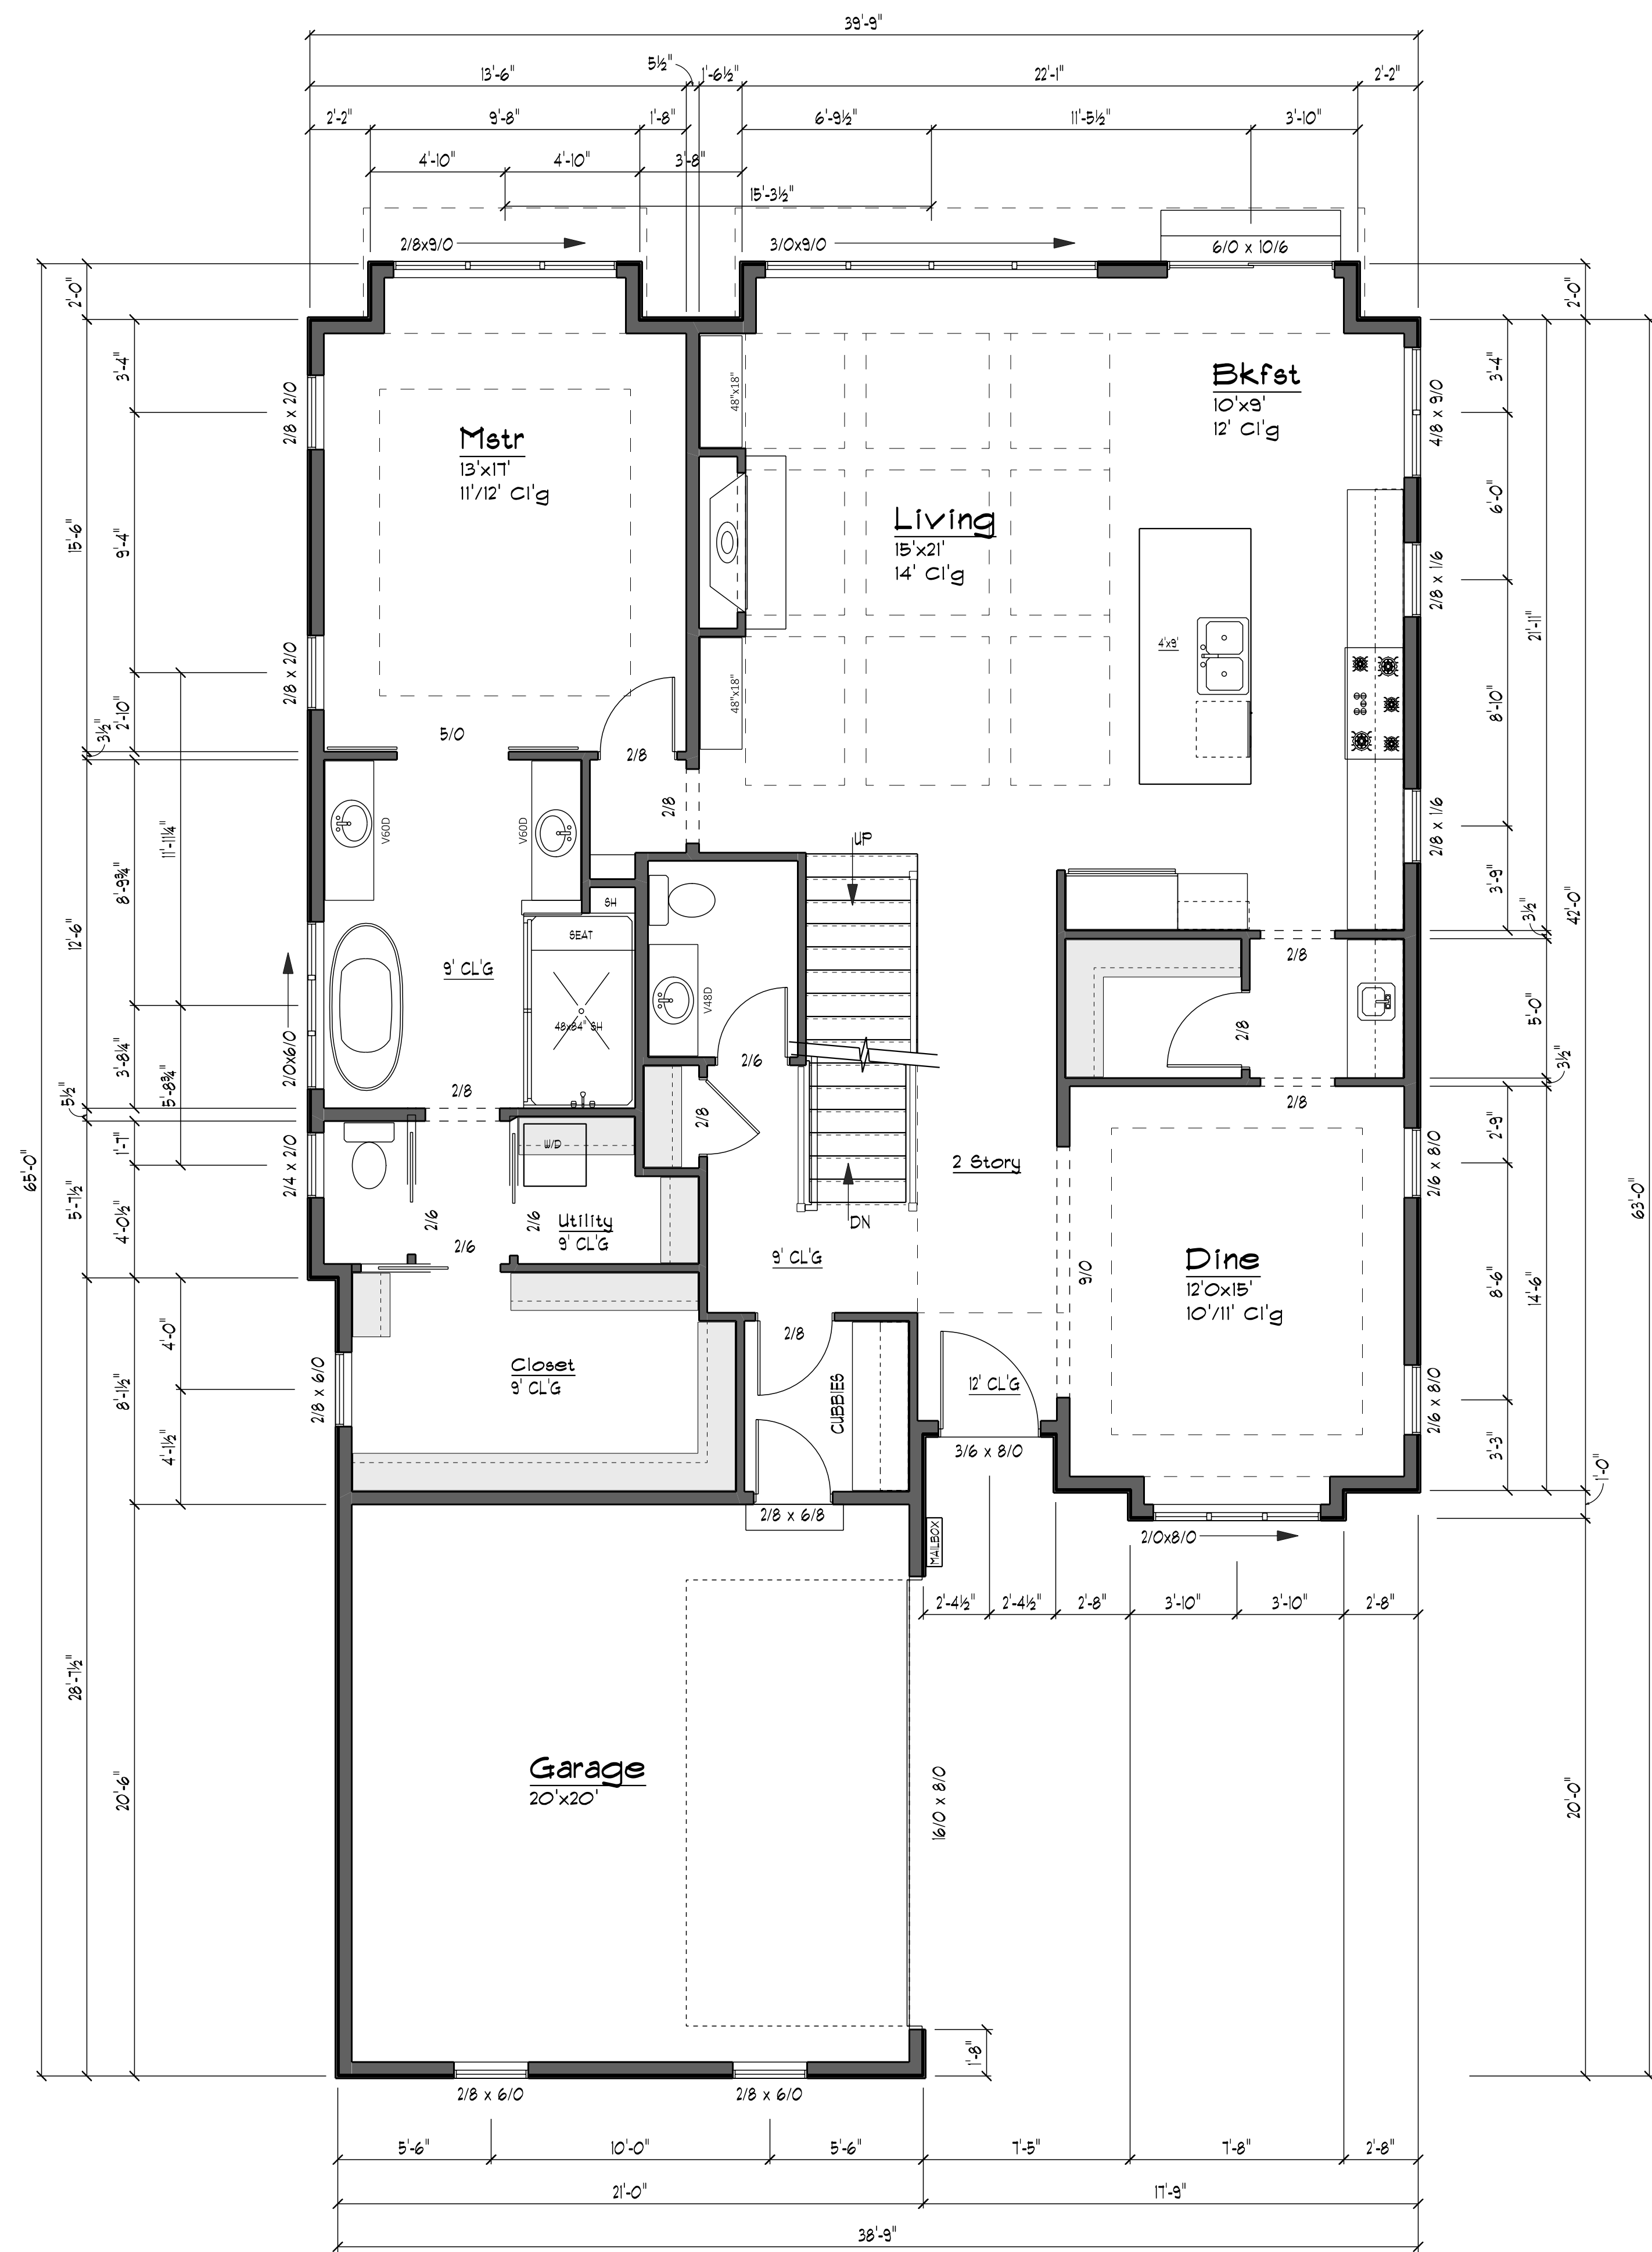

Dominion Homes

All room dimensions and square footages are approximate.

1st Floor

1,734sf. + 850sf. 2nd flr. = 2,584sf.

18 MidPark, Ladue

THE

Thompson
Design Group LLC

Design Group LLC

452 Jung's Station Rd.
St. Charles MO 63303-6243 (314) 283 8735

St. Charles MO 63303-6243 (314) 283 8735

18 Midpark Lane

1. The first step is to identify the problem or question that needs to be answered. This involves understanding the context and the specific requirements of the task.

Dominion Homes, LLC
 sales@dominionhomes.com (314) 220-1133

[illegible]

REVISIONS:

A1 of 3

13/25

Job#: 070925

Exterior Materials

18 Midpark Lane



Sierra Pacific, H3
Casement, White



Certainteed Asphalt Shingle
Roof, Georgetown Gray



Delden Delvation DV400 Garage
Door, White, No Windows



Horizon-Loc Metal Roof, Charcoal Gray



JamesHardie Plank Siding, Select Cedarmill,
Statement Collection, Light Mist



JamesHardie Trim Batten
Boards, Smooth Grain, Statement
Collection, Light Mist



Poured concrete w/ exposed
aggregate, Glacial