BCPL White Marsh

SYMBOLS & TAGS LEGEND DESCRIPTION DOOR TAG (101A) CASEWORK TAG AS OUTLINED IN THE CABINET DEPTH ARCHITECTURAL WOODWORK INSTITUTE (AWI) STANDARDS 1t SPECIALTY EQUIPMENT TAG DESIGNATION LEVEL ELEVATION TAG NORTH ARROW TAG T = TRUE NORTH P = PROJECT NORTH ROOM 101 **ROOM NAME &** NUMBER TAG SECTION TAG \A101/ CALLOUT / DETAIL A101 SPOT ELEVATION TAG → DRAWING TITLE TITLE TAG DRAWING SCALE 99 **PARTITION TAG** MATERIAL TAG 6:12 ROOF SLOPE ANNOTATION **ELEVATION TAG** SPECIFIC NOTE CONSTRUCTION DEMOLITION

PATTERN	DESCRIPTION
	BRICK
	CMU MASONRY
	CONCRETE SECTION
	POROUS FILL
	EARTH
	PLYWOOD
	GYPSUM BOARD SECTION
	RIGID INSULATION
	BATT INSULATION
	END GRAIN LUMBER
	WOOD BLOCK OR SHIM
	FINISH WOOD

AND - AMCHOR BOLT FIT FIRE REFLANDANT TREATED FOLLOWS AND STANDARD - AMONG COLOR FOLLOW FIX FOLLOW FOLLOW FIX						_	_	
2								
DAMETER		_			-			
1	$\bar{\Phi}$	-			-			
MACHOR BOLT		_			_			
AND A AMCHOR BOLT FIT							PVMT -	
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APP - ABOVE PRINSE FLOOR - FTG - FOOTING					-			
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## ACCESS PAREL		-		G				
APPROXIMATELY					-		•	-
ACHTECTURAL GL					_	•		
GND					_			
BOTTOM CHOOD				GND	-		RO -	ROUGH OPENING
SEC SOUTOM CHORD GOVB GYPSUM WALL BOAD	В			GRTG	-		RST -	REINFORCING STEEL
BUILDING	B.C.	-	BOTTOM CHORD	GWB	-	GYPSUM WALL BOARD		
BINCKING		-						
BILKHE AD		-						
BEAM					-			
BOTTOM OF								
BOD BASIS OF DESIGN HORIZ HORIZONTAL SED SEE ELECTRICAL DRAWING								
DOTTOM								
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CT. / CT	CONSTR	-	CONSTRUCTION	LTG	-			SWITCH
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CLUYD CUBIC YARD MECH MECH MECH MECH TEMP TEMPRATURE		-						
MEP MECHANICAL / ELECTRICAL / THK THICK								
D. PLUMBING	CO 1D		COBIC TARD					
December	D					, ,		
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DIM	DEG	-		MH	-	MANHOLE	T0 -	TOP OF
Dead Damper	DIA	-	DIAMETER	MIN	-	MINIMUM	TOB -	TOP OF BEARING POINT
DMMPR	DIM	-	DIMENSION	MO	-	MASONRY OPENING		TOP OF CONCRETE
DOWN		-	DEAD LOAD	MSNRY	-	MASONRY		
DOOR		-			-			
DS - DOWNSPOUT - DETAIL N		-						
DTL - DETAIL N		-		MTD	-	MOUNTED		
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EQ - EQUAL OPNG - OPENING VIF - VERIFY IN FIELD EST - ESTIMATE OPP - OPPOSITE VOL - VOLUME ETR - EXISTING TO REMAIN OPP HND- OPPOSITE HAND EW - EACH WAY OV - OVER W		-	EXPANSION JOINT	OFOI	-			VINYL COMPOSITION TILE
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ETR - EXISTING TO REMAIN OPP HND- OPPOSITE HAND EW - EACH WAY OV - OVER W								
EW - EACH WAY OV - OVER W							VOL -	VOLUME
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EXP JT - EXPANSION JOINT P.LAM - PLASTIC LAMINATE W.B WHITEBOARD PLY - PLYWOOD WD - WOOD F				Р				
PLY - PLYWOOD WD - WOOD F. WATER RESISTANT F. FARENHEIT PNLBD - PANELBOARD WTRPRF - WATERPROOF F. FLOOR DRAIN PNT/ PT - PAINT WWF - WELDED WIRE FABRIC F. FIRE EXTINGUISHER POLYISO - POLYISOCYANURATE WWM - WELDED WIRE MESH F. FIRE EXTINGUISHER CABINET PRESS - PRESSURE F. FINISHED FLOOR PROJ - PROJECT F. FINISHED FLOOR ELEVATION PROP - PROPERTY F. FIRE HYDRANT								
F	_/11 J1		2/11/11/21/21/11/11					
FARENHEIT PNLBD - PANELBOARD WTRPRF - WATERPROOF FD - FLOOR DRAIN PNT/ PT - PAINT WWF - WELDED WIRE FABRIC F.E FIRE EXTINGUISHER POLYISO - POLYISOCYANURATE WWM - WELDED WIRE MESH F.E.C FIRE EXTINGUISHER CABINET PRESS - PRESSURE FF - FINISHED FLOOR PROJ - PROJECT FF EL - FINISHED FLOOR ELEVATION PROP - PROPERTY FG - FINISHED GRADE FHY - FIRE HYDRANT								
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F.E.C FIRE EXTINGUISHER CABINET PRESS - PRESSURE FF - FINISHED FLOOR PROJ - PROJECT FF EL - FINISHED FLOOR ELEVATION PROP - PROPERTY FG - FINISHED GRADE FHY - FIRE HYDRANT				,				
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FG - FINISHED GRADE FHY - FIRE HYDRANT		-	FINISHED FLOOR					
FHY - FIRE HYDRANT		-		PROP	-	PROPERTY		
		-						
FDC - FIRE DEPARTMENT CONNECTION			FIRE HYDRANT					

8133 SANDPIPER CIRCLE BALTIMORE, MD 21236 **BID/PERMIT SET** 03/15/2024

PROJECT TEAM ARCHITECT MANNS WOODWARD STUDIOS 10839-D PHILADELPHIA ROAD WHITE MARSH MARYLAND 21162


PHONE: 410-344-1460

FAX: 443-403-2460

MEP ENGINEERING CC JOHNSON & MALHOTRA 9891 BROKEN LAND PARKWAY COLUMBIA, MD 21046 PHONE: 410-461-9920

CORRELATION AND INTENT OF THE CONTRACT DOCUMENTS

THE INTENT OF THE CONSTRUCTION DRAWINGS AND THE CONSTRUCTION SPECIFICATIONS/PROJECT MANUAL IS TO INCLUDE ALL ITEMS NECESSARY FOR THE PROPER EXECUTION AND COMPLÉTION OF THE WORK BY THE CONTRACTOR. THE CONSTRUCTION DRAWINGS AND THE CONSTRUCTION SPECIFICATIONS/PROJECT MANUAL ARE COMPLEMENTARY, AND WHAT IS REQUIRED BY ONE SHALL BE AS BINDING AS IF REQUIRED BY ALL; PERFORMANCE BY THE CONTRACTOR SHALL BE REQUIRED ONLY TO SPECIFICATIONS/PROJECT MANUAL AND REASONABLY INFERABLE FROM THEM AS BEING NECESSARY TO PRODUCE THE INDICATED/INTENDED RESULTS. IN THE CASE OF INCONSISTENCIES BETWEEN THE CONSTRUCTION DRAWINGS AND THE CONSTRUCTION SPECIFICATIONS/PROJECT MANUAL OR WITHIN EITHER DOCUMENT NOT CLARIFIED BY ADDENDUM, THE BETTER QUALITY OR GREATER QUANTITY OF WORK SHALL BE PROVIDED IN ACCORDANCE WITH THE ARCHITECT'S INTERPRETATION.

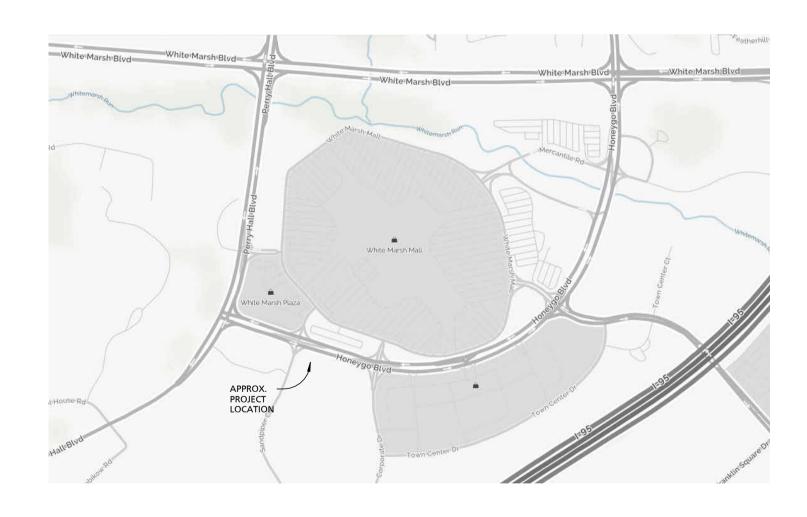

CODE ANALYSIS, PLAN, & DIAGRAM TYPICAL ACCESSIBILITY GUIDELINES ARCHITECTURAL - DEMOLITION DEMOLITION FLOOR PLAN DEMOLITION CEILING PLAN ARCHITECTURAL - NEW WORK **BUILDING ASSEMBLY TYPES AND NOTES** REFERENCE PLAN DIMENSION PLAN A103 FINISH PLAN **FINISH DETAILS** FFE PLAN & SCHEDULE DOOR SCHEDULE & DETAILS **ENLARGED PLANS & ELEVATIONS ENLARGED PLANS & ELEVATIONS ENLARGED PLANS & ELEVATIONS** TYPICAL DETAILS REFLECTED CEILING PLAN TYPICAL ADA SIGNAGE DETAILS MECHANICAL MECHANICAL LEGEND AND ABBREVIATIONS MECHANICAL - PARTIAL FLOOR PLAN - DEMOLITION AND NEW PLUMBING PLUMBING - LEGEND AND ABBREVIATIONS PLUMBING - PARTIAL FLOOR PLAN - DEMOLITION PLUMBING - PARTIAL FLOOR PLAN - NEW WORK PLUMBING RISER DIAGRAM - NEW WORK LEGEND AND ABBREVIATION **ELECTRICAL GENERAL NOTES** ELECTRICAL - PARTIAL FLOOR PLAN - DEMOLITION ELECTRICAL - PARTIAL FLOOR PLAN - NEW WORK

ELECTRICAL SCHEDULES


DRAWING INDEX

SHEET NUMBER

GENERAL / CODE

VICINITY MAP NOT TO SCALE

SUBDIVISION:

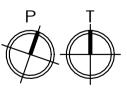

SEAL	PROFESSIONAL CERTIFIC	CATION	AS-BUILT / REV	ISION	BY	DATE	P.W.A. NO.	KEY SHEET	POSITION SHT	DRAWIN	G SCALE	
OF MADI	I HEREBY CERTIFY THAT THESE DOCUMENTS APPROVED BY ME, AND THAT I AM A DULY LIC		BID/PERMIT	SET		03.15.24	-	-	-	PLAN SCALE:	As indicated	APPROVED BY:
	PROFESSIONAL ARCHITECT UNDER THE LAWS						R.O.W NO.	-	-			DIRECTO
	MARYLAND. LICENSE NO. 15505 EXPIRATION DA	ATE: 08-18-2024					-	-	-	PROFILE SCALE:	-	DATE:
	ARCHITECT:	DGN BY:	BUREAU OF ENGINEERING AND CONSTRUCTION		HIGH	HWAYS	STRUCTURES	STORM DRAINS	SEWER	WATER	FIELD ENGINEER	PROPERTY MANAGEMENT
ARCHITECANIA	PRINCIPAL ARCHITECT MANNS WOODWARD STUDIOS	DWN BY:	REVIEWED BY:									APPROVED BY: <i>GM Doran</i>
DATE 03-15-2024	10839-D PHILADELPHIA ROAD WHITE MARSH, MARYLAND 21162 (P) 410-344-1460	CHKD BY:	DATE REVIEWED:									DATE: 4/17/2024

BALTIMORE COUNTY OFFICE OF BUDGET AND FINANCE, PROPERTY MANAGEMENT

BCPL White Marsh COVER SHEET BID/PERMIT SET

8133 SANDPIPER CIRCLE BALTIMORE, MD 21236

G000

SHEET DESIGNATION | CONTRACT NUMBER 24066 PO0 JOB ORDER NUMBER 10611599 SHEET 1 OF 29 DRAWING NUMBER

2024-0326 **ELECTION DIST. NO.:** FILE NO.: 10611599

CODE ANALYSIS

BALTIMORE COUNTY PUBLIC LIBRARIES - WHITE MARSH BRANCH

2018 EDITION NFPA 1

PROJECT ADDRESS: 8133 SANDPIPER CIRCLE BALTIMORE, MD 21236

APPLICABLE CODES: 2015 INTERNATIONAL EXISTING BUILDING CODE 2015 INTERNATIONAL BUILDING CODE 2015 INTERNATIONAL MECHANICAL CODE 2015 NATIONAL STANDARD PLUMBING CODE 2014 NATIONAL ELECTRIC CODE

2015 INTERNATIONAL ENERGY CODE MARYLAND ACCESSIBILITY CODE (COMAR 05.02.02) & ADA 2010 2010 ADAAG 2018 NATIONAL FIRE PROTECTION ASSOCIATION (NFPA 101)

THE ENCLOSED DRAWINGS ARE FOR RENOVATIONS TO THE MEETING ROOM AND ADJOINING STORAGE ROOMS, RESTROOMS, JANITOR CLOSET, AND LOBBY OF THE EXISTING BALTIMORE COUNTY PUBLIC LIBRARY WHITE MARSH BRANCH. RENOVATIONS TO THE MEETING ROOM ARE COSMETIC IN NATURE AND INCLUDE THE REPLACEMENT OF THE EXISTING FLOOR FINISH, CEILING FINISH, AND LIGHTING. THE EXISTING STORAGE ROOMS, RESTROOMS, AND ADJACENT HALLWAY WILL BE DEMOLISHED AND RECONFIGURED TO INCREASE THE STORAGE CAPACITY FOR THE MEETING ROOM, AND PROVIDE UPDATED LAYOUTS FOR THE RESTROOMS TO BETTER SERVE THE LIBRARY CLIENTELE. THE LOBBY AND NEW CORRIDOR AREA IMMEDIATELY ADJACENT TO THE NEW RESTROOMS SHALL RECEIVE NEW FLOOR FINISHES, CEILING FINISH, AND LIGHTING. THE PROPOSED RENOVATIONS DO NOT INVOLVE CHANGES TO EXISTING USE AND OCCUPANCY, STRUCTURAL WORK, EXTERIOR MODIFICATIONS, OR CHANGES IN OCCUPANT LOAD.

IEBC 2015

<u>CLASSIFICATION OF WORK - CHAPTER 5</u>
- ALTERATION LEVEL 2, TO COMPLY WITH CHAPTERS 7 & 8

COMPLIANCE METHOD TO BE THE WORK COMPLIANCE METHOD - CHAPTERS 3 & 5
- WORK AREA = 2,174 SF, WHICH IS LESS THAN 50% OF THE BUILDING AREA (APPROXIMATELY 12,833 SF)

MATERIALS AND METHODS - (702.6)
- ALL NEW WORK SHALL COMPLY WITH MATERIALS AND METHODS REQUIREMENTS OF IBC, IECC, IMC, AND IPC

- ALTERATIONS SHALL BE DONE IN A MANNER THAT MAINTAINS THE LEVEL OF FIRE PROTECTION PROVIDED, SEE (804.2.2)

MEANS OF EGRESS (704.1)

- ALTERATIONS SHALL BE DONE IN A MANNER THAT MAINTAINS THE LEVEL OF PROTECTION PROVIDED FOR THE MEANS OF EGRESS

CHAPTER 8: ALTERATIONS LEVEL 2

- ALL NEW CONSTRUCTION ELEMENTS, COMPONENTS, SYSTEMS AND SPACES SHALL COMPLY WITH THE REQUIREMENTS OF THE IBC

FIRE PROTECTION (804.2.2) - AS THE WORK AREA DOÉS NOT EXCEED 50% OF THE FLOOR AREA, A NEW SPRINKLER SYSTEM IS NOT REQUIRED

MEANS OF EGRESS (805.2) - EXCEPTION 2

- MEANS OF EGRESS CONFORMING TO THE REQUIREMENTS OF THE BUILDING CODE UNDER WHICH THE BUILDING WAS CONSTRUCTED SHALL BE CONSIDERED COMPLIANT MEANS OF EGRESS IF, IN THE OPINION OF THE CODE OFFICIAL, THEY DO NOT CONSTITUTE A DISTINCT HAZARD TO LIFE. - THE EXISTING EGRESS SYSTEM SERVING THE EXISTING LIBRARY IS TO REMAIN; THERE IS NO CHANGE IN OCCUPANCY CLASSIFICATION OR OCCUPANT LOAD, NOR IS THERE ANY NEW CONSTRUCTION OBSTRUCTING THE EXISTING EXITS WHILE THE BUILDING IS OCCUPIED.

MINIMUM NUMBER OF PLUMBING FIXTURES (810.1) - NOT APPLICABLE DUE TO NO CHANGE IN THE OCCUPANT LOAD

IBC 2015

USE AND OCCUPANCY CLASSIFICATION - CHAPTER 3

- THE EXISTING LIBRARY (A-3) IS TO REMAIN

GENERAL BUILDING HEIGHT AND AREA - CHAPTER 5 - NO CHANGES ARE PROPOSED

CONSTRUCTION TYPE - CHAPTER 6 - THE EXISTING CONSTRUCTION TYPE IS TYPE III B, UNSPRINKLERED

OCCUPANT LOAD FACTORS (1004.1.2)

- THE EXISTING OCCUPANCY IS TO REMAIN

NUMBER OF EXITS (1006.2.1) - THE EXISTING EXITS ARE TO REMAIN

NFPA 101


CLASSIFICATION OF OCCUPANCY (6.1.2) - EXISTING OCCUPANCY TO REMAIN: ASSEMBLY OCCUPANCY

CLASSIFICATION OF HAZARD (6.2) LOW HAZARD

LEGEND - CODE PLAN LEGEND NOT TO SCALE

lacksquare	ILLUMINATED "EXIT" SIGN
$\overline{\mathbf{Q}}$	ILLUMINATED "EXIT" SIGN W/ DIRECTION INDICATOR
1 HR UL#409 SMOKE PARTITION	RATED WALL TAG
FEC	RECESSED FIRE EXTINGUISHER & CABINET
	1 HOUR RATED PARTITION
	2 HOUR RATED PARTITION
	TRAVEL DISTANCE
	SEPARATION DISTANCE

SUBDIVISION:

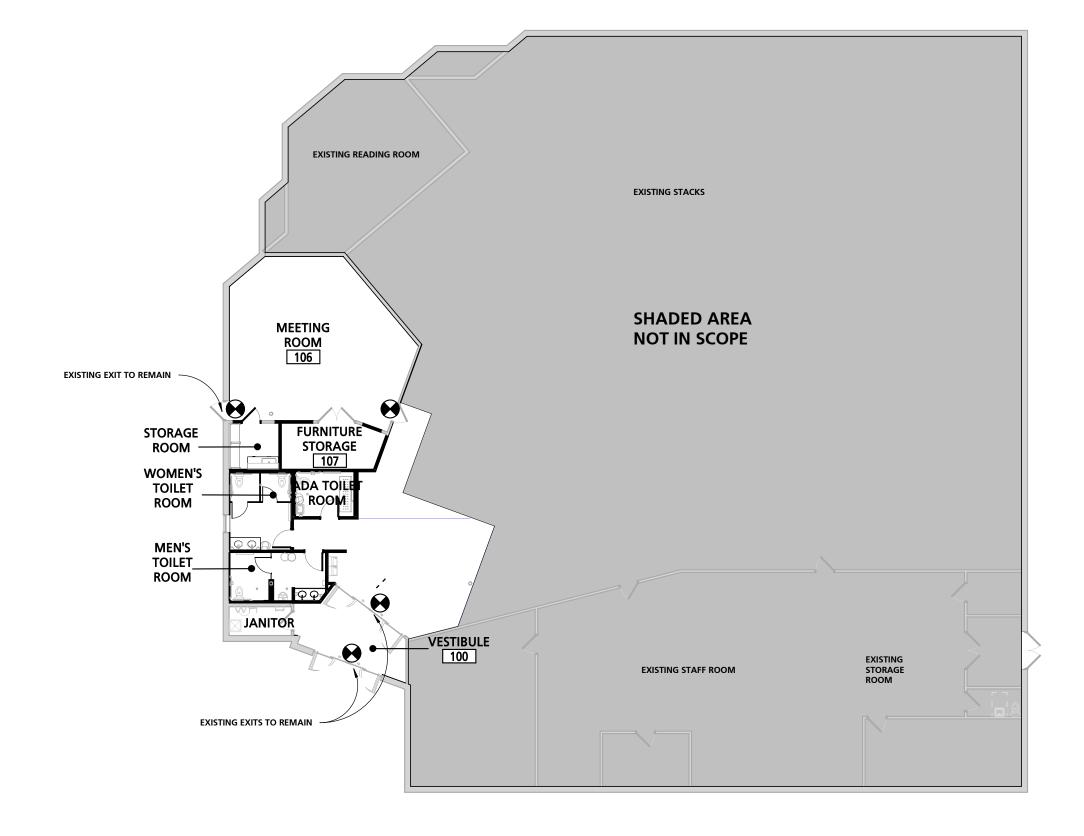


CODE PLAN

		SHEET DESIGNATION	CONTRACT NUMBER
		G001	24066 PO0
BALTIMORE COUNTY OFFICE OF BUDGET AND FINANCE, PROPERTY MANAGEMENT		JORE	JOB ORDER NUMBER
BCPL White Marsh			10611599
CODE ANALYSIS, PLAN, & DIAGRAM			SHEET 2 OF 29
BID/PERMIT SET		***	DRAWING NUMBER
8133 SANDPIPER CIRCLE			2024-0327
BALTIMORE, MD 21236	ELECTION DIST. NO.:	ARYLAND	FILE NO.: 10611599 REV. 12/15

ATE : 03-15-2024

AS-BUILT / REVISION BY DATE P.W.A. NO. KEY SHEET POSITION SHT DRAWING SCALE PROFESSIONAL CERTIFICATION I HEREBY CERTIFY THAT THESE DOCUMENTS WERE PREPARED OR BID/PERMIT SET APPROVED BY: PLAN SCALE: APPROVED BY ME, AND THAT I AM A DULY LICENSED DIRECTOR PROFESSIONAL ARCHITECT UNDER THE LAWS OF THE STATE OF R.O.W NO. MARYLAND. PROFILE SCALE: LICENSE NO. EXPIRATION DATE: BUREAU OF ENGINEERING AND CONSTRUCTION ARCHITECT: ___ PROPERTY MANAGEMENT HIGHWAYS STRUCTURES STORM DRAINS SEWER WATER FIELD ENGINEER DAVID WOODWARD, AIA REVIEWED BY: DWN BY: APPROVED BY: MANNS WOODWARD STUDIOS 10839-D PHILADELPHIA ROAD WHITE MARSH, MARYLAND 21162 DATE REVIEWED:

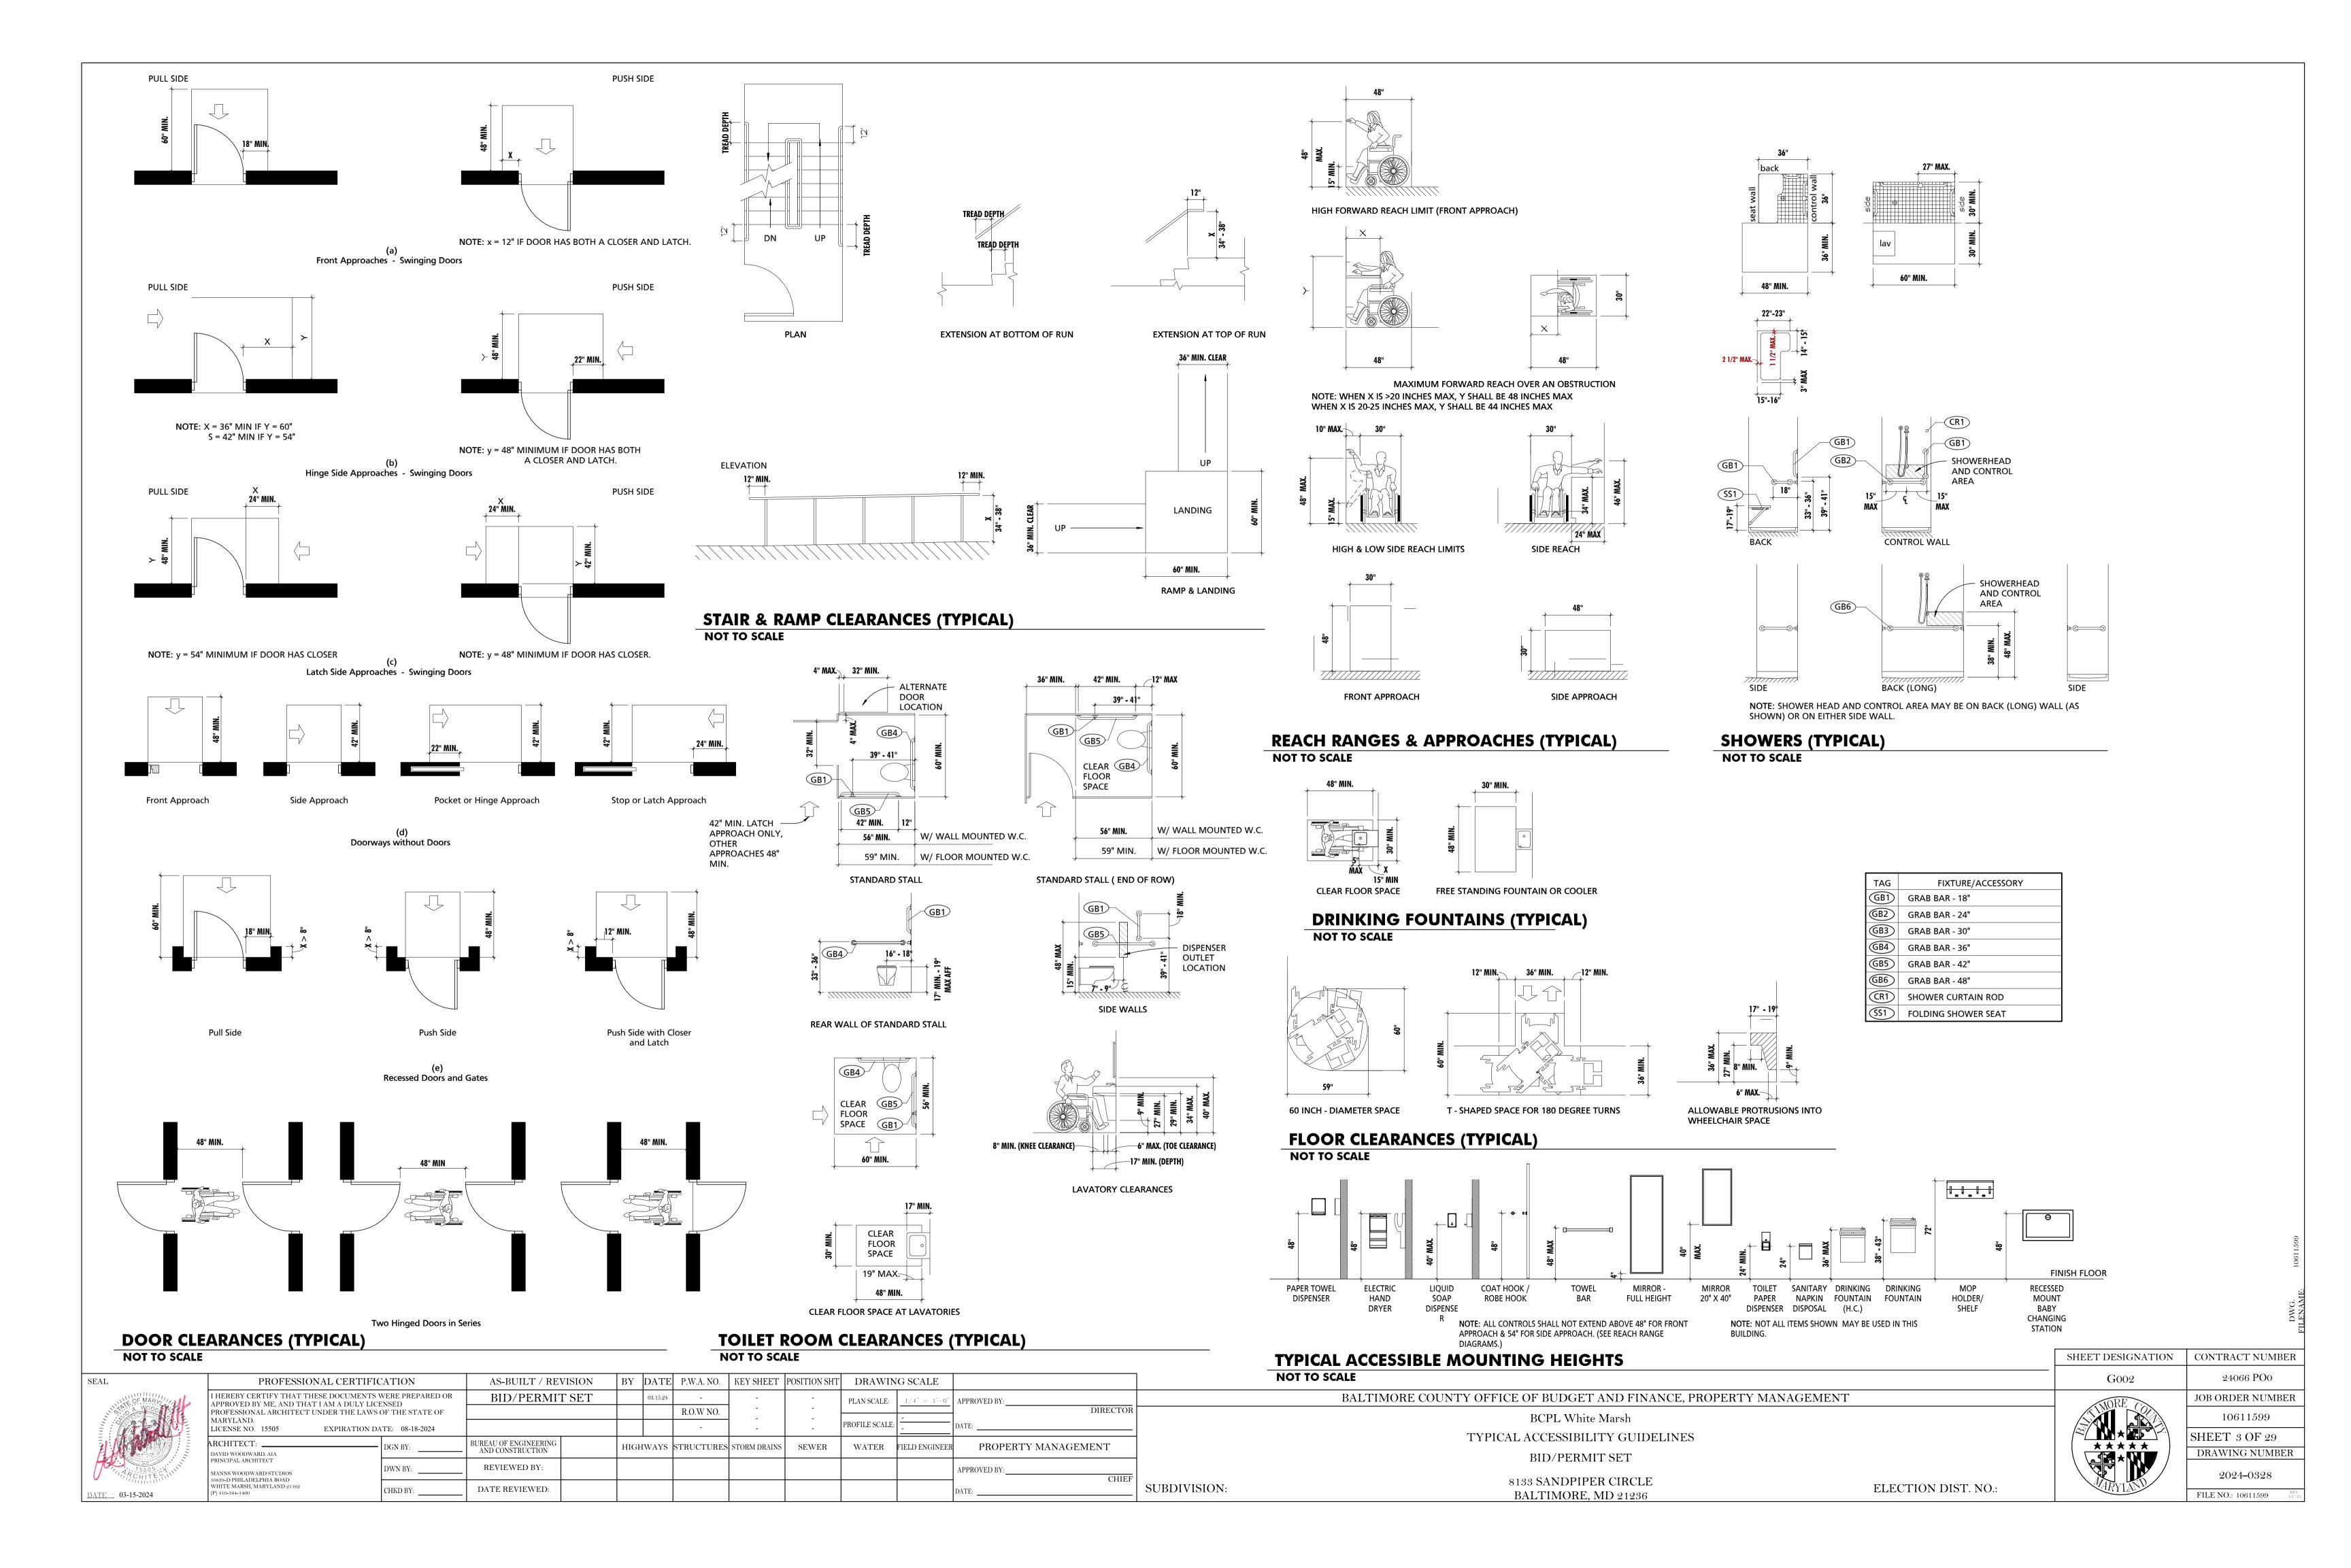



PROPERTY MANAGEMENT

SUBDIVISION:

GENERAL DEMOLITION NOTES

- 1 ALL BIDDERS SHALL MAKE THEMSELVES FAMILIAR WITH THE EXISTING PROJECT CONDITIONS PRIOR TO SUBMITTING A BID. THIS IS INCLUSIVE OF CONDITIONS ABOVE ACCESIBLE CEILINGS TO DETERMINE WORKING CONDITIONS.
- 2 PRIOR TO THE PERFORMANCE OF ANY DEMOLITION WORK THE CONTRACTOR SHALL MAKE THEMSELVES FAMILIAR WITH THE EXISTING CONDITIONS OF THE PROJECT. THE CONTRACTOR SHALL BE RESPONSIBLE FOR DESIGNING, PROVIDING, INSTALLING, AND MAINTAINING ALL TEMPORARY SUPPORT AND BRACING REQUIRED TO COMPLETE THE WORK.
- 3 THE CONTRACTOR SHALL BE RESPONSIBLE FOR VERIFYING ALL EXISTING CONDITIONS, DIMENSIONS, CONSTRUCTION ASSEMBLIES AND THE LIKE PRIOR TO FABRICATING, INSTALLING, OR PURCHASING ANY NEW WORK. DETAILS INDICATING EXISTING MATERIALS OF CONDITIONS MAY BE SHOWN WITHIN THE DOCUMENTS BUT ARE NOT INTENDED TO FULLY DEFINE EXISTING CONDITIONS. 4 DEMOLITION WORK MAY BE INDICATED THROUGHOUT THE CONTRACT DOCUMENTS. IT IS THE RESPONSIBILITY OF THE
- CONTRACTOR TO REVIEW ALL DOCUMENTS FOR ADDITIONAL DEMOLITION WORK. 5 IT IS THE CONTRACTORS RESPONSIBILITY TO MAINTAIN SAFE WORKING CONDITIONS THROUGHOUT THE CONSTRUCTION SITE. THE CONTRACTOR SHALL PROVIDE TEMPORARY BARRIERS AS REQUIRED TO PROTECT PERSONS AND PROPERTY AND OTHERWISE MAINTAIN SAFE WORKING CONDITIONS.
- 6 THE CONTRACTOR SHALL MAINTAIN A CLEAR, CLEAN, USEABLE CONSTRUCTION SITE THROUGH DAILY CLEANUP OF WORK AREAS. 7 THE OWNER SHALL BE MAINTAINING OCCUPANCY OF THE SITE AND PORTIONS OF THE BUILDING DURING THE CONSTRUCTION PROCESS. THE CONTRACTOR SHALL COORDINATE WITH THE OWNER AND THE OWNER'S PERSONNEL THROUGHOUT THE CONSTRUCTION TO MINIMIZE, TO THE GREATEST EXTENT POSSIBLE, ANY DISRUPTIONS IN THE OWNER'S WORKING PROCEDURES. THE PHASING OF THE PROJECT SHALL BE DETERMINED BY THE CONTRACTOR AND SHALL NOT BE REASON FOR ADDITIONAL FEES. ADDITIONALLY, THE CONTRACTOR SHALL COORDINATE WITH THE OWNER A MINIMUM OF 72 HOURS PRIOR TO ANY DISRUPTION OF
- SERVICES/UTILITIES REQUIRED TO COMPLETE THE WORK. 8 THE CONTRACTOR SHALL PROVIDE TEMPORARY DUST AND DEBRIS BARRIERS BETWEEN AREAS TO REMAIN IN OPERATION AND WORK AREAS. BARRIERS SHALL BE PROVIDED AT, BUT NOT LIMITED TO HVAC SUPPLY AND RETURN OPENINGS, TRANSFER VENTS, EXHAUST VENTS, AND OTHER SUCH OPENINGS. BARRIERS SHALL BE A MINIMUM OF 10 MIL PLASTIC SHEETING SECURED AND SEALED TO EXISTING CONSTRUCTION AND/OR TEMPORARY FRAMING. PLASTIC SHEETING SHALL BE OVERLAPPED A MINIMUM OF 12" AND TAPED
- 9 THE CONTRACTOR SHALL PROVIDE PROTECTION FROM THE WEATHER FOR PORTIONS OF EXISTING CONSTRUCTION THAT ARE TO REMAIN OCCUPIED OR USEABLE BY THE OWNER OR TO AREAS THAT CONTAIN ITEMS TO REMAIN THAT WILL BE DAMAGED BY
- 10 ALL ITEMS INDICATED TO BE REMOVED AND/OR DEMOLISHED SHALL REMAIN THE PROPERTY OF THE OWNER. THE CONTRACTOR SHALL REVIEW WITH THE OWNER IF ANY ITEMS TO BE REMOVED AND/OR DEMOLISHED ARE TO BE RETAINED BY THE OWNER PRIOR TO ANY DEMOLITION WORK BEING PERFORMED. ALL ITEMS TO BE RETAINED BY THE OWNER SHALL BE REMOVED BY THE CONTRACTOR AND DELIVERED TO THE OWNER IN THE CONDITION FOUND PRIOR TO ANY WORK BEING PERFORMED. ALL OTHER ITEMS INDICATED
- TO BE REMOVED AND/OR DEMOLISHED SHALL BE DISPOSED OF OFF SITE BY THE CONTRACTOR IN A LAWFUL MANNER. 11 THE CONTRACTOR SHALL REPLACE OR REPAIR ANY ITEMS DAMAGED BY THE CONTRACTOR OR ANY OF ITS AGENTS TO A MINIMUM CONDITION MATCHING THE ITEMS' CONDITION AT THE START OF CONSTRUCTION AT NO ADDITIONAL COST TO THE OWNER. 12 THE CONTRACTOR SHALL REPAIR ANY MATERIALS, SYSTEMS, OR FINISHES WITHIN OR OUTSIDE OF THE GENERAL WORK AREA THAT ARE REQUIRED TO BE DISTURBED TO COMPLETE THE ENTIRE SCOPE OF WORK ASSOCIATED WITH BUILDING SYSTEM CONNECTIVITY.
- 13 THE CONTRACTOR SHALL PREPARE ALL SURFACES AFFECTED BY DEMOLITION OPERATIONS TO RECEIVE NEW WORK AS BOTH INDICATED WITHIN THESE DRAWINGS AND SPECIFICATIONS/PROJECT MANUAL AND AS RECOMMENDED BY THE MANUFACTURERS' WRITTEN INSTRUCTIONS FOR THE INSTALLATION OF EACH RESPECTIVE PRODUCT.
- 14 THE CONTRACTOR SHALL REMOVE EXISTING FINISHES AS INDICATED THROUGHOUT THE CONTRACT DOCUMENTS AND ENSURE THAT SUBSTRATE CONDITIONS ARE SMOOTH AND IN SATISFACTORY CONDITION TO RECEIVE NEW WORK. 15 THE CONTRACTOR SHALL REMOVE ALL ANCHORS, FASTENERS, WALL HANGERS, AND MISCELLANEOUS EXTRUSIONS AND
- APPURTENANCES OF ITEMS BOTH NO LONGER INSTALLED AND ITEMS REMOVED THROUGH DEMOLITION PROCEDURES. 16 THE CONTRACTOR SHALL COORDINATE ANY SAW CUTS WITHIN THE EXISTING SLABS WITHIN THE NEW WORK AREA AS REQUIRED TO INSTALL NEW ELECTRICAL CONDUIT, PLUMBING, AND/OR STRUCTURAL ELEMENTS. CONTRACTOR SHALL COORDINATE SIZE, LOCATION, AND DEPTH WITH THE FULL SET OF DOCUMENTS. REPLACE AND REPAIR CONCRETE AND FLASH AS REQUIRED TO CREATE A FLUSH SUBSTRATE AFTER COMPLETION OF WORK TASKS.

0	REFERENCED NOTES - DEMOLITION							
NO.	NOTE							
1	REMOVE EXISTING FLOOR FINISH, BASE AND ALL ASSOCIATED APPURTENANCES DOWN TO SUBFLOOR. PREPARE SURFACE TO RECEIVE NEW WORK.							
2	REMOVE EXISTING DOORS, FRAMES AND ALL ASSOCIATED APPURTENANCES. IF A NEW DOOR IS INFILLING OPENING, SALVAGED DOOR AND FRAME, AND PREPARE OPENING TO RECEIVE NEW WORK.							
3	REMOVE EXISTING TOILET PARTITIONS							
4	REMOVE EXISTING PLUMBING FIXTURES AND TOILET ACCESSORIES							
5	<varies></varies>							
6	REMOVE EXISTING WALL FINISH (IF ANY), AND WALL BASE, PREPARE WALL TO RECEIVE NEW FINISH.							
7	REMOVE EXISTING CEILING AND ALL ASSOCIATED APPURTENANCES IN THEIR ENTIRETY THROUGHOUT SPACE, TYP. CONTRACTOR SHALL PREPARE SPACE TO RECEIVE NEW WORK.							
8	REMOVE EXISTING LIGHTING AND ALL ASSOCIATED APPURTENANCES							
9	REMOVE EXISTING BULKHEAD							
10	REMOVE EXISTING CABINETRY AND ASSOCIATED PLUMBING (SINK)							
11	REMOVE & SALVAGE PASSPORT SCREEN AND ACCESSORIES FOR REINSTALLATION							
12	EXISTING COLUMN TO REMAIN							


PLAN LEGEND EXISTING WALL TO REMAIN EXISTING CONSTRUCTION TO BE DEMOLISHED (SEE DEMO PLANS) NEW WALL/PARTITION

BALTIMORE COUNTY OFFICE OF BUDGET AND FINANCE, PROPERTY MANAGEMENT

BCPL White Marsh DEMOLITION FLOOR PLAN BID/PERMIT SET

8133 SANDPIPER CIRCLE BALTIMORE, MD 21236

ELECTION DIST. NO.:

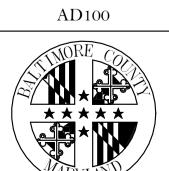

SHEET DESIGNATION | CONTRACT NUMBER 24066 PO0 JOB ORDER NUMBER

10611599 SHEET 4 OF 29 DRAWING NUMBER

2024-0329 FILE NO.: 10611599

ATE : 03-15-2024

PROFILE SCALE: EXPIRATION DATE: 08-18-2024 HIGHWAYS STRUCTURES STORM DRAINS SEWER WATER FIELD ENGINEER REVIEWED BY: DWN BY: 10839-D PHILADELPHIA ROAD WHITE MARSH, MARYLAND 21162

DATE REVIEWED:

CHKD BY:



PROFILE SCALE:

WATER

HIGHWAYS STRUCTURES STORM DRAINS

PROPERTY MANAGEMENT

SUBDIVISION:

BUREAU OF ENGINEERING AND CONSTRUCTION

REVIEWED BY:

DATE REVIEWED:

DWN BY:

CHKD BY:

10839-D PHILADELPHIA ROAD WHITE MARSH, MARYLAND 21162

ATE : 03-15-2024


GENERAL DEMOLITION NOTES

- ALL BIDDERS SHALL MAKE THEMSELVES FAMILIAR WITH THE EXISTING PROJECT CONDITIONS PRIOR TO SUBMITTING A BID. THIS IS INCLUSIVE OF CONDITIONS ABOVE ACCESIBLE CEILINGS TO DETERMINE WORKING CONDITIONS.
- PRIOR TO THE PERFORMANCE OF ANY DEMOLITION WORK THE CONTRACTOR SHALL MAKE THEMSELVES FAMILIAR WITH THE EXISTING CONDITIONS OF THE PROJECT. THE CONTRACTOR SHALL BE RESPONSIBLE FOR DESIGNING, PROVIDING, INSTALLING, AND MAINTAINING ALL TEMPORARY SUPPORT AND BRACING REQUIRED TO COMPLETE THE WORK.
- THE CONTRACTOR SHALL BE RESPONSIBLE FOR VERIFYING ALL EXISTING CONDITIONS, DIMENSIONS, CONSTRUCTION ASSEMBLIES AND THE LIKE PRIOR TO FABRICATING, INSTALLING, OR PURCHASING ANY NEW WORK. DETAILS INDICATING EXISTING MATERIALS OF CONDITIONS MAY BE SHOWN WITHIN THE DOCUMENTS BUT ARE NOT INTENDED TO FULLY DEFINE EXISTING CONDITIONS.
- DEMOLITION WORK MAY BE INDICATED THROUGHOUT THE CONTRACT DOCUMENTS. IT IS THE RESPONSIBILITY OF THE CONTRACTOR TO REVIEW ALL DOCUMENTS FOR ADDITIONAL DEMOLITION WORK.
- IT IS THE CONTRACTORS RESPONSIBILITY TO MAINTAIN SAFE WORKING CONDITIONS THROUGHOUT THE CONSTRUCTION SITE. THE CONTRACTOR SHALL PROVIDE TEMPORARY BARRIERS AS REQUIRED TO PROTECT PERSONS AND PROPERTY AND OTHERWISE MAINTAIN
- THE OWNER SHALL BE MAINTAINING OCCUPANCY OF THE SITE AND PORTIONS OF THE BUILDING DURING THE CONSTRUCTION PROCESS. THE CONTRACTOR SHALL COORDINATE WITH THE OWNER AND THE OWNER'S PERSONNEL THROUGHOUT THE CONSTRUCTION TO MINIMIZE, TO THE GREATEST EXTENT POSSIBLE, ANY DISRUPTIONS IN THE OWNER'S WORKING PROCEDURES. THE PHASING OF THE PROJECT SHALL BE DETERMINED BY THE CONTRACTOR AND SHALL NOT BE REASON FOR ADDITIONAL FEES. ADDITIONALLY, THE CONTRACTOR SHALL COORDINATE WITH THE OWNER A MINIMUM OF 72 HOURS PRIOR TO ANY DISRUPTION OF SERVICES/UTILITIES REQUIRED TO COMPLETE THE WORK.

THE CONTRACTOR SHALL MAINTAIN A CLEAR, CLEAN, USEABLE CONSTRUCTION SITE THROUGH DAILY CLEANUP OF WORK AREAS.

- THE CONTRACTOR SHALL PROVIDE TEMPORARY DUST AND DEBRIS BARRIERS BETWEEN AREAS TO REMAIN IN OPERATION AND WORK AREAS. BARRIERS SHALL BE PROVIDED AT, BUT NOT LIMITED TO HVAC SUPPLY AND RETURN OPENINGS, TRANSFER VENTS, EXHAUST VENTS, AND OTHER SUCH OPENINGS. BARRIERS SHALL BE A MINIMUM OF 10 MIL PLASTIC SHEETING SECURED AND SEALED TO EXISTING CONSTRUCTION AND/OR TEMPORARY FRAMING. PLASTIC SHEETING SHALL BE OVERLAPPED A MINIMUM OF 12" AND TAPED
- THE CONTRACTOR SHALL PROVIDE PROTECTION FROM THE WEATHER FOR PORTIONS OF EXISTING CONSTRUCTION THAT ARE TO REMAIN OCCUPIED OR USEABLE BY THE OWNER OR TO AREAS THAT CONTAIN ITEMS TO REMAIN THAT WILL BE DAMAGED BY
- 10 ALL ITEMS INDICATED TO BE REMOVED AND/OR DEMOLISHED SHALL REMAIN THE PROPERTY OF THE OWNER. THE CONTRACTOR SHALL REVIEW WITH THE OWNER IF ANY ITEMS TO BE REMOVED AND/OR DEMOLISHED ARE TO BE RETAINED BY THE OWNER PRIOR TO ANY DEMOLITION WORK BEING PERFORMED. ALL ITEMS TO BE RETAINED BY THE OWNER SHALL BE REMOVED BY THE CONTRACTOR AND DELIVERED TO THE OWNER IN THE CONDITION FOUND PRIOR TO ANY WORK BEING PERFORMED. ALL OTHER ITEMS INDICATED TO BE REMOVED AND/OR DEMOLISHED SHALL BE DISPOSED OF OFF SITE BY THE CONTRACTOR IN A LAWFUL MANNER.
- THE CONTRACTOR SHALL REPLACE OR REPAIR ANY ITEMS DAMAGED BY THE CONTRACTOR OR ANY OF ITS AGENTS TO A MINIMUM CONDITION MATCHING THE ITEMS' CONDITION AT THE START OF CONSTRUCTION AT NO ADDITIONAL COST TO THE OWNER. 12 THE CONTRACTOR SHALL REPAIR ANY MATERIALS, SYSTEMS, OR FINISHES WITHIN OR OUTSIDE OF THE GENERAL WORK AREA THAT
- ARE REQUIRED TO BE DISTURBED TO COMPLETE THE ENTIRE SCOPE OF WORK ASSOCIATED WITH BUILDING SYSTEM CONNECTIVITY. 13 THE CONTRACTOR SHALL PREPARE ALL SURFACES AFFECTED BY DEMOLITION OPERATIONS TO RECEIVE NEW WORK AS BOTH INDICATED WITHIN THESE DRAWINGS AND SPECIFICATIONS/PROJECT MANUAL AND AS RECOMMENDED BY THE MANUFACTURERS' WRITTEN INSTRUCTIONS FOR THE INSTALLATION OF EACH RESPECTIVE PRODUCT.
- 14 THE CONTRACTOR SHALL REMOVE EXISTING FINISHES AS INDICATED THROUGHOUT THE CONTRACT DOCUMENTS AND ENSURE THAT SUBSTRATE CONDITIONS ARE SMOOTH AND IN SATISFACTORY CONDITION TO RECEIVE NEW WORK.
- 15 THE CONTRACTOR SHALL REMOVE ALL ANCHORS, FASTENERS, WALL HANGERS, AND MISCELLANEOUS EXTRUSIONS AND APPURTENANCES OF ITEMS BOTH NO LONGER INSTALLED AND ITEMS REMOVED THROUGH DEMOLITION PROCEDURES.
- 16 THE CONTRACTOR SHALL COORDINATE ANY SAW CUTS WITHIN THE EXISTING SLABS WITHIN THE NEW WORK AREA AS REQUIRED TO INSTALL NEW ELECTRICAL CONDUIT, PLUMBING, AND/OR STRUCTURAL ELEMENTS. CONTRACTOR SHALL COORDINATE SIZE. LOCATION, AND DEPTH WITH THE FULL SET OF DOCUMENTS. REPLACE AND REPAIR CONCRETE AND FLASH AS REQUIRED TO CREATE A FLUSH SUBSTRATE AFTER COMPLETION OF WORK TASKS.

0	REFERENCED NOTES - DEMOLITION							
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12	EXISTING COLUMN TO REMAIN							

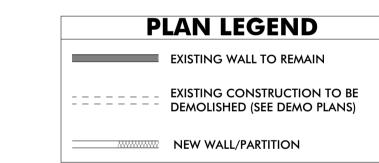

SHEET DESIGNATION | CONTRACT NUMBER 24066 PO0

AD101

JOB ORDER NUMBER 10611599 SHEET 5 OF 29 DRAWING NUMBER

2024-0330 FILE NO.: 10611599

BALTIMORE COUNTY OFFICE OF BUDGET AND FINANCE, PROPERTY MANAGEMENT

BCPL White Marsh DEMOLITION CEILING PLAN

BID/PERMIT SET

BALTIMORE, MD 21236

8133 SANDPIPER CIRCLE

ELECTION DIST. NO.:

	GENERAL PROJECT NOTES
NOTE	
#	NOTE
1 2	THE FOLLOWING GENERAL NOTES APPLY TO THE ENTIRE PROJECT. THE CONTRACTOR SHALL EXAMINE ALL CONTRACT DOCUMENTS AND ALL SPECIFICATIONS AND DRAWINGS FOR THE PROJECT, INCLUDING THOSE THAT MAY PRIMARILY PERTAIN TO MAN FORCES. THE CONTRACTOR SHALL LIST AND C
	WORK THAT THE CONTRACTOR NORMALLY DOES NOT PERFORM WITH ITS OWN FORCES. THE CONTRACTOR SHALL USE ALL OF THE PROJECT DRAWINGS AND SPECIFICATIONS FOR A COMPLETE UNDERSTANDING OF THE PROJECT AND ITS WORK, TO DETERMINE THE TYPE OF CONSTRUCTION AND SYSTEMS, FOR COORDINATION, TO DETERMINE WHAT OTHER WORK MAY BE INVOLVED THROUGHOUT, TO ANTICIPATE AND NOTIFY OTHERS WHEN THEIR COORDINATED EFFORTS WILL BE REQUIRED, AND ALL OTHER RELEVANT MATTERS RELATED TO THE PROJECT AND ITS WORK.
3	IF THERE IS ANY INCONSISTENCY IN THE QUALITY OR QUANTITY OF THE WORK REQUIRED UNDER THE CONTRACT DOCUMENTS, THEN THE CONTRACTOR SHALL (1) IMMEDIATELY NOTIFY THE ARCHITECT IN WRITING OF SUCH INCONSISTENCY AND (2) PROVIDE THE BETTER QUALITY OF OR GREATER QUANTITY OF WORK OR MATERIALS, UNLESS OTHERWISE ORDERED IN WRITING BY THE OWNER. COMPUTED DIMENSIONS SHALL TAKE PRECEDENCE OVER SCALE DIMENSIONS AND LARGE SCALE DRAWINGS SHALL TAKE PRECEDENCE OVER SMALL SCALE DRAWINGS. THE CONTRACT DOCUMENTS GENERALLY SET FORTH THE BASIS AND ANALYSIS OF DESIGN, AND THE CONTRACTOR SHALL OBTAIN SUCH INFORMATION AS MAY BE NECESSARY TO SATISFACTORILY PERFORM AND COMPLETE THE WORK.
4	THE ARCHITECTURAL DRAWINGS ARE A PART OF A LARGER SET OF DRAWINGS WHICH, WHEN COMPLETE, CONSISTS OF ALL DRAWINGS LISTED BY THE INDEX OF DRAWINGS AND WITHIN THE SPECIFICATIONS. THE WORK DESCRIBED BY THE DRAWINGS OF ANY ONE DISCIPLINE MAY BE AFFECTED BY THE WORK DESCRIBED ON DRAWINGS OF ANOTHER DISCIPLINE AND MAY REQUIRE REFERENCE TO THE DRAWINGS OF ANOTHER DISCIPLINE. PARTIAL SETS OF DRAWINGS ARE INCOMPLETE AND SHOULD NOT BE DISTRIBUTED OR UTILIZED BY THE CONTRACTOR. IT IS THE CONTRACTOR'S RESPONSIBILITY TO REVIEW AND COORDINATE THE WORK OF ALL SUB-CONTRACTORS, TRADES, AND SUPPLIERS WITH ALL REQUIREMENTS OF THE CONTRACT DOCUMENTS BEFORE COMMENCING CONSTRUCTION AND TO ASSURE THAT ALL PARTIES ARE AWARE OF ALL REQUIREMENTS, REGARDLESS OF WHERE THE REQUIREMENTS OCCUR IN THE CONTRACT DOCUMENTS, WHICH MIGHT AFFECT THE WORK OF THAT PARTY. THE CONTRACTOR IS RESPONSIBLE FOR ALL COORDINATION BETWEEN SUBCONTRACTORS, SUPPLIERS, AND VENDORS BASED ON THE ENTIRE SET OF THESE DOCUMENTS. NO ADDITIONAL COMPENSATION WILL BE DUE TO A CONTRACTOR FOR ANY ISSUES AS A RESULT OF ANY USE OF AN INCOMPLETE SET OF CONSTRUCTION DOCUMENTS.
5	AT WALLS WITH SOUND ATTENUATION BLANKETS, CONTRACTOR SHALL SEAL DOOR FRAMES, GLAZED OPENING FRAMES, INTERSECTIONS, AND OTHER PENETRATIONS WITH ACOUSTICAL SEALANT.
6	VERIFY ALL ROUGH-IN DIMENSIONS FOR EQUIPMENT PROVIDED IN THIS CONTRACT, OR BY OTHERS. UNLESS NOTED OTHERWISE, ALL MATERIALS AND EQUIPMENT TO BE INSTALLED PER THE APPLICABLE PROVISIONS OF THESE DOCUMENTS AND THE MANUFACTURER'S INSTALLATION INSTRUCTIONS.
7	CUTTING INTO NEW WORK OF OTHER TRADES SHALL BE DONE BY THE TRADE REQUIRING THE CUTTING. ALL CUTTING SHALL BE DONE IN A NEAT MANNER USING SAWS WHERE POSSIBLE. ALL PATCHING AND PAINTING REQUIRED AS A RESULT OF THIS CUTTING SHALL BE THE RESPONSIBILITY OF THE CONTRACTOR. PROVIDE ADEQUATE TEMPORARY SUPPORT FOR WORK BEING CUT AND PATCHED TO PREVENT FAILURE. DO NOT ENDANGER OTHER WORK. PROVIDE ADEQUATE PROTECTION OF OTHER WORK DURING CUTTING AND PATCHING TO PREVENT DAMAGE.
8	PROPERLY PREPARE ALL SURFACES FOR NEW FINISHES. PATCH WITH SEAMS WHICH ARE DURABLE AND AS INVISIBLE AS POSSIBLE. COMPLY WITH SPECIFIC TOLERANCES FOR THE TYPE OF WORK BEING DONE.
9	ALL PENETRATIONS OF FIRE RATED ASSEMBLIES SHALL BE SEALED WITH PROPER/APPROVED THROUGH PENETRATION FIRE STOP SYSTEM AS RECOGNIZED BY AND LISTED WITH NATIONALLY AND ACCEPTED TESTING LABORATORIES.
10	OBTAIN ARCHITECT'S SPECIFIC APPROVAL PRIOR TO DEVIATING FROM THE CONTRACT DOCUMENTS. THE ARCHITECT'S RESPONSIBILITY IS LIMITED TO THE ITEMS SHOWN ON THE ARCHITECTURAL DRAWINGS. IT SHALL BE THE CONTRACTOR'S SOLE RESPONSIBILITY TO COMPLY WITH STANDARD BUILDING AND CONSTRUCTION PRACTICES AND MANUFACTURER'S RECOMMENDATIONS FOR ALL ITEMS NOT SPECIFICALLY INDICATED AND DETAILED ON THE DRAWINGS. FOLLOW THE BEST TRADE PRACTICES AND ENGINEERING FOR THE ITEMS NOT SPECIFICALLY DETAILED AND INDICATED.
11	ALL PARTS OF THE WORK, INCLUDING MATERIALS, METHODS, ASSEMBLIES, ETC, MUST COMPLY WITH THE MINIMUM REQUIREMENTS OF THE GOVERNING REGULATIONS OF ALL FEDERAL, STATE, DISTRICT, AND LOCAL AUTHORITIES HAVING JURISDICTION OVER THE PROJECT AS WELL AS THOSE GREATER REQUIREMENTS INDICATED BY THE CONTRACT DOCUMENTS. NO PART OF THE CONTRACT DOCUMENTS MAY BE CONSTRUED TO REQUIRE OR PERMIT WORK CONTRARY TO A GOVERNING REGULATION.
12	THE CONTRACTOR IS RESPONSIBLE FOR MAINTAINING A CURRENT SET OF CONSTRUCTION DRAWINGS ON SITE DURING CONSTRUCTION. THE CONTRACTOR SHALL INDICATE ON THESE DRAWINGS ALL APPROVED CHANGES TO THE WORK. THIS SET OF DRAWINGS SHALL BE TURNED OVER TO THE OWNER/CLIENT WHEN THE PROJECT IS COMPLETE.
13	THE BUILDING HAS BEEN DESIGNED TO BE SELF-SUPPORTING AND STABLE AFTER THE BUILDING IS FULLY COMPLETED. IT IS SOLELY THE CONTRACTOR'S RESPONSIBILITY TO DETERMINE DEMOLITION, ERECTION PROCEDURES, SEQUENCE, AND TO ENSURE THE STABILITY OF ITS COMPONENTS AND PARTS, AND THE ADEQUACY OF TEMPORARY OR INCOMPLETE CONNECTIONS DURING ERECTION. THIS INCLUDES THE ADDITION OF ANY GUYS, SHORING, SHEETING OR TEMPORARY BRACING AND TIE-DOWNS THAT MIGHT BE NECESSARY. SUCH MATERIALS ARE NOT SHOWN ON THE DRAWINGS. IF APPLIED, THEY SHALL BE REMOVED AS CONDITIONS PERMIT, AND SHALL REMAIN THE CONTRACTOR'S PROPERTY.
14 15	CONTRACTOR SHALL COORDINATE THE FRAMING LAYOUT WITH ELECTRICAL AND MECHANICAL WORK. THE CONTRACTOR SHALL BE RESPONSIBLE FOR OBTAINING ALL MECHANICAL, AND ELECTRICAL PERMITS, AND ALL OTHER RELATED PERMITS REQUIRED TO COMPLETE THE WORK. ALL
	PLUMBING, ELECTRICAL & MECHANICAL CONSTRUCTION SHALL BE DONE IN ACCORDANCE WITH THE LATEST ADOPTED BUILDING CODE AND SHALL BE SUBJECT TO FIELD INSPECTION BY THE AGENCIES HAVING JURISDICTION.
16	MANNS WOODWARD STUDIOS, INC. HAS NO EXPERTISE IN, AND TAKES NO RESPONSIBILITY FOR, CONSTRUCTION MEANS AND METHODS OR JOB SITE SAFETY DURING CONSTRUCTION. PROCESSING AND/OR APPROVING SUBMITTALS MADE BY THE CONTRACTOR CONTAINING INFORMATION RELATED TO CONSTRUCTION METHODS, OR SAFETY ISSUES, OR PARTICIPATION IN MEETINGS WHERE SUCH ISSUES MIGHT BE DISCUSSED. IT SHALL NOT BE CONSTRUED AS VOLUNTARY ASSUMPTION BY MANNS WOODWARD STUDIOS, INC. OR ANY RESPONSIBILITY FOR SAFETY PROCEDURES. IT IS SOLELY THE RESPONSIBILITY OF THE CONTRACTOR TO FOLLOW ALL APPLICABLE SAFETY CODES AND REGULATIONS DURING CONSTRUCTION. MANNS WOODWARD STUDIOS, INC. DOES NOT ENGAGE IN, AND DOES NOT SUPERVISE THE CONSTRUCTION PROCESS.
17	THESE DRAWINGS ARE THE PROPERTY OF MANNS WOODWARD STUDIOS, INC. AND MAY NOT BE MODIFIED OR REPRODUCED WITHOUT WRITTEN PERMISSION. REPRODUCTIONS OF THE DRAWINGS MUST BEAR THE NAME OF THE ARCHITECT AND PROJECT LOCATION. THESE DRAWINGS ARE FULLY PROTECTED BY FEDERAL AND STATE COPYRIGHT LAWS; ANY INFRINGEMENT WILL BE PROSECUTED TO THE FULL EXTENT OF THE LAW.
18	ALL DEVICES INCLUDING SWITCHES, PLATES, THERMOSTATS, CONTROL PANELS, ETC. SHALL BE COORDINATED BY THE CONTRACTOR BASED UPON THE FOLLOWING CRITERIA: A. DEVICES LOCATED WITHIN 36" OF EACH OTHER HORIZONTALLY (IN PLAN VIEW) OF EACH OTHER SHALL BE INSTALLED SUCH THAT THE TOPS OF ALL DEVICES ARE ALIGNED OR THE CENTERLINE OF DEVICES ARE MAINTAINED. B. DEVICES LOCATED VERTICALLY (TWO OR MORE STACKED DEVICES) SHALL BE INSTALLED SUCH THAT THE CENTERLINES ARE MAINTAINED. SEE DIAGRAMS FOR REFERENCE. ADA REACH HEIGHTS AND DEVICE REQUIREMENTS PER CODE SUPERCEDE THIS NOTE AND WHERE IN CONFLICT SHALL REQUIRE COORDINATION AND APPROVAL FROM THE ARCHITECT.
19	FINAL LOCATION OF ALL FIRE ALARM DEVICES, EMERGENCY EGRESS LIGHTING, EXIT SIGNS, FIRE EXTINGUISHERS AND FIRE EXTINGUISHER CABINETS, ETC. SHALL BE REVIEWED AND FIELD COORDINATED WITH CONSIDERATION OF FINAL FINISHES WITH THE ARCHITECT PRIOR TO INSTALLATION. APPROVAL MUST BE OBTAINED BY THE ARCHITECT PRIOR TO INSTALLATION.
20	ALL DEVICES INCLUDING SWITCHES, PLATES, THERMOSTATS, CONTROL PANELS, ETC. SHALL BE COORDINATED BY THE CONTRACTOR BASED UPON THE FOLLOWING CRITERIA: A. DEVICES LOCATED WITHIN 36" OF EACH OTHER HORIZONTALLY (IN PLAN VIEW) OF EACH OTHER SHALL BE INSTALLED SUCH THAT THE TOPS OF ALL DEVICES ARE ALIGNED OR THE CENTERLINE OF DEVICES ARE MAINTAINED. B. DEVICES LOCATED VERTICALLY (TWO OR MORE STACKED DEVICES) SHALL BE INSTALLED SUCH THAT THE CENTERLINES ARE MAINTAINED. SEE DIAGRAMS FOR REFERENCE. ADA REACH HEIGHTS AND DEVICE REQUIREMENTS PER CODE SUPERCEDE THIS NOTE AND WHERE IN CONFLICT SHALL REQUIRE COORDINATION AND APPROVAL FROM THE ARCHITECT.

SUBDIVISION:

ENTRY SPACES, LOBBIES, AND CORRIDORS TO RECEIVE ABUSE RESISTANT GYPSUM WALL BOARD, U.N.O. PROVIDE FIBERGLASS REINFORCED MOISTURE RESISTANT GYPSUM WALL BOARD IN ALL EQUIPMENT ROOMS, JANITOR'S CLOSETS, RESTROOMS, KITCHENS AND OTHER WET AREAS. PROVIDE FIBERGLASS REINFORCED MOISTURE RESISTANT WALL BOARD IN ALL OTHER AREAS WITHIN 8'-0" OF WATER SOURCE. CONTRACTOR SHALL PROVIDE BLOCKING AND NAILERS AS REQUIRED TO SUPPORT ALL NEW WORK, INCLUDING ITEMS TO BE PROVIDED AND/OR INSTALLED BY OWNER. ALL CORRIDOR AND FIRE-RATED PARTITIONS SHALL BE EXTENDED TO THE UNDERSIDE OF THE STRUCTURE ABOVE, U.N.O. THE PERIMETER WALLS OF ANY SPACE NOT PROVIDED WITH A CEILING SHALL EXTEND THE THE UNDERSIDE OF DECK ABOVE. PROVIDE DEFLECTION TRACKS AT TOP OF ALL NON-LOAD BEARING STUD WALLS EXTENDING TO THE UNDERSIDE OF STRUCTURE ABOVE, U.N.O. PROVIDE CONCRETE BACKER BOARD IN LIEU OF GYPSUM WALL BOARD WHERE TILE FINISH IS INDICATED. ALL FIRE WALLS SHALL BE PLACARDED OR STENCILED ON BOTH SIDES WITH THE PHRASE "FIRE WALL" PER IBC SECTION 703.7.1. THE LETTERS SHALL BE RED IN COLOR, 6" INCHES HIGH AND A MIN. OF 3/4" WIDE. THE PHRASE SHALL BE WRITTEN ONCE FOR EACH 15 FEET OF HORIZONTAL WALL LENGTH. THIS SIGNAGE MAY BE LOCATED IN THE CONCEALED SPACE SEE METAL STUD PARTITION FRAMING SCHEDULE FOR INTERIOR PARTITION REQUIREMENTS.


SCHEDULE - INTERIOR PARTITION & WALL TYPE FIRE RATING **ASSEMBLY DESCRIPTION** RATING REF P1 1 1/2" 7/8" METAL FURRING W/ 5/8" GYPSUM WALL BOARD P4 4 1/4" 3 5/8" METAL STUD W/ 5/8" GYPSUM WALL BOARD ONE SIDE P7 4 7/8" 3-5/8" METAL STUD W/ 5/8" GYPSUM WALL BOARD EACH SIDE P8 8 1/4" 6" METAL STUD W/ 5/8" GWB ONE SIDE

INTERIOR APPLICATIONS. SUBSTRATE SHALL BE CLEANED AS REQUIRED AND FREE OF DUST, DEBRIS, AND MOISTURE PRIOR TO ADHESION AND FINISHING

MOISTURE RESISTANT GYPSUM WALL BOARD SHALL BE UTILIZED IN ALL AREAS WHERE GYPSUM WALL BOARD IS TO BE DIRECTLY ADHERED TO CONCRETE OR MASONRY SURFACES IN

CONSTRUCTION OF RATED WALL ASSEMBLIES SHALL BE STRICTLY ADHERED TO IN ACCORDANCE WITH UL AND/OR GYPSUM ASSEMBLY SPECIFICATIONS. REFER TO CODE PLANS FOR

GENERAL PARTITION NOTES

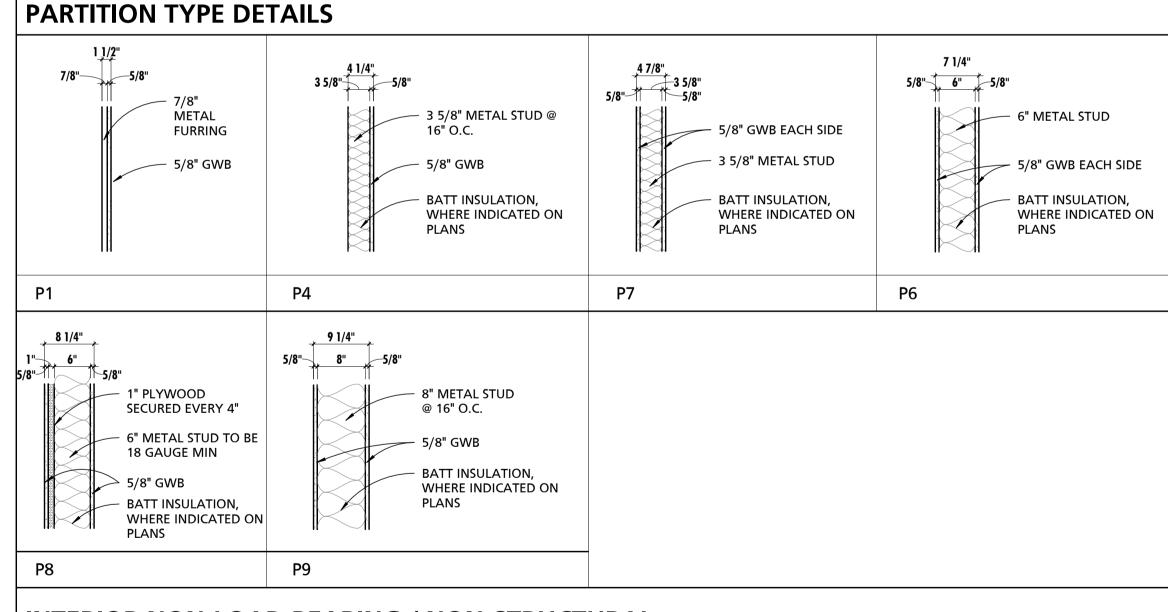

INTERIOR NON-LOAD BEARING / NON-STRUCTURAL PARTITION METAL STUD FRAMING

NOTE: METAL STUD FRAMING SHALL BE MINIMUM 20 GAUGE SPACED @ 16" O.C., UNLESS NOTED OTHERWISE. WIDTH & THICKNESS OF FRAMING SHALL BE AS INDICATED UNLESS HEAVIER/DEEPER/WIDER FRAMING MEMBERS ARE REQUIRED TO ACCOMODATE HEIGHT OR LOADING. FINAL FRAMING MEMBER SIZE AND BRACING SHALL BE THE RESPONSIBILITY OF THE METAL STUD PROVIDER/INSTALLER. WIDTH OF FRAMING SHALL ONLY BE INCREASED WHERE DEEPER/THICKER MEMBERS CANNOT ACCOMODATE HEIGHT OR LOADING.

SEAL
OF MARY WOOO WOOO WOOO WOOO WOOO WOOO WOOO WO

DATE: 03-15-2024

PROFESSIONAL CERTIFIC	CATION	AS-BUILT / REV	VISION	BY	DATE	P.W.A. NO.	KEY SHEET	POSITION SHT	DRAWIN	G SCALE		
I HEREBY CERTIFY THAT THESE DOCUMENTS APPROVED BY ME, AND THAT I AM A DULY LIC		BID/PERMIT	SET		03.15.24	-	-	-	PLAN SCALE:	3/4" = 1'-0"	APPROVED BY:	
PROFESSIONAL ARCHITECT UNDER THE LAWS MARYLAND.						R.O.W NO.	- - -	-	PROFILE SCALE:	-	DATE:	DIRECTOR
ARCHITECT:	DGN BY:	BUREAU OF ENGINEERING AND CONSTRUCTION		HIGH	WAYS	STRUCTURES	STORM DRAINS	SEWER	WATER	FIELD ENGINEER	PROPERTY MANAGI	EMENT
PRINCIPAL ARCHITECT MANNS WOODWARD STUDIOS	DWN BY:	REVIEWED BY:									APPROVED BY:	CHIEF
10839-D PHILADELPHIA ROAD WHITE MARSH, MARYLAND 21162 (P) 410-344-1460	CHKD BY:	DATE REVIEWED:									DATE:	

BALTIMORE COUNTY OFFICE OF BUDGET AND FINANCE, PROPERTY MANAGEMENT

ABOVE A CEILING.

ADDITIONAL INFORMATION.

P9 9 1/4" 8" METAL STUD W/ 5/8" GYPSUM WALL BOARD EACH SIDE

BCPL White Marsh

BUILDING ASSEMBLY TYPES AND NOTES

8133 SANDPIPER CIRCLE BALTIMORE, MD 21236


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A100

SHEET DESIGNATION | CONTRACT NUMBER 24066 PO0 JOB ORDER NUMBER 10611599 SHEET 6 OF 29 DRAWING NUMBER

> 2024-0331 FILE NO.: 10611599

ELECTION DIST. NO.:



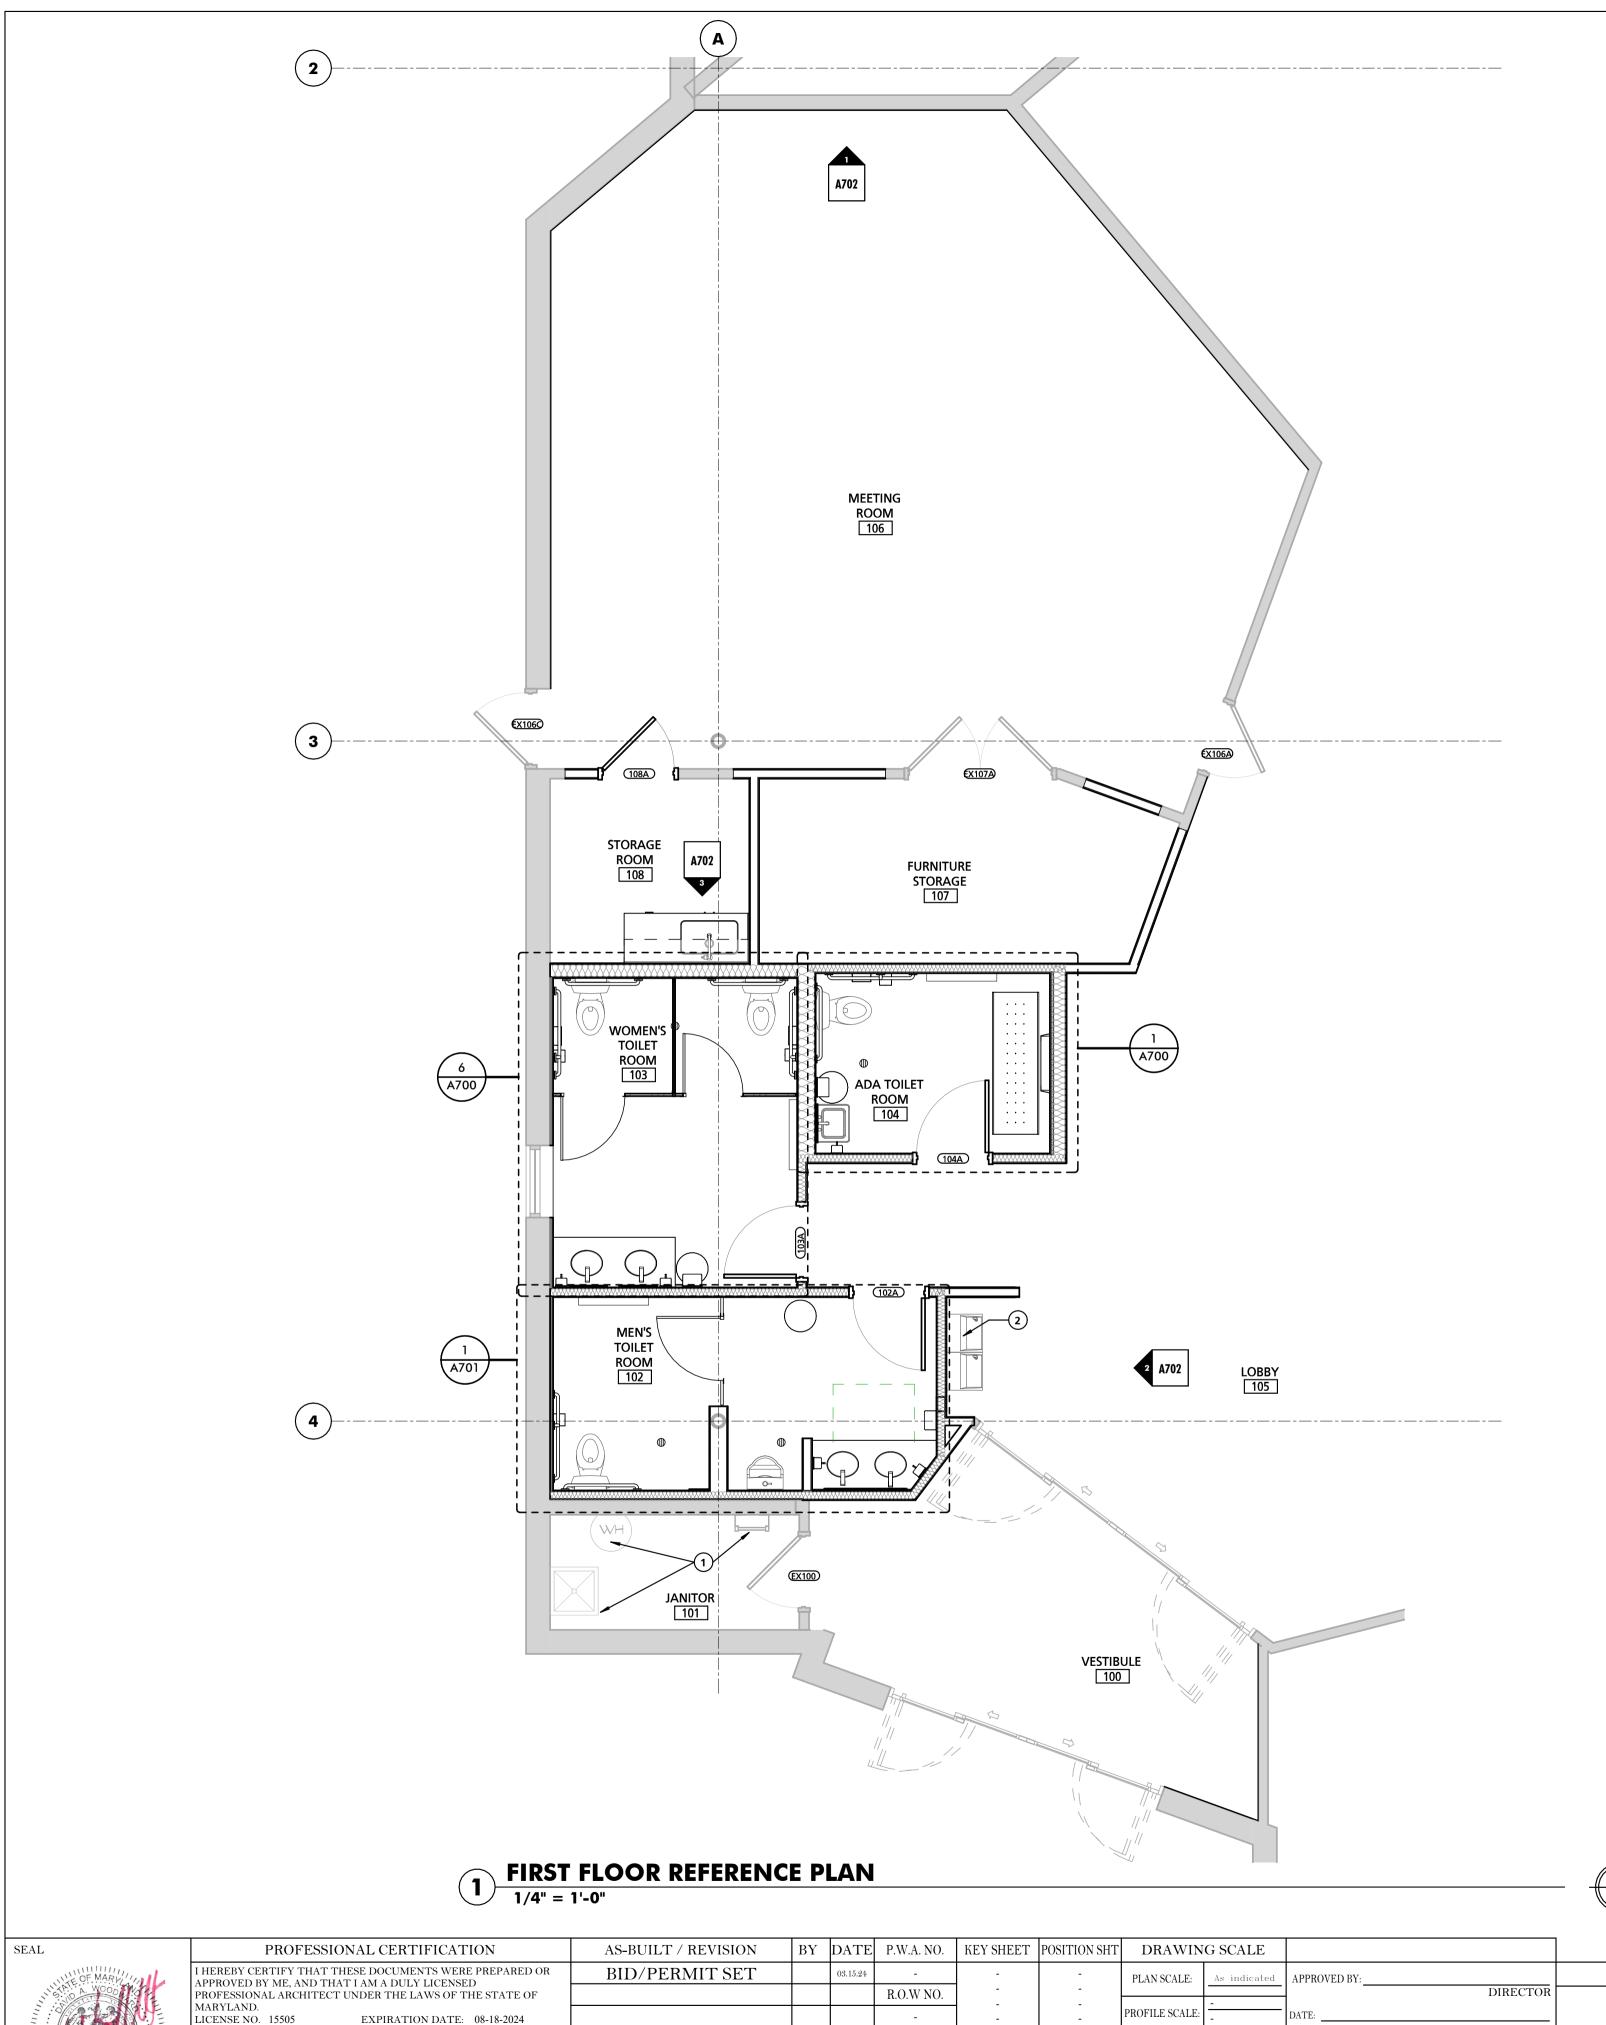

1 FURNITURE SHOWN FOR REFERENCE PURPOSES ONLY.

REFERENCED NOTES - NEW CONSTRUCTION

EXISTING WATER HEATER, MOP SINK AND ROOF LADDER TO REMAIN. SEE MEP DRAWINGS FOR ADDITIONAL DETAILS. NEW DRINKING FOUNTAINS, SEE MEP DRAWINGS FOR ADDITIONAL DETAILS.

PLAN LEGEND

EXISTING WALL TO REMAIN EXISTING CONSTRUCTION TO BE DEMOLISHED (SEE DEMO PLANS)

NEW WALL/PARTITION

A101

SHEET DESIGNATION | CONTRACT NUMBER 24066 PO0 JOB ORDER NUMBER

10611599 SHEET 7 OF 29 DRAWING NUMBER

2024-0332 FILE NO.: 10611599

BALTIMORE COUNTY OFFICE OF BUDGET AND FINANCE, PROPERTY MANAGEMENT

BCPL White Marsh REFERENCE PLAN BID/PERMIT SET

8133 SANDPIPER CIRCLE


BALTIMORE, MD 21236

SUBDIVISION:


ELECTION DIST. NO.:



BUREAU OF ENGINEERING AND CONSTRUCTION HIGHWAYS STRUCTURES STORM DRAINS SEWER WATER FIELD ENGINEER PROPERTY MANAGEMENT REVIEWED BY: DWN BY: MANNS WOODWARD STUDIOS 10839-D PHILADELPHIA ROAD WHITE MARSH, MARYLAND 21162 DATE REVIEWED: CHKD BY:

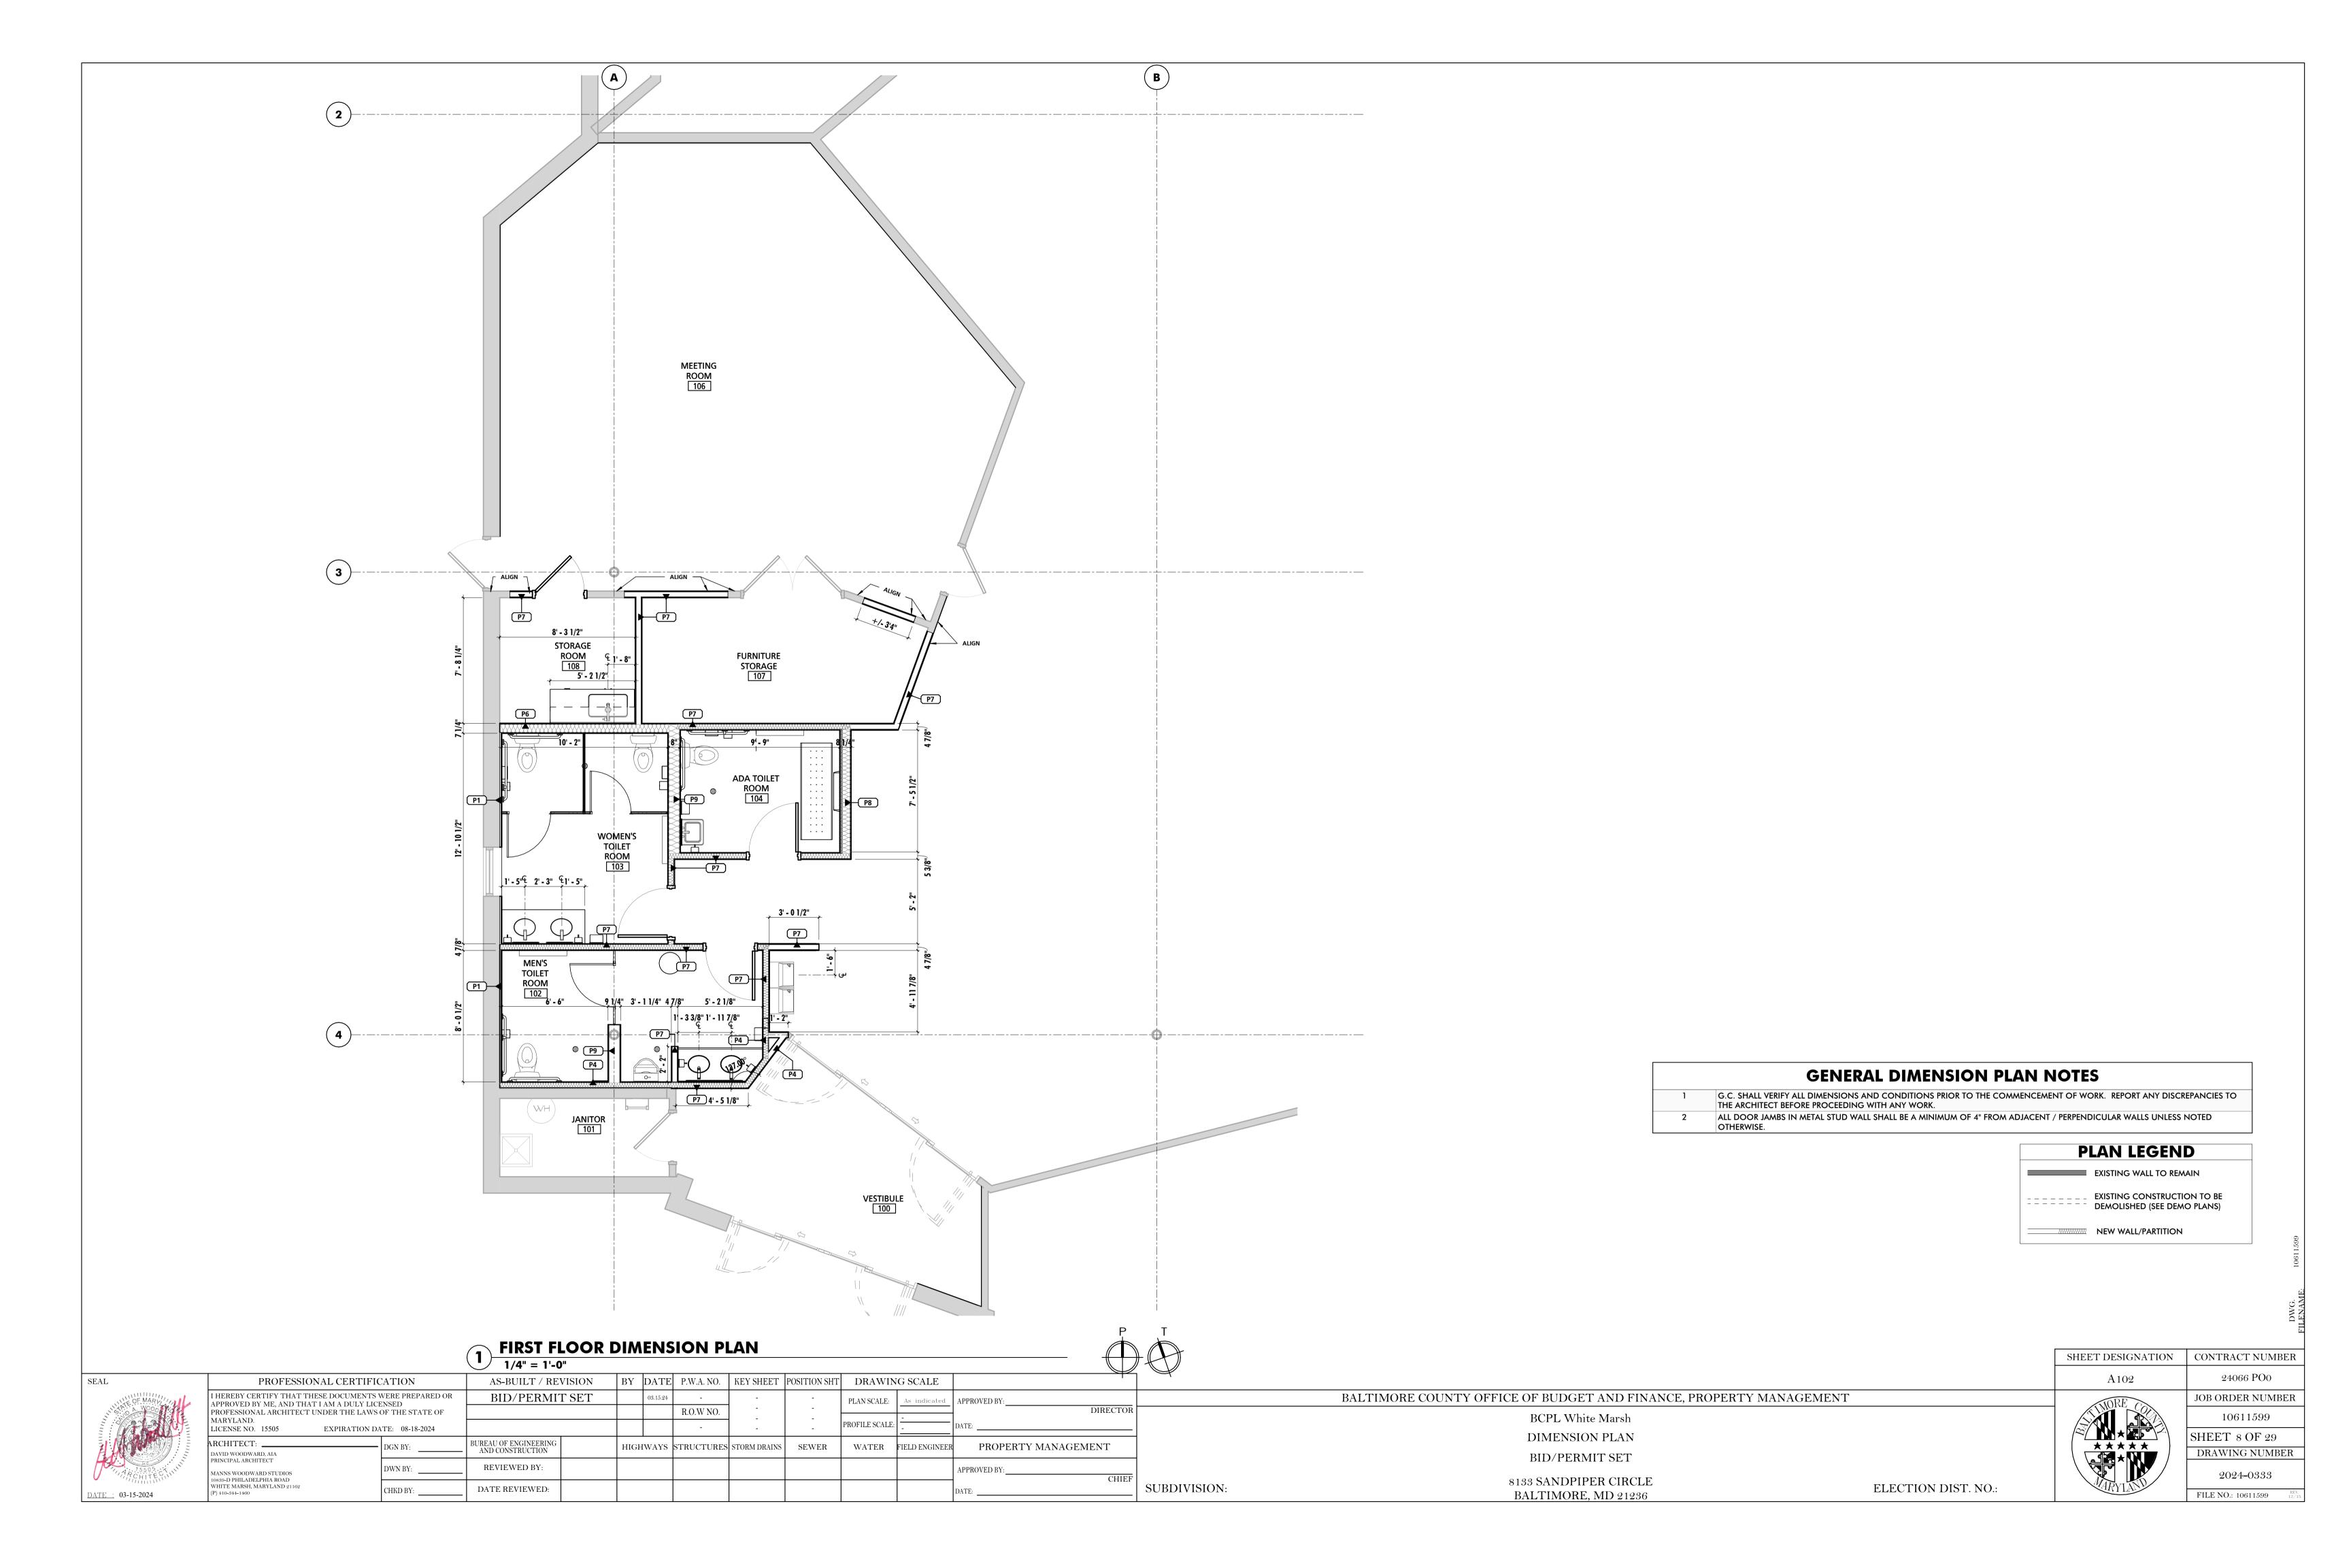



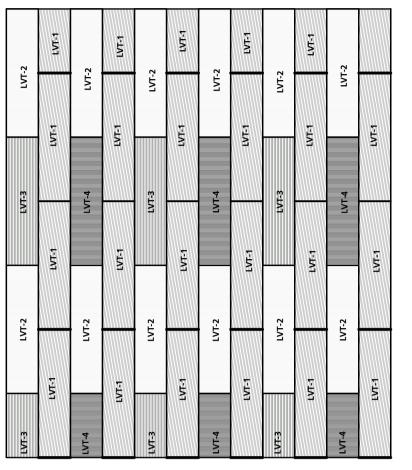

2 ENLARGED LVT PATTERN
1/2" = 1'-0"

WOC-1: MIDNIGHT LVT-3 : NEMO POINT LVT-1: BARKLITE LVT-4: NEBULOUS LVT-2 : WHITE NOISE CT-1: LINEN

FINISH LEGEND

3/4" = 1'-0"

	FINISH ROOM SCHEDULE										
ROOM INFORMATION RM # ROOM NAME					WALL F	INISH		CEILING			
		FLOOR FINISH	BASE	NORTH SOUTH		EAST	WEST	FINISH	REMARKS		
100	VESTIBULE	WOC-1	B-1	P-1	P-1	P-1	P-1	ETR			
101	JANITOR	ETR	ETR	ETR	ETR	ETR	ETR	ETR			
102	MEN'S TOILET ROOM	CT-1	CT-2/CT-3	CT-2/CT-3	CT-2/CT-3	CT-2/CT-3	CT-2/CT-3	CLG-1			
103	WOMEN'S TOILET ROOM	CT-1	CT-2/CT-3	CT-2/CT-3	CT-2/CT-3	CT-2/CT-3	CT-2/CT-3	CLG-1			
104	ADA TOILET ROOM	CT-1	CT-2/CT-3	CT-2/CT-3	CT-2/CT-3	CT-2/CT-3	CT-2/CT-3	CLG-1			
105	LOBBY	LVT-1,2,3,4	B-2	P-1	P-1	P-1	P-1	CLG-1	SEE FINISH PLAN FOR PATTERN		
106	MEETING ROOM	LVT-1,2,3,4	B-2	P-3	P-1	P-1	P-1	CLG-1 & CLG-2	SEE FINISH PLAN FOR PATTERN		
107	FURNITURE STORAGE	LVT-2	B-2	P-1	P-1	P-1	P-1	CLG-1			
108	STORAGE ROOM	LVT-2	B-2	P-1	P-1	P-1	P-1	CLG-1			

INTERIOR FINISH LEGEND							
FINISH MARK	DESCRIPTION	BOD MANUFACTURER	BOD MODEL/PRODUCT LINE	BOD COMMENTS			
B-1	4" RUBBER BASE	JOHNSONITE/TARKETT	TG4 - BLACK MAGIC B				
3-2	4" RUBBER BASE	JOHNSONITE/TARKETT	TO MATCH EXISTING BASE				
CT-1	12" x 24" CERAMIC TILE	CONESTOGA TILE	PAMARVA - BELGIAN LINEN - FOG MATTE				
CT-2	4" x 16" CERAMIC TILE	ARCHITESSA	HUES LIGHT GREY GLOSSY				
CT-3	4" x 16" CERAMIC TILE	ARCHITESSA	HUES OCEAN GLOSSY TILE				
F-1	TRANSLUCENT FROSTED POLYESTER FILM	SOLYX - GLASS FINISHES	SXWF-WM WHITE MATTE				
VT-1	LUXURY VINYL TILE FLOORING	ARMSTRONG FLOORING	EXCHANGE - ST960 STATIC - BAKELITE	ASHLAR PATTERN			
VT-2	LUXURY VINYL TILE FLOORING	ARMSTRONG FLOORING	EXCHANGE - ST900 STATIC - WHITE NOISE	ASHLAR PATTERN			
VT-3	LUXURY VINYL TILE FLOORING	ARMSTRONG FLOORING	EXCHANGE - ST973 SYSTEM GRADIENT - NEMO POINT	ASHLAR PATTERN			
VT-4	LUXURY VINYL TILE FLOORING	ARMSTRONG FLOORING	EXCHANGE - ST972 SYSTEM GRADIENT - NEBULOUS	ASHLAR PATTERN			
-1	FIELD PAINT	SHERWIN WILLIAMS	SW 7517 - RIVERS EDGE				
-2	TRIM PAINT	SHERWIN WILLIAMS	SW 6258 - TRICORN BLACK				
-3	ACCENT PAINT	SHERWIN WILLIAMS	SW 0017 - CALICO				
PL-1	PLASTIC LAMINATE	WILSONART	7966K-12 - 5TH AVE ELM - SOFTGRAIN FINISH				
S-1	SOLID SURFACE COUNTERTOP	CORIAN	ARTISTA CANVAS				
P-1	TOILET PARTITION	SCRANTON PRODUCTS	HINEY HIDERS - CONCRETE				
NOC-1	25CM X 25CM CARPET TILE	INTERFACE	STEP REPEAT - MIDNIGHT	ASHLAR PATTERN			

· ·	
NOTE	CENIEDAL FINUCLI DI ANI NICTES
#	GENERAL FINISH PLAN NOTES
1	ALL MECHANICAL, ELECTRICAL, PLUMBING, AND SPRINKLER WORK TO OCCUR IN AREAS WHERE THE STRUCTURE IS EXPOSED SHALL BE EXECUTED IN A COORDINATED, NEAT AND WORKMANLIKE MANNER. AT A MINIMUM ALL WIRING SHALL BE RUN THOUGH CONDUITS, PIPE AND DUCT INSULATION SHALL BE NEATLY INSTALLED AND PAINTABLE ALL PENETRATIONS SHALL EITHER BE NEATLY COPED OR UTILIZE PAINTABLE ESCUTCHEONS/COPVER PLATES. ALL PIPES AND DUCTS SHALL BE RUN EITHER PERPENDICULAR OR PARALLEL TO WALL CONSTRUCTION AND SHALL BE INSTALLED AT THE SAME NOMINAL ELEVATION OR SLOPE. ALL MATERIALS AND INSTALLATION METHODS SHALL COMPLY WITH APPLICALBE CODES AND STANDARDS. WHERE MEHCANICAL ELECTRICAL, AND PLUMBING DRAWINGS INDICATE OTHER REQUIREMENTS, THE GREATER QUALITY SHALL PREVAIL
2	REFER TO A700 SERIES FOR ADDITIONAL FINISH REQUIREMENTS.
3	REFER TO FLOORING TRANSITION DETAILS FOR THRESHOLDS & TRANSITION STRIPS (T#) DETAILS.
4	DO NOT MAKE INDELIBLE MARKS ON PORTIONS OF SLAB THAT WILL BE VISIBLE INCLUDING, BUT NOT LIMITED TO PERMANENT MARKER, PAINT, ETCHED LINES OR PINS. REMOVE ALL STAINS, MARKINGS, DISCOLORATIONS, AND VISIBLE SOILS FROM CONCRETE BEFORE APPLYING SEALER.
5	REFER TO A800 SERIES REFLECTED CEILING PLAN FOR CEILING TYPES/FINISHES.
6	PROVIDE LVT FLOORING DIAGRAM
7	IN AREA OF WORK, PAINT EXPOSED COLUMNS P-2
8	MOISTURE RESISTANT GYPSUM WALL BOARD SHALL BE UTILIZED IN ALL AREAS WHERE GYPSUM WALL BOARD IS TO BE DIRECTLY ADHERED TO CONCRETE OR MASONRY SURFACES IN INTERIOR APPLICATIONS. SUBSTRATE SHALL BE CLEANED AS REQUIRED AND FREE OF DUST, DEBRIS, AND MOISTURE PRIOR TO ADHESION AND FINISHING.

BALTIMORE COUNTY OFFICE OF BUDGET AND FINANCE, PROPERTY MANAGEMENT

A103

SHEET DESIGNATION | CONTRACT NUMBER 24066 PO0 JOB ORDER NUMBER 10611599 SHEET 9 OF 29 DRAWING NUMBER

2024-0334

FILE NO.: 10611599

BID/PERMIT SET 8133 SANDPIPER CIRCLE BALTIMORE, MD 21236

BCPL White Marsh

FINISH PLAN

ELECTION DIST. NO.:


FF-1 FROSTED FILM TO BE INSTALLED ON WOMEN'S TOILET ROOM WINDOW

BUREAU OF ENGINEERING AND CONSTRUCTION HIGHWAYS STRUCTURES STORM DRAINS SEWER WATER FIELD ENGINEER REVIEWED BY: DWN BY: MANNS WOODWARD STUDIOS 10839-D PHILADELPHIA ROAD WHITE MARSH, MARYLAND 21162 (P) 410-344-1460 DATE REVIEWED:)ATE : 03-15-2024

SUBDIVISION:


DIRECTO

PROPERTY MANAGEMENT

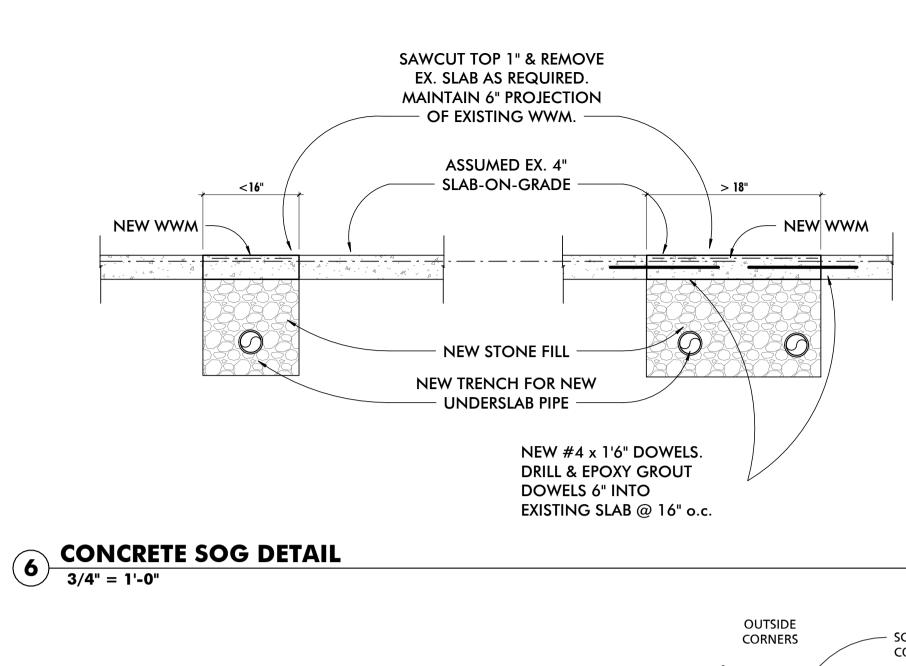

CERAMIC TILE, TYP. -GROUT, TYP. — CONCRETE SLAB, TYP. VAPOR BARRIER, TYP. POROUS FILL, TYP. —


FLOOR DRAIN DETAIL

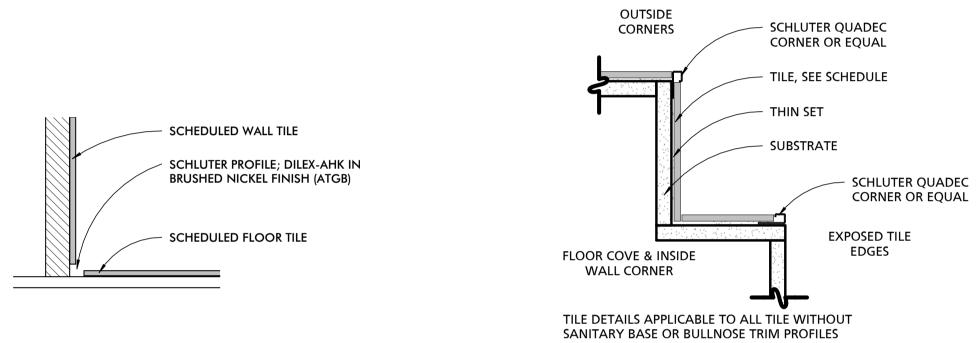

FLOOR AND WALL TILE DETAIL

3" = 1'-0"

TYPICAL TILE EDGE DETAILS

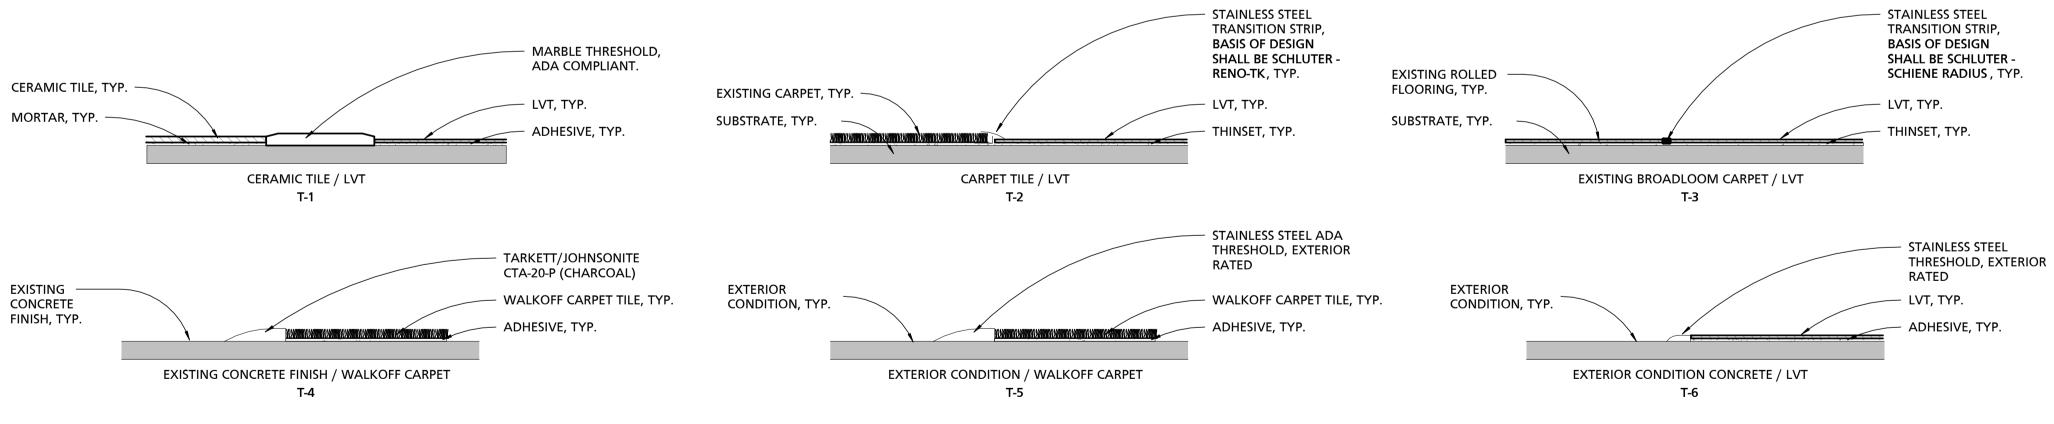

FLOORING TRANSITION DETAILS

3" = 1'-0"

SUBDIVISION:


	SEAL	PROFESSIONAL CERTIFIC	CATION	AS-BUILT / REVISION BY		BY	DATE	P.W.A. NO.	KEY SHEET	POSITION SHT	DRAWIN	G SCALE		
WE OF MARK		I HEREBY CERTIFY THAT THESE DOCUMENTS APPROVED BY ME, AND THAT I AM A DULY LIC		BID/PERMIT	BID/PERMIT SET		03.15.24	-	-	-	PLAN SCALE:	As indicated	APPROVED BY: DIRECTOR DATE:	
			ONAL ARCHITECT UNDER THE LAWS OF THE STATE OF					R.O.W NO.	-	-		-		
			ATE: 08-18-2024	E: 08-18-2024				-	_ PI		PROFILE SCALE:			
		ARCHITECT:	DGN BY:	BUREAU OF ENGINEERING AND CONSTRUCTION		HIGH	HWAYS	STRUCTURES	STORM DRAINS	SEWER	WATER	FIELD ENGINEER	PROPERTY MANAGEME	NT
	15505 CK	PRINCIPAL ARCHITECT MANNS WOODWARD STUDIOS	DWN BY:	REVIEWED BY:									APPROVED BY:	CHIEI
	DATE : 03-15-2024	10839-D PHILADELPHIA ROAD WHITE MARSH, MARYLAND 21162 (P) 410-344-1460	CHKD BY:	DATE REVIEWED:									DATE:	

BALTIMORE COUNTY OFFICE OF BUDGET AND FINANCE, PROPERTY MANAGEMENT BCPL White Marsh FINISH DETAILS BID/PERMIT SET 8133 SANDPIPER CIRCLE ELECTION DIST. NO.: BALTIMORE, MD 21236

SHEET DESIGNATION | CONTRACT NUMBER A104

24066 PO0 JOB ORDER NUMBER 10611599 SHEET 10 OF 29 DRAWING NUMBER

2024-0335 FILE NO.: 10611599

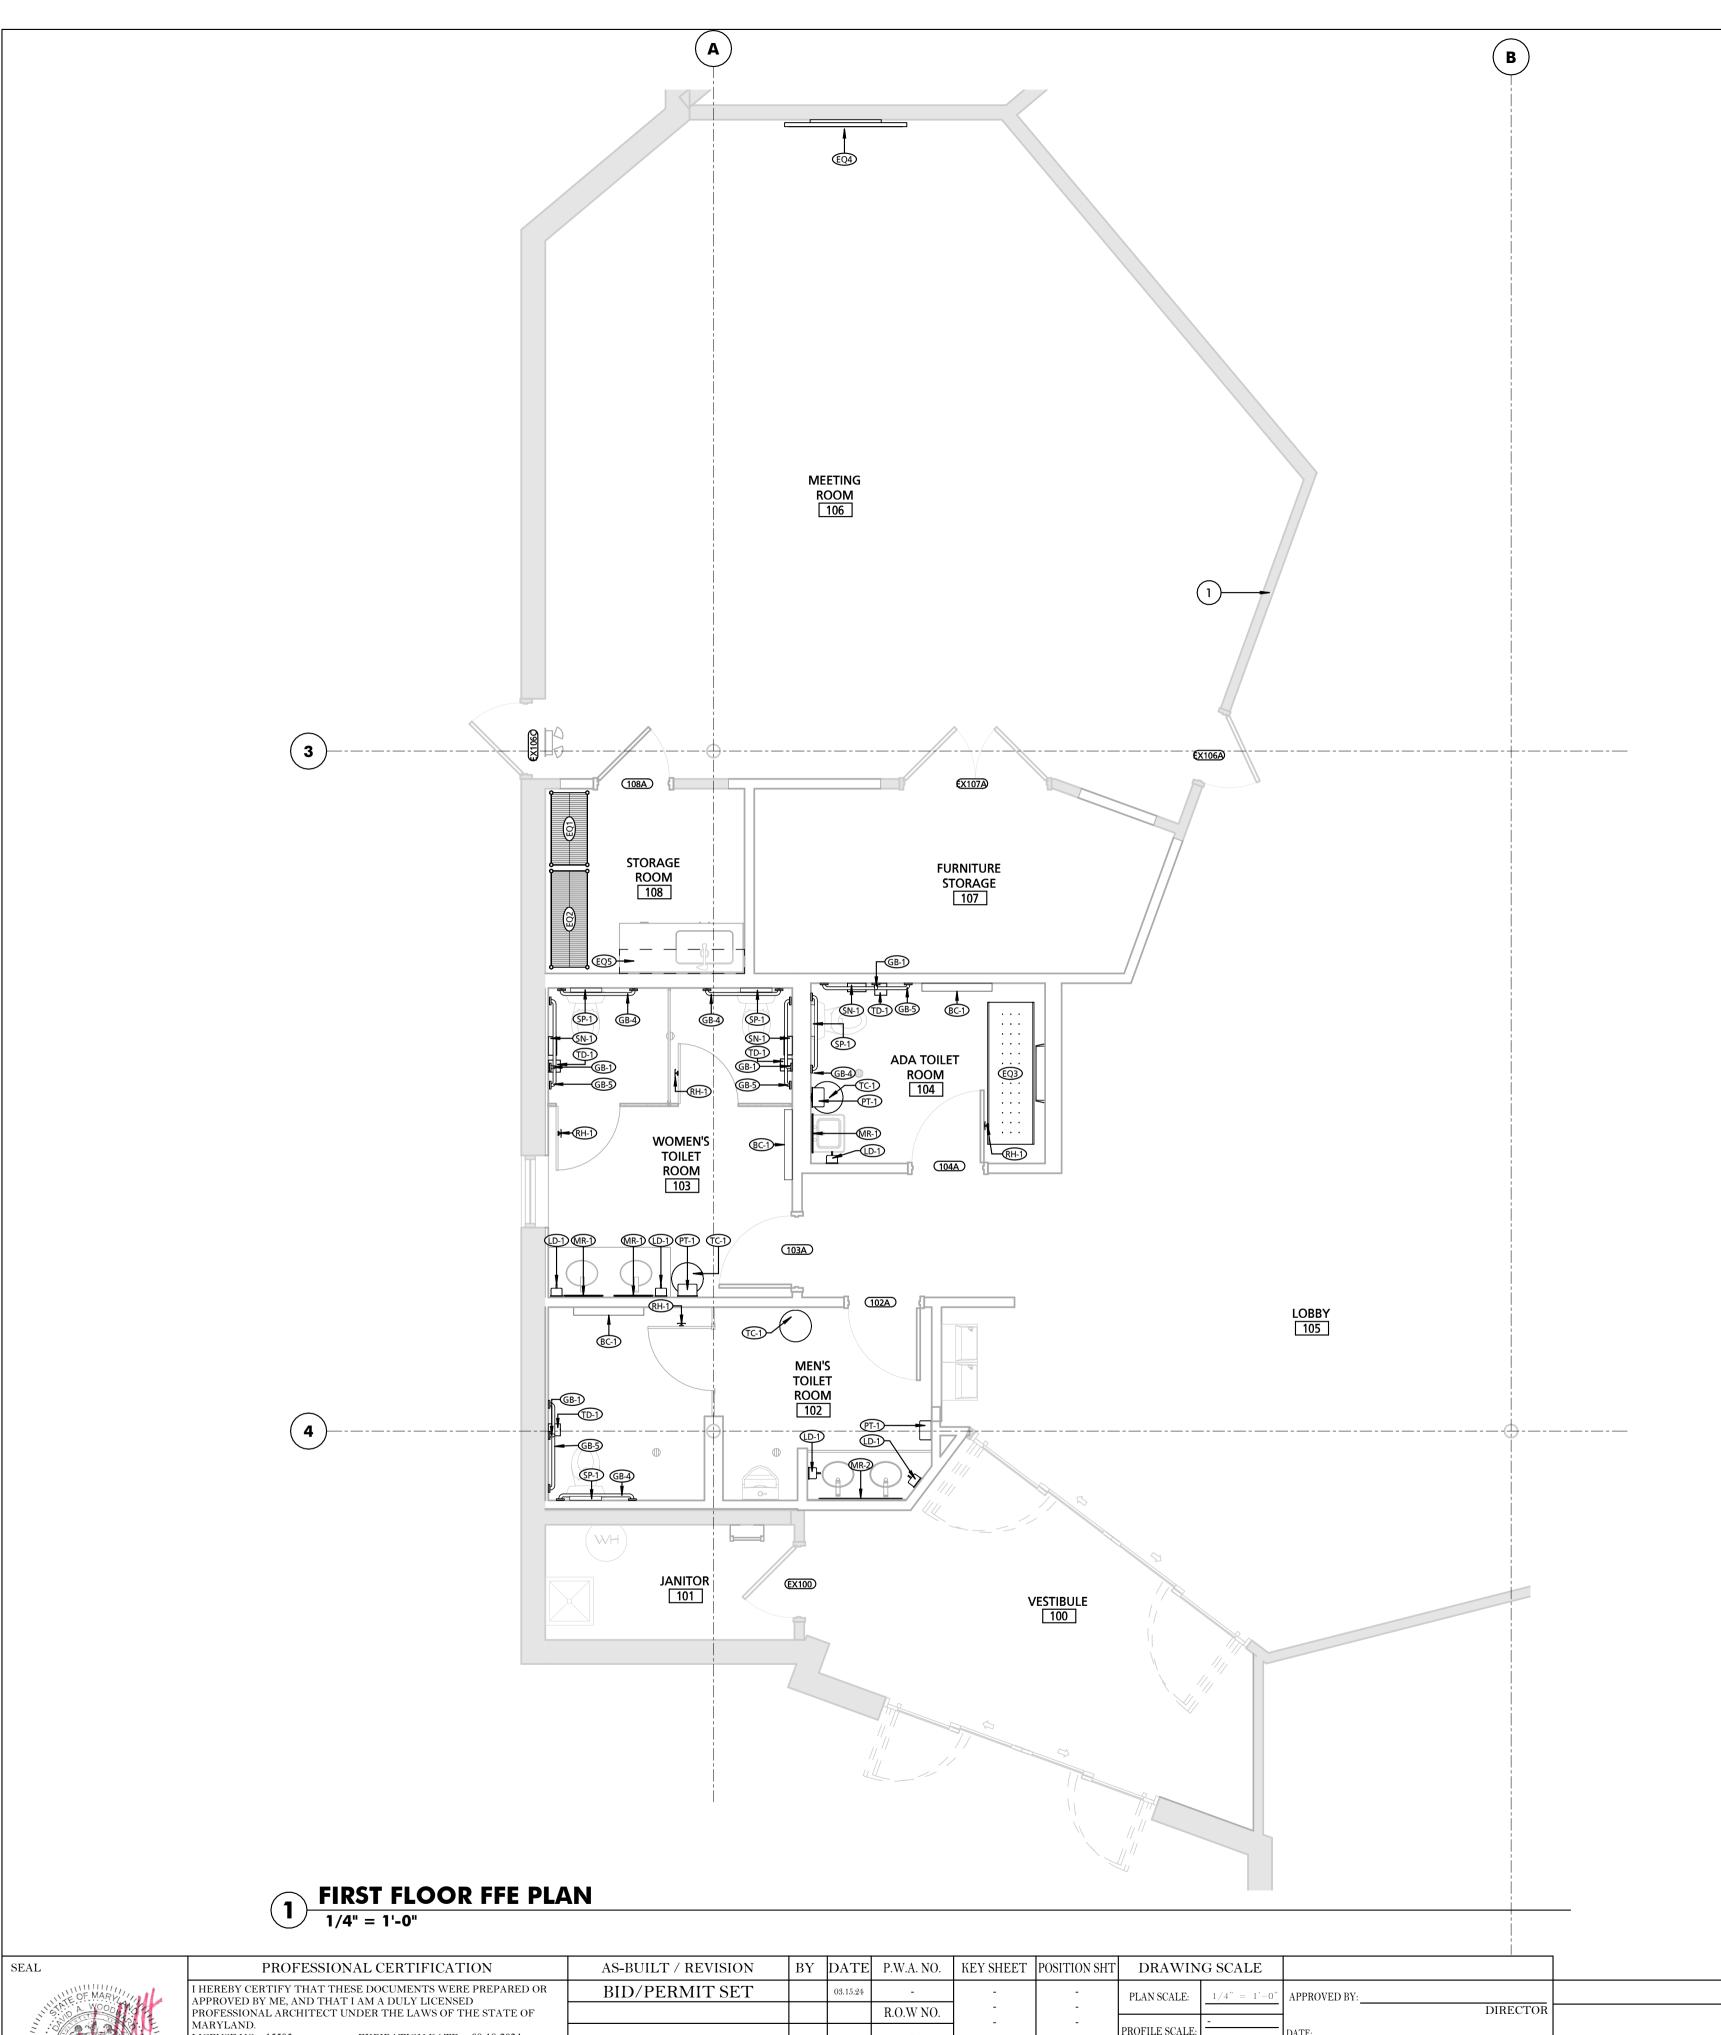

CEILING KEYNOTES REINSTALL SALVAGED PASSPORT PHOTO SCREEN AND ACCESSORIES. COORDINATE WITH BCPL.

	SCHEDULE - EQUIPMENT										
MARK	DESCRIPTION	BOD MANUFACTURER	BOD MODEL	OWNER FURNISH AND INSTALL	OWNER FURNISH CONTRACTOR INSTALL	CONTRACTOR FURNISH AND INSTALL	COMMENTS				
EQ1	WIRE SHELVING		36X18			•					
EQ2	WIRE SHELVING		48X18			•					
EQ3	ADJUSTABLE HEIGHT ADULT CHANGING STATION	BOBRICK - KOALA KARE	KB3000-AHL			•	WALL MOUNTED, PROVIDE FULL HEIGHT IN-WALL BLOCKING AND SECURE PER MANUFACTURER'S RECOMMENDATIONS.				
EQ4	TV MONITOR	N/A	N/A		•		WALL MOUNTED, PROVIDE IN-WALL BLOCKING BEHIND GYP BD AT MOUNTING LOCATION				
EQ5	OPEN WIRE FIXED SHELVING	CLOSETMAID	5640			•					

	SCHEDULE - TOILET ROOM ACCESSORIES											
MARK	DESCRIPTION	BOD MANUFACTURER	BOD MODEL	COMMENTS								
BC-1	RECESSED BABY CHANGING STATION	BOBRICK	KB110-SSWM									
GB-1	18" VERTICAL GRAB BAR W/ CONCEALED MOUNTING	BOBRICK	B-6806-18									
GB-4	36" GRAB BAR W/ CONCEALED MOUNTING	BOBRICK	B-6806-36									
GB-5	42" GRAB BAR W/ CONCEALED MOUNTING	BOBRICK	B-6806-42									
LD-1	VERTICAL WALL MOUNTED SOAP DISPENSER	GOGO	9034									
MR-1	18" x 30" CHANNEL FRAMED MIRROR	BOBRICK	B-165 1830									
MR-2	40" x 30" CHANNEL FRAMED MIRROR	ELEGANT LIGHTING	MR43040S									
PT-1	ESSENTIAL HIGH CAPACITY HARD ROLL TOWEL DISPENSER	SCOTT	46253									
RH-1	DOUBLE ROBE HOOK	AMERICAN SPECIALTIES	7345									
SN-1	SURFACE MOUNTED SANITARY WASTE RECEPTACLE	RUBBERMAID	6140									
SP-1	SEAT COVER DISPENSER	WINCO	TSC10	<varies></varies>								
TC-1	22 GALLON FREE STANDING WASTE RECEPTACLE	RUBBERMAID	55824									
TD-1	TWIN JUMBO ROLL TOILET PAPER DISPENSER	TORK	SC-56TR									

BALTIMORE COUNTY OFFICE OF BUDGET AND FINANCE, PROPERTY MANAGEMENT

BCPL White Marsh FFE PLAN & SCHEDULE

SUBDIVISION:

BID/PERMIT SET

8133 SANDPIPER CIRCLE BALTIMORE, MD 21236


ELECTION DIST. NO.:

SHEET DESIGNATION CONTRACT NUMBER A105


24066 PO0 JOB ORDER NUMBER 10611599 SHEET 11 OF 29

DRAWING NUMBER 2024-0336

FILE NO.: 10611599

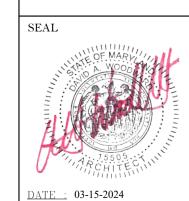

PROFILE SCALE: EXPIRATION DATE: 08-18-2024 PROPERTY MANAGEMENT HIGHWAYS STRUCTURES STORM DRAINS SEWER WATER FIELD ENGINEER REVIEWED BY: DWN BY: MANNS WOODWARD STUDIOS 10839-D PHILADELPHIA ROAD WHITE MARSH, MARYLAND 21162 (P) 410-344-1460 DATE REVIEWED:

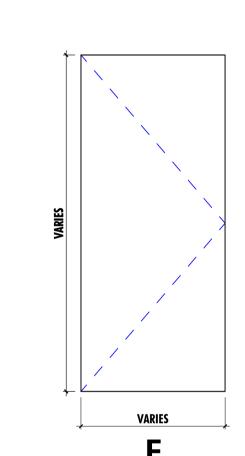

SEE DOOR SCHEDULE FOR ACTUAL PANEL DIMENSIONS. NOT ALL PANEL TYPES MAY BE USED IN THIS PROJECT, SEE DOOR SCHEDULE. DIMENSIONS FOR GLAZING INDICATED SHALL CONSTITUTE THE FULL GLAZING WIDTH.

SEE STOREFRONT ELEVATIONS FOR CURTAIN WALL / STOREFRONT ENTRANCE

DOOR PANEL TYPES

1/2" = 1'-0"

SCHEDULE - DOOR DETAILS DOOR PANEL SIZE SUMMARY **OVERALL** COMMENTS MATCH EXISTING STAINED DOORS 102A 3'-0" x 7'-0" PANEL : F 103A 3'-0" x 7'-0" PANEL : F 1 3/4" SCWD 5 7/8" 4 7/8" H1 MATCH EXISTING STAINED DOORS STAINED HM ST MATCH EXISTING STAINED DOORS 3'-0" x 7'-0" PANEL : F 5 7/8" 4 7/8" 3'-0" x 7'-0" PANEL : F 1 3/4" SCWD P-2 3' - 4" 5 7/8" 4 7/8" 2" 2" P-2 H1 J1 03 EX100 3'-0" x 7'-0" PANEL : F 1 3/4" EXISTING p-2 EXISTING EXISTING EXISTING EX106A 3'-0" x 7'-0" PANEL : F 1 3/4" EXISTING P-2 5 7/8" 4 7/8" 2" 2" P-2 EXISTING EXISTING EXISTING EX106C 3'-0" x 7'-0" PANEL : F 3' - 4" 5 7/8" 4 7/8" 2" 2" P-2 1 3/4" EXISTING P-2 7' - 2" EXISTING EXISTING EXISTING EX107A (2) 3'-0" x 7'-0" PANEL : F 1 3/4" EXISTING P-2 HM ST 6' - 4" 5 7/8" 4 7/8" 2" 2" P-2 EXISTING EXISTING EXISTING

Heavy Duty Standard Arm with Hold Open

Privacy Function (ANSI F19) with 2 sided indicator trim

Heavy Duty Standard Arm

Storeroom Function (ANSI F07)

1-1/2" LDW

1-1/2" LDW

1-1/2" LDW

Interior Toilet Room Door - Single Leaf

1 Pull

1 Push Plate

1 Perimeter Seal

2 Kick Plates

1 Wall Stop

Interior Toilet Room Door - Single Leaf

3 Hinge

1 Mortise Lockset

1 Perimeter Seal

2 Kick Plates

1 Wall Stop

1 Hook

Interior Storage Room Door - Single Leaf

3 Hinge

1 Mortise Lockset

2 Kick Plates

1 Wall Stop


1 Perimeter Gasketing

1 Surface Mount Closer

1 Surface Mount Closer

Doors: 102A, 103A

Door: 104A

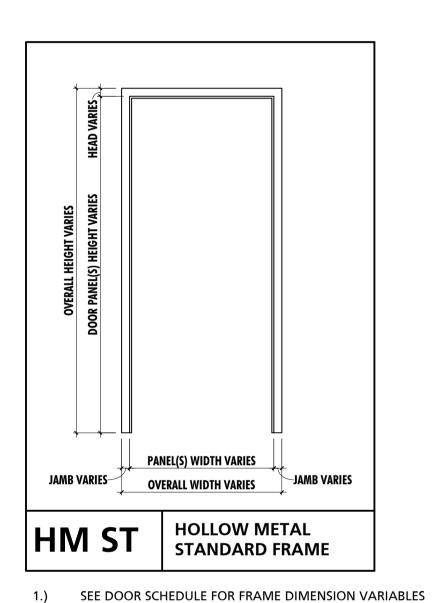


E TVDES			

FRAME TYPES

1/2" = 1'-0"

DOOR HARDWARE

Door: 108A

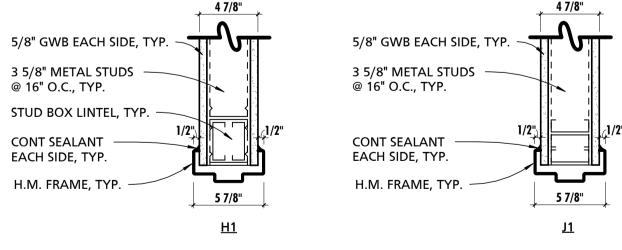

SUBDIVISION:

2	DETAILS MAY VARY AT EACH DOOR. VERIFY EACH CONDITION IN FIELD.
3	SEE PARTITION SCHEDULE AND FLOOR PLAN FOR CONSTRUCTION OF WALLS AND PARTITIONS.
4	NEW FRAMES IN EXISTING OPENINGS SHALL RECEIVE COUNTER SUNK MASONRY EXPANSION JAMB ANCHORS, 1/2" DIAMETER, IN LIEU OF MASONRY WIRE JAMB ANCHORS.
5	ALL DOORS SHALL BE SET WITHIN OPENINGS TO ENSURE ADA APPROACH COMPLIANCE AS INDICATED ON SHEET G002.
6	AT WALLS WITH SOUND ATTENUATION BLANKETS, CONTRACTOR SHALL SEAL DOOR FRAMES, GLAZED OPENING FRAMES, INTERSECTIONS, AND OTHER PENETRATIONS WITH ACOUSTICAL SEALANT.
	2 3 4 5 6

NOTE

SEAL	PROFESSIONAL CERTIFIC	CATION	AS-BUILT / RE	AS-BUILT / REVISION BY		DATE	P.W.A. NO.	KEY SHEET	POSITION SHT	DRAWIN	IG SCALE									
OF MARY IN	I HEREBY CERTIFY THAT THESE DOCUMENTS WERE PREPARED OR APPROVED BY ME, AND THAT I AM A DULY LICENSED		BID/PERMI	BID/PERMIT SET		BID/PERMIT SET		ERMIT SET		BID/PERMIT SET		03.15.24	-			PLAN SCALE: As indicated		APPROVED BY:		
Noon Wood	PROFESSIONAL ARCHITECT UNDER THE LAWS						R.O.W NO.	-	-		-	DIRECTOR								
		ATE: 08-18-2024					-	-	-	PROFILE SCALE:	-	DATE:								
	ARCHITECT:	DGN BY:	BUREAU OF ENGINEERING AND CONSTRUCTION		HIGH	WAYS	STRUCTURES	STORM DRAINS	SEWER	WATER	FIELD ENGINEER	PROPER	TY MANAGEM	(ENT						
A 15505 CKINING	PRINCIPAL ARCHITECT MANNS WOODWARD STUDIOS 10839-D PHILADELPHIA ROAD	DWN BY:	REVIEWED BY:									APPROVED BY:		СНІЕН						
DATE : 03-15-2024	10839-D PHILADELPHIA ROAD WHITE MARSH, MARYLAND 21162 (P) 410-344-1460	CHKD BY:	DATE REVIEWED:									DATE:		CITE						

BALTIMORE COUNTY OFFICE OF BUDGET AND FINANCE, PROPERTY MANAGEMENT
BCPL White Marsh

BCPL White Marsh DOOR SCHEDULE & DETAILS BID/PERMIT SET

PAITIMODE MD 01006	8133 SANDPIPER CIRCLE	
DALTIMORE, MD 21230	BALTIMORE, MD 21236	

ELECTION DIST. NO.:

GENERAL DOOR NOTES

CONTRACTOR SHALL FIELD VERIFY ALL EXISTING OPENINGS/MODIFIED OPENINGS PRIOR TO FABRICATION OF DOORS AND FRAMES.

NOTE


SHEET DESIGNATION
A600
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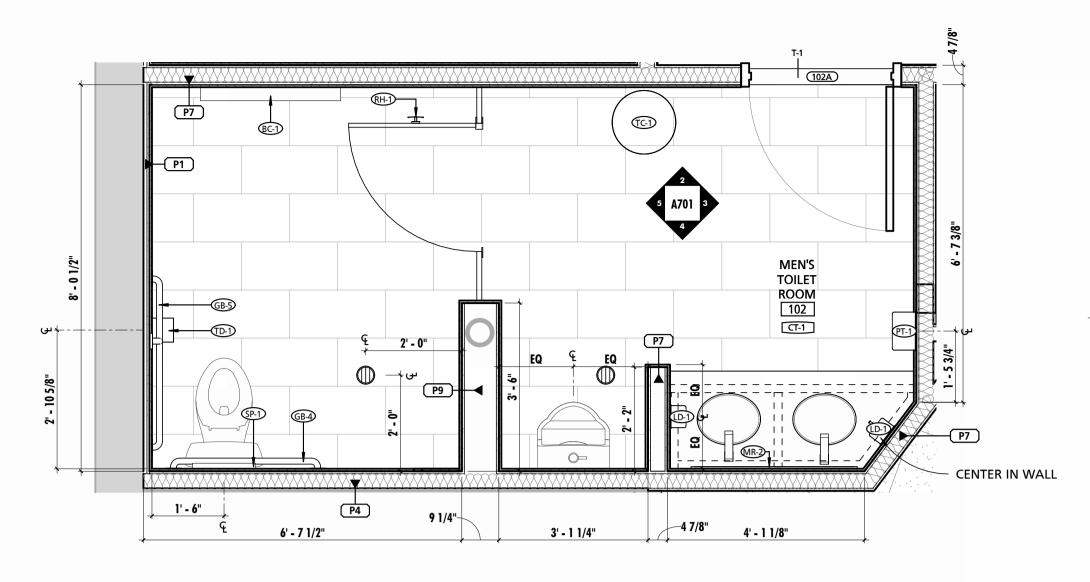
CONTRACT NUMBER
24066 PO0
JOB ORDER NUMBER
10611599
SHEET 12 OF 29
DRAWING NUMBER


2024-0337


FILE NO.: 10611599

ZED OPENING FRAMES, INTERSECTIONS, AND OTHER JMBER



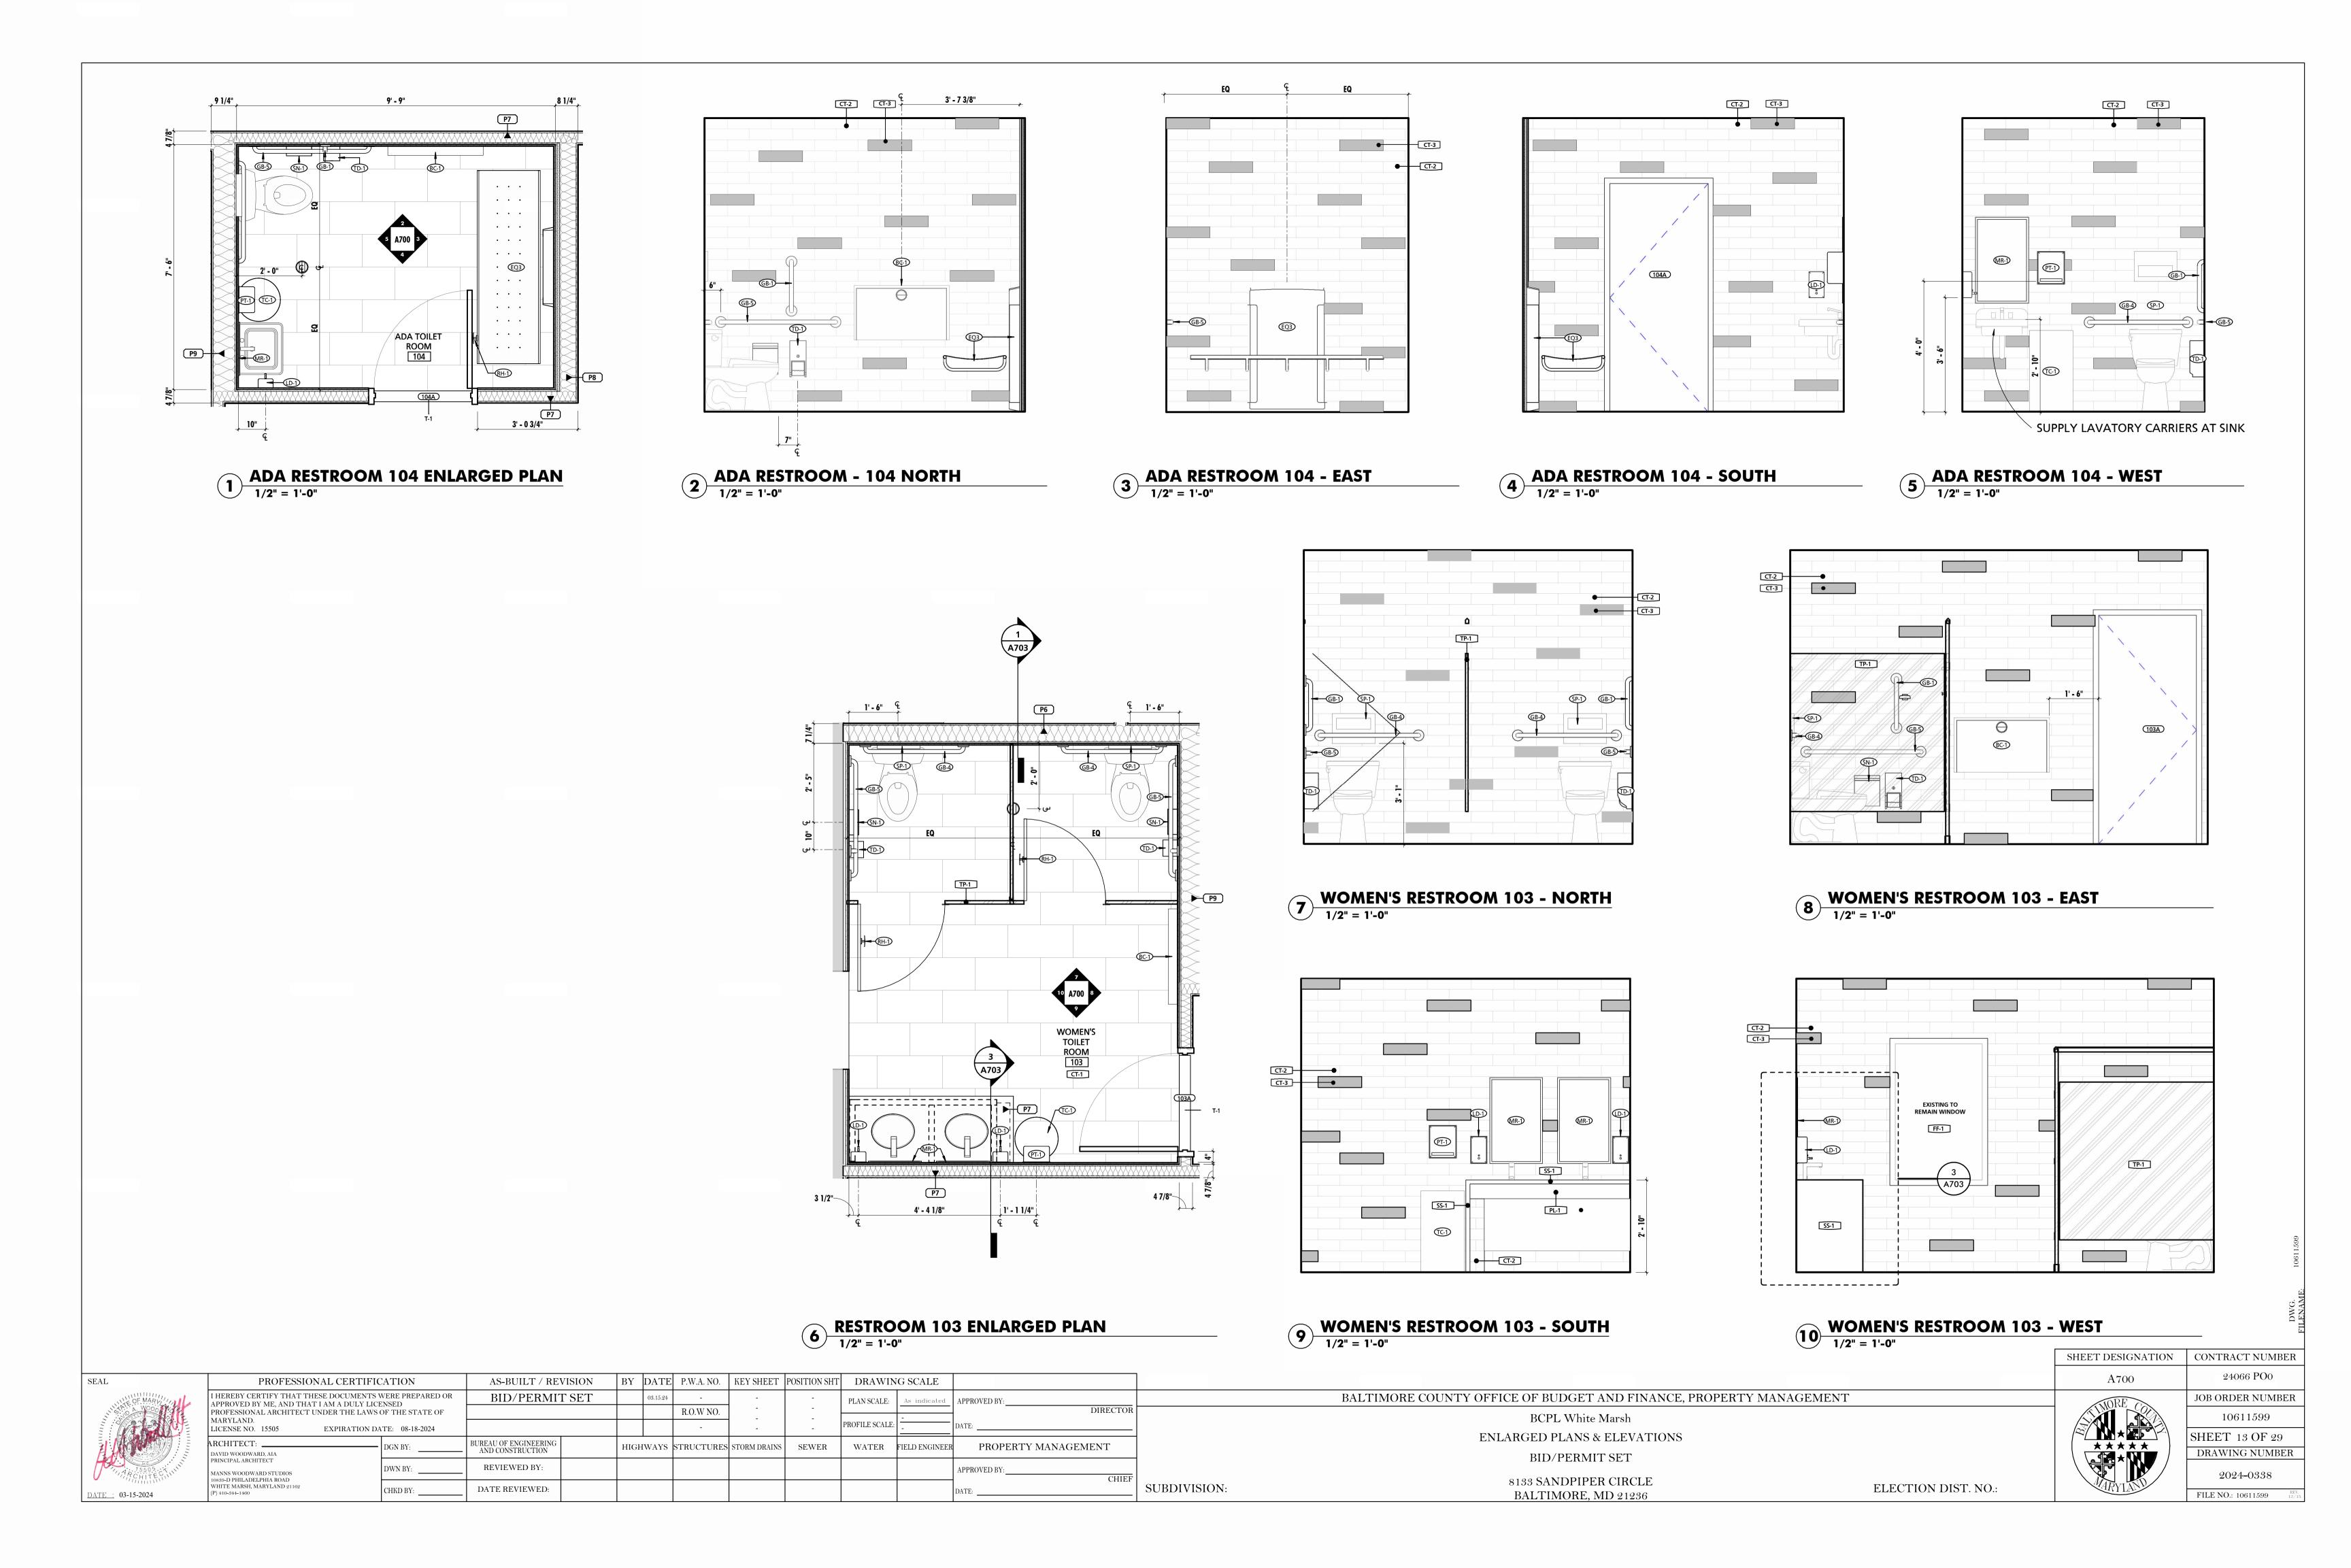

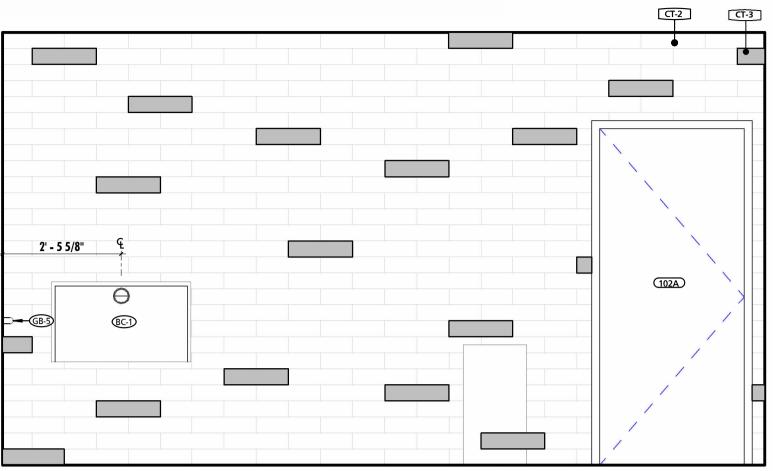


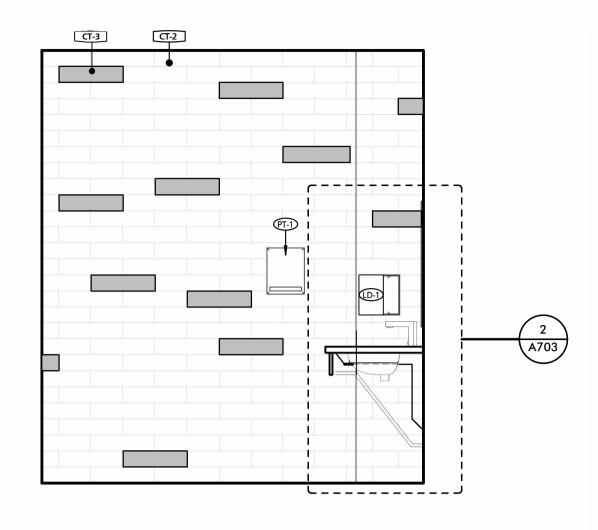

1 RESTROOM 102 ENLARGED PLAN
1/2" = 1'-0"


2 RESTROOM 102 - NORTH
1/2" = 1'-0"

3 RESTROOM 102 - EAST

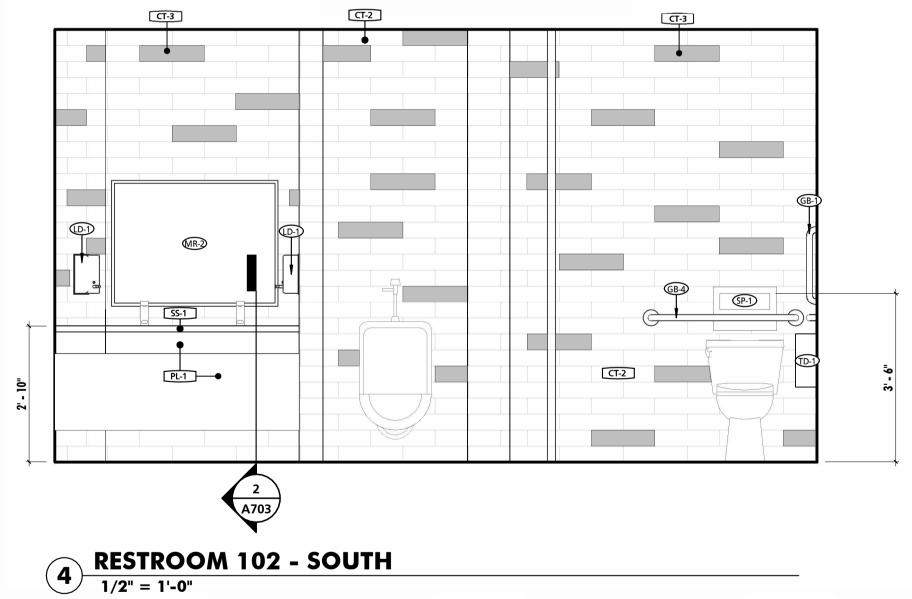

SUBDIVISION:

RESTROOM 102 - WEST1/2" = 1'-0"

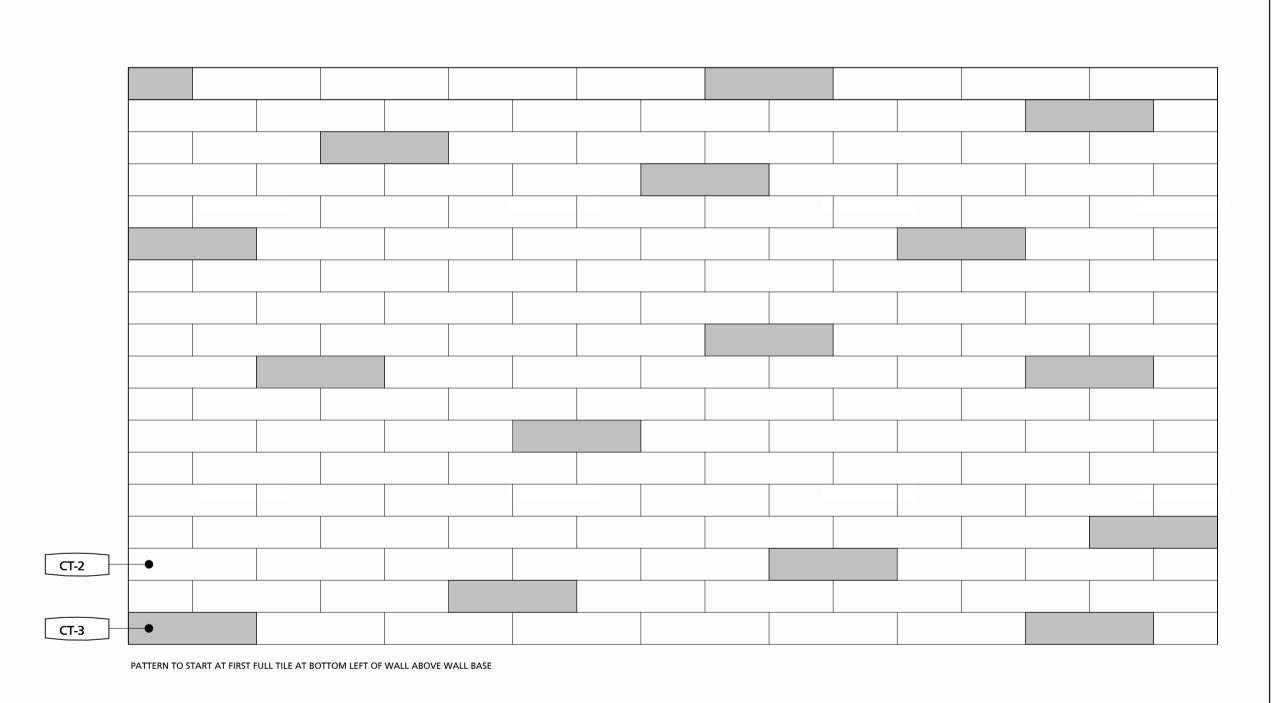

6 FIELD WALL TILE PATTERN
1" = 1'-0"

SEAL	PROFESSIONAL CERTIFIC	CATION	N AS-BUILT / REVISION		Y DATE	P.W.A. NO.	KEY SHEET	POSITION SHT	DRAWIN	IG SCALE			
OF MARY	I HEREBY CERTIFY THAT THESE DOCUMENTS WERE PREPARED OR APPROVED BY ME, AND THAT I AM A DULY LICENSED		BID/PERMIT SET		03.15.24	-	-	-	PLAN SCALE:	As indicated	APPROVED BY:		
= .8/6 A B . LE	PROFESSIONAL ARCHITECT UNDER THE LAWS MARYLAND. LICENSE NO. 15505 EXPIRATION DA	OF THE STATE OF				R.O.W NO.	- - -	-	PROFILE SCALE:	-	DATE:		DIRECTO
	ARCHITECT:	DGN BY:	BUREAU OF ENGINEERING AND CONSTRUCTION	НІ	GHWAYS	STRUCTURES	S STORM DRAINS	SEWER	WATER	FIELD ENGINEER	PROPEI	RTY MANAGEMI	ENT
15505	PRINCIPAL ARCHITECT MANNS WOODWARD STUDIOS 10839-D PHILADELPHIA ROAD	DWN BY:	REVIEWED BY:								APPROVED BY:		СНІЕІ
DATE : 03-15-2024	10859-D FIILADELFIIA ROAD WHITE MARSH, MARYLAND 21162 (P) 410-344-1460	CHKD BY:	DATE REVIEWED:								DATE:		

BALTIMORE COUNTY OFFICE OF BUDGET AND FINANCE, PROPERTY MANAGEMENT BCPL White Marsh ENLARGED PLANS & ELEVATIONS BID/PERMIT SET 8133 SANDPIPER CIRCLE


BALTIMORE, MD 21236

A701


SHEET DESIGNATION | CONTRACT NUMBER 24066 PO0 JOB ORDER NUMBER 10611599 SHEET 14 OF 29 DRAWING NUMBER 2024-0339


ELECTION DIST. NO.:

FILE NO.: 10611599

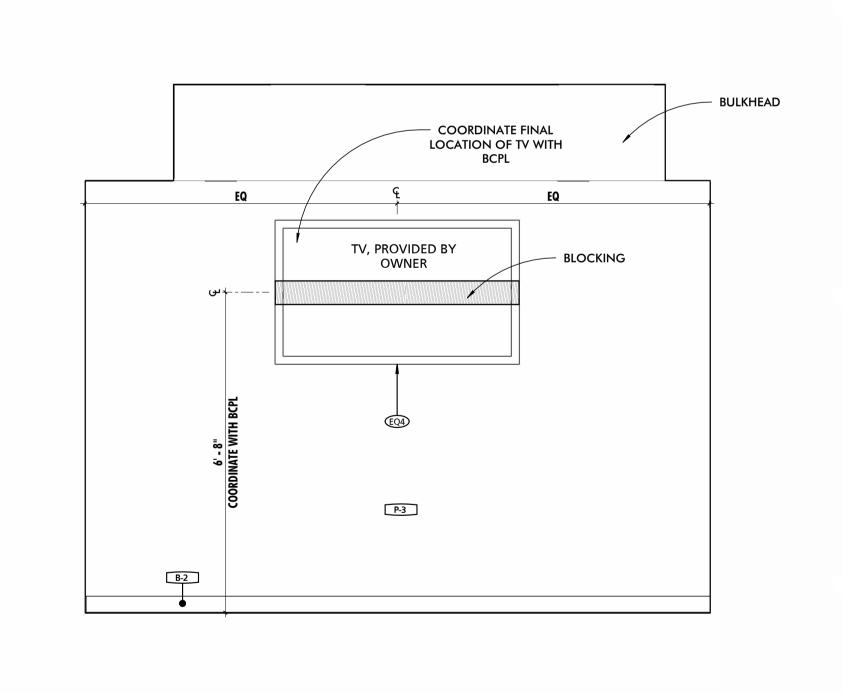

SUBDIVISION:

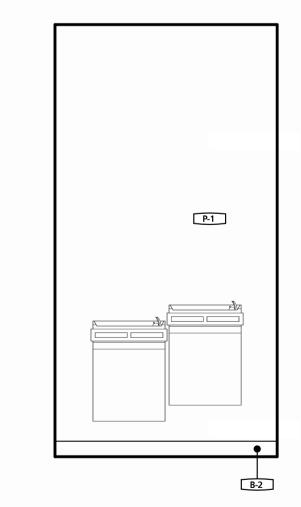

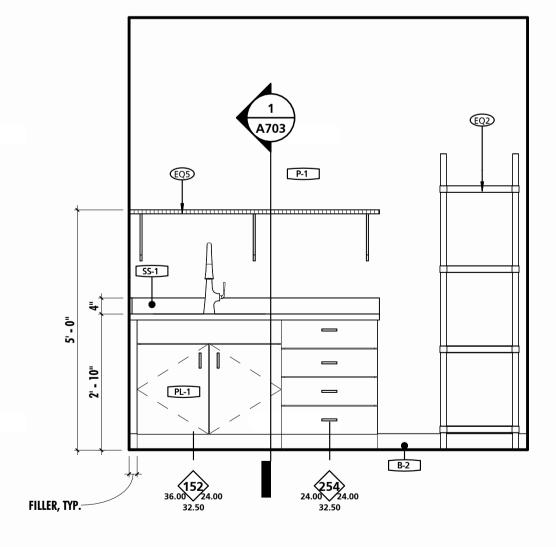

MEETING ROOM - NORTH

2 LOBBY DRINKING FOUNTAIN - WEST

1/2" = 1'-0"

3 STORAGE 105 - SOUTH

SEAL
OF MARY WOOD WOOD T5505.CO

DATE : 03-15-2024

	PROFESSIONAL CERTIFIC	LATION	AS-BUILT / REV	HSION	BY	DATE	P.W.A. NO.	KEY SHEET	POSITION SHT	DRAWIN	CSCALE	
	PROFESSIONAL CERTIFIC	ATION	AS-BUILT / REV	/1510N	ы	DATE	P. W.A. NO.	NET SHEET	POSITION SHI	DKAWIN	GSCALE	
	I HEREBY CERTIFY THAT THESE DOCUMENTS V APPROVED BY ME, AND THAT I AM A DULY LICE		BID/PERMIT SET			03.15.24	-	-	-	PLAN SCALE:	1/2" = 1'-0"	APPROVED BY:
	PROFESSIONAL ARCHITECT UNDER THE LAWS OF THE STATE OF MARYLAND. LICENSE NO. 15505 EXPIRATION DATE: 08-18-2024						R.O.W NO.	-	-			DIRECTOR
							-	- -	-	PROFILE SCALE:	-	DATE:
	ARCHITECT:	DGN BY:	BUREAU OF ENGINEERING AND CONSTRUCTION		HIGH	WAYS	STRUCTURES	STORM DRAINS	SEWER	WATER	FIELD ENGINEER	PROPERTY MANAGEMENT
PRINCIPAL ARCHITECT MANNS WOODWARD STUDIOS 10839-D PHILADELPHIA ROAD	MANNS WOODWARD STUDIOS	DWN BY:	REVIEWED BY:									APPROVED BY:CHIEF
	WHITE MARSH MARVI AND 01160	CHKD BY:	DATE REVIEWED:									DATE:


BALTIMORE COUNTY OFFICE OF BUDGET AND FINANCE, PROPERTY MANAGEMENT BCPL White Marsh ENLARGED PLANS & ELEVATIONS BID/PERMIT SET 8133 SANDPIPER CIRCLE **ELECTION DIST. NO.:**


BALTIMORE, MD 21236


A702

SHEET DESIGNATION | CONTRACT NUMBER 24066 PO0 JOB ORDER NUMBER 10611599 SHEET 15 OF 29 DRAWING NUMBER

> 2024-0340 FILE NO.: 10611599

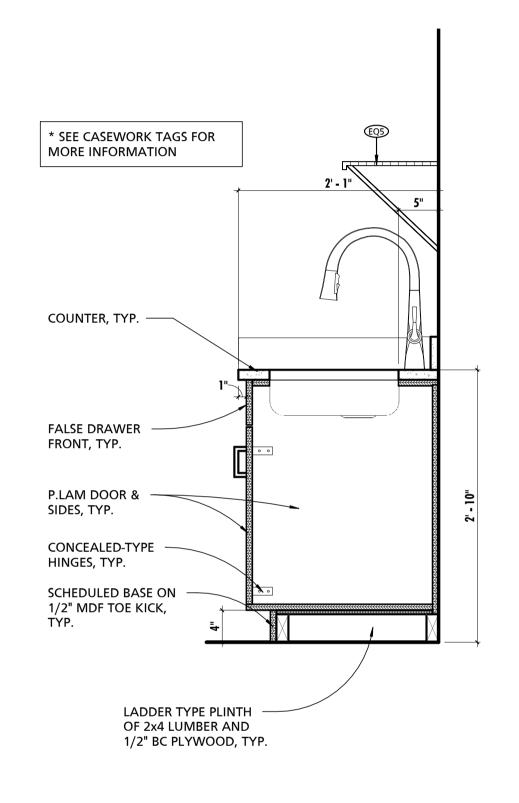

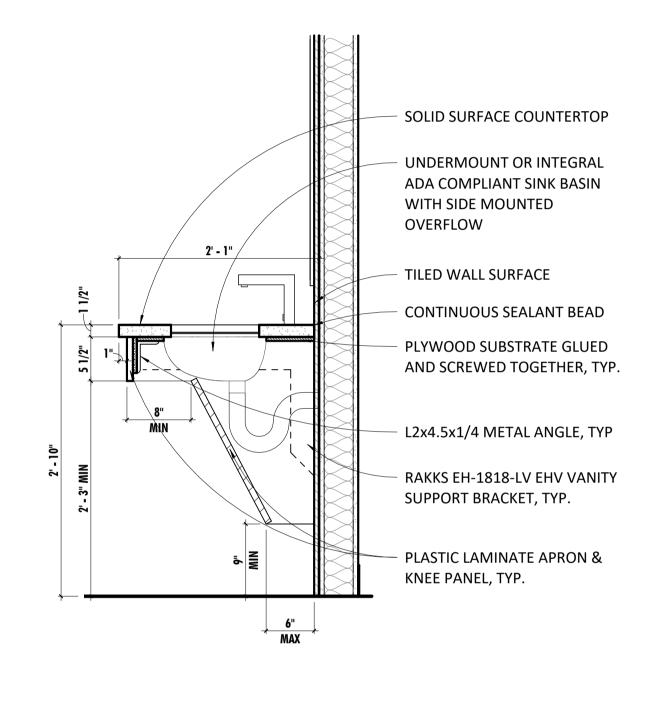

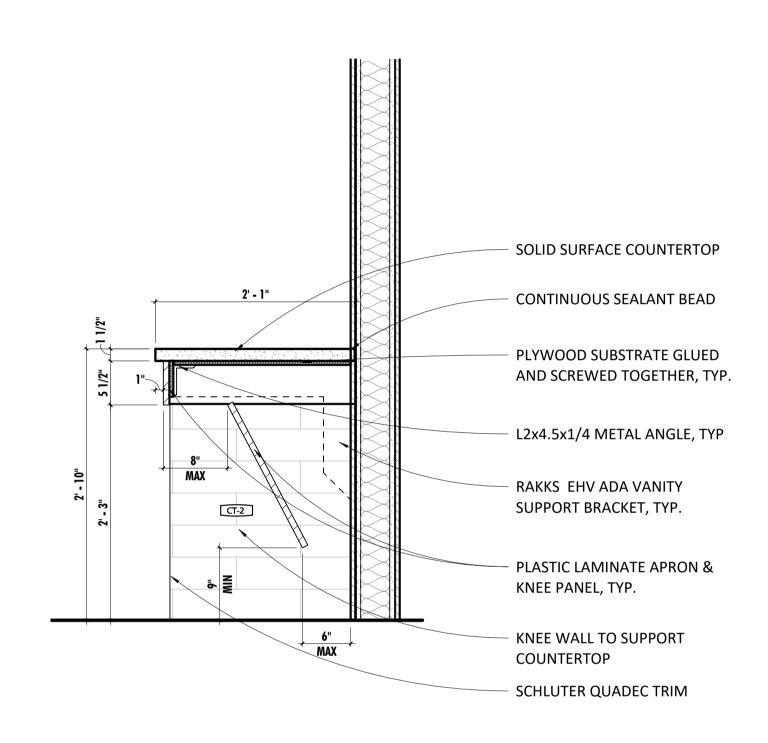

CONTRACTOR RESPONSIBLE FOR ENSURING ALL FABRICATED CASEWORK CONFORMS WITH ADA REQUIREMENTS. SEE ADA CODE SHEET FOR ADDITIONAL INFORMATION RELATED TO CLEARANCE REQUIREMENTS.

SEE INTERIOR ELEVATIONS FOR WALL FINISHES AND BACK SPLASH REQUIREMENTS

ALL COUNTERS SHALL BE SEAMLESS UNLESS NOTED OTHERWISE.

CONTRACTOR TO SUPPLY LAVATORY CARRIER SUPPORTS AT ALL SINK LOCATIONS

1 SINK CABINET DETAIL
1" = 1'-0"

2 TYPICAL LAVATORY DETAIL

1" = 1'-0"

SUBDIVISION:

WOMEN'S ROOM COUNTERTOP DETAIL

	GENERAL CASEWORK NOTES
NOTE #	NOTE
1	CONTRACTOR SHALL BE RESPONSIBLE FOR FINAL COORDINATION OF CASEWORK AND COUNTERTOP OPENING AND CLEARANCE REQUIREMENTS TO ENSURE ANY APPLIANCE, FIXTURES, AND/OR EQUIPMENT (CONTRACTOR AND OWNER SUPPLIED) ARE INSTALLED IN ACCORDANCE WITH THE RESPECTIVE MANUFACTURER REQUIREMENTS.
2	CONTRACTOR SHALL REFER TO ARCHITECTURAL WOODWORK STANDARDS 2014, CABINET DESIGN SERIES (CDS) FOR FURTHER INFORMATION ABOUT CASEWORK

SEAL	
11111	EOF MARY

DATE : 03-15-2024

PROFESSIONAL CERTIFICATION		AS-BUILT / REVISION	BY	DATE	P.W.A. NO.	KEY SHEET	POSITION SHT	DRAWIN	G SCALE			
- 1	I HEREBY CERTIFY THAT THESE DOCUMENTS WERE PREPARED OR APPROVED BY ME, AND THAT I AM A DULY LICENSED		BID/PERMIT SET		03.15.24	-	-	-	PLAN SCALE:	1" = 1'-0"	APPROVED BY:	
	PROFESSIONAL ARCHITECT UNDER THE LAWS					R.O.W NO.	-	-			DIREC	
	MARYLAND. LICENSE NO. 15505 EXPIRATION DATE: 08-18-2024					-	-	-	PROFILE SCALE:	-	DATE:	
	ARCHITECT:	DGN BY:	BUREAU OF ENGINEERING AND CONSTRUCTION	HIGH	HWAYS	STRUCTURES	STORM DRAINS	SEWER	WATER	FIELD ENGINEER	PROPERTY MANAGEMENT	
	PRINCIPAL ARCHITECT MANNS WOODWARD STUDIOS 10839-D PHILADELPHIA ROAD	DWN BY:	REVIEWED BY:								APPROVED BY:	
	10839-D FIILADELFIIA ROAD WSHTE MARSH, MARYLAND 21162 (P) 410-344-1460	CHKD BY:	DATE REVIEWED:								DATE:	

BALTIMORE COUNTY OFFICE OF BUDGET AND FINANCE, PROPERTY MANAGEMENT


BCPL White Marsh TYPICAL DETAILS BID/PERMIT SET

8133 SANDPIPER CIRCLE BALTIMORE, MD 21236

HEET DESIGNATION	CONTRACT NUMBER
A703	24066 PO0
NORE C	JOB ORDER NUMBER
* * * * *	10611599
	SHEET 16 OF 29
	DRAWING NUMBER
	2024 2244

2024-0341 FILE NO.: 10611599


ELECTION DIST. NO.:

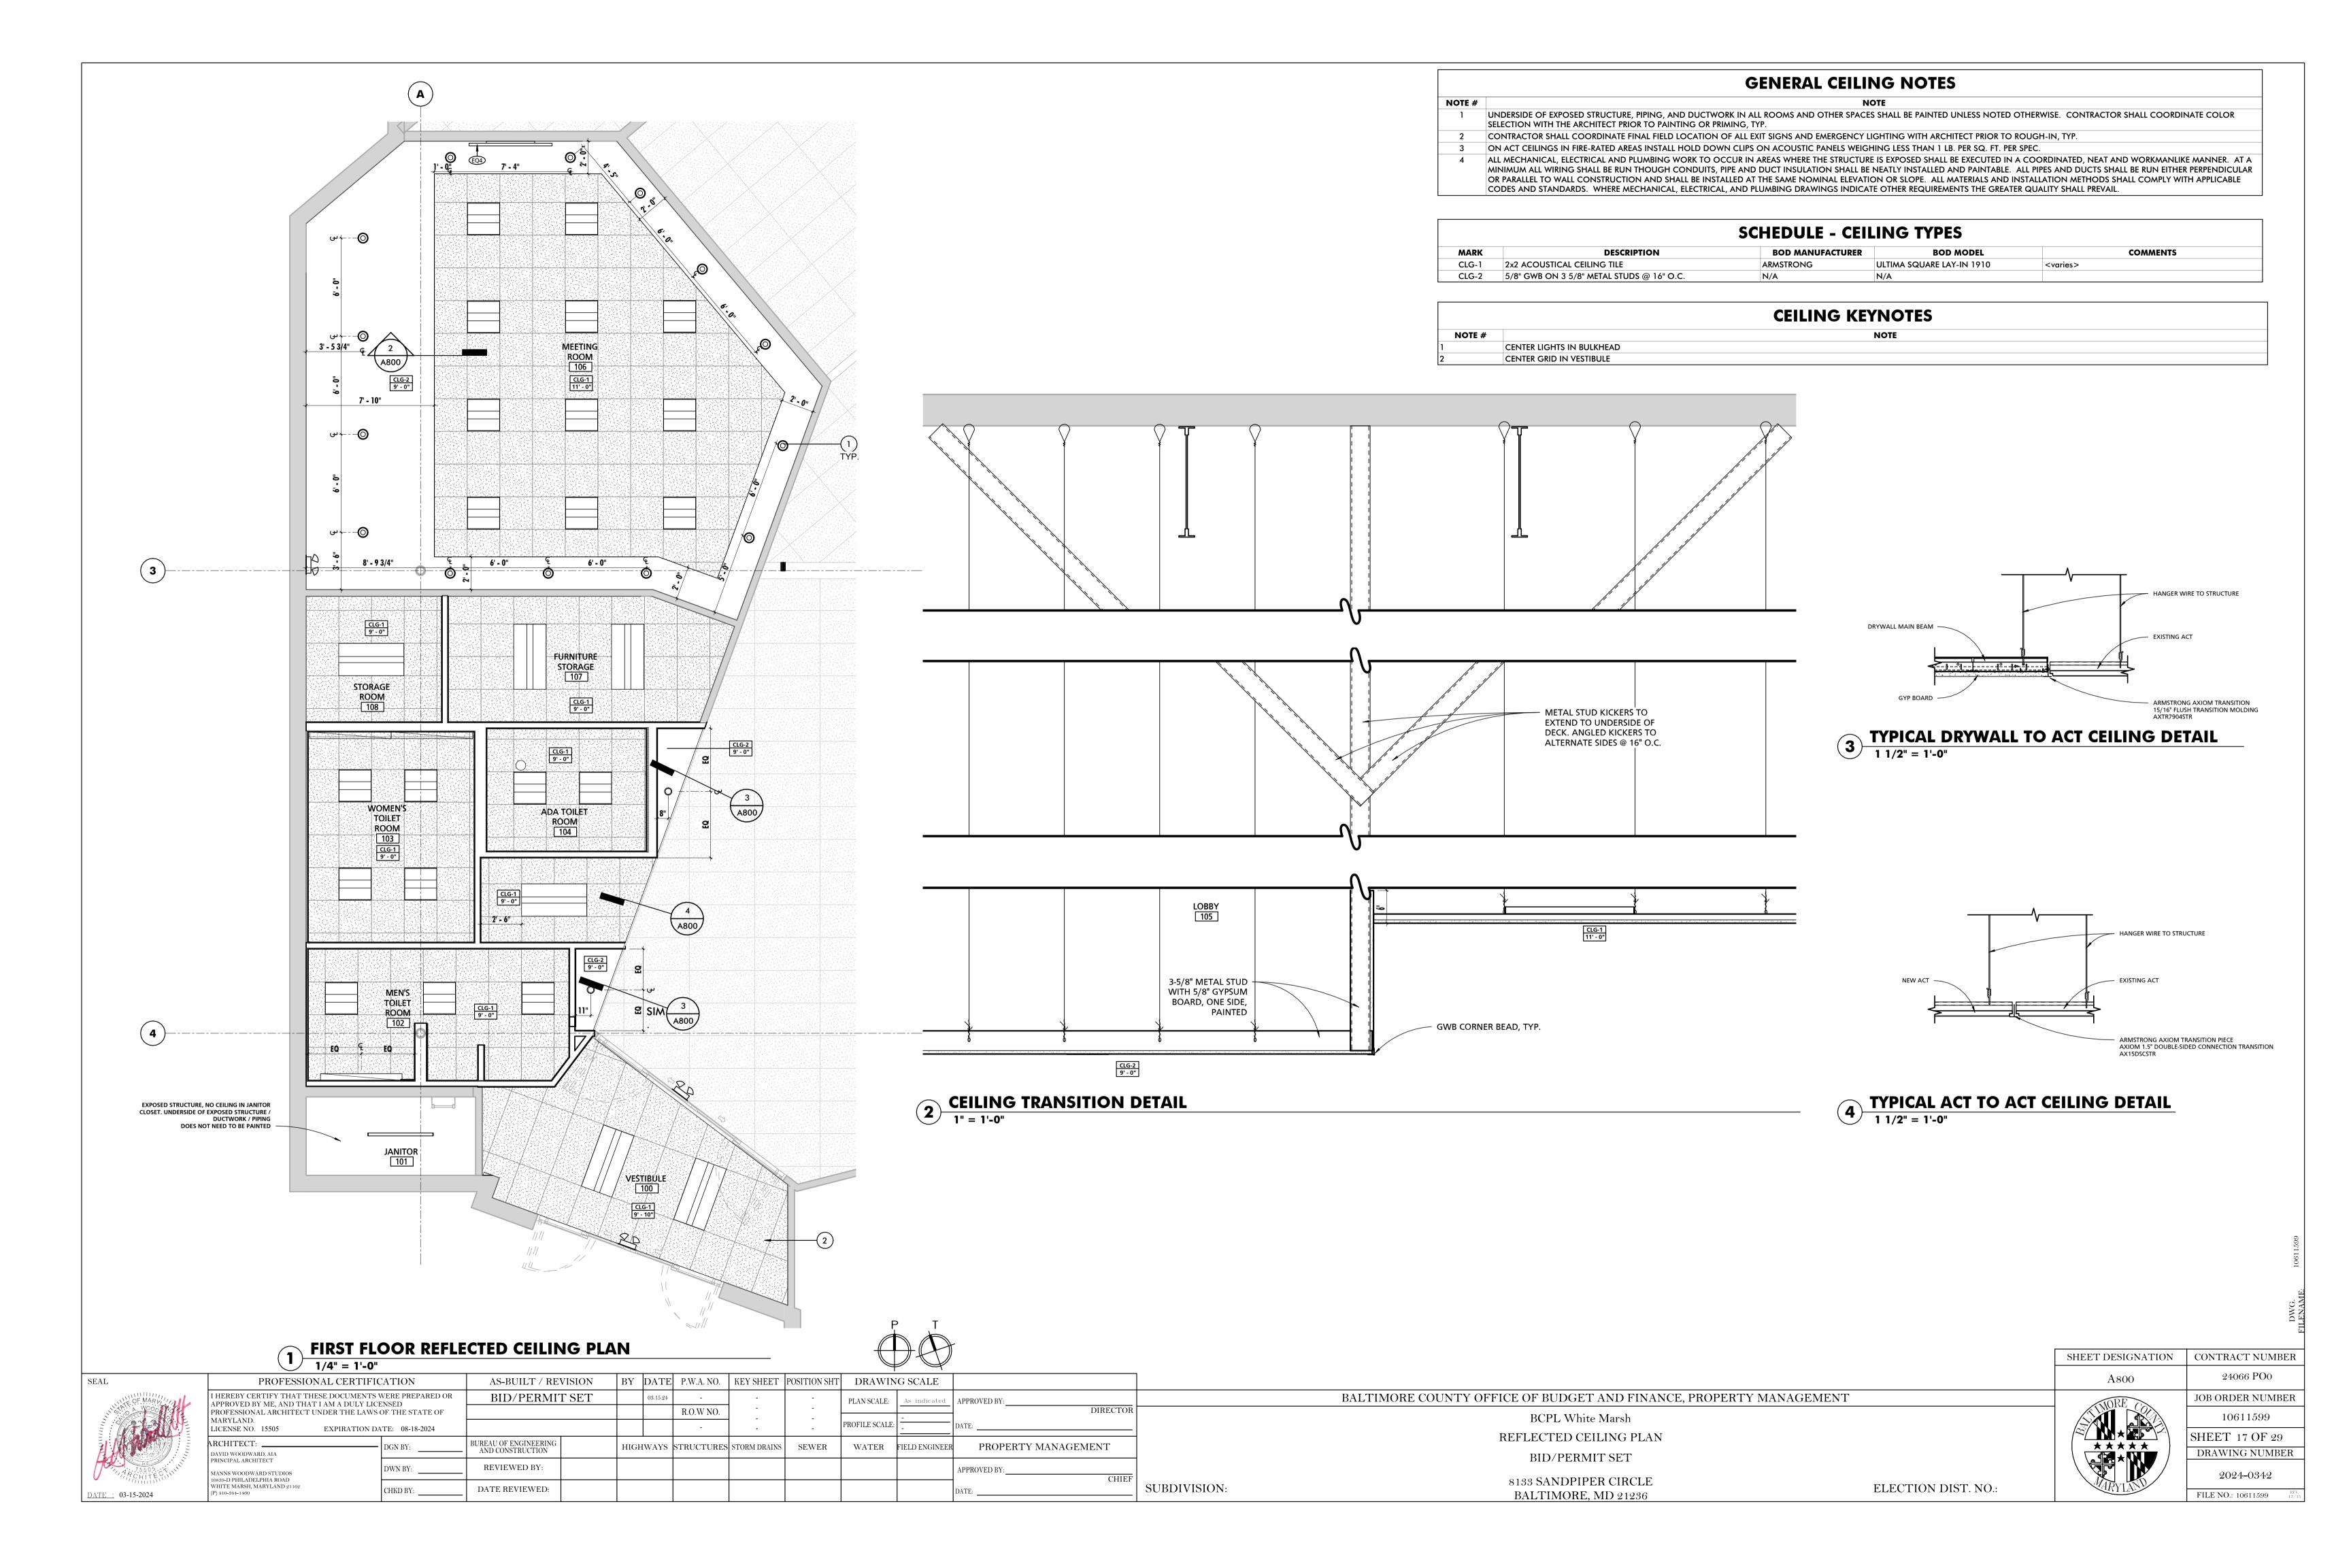

PROVIDE SIGNAGE AT ALL OF THE FOLLOWING LOCATIONS:

- ADA COMPLIANT IDENTIFICATION ROOM SIGNAGE WITH REMOVABLE INSERT AT ALL ROOMS OTHER THAN MECHANICAL ROOMS AND TOILET ROOMS. SIGNS SHALL INDICATE ROOM NUMBER AND PROVIDE REMOVABLE INSERT FOR ROOM NAMES.
- ADA COMPLIANT IDENTIFICATION ROOM SIGNAGE AT MECHANICAL ROOMS AND TOILET ROOMS. SINGLE OCCUPANT TOILET ROOMS SHALL BE IDENTIFIED AS UNI-SEX. SINGLE OCCUPANT TOILET ROOMS WITH CHANGING STATIONS SHALL BE IDENTIFIED AS FAMILY RESTOOMS.
- ADA COMPLIANT IDENTIFICATION EXIT SIGNAGE AT ALL DOORS LEADING TO RATED EXITS.
- ADA COMPLIANT IDENTIFICATION FLOOR LEVEL SIGNAGE AT ALL FLOOR LANDINGS OF STAIRS AND RAMPS.
- ADA COMPLAINT INFORMATIONAL SIGNAGE AT ALL AED STATIONS AND FIRE EXTINGUISHERS.
- 6. ADA COMPLIANT INFORMATIONAL SIGNAGE INDICATING THE MAXIMUM OCCUPANCY OF ALL ASSEMBLY SPACES.
- 7. ADA COMPLIANT INFORMATIONAL SIGNAGE SHALL BE PROVIDED AT ALL ELEVATORS.


ADA SIGNAGE MOUNTING LOCATIONS

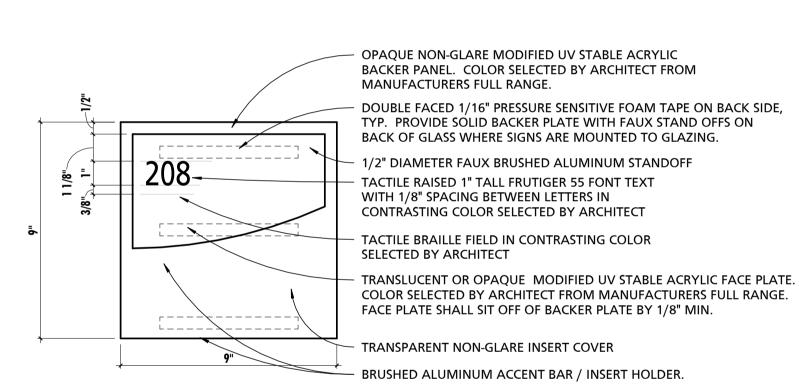


TYPICAL ROOM IDENTIFICATION SIGNAGE

RESTROOM

TYPICAL RESTROOM SIGN

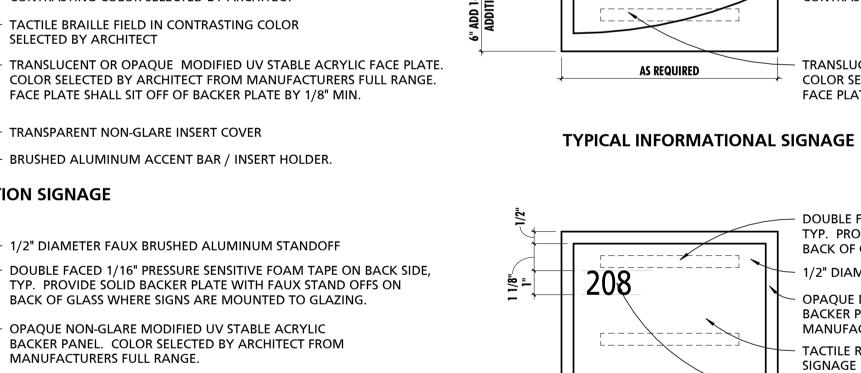

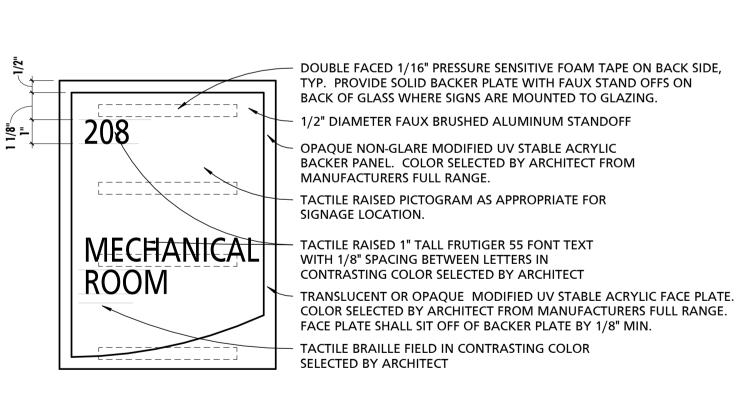

OPAQUE NON-GLARE MODIFIED UV STABLE ACRYLIC

MANUFACTURERS FULL RANGE.

BACKER PANEL. COLOR SELECTED BY ARCHITECT FROM

BACK OF GLASS WHERE SIGNS ARE MOUNTED TO GLAZING.

FACE PLATE SHALL SIT OFF OF BACKER PLATE BY 1/8" MIN.

1/2" DIAMETER FAUX BRUSHED ALUMINUM STANDOFF

TACTILE RAISED 1" TALL FRUTIGER 55 FONT TEXT

CONTRASTING COLOR SELECTED BY ARCHITECT

WITH 1/8" SPACING BETWEEN LETTERS IN

DOUBLE FACED 1/16" PRESSURE SENSITIVE FOAM TAPE ON BACK SIDE,

TRANSLUCENT OR OPAQUE MODIFIED UV STABLE ACRYLIC FACE PLATE.

COLOR SELECTED BY ARCHITECT FROM MANUFACTURERS FULL RANGE.

TYP. PROVIDE SOLID BACKER PLATE WITH FAUX STAND OFFS ON

2 TYPICAL SIGNAGE DETAILS
3" = 1'-0"

BALTIMORE COUNTY OFFICE OF BUDGET AND FINANCE, PROPERTY MANAGEMENT
BCPL White Marsh
THE PART OF THE PA

TACTILE RAISED PICTOGRAM AS APPROPRIATE FOR

TACTILE RAISED 1" TALL FRUTIGER 55 FONT TEXT

CONTRASTING COLOR SELECTED BY ARCHITECT TACTILE BRAILLE FIELD IN CONTRASTING COLOR

WITH 1/8" SPACING BETWEEN LETTERS IN

FACE PLATE SHALL SIT OFF OF BACKER PLATE BY 1/8" MIN.

TRANSLUCENT OR OPAQUE MODIFIED UV STABLE ACRYLIC FACE PLATE. COLOR SELECTED BY ARCHITECT FROM MANUFACTURERS FULL RANGE.

SIGNAGE LOCATION.

SELECTED BY ARCHITECT

TYPICAL ADA SIGNAGE DETAILS BID/PERMIT SET

BALTIMORE, MD 21236

TYPICAL UTILITY ROOM / STAIRWAY SIGN

SHEET DESIGNATION | CONTRACT NUMBER A900

24066 PO0 JOB ORDER NUMBER 10611599 SHEET 18 OF 29 DRAWING NUMBER

2024-0343 FILE NO.: 10611599


AS-BUILT / REVISION BY DATE P.W.A. NO. KEY SHEET POSITION SHT DRAWING SCALE PROFESSIONAL CERTIFICATION BID/PERMIT SET PLAN SCALE: APPROVED BY: APPROVED BY ME, AND THAT I AM A DULY LICENSED DIRECTO PROFESSIONAL ARCHITECT UNDER THE LAWS OF THE STATE OF R.O.W NO. PROFILE SCALE: LICENSE NO. 15505 EXPIRATION DATE: 08-18-2024 BUREAU OF ENGINEERING AND CONSTRUCTION ARCHITECT: ____ PROPERTY MANAGEMENT HIGHWAYS STRUCTURES STORM DRAINS SEWER WATER FIELD ENGINEER APPROVED BY:____ REVIEWED BY: DWN BY: 10839-D PHILADELPHIA ROAD WHITE MARSH, MARYLAND 21162 DATE REVIEWED: CHKD BY:


8133 SANDPIPER CIRCLE

ATE: 03-15-2024

ELECTION DIST. NO.:

SUBDIVISION:

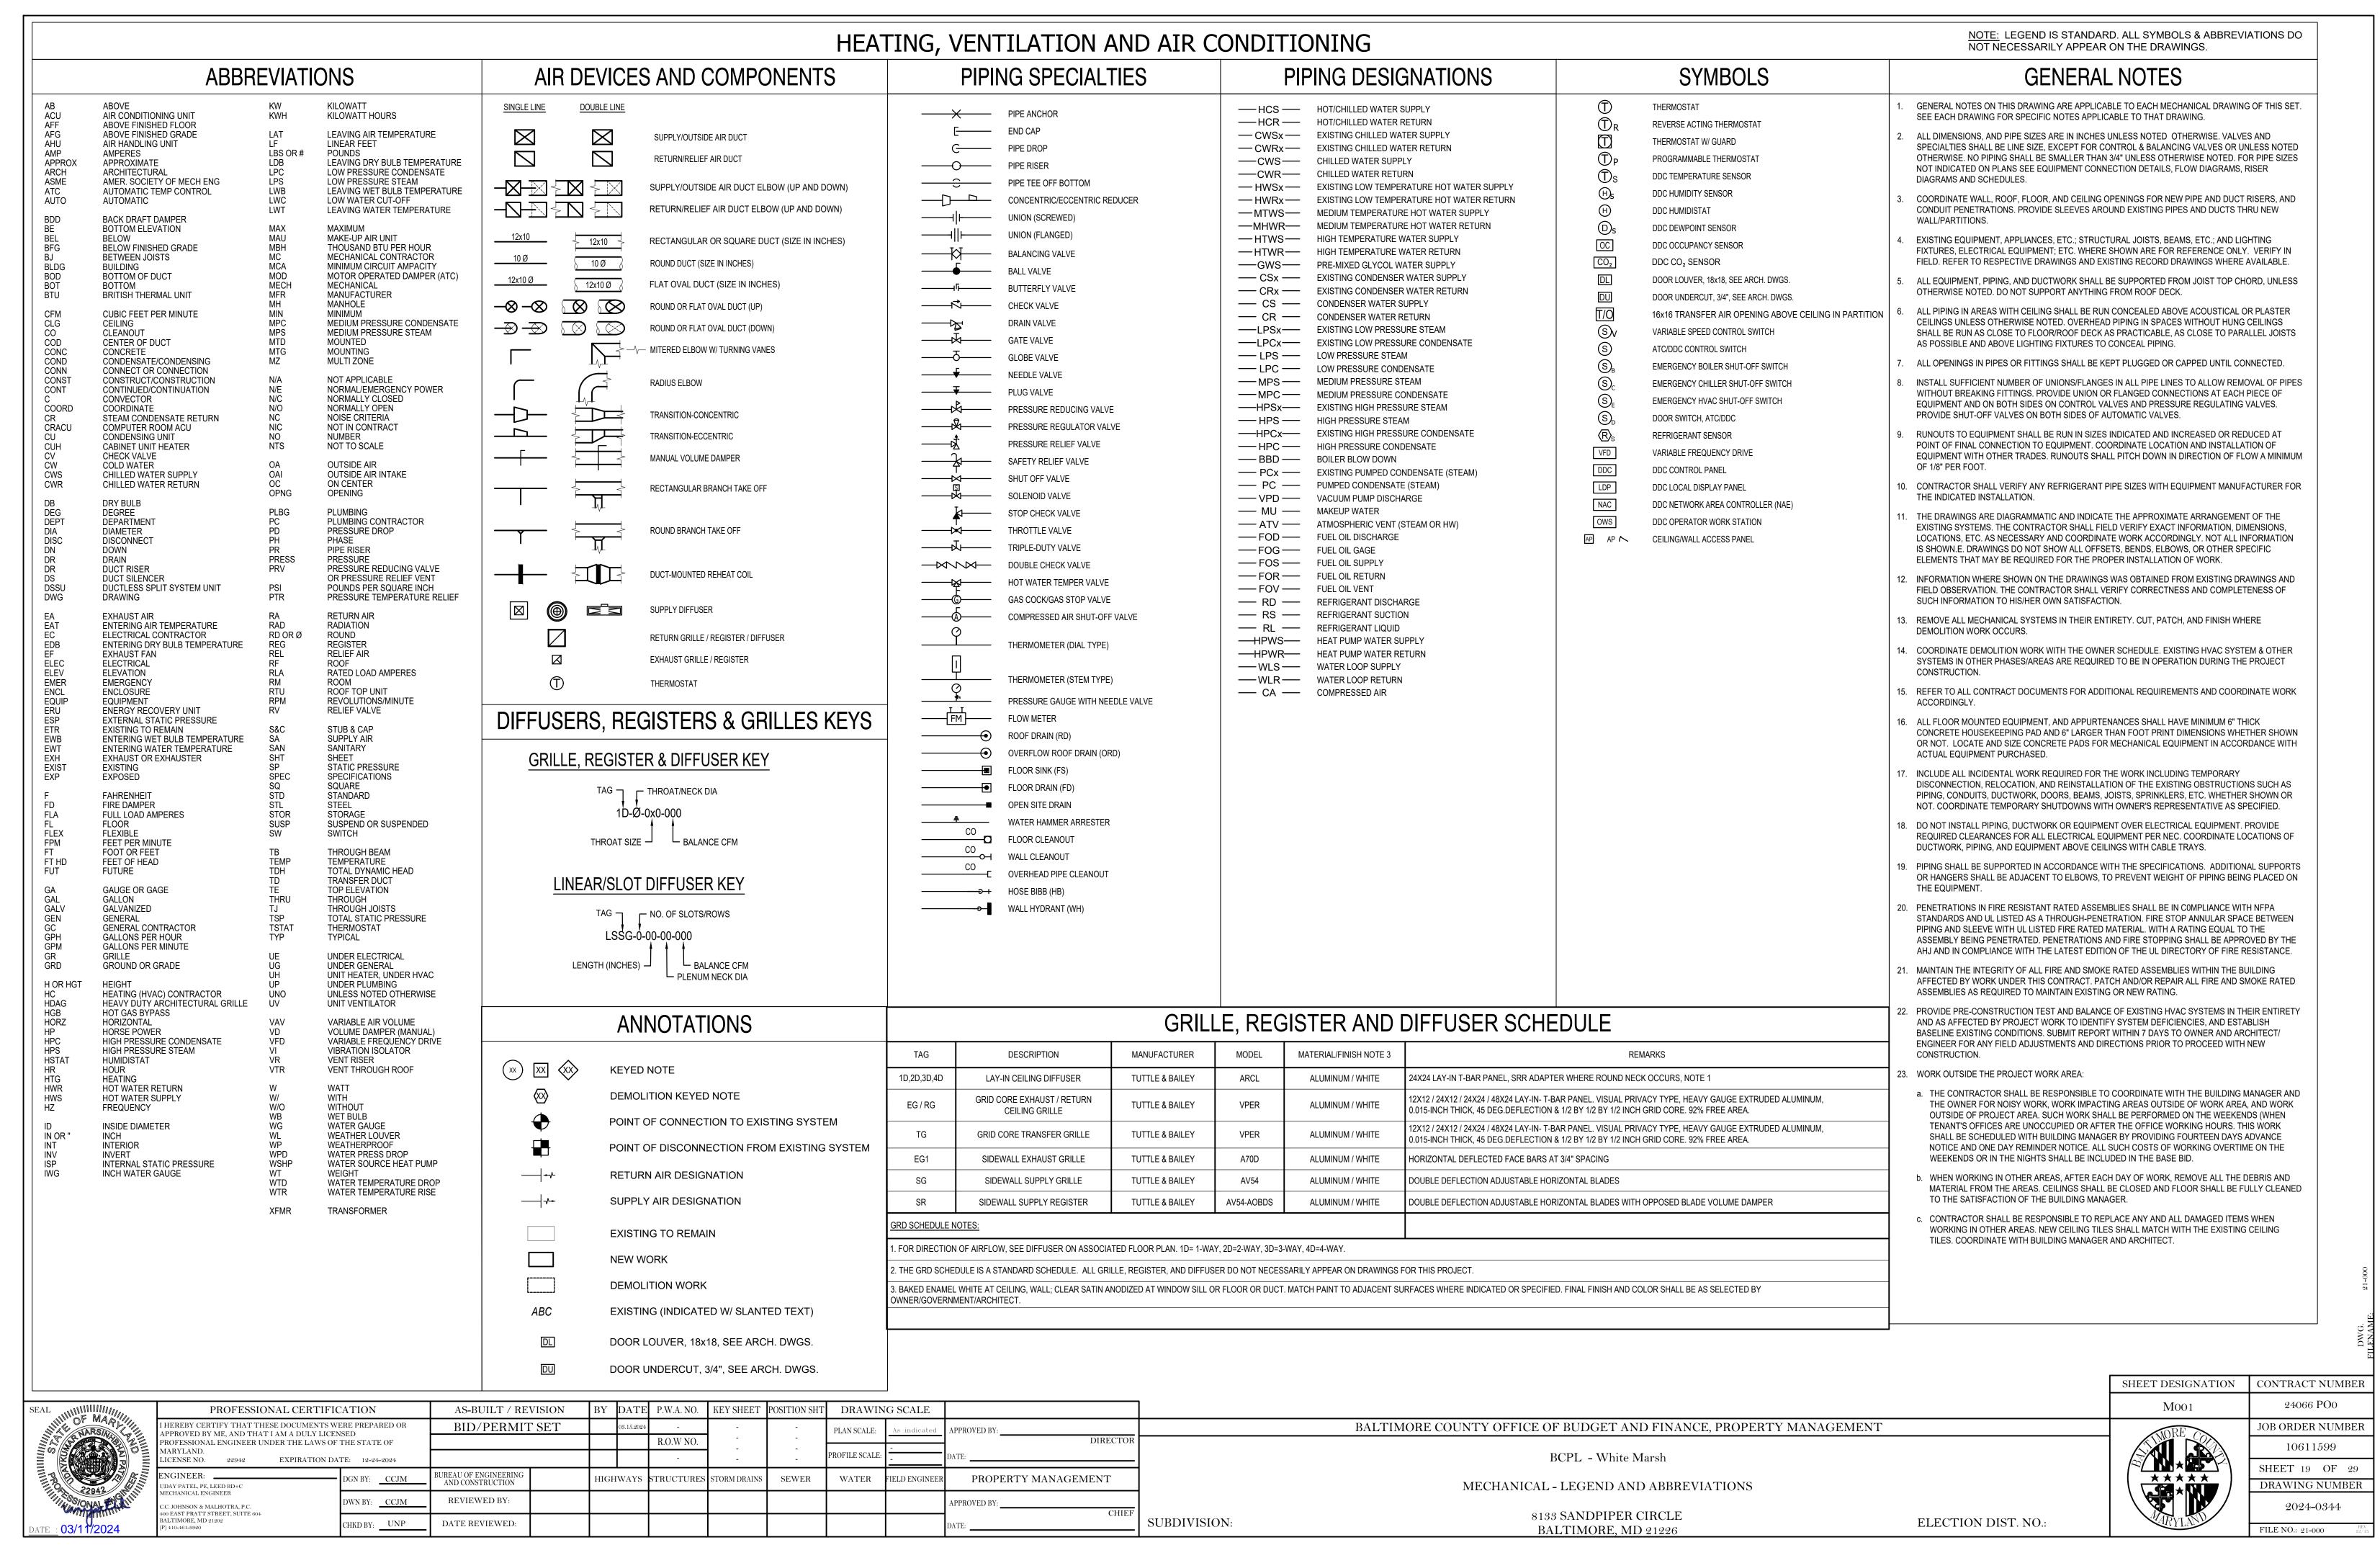

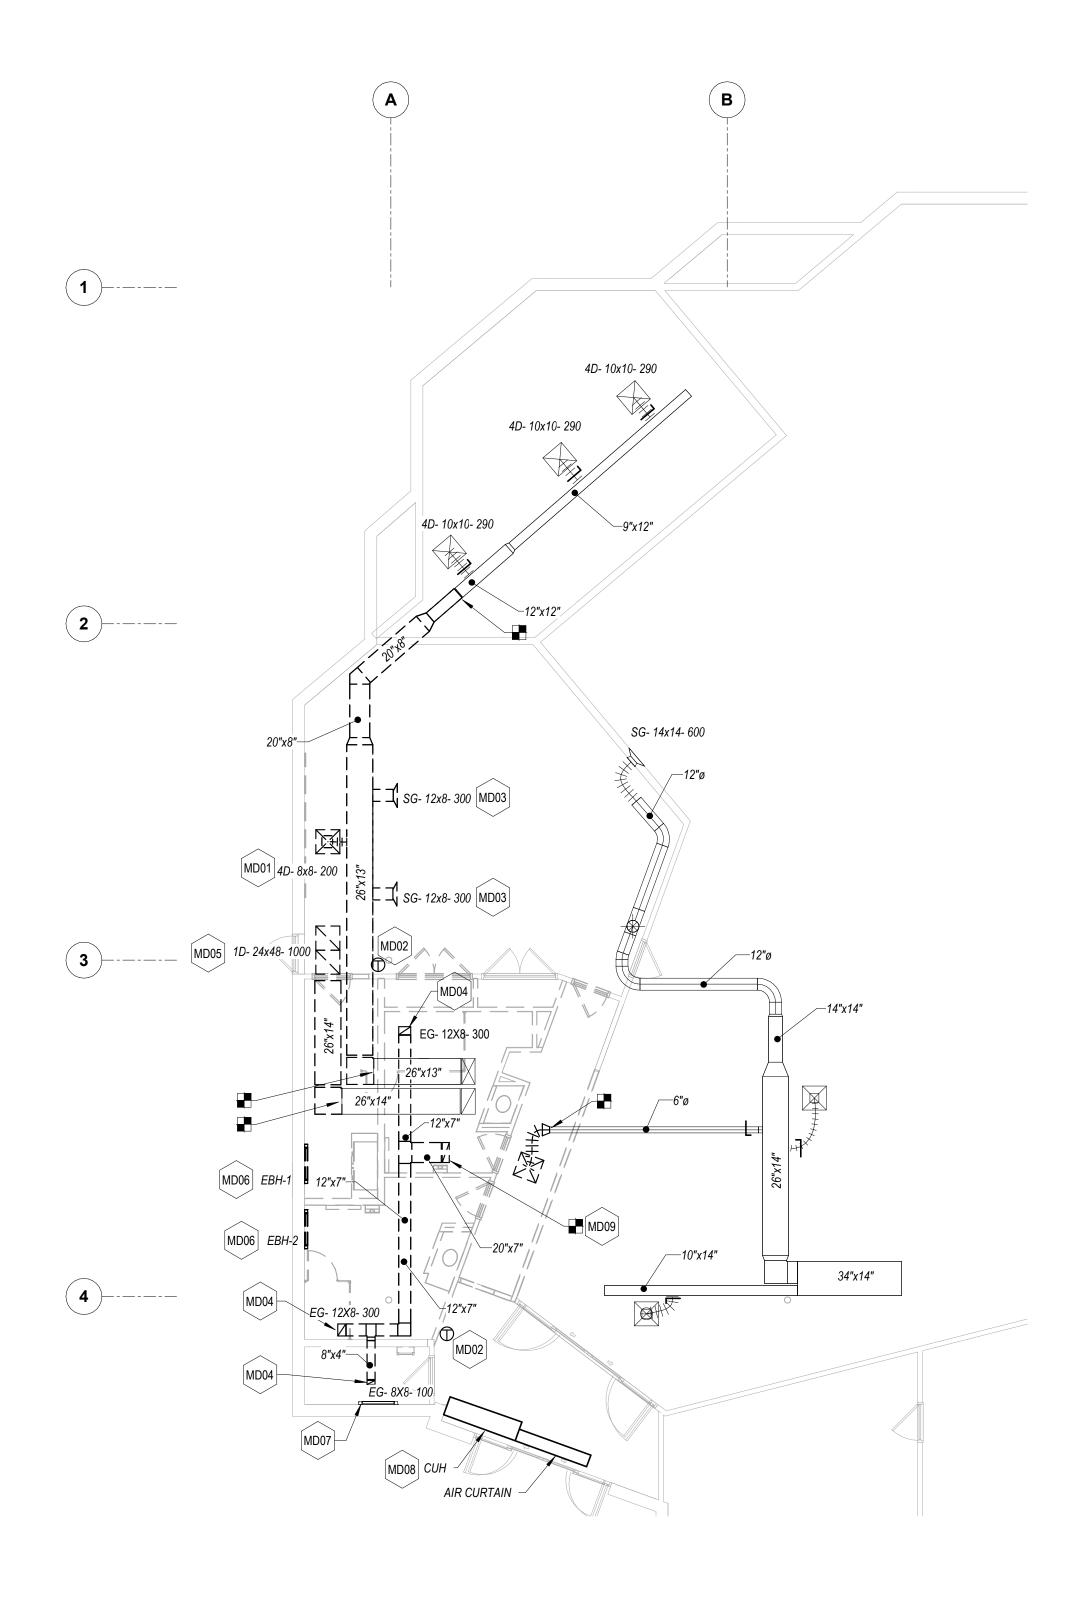

1 MECHANICAL - PARTIAL FLOOR PLAN - DEMOLITION 1/8" = 1'-0"

4D- 10x10- 290 4D- 10x10- 290 CEILING SSG - 12-48-10- 300 **MEETING ROOM** SG- 14x14- 600 106 √10"ø RETURN AIR PLENUM M04 BELMOUTH OPEN END WITH INSECT SCREEN **FURNITURE** M02 RG - 22x22- 800 STORAGE ROOM 108 ADA TOILET 104 WOMEN'S TOILET EG- 10x10-20 **ROOM** 105 103 **MEN'S TOILET** 102 **JANITOR** 4D- 12x12- 600 101 100 AIR CURTAIN

2 MECHANICAL - PARTIAL FLOOR PLAN - NEW WORK 1/8" = 1'-0"

SUBDIVISION:

MECHANICAL KEYED NOTES - DEMOLITION

NOTE#	NOTES
MD01	DISCONNECT AND REMOVE CEILING SUPPLY DIFFUSER AND ALL
	ASSOCIATED BRANCH DUCTWORK IN ITS ENTIRETY UP TO THE POINT C
	DISCONNECTION.

MD02 | RELOCATE AND REINSTALL THERMOSTAT AT NEW LOCATION.

DISCONNECT AND REMOVE WALL SUPPLY DIFFUSER AND ALL ASSOCIATED BRANCH DUCTWORK IN ITS ENTIRETY UP TO THE POINT OF DISCONNECTION.

MD04 DISCONNECT AND REMOVE EXHAUST GRILLE AND ALL ASSOCIATED BRANCH DUCTWORK IN ITS ENTIRETY UP TO THE POINT OF DISCONNECTION.

MD05 DISCONNECT AND REMOVE RETURN GRILL AND ALL ASSOCIATED DUCTWORK IN ITS ENTIRETY UP TO THE POINT OF DISCONNECTION.

MD06 DISCONNECT AND REMOVE THE ELECTRIC BASE BOARD HEATER IN ITS ENTIRETY.

MD07 EXISTING ELECTRIC BASE BOARD HEATER WITH 500 WATTS CAPACITY @120V /1PH TO REMAIN.

MD08 EXISTING ELECTRIC CABINET HEATER WITH 5KW CAPACITY @208V /3PH TO

EXISTING 20X7 EXHAUST DUCT UP TO EXHAUST FAN EF-1 ON ROOF TO REMAIN. EXISTING EXHAUST FAN IS ASSUMED TO HAVE PERFORMANCE CAPACITY OF 700 CFM @0.375 ISP, BELT DRIVEN, 1/6 HP @115V/ 1PH. REMOVE ALL ASSOCIATED CONTROLS INCLUDING WALL SWITCH IN JANITOR CLOSET.

MECHANICAL KEYED NOTES - NEW WORK

#	NOTES
M01	FIELD VERIFY AND COORDINATE DUCT ELEVATIONS TO FIT WITHIN NEW
	CEILING HEIGHTS AND EXISTING STRUCTURE. MODIFY EXISTING TO
	REMAIN DUCTWORK AS REQUIRED.


PROVIDE RETURN/EXHAUST GRILLE WITH MANUAL VOLUME DAMPER IN BRANCH DUCT. MODIFY EXISTING 20x7 DUCT RISER CONNECT NEW DUCTWORK TO EXISTING TO EF-1 ON ROOF AS REQUIRED TO SUIT NEW WORK. TEST, ADJUST AND BALANCE ASSOCIATED EXISTING AND NEW EXHAUST GRILLES AND EXHAUST FAN EF-1 IN THEIR ENTIRETY. REPLACE/ADJUST DRIVES, VARIABLE SPEED MOTOR, AND/OR WHEELS AS REQUIRED TO ACHIEVE DESIGN AIRFLOW WITHOUT OVERLOADING MOTOR PROVIDE A WALL MOUNTED TIME DELAY CONTROLLED ON-OFF SWITCH IN JANITOR 101. CONTROL SEQUENCE OF OPERATION: WHEN ON-OFF WALL SWITCH IS MANUALLY INDEXED TO NORMAL ON POSITION DURING OCCUPIED HOURS, THE EXHAUST FAN SHALL BE AUTOMATICALLY STARTED AND RUN UNTIL MANUALLY INDEXED TO OFF POSITION. WHEN WALL SWITCH IS MANUALLY INDEXED TO OFF POSITION DURING UNOCCUPIED HOURS, THE EXHAUST FAN SHALL BE AUTOMATICALLY DE-ENERGIZED AFTER 15 MINUTES TIME DELAY (ADJ.). EXISITNG EF-1 (BASED ON LABEL & 1987 DRAWINGS): 700 CFM, 0.625" WG ESP, 1/6 HP, 120/1/60, DIRECT DRIVE,

M03 EXISTING RTU (HEAT PUMP, HPHW#1) CAPACITIES (BASED ON LABEL & 1987 DRAWINGS): DX COOLING (58 MBH TOTAL & 37 MBH SENSIBLE, 68 DEG. F EWB) COIL, 1670 TOTAL CFM @0.40" WC ESP, 3/4 HP, 208 V /3 PH / 60 HZ, 25% MINIMUM OUTSIDE AIR. CARRIER MODEL 50TCQA06A2A5A0A0A0. TEST, ADJUST AND BALANCE RTU AND ASSOCIATED AIR DISTRIBUTION SYSTEM AND CONTROLS IN THEIR ENTIRETY. REPLACE DRIVES AS REQUIRED TO ACHIEVE DESIGN AIRFLOW WITHOUT OVERLOADING MOTOR.

DAYTON MODEL 5DVT1 DOWNBLAST FAN.

PROVIDE CEILING DIFFUSER WITH MANUAL VOLUME DAMPER IN BRANCH DUCT TAKE-OFF.

RELOCATE AND REINSTALL THERMOSTAT FOR RTU AND AIR CURTAIN AT NEW LOCATION. VERIFY OPERATION.

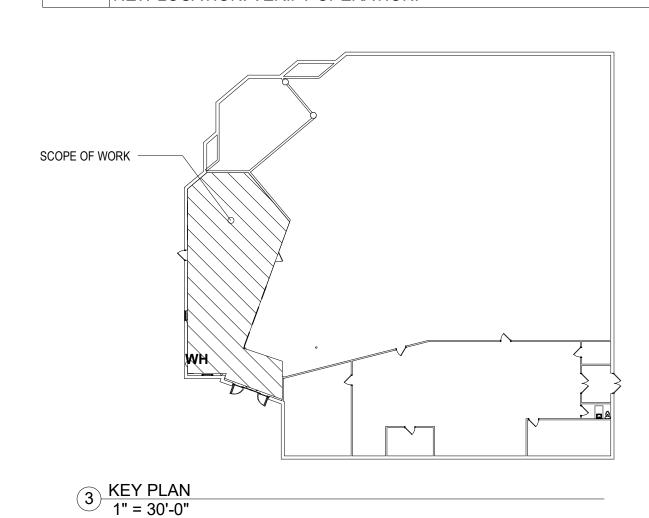

ELECTION DIST. NO.:

111111111111111111111111111111111111111	PROFESSIONAL CERTIFIC	AS-BUILT / RE	VISION	BY	DATE	P.W.A. NO.	KEY SHEET	POSITION SHT	DRAWIN	G SCALE			
MARLINA RSING P	I HEREBY CERTIFY THAT THESE DOCUMENTS WERE PREPARED OR APPROVED BY ME, AND THAT I AM A DULY LICENSED PROFESSIONAL ENGINEER UNDER THE LAWS OF THE STATE OF		BID/PERMIT	Г ЅЕТ		03.15.2024	-	-	-	PLAN SCALE:	As indicated	APPROVED BY:	
							R.O.W NO.			-		DIRECT	
	MARYLAND. LICENSE NO. 22942 EXPIRATION DA	ATE: 12-24-2024					-	-	-	PROFILE SCALE:	-	DATE:	
	ENGINEER: UDAY PATEL, PE, LEED BD+C	DGN BY: CCJM	BUREAU OF ENGINEERING AND CONSTRUCTION		HIGH	IWAYS	STRUCTURES	STORM DRAINS	SEWER	WATER	FIELD ENGINEER	PROPERTY MANAGEMENT	Γ
NAL FULLIN	MECHANICAL ENGINEER C.C. JOHNSON & MALHOTRA, P.C.	DWN BY: CCJM	REVIEWED BY:									APPROVED BY:	СНІЕ
	400 EAST PRATT STREET, SUITE 604 BALTIMORE, MD 21202 (P) 410-461-9920	CHKD BY: UNP	DATE REVIEWED:									DATE:	CITIE

BALTIMORE COUNTY OFFICE OF BUDGET AND FINANCE, PROPERTY MANAGEMENT

BCPL - White Marsh

MECHANICAL - PARTIAL FLOOR PLAN - DEMOLITION & NEW WORK

8133 SANDPIPER CIRCLE BALTIMORE, MD 21226

SHEET DESIGNATION

M101

JOB ORDER NUMBER SHEET 20 OF 29 DRAWING NUMBER FILE NO.: 10611599


ALL DRAWINGS ARE PROTECTED BY FEDERAL COPYRIGHT BY C.C. JOHNSON & MALHOTRA, P.C. AND CAN NOT BE REPRODUCED OR MODIFIED IN ANY MANNER WITHOUT EXPRESS WRITTEN PERMISSION. DOCUMENTS MAY NOT BE USED IN PART OR WHOLE TO DEVELOP THE DESIGN OF ANOTHER BUILDING WITHOUT EXPRESS WRITTEN PERMISSION BY C.C. JOHNSON & MALHOTRA, P.C.

CONTRACT NUMBER 24066 PO0

10611599

2024-0345


					PLUMBING							
ABBREVIATIONS PIPING SPECIALTIES		PIPING DESIGNATION	A	ANNOTATIO	ONS	GENERAL CONSTRUCTION NOTES						
AFF ABOVE FINISHED FLOOR KW KILOWATT AFG ABOVE FINISHED GRADE KWH KILOWATT HOUR AFLR ABOVE FLOOR LEVEL RIM APLR APROXIMATE LF LINEAR FEET (FOOT) APPROX APPROXIMATE LF LINEAR FEET (FOOT) APPROX APPROXIMATE LF LINEAR FEET (FOOT) APPROX ACID VENT AVA ACID VENT RISER MAX MAXIMUM AVA ACID VENT RISER MBH THOUSAND BTU PERF MC MECHANICAL CONTRA WAY ACID VENT RISER MBH THOUSAND BTU PERF MC MECHANICAL CONTRA MINIMUM MINIMU		PIPE ANCHOR E END CAP C PIPE DROP PIPE RISER PIPE TEE OFF BOTTOM CONCENTRIC/ECCENTRIC REDUCER UNION (SCREWED) UNION (FLANGED) PRESSURE/ TEMPERATURE TEST FITTING ALIGNMENT GUIDE EXPANSION JOINT W/ ALIGNMENT GUIDES FLEXIBLE CONNECTOR EXPANSION COMPENSATOR EXPANSION LOOP STRAINER WITH HOSE END BLOW OFF VALVE STRAINER PUMP BALANCING VALVE BALL VALVE DRAIN VALVE GATE VALVE CHECK VALVE PLUG VALVE PRESSURE REDUCING VALVE PRESSURE REGULATOR VALVE SAFETY RELIEF VALVE	—————————————————————————————————————	X # KEY X DEI X DEI DEI M-5xx SHE #X PHO EXI DEI NEV	NT OF DISCONNECTI FAIL NUMBER EET NUMBER CTION NUMBER	TE TO EXISTING SYSTEM ION FROM EXISTING SYSTEM CTION OF VIEW)	BECORD THE CONTRACTOR. 1. ALL DIMENSIONS, PIPE SIZES, AND EXISTING CONDITIONS SHALL BE VERIFIED AT THE STE BY THE CONTRACTOR. 2. BEFORE STARTING WORK MAKE ATHOROUGH EXAMINATION OF THOSE PORTIONS OF THE STRUCTURE IN WHICH THE WORK IS TO BE PERPOYMED, CITICAL THE WORK IS TO BE PERPOYMED. CHECK ALL THE WORK ADDIMING, AT OVERHEAD LOCATIONS, AND LOCATIONS BELOW THE FLOOR, REPORT TO THE OWNER, ANY AND ALL CONDITIONS WHICH MAY INTERSERE WITH OR OTHERWISE AREFET OR, PREVENT THE PROPER EXECUTION AND COMPLETION OF THE WORK IS ON OTHERWISE AREFET OR, PREVENT THE PROPER EXECUTION AND COMPLETION OF THE WORK IS ON THE STRUCTURE. BEEN MULTILLY AGREED UPON. 3. EXISTING FINISHEST OR PROMINT THAT ARE DISTURBED BY DEMOLITION SHALL BE REFINISHED TO MATCH EXISTING. REPAIR AND/OR REPLACE ALL EXISTING CONSTRUCTION OND AND AT NO ADDITIONAL CONTROL THE OF REMOVAL OR DAMAGED BY, THE WORK REPLACEMENTS AND MODIFICATIONS SHALL RESTORE REMOVED OR DAMAGED BY, THE WORK REPLACEMENTS AND MODIFICATIONS SHALL RESTORE REMOVED OR DAMAGED BY, THE WORK REPLACEMENTS AND REGULATIONS. 4. BEFORE STARTING DEMOLITION OPERATIONS, PROVIDE THE INCESSARY PROTECTIVE DEVICES WHERE REQUIRED, AND IN STRICT ACCORDANCE WITH OSHA RULES AND REGULATIONS. 5. CONTRACTOR MUST HAVE SEPARATE CONTRINCES FOR MASTE AND BECYCLIDE AT APPROVAL REPRESENTATIVE, DEPERPAGE OR MADE IMPERED AND CONTROLLED OR THE PROPERTY OF THE CONTRACTOR AND SHALL BE DISPOSED OF OF THE SITE, ON A BEGULAR BASIS, IN A LEGAL MANNER, RECYCLABLE BY OR MADE IMPERED THE CONTROLLED OR TO THE CONTRACTOR AND SHALL BE DISPOSED OF OF THE SITE, ON A BEGULAR BASIS, IN A LEGAL MANNER, RECYCLABLE BY OR MADE IMPERED AND CONTROLLED OR THE PROPERTY OF THE CONTRACTOR AND SHALL BE RECYCLED AT APPROVAL REPRELIES AND ARRANGEMENTS. 5. PATCH, FILL AND REPAIR ALL SURFACES DISTURBED, CUT, DAMAGED, IN NEED OF REPAIR OR MADE IMPERED THE CONTRACTOR AND SHALL BE RECYCLED AT APPROVAL REPRESENTATIVE. 5. PATCH, FILL AND REPAIR ALL SURFACES DISTURBED, CUT, DAMAGED, IN NEED OF REPAIR OR MADE IMPERED TO THE CONTRACTOR AND SHALL B					
FINISH FLOOR ELEVATION FINISH GRADE FLOOR FULL LOAD AMPERES FLOOR SINK FOOT OR FEET FEET OF HEAD	SP SUMP PUMP SPEC SPECIFICATION SQ SQUARE SS SERVICE SINK SSD SUBSOIL DRAIN ST W STORM WATER STD STANDARD	SHUT OFF VALVE SOLENOID VALVE STOP CHECK VALVE THROTTLE VALVE		INECTIONS ROUGH-IN SIZE (II	NCHES)	PL	PLUMBING FIXTURES SCHEDULE					
FUTURE FLUSH VALVE R FLUSH VALVE TRANSFORMER GAUGE OR GAGE GALLON GENERAL CONTRACTOR	STL STEEL SUSP SUSPENDED SW SWITCH TEMP TEMPERATURE TDH TOTAL DYNAMIC HEAD THRU THROUGH	TRIPLE-DUTY VALVE DOUBLE CHECK VALVE HOT WATER TEMPER VALVE GAS COCK/GAS STOP VALVE	TAG DESCRIPTION WC-1 WATER CLOSET		HOT TEMPERED WA	STE VENT	EAT. TRIP LEVER ON OPEN SIDE OF THE TOILET.					
GENERAL GALLONS PER HOUR GALLONS PER MINUTE	TJ THROUGH JOISTS TW TEMPERED WATER TWMV THERMOSTATIC WATER MIXING VAVLE TYP TYPICAL	COMPRESSED AIR SHUT-OFF VALVE	WC-1A WATER CLOSET - ADA UR-1A URINAL - ADA	3/4"		4" 2" 2" 1-1/2"		OUNTED, MANUAL FLUSH TANK TYPE WATER CLOSET WITH 17" AFF RIM HEIGHT. TOTO MODEL CST744EGN(G) WATER CLOSET; SC534 ELONGATED OPEN FRONT SEAT. TRIP LEVER ON OPEN SIDE OF TH JNTED WASHOUT URINAL WITH MANUAL EXPOSED TOP SPUD FLUSHOMETER AND RIM HEIGHT 24" AFF. TOTO MODEL UT447E URINAL, THU3017 STAINLESS STEEL URINAL DRAIN COVER & SLOAN VALVE I				
GROUND OR GRADE GATE VALVE HEIGHT	UE UNDER ELECTRICAL UG UNDER GENERAL	THERMOMETER (DIAL TYPE)	SK-1 COUNTERTOP SINK	1/2"	1/2" - :	2" 1-1/2"	,	EL SINGLE BOWL SINK. ELKAY MODEL ELUH241610PD SINK. CONCEALED WIDESPREAD MIXING FAUCET W/ 6" SWIVEL GOOSENECK SPOUT, 1.5 D QUARTER TURN CERAMIC CARTRIDGE. T&S FAUCET MODEL B-2866-LF15 WITH B-0199-29VR. OTHER ACCESSORIES AND CABINETS SPECIFIEI				
HEATING (HVAC) CONTRACTOR HANDICAPPED (ACCESSIBLE) HORSE POWER	UH UNIT HEATER, UNDER HVAC UP UNDER PLUMBING UNO UNLESS NOTED OTHERWISE	THERMOMETER (STEM TYPE)	L-1A LAVATORY - ADA	1/2"	1/2" - 2	2" 1-1/2"	ACCESSIBLE, WALL MOUNTED LAVATO MODEL 8210 [NOTE 2, 3, 7]	ORY WITH FRONT INTEGRAL OVERFLOW, CENTER FLAT STRAINER DRAIN, COLOR SELECTED BY ARCHITECT, TOTO MODEL LT307.4. MANUAL-T	YPE SINGLE-CONTROL MIXING FAUCET WITH 0.5 GPM LAMINAR SPRAY OUTLET, MOEN FA			
HOUR HOT WATER RECIRCULATION HERTZ (FREQUENCY)	UR URINAL VAC VACUUM	PRESSURE GAUGE WITH NEEDLE VALVE	L-2A SOLID SURFACE LAVATORY - ADA	1/2"	1/2" - :	2" 1-1/2"	<u> </u>	CONTRACTOR. MANUAL-TYPE SINGLE-CONTROL MIXING FAUCET WITH 0.5 GPM LAMINAR SPRAY OUTLET, MOEN FAUCET MODEL 8210 [NOTE 2,	71			
INSIDE DIAMETER	V VENT VFD VARIABLE FREQUENCY DRIVE VIF VERIFY IN FIELD	FLOW METER ROOF DRAIN (RD)	EWC-1 ELECTRIC WATER COOLER W/BOTTLE FILLER - ADA		<u></u>	1/2" 1-1/2"		STATION WATER COOLER WITH BOTTLE FILLING STATION, BARRIER FREE, LEAD FREE, FLEXIBLE BUBBLE GUARD, STAINLESS STEEL FINISH. EL				
INTERIOR INVERT	VR VENT RISER VS VENT STACK VTR VENT THROUGH ROOF	OVERFLOW ROOF DRAIN (ORD)	PT PLASTER TRAP	-	- - ;	2" -	BOTTOM DRAIN CONNECTION. SEE AR					
	W WASTE W/ WITH	FLOOR SINK (FS)	FD FLOOR DRAIN	-	;	3" 1-1/2"	DEEP SEAL TRAP WITH PROSET TRAP	GUARD				
	W/O WITHOUT WC WATER CLOSET WCO WALL CLEANOUT	FLOOR DRAIN (FD)	SCHEDULE NOTES:	S FOR ALL FIXTURES R	DEFODE INICTALLATION DEFED TO ADO	CHITECTURAL ELEVA	ATION DRAWINGS BOUGH IN AND INSTALL	L BARRIER-FREE/ACCESSIBLE FIXTURES PER ADA REQUIREMENTS. COORDINATE AUTOMATIC FLUSH VALVE HEIGHT WITH GRAB BARS.				
	WG WATER GAGE WHA WATER HAMMER ARRESTOR WM WATER METER	OPEN SITE DRAIN WATER HAMMER ARRESTER	FAUCET AS SPECIFIED; OFFSET TRAP; PROVIDE INS		·	THE TOTAL ELLY	THOR BRAWINGS. NOOGH IN AIRS INGTALL	E BYWWENT TREET/ROSESSIBLE FIXTORIES FERTILITIES. SOCIEDITATIE TO TOWN THE FESTIVATION OF BUILDING WITH GIVIN BYWO.				
	WP WEATHERPROOF WPD WATER PRESS DROP WT WEIGHT	FLOOR CLEANOUT CO WALL CLEANOUT	3. PROVIDE FLOOR MOUNTED CHAIR-CARRIER TYPE F	IXTURE SUPPORTS F	OR EACH OFF-THE-FLOOR MOUNTED F	FIXTURE SUCH AS LA	AVATORIES, URINALS, WATER CLOSETS, V	VATER COOLERS, AND SIMILAR OTHER FIXTURES.				
	WTR WATER TEMPERATURE RISE XFMR TRANSFORMER	CO OVERHEAD PIPE CLEANOUT	.,	,				PANEL, MLP100 IN-WALL SUPPORT FRAME, AND 51300C WATERSENTRY PLUS FILTER AND WATERSENTRY VII FILTER KIT. 8 GPH CAPACITY. 12(PANEL, MLP200 IN-WALL SUPPORT FRAME, AND 51300C WATERSENTRY PLUS FILTER AND WATERSENTRY VII FILTER KIT. 8 GPH CAPACITY. 12(
	YCO YARD CLEANOUT	HOSE BIBB (HB) WALL HYDRANT (WH)		,			,	SH COLLECTION PER OSHA MANDATED USER TESTING.	0 4021, 11111102, 00112.			
			7. PROVIDE MANUFACTURED PROTECTIVE SHIELDING	PIPE COVERS AND EN	NCLOSURES FOR COVERING EACH AD	A PLUMBING FIXTUR	E HOT- AND COLD-WATER SUPPLIES AND	TRAP AND DRAIN PIPING TO COMPLY WITH ADA REQUIREMENTS. TRUEBRO LAV GUARD2 OR APPROVED EQUAL.				
							PLUMBING SPECIAL	TIES SCHEDULE				
			TAG DESCRIPTION N	MANUFACTURER	R MODEL	1	CAPACITY	REMARKS				
			CO CLEANOUT - FLOOR (VCT/CERAMIC TILE)	ZURN	ZB-1400-BP-TX		MINIMUM 4" OR LINE SIZE (UNO)	NOTE 1				
			WCO CLEANOUT - WALL CO AP CLEANOUT - ACCESS PANEL	ZURN ACUDOR	Z-1447-BP UF-5000-PS-CL-16X16		MINIMUM 4" OR LINE SIZE (UNO)	NOTE 1 PROVIDE FOR ALL EXISTING AND NEW WALL CLEANOUTS				
			FD FLOOR DRAIN - VCT/CERAMIC TILE	ZURN	ZN-415-6S-HD-VP	6" X 6" H	EAVY DUTY STRAINER, MIN. 3" OR LINE SIZ	ZE (UNO) PROVIDE DEEP SEAL TRAP AND PROSET TRAP GUARD. NOTE 2				
			WHA WATER HAMMER ARRESTER SI-1 SOLIDS INTERCEPTOR (PLASTER TRAP)	ZURN ZURN	Z-1700 ZA-1180-SS		AS PER PDI 15 GPM FLOW RATE, 2" INLET & OUTLET	TOP ACCESS FOR INSIDE CABINET INSTALLATION, STAINLESS STEEL 3/32" DIA PERFORATED SCREEN				
			PLUMBING SPECIALTIES SCHEDULE NOTES:									
			REPLACE CLEANOUT COVERS TO MATCH EXISTIN PEDLACE ELOOP DRAIN STRAINERS TO MATCH EXISTIN						SHEET DESIGNATION CONT			
.,,,,,,,,,,,,,,,,,,,,,,,,,,,,,,,,,,,,,,	PROFESSIONAL CERTIFICATION	AS-BUILT / REVISION BY DATE P.W.A. NO. KEY SHE.	2. REPLACE FLOOR DRAIN STRAINERS TO MATCH EX	MOTING SIZE AND SHA	APE FUK ALL FLOUR DRAINS TO SUIT N	NEVV FINISHES IN PR	OJECT WORK AREA, WHETHER SHOWN O	K NOI.	P001			
I HEREBY CERT APPROVED BY I	CIFY THAT THESE DOCUMENTS WERE PREPARED OR ME, AND THAT I AM A DULY LICENSED	BID/PERMIT SET 03.15.2024	PLAN SCALE: As indicated APPROVED BY:				BALTIMORE CO	DUNTY OFFICE OF BUDGET AND FINANCE, PROPERTY MANAGEMENT	1 001			
	L ENGINEER UNDER THE LAWS OF THE STATE OF 22942 EXPIRATION DATE: 12-24-2024	R.O.W NO.	PROFILE SCALE: DATE:		DIRECTOR			BCPL - White Marsh	JOB O			
ENGINEER: UDAY PATEL, PE, LI	DGN BY: CCJM	BUREAU OF ENGINEERING AND CONSTRUCTION HIGHWAYS STRUCTURES STORM DRA	NS SEWER WATER FIELD ENGINEER PROPE	CRTY MANAGEN	MENT		D i I i	MBING - SCHEDULES, LEGEND, AND ABBREVIATIONS				
MECHANICAL ENGI C.C. JOHNSON & MAI 400 EAST PRATT ST	INEER LHOTRA, P.C. DWN BY: CCJM	REVIEWED BY:	APPROVED BY:	_	СПІБЕ		1 110		DRAW 2			
	CHKD BY: UNP	DATE REVIEWED:			SUBDIVISION	. T		8133 SANDPIPER CIRCLE ELECTION				

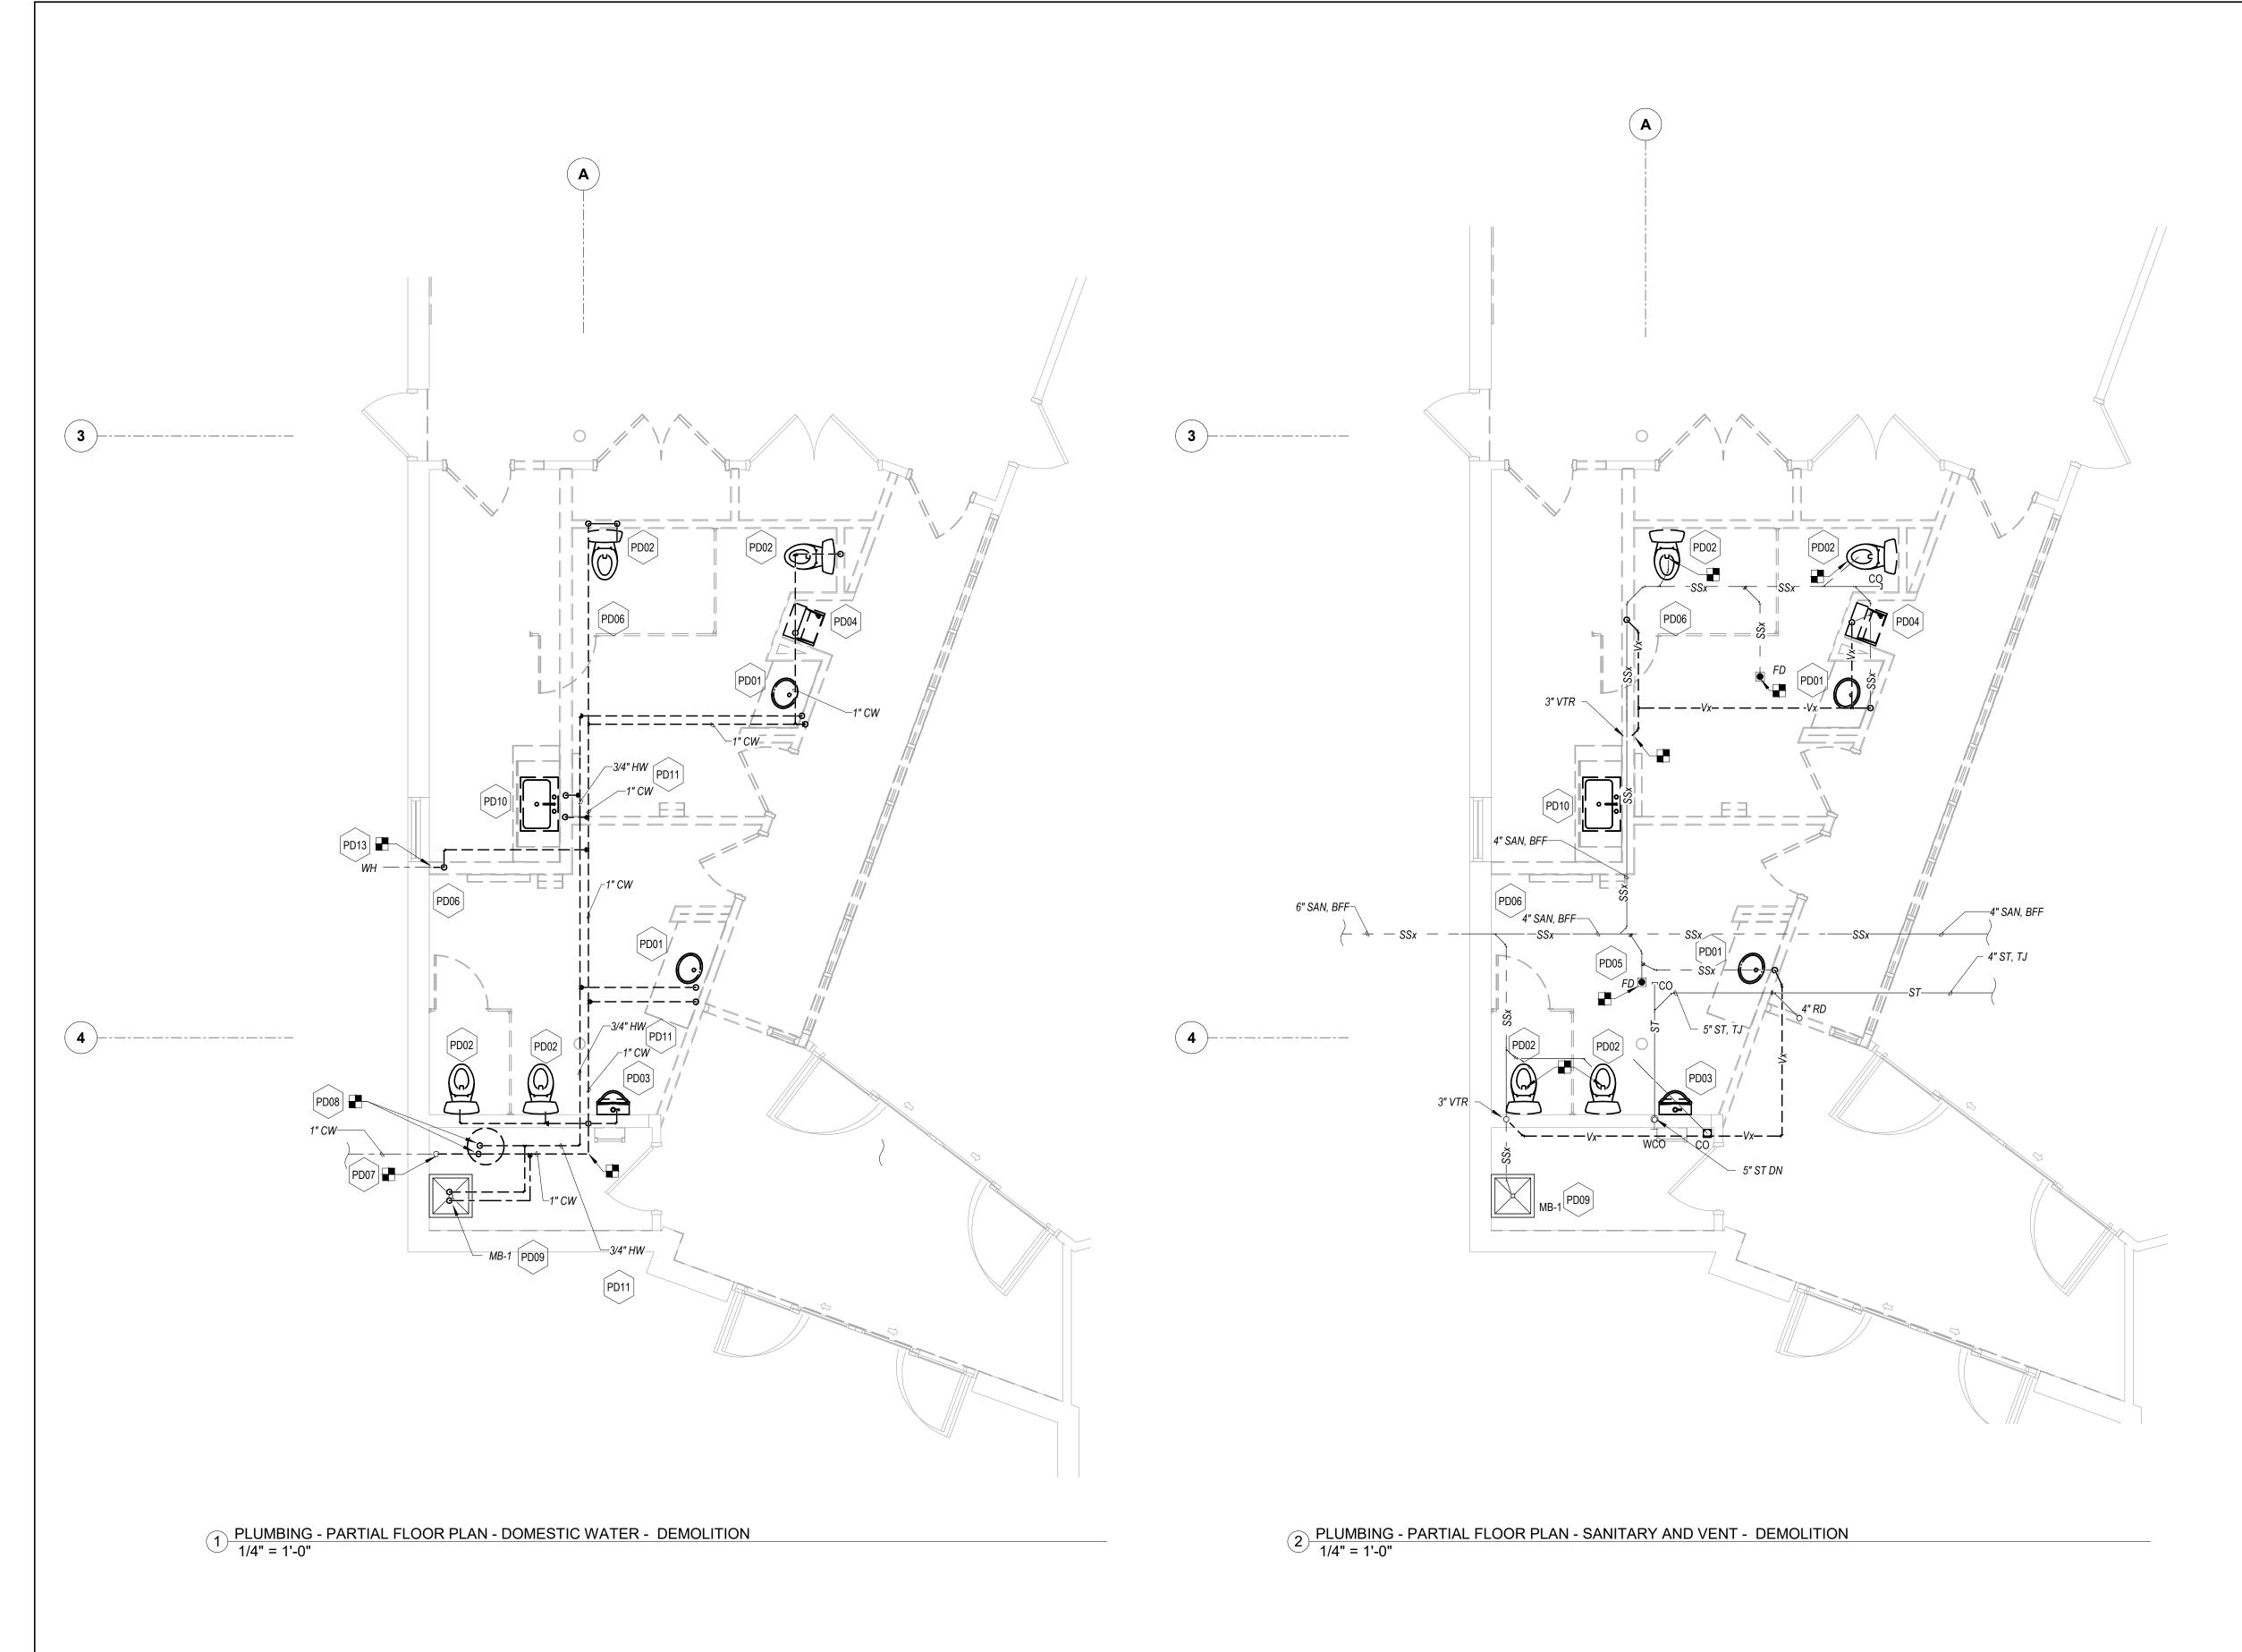

PLUMBING KEYED NOTES - DEMOLITION

NOTE# **NOTES**

- REMOVE WALL HUNG LAVATORY AND ALL ASSOCIATED SUPPORTS, ROUGH-INS, ACCESSORIES, HOT & COLD WATER, WASTE & VENT PIPING, ETC. IN THEIR ENTIRETY. DISCONNECT AND CAP-OFF EXISTING PIPING IN WALL/CEILING/FLOOR AT THE NEAREST MAIN PIPING WHERE NOT REUSED. DO NOT ABANDON UNUSED PORTION OF THE PIPING
- REMOVE FLOOR MOUNTED WATER CLOSET AND ALL ASSOCIATED SUPPORTS, ROUGH-INS, ACCESSORIES, COLD WATER, SANITARY & VENT PIPING, ETC. IN THEIR ENTIRETY. DISCONNECT AND CAP-OFF EXISTING PIPING IN WALL/CEILING/FLOOR AT THE NEAREST MAIN PIPING WHERE NOT REUSED. DO NOT ABANDON UNUSED PORTION OF THE PIPING.
- REMOVE WALL HUNG URINAL AND ALL ASSOCIATED SUPPORTS, ROUGH-INS, ACCESSORIES, COLD WATER, SANITARY & VENT PIPING, ETC. IN THEIR ENTIRETY. DISCONNECT AND CAP-OFF EXISTING PIPING IN WALL/CEILING/FLOOR AT THE NEAREST MAIN PIPING WHERE NOT REUSED. DO NOT ABANDON UNUSED PORTION OF THE PIPING.
- REMOVE DRINKING FOUNTAIN/WATER COOLER AND ALL ASSOCIATED SUPPORTS, ROUGH-INS, ACCESSORIES, COLD WATER, WASTE & VENT PIPING, ETC. IN THEIR ENTIRETY. DISCONNECT AND CAP-OFF EXISTING PIPING IN WALL/CEILING/FLOOR AT THE NEAREST MAIN PIPING WHERE NOT REUSED. DO NOT ABANDON UNUSED PORTION OF THE PIPING
- DISCONNECT AND REMOVE FLOOR DRAIN AND ALL ASSOCIATED SANITARY & VENT PIPING, ETC. IN THEIR ENTIRETY. DISCONNECT AND CAP-OFF EXISTING PIPING IN WALL/CEILING/FLOOR AT THE NEAREST BRANCH PIPING WHERE NOT REUSED. PATCH AND FINISH UNUSED FLOOR OPENING. DO NOT ABANDON UNUSED PORTION OF THE PIPING. REMOVE CLEANOUT COVERS AND FLOOR DRAIN STRAINERS AND PREPARE FOR NEW COVERS AND STRAINERS TO SUIT NEW FINISHES WITHIN RENOVATION PROJECT AREAS.
- DISCONNECT AND REMOVE ABOVEGROUND SANITARY/WASTE AND VENT PIPING IN THEIR ENTIRETY FROM THE POINT OF DISCONNECTION SHOWN. DISCONNECT AND CAP-OFF PIPING IN WALL/CEILING/FLOOR AT THE NEAREST BRANCH PIPING WHERE NOT REUSED. PATCH AND FINISH UNUSED FLOOR OPENING. DO NOT ABANDON UNUSED PORTION OF THE PIPING. PREPARE EXISTING PIPING FOR NEW CONNECTION AS SHOWN NEW WORK PLAN.
- DISCONNECT AND REMOVE THE COLD WATER SERVICE RISER ABOVE FLOOR AND ASSOCIATED SHUT-OFF VALVE AND HOSE END DRAIN.
- DISCONNECT AND REMOVE WATER HEATER AND ALL ASSOCIATED COLD AND HOT WATER PIPING, RELIEF DRAIN PIPING, ETC. IN THEIR ENTIRETY. EXISTING ELECTRIC WATER HEATER IS BRADFORD WHITE MODEL RE120U6-1NAL, 19 GALLON, 1.5 KW, 120V/1PH/60HZ. SALVAGE WATER HEATER FOR REINSTALLATION AT NEW LOCATION SHOWN ON NEW WORK PLAN.
- EXISTING MOP BASIN IN JANITOR S ROOM TO REMAIN. DICONNECT AND REMOVE COLD AND HOT WATER PIPING FROM THE FAUCET. EXISTING WASTE AND VENT TO REMAIN.
- REMOVE KITCHEN SINK AND ALL ASSOCIATED SUPPORTS, ROUGH-INS, ACCESSORIES. HOT & COLD WATER, WASTE & VENT PIPING, ETC. IN THEIR ENTIRETY. DISCONNECT AND CAP-OFF EXISTING PIPING IN WALL/CEILING/FLOOR AT THE NEAREST MAIN PIPING WHERE NOT REUSED. DO NOT ABANDON UNUSED PORTION OF THE PIPING.
- REMOVE CW AND HW PIPING SERVING PLUMBING FIXTURES BEING REMOVED IN THEIR ENTIRETY FROM THE POINT OF DISCONNECTION SHOWN. PREPARE EXISTING PIPING FOR NEW CONNECTION AS SHOWN NEW WORK PLAN. REMOVE AND REPLACE PIPING INSULATION OF ALL EXISTING DOMESTIC WATER PIPING OCCURRING ABOVE THE CEILING IN THE RESTROOMS AND MEETING ROOM BEING RENOVATED.
- DISCONNECT AND REMOVE 3/4" CW PIPING TO WALL HYDRANT. EXISTING WALL HYDRANT TO REMAIN. PREPARE PIPING FOR RECONNECTION.

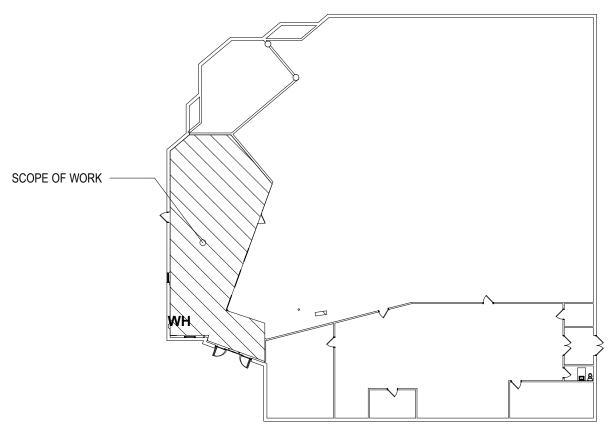

3 KEY PLAN 1" = 30'-0"

AS-BUILT / REVISION BY DATE P.W.A. NO. KEY SHEET POSITION SHT DRAWING SCALE PROFESSIONAL CERTIFICATION HEREBY CERTIFY THAT THESE DOCUMENTS WERE PREPARED OR BID/PERMIT SET PLAN SCALE: APPROVED BY ME, AND THAT I AM A DULY LICENSED PROFESSIONAL ENGINEER UNDER THE LAWS OF THE STATE OF R.O.W NO. BUREAU OF ENGINEERING AND CONSTRUCTION PROPERTY MANAGEMENT HIGHWAYS STRUCTURES STORM DRAINS SEWER WATER REVIEWED BY: PPROVED BY EAST PRATT STREET, SUITE 604 TIMORE, MD 21202 CHKD BY: UNP DATE REVIEWED:

BALTIMORE COUNTY OFFICE OF BUDGET AND FINANCE, PROPERTY MANAGEMENT


BCPL - White Marsh

PLUMBING - PARTIAL FLOOR PLAN - DEMOLITION


SUBDIVISION:


8133 SANDPIPER CIRCLE BALTIMORE, MD 21226

ELECTION DIST. NO.:

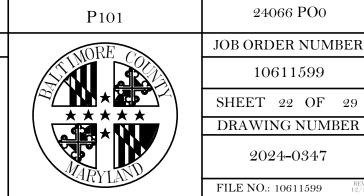

SHEET DESIGNATION

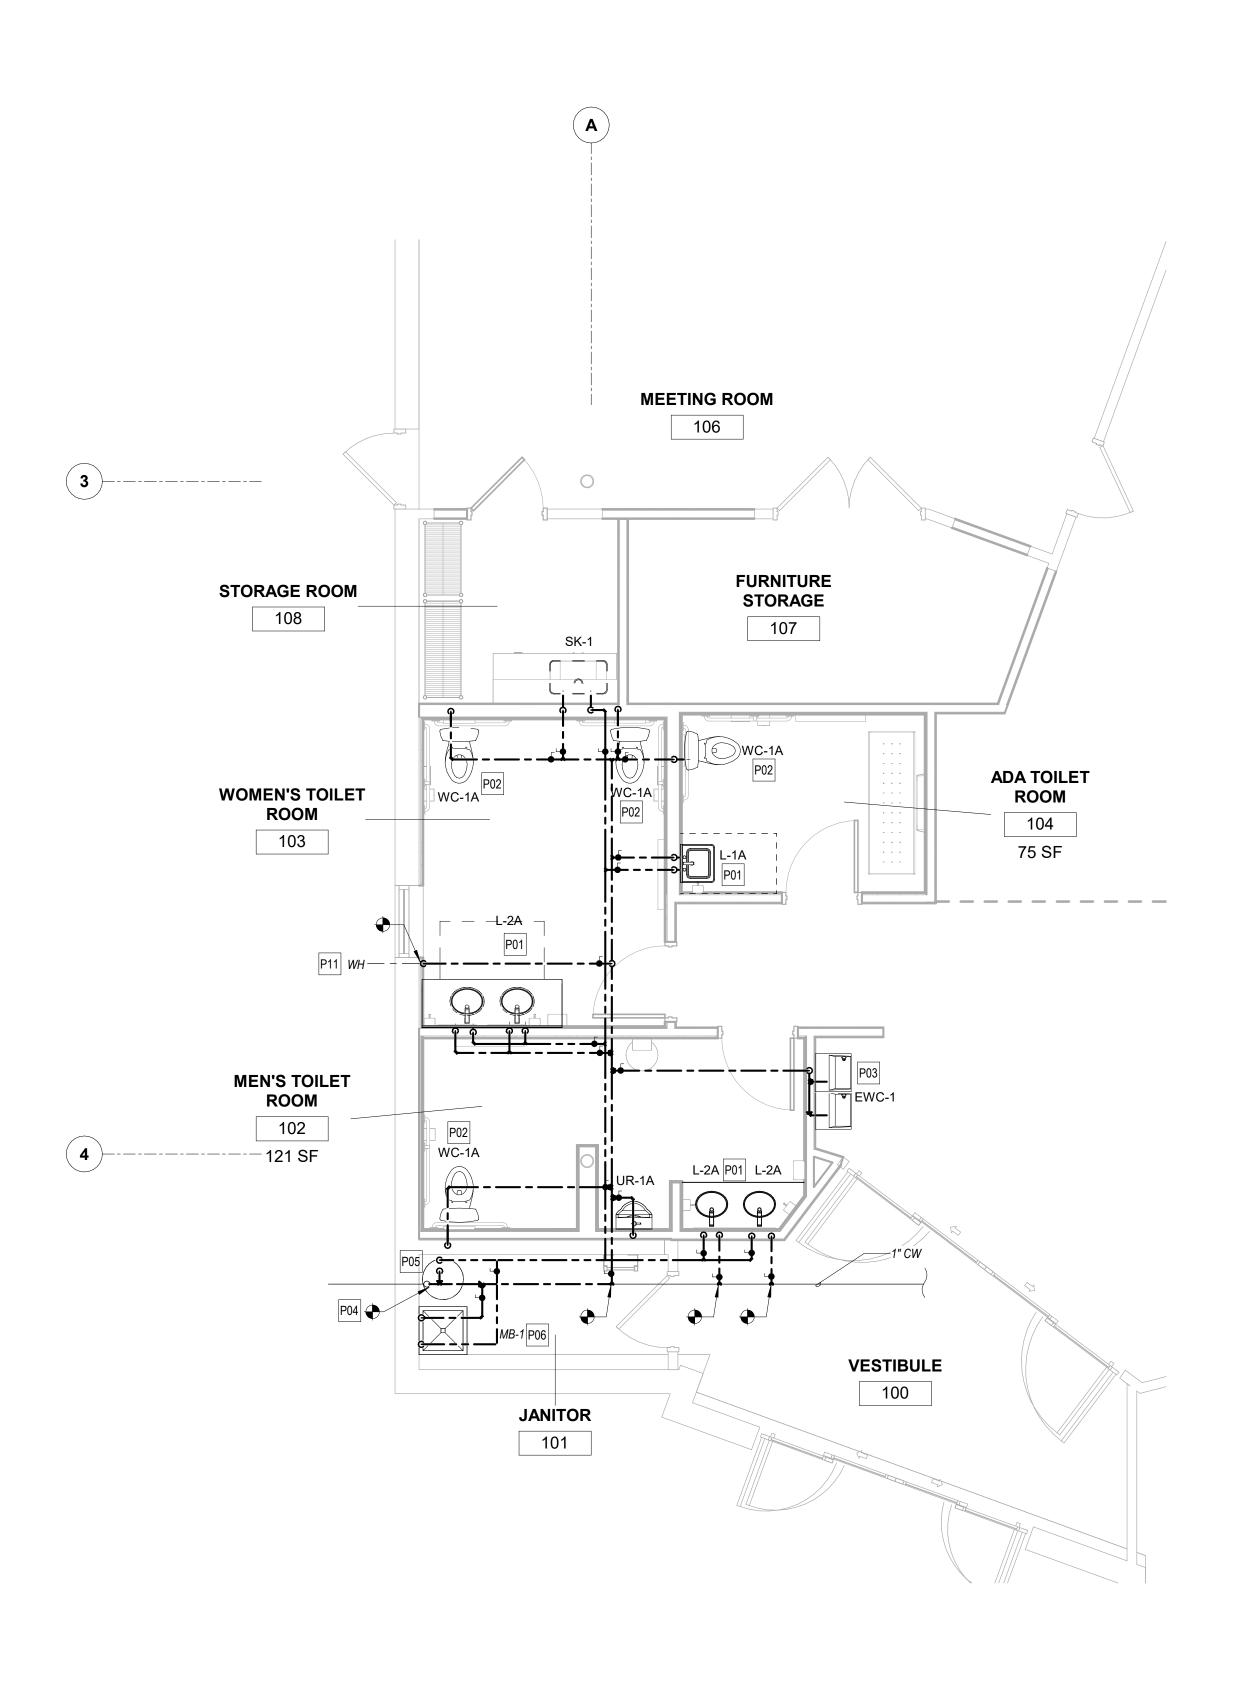

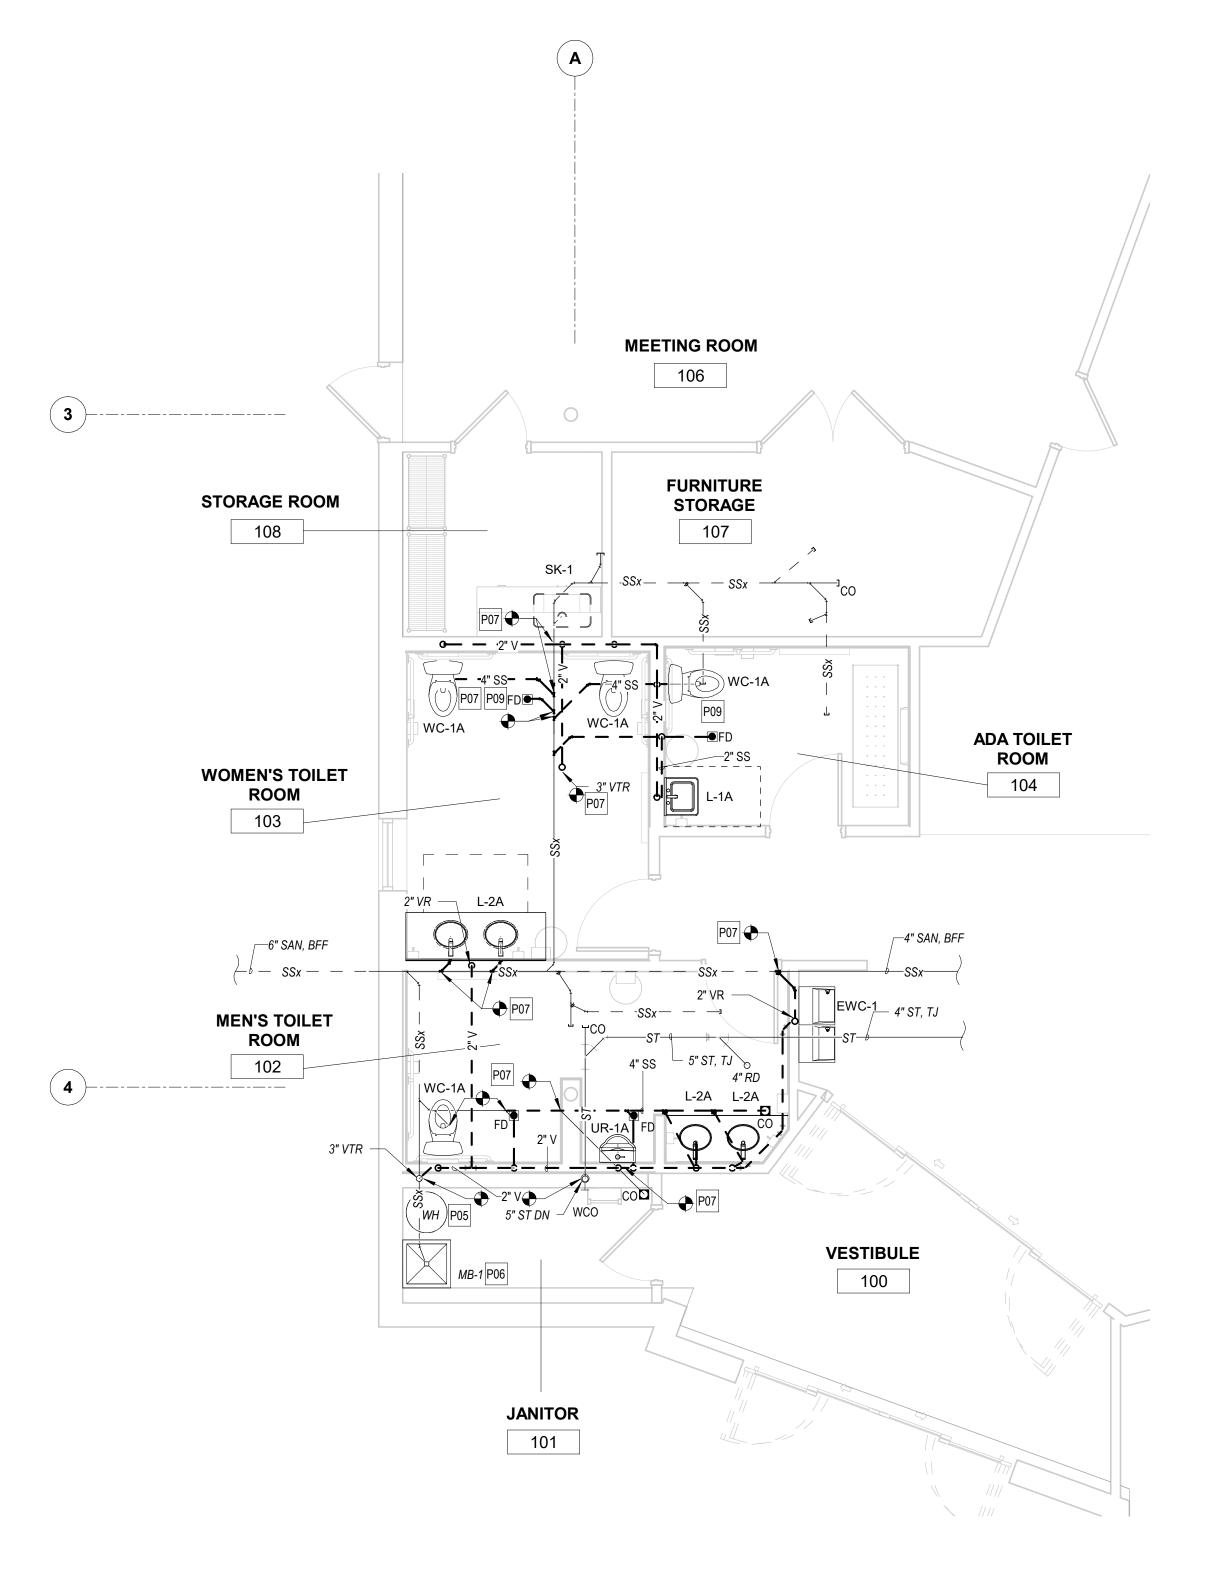

PLUMBING KEYED NOTES - NEW WORK

NOTE#	NOTES
701	PROVIDE 1/2" CW & HW, 2" WASTE AND 1-1/2" VENT PIPING FOR LAVATORY. CUT & PATCH WALL/FLOOR TO EXTEND NEW PIPING AND CONNECT TO EXISTING SANITARY PIPING BELOW FLOOR TO APPROPRIATE INVERT ELEVATION.
P02	PROVIDE 1" CW, 4" SANITARY AND 2" VENT PIPING FOR WATER CLOSET. CUT & PATCH WALL/FLOOR TO EXTEND NEW PIPING AND CONNECT TO EXISTING SANITARY PIPING BELOW FLOOR TO APPROPRIATE INVERT ELEVATION.
⊃03	PROVIDE 1/2" CW, 1-1/2" WASTE ABOVEGROUND, 2" WASTE BELOW GROUND AND 1-1/2" VENT PIPING FOR WATER COOLER. CUT & PATCH

WALL/FLOOR TO EXTEND NEW PIPING AND CONNECT TO EXISTING SANITARY PIPING BELOW FLOOR TO APPROPRIATE INVERT ELEVATION.

CONNECT NEW 1" CW TO EXISTING SERVICE RISER WITH SHUTOFF VALVE AND 1" REDUCED PRESSURE PRINCIPLE BACKFLOW PREVENTER IN THE RISER.

REINSTALL EXISTING WATER HEATER ON NEW 4" CONCRETE PAD AND DRAIN PAN. EXTEND CW AND HW WITH SHUTOFF VALVES IN EACH RISER. EXTEND RELIEF VALVE DRAIN TO MOP BASIN.

PROVIDE 3/4" CW & HW TO EXISTING MOP BASIN AND CONNECT TO EXISITNG FAUCET.

PROVIDE AND EXTEND CW & HW, WASTE, SANITARY, AND VENT PIPING TO THE EXTENT SHOWN. CONNECT NEW PIPING TO EXISTING PIPING OF SAME OR LARGER SIZE WHERE SHOWN. PROVIDE SHUT-OFF VALVES IN CW & HW BRANCH PIPING TO EACH RESTROOM. ROD, CLEAN, AND PREPARE EXISTING UNDERGROUND SANITARY PIPING FOR NEW CONNECTION AT APPROPRIATE INVERT ELEVATION. PROVIDE WATER HAMMER ARRESTER ON HW AND CW PIPING.

PROVIDE 3" FLOOR DRAIN AND ALL ASSOCIATED SANITARY & VENT PIPING, ETC. IN THEIR ENTIRETY. CUT & PATCH WALL/FLOOR TO EXTEND NEW WASTE/VENT PIPING AND CONNECT TO EXISTING SANITARY PIPING BELOW FLOOR TO APPROPRIATE INVERT ELEVATION. PROVIDE SQUARE, POLISHED NICKEL BRONZE CLEANOUT COVERS TO SUIT NEW FLOOR FINISHES WITHIN RENOVATED PROJECT AREAS.

EXTEND AND RECONNECT 3/4" CW PIPING FROM NEW 1" CW MAIN WITH SHUT-OFF VALVE TO EXISTING WALL HYDRANT.

SCOPE OF WORK

1 PLUMBING - PARTIAL FLOOR PLAN - DOMESTIC WATER - NEW WORK 1/4" = 1'-0"

2 PLUMBING - PARTIAL FLOOR PLAN - SANITARY AND VENT - NEW WORK 1/4" = 1'-0"

SUBDIVISION:

ELECTION DIST. NO.:

PROFESSIONAL CERTIFIC	CATION	AS-BUILT / REV	/ISION	BY	DATE	P.W.A. NO.	KEY SHEET	POSITION SHT	DRAWIN	G SCALE	
I HEREBY CERTIFY THAT THESE DOCUMENTS WERE PREPARED OR APPROVED BY ME, AND THAT I AM A DULY LICENSED PROFESSIONAL ENGINEER UNDER THE LAWS OF THE STATE OF MARYLAND. LICENSE NO. 22942 EXPIRATION DATE: 12-24-2024		BID/PERMIT SET			03.15.2024	-	-	-	PLAN SCALE:		APPROVED BY:
						R.O.W NO.	-	-	PROFILE SCALE:		DATE:
		BUREAU OF ENGINEERING				<u>-</u>	-	-		<u>-</u>	
UDAY PATEL, PE, LEED BD+C MECHANICAL ENGINEER	DGN BY: CCJM	AND CONSTRUCTION		HIGH	WAYS	STRUCTURES	STORM DRAINS	SEWER	WATER	FIELD ENGINEER	PROPERTY MANAGEMENT
C.C. JOHNSON & MALHOTRA, P.C. 400 EAST PRATT STREET, SUITE 604 BALTIMORE, MD 21202 (P) 410-461-9920	DWN BY: CCJM	REVIEWED BY:									APPROVED BY: CHIEF
	CHKD BY: UNP	DATE REVIEWED:									DATE:

BALTIMORE COUNTY OFFICE OF BUDGET AND FINANCE, PROPERTY MANAGEMENT

BCPL - White Marsh

PLUMBING - PARTIAL FLOOR PLAN - NEW WORK

8133 SANDPIPER CIRCLE BALTIMORE, MD 21226

JOB ORDER NUMBER DRAWING NUMBER


SHEET DESIGNATION | CONTRACT NUMBER

24066 PO0


10611599

SHEET 23 OF 29

2024-0348

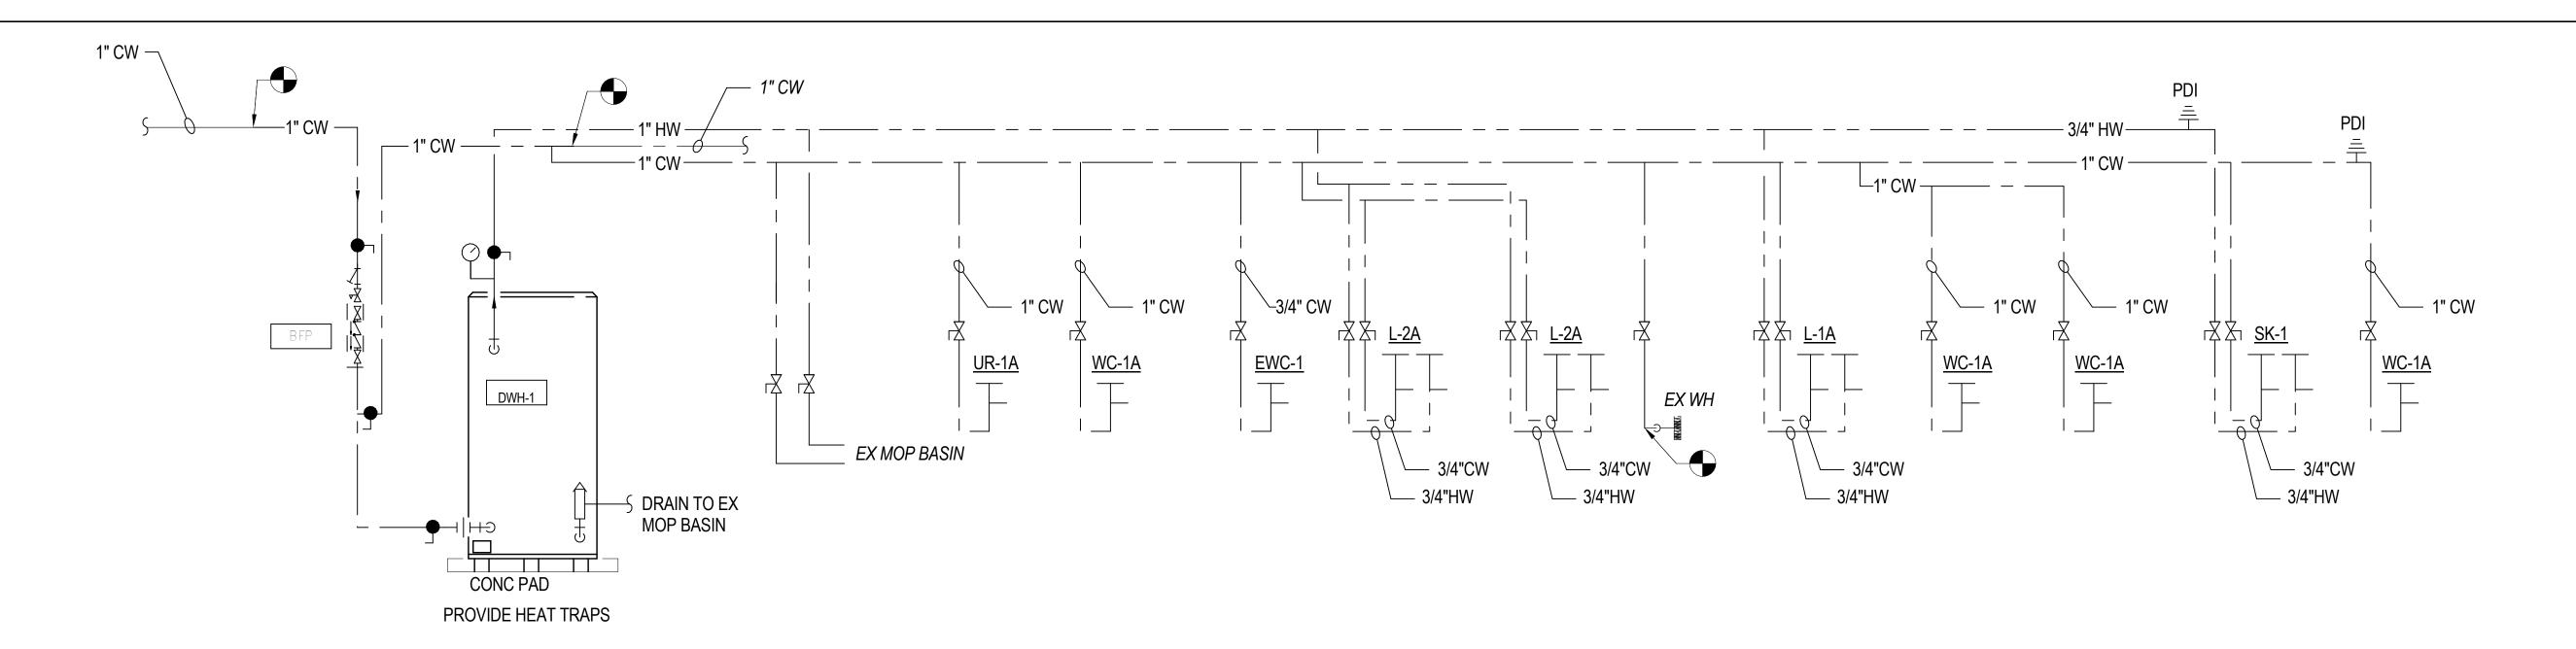


1 DOMESTIC WATER RISER DIAGRAM SCALE: NONE

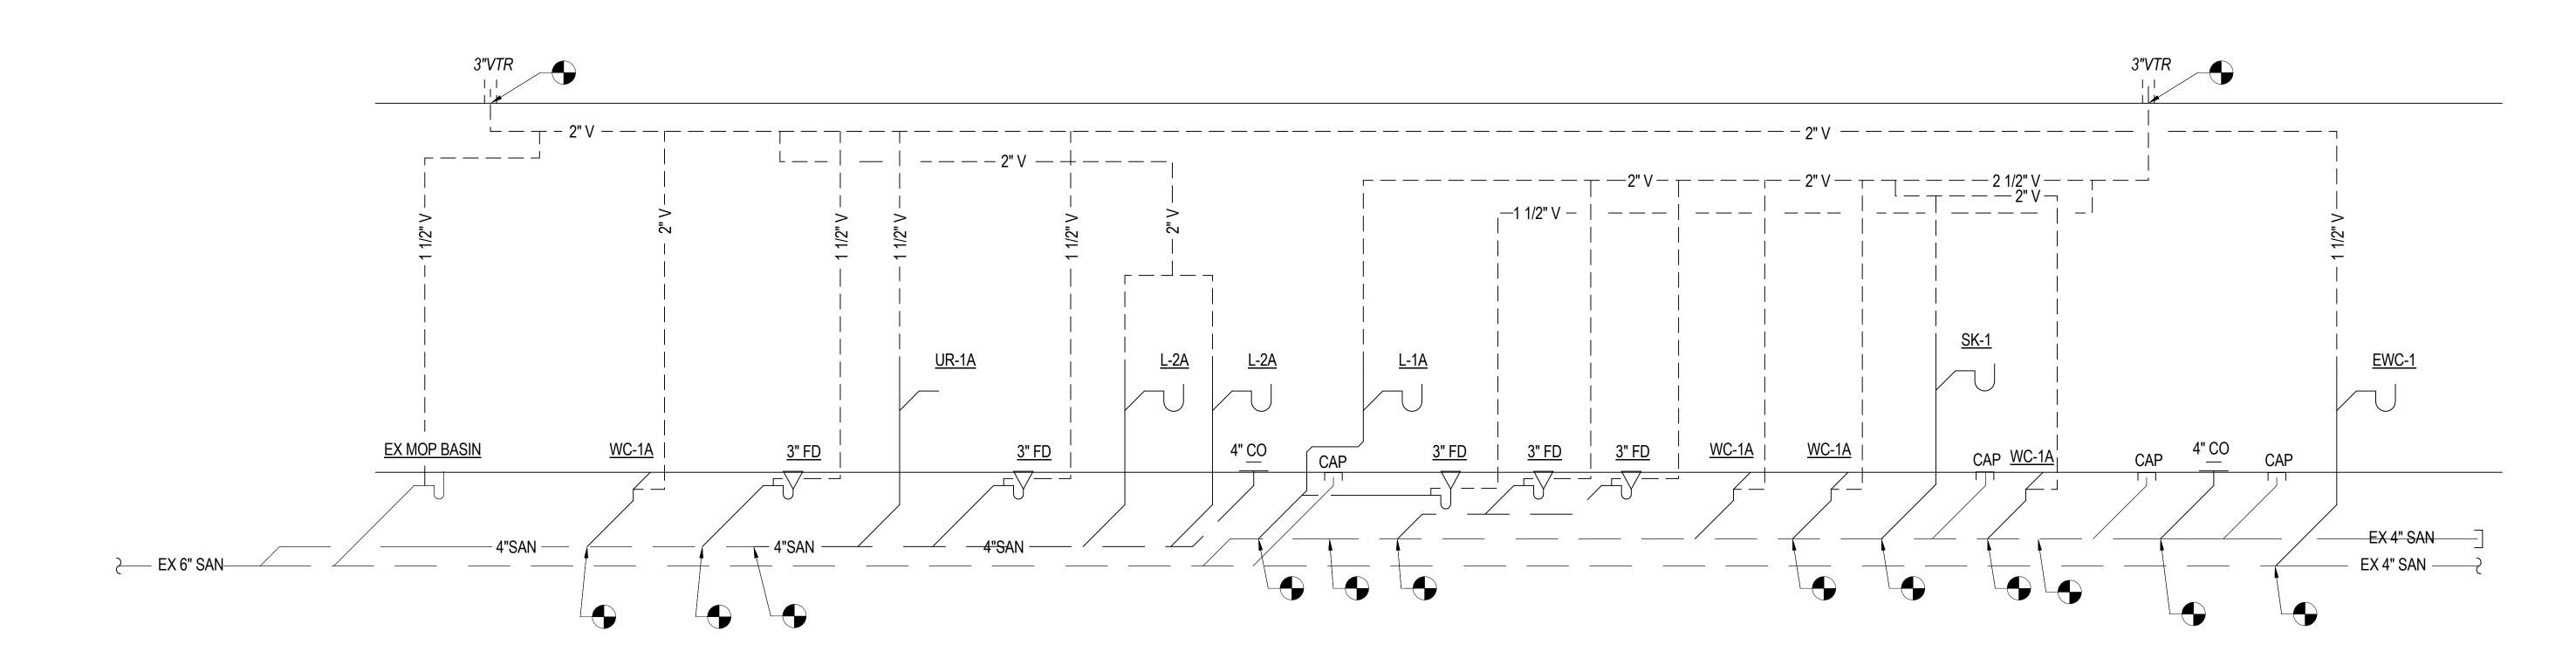

2 SANITARY RISER DIAGRAM SCALE: NONE

														SHEET DESIGNATION	CONTRACT NUMBER
SEAL SEAL	PROFESSIONAL CERTIFI	ICATION	AS-BUILT / REVISION	BY DATE	P.W.A. NO.	KEY SHEET	POSITION SHT	DRAWIN	G SCALE					P501	24066 PO0
JAK ARRIVA	I HEREBY CERTIFY THAT THESE DOCUMENTS	S WERE PREPARED OR CENSED	BID/PERMIT SET	03.15.2024	-	-	-	PLAN SCALE:	3/16" = 1'-0"	APPROVED BY:		BALTIMORE COUNTY OFFICE OF BUDGET AND FINANCE, PROPERTY MANAGEMENT		JORE CO	JOB ORDER NUMBER
	PROFESSIONAL ENGINEER UNDER THE LAWS (R.O.W NO.		-	DD ODIN D GGAN D	-	DIRECTOR				NORE CO	10611599
	LICENSE NO. 22942 EXPIRATION D	DATE: 12-24-2024			-	-	-	PROFILE SCALE:	-	DATE:		BCPL - White Marsh			SHEET 24 OF 29
	ENGINEER:UDAY PATEL, PE, LEED BD+C	DGN BY: CCJM	BUREAU OF ENGINEERING AND CONSTRUCTION	HIGHWAYS	STRUCTURES	STORM DRAINS	SEWER	WATER	FIELD ENGINEER	PROPERTY MANAGEMENT		PLUMBING RISER DIAGRAM		 	DRAWING NUMBER
I SONAL PROMISE	C.C. JOHNSON & MALHOTRA, P.C. 400 EAST PRATT STREET, SUITE 604	DWN BY: <u>CCJM</u>	REVIEWED BY:							APPROVED BY:				***	2024-0349
DATE : 03/11/2024	400 EAST PRATT STREET, SUITE 604 BALTIMORE, MD 21202 (P) 410-461-9920	CHKD BY: UNP	DATE REVIEWED:							DATE: SUBI	DIVISION:	8133 SANDPIPER CIRCLE BALTIMORE, MD 21226 ELECT	ΓΙΟΝ DIST. NO.:	MRYLAND	FILE NO.: 10611599 REV. 12/15

ELECTRICAL, COMMUNICATION, ELECTRONIC SAFETY AND SPECIAL SYSTEMS LEGEND

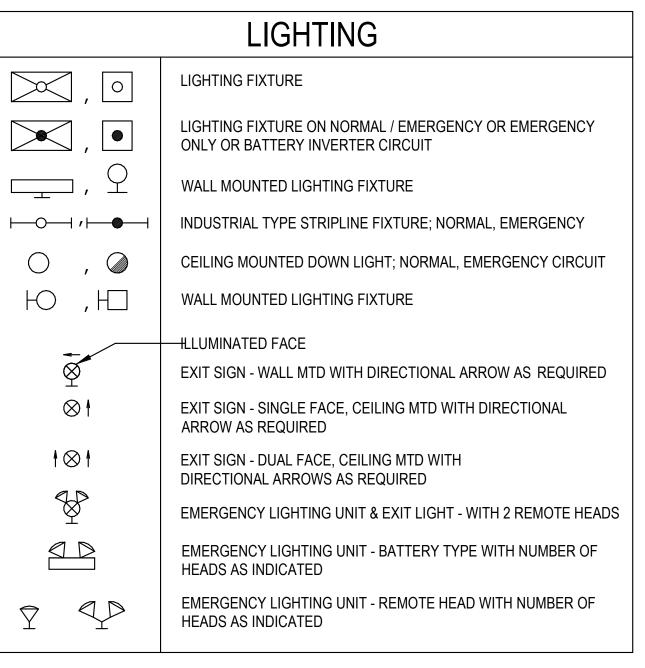


	FIRE ALARM DEVICES											
P	MANUAL PULL STATION - DUAL ACTION TYPE											
	HORN - WALL MTD (OR "C"-CEILING)											
X	STROBE - WALL MTD (OR "C"-CEILING)											
	COMBINATION HORN WITH STROBE - WALL MTD (OR "C"-CEILING)											
	FIRE ALARM SYSTEM HEAT DETECTOR											
?	FIRE ALARM SYSTEM SMOKE DETECTOR											

MOUNTING HEIGHTS

NOTE: UNLESS OTHERWISE INDICATED, STANDARD MOUNTING HEIGHTS FOR OUTLET BOXES FOR THE FOLLOWING EQUIPMENT/DEVICE SHALL BE ABOVE FINISHED FLOOR AND SHALL BE TO THE CENTER LINE OF EQUIPMENT & FIELD COORDINATED.

EQUIPMENT/DEVICE MOUNTING HEIGHT

SWITCHES 48 INCH RECEPTACLE-GENERAL 18 INCH RECEPTACLE-SPECIAL 18 INCH RECEPTACLE-SINGLE 18 INCH RECEPTACLE-REST ROOM 9 INCH ABOVE BASIN RECEPTACLE-COUNTER 8 INCH ABOVE COUNTER RECEPTACLE- MONITOR (DISPLAY) 78 INCH OR DIRECTED BY OWNER RECEPTACLE-EXTERIOR 30 INCH CABLE TV OUTLET 78 INCH, 18 INCH FOR APARTMENTS, UON TELEPHONE/DATA-GENERAL TELEPHONE-WALL TYPE 54 INCH, (48 INCH ADA ACCESSIBLE) 48 INCH FIRE ALARM PULL STATION FIRE ALARM AUDIO/VISUAL DEVICE 80 INCH CARD READER 40 INCH MAX. 90 INCH EXIT LIGHT WALL MOUNTED 72 INCH TO HANDLE SAFETY SWITCH PANELBOARD 72 INCH TO TOP CB 48 INCH MANUAL MOTOR STARTER 48 INCH **PUSH BUTTON** AUTOMATIC DOOR OPENER 36 INCH APARTMENT UNITS 48 INCH TELEPHONE/DATA, KITCHEN ONLY 48 INCH REFRIGERATOR RECEPTACLE WASHER/DRYER RECEPTACLE 36 INCH

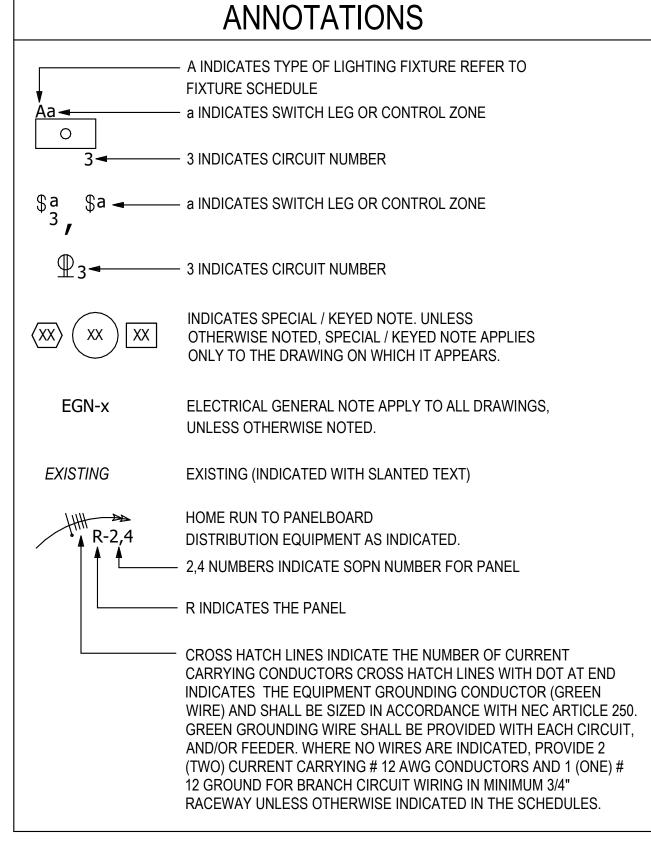

	SWITCHING SYMBOLS
\$	SINGLE POLE SWITCH
\$3	THREE WAY SWITCH
\$ M	MANUAL MOTOR STARTER WITH THERMAL OVERLOAD AND HOA SWITCH
$\LV	LOW VOLTAGE SWITCH
\S^D	LOW VOLTAGE DIMMER
(OS)	OCCUPANCY SENSOR
VS	VACANCY SENSOR
PS	PHOTO SENSOR
PP	POWER PACK

WIRING NOTES

BRANCH CIRCUIT WIRING FOR 120 VOLT 20 AMP CIRCUITS WIRED TO 208Y/120V SYSTEMS SHALL BE ADJUSTED FOR DISTANCE VOLTAGE DROP AND LOAD HARMONIC CONTENTS AS FOLLOWS:

GENERAL RECEPTACLES AND RESISTIVE LOADS: UP TO 100 FEET IN LENGTH: 3#12, 1#12N, 1#12G - 3/4"C OVER 100 FEET IN LENGTH: 3#10, 1#10N, 1#10G - 3/4"C COMPUTER RECEPTACLES, LED LIGHTING: UP TO 100 FEET IN LENGTH: 3#12, 1#10N, 1#12G - 3/4"C

B. ALL WORK IS NEW, UNLESS NOTED OTHERWISE

ALL CONDUIT SHALL BE 3/4" MINIMUM. ALL CONDUCTORS SHALL BE #12 THHN, MINIMUM.

OVER 100 FEET IN LENGTH: 3#10, 1#8N, 1#10G - 3/4"C

	POWER DISTRIBUTION
	PANELBOARD - SURFACE MTD
	PANELBOARD - RECESSED
J , ①	JUNCTION BOX
D _D ,O _D	JUNCTION BOX FOR SYSTEM FURNITURE DATA - 18" AFF
	CIRCUIT BREAKER
	MOTOR CONNECTION
	SAFETY SWITCH NONFUSED, SIZE AS INDICATED
Εh	SAFETY SWITCH FUSED, SIZE AS INDICATED
	ELECTRICAL DEVICE AS INDICATED
⊠h	COMBINATION TYPE MOTOR STARTER, SIZE AS INDICATED
	CONDUIT, CONCEALED IN CEILING OR WALL OR CHASE
	CONDUIT CONCEALED IN FLOOR OR UNDERFLOOR OR UNDERGROUND
— II	SYSTEM GROUND OR EQUIPMENT GROUND
_	208 VOLT PANELBOARD
	480 VOLT PANELBOARD
	MEDIA CENTER

	WIRING DEVICES
Ф	DUPLEX RECEPTACLE
	DUPLEX RECEPTACLE - FLUSH MOUNTED FLOOR BOX
**	TWO DUPLEX RECEPTACLE IN TWO-GANG BOX
•	SWITCH DUPLEX RECEPTACLE CIRCUIT
approx	SPECIAL RECEPTACLE, SIZE AND TYPE AS NOTED
\oplus^{WP}	GFCI WP RECEPTACLE WITH IN-USE BUBBLE COVER
ФGFCI	DUPLEX RECEPTACLE WITH GROUND FAULT CIRCUIT
Φ^{EM}	RECEPTACLE - EMERGENCY POWER
Φ_{C}	DUPLEX RECEPTACLE - CEILING
ФUSВ	DUPLEX RECEPTACLE WITH (2) UNIVERSAL SERIAL BUS PORTS
\bigoplus IG	DUPLEX RECEPTACLE ISOLATED GROUND - 20A, 2P, 3W, 120V
⊕GFCI	DUPLEX RECEPTACLE WITH GROUND FAULT CIRCUIT MOUNTED OVER COUNTER OR SINK. SEE MOUNTING HEIGHTS TABLE FOR ADDITIONAL DETAILS
\bigvee	DATA OUTLET. COORDINATE TYPE WITH OWNER IT DEPARTMENT.

SUBDIVISION:

	ABBRE\	/IATIO	NS
ABBREV	DESCRIPTION	ABBREV	DESCRIPTION
AS/AF	AMPERES SWITCH & FUSE RATING	HTR	HEATER
A, AMP	AMPERES	HV	HIGH VOLTAGE
AC	ALTERNATING CURRENT, ARMORED CABLE	MDP	MAIN DISTRIBUTION PANEL
ACU	AIR CONDITIONING UNIT	MTD	MOUNTED
AF	AMPERE FRAME	MLO	MAIN LUGS ONLY
AFF AFG	ABOVE FINISHED FLOOR ABOVE FINISHED GRADE	MTG N	MOUNTING NEUTRAL
AFG AHU	ABOVE FINISHED GRADE AIR HANDLING UNIT	NEC	NATIONAL ELECTRICAL CODE
AIC	AMPERE INTERRUPTING CAPACITY	NIC	NOT-IN-CONTRACT
ATC	AUTOMATIC TEMPERATURE CONTROL	NL	NIGHT LIGHT
ATS	AUTOMATIC TRANSFER SWITCH	NO	NORMALLY OPEN
AUX	AUXILIARY	NTS	NOT TO SCALE
AWG	AMERICAN WIRE GAUGE	NFSS	NON FUSED SAFETY SWITCH
BES	BLDG ELECTRICAL SYSTEM	OC OL	ON CENTER OVERLOAD
	BASIC IMPLUSE LEVEL	P	POLE OR POLES
BLDG	BUILDING	l ' PF	POWER FACTOR
BKBD	BACKBOARD	РН, ф	PHASE
BRKR C	BREAKER CONDUIT	VT	POTENTIAL TRANSFORMER
_	CHICAGO ELECTRICAL CODE	PNL	PANELBOARD
CB	CIRCUIT BREAKER	PVC	POLYVINYL CHLORIDE
	CLOSED CIRCUIT TELEVISION	R	REMOVE
CKT	CIRCUIT	RAF	RETURN AIR FAN
CR	CARD READER	RECEPT	RECEPTACLE
CL	CURRENT LIMITING	REQD	REQUIRED
	CEILING	RGS	RIGID GALVANIZED STEEL
CPT	CONTROL POWER TRANSFORMER	RMS RS	ROOT MEAN SQUARE RAPID START
	CURRENT TRANSFORMER	RVAT	REDUCED VOLTAGE AUTOTRANSFORMER
CUH	CABINET UNIT HEATER	S/N	SOLID NEUTRAL
CW DGS	COOL WHITE DIESEL GENERATOR SET	SD	SMOKE DETECTOR
DIA	DIAMETER	SEC	SECONDARY
	DISCONNECT	SFA	SPRINKLER FLOW ALARM
	DISTRIBUTION	SMR	SURFACE METAL RACEWAY
DN	DOWN	ST	SHUNT TRIP
DP	DISTRIBUTION PANEL	SS	SUB STATION
DVR	DIGITAL VIDEO RECORDER	STR	STARTER
DWG	DRAWING	SW SWBD	SWITCH SWITCHBOARD
	EMERGENCY	SWGR	SWITCHGEAR
	ELECTRIC BASEBOARD HEATER	SYS	SYSTEM
	EMPTY CONDUIT	SYM	SYMMETRICAL
	ENCLOSED CIRCUIT BREAKER EXHAUST FAN	SOPN	SPACE OR POLE NUMBER
	ELECTRIC GENERATOR SET	TA	TRIP AMPERE
	ELECTRIC HEATER	ТВ	TERMINAL BOX
	ELECTRICAL	TC	TIME CLOCK
EMT	ELECTRICAL METALLIC TUBING	TD	TIME DELAY
ENCL	ENCLOSURE	TTB	TELEPHONE TERMINAL BOARD/BLOCK
	EQUIPMENT	TTC TYP	TELEPHONE TERMINAL CLOSET TYPICAL
	EXISTING RELOCATED	TV	TELEVISION
	EXISTING-TO-REMAIN	UC	UNDER COUNTER
	EXISTING	UG	UNDERGROUND
	EXHAUST	UOI	UNLESS OTHERWISE INDICATED
	FUSED OR FUSIBLE FRAME AMPERE	UON	UNLESS OTHERWISE NOTED
	FRAME AMPERE FIRE ALARM ANNUNCIATOR PANEL	USB	UNIVERSAL SERIAL BUS
	FIRE ALARM CONTROL PANEL	V	VOLT (S) OR VOLTAGE
	FIRE ALARM AND DETECTION SYSTEM	VA	VOLT AMPERE
	FURNISHED BY OTHERS	VFD	VARIABLE FREQUENCY DRIVE
FDR	FEEDER	W	WIRE
	FLUORESCENT	W/	WITH
	FUSED SAFETY SWITCH	WP WW	WEATHER PROOF, WORK PHONE WIREWAY
	FOOT OR FEET		
	FULL VOLTAGE NON REVERSING	XFMR @	TRANSFORMER AT
GFCI GND	GROUND FAULT CURRENT INTERRUPTER GROUND		,
	GALVANIZED RIGID STEEL		
GW	GROUND WIRE		
_	HANDICAP		
-	HEAVY DUTY		
	HIGH INTENSIFY DISCHARGE		
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	ENGINEER: TA CHIH LIN, PE	DGN BY: CCJM	BUREAU OF ENGINEERING AND CONSTRUCTION		HIGH	IWAYS	STRUCTURES	STORM DRAINS	SEWER	WATER	FIELD ENGINEER	PROF	PERTY MANAGEN	ИENT
	ELECTRICAL ENGINEER C.C. JOHNSON & MALHOTRA, P.C. 400 EAST PRATT STREET, SUITE 604	DWN BY: CCJM	REVIEWED BY:									APPROVED BY	:	CHI
	DAYER CORP. MO	CHKD BY: UNP	DATE REVIEWED:									DATE:		

BALTIMORE COUNTY OFFICE OF BUDGET AND FINANCE, PROPERTY MANAGEMENT

HP HORSE POWER


HPS | HIGH PRESSURE SODIUM

BCPL - White Marsh

ELECTRICAL - LEGEND AND ABBREVIATION

8133 SANDPIPER CIRCLE BALTIMORE, MD 21226

ELECTION DIST. NO.:

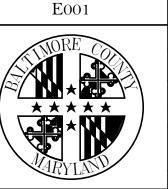

SHEET DESIGNATION

JOB ORDER NUMBER SHEET 25 OF 29 DRAWING NUMBER

ALL DRAWINGS ARE PROTECTED BY FEDERAL COPYRIGHT BY C.C. JOHNSON & MALHOTRA, P.C. AND CAN NOT BE REPRODUCED OR MODIFIED IN ANY MANNER WITHOUT EXPRESS WRITTEN PERMISSION BY C.C. JOHNSON & MALHOTRA, P.C.

CONTRACT NUMBER

24066 PO0

10611599

2024-0350

FILE NO.: 10611599

GENERAL ELECTRICAL NOTES (APPLIES TO ALL ELECTRICAL WORK)

- ALL DOCUMENTS AND PUBLICATIONS (SUCH AS, BUT NOT LIMITED TO, MANUALS, HANDBOOKS, CODES, STANDARDS AND SPECIFICATIONS) WHICH ARE CITED IN THIS CONTRACT OR THE SPECIFICATIONS INCORPORATED HEREIN, FOR THE PURPOSE OF ESTABLISHING REQUIREMENTS APPLICABLE TO EQUIPMENT, MATERIALS OR WORKMANSHIP UNDER THIS CONTRACT SHALL BE DEEMED TO BE INCORPORATED HEREIN AS FULLY AS IF PRINTED AND BOUND WITH THIS CONTRACT. WHEREVER REFERENCE IS MADE TO ANY SUCH DOCUMENT, THE CONTRACTOR SHALL COMPLY WITH THE REQUIREMENTS SET OUT IN THE EDITION SPECIFIED IN THIS CONTRACT, OR IF NOT SPECIFIED. THE LATEST EDITION OR REVISION THEREOF, AS WELL AS THE LATEST AMENDMENT OR SUPPLEMENT OR SUPPLEMENT THERETO, EXCEPT AS MODIFIED BY, OR OTHERWISE PROVIDED IN THE SPECIFICATIONS OR THIS CONTRACT.
- CONTRACTOR SHALL COORDINATE THE WORK WITH EXISTING FIELD CONDITIONS & THE WORK OF OTHER TRADES. UNRESOLVABLE CONFLICTS OR INTERFERENCES SHALL BE BROUGHT TO THE IMMEDIATE ATTENTION OF THE ARCHITECT/ENGINEER AND OWNER.
- ALL AUXILIARY ELECTRICAL COMPONENTS, OR CONTROL & POWER WIRING. REQUIRED TO ENSURE THE FUNCTIONALITY OF THE ITEMS SHOWN ON THE DRAWINGS SHALL BE PROVIDED. EVEN IF NOT SPECIFICALLY SHOWN ON THE DRAWINGS. THIS INCLUDES SUCH ITEMS AS LOW VOLTAGE CONTROL POWER AND WIRING TO REMOTE MOUNTED INTERLOCK DEVICES. CONTRACTOR SHALL CONSULT ALL TRADES FURNISHING EQUIPMENT & OBTAIN FROM THEM ALL DATA AND INSTALLATION INSTRUCTIONS TO ENSURE THAT ALL ELECTRICAL REQUIREMENTS ARE INCLUDED.
- DRAWINGS ARE DIAGRAMMATIC AND DO NOT SHOW ALL OF THE RACEWAY, BOXES, PENETRATIONS, SUPPORTS AND OTHER COMPONENTS THAT ARE REQUIRED TO COMPLETE THE WORK. ONLY MAJOR ITEMS ARE SHOWN ON THE DRAWINGS. PROVIDE ALL WORK AS REQUIRED FOR A COMPLETE AND FULLY FUNCTIONAL ELECTRICAL SYSTEM.
- EQUIPMENT MANUFACTURER'S WRITTEN INSTALLATION INSTRUCTIONS AND ALL LABELS AND WARNINGS AFFIXED TO THE INSTALLED EQUIPMENT SHALL BE STRICTLY ADHERED TO.
- ALL WORK SHALL BE DONE IN ACCORDANCE WITH THE LATEST REQUIREMENTS OF ALL APPLICABLE CODES & REGULATIONS.
- CONDUCTOR SIZING, BREAKER TRIP RATINGS AND FUSE SIZES FOR MECHANICAL EQUIPMENT FEEDERS AS SHOWN ON THE DRAWINGS ARE BASED ON PRELIMINARY DESIGN INFORMATION. CONTRACTOR SHALL VERIFY THE PROPER SIZING AND RATINGS FROM THE FURNISHED EQUIPMENT WRITTEN DATA OR EQUIPMENT NAMEPLATES PRIOR TO ROUGH IN. IMMEDIATELY ADVISE THE ARCHITECT/ENGINEER AND OWNER OF ANY DISCREPANCIES.
- PROVIDE EQUIPMENT DISCONNECT SWITCHES IN STRICT COMPLIANCE WITH CODE REQUIREMENTS. (NOT ALL LOCAL DISCONNECT SWITCHES ARE SHOWN)
- ALL OUTLET BOXES SHALL BE PROVIDED WITH PROPER COVER PLATES.
- 10. IN AREAS WHERE COUNTERS ARE PROVIDED, COORDINATE EXACT LOCATION OF OUTLETS AND WIRING WITH CASEWORK.
- 11. CONDUITS SHALL BE CONCEALED IN WALLS AND CEILINGS TO THE GREATEST EXTENT POSSIBLE. INTERIOR SURFACE METAL RACEWAY (WIREMOLD OR EQUAL) MAY BE USED FOR LIGHTING FIXTURES OR WIRING DEVICES LOCATED ON INACCESSIBLE BUILDING ELEMENTS. SUCH AS CONCRETE CEILINGS OR MASONRY WALLS. SURFACE METAL RACEWAY SHALL BE MOUNTED TIGHT TO WALLS OR CEILINGS. LOCATION AND ROUTING SHALL BE APPROVED BY ARCHITECT AND OWNER. SEE TECHNICAL SPECIFICATION FOR FURTHER INFORMATION.
- 12. ALL OUTDOOR RECEPTACLES SHALL BE WEATHERPROOF (W.P.)AND THE GFI TYPE.
- 13. ALL OUTDOOR ENCLOSURES SHALL BE NEMA 3R. THE PADLOCKED TYPE WITH TAMPER PROOF SCREWS.
- 14. THE CONTRACTOR SHALL PROVIDE ALL LABOR AND MATERIALS NECESSARY FOR A COMPLETE AND FUNCTIONING ELECTRICAL
- ALL MATERIALS AND EQUIPMENT SHALL BE ERECTED. INSTALLED. CONNECTED, CLEANED, ADJUSTED, TESTED, CONDITIONED, AND PLACED IN SERVICE IN ACCORDANCE WITH THE MANUFACTURER'S DIRECTIONS AND RECOMMENDATIONS.
- 16. CONDUIT RUNS OR PULL BOXES SHALL NOT BLOCK OR PREVENT FULL COMPLETE ACCESS AND/OR OPERATION OF HVAC EQUIPMENT, ACCESS DOORS, PIPING VAULTS, JUNCTION BOXES MAIN RETURN AIR DUCTS, PULL BOXES, CLEANOUTS, ETC.

- VERIFY CLEARANCES FOR ALL NEW ELECTRICAL WORK BEFORE PROCEEDING WITH CONSTRUCTION. COORDINATE USAGE OF AVAILABLE SPACE WITH ALL TRADES. IN THE EVENT OF CONFLICTS, NOTIFY THE ARCHITECT/ENGINEER AND OWNER BEFORE PROCEEDING WITH THE WORK.
- 18. SEAL ALL NEW WALL AND FLOOR CONDUIT PENETRATIONS.
- CIRCUITS ARE SIZED ASSUMING THAT NO MORE THAN THREE CURRENT CARRYING CONDUCTORS ARE IN A SINGLE CONDUIT. FOR CONDUITS CONTAINING MORE THAN THREE. PROVIDE APPROPRIATE DERATING OF CONDUCTORS PER CODE.
- NUMBERED CIRCUITS ARE CREATED FOR THE CONVENIENCE OF DESIGN ONLY. DESIGN INTENT MUST BE FOLLOWED THROUGHOUT, INDICATE THE CIRCUIT NUMBERS AND CORRESPONDING ROOM NUMBERS USED ON THE "AS-BUILT" DRAWINGS. EMERGENCY PANEL CIRCUIT NUMBERS MAY VARY, ACTUAL FIELD CONDITIONS SHALL BE VERIFIED.
- NO WIRING SHALL BE INSTALLED PRIOR TO THE CONTRACTOR'S REVIEW OF THE PROJECT EQUIPMENT SHOP DRAWINGS AND COORDINATION WITH THE DESIGN DOCUMENTS. ANY DISCREPANCIES SHALL BE BROUGHT TO THE ARCHITECT/ENGINEER AND OWNER ATTENTION FOR FINAL RESOLUTION. WORK THAT HAS TO BE REPLACED DUE TO LACK OF PROPER SHOP DRAWINGS COORDINATION SHALL BE DONE AT CONTRACTOR'S EXPENSE.
- MOTOR SIZES AND LOCATIONS SHOWN ON THE DRAWINGS ARE BASED ON INFORMATION OBTAINED DURING DESIGN. VERIFY THE ACTUAL LOCATIONS AND PROVIDE WIRING AND PROTECTION OF PROPER SIZES AS REQUIRED. WIRE THE MOTORS FOR PROPER DIRECTION OF ROTATION AND CHECK ROTATION AT START-UP.
- ALL INCOMING POWER & LOW VOLTAGE CONDUCTORS SHALL RUN IN CONCEALED CONDUIT. UTILIZE EXISTING CONDUIT WHERE POSSIBLE.
- ALL EQUIPMENT INSTALLED IN MECHANICAL AIR PLENUM SPACE SHALL BE RATED FOR THAT USE PER LOCAL REQUIREMENT.
- FOR 15A OR 20A BRANCH CIRCUITS, PROVIDE WIRE SIZES AND RACEWAYS AS PER WIRING NOTES ON DRAWING E001
- NOTIFY ARCHITECT AND OWNER NO FEWER THAN SEVEN (7) DAYS IN ADVANCE OF PROPOSED INTERRUPTION OF ELECTRICAL SERVICE. DO NOT PROCEED WITH INTERRUPTION OF ELECTRICAL SERVICE WITHOUT ARCHITECT'S AND OWNER WRITTEN PERMISSION.
- SURFACE MOUNTED METAL RACEWAYS ONLY PERMISSIBLE ON EXISTING WALLS, WHERE CONDUIT CANNOT BE CONCEALED, IN OCCUPIED, OR NON-OCCUPIED SPACES.
- PROVIDE GFCI RECEPTACLES AS INDICATED. GFCI BREAKERS SHALL NOT BE USED.
- 29. ALL RECEPTACLES AT PUBLICLY ACCESSIBLE LOCATIONS TO BE TAMPER RESISTANT TYPE.

ELECTRICAL DEMOLITION NOTES

- EXISTING ELECTRICAL SYSTEM IS DESCRIBED BASED ON SITE CONDITIONS VISIBLE AT THE TIME OF THE SURVEY. THE CONTRACTOR SHALL VISIT THE JOB SITE TO FAMILIARIZE HIM/HERSELF WITH THE EXTENT OF EXISTING WORK TO BE DEMOLISHED
- ELECTRICAL CONTRACTOR SHALL REMOVE ALL ELECTRICAL EQUIPMENT AFFECTED BY THE DEMOLITION. COORDINATE EXACT SCOPE OF WORK WITH ALL OTHER DISCIPLINE DRAWINGS
- ALL EXPOSED CONDUITS, HANGERS, SUPPORTS, ETC. THAT ARE ABANDONED SHALL BE REMOVED. CONDUIT WHICH IS BURIED IN CONCRETE OR OTHERWISE INACCESSIBLY POSITIONED MAY BE ABANDONED. IN SUCH CASES, WIRE SHALL BE PULLED OUT OF THE CONDUIT AND THE CONDUIT ITSELF PLUGGED AT EACH END
- WHERE EXISTING DEVICES, CONDUIT WIRE, SUPPORTS, HANGERS AND OTHER ELECTRICAL EQUIPMENT MUST BE REMOVED AS A RESULT OF THE ALTERATIONS, THEY SHALL BE COMPLETELY REMOVED, BACK TO THE FIRST OUTLET WHICH IS LEFT UNAFFECTED. IF REMOVED BACK TO THE PANEL, LABEL THAT CIRCUIT AS SPACE
- PATCH ALL HOLES IN SLABS, WALLS AND CEILING WHERE ELECTRICAL DEVICES AND/OR CONDUIT ARE REMOVED. IF THE REMOVAL OF CONDUIT, BOXES, EQUIPMENT, ETC. COMPROMISES THE FIRE RATING OF THESE ITEMS, THE CONTRACTOR SHALL SEAL OPENINGS WITH CODE APPROVED FIRE STOPPING MATERIAL
- WHERE EXISTING ELECTRICAL WORK PREVENTS PROPER CONSTRUCTION OF NEW WORK, REMOVE, REROUTE, RELOCATE, OR IN OTHER WAYS ALTER EXISTING WORK TO ACCOMMODATE
- SOME EXCEPTIONS MAY ARISE WHEREIN EQUIPMENT, EITHER IN ALTERED AREAS OR OTHER AREAS, MUST BE KEPT IN SERVICE, REQUIRING THAT FEEDERS, SIGNAL CONDUCTORS, CONDUITS, BOXES ETC. SERVING THE SAME ALSO BE KEPT IN SERVICE. IN SUCH CASES THE ELECTRICAL FEEDERS, SIGNAL CONDUCTORS, CONDUITS, ETC. SHALL BE REROUTED AND RECONNECTED BEFORE PRESENT WORK IS REMOVED. IF THIS IS NOT POSSIBLE, TEMPORARY WIRING SHALL BE PROVIDED TO ALLOW FOR INSTALLATION OF NEW WORK, AFTER WHICH TEMPORARY WIRING SHALL BE REMOVED
- ALL PROPOSED DEMOLITION WORK SHALL BE THOROUGHLY COORDINATED WITH ALL OTHER TRADES
- CONTRACTOR IS TO PERFORM DEMOLITION WORK IN A NEAT, SKILLFUL. AND CAREFUL MANNER SO AS NOT TO DAMAGE OR DEFACE EXISTING CONSTRUCTION THAT IS TO REMAIN
- CONFIRM WITH THE MANUFACTURERS OF EXISTING EQUIPMENT THAT IS TO BE REVISED OR EXTENDED. ENSURE THAT EXISTING EQUIPMENT COMPLIES WITH NEW WORK REQUIREMENTS
- 11. ELECTRICAL CONTRACTOR TO REROUTE, AND REFEED ALL EXISTING EQUIPMENT/DEVICES TO REMAIN BUT MAY BE AFFECTED BY EQUIPMENT BEING DEMOLISHED
- 12. EXISTING FIRE ALARM SYSTEM SHALL REMAIN IN SERVICE UNTIL NEW SYSTEM IS FULLY OPERATIONAL AND TESTED. PROVIDE PROPOSED DEMOLITION AND INSTALLATION PLAN AS PART OF SUBMITTAL PACKAGE. NEW FIRE ALARM SYSTEM SHALL BE INSTALLED IN PARALLEL WITH EXISTING. EXISTING FIRE ALARM SYSTEM SHALL BE REMOVED ONLY WHEN NEW SYSTEM INSTALLED THROUGHOUT, OPERATIONAL TESTED AND APPROVED BY THE AHJ.
- WHEN THE EXISTING FIRE ALARM SYSTEM IS OUT OF SERVICE FOR MORE THAN 4 HOURS OR LESS AS APPROVED BY AHJ IN A 24-HOUR PERIOD, THE AHJ SHALL BE NOTIFIED AND BUILDING SHALL BE EVACUATED OR AN APPROVED FIRE WATCH SHALL BE PROVIDED BY THE CONTRACTOR UNTIL THE EXISTING SYSTEM HAS BEEN RETURNED TO SERVICE, AND DETERMINED ACCEPTABLE BY THE AHJ.
- DEMOLITION OF EXISTING FIRE ALARM SYSTEM DEVICES, CONDUITS, AND CIRCUITS SHALL PROCEED WITH CAUTION. CONTRACTOR SHALL BE RESPONSIBLE FOR MAINTAINING ALL EXISTING-TO-REMAIN FIRE PROTECTION CONDUIT, CIRCUITS, AND DEVICES IN OPERATIONAL CONDITION. IN THE DAMAGE TO THE EXISTING FIRE ALARM SYSTEM OR CIRCUITS, REPAIRS TO THE EXISTING FIRE ALARM SYSTEM SHALL BE COMPLETED ON THE SAME DAY AS THE DAMAGE. REMOVE EXISTING FIRE ALARM DEVICES SHOWN IN PROJECT AREA.
- 15. WHERE EXISTING WALL MOUNTED FIRE ALARM DEVICES ARE REMOVED, PROVIDE AN OVER-SIZED METAL COVER PLATE TO COVER EXISTING OPENING. COVER PLATE SHALL HAVE ROUNDED EDGES AND CORNERS AND FINISH TO MATCH ADJACENT FINISHES/COLOR AS APPROVED BY OWNER.

SUBDIVISION:

DIRECTO

FIRE ALARM SYSTEM NOTES

- DRAWINGS ARE DIAGRAMMATIC ONLY. RUNS OF WIRING AND THE MANNER OF CONNECTIONS SHALL BE DETERMINED BY THE CONTRACTOR IN THE FIELD. INSTALLATION OF FAS SHALL MEET SYSTEM'S MANUFACTURER'S AND FIRE MARSHAL'S REQUIREMENTS.
- 2. FAS DEVICES AND EQUIPMENT SHOWN ON PLANS ARE FOR MINIMUM REQUIREMENTS. ADDITIONAL DEVICES AND/OR EQUIPMENT SHALL BE PROVIDED WITHOUT ANY ADDITIONAL COST TO THE OWNER TO MEET THE LATEST NFPA 72 REQUIREMENTS AND ANY OTHER FIRE MARSHAL'S REQUIREMENTS
- 3. ALL 120V WIRING FOR FIRE ALARM DEVICES SHALL BE RUN IN RED RACEWAY AND JUNCTION BOXES AND IDENTIFIED AS FOR FIRE ALARM DEVICES.
- FOR ALL AREAS, THE CONTRACTOR SHALL BE RESPONSIBLE TO PROVIDE THE PROPER SIZE FAS DEVICES AND TO DETERMINE THEIR LOCATIONS IN THE FIELD TO MEET THE NFPA 72 CANDELA POWER AND SOUND LEVEL REQUIREMENTS.
- 5. ALL NEW WIRING AND RACEWAY SIZES AND THEIR QUANTITIES SHALL BE STRICTLY IN ACCORDANCE WITH MANUFACTURER'S RECOMMENDATIONS AND AHJ FIRE MARSHAL REQUIREMENTS. ALL WIRING SHALL BE INSTALLED IN RACEWAYS APPROVED BY AHJ WITH MAXIMUM 40% FILL CAPACITY. PLENUM RATED FIRE ALARM WIRING OR MC CABLE IS NOT PERMITTED.
- 6. FIRE ALARM DEVICES SHALL BE OF THE SAME MANUFACTURER AS EXISTING FIRE ALARM SYSTEM.
- CONTRACTOR SHALL BE RESPONSIBLE TO SUBMIT THE SHOP DRAWINGS TO AHJ AND OBTAINING FIRE MARSHAL'S APPROVAL PRIOR TO ANY SUBMISSION TO ENGINEER OF RECORD AND ANY INSTALLATION OF WORK.
- ALL MANUAL PULL STATION SHALL BE LOCATED WITHIN 5 FEET OF THE EXIT DOORS. ALL NEW MANUAL PULL STATIONS SHALL HAVE TWO PAIRS OF DRY CONTACTS.
- 9. ALL FAS VISUAL DEVICES SHALL BE MOUNTED AT A HEIGHT WHICH IS IN THE LINE OF SIGHT AND MEET ADA REQUIREMENTS.
- 10. PROVIDE ALL WIRING AND RACEWAYS TO FIRE PROTECTION SYSTEM (SPRINKLER SYSTEM) DEVICES SUCH AS FLOW SWITCHES, TAMPER SWITCHES ETC. AS PER NFPA AND AHJ REQUIREMENTS. FIRE ALARM SYSTEM ZONES SHALL BE COORDINATED WITH FIRE PROTECTION SYSTEM WHILE PREPARING THE SHOP DRAWINGS.
- 11. ALL NEW FIRE ALARM DEVICES FLUSH AND/OR SURFACE MOUNTED SHALL BE MOUNTED ON A FIRE ALARM SYSTEM'S MANUFACTURER FURNISHED BACK BOXES. STANDARD BOX OR 4" SQUARE BOX WILL NOT BE PERMITTED.
- 12. FOR ADDRESSABLE SYSTEM, WHICH INCLUDE SEPARATE SIGNALING LINE CIRCUITS (SLC) AND NOTIFICATION APPLIANCE CIRCUITS (NAC) EACH CIRCUIT MUST BE LOCATED IN SEPARATE CONDUITS TO AVOID CROSS TALK BETWEEN THE CIRCUITS. CABLE FOR NAC MUST BE PROPERLY SHIELDED AND PROPERLY GROUNDED AND WIRING TERMINATIONS MUST BE PROPERLY TAPED TO PREVENT SHIELDS FROM CONTACTING CIRCUITS AND OTHER WIRING. PROVIDE AMPLIFIERS AND NAC ZONES AS NEEDED FOR THE AREAS.

SHEET DESIGNATION CONTRACT NUMBER 24066 PO0 E002 JOB ORDER NUMBER

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ELECTION DIST. NO.:

10611599 SHEET 26 OF 29 DRAWING NUMBER 2024-0351


FILE NO.: 10611599

AS-BUILT / REVISION BY DATE P.W.A. NO. KEY SHEET POSITION SHT DRAWING SCALE PROFESSIONAL CERTIFICATION I HEREBY CERTIFY THAT THESE DOCUMENTS WERE PREPARED OF BID/PERMIT SET PPROVED BY: PLAN SCALE APPROVED BY ME, AND THAT I AM A DULY LICENSED PROFESSIONAL ENGINEER UNDER THE LAWS OF THE STATE OF R.O.W NO. ATIS TO MARYLAND. PROFILE SCAL EXPIRATION DATE: 06-19-2025 LICENSE NO. 44664 BUREAU OF ENGINEERING AND CONSTRUCTION ENGINEER: _ PROPERTY MANAGEMENT HIGHWAYS STRUCTURES STORM DRAINS SEWER WATER A CHIH LIN. PE 44664 REVIEWED BY: DWN BY: CCJM APPROVED BY: C. IOHNSON & MALHOTRA P.C. HOMWI Em EAST PRATT STREET, SUITE 604 LTIMORE, MD 21202 HKD BY: UNP DATE REVIEWED: 03/11/2024


BALTIMORE COUNTY OFFICE OF BUDGET AND FINANCE, PROPERTY MANAGEMENT

BCPL - White Marsh ELECTRICAL - GENERAL NOTES


8133 SANDPIPER CIRCLE BALTIMORE, MD 21226

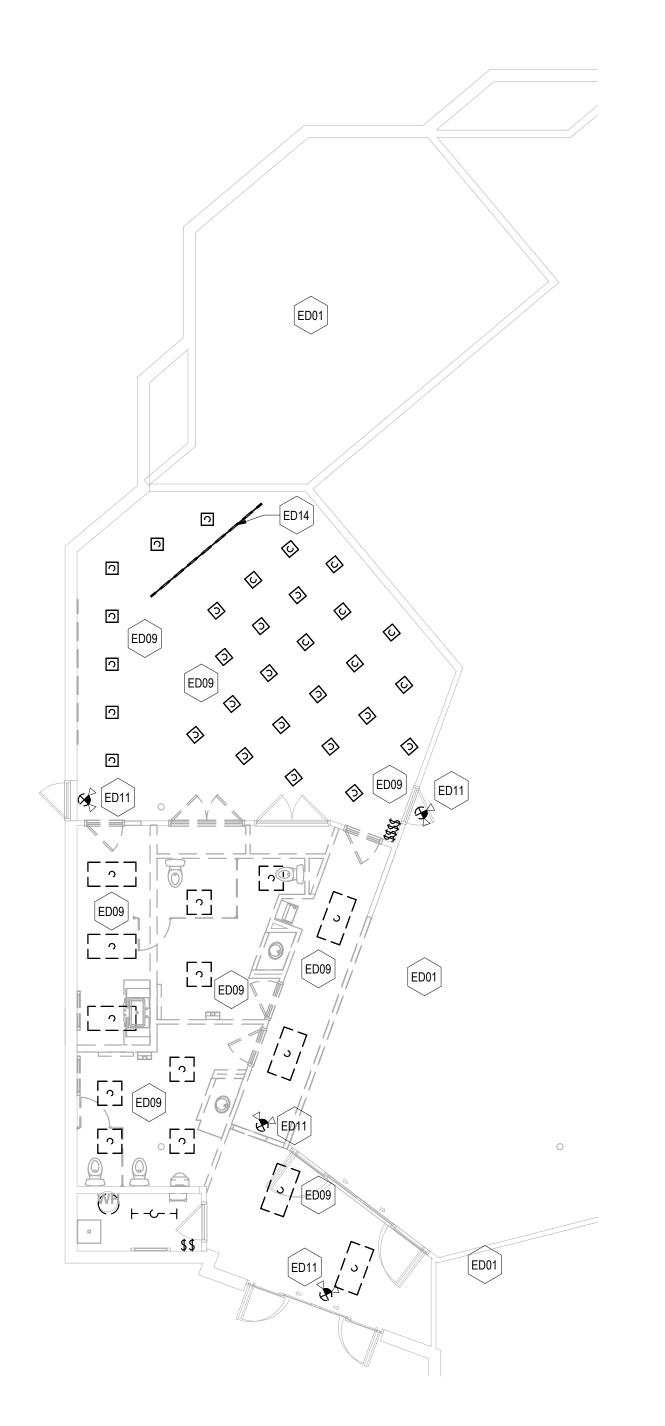

1 ELECTRICAL FLOOR PLAN - LIGHTING - DEMOLITION 1/8" = 1'-0"

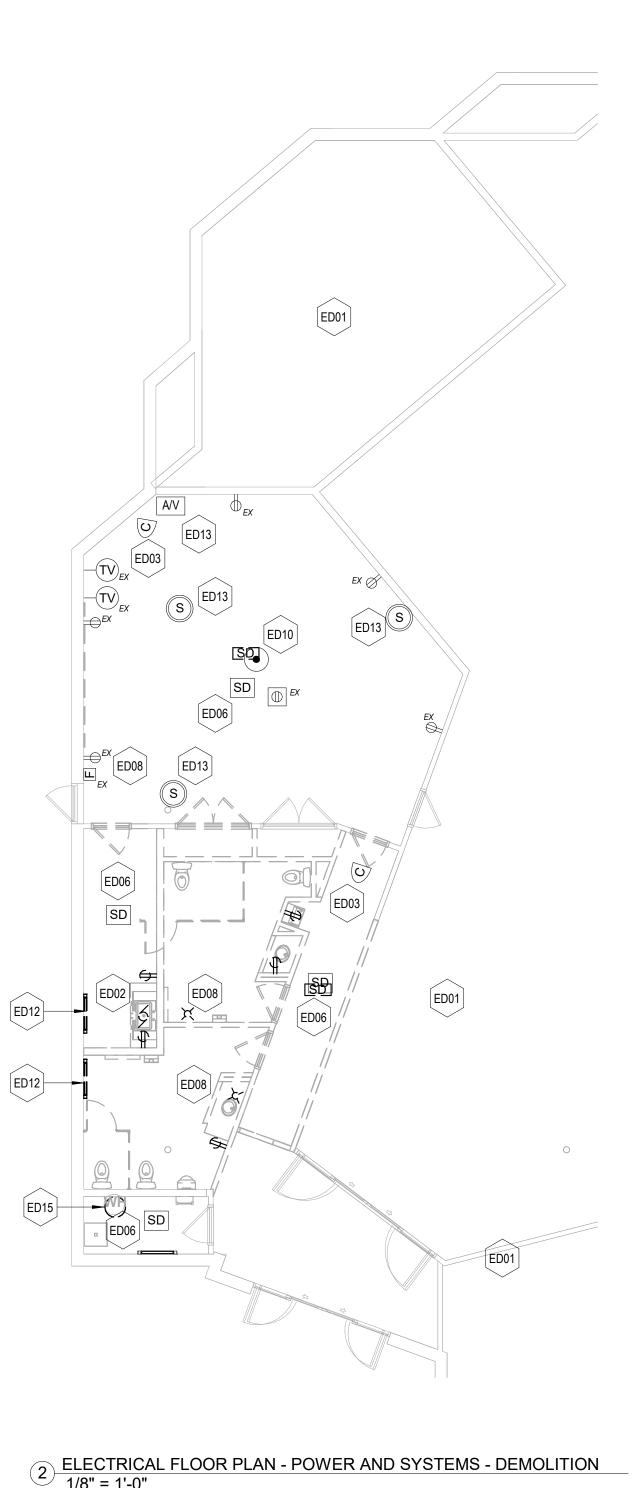

SUBDIVISION:

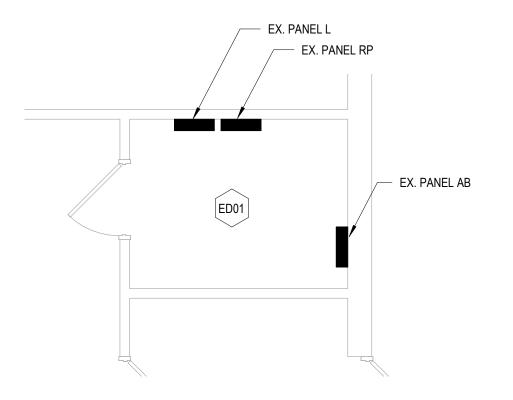

4 ENLARGED FLOOR PLAN - ELECTRICAL ROOM 1/4" = 1'-0"

ELECTRICAL KEYED NOTES - DEMOLITION NOTE # NOTES ALL ELECTRICAL EQUIPMENT / DEVICES / LIGHTING IN THIS AREA ARE EXISTING TO REMAIN, ED01 UNLESS OTHERWISE NOTED. FIELD VERIFY ALL ELECTRICAL WORK PRIOR THE INSTALLATION OF NEW WORK, POWER AND LIGHTING. DISCONNECT AND REMOVE GARBAGE DISPOSAL AND ALL ASSOCIATED CONTROL SWITCH, ED02 WIRING, AND RACEWAY BACK TO SOURCE. ASSOCIATED CIRCUIT BREAKER TO BE TURNED OFF AND MADE SPARE. UPDATE ASSOCIATED PANEL SCHEDULE. CAREFULLY DISCONNECT AND REMOVE EXISTING SECURITY CAMERA. SECURITY CAMERA ED03 TO BE RELOCATED AS INDICATED ON NEW WORK PLANS. COORDINATE ALL WORK WITH OWNER IT AND SECURITY DEPARTMENTS. CAREFULLY DISCONNECT AND REMOVE EXISTING SMOKE DETECTOR AND ASSOCIATED ED06 WIRING AND RACEWAY TO BE REINSTALLED AT NEW LOCATION AS INDICATED ON ELECTRICAL NEW WORK PLAN. DISCONNECT AND REMOVE EXISTING FIRE ALARM DEVICE AND ASSOCIATED WIRING/RACEWAY BACK TO SOURCE. EXISTING TO REMAIN FIRE ALARM DEVICES TO ED08 | REMAIN FULLY OPERATIONAL. IF ANY EXISTING-TO-REMAIN DEVICE AND/OR EQUIPMENT IS AFFECTED, PROVIDE ADDITIONAL WIRING/RACEWAY AS REQUIRED TO RESTORE AND MAINTAIN THE DEVICES/EQUIPMENT TO EXISTING OPERATIONAL AND WORKING CONDITION. DISCONNECT AND REMOVE SELECTED LIGHTING FIXTURES AND ASSOCIATED CONTROL SWITCH, OCCUPANCY SENSORS, AND BRANCH CIRCUIT WIRING/RACEWAY BACK TO SOURCE. EXISTING TO REMAIN LIGHT FIXTURES TO REMAIN CONTINUOUS. IF ANY POWER TO THE EXISTING-TO-REMAIN FIXTURES IS AFFECTED, PROVIDE ADDITIONAL WIRING/RACEWAY AS REQUIRED TO RESTORE AND MAINTAIN FIXTURES TO EXISTING OPERATIONAL AND WORKING CONDITION. CAREFULLY DISCONNECT AND REMOVE EXISTING WIRELESS ACCESS POINT. WIRELESS ED10 ACCESS POINT TO BE RELOCATED TO NEW LOCATION AS INDICATED ON NEW WORK PLANS. COORDINATE ALL WORK WITH OWNER IT DEPARTMENT. REMOVE EXISTING EXIT/BATTERY EMERGENCY FIXTURE AND ASSOCIATED WIRING AND

DISCONNECT AND REMOVE ELECTRICAL BASEBOARD HEATER AND ALL ASSOCIATED

DISCONNECT AND REMOVE EXISTING A/V EQUIPMENT, SPEAKERS AND ALL ASSOCIATED

DISCONNECT AND REMOVE EXISTING TRACK LIGHT AND RETURN TO OWNER. REMOVE ALL

CAREFULLY DISCONNECT AND REMOVE EXISTING WATER HEATER AND ASSOCIATED DISCONNECT SWITCH AND WIRING AND CONDUIT BACK TO JUNCTION POINT. WATER HEATER TO BE RELOCATED TO NEW LOCATION AS INDICATED ON NEW WORK PLANS.

ED12 WIRING/RACEWAY IN THEIR ENTIRETY. COORDINATE ALL WORK WITH MECHANICAL

ED13 WIRING/RACEWAYS IN THEIR ENTIRETY. SALVAGE AND RETURN A/V EQUIPMENT AND


ASSOCIATED WIRING/RACEWAYS IN THEIR ENTIRETY BACK TO SOURCE.

COORDINATE ALL WORK WITH PLUMBING CONTRACTOR.

CONDUIT BACK TO SOURCE.

SPEAKERS TO OWNER.

3 KEY PLAN 1" = 30'-0"

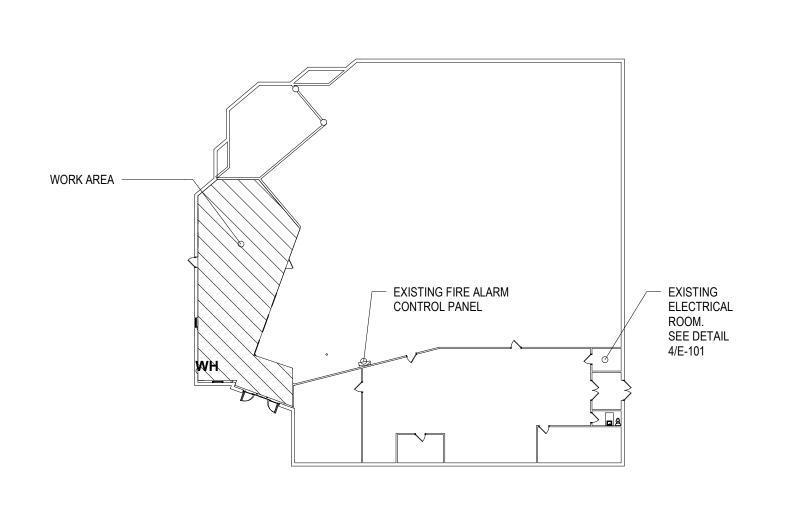

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		HEREBY CERTIFY THAT THESE DOCUMENTS WERE PREPARED OR PPROVED BY ME, AND THAT I AM A DULY LICENSED				03.15.2024	-	-	-	PLAN SCALE:	As indicated	APPROVED BY:
PROFESSIONAL ENGINEER UNDER THE L MARYLAND.							R.O.W NO.	-	-		-	DIRE
	LICENSE NO. 44664 EXPIRATION DA					-	-			-	DATE:	
	ENGINEER: TA CHIH LIN, PE	DGN BY: CCJM	BUREAU OF ENGINEERING AND CONSTRUCTION		HIGH	HWAYS	STRUCTURES	STORM DRAINS	SEWER	WATER	FIELD ENGINEER	PROPERTY MANAGEMENT
IIII SIONALENGIIIII	ELECTRICAL ENGINEER C.C. JOHNSON & MALHOTRA, P.C.	DWN BY: CCJM	REVIEWED BY:									APPROVED BY:
	400 EAST PRATT STREET, SUITE 604 BALTIMORE, MD 21202 (P) 410-461-9920	CHKD BY: UNP	DATE REVIEWED:									DATE:

BALTIMORE COUNTY OFFICE OF BUDGET AND FINANCE, PROPERTY MANAGEMENT

ELECTRICAL - PARTIAL FLOOR PLAN - DEMOLITION

8133 SANDPIPER CIRCLE

BCPL - White Marsh

SHEET DESIGNATION

E101

JOB ORDER NUMBER SHEET 27 OF 29 DRAWING NUMBER

CONTRACT NUMBER


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10611599

2024-0352

FILE NO.: 10611599

ELECTION DIST. NO.: BALTIMORE, MD 21226



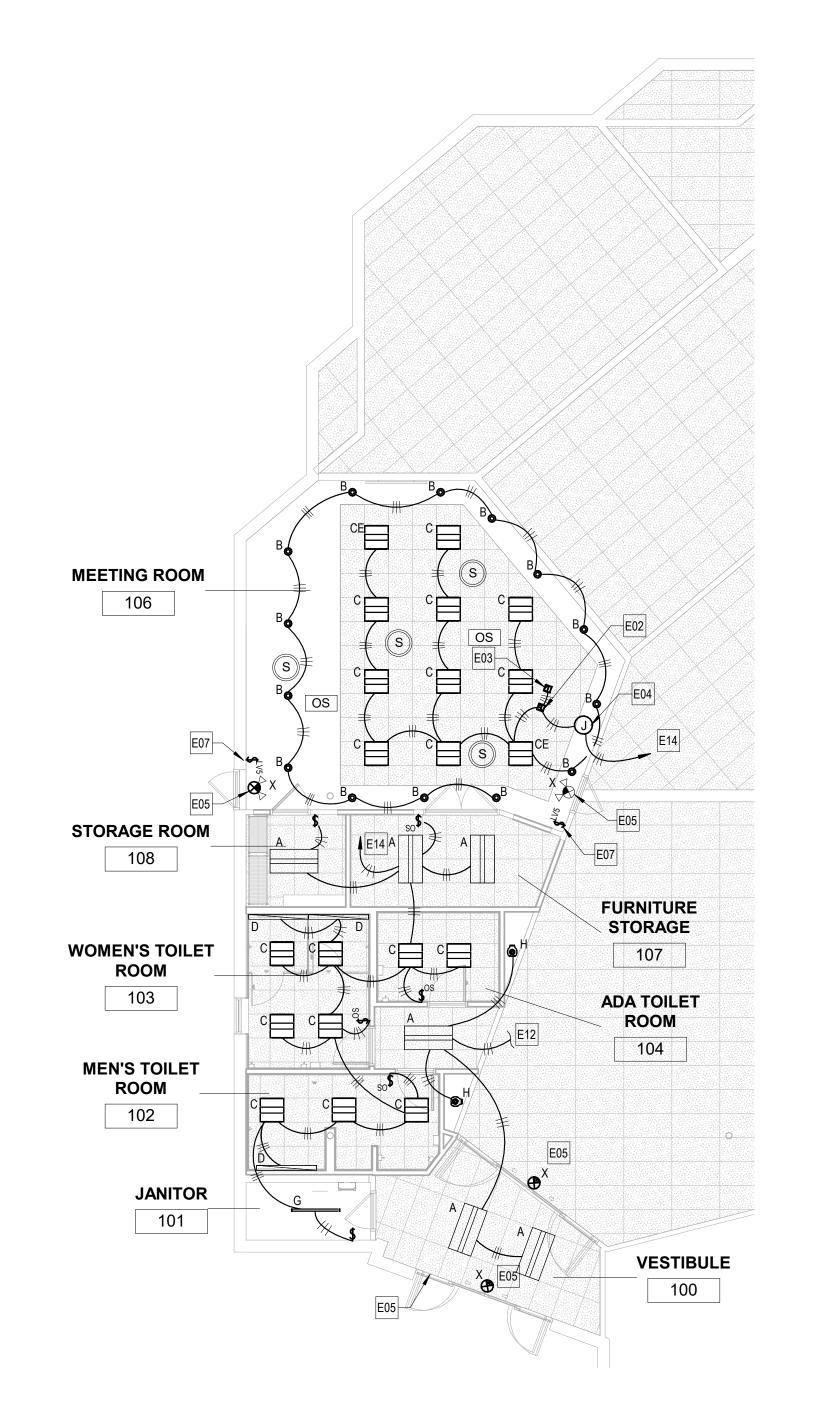

AS-BUILT / REVISION

BID/PERMIT SET

BUREAU OF ENGINEERING AND CONSTRUCTION

REVIEWED BY:

DATE REVIEWED:

PROFESSIONAL CERTIFICATION

I HEREBY CERTIFY THAT THESE DOCUMENTS WERE PREPARED OR APPROVED BY ME, AND THAT I AM A DULY LICENSED PROFESSIONAL ENGINEER UNDER THE LAWS OF THE STATE OF

EXPIRATION DATE: 06-19-2025


CHKD BY: UNP

MARYLAND.

LICENSE NO. 44664

ALTIMORE, MD 21202 P) 410-461-9920

C. JOHNSON & MALHOTRA, P.C. 00 EAST PRATT STREET, SUITE 604

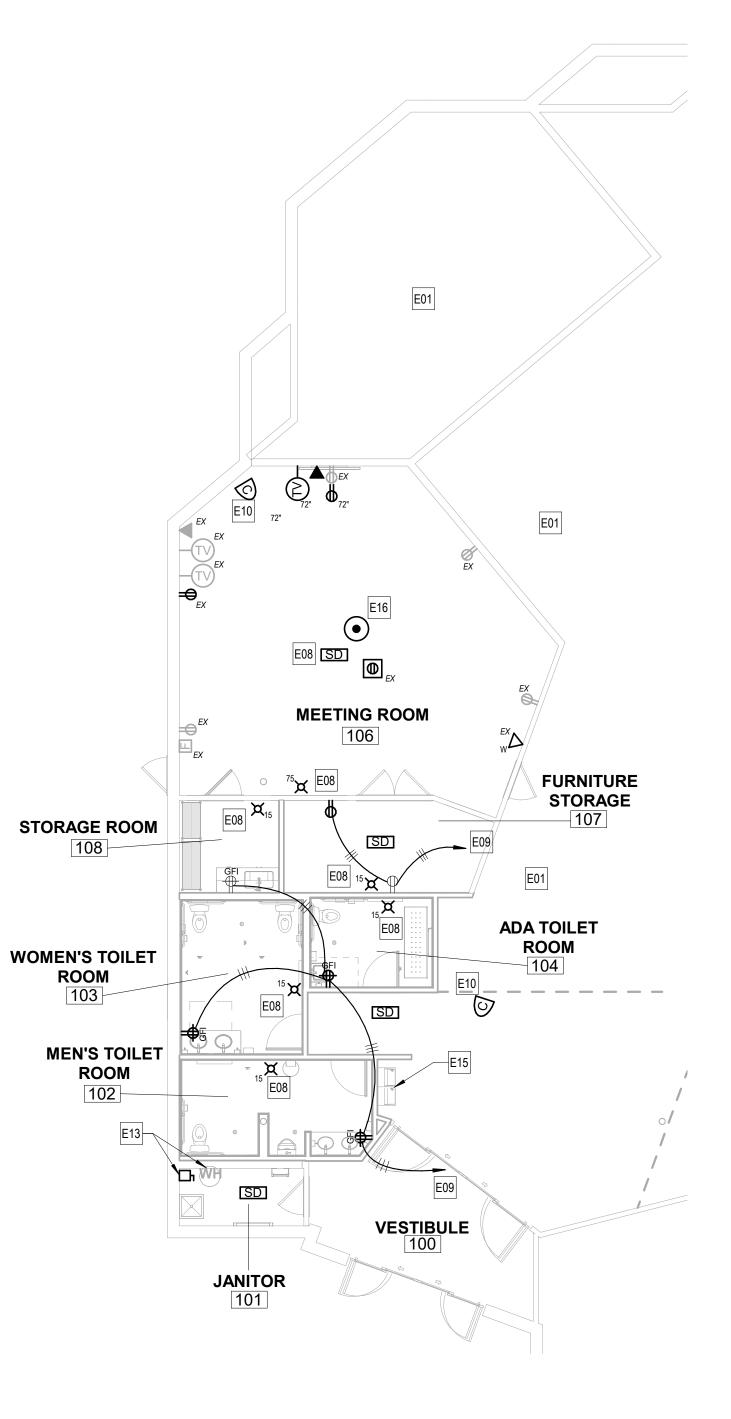


2 ELECTRICAL FLOOR PLAN - POWER AND SYSTEMS - NEW WORK
1/8" = 1'-0" 1/8" = 1'-0"

PROPERTY MANAGEMENT

SUBDIVISION:

APPROVED BY:

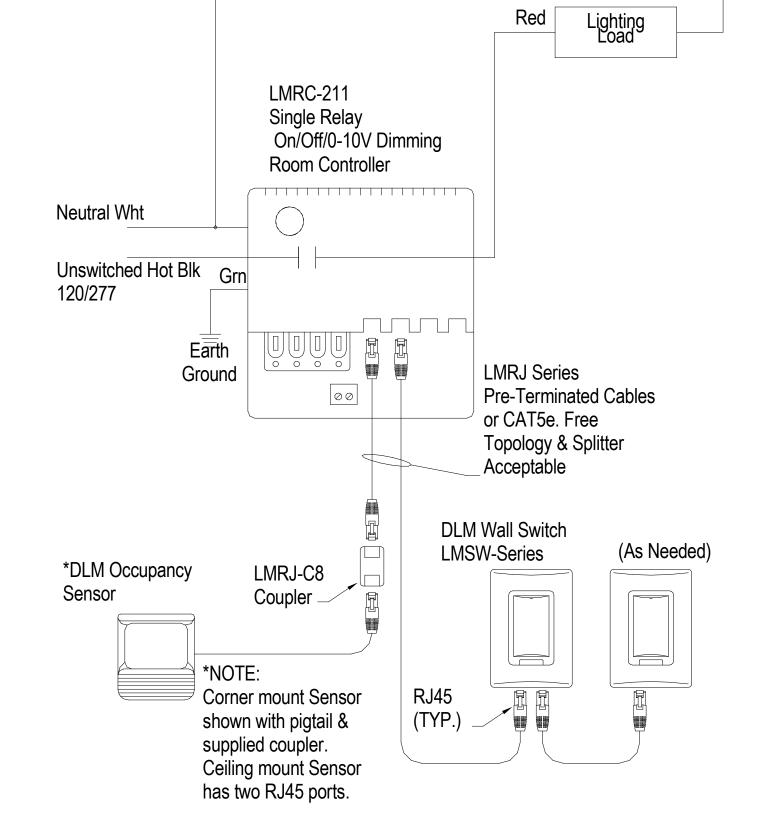


DEVICES ARE PRESET FOR PLUG n' GO™ OPERATION, ADJUSTMENT IS OPTIONAL. Sequence of Operation: In this configuration the LMRC-211 defaults to manual-on/automatic-off operation. Enhanced room controllers support up to 64 loads and 48 devices per DLM local network. For full operational details, adjustments and more features of the product, see the DLM System Installation Guide at www.wattstopper.com

4 LIGHTING CONTROL DIAGRAM

E	LECTRICAL KEYED NOTES - NEW WORK
NOTE#	NOTES
E01	ALL ELECTRICAL EQUIPMENT AND SYSTEMS IN THIS AREA ARE EXISTING TO REMAIN, UNLESS OTHERWISE NOTED.
E02	PROVIDE 2-RELAY ROOM CONTROLLER, 0-10V DIMMING BY WATTSTOPPER #LMRC-212 OR APPROVED EQUAL.
E03	PROVIDE 3-RELAY ROOM CONTROLLER, 0-10V DIMMING BY WATTSTOPPER #LMRC-213 OR APPROVED EQUAL.
E04	PROVIDE 120V JUNCTION BOX FOR LIGHTING CONTROLS AND CONNECT TO EXISTING 120V, 20A LIGHTING BRANCH CIRCUIT LOCATED IN THIS AREA AFTER DEMOLITION WORK. EXISTING BRANCH CIRCUIT SHALL NOT EXCEED 1.5 KW TOTAL CONNECTED LOAD.
E05	CONNECT EXIT SIGNS/EMERGENCY BATTERY PACK TO AREA UNSWITCHED LIGHTING CIRCUIT. PROVIDE 2#12 + 1#12G IN 3/4"C.
E07	PROVIDE LOW VOLTAGE, 5-BUTTON SCENE SWITCH BY WATTSTOPPER #LMSW-105 OR APPROVED EQUAL. COORDINATE SCENE CONFIGURATION WITH OWNER.
E08	PROVIDE FIRE ALARM SYSTEM DEVICE COMPATIBLE WITH EXISTING (EDWARDS SYSTEMS TECHNOLOGY) AND ASSOCIATED WIRING AND RACEWAY. FIRE DEVICE OUTPUT SHALL BE ADJUSTED IN ACCORDANCE WITH NFPA 72 REQUIREMENTS AND LOCAL AUTHORITY HAVING JURISDICTION (AHJ). INTEGRATE DEVICE TO EXISTING FIRE ALARM SYSTEM. PROVIDE UPDATES TO ASSOCIATED FIRE ALARM CONTROL PANEL AND ANNUNCIATOR AS REQUIRED. TEST THE SYSTEM AND SUBMIT THE REPORT TO THE OWNER, AHJ AND BUILDING MANAGER.
E09	PROVIDE 2#12 & #12G IN 3/4" C TO EXISTING 1P, 20A SPARE AT PANEL "RP". COORDINATE EXACT LOCATION OF ALL RECEPTACLES WITH ARCHITECTURAL DRAWINGS PRIOR TO THE INSTALLATION OF THE ELECTRICAL DEVICE. UPDATE PANEL SCHEDULE ACCORDINGLY.
E10	EXISTING SECURITY CAMERA AT NEW LOCATION. PROVIDE WIRING AND CONDUIT TO BUILDING SECURITY RACK. COORDINATE ALL WORK WITH OWNER IT AND SECURITY DEPARTMENTS.
E12	SPLICE, EXTEND, AND PROVIDE 2#12& #12G TO AREA LIGHTING CIRCUIT. LIGHTING SHALL BE CONTROLLED BY EXISTING BUILDING TIME CLOCK LOCATED IN EXISTING ELECTRICAL CLOSET. COORDINATE LIGHTING SCHEDULE CONFIGURATION WITH OWNER.
E13	REINSTALL EXISTING WATER HEATER AND ASSOCIATED DISCONNECT SWITCH AT NEW LOCATION. SPLICE, EXTEND, AND PROVIDE WIRING AND CONDUIT EQUAL TO EXISTING BUT NOT LESS THAN WHAT IS REQUIRED BY THE NEC.
E14	SPLICE, EXTEND, AND PROVIDE 2#12& #12G TO AREA LIGHTING CIRCUIT.
E15	FOR WATER COOLER. PROVIDE 2#12 & #12G IN 3/4"C TO EXISTING 1P, 20A SPARE AT PANEL "RP". UPDATE PANEL SCHEDULE ACCORDINGLY.
E16	EXISTING WIRELESS ACCESS POINT AT NEW LOCATION. PROVIDE WIRING AND RACEWAY TO BUILDING DATA RACK. COORDINATE EXACT LOCATION WITH OWNER IT DEPARTMENT.

DEPARTMENT. COORDINATE ALL WORK WITH OWNER IT DEPARTMENT.

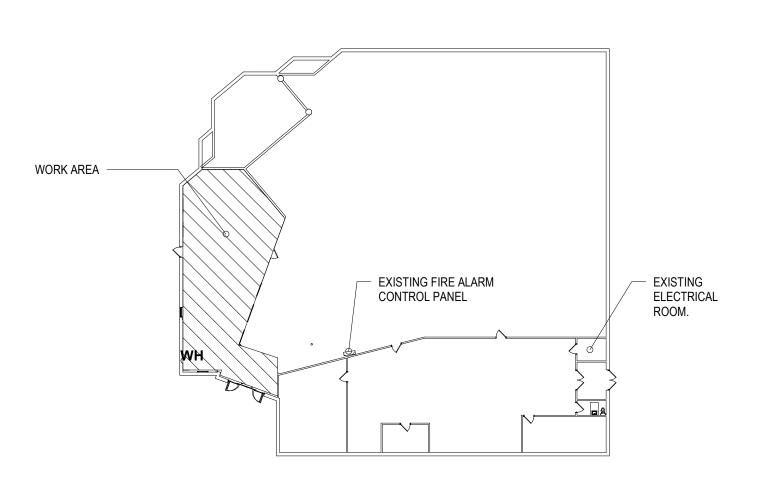

3 KEY PLAN 1" = 30'-0"

ELECTION DIST. NO.:

E201

24066 PO0 JOB ORDER NUMBER 10611599 SHEET 28 OF 29 DRAWING NUMBER

FILE NO.: 10611599

ELECTRICAL - PARTIAL FLOOR PLAN - NEW WORK

BCPL - White Marsh

BALTIMORE COUNTY OFFICE OF BUDGET AND FINANCE, PROPERTY MANAGEMENT

8133 SANDPIPER CIRCLE BALTIMORE, MD 21226

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R.O.W NO.

HIGHWAYS STRUCTURES STORM DRAINS

BY DATE P.W.A. NO. KEY SHEET POSITION SHT DRAWING SCALE

SEWER

PLAN SCALE:

WATER

2024-0353

SHEET DESIGNATION | CONTRACT NUMBER

Branch Panel: L

Location: ELECTRICAL ROOM Supply From: Mounting: Surface Enclosure: Type 1

Volts: 120/208 Wye Phases: 3 Wires: 4

A.I.C. Rating: Mains Type: MCB Mains Rating: 200 A MCB Rating: 200 A

EXISTING PANEL. MANUFACTURED BY GENERAL ELECTRIC.

СКТ	Circuit Description	Trip	Poles		4	E	3			Poles	Trip	Circuit Description	СКТ
1	EXTERIOR WALL LIGHTS	20 A	1	0 VA	0 VA					1	20 A	POLE LIGHTS - CONTACTOR	2
3	EXTERIOR WALL LIGHTS	20 A	1			0 VA	0 VA			1	20 A	POLE LIGHTS - CONTACTOR	4
5	SIGN & TIME CLOCK	20 A	1					0 VA	0 VA	1	20 A	WORK ROOM & OFFICE LIGHTS	6
7	WORK ROOM LIGHT	20 A	1	0 VA	0 VA					1	20 A	SHIPPING, STAFF LIGHTS	8
9	WORK ROOM LIGHT	20 A	1			0 VA	0 VA			1	20 A	JANITOR, TOILETS, PREP LIGHTS	10
11	WORK ROOM LIGHT	20 A	1					0 VA	0 VA	1	20 A	MEETING ROOM LIGHTS	12
13	MEETING ROOM TRACK LIGHTS	20 A	1	0 VA	0 VA					1	20 A	MEETING ROOM LIGHTS	14
15	BULKHEAD RECEPTACLE	20 A	1			0 VA	0 VA 0 VA			1	20 A	READING ROOM LIGHTS 2X4'S - SLOPE	16
17	READING ROOM LIGHTS 2X4'S	20 A	1						0 VA	1	20 A	READING ROOM LIGHTS 2X4'S - HIGH CEILING	18
19	READING ROOM LIGHTS 2X4'S	20 A	1	0 VA	0 VA					1	20 A	READING ROOM LIGHTS 2X4'S - HIGH CEILING	20
21	READING ROOM LIGHTS 2X4'S	20 A	1			0 VA	0 VA			1	20 A	READING ROOM LIGHTS 2X4'S	22
23	KITCHEN REC PLUG MOLD/PREP ROOM REC	20 A	1					0 VA	0 VA	1	20 A	READING ROOM LIGHTS 2X4'S	24
25	SHELF LTS. (QUIET ROOM)	20 A	1	0 VA	0 VA					1	20 A	READING ROOM LIGHTS 2X4'S	26
27	RECEP. LAPTOP (QUIET ROOM)	20 A	1			0 VA	0 VA			1	20 A	READING ROOM LIGHTS 2X4'S	28
29	TRACK LIGHTS - QUIET STUDY	20 A	1					0 VA	0 VA	1	20 A	READING ROOM LIGHTS 2X4'S	30
31	TRACK LIGHTS - QUIET STUDY	20 A	1	0 VA	0 VA					1	20 A	READING ROOM LIGHTS 2X4'S	32
33	TRACK LIGHTS	20 A	1			0 VA	0 VA			1	20 A	TRACK LIGHTS - HIGH CEILING	34
35	LAY IN 2X4 PERIODICALS	20 A	1					0 VA	0 VA	1	20 A	COUNTER RECEPTACLE - INFORMATION	36
37	TRACK LIGHTS - HIGH CEILING	20 A	1	0 VA	0 VA					1	20 A	NEON LIGHTS - LOBBY	38
39	TRACK LIGHTS - HOLD SHELF	20 A	1			0 VA	0 VA			1	20 A	NEON LIGHTS - ROUND DESK	40
41	TRACK LIGHTS - HIGH CEILING	20 A	1					0 VA	0 VA	1	20 A	CONTACTOR OPEN/CLOSED SIGN	42
		Tota	al Load:	0 \	/A	0 '	VA	0 '	VΑ				
		Tota	I Amps:	0	Α	0	Α	0	Α	-			

Load Classification	Connected Load	Demand Factor	Estimated Demand	Panel	Totals		
				Total Conn. Load:	0 VA		
				Total Est. Demand:	0 VA		
				Total Conn.:	0 A		
				Total Est. Demand:	0 A		

Branch Panel: RP

Location: Supply From: Mounting: Surface Enclosure: Type 1

Volts: 120/208 Wye Phases: 3 Wires: 4

A.I.C. Rating: Mains Type: MCB Mains Rating: 200 A MCB Rating: 200 A

EXISTING PANEL. MANUFACTURED BY GENERAL ELECTRIC.

СКТ	Circuit Description	Trip	Poles	A		В		С		Poles Trip		Circuit Description	СКТ
1	TELE POWER RECEPTACLE	20 A	1	0 VA	0 VA					1	20 A	QUIET, MEETING, CORRIDOR RECEP	2
3	PROF. WORK ROOM & OFFICE RECEPTACLE	20 A	1			0 VA	0 VA			1	20 A	QUITE, MEETING ROOM RECEPTACLE	4
5	ROOF, WORK RM, OFFICE RECP &	20 A	1					0 VA	0 VA	1	20 A	INFORMATION COUNTER, ISOLATED REC'S	6
7	WORK ROOM, STAFF RECEPTACLE	20 A	1	0 VA	0 VA					1	20 A	READING ROOM WALL RECEPTACLE	8
9	WORM ROOM, STAFF RECEPTACLE, POWER	20 A	1			0 VA	0 VA			1	20 A	READING ROOM WALL RECEPTACLE	10
11	WORK ROOM DEDICATED RECEPTACLE	20 A	1					0 VA	0 VA	1	20 A	STACK LGTS	12
13	ISOLATED CIR FOR MACINTOSH	20 A	1	0 VA	0 VA 0 VA						20 A	RECP. OUTSIDE WALL	14
15	LIGHTS - FLOOR OUTLETS	20 A	1				0 VA				20 A	MEN'S HAND DRYER	16
17	LIGHTS - FLOOR OUTLETS	20 A	1					0 VA	0 VA 0 VA		20 A	WOMEN'S HAND DRYER	18
19	LIGHTS - FLOOR OUTLETS	20 A	1	0 VA	0 VA 0 VA					1	20 A	SPARE [EXISTING]	20
21	LIGHTS - FLOOR OUTLETS	20 A	1			0 VA	0 VA			3	20 A	DUCT HEATER	22
23	SPARE [EXISTING]	20 A	1					0 VA	0 VA				24
25	SLIDING DOORS	20 A	1	0 VA	0 VA								26
27	SPARE [EXISTING]	20 A	1			0 VA	0 VA			3	20 A	SHIPPING HEATER	28
29	READING ROOM RECEPTACLE	20 A	1					0 VA	0 VA				30
31	BASEBOARD HEAT - WORK ROOMS	20 A	1	0 VA	0 VA								32
33	SPARE [EXISTING]	20 A	1			0 VA	0 VA			1	20 A	STAFF HOT WATER HEATER	34
35	SPARE [EXISTING]	20 A	1					0 VA	0 VA	1	20 A	SHIPPING DOCK LIGHT	36
37	BASEBOARD HEAT - STAFF BATHROOM	20 A	1	0 VA	0 VA 0 VA					1	20 A	PUBLIC HOT WATER HEATER	38
39	KITCHEN RANGE	40 A	2			0 VA	0 VA			1	20 A	BASEBOARD HEATERS - JANITOR - WORK	40
41								0 VA	0 VA	1	20 A	SPARE [EXISTING]	42
		Tota	al Load:	0 \	VΑ	0 '	VΑ	0 '	VA				
		Tota	l Amps:	0	Α	0 A		0	Α	•			

Legend:

Load Classification	Connected Load	Demand Factor	Estimated Demand	Panel T	Totals
				Total Conn. Load:	0 VA
				Total Est. Demand:	0 VA
				Total Conn.:	0 A
				Total Est. Demand:	0 A

Branch Panel: AB

Location: ELECTRICAL ROOM Supply From: Mounting: Surface

Enclosure: Type 1

Volts: 120/208 Wye Phases: 3 Wires: 4

A.I.C. Rating: Mains Type: MCB Mains Rating: 150 A MCB Rating: 150 A

EXISTING PANEL. MANUFACTURED BY GENERAL ELECTRIC.

СКТ	Circuit Description	Trip	Poles		A	l	В		С	Poles	Trip	Circuit Description	CI	
1	EXISTING	20 A	1	0 VA	0 VA					1	20 A	VENDING MACHINES	2	
3	PUBLIC COMPUTERS (FLOOR)	20 A	1			0 VA	0 VA				20 A	COMPUTER	4	
5	EXISTING	20 A	1					0 VA	0 VA	1	20 A	NEW COMP CTR FLOOR	6	
7	CHILDRENS COMPUTER	20 A	1	0 VA	0 VA					1	20 A	RECEP AUTOCHECKOUT MACHINE	8	
9	NEW COMP CTR FLOOR	20 A	1			0 VA	0 VA			1	20 A	NEW COMP CTR FLOOR	10	
11	NEW COMP CTR FLOOR	20 A	1				0 VA 0 V		0 VA 0 VA		20 A	COPIER #1	12	
13	RECEP. BY PANEL	20 A	1	0 VA	0 VA					1	20 A	COPIER #2	14	
15	POWER POLE WK RM #1	20 A	1			0 VA	0 VA			1	20 A	REFRIG BREAK RM	16	
17	POWER POLE WK RM #2	20 A	1					0 VA	0 VA	1	20 A	NEW COMPUTER CTR FLOOR	18	
19	CATALOG COMP (FLOOR)	20 A	1	0 VA	0 VA					1	20 A	EXISTING	20	
21	FIRE ALARM PANEL	20 A	1			0 VA	0 VA			3	50 A	AIR CURTAIN FRONT DOOR	22	
23	POWER POLE	20 A	1					0 VA	0 VA				24	
25	Space		1		0 VA								26	
27	Space		1							1		Space	28	
29	Space		1							1		Space	30	
	,	Tot	al Load:	0	VA	0 '	VA	0 '	VA					
Total Amps:				0	Α	0	Α	0	Α	•				

Load Classification	Connected Load	Demand Factor	Estimated Demand	Panel	l Totals		
				Total Conn. Load:	0 VA		
				Total Est. Demand:	0 VA		
				Total Conn.:	0 A		
				Total Est. Demand:	0 A		

PANEL SCHEDULE GENERAL NOTES

ALL PANEL SCHEDULE INFORMATION SHOWN IS BASED ON EXISTING PANEL SCHEDULE INFORMATION. CONTRACTOR TO FIELD VERIFY AVAILABILITY OF EXISTING SPARES PRIOR TO COMMENCING WORK. SHOULD INSUFFICIENT SPARES BE AVAILABLE, IMMEDIATELY NOTIFY OWNER AND ARCHITECT.

		LIGHTI	NG FIXTURE SCHE	DULE				
TYPE	DECODIDATION		BASIS OF DESIGN		LAMP			OOMMENTO
	DESCRIPTION	DESCRIPTION	MANUFACTURER	MODEL	TYPE	WATTS	EFFICACY	VOLTAGE
Α	RECESSED 2X4	LEDALITE	SHINE 3324	28W T5	39 W	149 lm/W	120V	
В	1200 & 1800 Lumen Series	Eaton's Cooper Lighting	PD612 and PD618	LED	19 W	149 lm/W	120V	
С	2x2, 3000lm, 80CRI, 3500K, Diffuse(Ribbed)	PHILLIPS	2FGG30L835-2-D-UNV	LED	20 W	149 lm/W	120V	
CE	2x2, 3000lm, 80CRI, 3500K, Diffuse(Ribbed)	PHILLIPS	2FGG30L835-2-D-UNV	LED	20 W	149 lm/W	120V	
D	5' SEAMLESS RECESSED LED	PHILLIPS	TRUELINE RECESSED	LED	56 W	147 lm/W	120V	
G	4' MVOLT SWITCHABLE LED STRIP FIXTURE	LITHONIA LIGHTING	CSS L48 ALO3 MVOLT SWW3 80CRI	LED	27 W	149 lm/W	120V	
Н	4" OPEN TRIM DOWNLIGHT	LITHONIA LIGHTING	LDN4 40 20 L04 MVOLT	LED	22 W	91 lm/W	120V	COORDINATE WITH ARCHITECT FOR FIXTURE FINISHES
Χ	EXIT SIGN	LITHONIA LIGHTING	LQM SERIES	LED	12 W	0 lm/W	120V	

LIGHT FIXTURE GENERAL NOTES

SUBDIVISION:

- REFER TO ARCHITECTURAL DRAWING FOR MOUNTING CONSTRUCTION.
- LISTED CATALOG NUMBER AND MANUFACTURER CONSTITUTES "BASIS OF DESIGN". LISTING OF ALTERNATE MANUFACTURER'S NAMES DOES NOT IMPLY ACCEPTANCE OF THEIR STANDARD PRODUCT. MANUFACTURERS ARE RESPONSIBLE FOR PROVIDING FIXTURES THAT ARE EQUAL IN ALL RESPECTS TO THE "BASIS OF DESIGN" FIXTURES. "INTENT IS TO ALLOW FOR COMPETITIVELY BID LIGHTING PACKAGE, FOR FIXTURES WITH MULTIPLE NAMED MANUFACTURERS."
- SUBSTITUTIONS OF FIXTURES ONLY ALLOWED WHEN APPROVED IN ADVANCE BEFORE SHOP DRAWINGS SUBMITTAL AND REQUEST FOR SUBSTITUTION IS SUBMITTED IN ACCORDANCE WITH SPECIFICATION REQUIREMENTS.
- LIGHTING FIXTURES SUBMITTALS SHALL INCLUDE, AS A MINIMUM: A) FIXTURE TYPE (TO MATCH WITH SCHEDULE), DIMENSIONS AND FINISH. B) LAMP DATA/LED DATA FOR EACH TYPE OF FIXTURE INCLUDING: TYPE, QUANTITY, WATTAGE, AND PHOSPHOR COLOR. C) DRIVER FOR EACH FIXTURE TYPE AND FIXTURE VOLTAGE.
- PROVIDE UNIVERSAL 120/277 VOLT, 0-10V DIMMING DRIVER FOR DIMMING TO 1% UNLESS OTHERWISE INDICATED.
- VERIFY CEILING/WALL TRIM COMPATIBILITY PRIOR TO SUBMITTING THE FIXTURES. COLOR AND FIXTURE FINISHES AS SELECTED BY ARCHITECT WHETHER SHOWN OR NOT. PROVIDE ADAPTER AND ADDITIONAL MOUNTING EQUIPMENT AS REQUIRED TO MOUNT FIXTURE TO SURFACE.
- PROVIDE LABOR AND EQUIPMENT FOR FOCUSING OF ADJUSTABLE FIXTURES AND PRESETTING OF LIGHTING CONTROL SYSTEMS. FOCUSING AND PRESETTING SHALL BE DONE IN THE PRESENCE OF THE OWNER AND ARCHITECT/ENGINEER.
- PROVIDE ALL CONTROL WIRES FOR 0-10V DIMMING. PROVIDE DIMMING BALLAST (DIMMABLE FROM 10%-100%)

- 9. IF THE CONTRACTOR OPTS TO USE THE FIXTURE OF ALTERNATE MANUFACTURER (WHERE ACCEPTABLE), THE CONTRACTOR SHALL BE RESPONSIBLE TO PROVIDE POINT-TO-POINT CALCULATIONS FOR ALL AREAS AS DIRECTED BY THE ENGINEER AT THE TIME OF SUBSTITUTION
- 10. PROVIDE ALL CHANNELS, HANGERS, CABLES, SUPPORTS AND OTHER ACCESSORIES AS REQUIRED FOR SUSPENDED FIXTURES FOR COMPLETE WORKING SYSTEM WITHOUT ADDITIONAL COST TO OWNER. PROVIDE SIDE BRACKETS TO MOUNT TO WALL /COVE/SUPPORTS.
- 11. IF MULTIPLE VOLTAGES ARE INDICATED, FIXTURE IS COMPATIBLE WITH MULTIPLE VOLTAGES. FIXTURE TO BE WIRED TO VOLTAGE INDICATED IN PARENTHESES ().
- 12. PROVIDE INSTALLED UL LABELS WITH THE MAXIMUM SCHEDULED WATTAGE.
- 13. LED SHALL BE 3500K COLOR TEMPERATURE.
- 14. REFER TO LIGHTING PLANS FOR (*) ROW LENGTH.
- 15. LIGHTING FIXTURES IN EQUIPMENT ROOMS TO BE INSTALLED AFTER ALL EQUIPMENT, PIPING, DUCTWORK, ETC. HAS BEEN INSTALLED SO AS NOT TO CREATE INTERFERENCES AND TO MAXIMIZE ILLUMINATION LEVELS.
- 16. THE BATTERY BACKUP SYSTEM SHALL MEET LOCAL REQUIREMENTS (MINIMUM 90 MIN. BACKUP TIME, TEST SWITCH & INDICATOR). BALLAST SELECTION FOR ALL FIXTURES SHALL BE COORDINATED WITH THE LIGHTING CONTROL MANUFACTURER BEFORE BID. PROVIDE DIMMING BALLAST AS IT IS INDICATED ON LIGHTING PLANS, MOUNTING METHOD AND HEIGHT FOR PENDANT-TYPE FIXTURES SHALL BE COORDINATED WITH THE ARCHITECT AND ARCHITECTURAL PLANS. PROVIDE PLENUM-RATED FIXTURE WHERE IT IS APPLICABLE. REFER TO MECHANICAL DRAWING FOR INFORMATION.

	SEAL WILLIAM	PROFESSIONAL CERTIFIC	CATION	AS-BUILT / REVISION		AS-BUILT / REVISION		AS-BUILT / REVISION B'		BY	DATE	P.W.A. NO.	KEY SHEET	POSITION SHT	DRAWIN	G SCALE			
		I HEREBY CERTIFY THAT THESE DOCUMENTS WERE PREPARED OR APPROVED BY ME, AND THAT I AM A DULY LICENSED		BID/PERMIT SET		(03.15.2024	-	-	-	PLAN SCALE:		APPROVED BY:_	PPROVED BY:					
	PROFESSIONAL ENGINEER UNDER THE LAW MARYLAND.							R.O.W NO.	-	-		-	DIR		DIRECTO				
			TE: 06-19-2025					-	-	-	PROFILE SCALE:	-	DATE:						
		ENGINEER:	DGN BY: CCJM	BUREAU OF ENGINEERING AND CONSTRUCTION		HIGHV	WAYS	STRUCTURES	STORM DRAINS	SEWER	WATER	FIELD ENGINEER	PROPE	ERTY MANAGEME	ENT				
	44664 NGMIII	ELECTRICAL ENGINEER C.C. JOHNSON & MALHOTRA, P.C. 400 EAST PRATT STREET. SUITE 604	DWN BY: CCJM	REVIEWED BY:									APPROVED BY:		CHIE				
	- Ta Dinwhi Ein	DALTIMODE MD 04000	CUKD BV. LINP	DATE REVIEWED:									DATE.		CITIE				

BALTIMORE COUNTY OFFICE OF BUDGET AND FINANCE, PROPERTY MANAGEMENT

BCPL - White Marsh

ELECTRICAL - SCHEDULES

8133 SANDPIPER CIRCLE BALTIMORE, MD 21226

ELECTION DIST. NO.:

E601 24066 PO0 JOB ORDER NUMBER 10611599 SHEET 29 OF 29 **** DRAWING NUMBER 2024-0354 FILE NO.: 10611599

SHEET DESIGNATION | CONTRACT NUMBER