

SYMBOL DESCRIPTION	SYMBOL	DESCRIPTION	SYMBOL	DESCRIPTION	SYMBOL	DESCRIPTION
G — G — G — GROUND WIRING OVERHEAD WIRING (BY UTILITY) UNDERGROUND WIRING CONDUIT TURNING UP UTILITY POLE TYPE "T" THERMIT GROUND WELD THERMIT GROUND WELD TO HORIZONTAL STEEL THERMIT GROUND WELD TO 6x250x400mm GROUND PLATE CEILING MOUNTED LUMINAIRE/POT LIGHT A - INDICATES TYPE (SEE SCHEDULE) WALL MOUNTED LUMINAIRE/POT LIGHT PENDANT OR STEM MOUNTED LUMINAIRE/POT LIGHT LUMINAIRE ON EMERGENCY CIRCUIT NL - INDICATES UNSWITCHED NIGHT—LIGHT EMERGENCY BATTERY PACK DUAL HEAD LIGHTING UNIT A - INDICATES WALL MOUNTED SUCH AS READY LITE LDX—VQ SERIES OR APPROVED EQUAL B - INDICATES CEILING MOUNTED SUCH AS READY LITE LDX—T SERIES OR APPROVED EQUAL EMERGENCY DUAL REMOTE HEAD LIGHTING UNIT VQ SERIES SINGLE—POLE LIGHT SWITCH A.T. — INDICATES ASTRONOMICAL TIMER SWITCH SUCH AS LEVITON VPT24—IPZ OR APPROVED EQUAL O.S. — INDICATES OCCUPANCY SENSOR SWITCH	\$ □ (((((((((((((((((((((((((((((((((((DIMMER SWITCH TIMER CLOCK SUCH AS INTERMATIC ET2725CP CEILING MOUNTED OCCUPANCY SENSOR)) — INDICATES ORIENTATION OF DETECTION POLE MOUNTED LUMINAIRE WITH ARM P — BASEBALL FIELD LIGHTING Q — PARKING LIGHTS (LUMINAIRE AND MOUNTING ARM SUPPLIED BY OTHERS) ALL OTHER MATERIAL (POLE, WIRING, MOUNTING HARDWARE, ETC), SUPPLIED, INSTALLED AND WIRED BY THIS CONTRACTOR 20A/125V, 5—20R DUPLEX RECEPTACLE QUAD RECEPTACLE OUTLET WITH COMMON COVER PLATE 15A/125V, 5—15R DUPLEX U—GROUND RECEPTACLE GFR — INDICATES GROUND FAULT CIRCUIT INTERRUPTER RECEPTACLE O.C. — INDICATES 150mm OVER BACKSPLASH W.P. — INDICATES WEATHERPROOF COVER WHILE—IN—USE HAND DRYER SURFACE MOUNTED SUCH AS DYSON AIRBLADE V LOCKABLE HP RATED TOGGLE DISCONNECT SWITCH WIRELESS DATA ACCESS POINT (DATA BY DIV.27, DEVICE BY OWNER) COMBINED DATA/TELEPHONE OUTLET CAT.6 50x100x100mm BOX C/W PLASTER RING, 27mm CONDUIT UP TO ACCESSIBLE CEILING SPACE, NYLON BUSHING AT END, CAT.6 TO COMMUNICATION RACK # — INDICATES NUMBER OF DROPS		DATA OUTLET CAT.6 50x100x100mm BOX C/W PLASTER RING, 27mm CONDUIT UP TO ACCESSIBLE CEILING SPACE, NYLON BUSHING AT END, CAT.6 TO COMMUNICATION RACK # — INDICATES NUMBER OF DROPS AUDIO SPEAKER SUCH AS TOA #F—1300BTWP C/W MOUNTING HARDWARE DOOR OPERATOR PUSHBUTTON (BY DIV.8, WIRED BY DIV.26) DOOR OPERATOR (BY DIV.8, WIRED BY DIV.26) DOOR KEYSWITCH (BY DIV.8, WIRED BY DIV.26) INTRUSION ALARM MOTION DETECTOR CCTV CAMERA A — INTERIOR DOME CAMERA B — EXTERIOR CAMERA SECURITY DOOR CONTACT (BY DIV.8, WIRED BY DIV.28) INTRUSION ALARM KEYPAD SECURITY PANEL ELECTRIC BASEBOARD HEATER A — INDICATES TYPE (SEE SCHEDULE) SURFACE MOUNTED ELECTRIC FORCED AIR HEATER A — INDICATES TYPE (SEE SCHEDULE) RECESS MOUNTED ELECTRIC FORCED AIR HEATER A — INDICATES TYPE (SEE SCHEDULE) ELECTRIC CEILING FORCED AIR HEATER A — INDICATES TYPE (SEE SCHEDULE)		MOTORIZED DAMPER (BY DIV.23, 120V WIRING BY DIV.26) # — INDICATES MECHANICAL EQUIPMENT NUMBER ELECTRICAL THERMOSTAT MECHANICAL LINE VOLTAGE RA — HONEYWELL T651A OR APPROVED EQUAL TP — TAMPER PROOF COVER LOW VOLTAGE THERMOSTAT (BY DIV.23) F.A. SMOKE DETECTOR JUNCTION BOX INFRARED DOOR SENSOR (BY DIV.8, WIRED BY DIV.2 SINGLE PHASE ELECTRIC MOTOR F — INDICATES FAN # — INDICATES HP PUSH BUTTON STATION (BY DIV.8, WIRED BY DIV.26) DISCONNECT SWITCH # — INDICATES DISCONNECT SIZE F — INDICATES FUSE SIZE W.P. — INDICATES NEMA 3R POWER TRANSFORMER UTILITY METER SOCKET FLOOR MOUNTED COMMUNICATION RACK C — INDICATES COMMUNICATION TEL. BACKBOARD DEMARCATION POINT BIX PANEL SURFACE MOUNTED ELECTRICAL PANELBOARD RECESS MOUNTED ELECTRICAL PANELBOARD



1435, RUE SAINT-ALEXANDRE, BUREAU 1000 MONTRÉAL (QUÉBEC) H3A 2G4 T. 514-393-9490 F. 514-393-9498 info@evoqarchitecture.com



#493-18-4A

Red Island Contractors Inc.

305, Route 390, Tobique First Nation, NB, E7H 4P7

1	ISSUED FOR CONSTRUCTION	L.N.	2022-09-23
0	ISSUED FOR TENDER	L.N.	2022-05-27
А	ISSUED FOR 50% REVIEW	J.O.	2021-06-18
Nº:	DESCRIPTION:	BY	DATE
REVISI	ON:		

GENERAL NOTES:

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- 3. THE GENERAL CONTRACTORSHOULD NOT TAKE SCALED MEASUREMENTS OFF THE
- 4. ANY INDIVIDUAL OR FIRM THAT HAVE RECEIVED ELECTRONIC DOCUMENT USE THEM AT THEIR OWN RISK. ONLY ORIGINAL DRAWINGS, STAMPED BY THE ARCHITECT, CAN BE USED FOR CONSTRUCTION.

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KCIW KNICANEWEK SPORTS AND RECREATION PARK - PHASE 2

DRAWING TITLE:

-ELECTRICAL-SITE PLAN & LEGEND


DESIGN: M. DOUCET APPROVED: M. DOUCET DRAWN: L. N. / J. O.

VERIFIED: M. DOUCET

PROJECT Nº: DRAWING Nº: 9223-18-00

SCALE: AS SHOWN

EVOQ ARCHITECTURE 2016 EMPLACEMENT FICHER: R:1Projectsl 2018/493-18-04 Phase 2 - 2021 KKSRP ilssued drawingsi 2022-09-23 Issued for Construction Electrical CaD483-18-4E1_Revi.dwg IMPRIMÉ LE: 2022-09-23 32901 PM

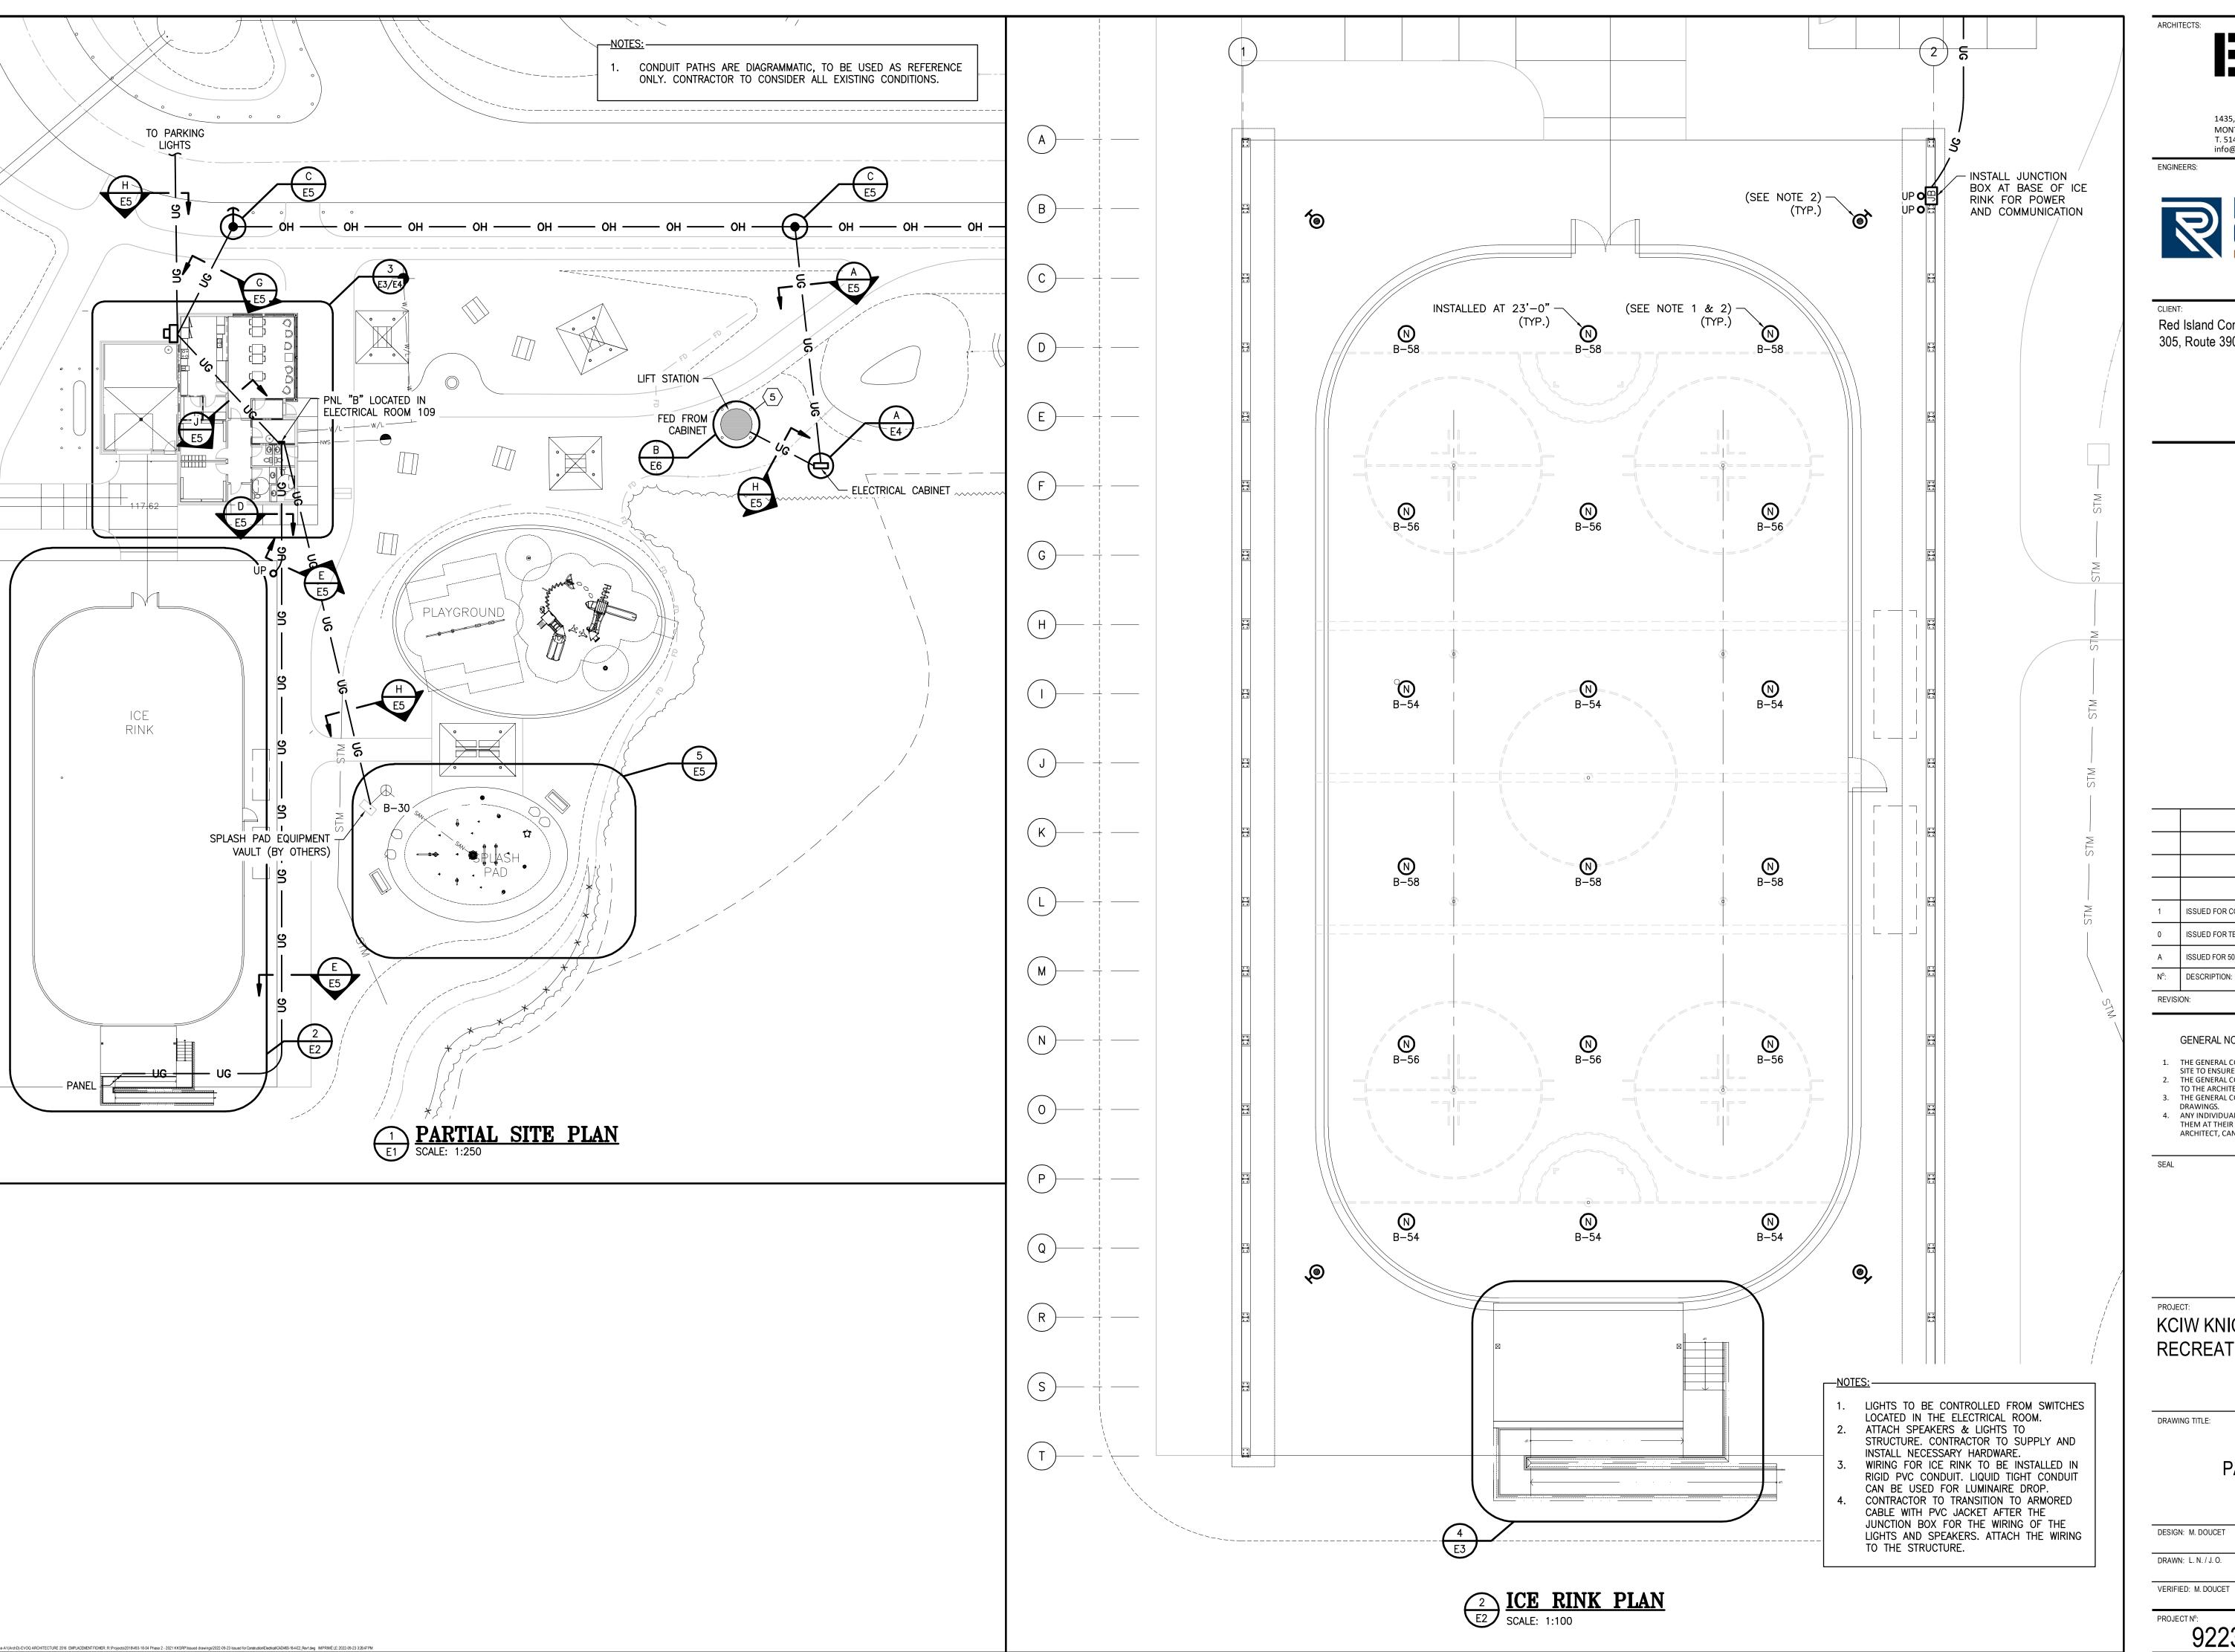

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KCIW KNICANEWEK SPORTS AND RECREATION PARK - PHASE 2

DRAWING TITLE:

-ELECTRICAL-PARTIAL SITE PLAN & ICE RINK PLAN


APPROVED: M. DOUCET DESIGN: M. DOUCET DATE: 2021-05-01 DRAWN: L. N. / J. O.


PROJECT Nº:

DRAWING N°: 9223-18-00

E2

SCALE: AS SHOWN

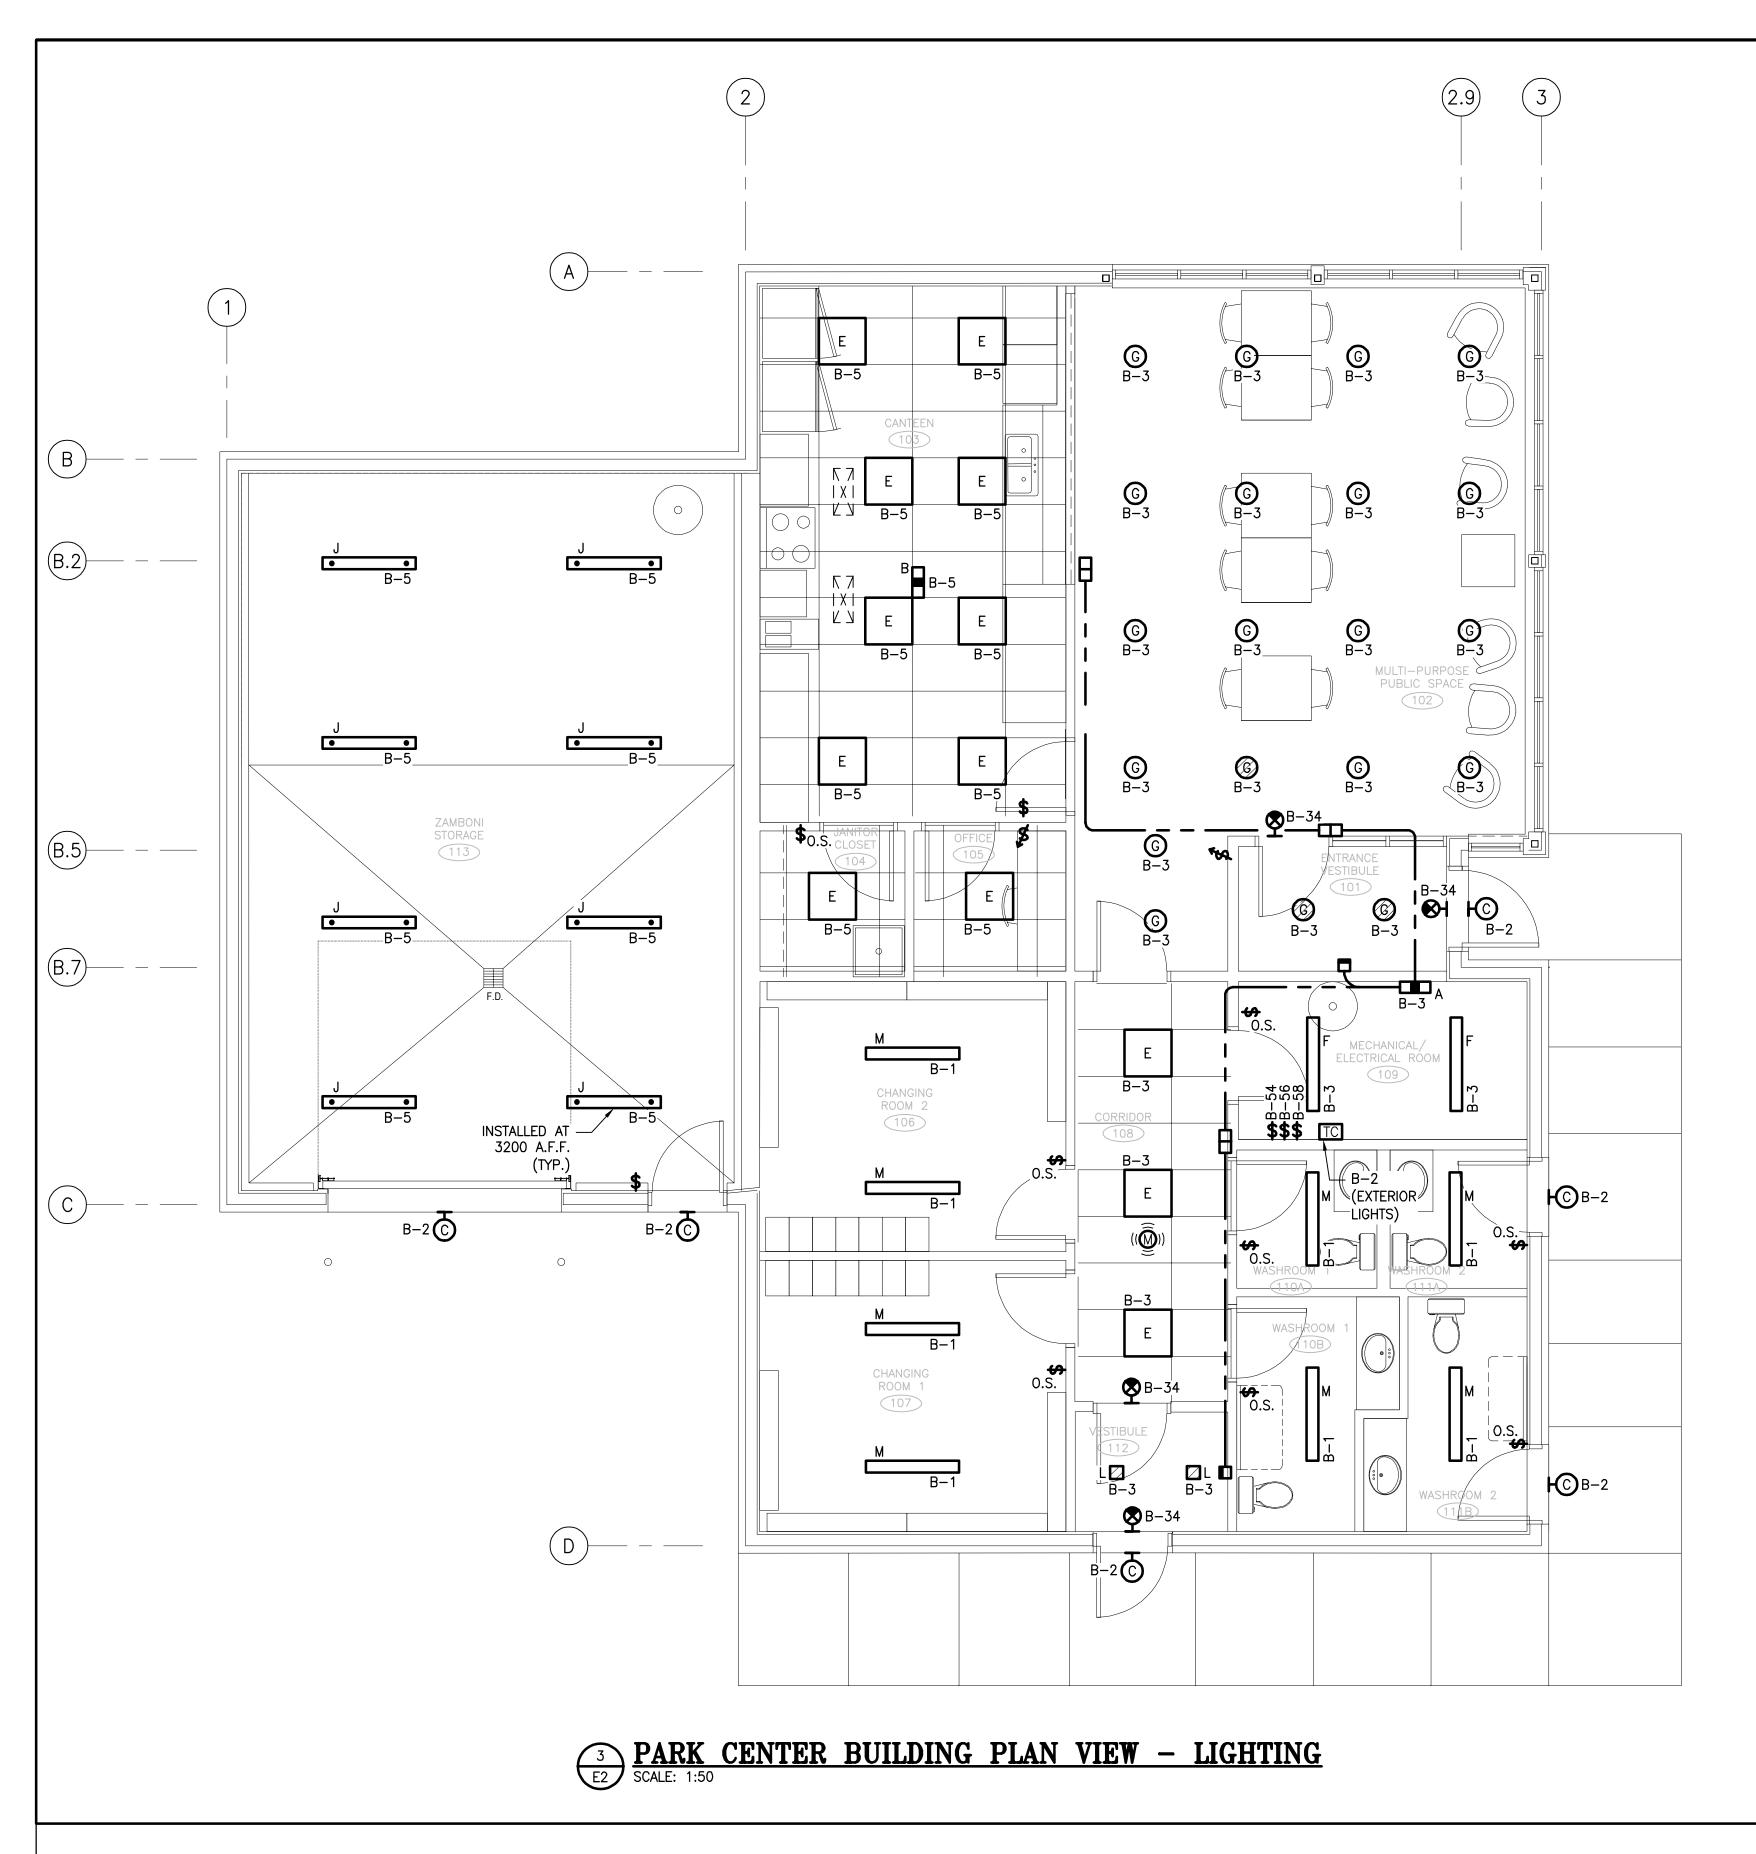

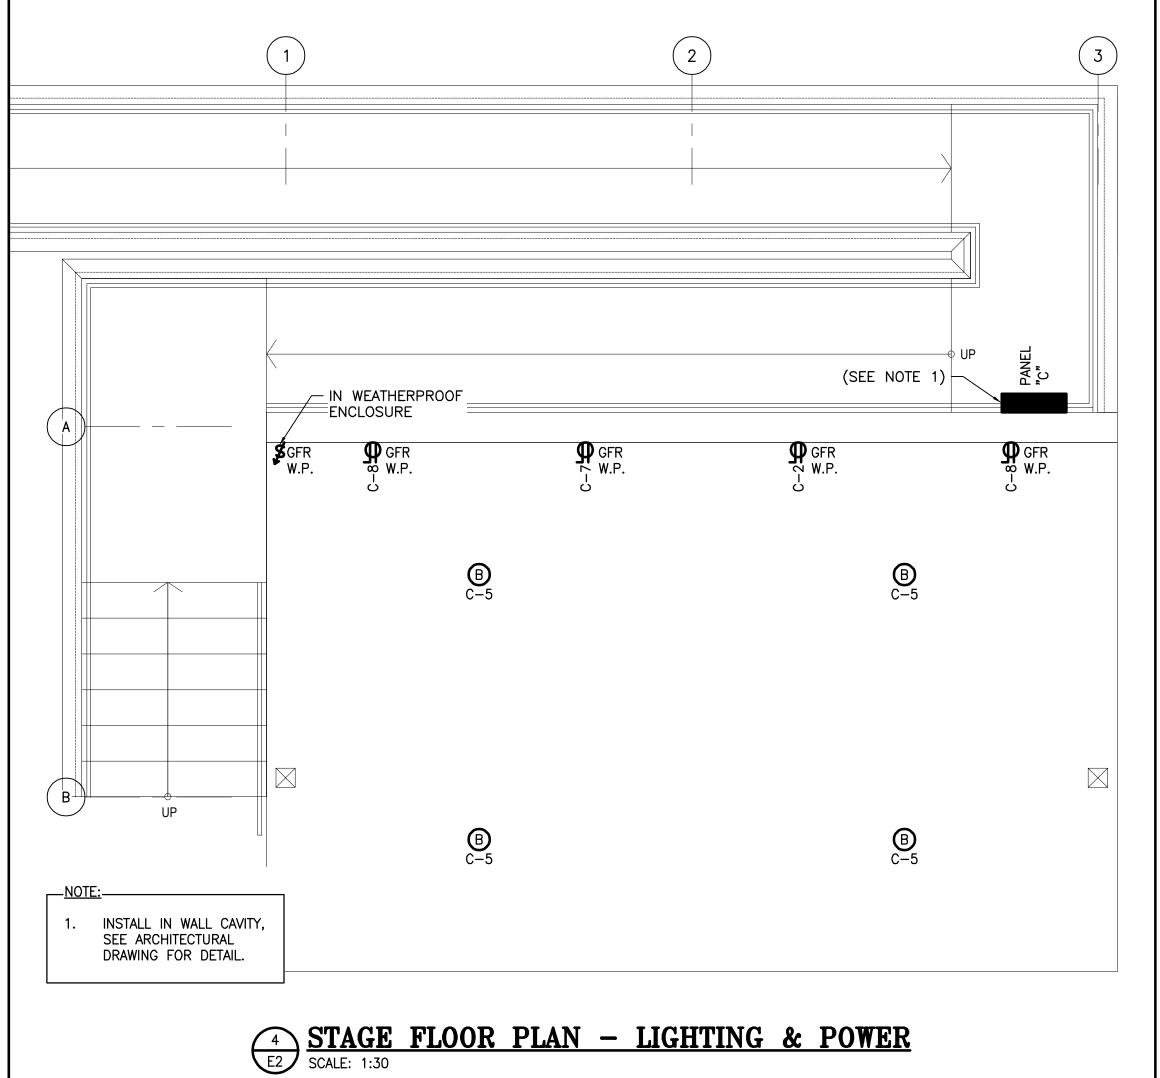

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KCIW KNICANEWEK SPORTS AND RECREATION PARK - PHASE 2

DRAWING TITLE:

-ELECTRICAL-**PLAN VIEWS** LIGHTING & POWER


DESIGN: M. DOUCET APPROVED: M. DOUCET DATE: 2021-05-01 DRAWN: L. N. / J. O. VERIFIED: M. DOUCET

PROJECT Nº:

DRAWING N°: 9223-18-00

E3

SCALE: AS SHOWN

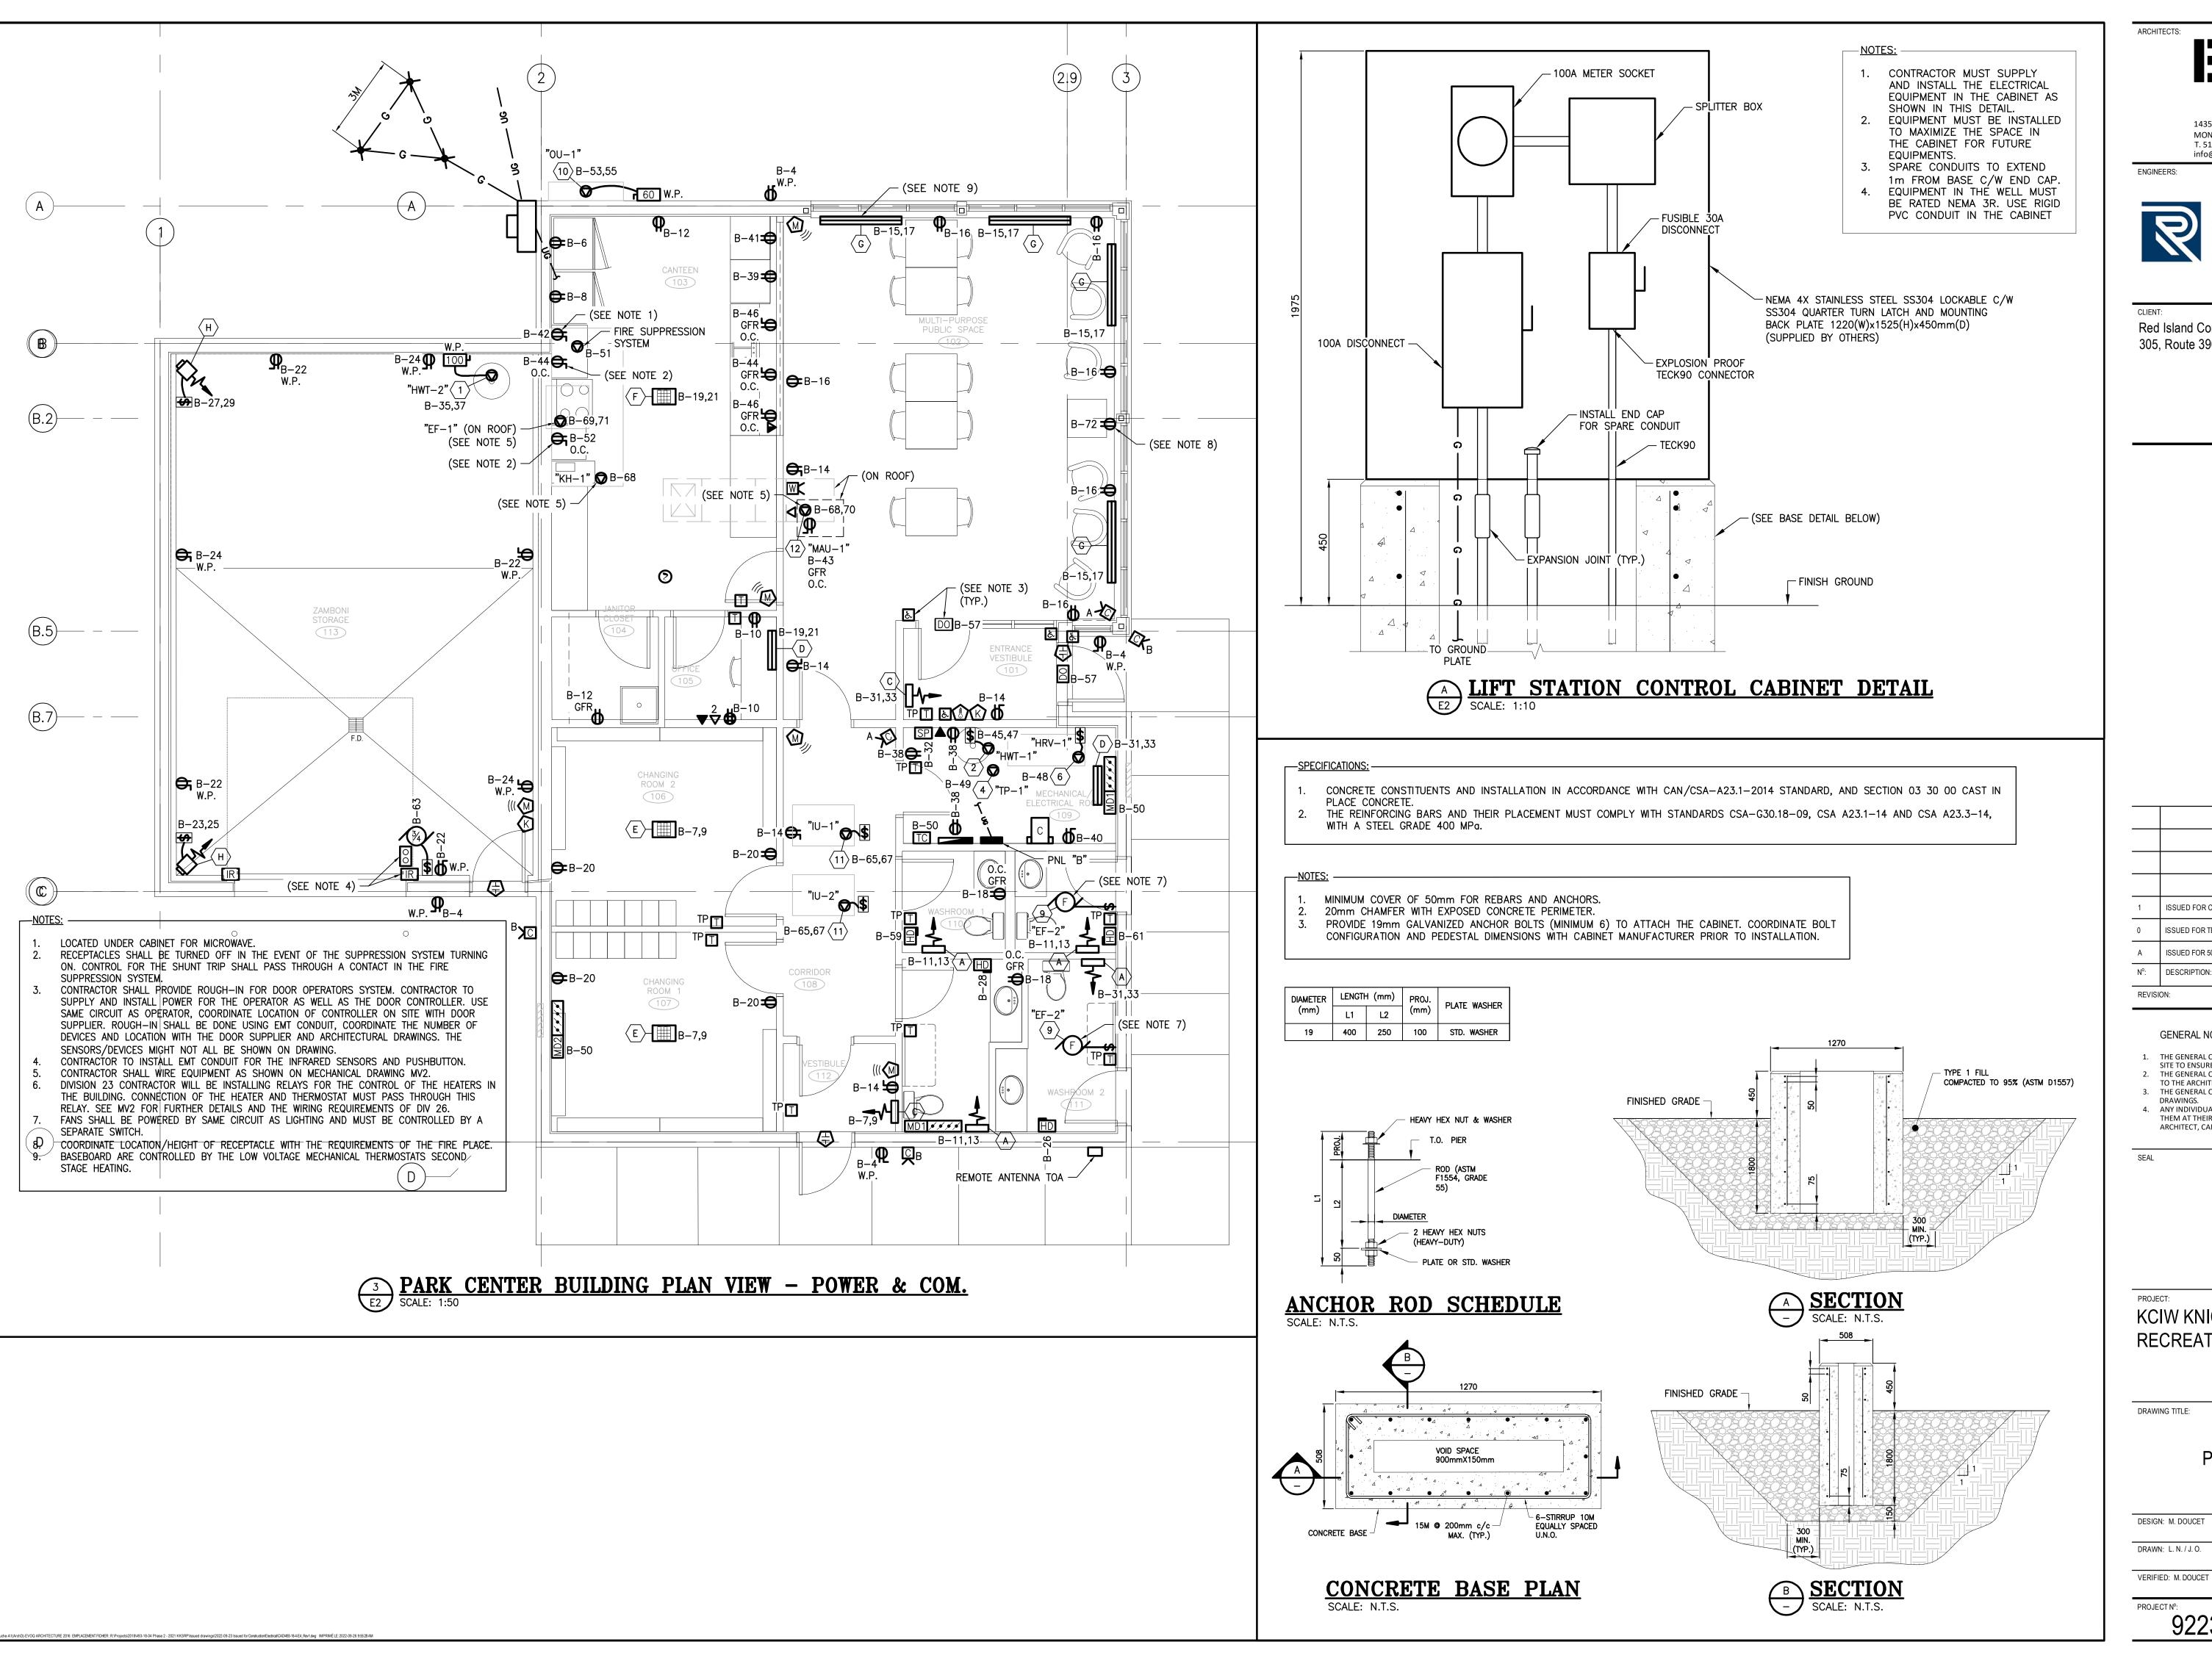

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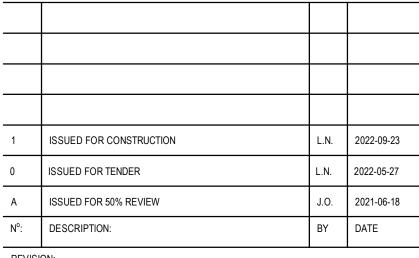
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KCIW KNICANEWEK SPORTS AND **RECREATION PARK - PHASE 2**


DRAWING TITLE:

-ELECTRICAL-PLAN VIEW POWER & COMMUNICATION

DESIGN: M. DOUCET APPROVED: M. DOUCET DRAWN: L. N. / J. O. DATE: 2021-05-01

DRAWING N°: 9223-18-00

SCALE: AS SHOWN

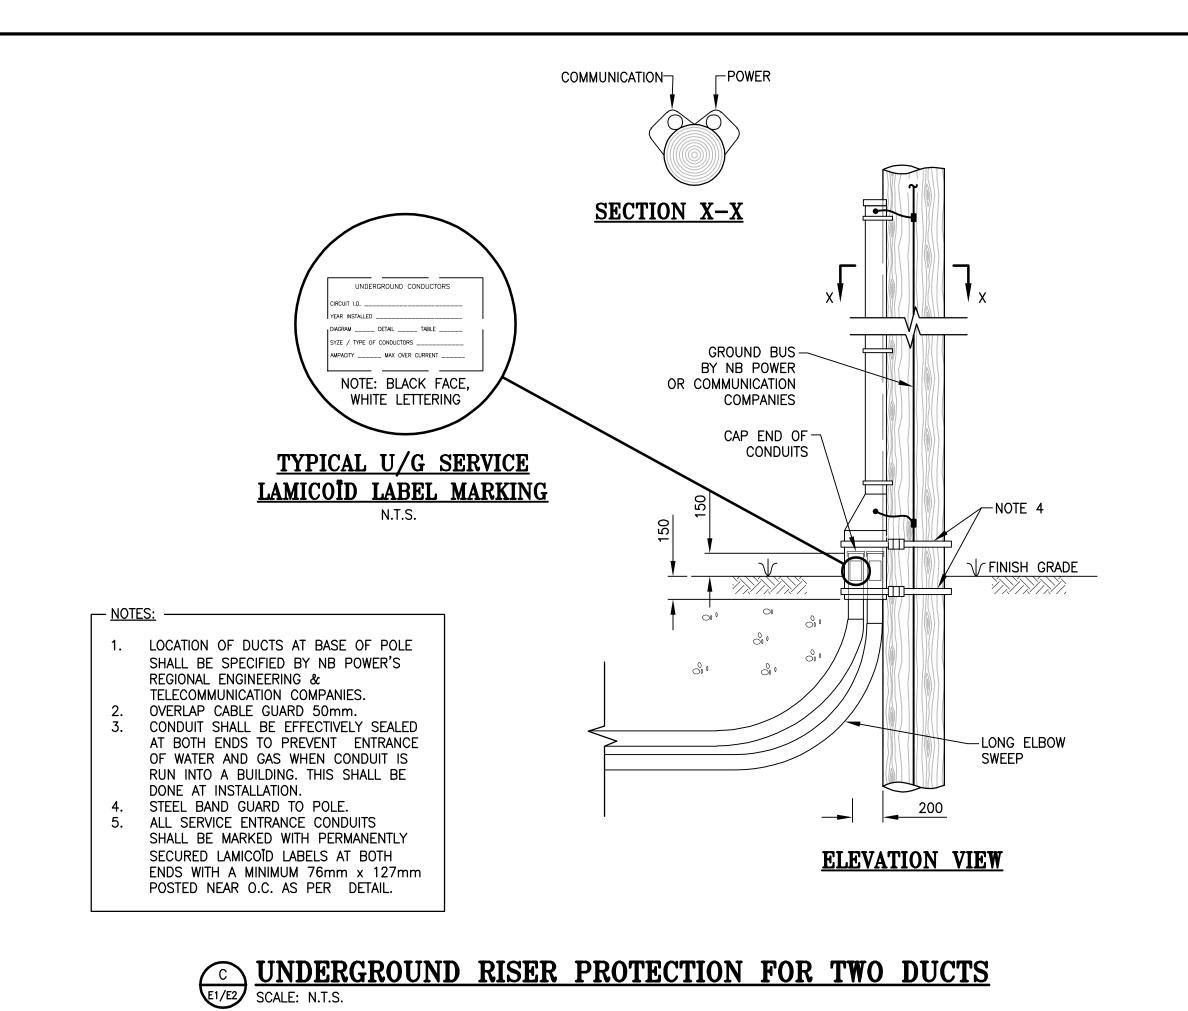

6mm NYLON ROPE OR EQUIVALENT SHALL BE INSTALLED AND SECURED IN EACH CONDUIT.

BACKFILL PARTICLES SHALL BE LESS THAN 38mm AND BACKFILL SHALL BE COMPACTED TO AT

WELL

COMPACTED


BACKFILL

- ELECTRICAL WARNING


DETECTABLE MARKER

ALL DUCTS SHALL BE PROPERLY IDENTIFIED AT BOTH ENDS WITH LAMICOÏD PLATES.

LEAST 95% MAXIMUM DENSITY TO ASTM D698.

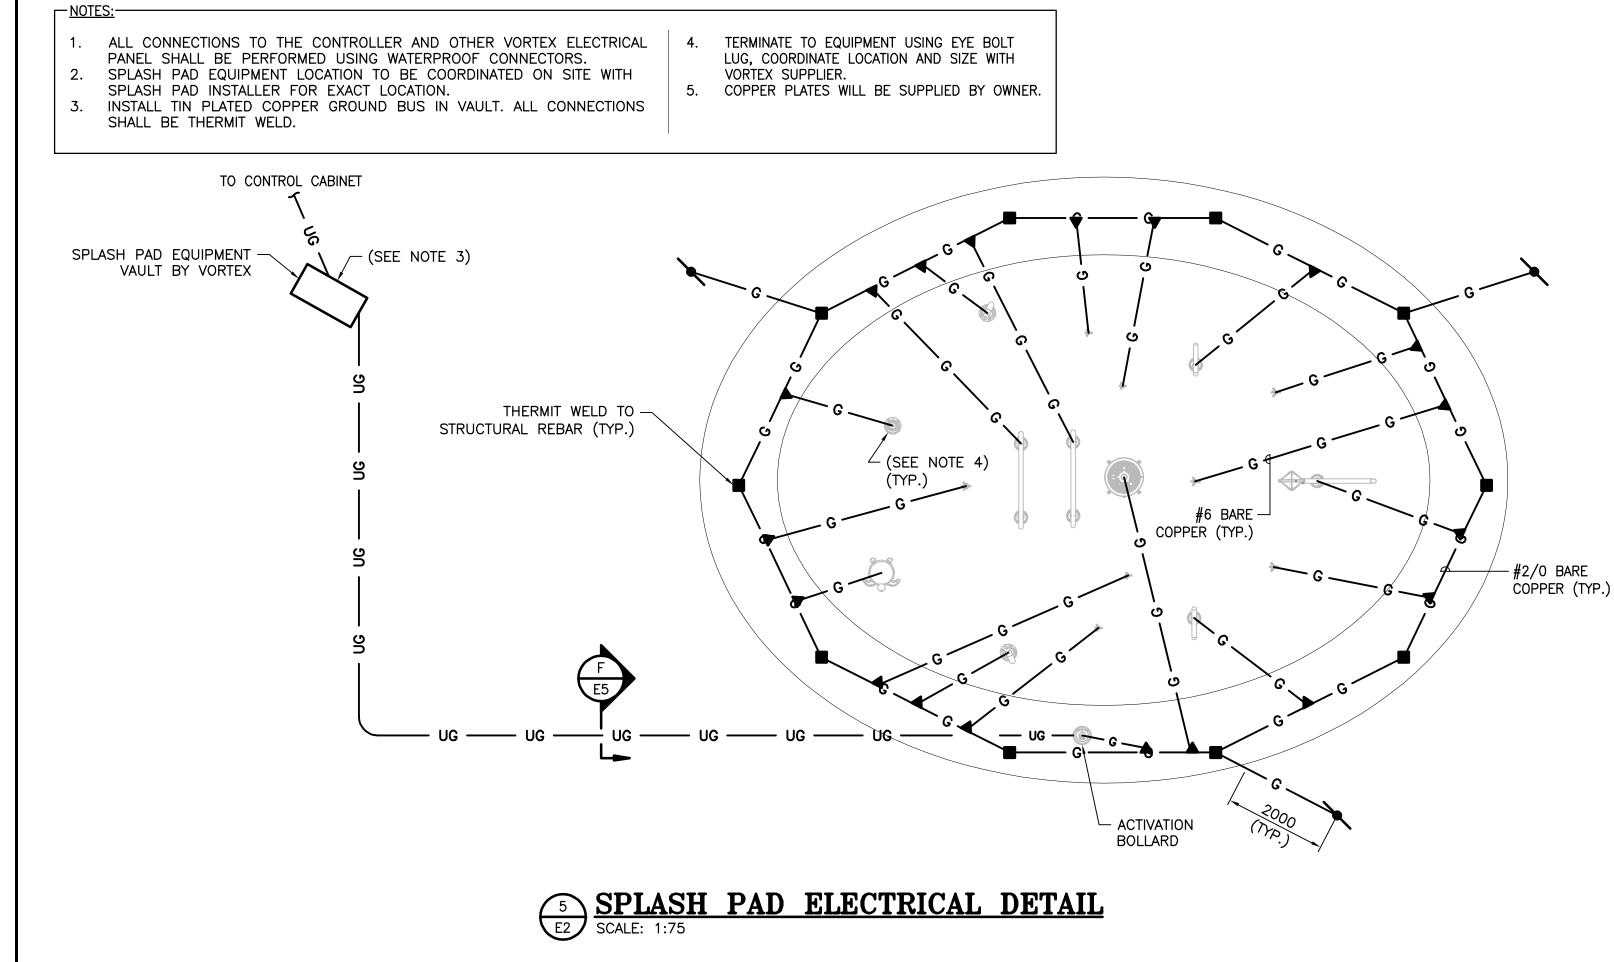

CONFIRM EXACT LOCATION OF DISCONNECT, GROUND BUS & ELECTRICAL ENTRY POINT WITH MANUFACTURER'S SHOP DRAWINGS PRIOR TO ROUGH-IN. 2. CONFIRM TERMINAL CONNECTIONS IN CONTROLLER WITH MANUFACTURER'S SHOP DRAWINGS PRIOR TO ROUGH-IN. ALL CONNECTORS & INSTALATION IN VAULT SHALL BE WATERPROOF. WIRING FOR ACTIVATION BOLLARD FROM CONTROLLER PROVIDED BY VORTEX, INSTALLED BY THIS CONTRACTOR. 5. INSTALL DISCONNECT IN VAULT IF POSSIBLE. IF NOT, INSTALL IT ON THE EXTERIOR OF THE VAULT. UNDERGROUND GFCI CIRCUIT FROM ELECTRIC PANEL 2C#10 & BOND RWU90 IN - 8C#22 AWG IN 41mm CONDUIT RIGID PVC CONDUIT 53mm SPLASH PAD VAULT (SUPPLIED BY OTHERS) (NEMA 4X) ACTIVATION BOLLARD → GROUNDING PLATE CONTROLLER (SUPPLIED BY OTHERS) TO GROUND (SUPPLIED BY OTHERS) #2/0 GROUND WIRE -SPLASH PAD ELECTRICAL SCHEMATIC

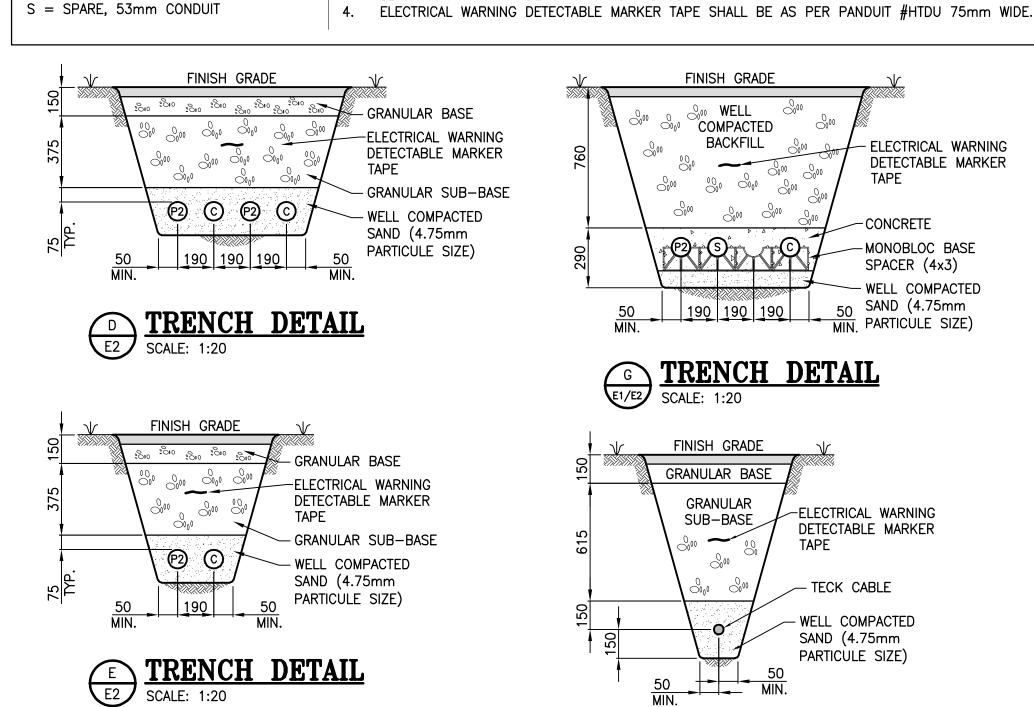

- GRANULAR BASE

-ELECTRICAL WARNING

GRANULAR SUB-BASE

-#2/0 GROUND WIRE

(SPLASH PAD)

TRENCH DETAIL

E5 SCALE: 1:20

WELL COMPACTED SAND (4.75mm PARTICULE SIZE)


DETECTABLE MARKER TAPE

P1 = POWER, 41mm RIGID PVC CONDUIT

P2 = POWER, 103mm RIGID PVC CONDUIT

P3 = POWER, 53mm RIGID PVC CONDUIT

C = COMMUNICATION, 53mm CONDUIT

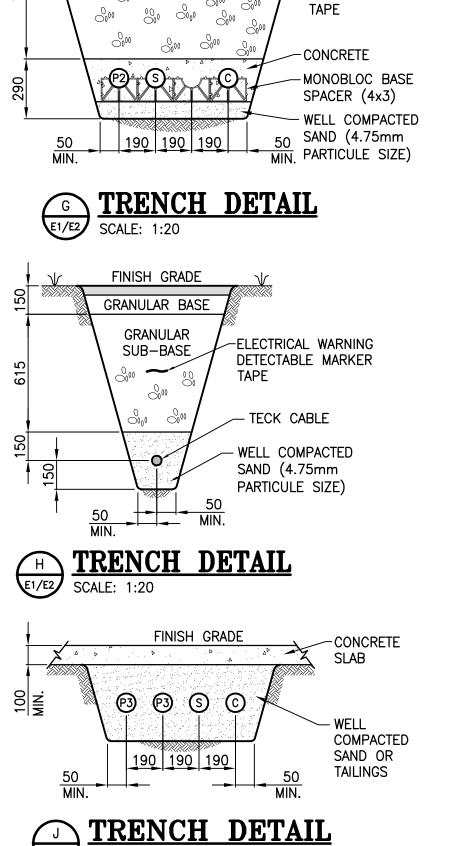

SCALE: N.T.S.

FINISH GRADE

○ WELL ○ COMPACTED ॐ

BACKFILL

TRENCH DETAIL
SCALE: 1:20

ELECTRICAL WARNING

DETECTABLE MARKER

-CONCRETE

-MONOBLOC BASE

SPACER (4x3)

50 SAND (4.75mm MIN. PARTICULE SIZE)

WELL COMPACTED

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ENGINEERS:



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Red Island Contractors Inc. 305, Route 390, Tobique First Nation, NB, E7H 4P7

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KCIW KNICANEWEK SPORTS AND **RECREATION PARK - PHASE 2**


DRAWING TITLE:

-ELECTRICAL-**DETAILS**

DESIGN: M. DOUCET	APPROVED:	M. DOUCET
DRAWN: L. NOEL	DATE:	2021-05-01
VERIFIED: M DOUCET	SCALE: AS SE	IOWN

PROJECT Nº:

DRAWING N°: 9223-18-00

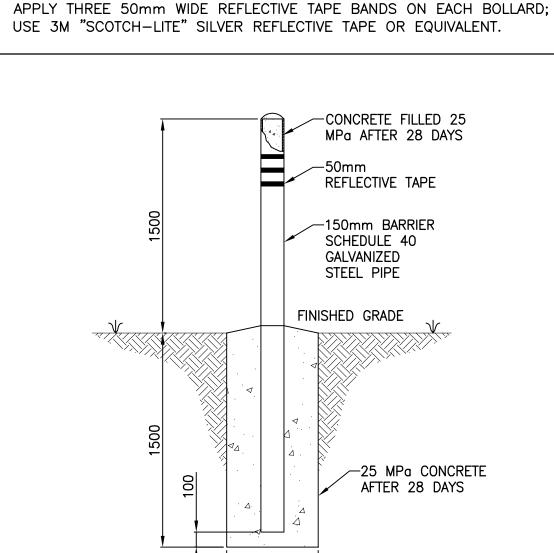

PAINT BARRIER BOLLARDS WITH TWO COATS OF "SAFETY YELLOW". PAINT


OVER A SUITABLE PRIMER. YELLOW POLYETHYLENE SLEEVES, SUCH AS

THE ARMORCAST "GUARDIAN SLEEVE" MAY BE USED INSTEAD OF


PAINTING. INSTALL AT APPROXIMETLY 1.5m FROM ENCLOSURE.

TYPICAL BARRIER BOLLARD DETAIL

- THE DRAWINGS ARE DIAGRAMMATIC AND INDICATE GENERAL LOCATIONS FOR ELECTRICAL EQUIPMENT. THE CONTRACTOR SHALL VERIFY ALL EQUIPMENT LOCATIONS ON SITE PRIOR TO INSTALLATION.
- 2. ALL EXPOSED WIRING IN EMT CONDUIT. CONCEALED WIRING SHALL BE SUPPORTED
- FLOOR PLANS HAVE PRECEDENCE OVER THIS RISER FOR DEVICE COUNT: THE RISER IS DIAGRAMMATIC ONLY FOR OPERATION/ZONING PURPOSES ONLY AND NOT A WIRING DIAGRAM.
- CONTRACTOR SHALL SUPPLY ALL THE NECESSARY MATERIALS TO OBTAIN COMPLETE FUNCTIONAL SYSTEM.

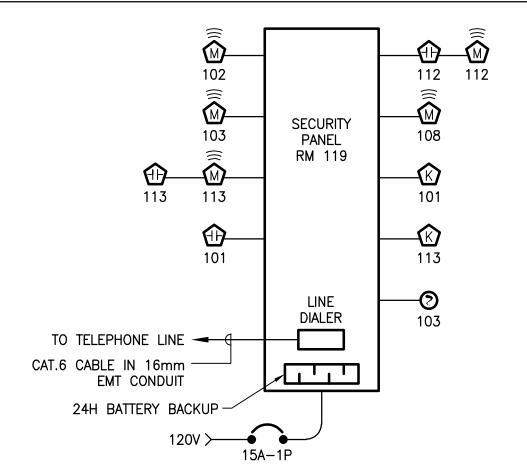

SECURITY RISER DIAGRAM

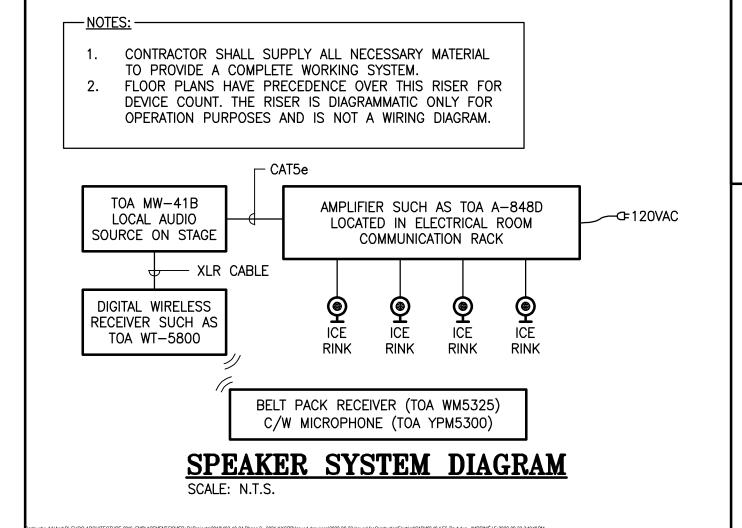

WIRE & CONDUIT TABLE

1 4C#3 AWG RWU90 IN 53mm RIGID PVC CONDUIT

2 4C#3 AWG RW90 & BOND IN 53mm RIGID PVC CONDUIT


3 1C#6 AWG RW90 GREEN & BOND IN 21mm RIGID PVC CONDUIT

(4) 3C#10 TECK90

5 WIRE SUPPLIED BY DIV.22, INSTALLED BY DIV.26

3C#10 AWG RW90 & BOND IN 6 21mm CONDUIT + 4C#12 AWG RW90 & BOND IN 21mm CONDUIT

7 10C#12 AWG RW90 IN 27mm CONDUIT

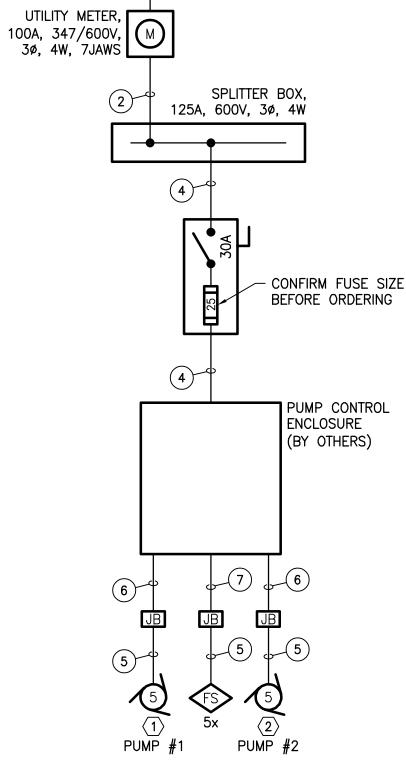

FROM NB POWER

FUSED DISCONNECT SWITCH


(SERVICE ENTRANCE RATED)

LIFT STATION SINGLE LINE DIAGRAM

WIRE & CONDUIT TABLE


- 1 3C#500 MCM RWU90-CU & BOND IN 104mm RIGID PVC CONDUIT
- 2 1C#6 AWG RW90 GREEN INSULATED GROUND IN 16mm RIGID PVC CONDUIT
- (3) 1C#2/0 AWG BARE COPPER CABLE

DE	MAND TA	BLE
LOADS	CONNECTED (W)	DEMAND (W)
MECH.	28200	21200
BASE	12000	12000
HEATING	25000	22000
OTHER	11500	11500
TOTAL:	76700	66700

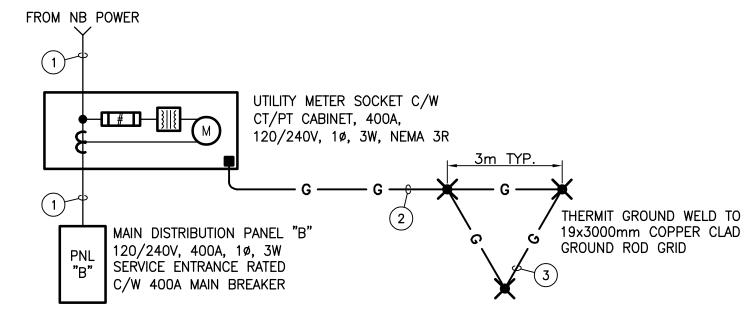


PARK CENTER BUILDING SINGLE LINE DIAGRAM

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- ALL EXPOSED WIRING IN EMT CONDUIT. CONCEALED WIRING SHALL BE SUPPORTED BY J-HOOKS. FLOOR PLANS HAVE PRECEDENCE OVER THIS RISER FOR DEVICE COUNT: THE RISER IS
- DIAGRAMMATIC ONLY FOR OPERATION/ZONING PURPOSES ONLY AND NOT A WIRING DIAGRAM. CONTRACTOR SHALL SUPPLY ALL THE NECESSARY MATERIALS TO OBTAIN A COMPLETE

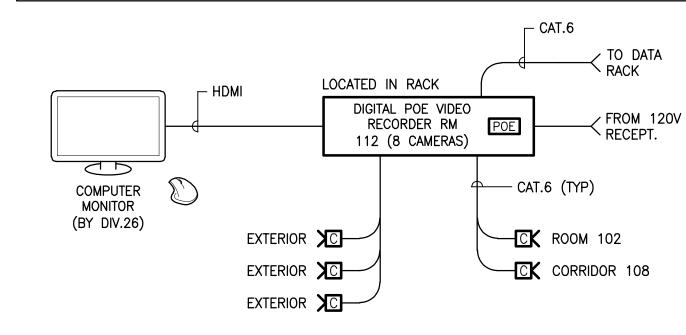


CCTV SYSTEM DIAGRAM

REFER TO MECHANICAL DRAWINGS FOR ELEVATIONS. ADD UNISTRUTS AS REQUIRED TO SUPPORT CONDUITS/CABLE AND PANEL/BOX.

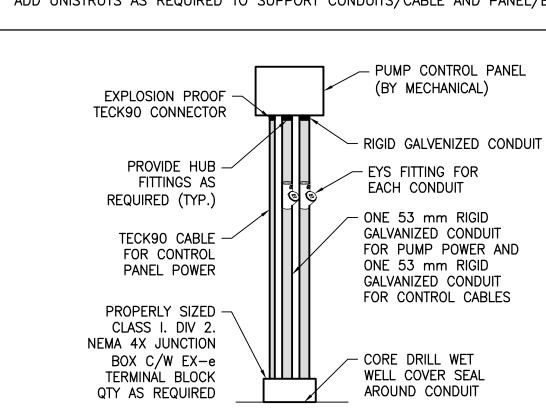

PUMP CONTROL PANEL ELEVATION VIEW N.T.S.

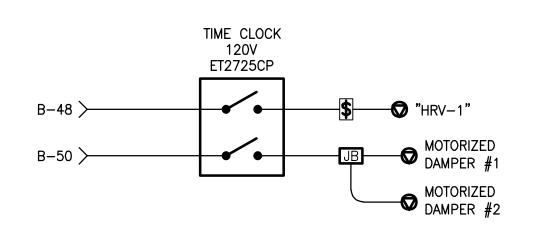

HRV TIME CLOCK CONTROL DIAGRAM SCALE: N.T.S.



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KCIW KNICANEWEK SPORTS AND **RECREATION PARK - PHASE 2**

DRAWING TITLE:

-ELECTRICAL-**DETAILS &** DIAGRAMS

DESIGN: M. DOUCET APPROVED: M. DOUCET DRAWN: J. OUEDRAOGO DATE: 2021-05-01

VERIFIED: M. DOUCET SCALE: AS SHOWN

PROJECT Nº:

DRAWING N°: 9223-18-00

		MEC	CHANI	CAL	EQU	JIPM	ENT	CONN	ECTION	N SCH	EDULE		
TAG	LOCATION	DESCRIPTION	VOLTAGE/ PHASE	HP/kW	MCA/FLA	MOP/OPD	STARTER SUPPLIED BY	STARTER TYPE	DISCONNECT MEANS	BREAKER /PANEL	POWER WIRING	INTERLOCK WITH	COMMENTS
1	ZAMBONI STORAGE	HOT WATER TANK "HWT-2"	240/1	12kW	50FLA				DIV.26	70A-2P/ PNL "B"	2C#4 AWG NMD90		
2	MECH. ELEC. ROOM 109	HOT WATER TANK "HWT-1"	240/1	4.5kW	12.5FLA				DIV.26	25A-2P/ PNL "B"	2C#10 AWG NMD90		
3													
4	MECH. ELEC. ROOM 109	TRAP PRIMER "TP-1"	120/1							15A-1P/ PNL "B"	2C#12 AWG NMD90		
(5)	EXTERIOR	LIFT STATION	600/3	10HP		25A	DIV.23		DIV.23	25A-3P	3C#10 AWG TECK90		
(6)	MECH. ELEC. ROOM 109	HEAT RECOVERY VENTILATION UNIT "HRV-1"	120/1		12MCA	20A			DIV.26	20A-1P/ PNL "B"	2C#12 AWG NMD90	"MD-1" & "MD-2"	
7	MECH. ELEC. ROOM 109, 107	MOTORIZE DAMPER "MD-1" & "MD-2"	120/1	50W						15A-1P/ PNL "B"	2C#12 AWG NMD90	"HRV-1"	
8	CANTEEN 103	KITCHEN EXHAUST "EF-1"	240/1	1.5HP	10FLA		DIV.23		DIV.23	25A-2P/ PNL "B"	2C#10 AWG TECK90		
9													
(10)	EXTERIOR	OUTDOOR UNIT "OU-1"	240/1			45A			DIV.26	45A-2P/ PNL "B"	2C#8 AWG NMD90		
(11)	CORRIDOR 109	INDOOR UNIT "IU-1" & "IU-2"	240/1						DIV.26	15A-2P/ PNL "B"	2C#12 AWG NMD90		
(12)	ROOT	MAKE UP AIR "MUA-1"	240/1	¾ HP	6.9FLA		DIV.23		DIV.23	15A-2P/ PNL "B"	2C#12 AWG NMD90		

POWER SUPPLY: 120/240	V. 1ø	-3W									Α	В
MAINS: 100A MAIN BREAKE			- F	'NT	RAN	CF	R	ΔTFD	NFM	IA 3R	430	1,000
BRANCH BREAKERS: 24 CC	-					о _		1120	, , , , ,	,,,		•
DESCRIPTION	LOAD	BRKR	CCT		N		ССТ	BRKR AMPS	LOAD		DESCRIPTION	I
SPARE	0	15	1	-	—	\vdash	2	20	200	RECEPTACLE	STAGE	
SPARE	0	15	3	_		-	4	15	400	RECEPTACLE		
LIGHTING STAGE	230	15	5	—	•		6	15	0	SPARE		
RECEPTACLE STAGE	200	20	7			-	8	20	400	RECEPTACLE	STAGE	
	0		9	-	-		10		0			
	0		11	_		_	12		0			
	0		13	ľ	-		14		0			
	0		15	_	•		16		0			
	0		17	-	-		18		0			
	0		19				20		0			
	0		21	⊸	-		22		0			
	0		23	_	 	-	24		0			

MCA = MINIMUM CIRCUIT	AMPACITY FLA = FUL	L LOAD AMPS I	MOP = MAXIMUM OVERCUR	RENT PROTECTION	OPD = OVERCURRENT F	PROTECTION DEVICE
H-O-A = HAND-OFF-AU1	O-A = OFF-AUTO	T-O-A = TES	ST-OFF-AUTO			

REPORTED TO CONSULTANT FOR REVIEW. INSTALL NMD WIRING IN FLEXIBLE METAL CONDUIT/LIQUID TIGHT CONDUIT WHEN EXPOSED FOR FINAL CONNECTION.

	LUMINAI	RE SCH	HEDULE				
TYPE	DESCRIPTION	MANUFACTURER	MODEL #	VOLTAGE	LAMP TYPE	WATTAGE	LUM/HOUR
A • •	1168X81mm SUSPENDED MOUNTED LED LUMINAIRE, CODE—GAUGE STEEL C/W SENSOR AT 10FT ABOVE FINISHED FLOOR, DAMP LOCATION	LITHONIA LIGHTING	BLWP4-40L-ADP-GZ10- LP835-MSD7ADCX	120V	LED 3500K CRI>80	39.5	4124/ 60000
B	260mm PENDANT THREAD MOUNT LED LUMINAIRE, DOWNLIGHT, HEAVY—GAUGE ALUMINUM HOUSING, 0—10V DIMMING, 45° SWIVEL	LITHONIA LIGHTING	LDN6CYL-35-50-L06-AR-LSS- MVOLT-GZ1-PM-WL-CRS	120V	LED 3500K CRI>80	57.7W	4975/ 60000
©	229x329mm WALL PACK LED LUMINAIRE, PRIMSATIC GLASS LENSE, LOW MAINTENANCE, RUGGED CAST—ALUMINUM HOUSING	LITHONIA LIGHTING	ARC2-LED-P4-30K- MVOLT-DBLXD OPTION: FAO	120V	LED 3000K CRI>80	30W	3903/ 100000
	94x110mm WALL MOUNTED LED LUMINAIRE, CAST—ALUMINUM HOUSING, POLYCARBONATE LENS, WET LOCATION	LITHONIA LIGHTING	OLLWD-LED-P1-40K- MVOLT-DDB	120V	LED 4000K CRI>80	9W	533/ 50000
E	600X600mm LUMEN LED FLAT PANEL, ALUMINUM FRAME, DAMP LOCATION, ADJUSTABLE LUMEN	LITHONIA LIGHTING	CPANL-2X2-24/33/44LM- 35K-24LM	120V	LED 3500K CRI>80	20W	2400/ 60000
F	1168x81mm SURFACE MOUNTED LED LUMINAIRE, CODE—GAUGE STEEL, DAMP LOCATION	LITHONIA LIGHTING	WL4-40L-EZ1-LP835	120V	LED 3500K CRI>80	39.5	4124/ 60000
<u>©</u>	170mm LED RECESSED DOWNLIGHT LUMINAIRE, ALUMINUM DIE CAST CONSTRUCTION WITH DETACHED HIGH EFFICIENCY DRIVER TO ALLOW SHALLOW CEILING INSTALLATION, WET LOCATION RATED	LITHONIA LIGHTING	WF8-SWW5-90CRI-MW	120V	LED 3500K CRI>80	19.7W	1649/ 50000
Ψ	114.3mm SCOUT WALL MOUNTED ARCHITECTURAL LUMINAIRE, 0-10V DIMMING, EXTRUDED ALUMINIUM HEATSINK, WHITE FINE TEXTURE C/W WHITE CABLE	EUREKA LIGHTING	3049-10-LED-35-80- 120-DV-WI-FRO-WHE-WHE	120V	LED 3500K CRI>80	13.7W	1472/ 50000
J	1168X81mm SUSPENDED MOUNTED LED LUMINAIRE, DAMP LOCATION	LITHONIA LIGHTING	BLWP4-48L-ADP-GZ10-LP835	120V	LED 3500K CRI>80	40W	5137/ 60000
К	254x254mm SURFACE MOUNTED LED LUMINAIRE, CAST—ALUMINIUM CONSTRUCTION, 0—10V DIMING, WET LOCATION	LITHONIA LIGHTING	CNYLED-PO-4000K- MVOLT-DDB	120V	LED 4000K CRI>80	27W	3500/ 50000
L	170mm LED RECESSED DOWNLIGHT LUMINAIRE, ALUMINUM DIE CAST CONSTRUCTION WITH DETACHED HIGH EFFICIENCY DRIVER TO ALLOW SHALLOW CEILING INSTALLATION, WET LOCATION RATED	LITHONIA LIGHTING	WF6-SQ-S-LED-40K-MVOLT	120V	LED 4000K CRI>80	13.9W	920/ 36000
М	305X1220mm LUMEN LED FLAT PANEL, ALUMINUM FRAME, DAMP LOCATION C/W SURFACE MOUNT KIT, ADJUSTABLE LUMEN & CRI	LITHONIA LIGHTING	CPANL-1x4-ALO1-SWW7- M4-DGA14 ACC: DCMK14	120V	LED 3500K CRI>80	38.7W	4881/ 60000
N	330mm SUSPENDED LED HIGH BAY LUMINAIRE, WHITE DIE-CAST ALUMINUM HOUSING, WET LOCATION (IP65), C/W WIRE GUARD.	LITHONIA LIGHTING	JEBL-24000LM-GL- MVOLT-40K-80CRI ACC: WGX	120V	LED 4000K CRI>80	174W	24181, 54000

			HE	ATER	SC SC	HF	DULE		
TYPE	DESCRIPTION	MANUFACTURER	MODEL	VOLTAGE	WATTS	PH	MOUNTING	CONTROLS	COMMENTS
(A)	WALL FAN HEATER	OUELLET	0VS0752	240	750	1	WALL	LINE VOLTAGE THERMOSTAT	SURFACE MOUNT KIT
B	UNIT HEATER	OUELLET	OAE2000 AM-EO-TB6	208	1500	1	WALL	BUILT-IN	
(C)	WALL FAN HEATER	OUELLET	OAC1500-T	240	1500	1	WALL	LINE VOLTAGE THERMOSTAT	SURFACE MOUNT KIT
(D)	BASEBOARD	OUELLET	OFM 0750	240	750	1	WALL	LINE VOLTAGE THERMOSTAT	
(E)	CEILING FAN HEATER	OUELLET	OACP1500	240	1500	1	CEILING	LINE VOLTAGE THERMOSTAT	
F	CEILING FAN HEATER	OUELLET	OACP3000	240	3000	1	CEILING	LINE VOLTAGE THERMOSTAT	
G	BASEBOARD	OUELLET	OFM 1250	240	1250	1	WALL	24V CONTROL	
$\langle H \rangle$	UNIT HEATER	OUELLET	OAE3000 AM-EO-TB6	240	3000	1	WALL	BUILT-IN	

NUMBER, CONTACT CONSULTANT PRIOR TO TENDER CLOSING.

NEW PANEL "B"		71								Α	В	#PRL1a C
POWER SUPPLY: 120/240	V, 1ø	-3W									_	
MAINS: 400A C/W 400A M	AIN BF	REAK	ER,	. 2	22kAl	С				27,175	23,780	28,860
BRANCH BREAKERS: 84 CC	T, 10k	(AIC										
DESCRIPTION	LOAD	BRKR	ССТ		-N		CCT	BRKR AMPS	LOAD		DESCRIPTION	
LIGHTS WASHROOMS & CHANGING RM	310	15	1	-	•		2	15	180	OUTDOOR L	IGHTING	
LIGHTS ROOMS 112, 108, 102, 101, 109	560	15	3	_		ightharpoons	4	15	600	OUTDOOR R	ECEPTACLE	
LIGHTS ROOMS 103, 104, 105, 113	525	15	5	_		-	6	15	720	REFRIGERATO	OR	
HEATING ROOM 106, 107, 112	2250	30	7	_		-	8	15	1200	REFRIGERATO	OR	
11EATING ROOM 100, 107, 112	2250	2P	9	-		_	10	15	600	RECEPTACLE	OFFICE 105	
HEATING WASHROOM 110 & 111	2250	30	11	_	-		12	15	400	RECEPTACLE	JANITOR CLOSE	ET & KITCHEN
TIENTING WASHINGOM TTO & TTT	2250	2P	13	_			14	20	200	HOUSEKEEPI	ING RECEPTAG	CLE
HEATING ROOM 102	2500	30	15	_		┢	16	15	1200	RECEPTACLE	MULTI-PURF	POSE
	2500	2P	17	-			18	20	400	RECEPTACLE	S WASHROOM	IS
HEATING ROOM 103, 104 & 105	2250	30	19	_		_	20	15	400	RECEPTACLE	S CHANGING	ROOM
	2250	2P	21	_			22	20	600	RECEPTACLE	S ZAMBONIE	
HEATING ZAMBONI STORAGE	1500	20	23	_		┷	24	20	600	RECEPTACLE	S ZAMBONIE	
	1500	2P	25	_			26	15	1000	HAND DRYE		
HEATING ZAMBONI STORAGE	1500	20	27	_			28	15	1000	HAND DRYE		
	1500	2P	29	<u> </u>			30	20	500	SPLASH PAI		
HEATING ENTRANCE, ELECTRICAL	2250	30	31	_		┷	32	15	200		LARM PANEL	
ROOM & BATHROOM	2250	2P	33	<u> </u>			34	15	200	EXIT SIGNS		
HOT WATER TANK "HWT-2"	6000	70	1			-		15	0	SPARE		
	6000	2P	37				38	15	600		MECH./ELEC	
SANDWICH REFRIDGERATOR	500	15	39	_			40	20	600		TION CABINET	
SANDWICH REFRIDGERATOR	500	15	41	~			42	15	1000	MICROWAVE		
ROOF TOP RECEPTACLE	200	20	43				44	20	200	RECEPTACLE		
HOT WATER TANK "HWT-1"	2250	25	45	\vdash			46	20	200	RECEPTACLE		011 21151 42
TDAD DDIMED	2250	2P	47				48	20	1500		ERY VENTILATI	
TRAP PRIMER	50	15	49	~			50	15	300		DAMPER & T	IME CLOCK
FIRE SUPPRESSION SYSTEM	50	15	51			_	52 54	20	0	RECEPTACLE		
OUTDOOR UNIT "OU-1"	1500 1500	45 2P	53 55			\exists	54 56	15 15	1050 1050	LIGHTS ICE		
DOOR OPERATOR	1000	15	57			\exists	58	15	1050	LIGHTS ICE		
HAND DRYER	1000	15	59			\exists	60	15 1100	1615	LIGHTS ICE	MINT	
HAND DRYER	1000	15	61				62	2P	1615	PANEL "C"		
DOOR OPERATOR	1000	25	63				64	1 45	0			
DOOK OFFICEION	250	15 	65				66	15	100	KITCHEN HC)OD	
INDOOR UNIT	250	2P	67	-		\exists	68	15	420	THE TIC		
	1200	25	69				70	2P	420	MAKEUP AIR	UNIT	
KITCHEN EXHAUST "EF-1"	1200	25 2P	71	<u> </u>			72	15	0	FIRE PLACE		
	0	-' 1	73				74	10	0	, II.L 1 LAOL		
	0		75			\exists	7 4 76		0			
	0		77	_			78		0			
	0		79				80		0			
	0		81				82		0			
		ı	101	ı `	ı				,			

(1) PROVIDE BREAKER LOCK(2) SHUNT TRIP BREAKER (3) GFCI BREAKER



1435, RUE SAINT-ALEXANDRE, BUREAU 1000 MONTRÉAL (QUÉBEC) H3A 2G4 T. 514-393-9490 F. 514-393-9498 info@evoqarchitecture.com



#493-18-4A

Red Island Contractors Inc. 305, Route 390, Tobique First Nation, NB, E7H 4P7

1	ISSUED FOR CONSTRUCTION	L.N.	2022-09-23
0	ISSUED FOR TENDER	L.N.	2022-05-27
Α	ISSUED FOR 50% REVIEW	J.O.	2021-06-18
Nº:	DESCRIPTION:	BY	DATE

GENERAL NOTES:

1. THE GENERAL CONTRACTOR IS RESPONSIBLE FOR VERIFYING ALL DIMENSIONS ON SITE TO ENSURE CONFORMITY WITH THE DIMENSIONS GIVEN ON THE DRAWINGS. 2. THE GENERAL CONTRACTORIS RESPONSIBLE TO IMMEDIATELY SUBMIT A REPORT TO THE ARCHITECT OR ENGINEER WITH ANY INACCURACIES.

3. THE GENERAL CONTRACTORSHOULD NOT TAKE SCALED MEASUREMENTS OFF THE

4. ANY INDIVIDUAL OR FIRM THAT HAVE RECEIVED ELECTRONIC DOCUMENT USE THEM AT THEIR OWN RISK. ONLY ORIGINAL DRAWINGS, STAMPED BY THE ARCHITECT, CAN BE USED FOR CONSTRUCTION.

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KCIW KNICANEWEK SPORTS AND RECREATION PARK - PHASE 2

DRAWING TITLE:

-ELECTRICAL-SCHEDULES

DESIGN: M. DOUCET	APPROVED:	M. DOUCET
DRAWN: L. N. / J. O.	DATE:	2021-05-01
VERIFIED: M. DOUCET	SCALE: AS SHOWN	
· 2	00/1221 / 10 0/10/11/	

PROJECT Nº:

DRAWING N°: