
# KCIW KNICANEWEK SPORTS AND RECREATION PARK -PHASE 2 BUILDINGS TOBIQUE FIRST NATION, NB

## STRUCTURAL / FOUNDATION

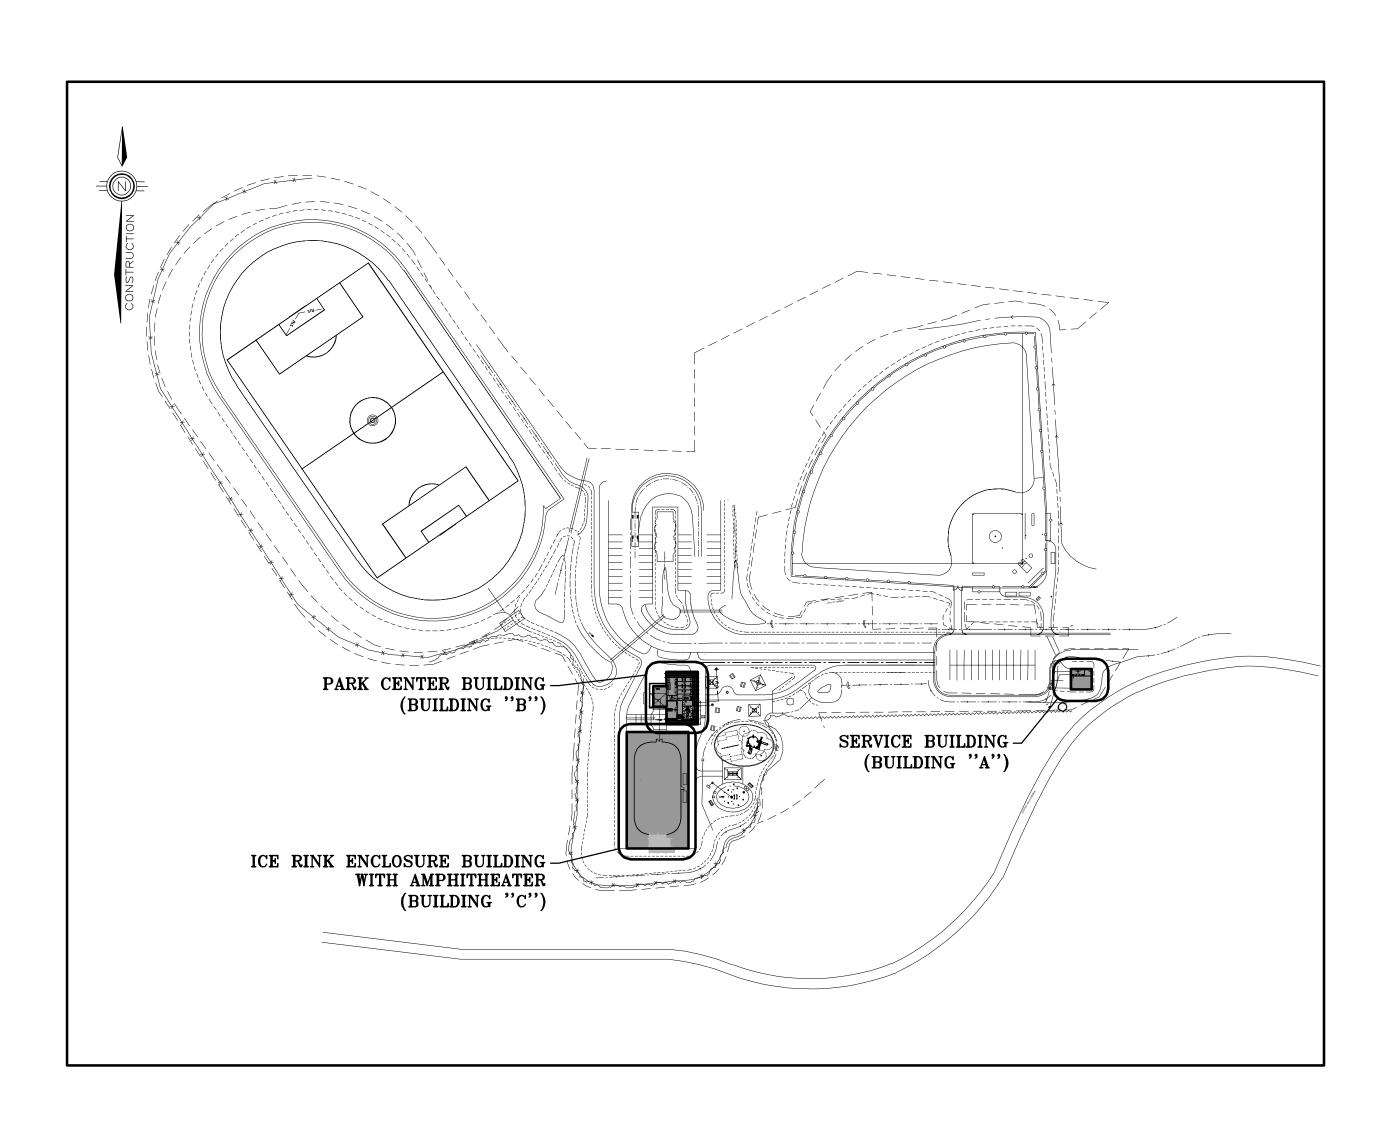

## STRUCTURAL/FOUNDATION DRAWINGS

## SERVICE BUILDING (BUILDING "A")

2/05/30
2/05/30
2/05/30
2/05/30
2/05/30

#### PARK CENTER BUILDING (BUILDING "B")

DRAWING No.	DRAWING TITLE	REVISION
F1B	FOUNDATION PLAN	ISSUED FOR TENDER 2022/05/30
F2B	SECTIONS & DETAILS	ISSUED FOR TENDER 2022/05/30
F3B	SECTIONS & DETAILS	ISSUED FOR TENDER 2022/05/30
F4B	SECTIONS & TYPICAL DETAILS	ISSUED FOR TENDER 2022/05/30
S1B	PLAN VIEW & SCHEDULES	ISSUED FOR TENDER 2022/05/30
S2B	<b>ROOF PLAN &amp; SECTIONS</b>	ISSUED FOR TENDER 2022/05/30
S3B	SECTIONS & DETAILS	ISSUED FOR TENDER 2022/05/30
S4B	DETAILS	ISSUED FOR TENDER 2022/05/30

#### ICE RINK ENCLOSURE BUILDING WITH AMPHITHEATER (BUILDING "C")

DRAWING No.	DRAWING TITLE	REVISION
F1C	FOUNDATION PLAN VIEW & DETAIL	ISSUED FOR TENDER 2022/05/30
F2C	SECTIONS & DETAILS	ISSUED FOR TENDER 2022/05/30
F3C	PLAN VIEW & SECTIONS	ISSUED FOR TENDER 2022/05/30
S1C	PLAN VIEWS & DETAILS	ISSUED FOR TENDER 2022/05/30
S2C	SECTIONS	ISSUED FOR TENDER 2022/05/30

EVOQ

MONTRÉAL (QUÉBEC) H3A 2G4 T. 514-393-9490 F. 514-393-9498



REF: 493-18-4A

LANDSCAPE ARCHITECTS:



Red Island Contractors Inc.

305, Route 390, Tobique First Nation, NB, E7H 4P7

0	ISSUED TENDER	RV	2022-05-30
Α	ISSUED FOR 50% REVIEW	KH	2021-06-18
Nº:	DESCRIPTION:	BY	DATE

#### GENERAL NOTES:

- 1. THE GENERAL CONTRACTOR IS RESPONSIBLE FOR VERIFYING ALL DIMENSIONS ON SITE TO ENSURE CONFORMITY WITH THE DIMENSIONS GIVEN ON THE DRAWINGS.
- 2. THE GENERAL CONTRACTOR IS RESPONSIBLE TO IMMEDIATELY SUBMIT A REPORT TO THE ARCHITECT OR ENGINEER WITH ANY INACCURACIES. 3. THE GENERAL CONTRACTOR SHOULD NOT TAKE SCALED MEASUREMENTS OFF THE
- 4. ANY INDIVIDUAL OR FIRM THAT HAVE RECEIVED ELECTRONIC DOCUMENT USE THEM AT THEIR OWN RISK. ONLY ORIGINAL DRAWINGS, STAMPED BY THE ARCHITECT OR ENGINEER, CAN BE USED FOR CONSTRUCTION.


KCIW KNICANEWEK SPORTS AND RECREATION PARK -PHASE 2 BUILDINGS TOBIQUE FIRST NATION, NB


STRUCTURAL / FOUNDATION -TITLE PAGE-

APPROVED: -DRAWN: R. COUTURE

> VERIFIED: M. BOUDREAU SCALE: AS SHOWN

9223-18-00

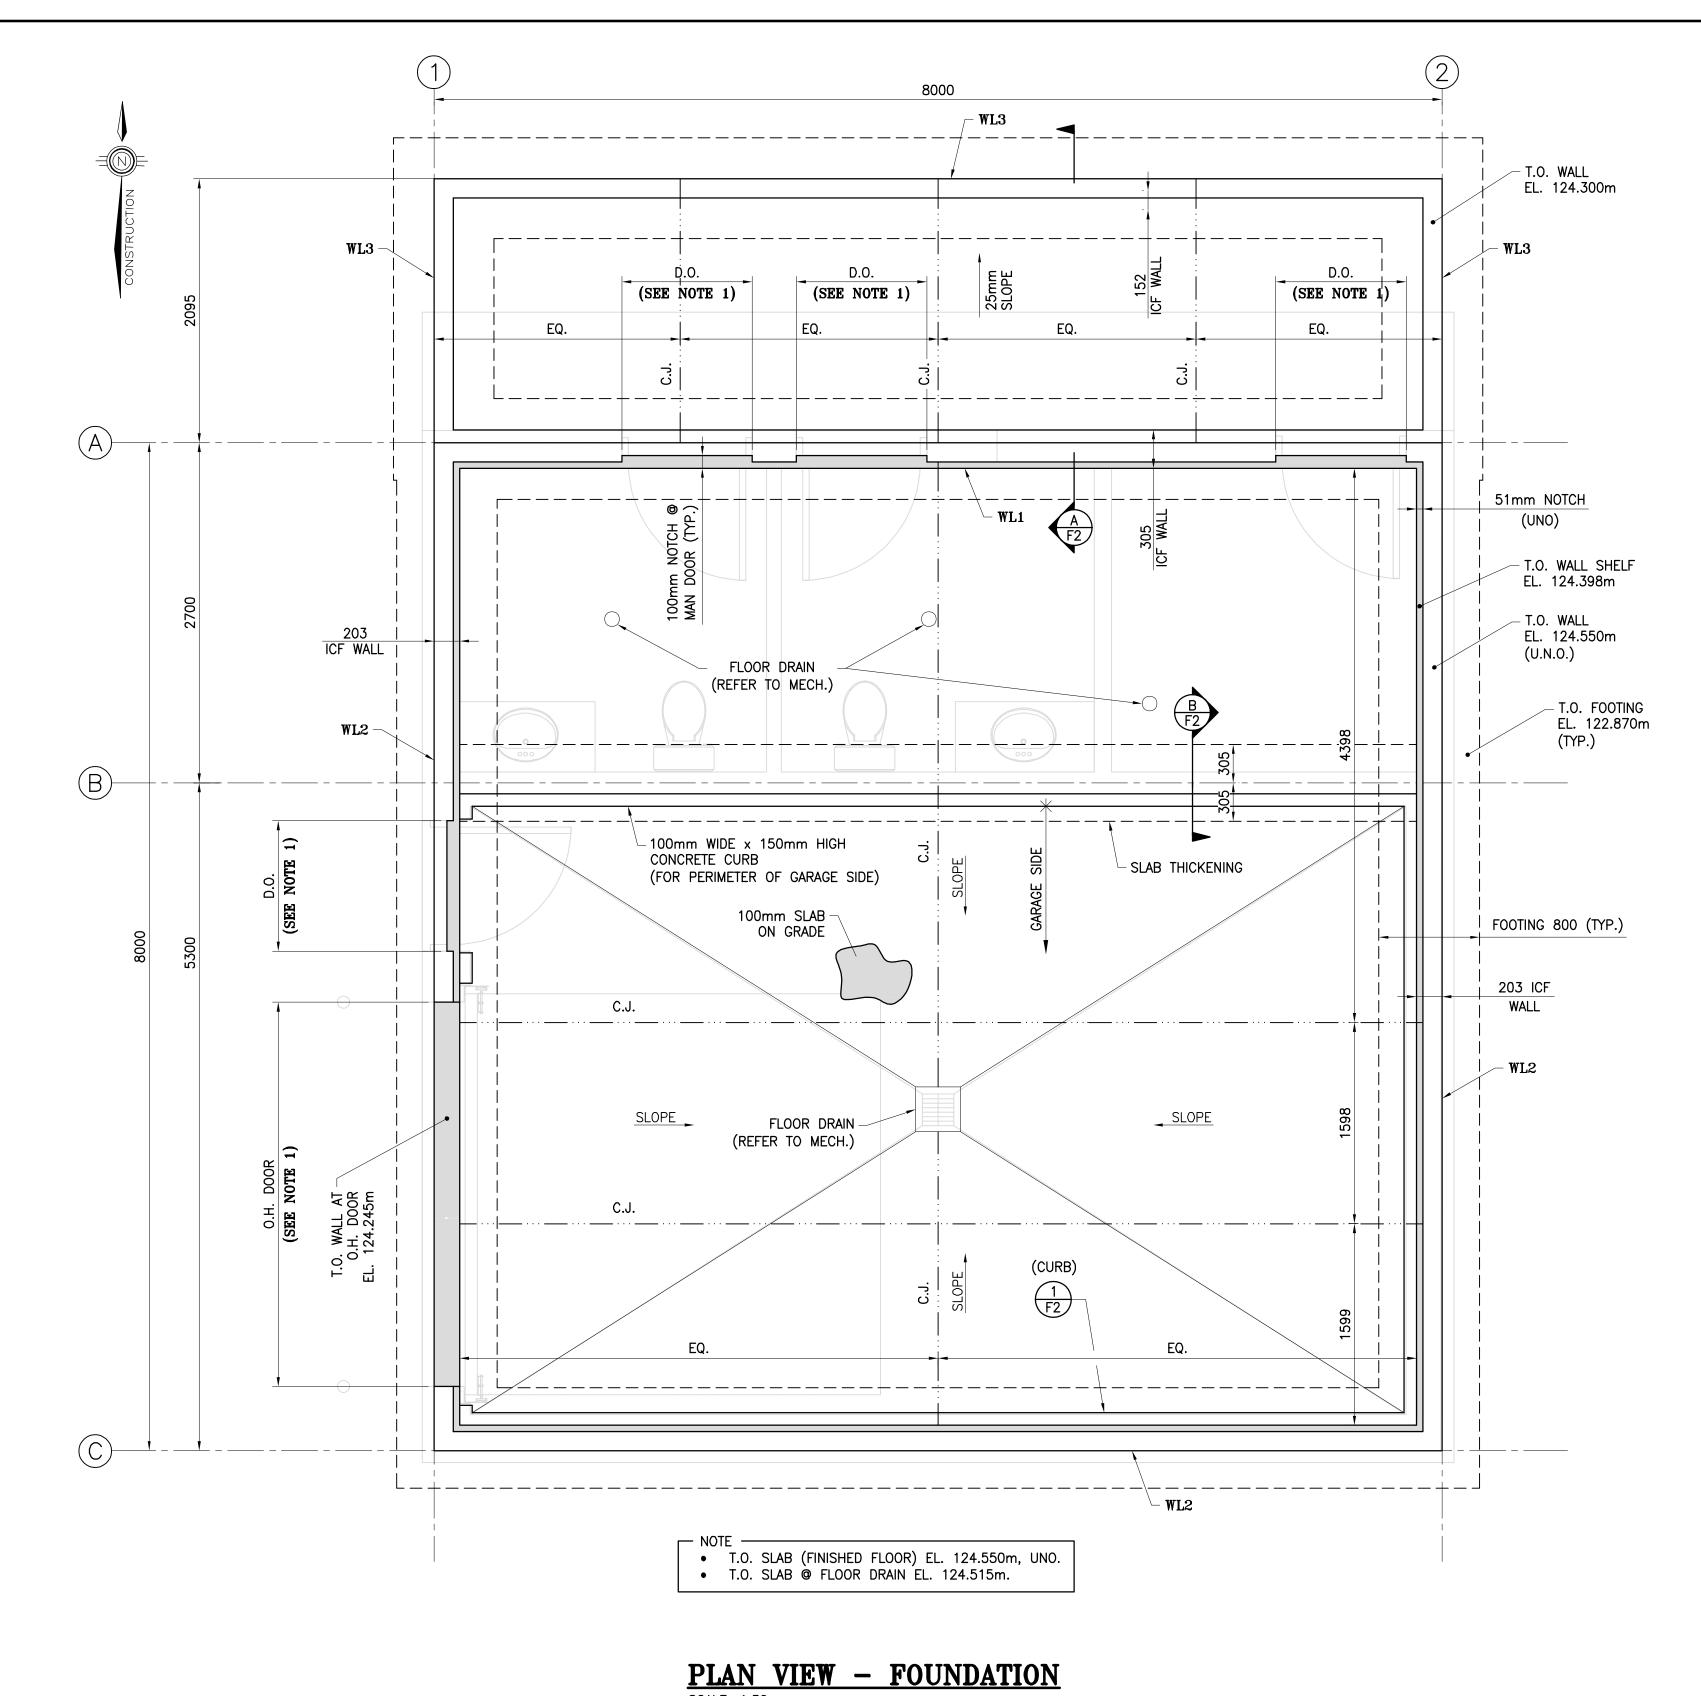

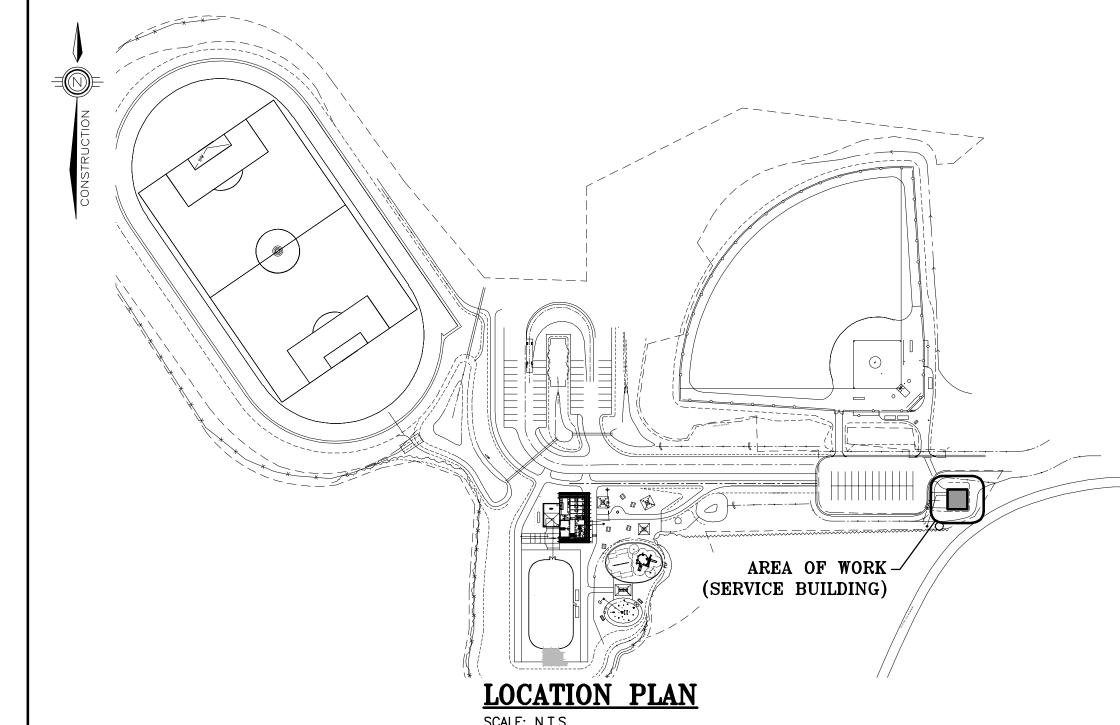

#### **LEGEND**

INDICATES DOOR OPENING (COORDINATE SIZE AND LOCATION WITH ARCH.) INDICATES FOUNDATION WALL TYPE 'WL1' (REFER TO DRAWING F2 FOR FOUNDATION WALL DETAILS) HIGH POINT LOW POINT DOOR OPENING TOP OF NOT IN CONTRACT CONTROL JOINT EACH WAY TOP AND BOTTOM UNLESS NOTED OTHERWISE COMPLETE WITH CONTROL JOINT

#### **GENERAL NOTES:**

(SEE SLAB ON GRADE DETAIL)

- CONTRACTOR IS RESPONSIBLE FOR ALL CUTTING AND PATCHING, AND THE REMOVAL OF ALL EXISTING MATERIALS AND INSTALLATIONS NECESSARY FOR THE EXECUTION OF THE WORK DESCRIBED BELOW OR SHOWN ON THESE STRUCTURAL DRAWINGS. ALL REMOVED MATERIALS ARE TO BE DISPOSED OF IN ACCORDANCE WITH AUTHORITY HAVING JURISDICTION, UNLESS INDICATED OTHERWISE BY OWNER AND/OR TENANT.
- CONTRACTOR SHALL VERIFY ALL DIMENSIONS, LOCATIONS, ELEVATIONS AND/OR CONSTRUCTION DETAILS. REPORT ANY DISCREPANCIES TO THE CONSULTANT. DO NOT SCALE ON THESE STRUCTURAL DRAWINGS.
- ALL WORK SHALL BE PERFORMED AND COMPLETED TO THE STANDARDS OF MATERIALS AND WORKMANSHIP AS PER THE NATIONAL BUILDING CODE OF CANADA (NBC), 2015, INCLUDING ALL CORRECTIONS AND REVISIONS TO DATE. ALL WORK AND INSTALLATIONS SHALL ALSO COMPLY TO APPLICABLE MUNICIPAL AND PROVINCIAL REGULATIONS. IN THE ABSENCE OF SPECIFIC REQUIREMENTS IN THE ABOVE, WORK SHALL CONFORM TO SOUND BUILDING PRACTICE AND QUALITY WORKMANSHIP.
- THESE STRUCTURAL DRAWINGS ARE TO BE READ IN CONJUNCTION WITH STRUCTURAL SPECIFICATIONS.
- REFER TO ARCHITECTURAL DRAWINGS FOR WALL OPENING DIMENSIONS AND LOCATIONS.
- SEE MECH. FOR LOCATION OF REQUIRED SLEEVES THROUGH FOUNDATION WALL. OPENING SHALL BE 150mmø OR LESS (UNLESS APPROVED BY CONSULTANT) AND SHOULD NOT INTERRUPT REINFORCEMENT BARS.
- TYPICAL STEEL REINFORCEMENT COVER TO BE 40mm
- REFERENCE ELEVATION AS PER CIVIL AND LANDSCAPE ARCH. (BDA). IT DIFFER FROM BUILDING ARCH. (EVOQ) BY 114.550 m: T.O. SLAB ON FOUNDATION DWG. = 124.550 m

= 10.000 m

T.O. SLAB ON ARCH. DWG.

EVOQ

1435, RUE SAINT-ALEXANDRE, BUREAU 1000

MONTRÉAL (QUÉBEC) H3A 2G4 T. 514-393-9490 F. 514-393-9498 info@evoqarchitecture.com



13, rue Costigan Street

REF: 493-18-4A


LANDSCAPE ARCHITECTS:



Red Island Contractors Inc. 305, Route 390, Tobique First Nation, NB, E7H 4P7

#### SPECIFIC NOTE

1. EXACT LOCATIONS OF DOORS AND FOUNDATION NOTCHING ARE TO BE COORDINATED WITH ARCHITECTURAL. REFER TO TYP. SECTION AT OVERHEAD DOOR AND TYP. DETAIL AT MAN **DOORS** ON DWG. **F3**.

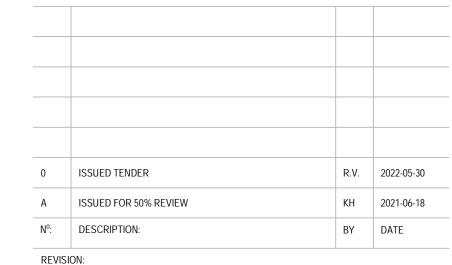

#### **GENERAL NOTES:**

- 1. THE GENERAL CONTRACTOR IS RESPONSIBLE FOR VERIFYING ALL DIMENSIONS ON SITE TO ENSURE CONFORMITY WITH THE DIMENSIONS GIVEN ON THE DRAWINGS
- 2. THE GENERAL CONTRACTOR IS RESPONSIBLE TO IMMEDIATELY SUBMIT A REPORT TO THE ARCHITECT OR ENGINEER WITH ANY INACCURACIES. 3. THE GENERAL CONTRACTOR SHOULD NOT TAKE SCALED MEASUREMENTS OFF THE
- 4. ANY INDIVIDUAL OR FIRM THAT HAVE RECEIVED ELECTRONIC DOCUMENT USE THEM AT THEIR OWN RISK. ONLY ORIGINAL DRAWINGS, STAMPED BY THE ARCHITECT OR ENGINEER, CAN BE USED FOR CONSTRUCTION.

KCIW KNICANEWEK SPORTS AND RECREATION PARK -PHASE 2 BUILDINGS TOBIQUE FIRST NATION, NB

DRAWING TITLE:

DRAWN: K. HEBERT

SERVICE BUILDING -FOUNDATION-PLAN VIEW & SECTIONS


DESIGN: P. BOUDREAU APPROVED: P. BOUDREAU

VERIFIED: M. BOUDREAU SCALE: AS SHOWN

PROJECT Nº: DRAWING N°:

9223-18-00 F1A

DATE: JUNE 2021

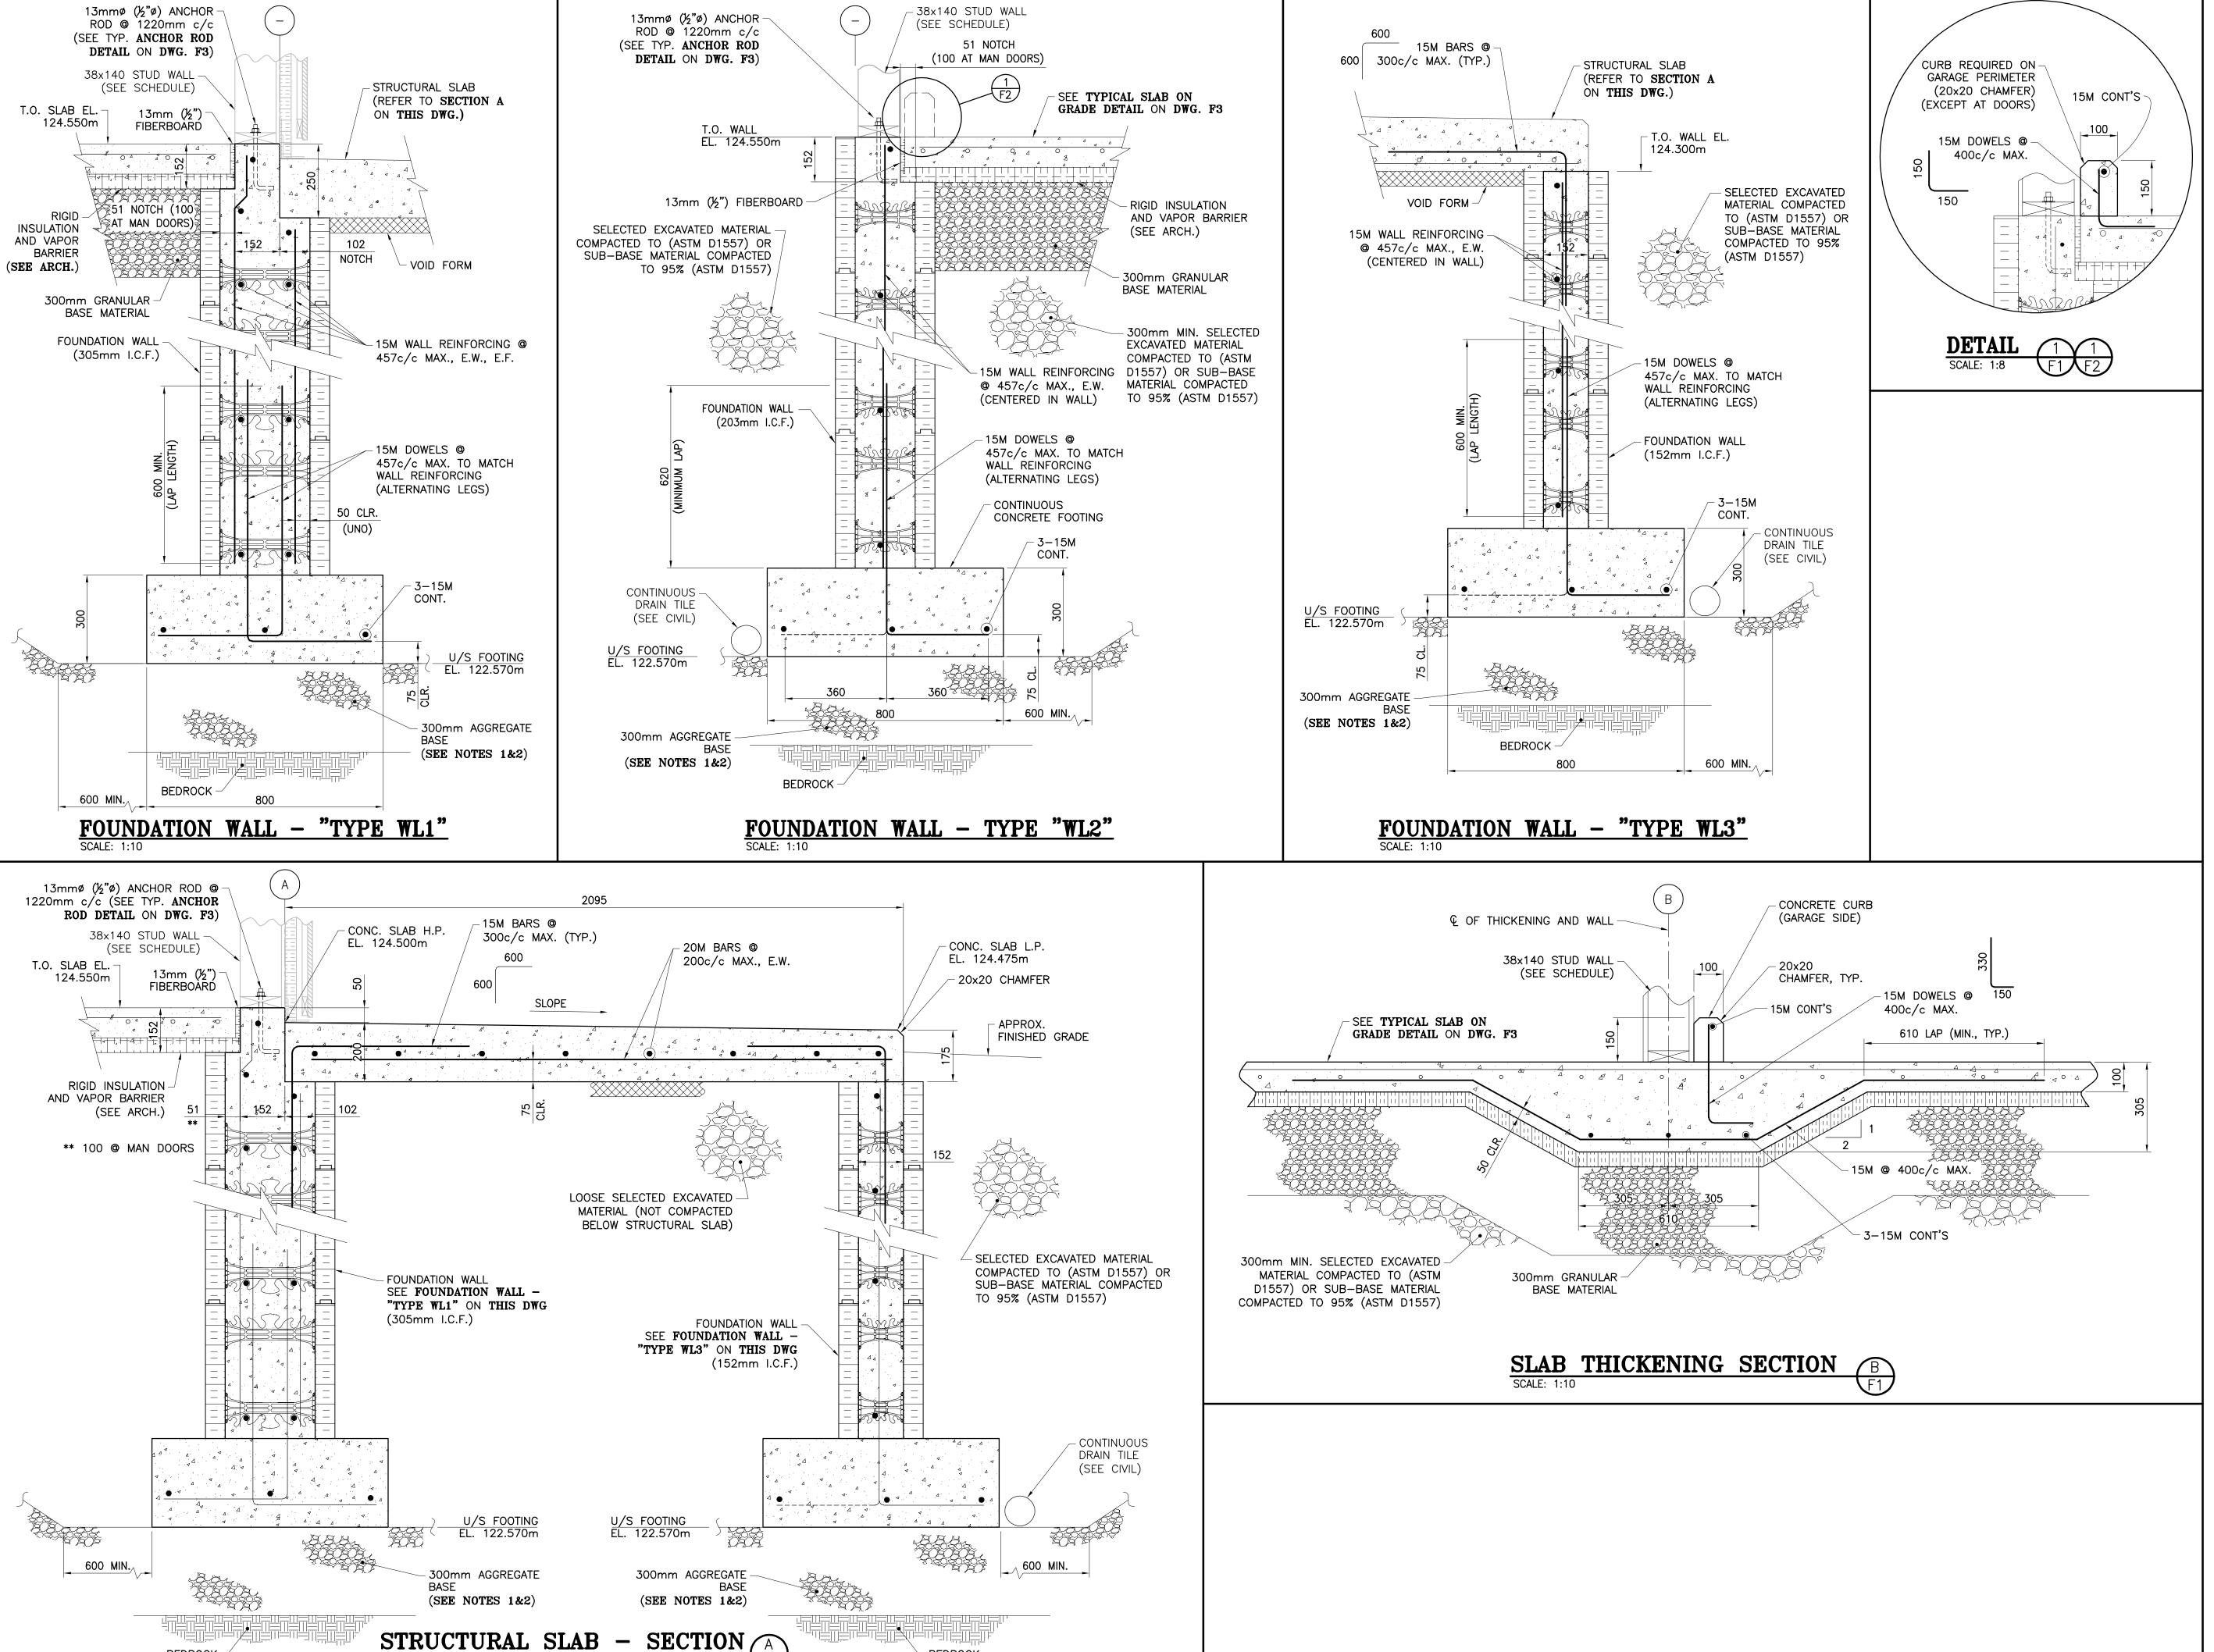

BEDROCK

38x140 STUD WALL

13mmø (½"ø) ANCHOR

BEDROCK -

EVOQ

1435, RUE SAINT-ALEXANDRE, BUREAU 1000 MONTRÉAL (QUÉBEC) H3A 2G4 T. 514-393-9490 F. 514-393-9498 info@evoqarchitecture.com



13, rue Costigan Street

REF: 493-18-4A

LANDSCAPE ARCHITECTS:




Red Island Contractors Inc. 305, Route 390, Tobique First Nation, NB, E7H 4P7

#### SPECIFIC NOTES

1. REFER TO GEOTECHNICAL REPORT FOR EXCAVATION AND BACKFILL RECOMMENDATIONS.

2. BEDROCK EXCAVATION MAY BE REQUIRED.

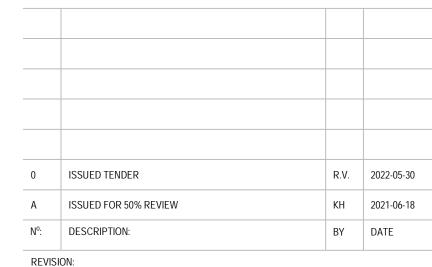

#### **GENERAL NOTES:**

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KCIW KNICANEWEK SPORTS AND RECREATION PARK -PHASE 2 BUILDINGS TOBIQUE FIRST NATION, NB

DRAWING TITLE:

VERIFIED: M. BOUDREAU


SERVICE BUILDING -FOUNDATION-**SECTIONS & DETAILS** 

SCALE: AS SHOWN


DESIGN: P. BOUDREAU APPROVED: P. BOUDREAU DRAWN: K. HEBERT DATE: JUNE 2021

PROJECT Nº: DRAWING N°:


> 9223-18-00 F2A

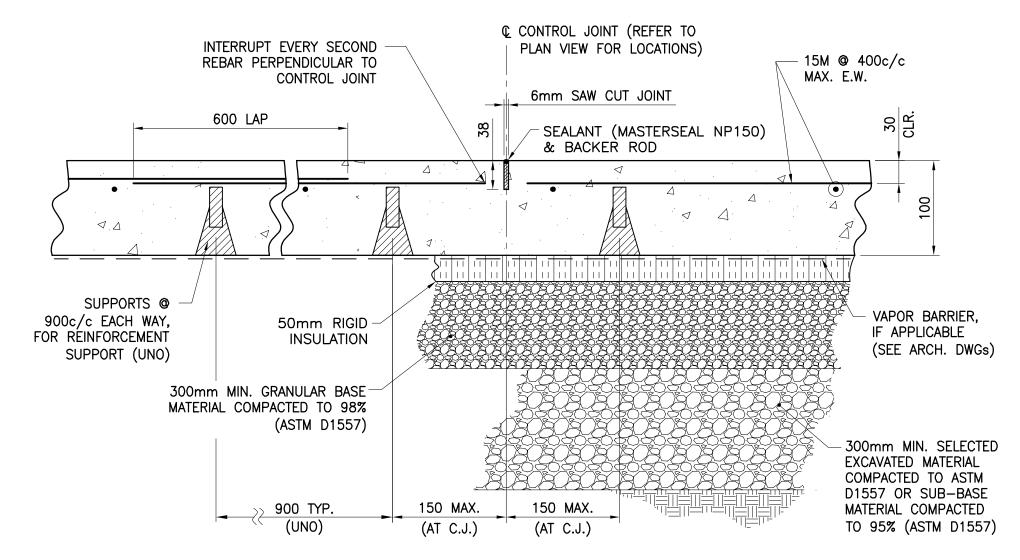


## TYPICAL SLAB ON GRADE DETAIL

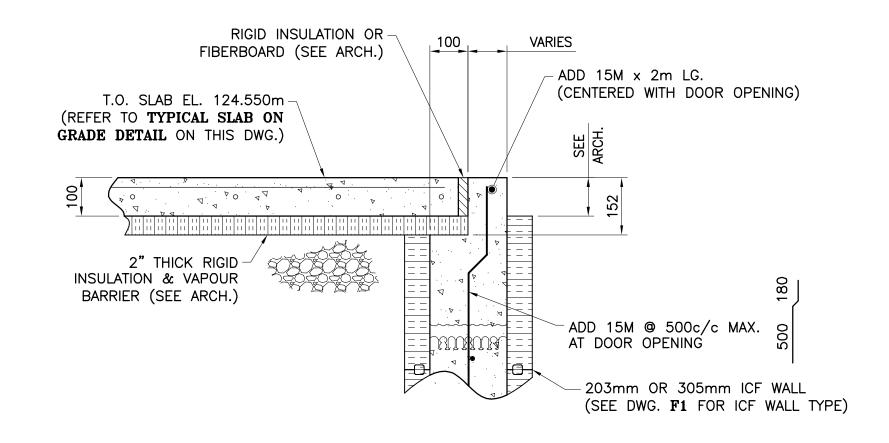


#### TYP. DETAIL AT MAN DOORS (D.O.) SCALE: N.T.S. @ 4 LOCATIONS

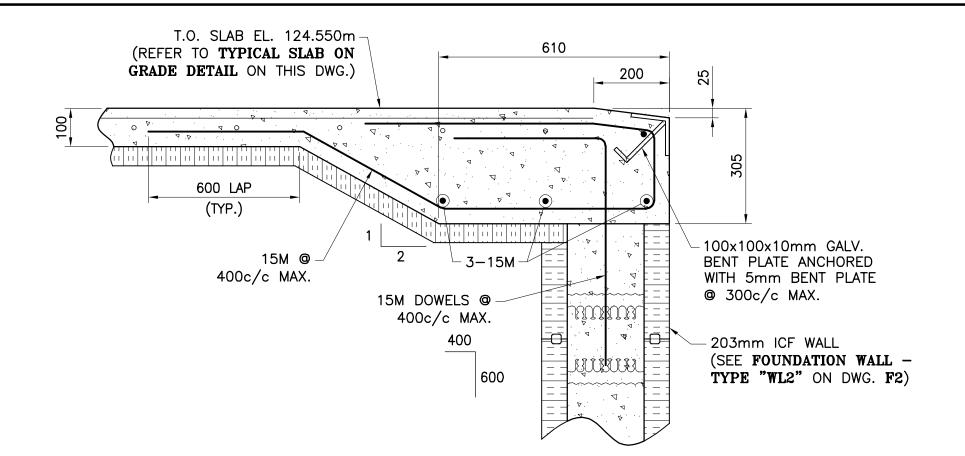


#### TYP. SECTION AT OVERHEAD DOOR SCALE: N.T.S.

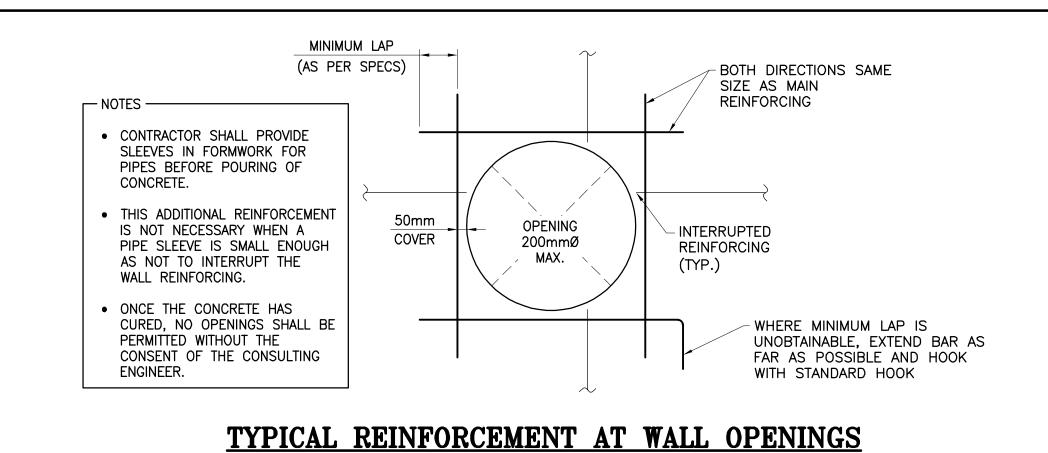


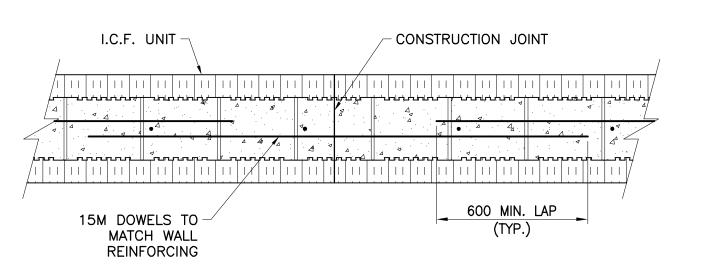

## TYPICAL WALL CONSTRUCTION JOINT

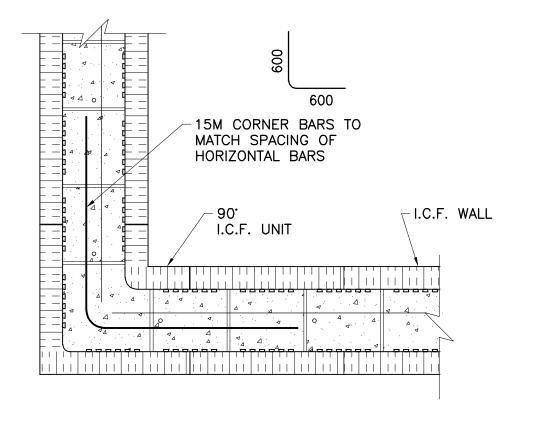

#### TYPICAL CORNER REINFORCING DETAIL SCALE: N.T.S.

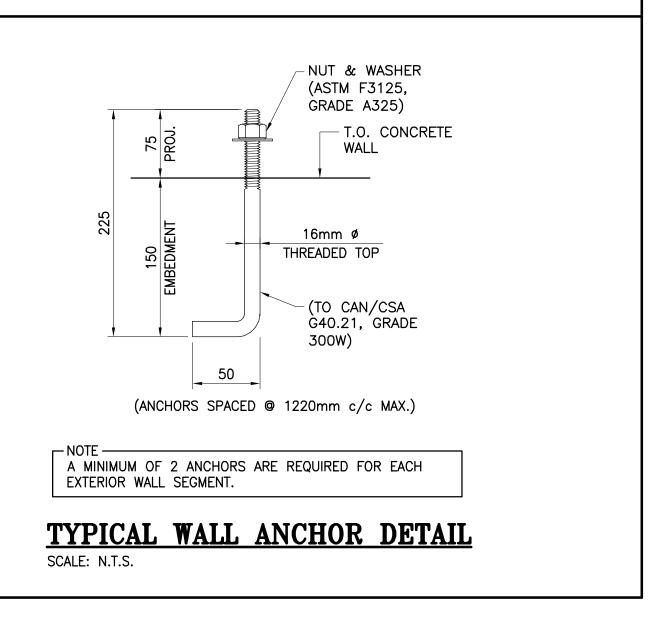

# EVOQ

1435, RUE SAINT-ALEXANDRE, BUREAU 1000 MONTRÉAL (QUÉBEC) H3A 2G4 T. 514-393-9490 F. 514-393-9498 info@evoqarchitecture.com



13, rue Costigan Street Edmundston (NB) E3V 1W7 506.737.9730

REF: 493-18-4A

LANDSCAPE ARCHITECTS:




Red Island Contractors Inc.

305, Route 390, Tobique First Nation, NB, E7H 4P7

#### SPECIFIC NOTES

- 1. THIS DETAIL IS APPLICABLE FOR 152mm AND 203mm THICK ICF WALLS. FOR 305mm THICK ICF WALL, TWO DOWELS ARE REQUIRED (NEAR FACE AND FAR FACE). LOCATIONS OF CONSTRUCTION JOINTS TO BE APPROVED BY THE ENGINEERING CONSULTANT.
- 2. THIS DETAIL IS APPLICABLE FOR 152mm AND 203mm THICK ICF WALLS. FOR 305mm THICK ICF WALL, TWO CORNER BARS ARE REQUIRED (NEAR FACE AND FAR FACE).

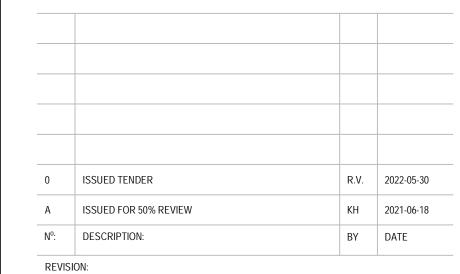

**GENERAL NOTES:** 

- 1. THE GENERAL CONTRACTOR IS RESPONSIBLE FOR VERIFYING ALL DIMENSIONS ON
- SITE TO ENSURE CONFORMITY WITH THE DIMENSIONS GIVEN ON THE DRAWINGS 2. THE GENERAL CONTRACTOR IS RESPONSIBLE TO IMMEDIATELY SUBMIT A REPORT TO THE ARCHITECT OR ENGINEER WITH ANY INACCURACIES.
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KCIW KNICANEWEK SPORTS AND RECREATION PARK -PHASE 2 BUILDINGS TOBIQUE FIRST NATION, NB

DRAWING TITLE:

PROJECT Nº:

SERVICE BUILDING -FOUNDATION-TYPICAL DETAILS


DESIGN: P. BOUDREAU APPROVED: P. BOUDREAU DRAWN: K. HEBERT DATE: JUNE 2021

VERIFIED: M. BOUDREAU SCALE: AS SHOWN

9223-18-00

F3A

DRAWING N°:

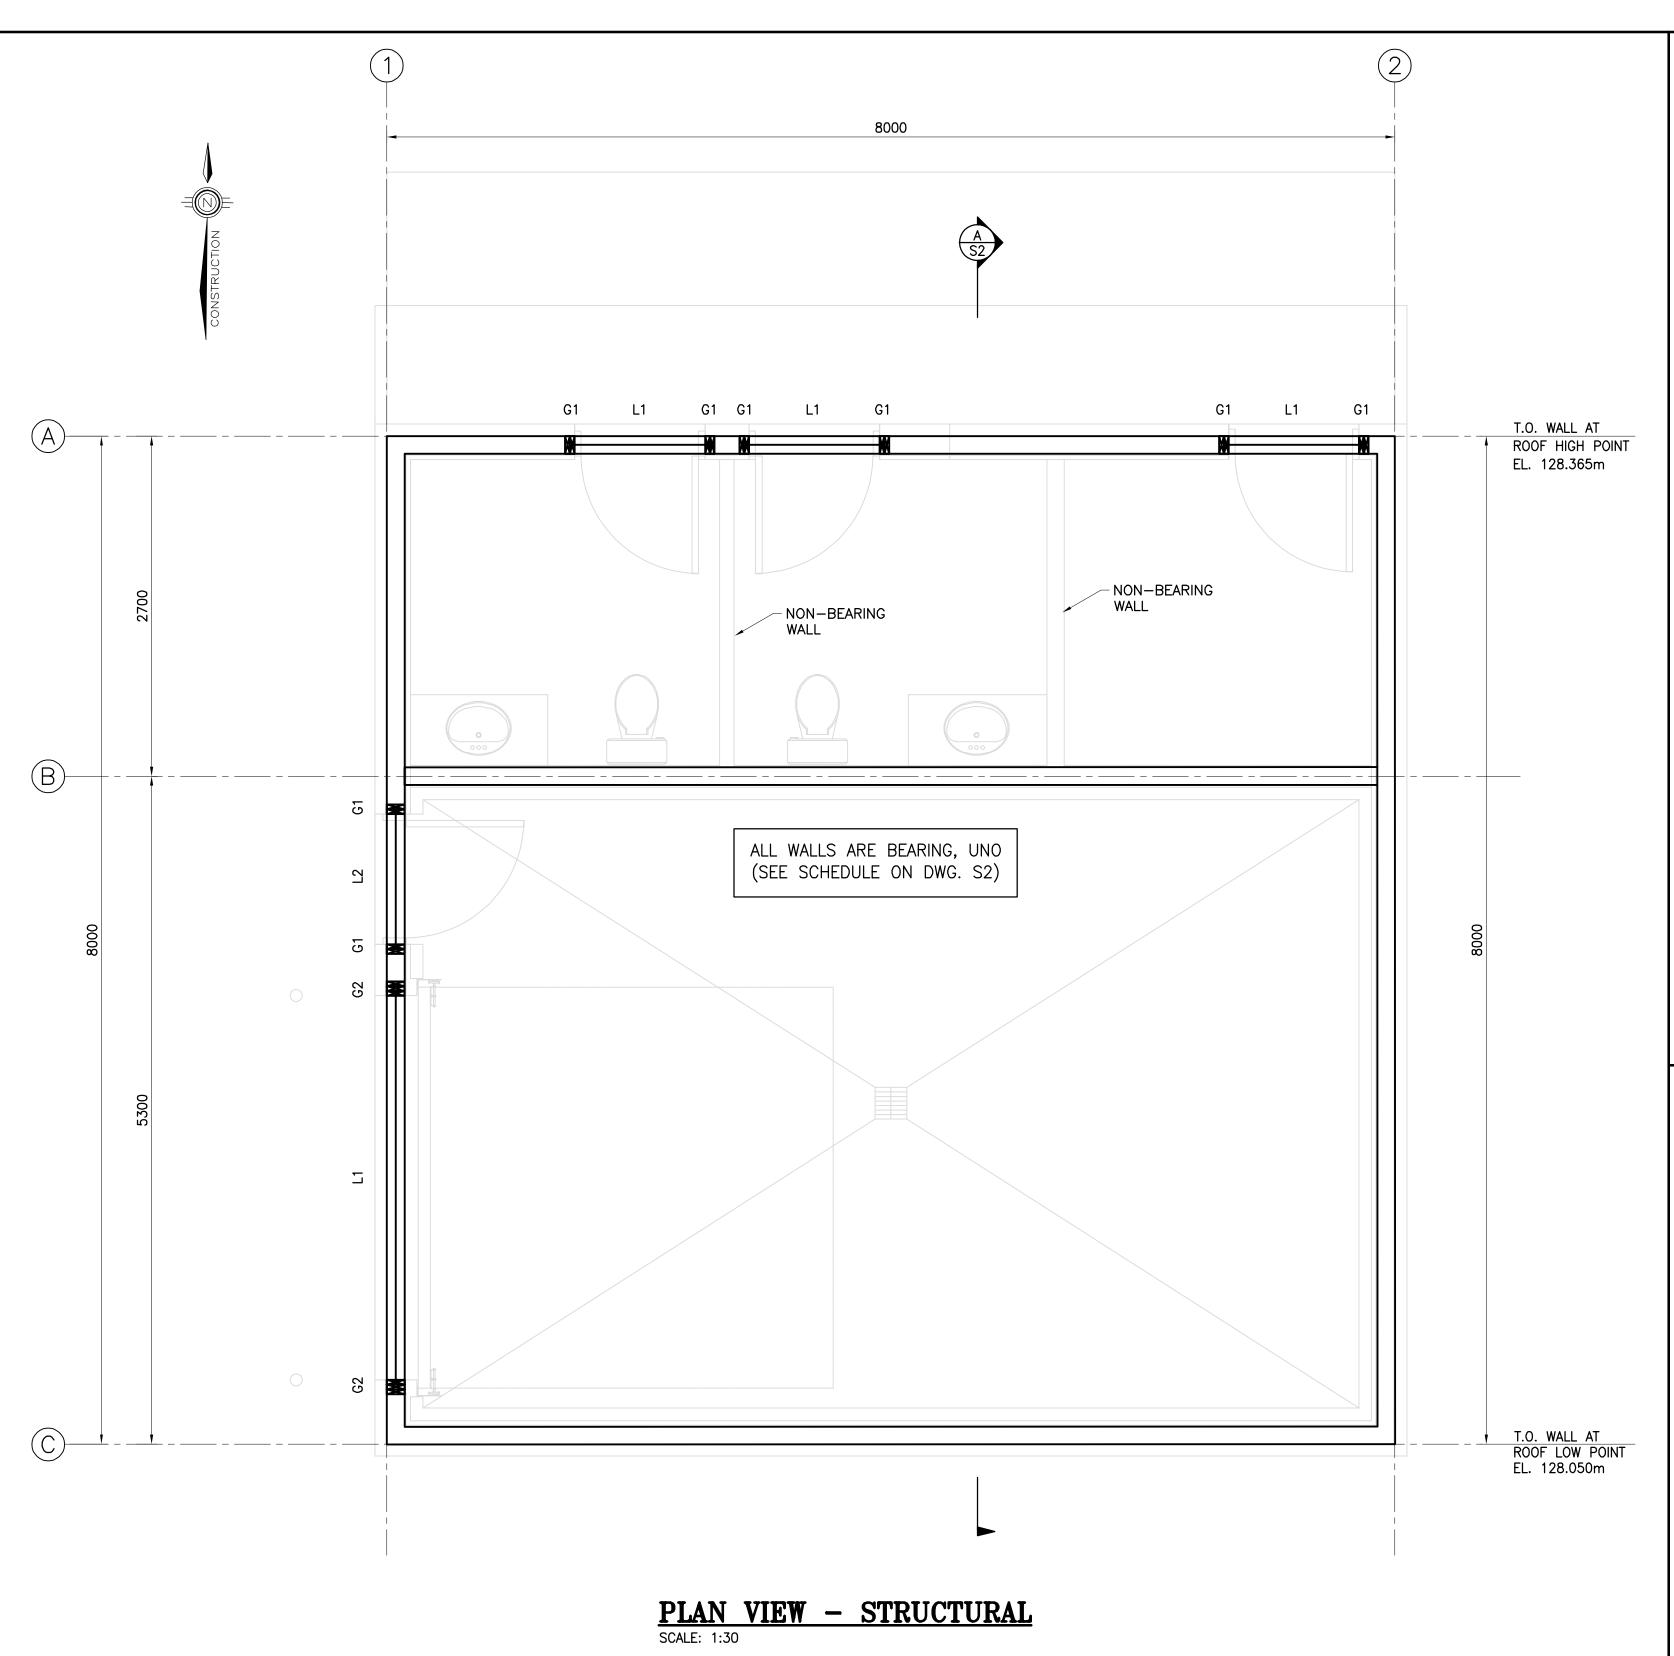

# 8000 \_\_\_\_\_ \_\_\_\_\_\_\_ (SEE **NOTE 1**) ROOF VENT (SEE MEC.) INTERIOR BEARING WALL -- PLYWOOD ROOF DECK (NAILED TO TOP OF JOISTS) PRE-FABRICATED 406mm I-JOIST AT 406 mm c/c MAX. (SEE NOTE 1) -----

#### ROOF JOISTS DESIGN LOADS

(AS PER PART 4 OF THE NBC OF CANADA 2015, BUT WITH FOLLOWING UNFACTORED LOADS)

ALL JOISTS SHALL BE DESIGNED FOR AN ADDITIONAL POINT LOAD OF 0.71kN

ANYWHERE ON THEIR BOTTOM AND TOP CHORD (NON SIMULTANEOUSLY).

<u>ΔSL:</u>

ROOF PLAN

1.2kPa (NOT INCLUDING **I**—JOISTS)

TOP CHORD = 0.8kPa, BOTTOM CHORD = 0.4kPa

SL ROOF: 3.48kPa, UNO. (Ss = 3.6kPa, Sr = 0.6kPa, Cb = 0.8, Is=1.0)

L/360

# EVOQ

info@evoqarchitecture.com

1435, RUE SAINT-ALEXANDRE, BUREAU 1000 MONTRÉAL (QUÉBEC) H3A 2G4 T. 514-393-9490 F. 514-393-9498



13, rue Costigan Street

REF: 493-18-4A

LANDSCAPE ARCHITECTS:



Red Island Contractors Inc. 305, Route 390, Tobique First Nation, NB, E7H 4P7

#### SPECIFIC NOTE

1. EACH ROOF JOIST TO BE CONNECTED TO EXTERIOR WALL TOP PLATES WITH ONE H4 CONNECTOR BY SIMPSON STRONG TIE (OR APPROVED EQUAL), ALONG LINES 'A' AND 'C'.


#### **LEGEND**

T.O. **– TOP OF** 

U.N.O. - UNLESS NOTED OTHERWISE

Gx - GANG STUD, SEE SCHEDULE ON DWG. S2

Lx - LINTEL, SEE SCHEDULE ON DWG. S2

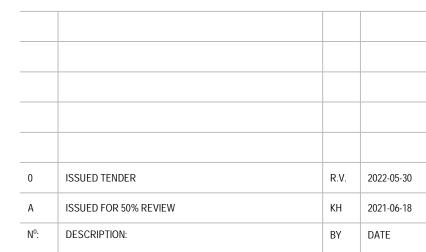

#### REVISION:

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KCIW KNICANEWEK SPORTS AND RECREATION PARK -PHASE 2 BUILDINGS

TOBIQUE FIRST NATION, NB

SERVICE BUILDING -STRUCTURAL-PLAN VIEWS

DESIGN: P. BOUDREAU APPROVED: P. BOUDREAU DRAWN: K. HEBERT DATE: JUNE 2021

VERIFIED: M. BOUDREAU SCALE: AS SHOWN

PROJECT Nº: DRAWING N°:

9223-18-00 S1A


## **GENERAL NOTES:**


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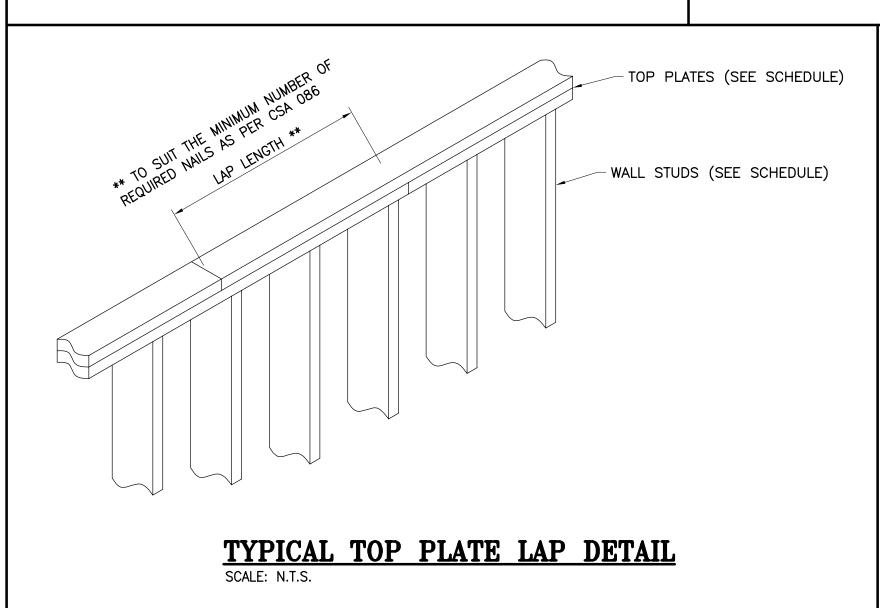
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- THESE STRUCTURAL DRAWINGS ARE TO BE READ IN CONJUNCTION WITH STRUCTURAL SPECIFICATIONS.
- REFER TO ARCHITECTURAL DRAWINGS FOR FINISHES, AS WELL AS WALL OPENING DIMENSIONS AND LOCATIONS.
- THE TYPICAL DETAILS ON THIS THESE STRUCTURAL DRAWINGS ARE DIAGRAMMATIC AND INDICATE GENERAL ARRANGEMENT. REFER TO WRITTEN ANNOTATIONS AND SCHEDULES FOR EXACT ARRANGEMENT.


- REFERENCE ELEVATIONS ARE AS PER CIVIL AND LANDSCAPE ARCH. (BDA). THEY DIFFER FROM BUILDING ARCH. (EVOQ) BY 114.550 m:

- T.O. SLAB ON FOUNDATION DWG. = 124.550 mT.O. SLAB ON ARCH. DWG. = 10.000 m



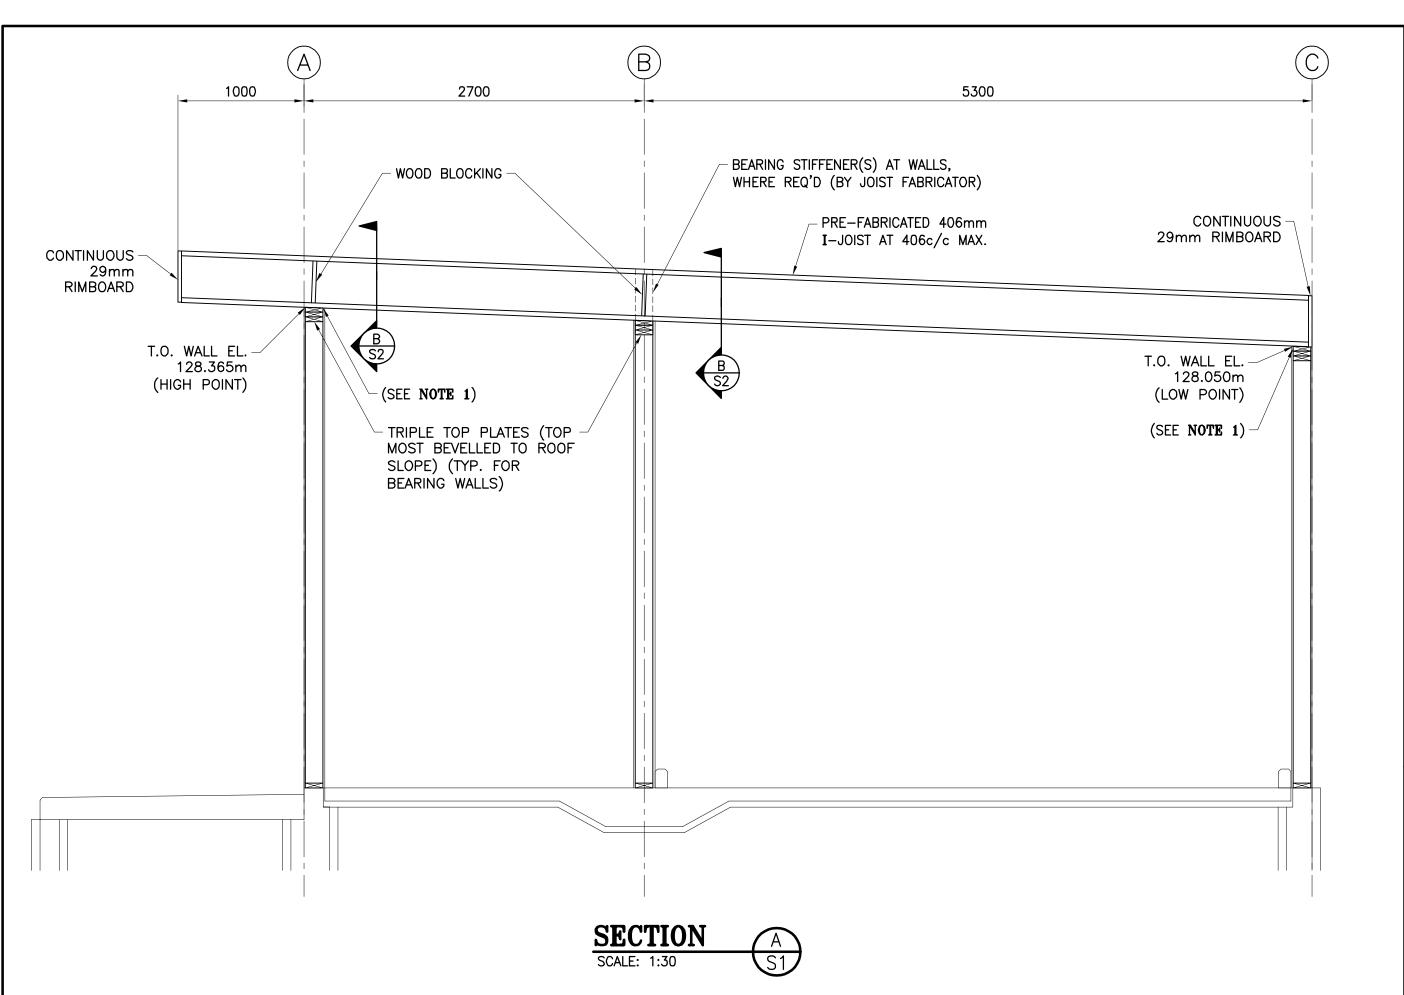

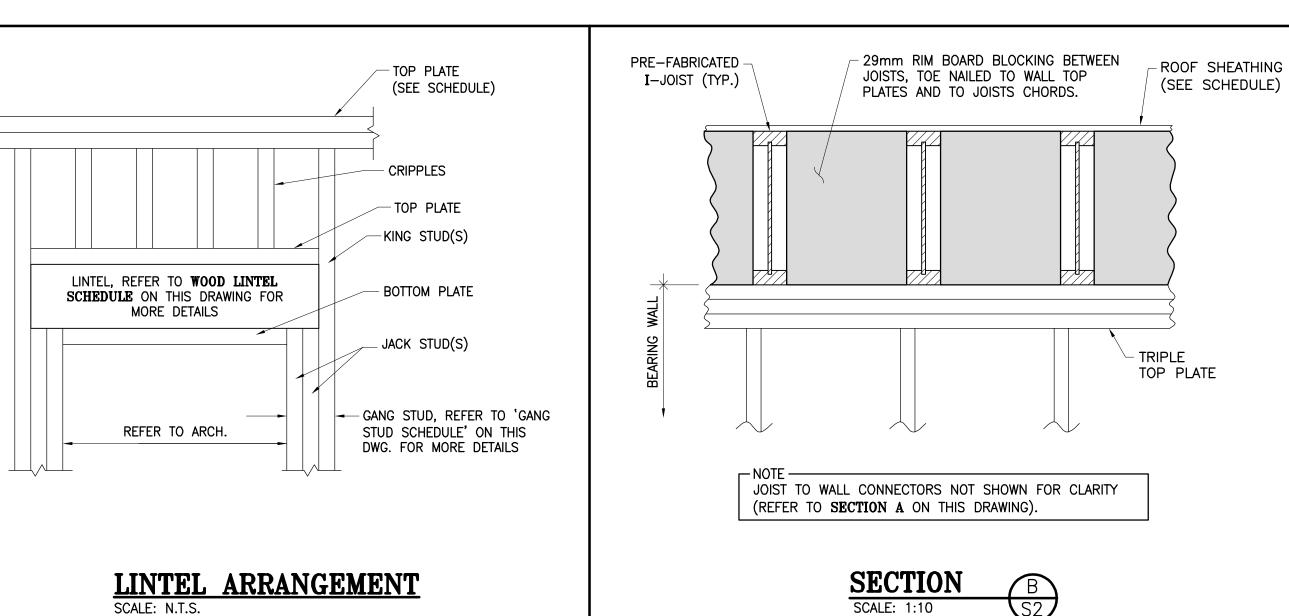

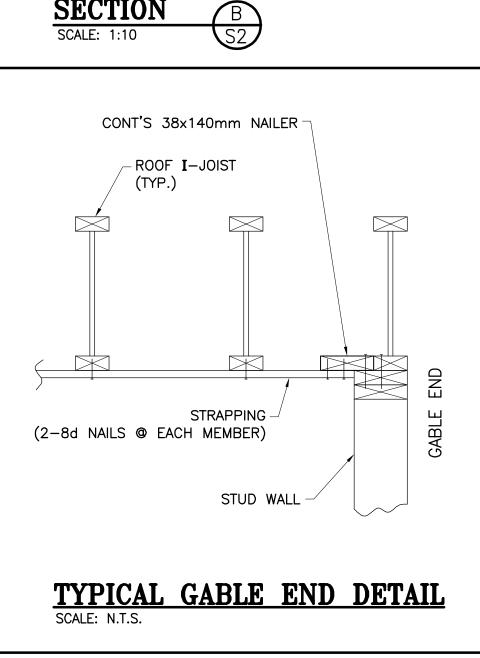

#### GANG STUD SCHEDULE NO. OF KING STUDS JACK STUDS **MEMBER** MARK LUMBER GRADE PLIES SIZE REQ'D REQ'D No. 2 SPF G1 38x140 1 G2 38x140 No. 2 SPF

BEARING WALL SCHEDULE

38x140mm SPF No.2 (OR BETTER) STUDS SPACED AT 406mm c/c MAX. SILL PLATE TO BE 38x140mm SPF No.2 OR BETTER. TOP PLATE TO BE 3-38X140mm SPF No.2 OR BETTER, WITH VERY TOP PLATE BEVELED TO ROOF SLOPE. STUD SPACING ARE MINIMUM STRUCTURAL REQUIREMENTS. CONTRACTOR TO MODIFY (CLOSER) AS REQUIRED TO SUIT ARCHITECTURAL FINISH.

NOTE: - REFER TO LINTEL ARRANGEMENT ON THIS DRAWING.

#### MINIMUM SHEATHING REQUIREMENTS

LINTEL SCHEDULE

LUMBER GRADE

No. 2 SPF

No. 2 SPF

NO. OF

PLIES

- REFER TO LINTEL ARRANGEMENT ON THIS DRAWING.

ARCHITECTURAL DRAWINGS.

MEMBER

SIZE

38X235

38X235

MARK

L1

L2


NOTE:

CONSTRUCTION SHEATHING PLYWOOD IN ACCORDANCE WITH <u>MATERIAL:</u> CAN/CSA 0151, AND OSB IN ACCORDANCE WITH CAN/CSA 0325.


ROOF (DIRECTLY ON JOISTS): 16mm THICK 5-PLY T&G PLYWOOD FOR ALL ROOF (U.N.O.) ORIENTED AT 0' (EXTERIOR TYPE) WITH STAGGERED PATTERN. NAIL SHEATHING AT 152mm c/c ON PANEL EDGES AND AT 305mm c/c AT INTERMEDIATE FRAMING MEMBERS USING

63.5mm (2.5") LONG x 3.05mmø (0.120"ø) MIN. NAILS.

BR'G WALLS: U.N.O., 11mm  $\binom{7}{16}$ ") OSB SHEATHING (1R24) ON ONE SIDE FOR ALL BEARING WALLS (EXTERIOR TYPE FOR EXTERIOR WALLS), WITH LONG DIMENSION LAID HORIZONTALLY AND ENDS STAGGERED 1220mm (4'-0") c/c. FASTEN SHEATHING WITH 63.5mm (2.5") LONG x 3.05mmø (0.120"ø) MIN. NAILS AT 152mm (6") c/c MIN. AT ALL PANEL EDGES AND AT 305mm (12") c/c ALONG INTERMEDIATE WALL STUDS. BLOCK PANEL EDGES. PARTITION INTERIOR WALL SHEATHING AS PER

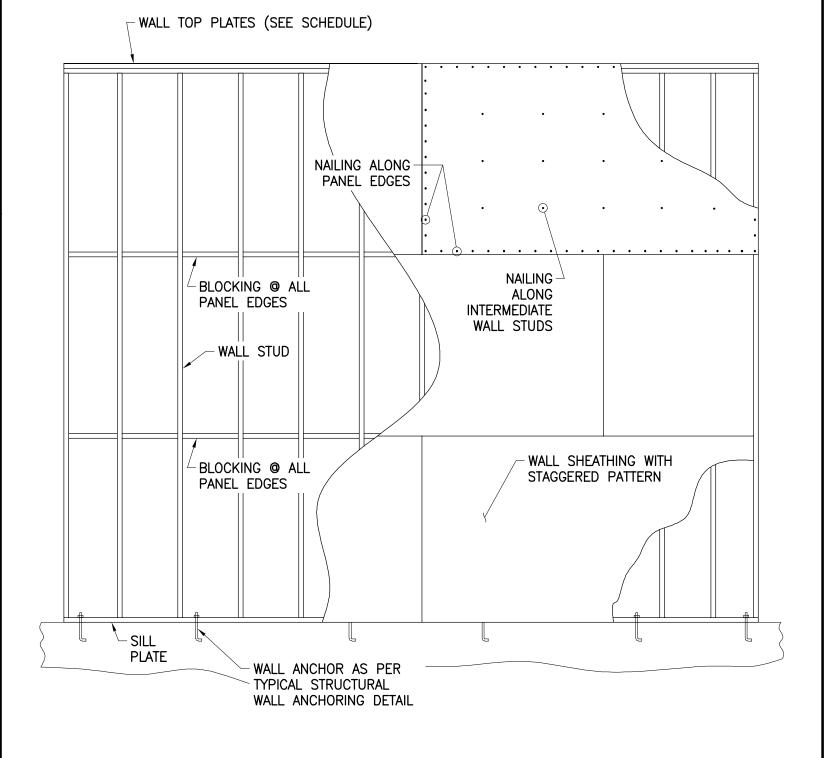

#### TYPICAL BLOCKED WALL DETAIL

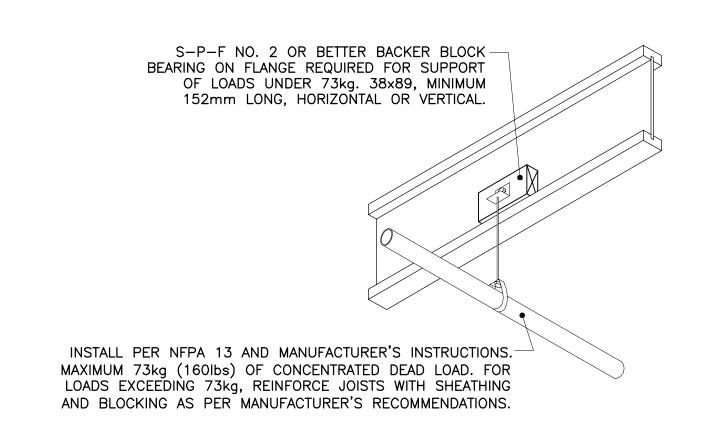

HANGING ELEC./MECH. LOADS TO I-JOISTS

SCALE: N.T.S.

EVOQ

1435, RUE SAINT-ALEXANDRE, BUREAU 1000 MONTRÉAL (QUÉBEC) H3A 2G4

T. 514-393-9490 F. 514-393-9498

info@evoqarchitecture.com

ENGINEERS:



13, rue Costigan Street Edmundston (NB) E3V 1W7

REF: 493-18-4A


LANDSCAPE ARCHITECTS:



Red Island Contractors Inc. 305, Route 390, Tobique First Nation, NB, E7H 4P7

#### SPECIFIC NOTE

1. EACH ROOF JOIST TO BE CONNECTED TO EXTERIOR WALL TOP PLATES WITH ONE H4 CONNECTOR BY SIMPSON STRONG TIE (OR APPROVED EQUAL), ALONG LINES 'A' AND 'C'.

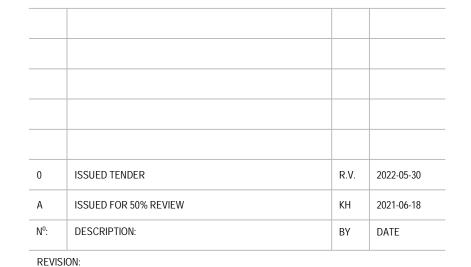

#### **GENERAL NOTES:**

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KCIW KNICANEWEK SPORTS AND RECREATION PARK -PHASE 2 BUILDINGS TOBIQUE FIRST NATION, NB


SERVICE BUILDING -STRUCTURAL-**SECTIONS & DETAILS** 


DESIGN: P. BOUDREAU APPROVED: P. BOUDREAU DRAWN: K. HEBERT DATE: JUNE 2021

VERIFIED: M. BOUDREAU SCALE: AS SHOWN

PROJECT Nº: DRAWING N°: 9223-18-00

S2A

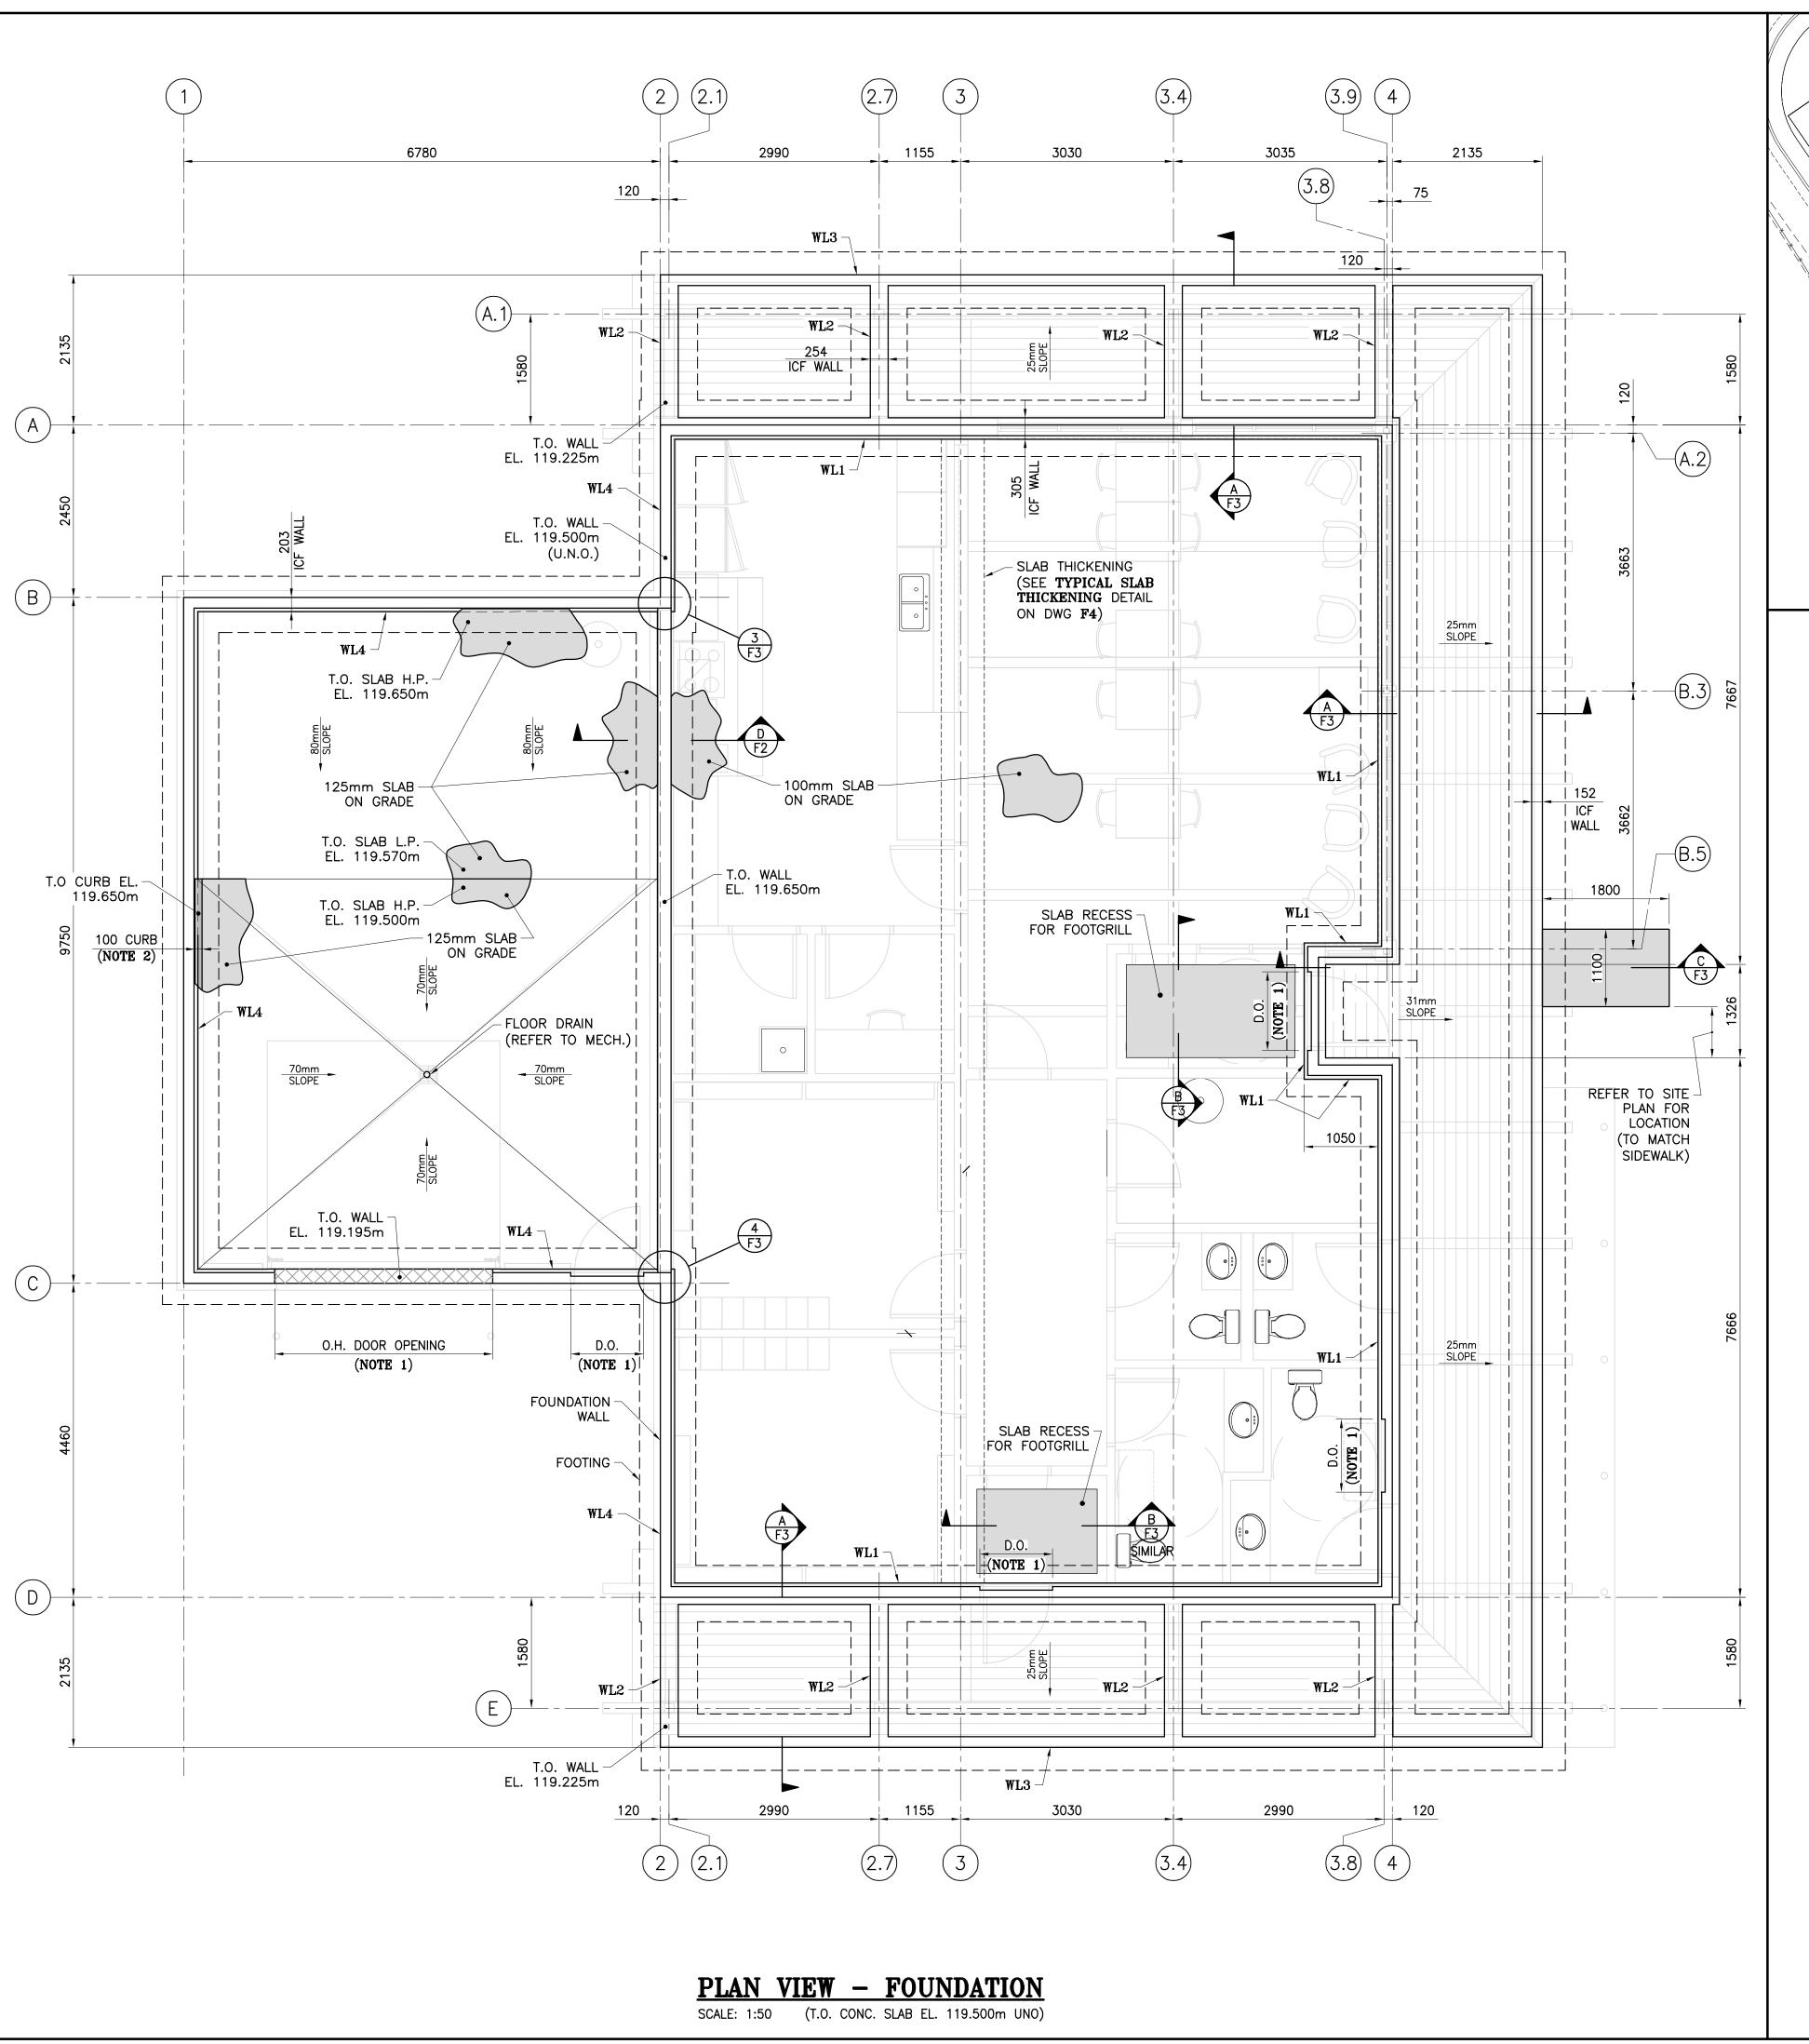

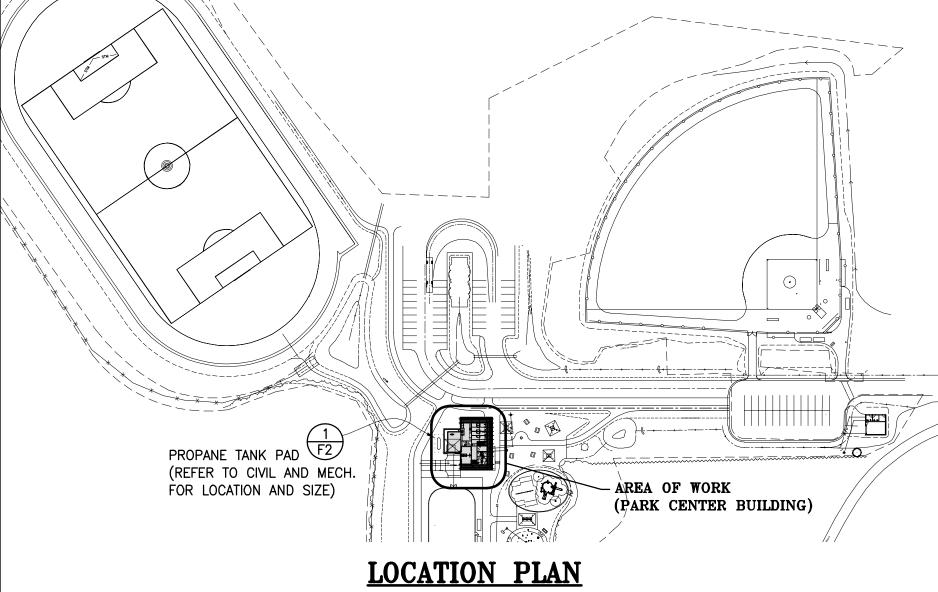

#### **LEGEND**

D.O. = INDICATES DOOR OPENING
(COORDINATE SIZE AND LOCATION WITH ARCH.)

WL1 = INDICATES FOUNDATION WALL TYPE 'WL1'
(REFER TO DRAWING F2 FOR FOUNDATION
WALL DETAILS)

T.O. = TOP OF
N.I.C. = NOT IN CONTRACT
C.J. = CONTROL JOINT

N.I.C. = NOT IN CONTRACT
C.J. = CONTROL JOINT
E.W. = EACH WAY
T&B = TOP AND BOTTOM
UNO = UNLESS NOTED OTHERWISE

c/w = COMPLETE WITH

----- = CONTROL JOINT (SEE SLAB ON GRADE DETAIL)

#### **GENERAL NOTES:**

- CONTRACTOR IS RESPONSIBLE FOR ALL CUTTING AND PATCHING, AND THE REMOVAL OF ALL EXISTING MATERIALS AND INSTALLATIONS NECESSARY FOR THE EXECUTION OF THE WORK DESCRIBED BELOW OR SHOWN ON THESE STRUCTURAL DRAWINGS. ALL REMOVED MATERIALS ARE TO BE DISPOSED OF IN ACCORDANCE WITH AUTHORITY HAVING JURISDICTION, UNLESS INDICATED OTHERWISE BY OWNER AND/OR TENANT.
- CONTRACTOR SHALL VERIFY ALL DIMENSIONS, LOCATIONS, ELEVATIONS AND/OR CONSTRUCTION DETAILS. REPORT ANY DISCREPANCIES TO THE CONSULTANT. DO NOT SCALE ON THESE STRUCTURAL DRAWINGS.
- ALL WORK SHALL BE PERFORMED AND COMPLETED TO THE STANDARDS OF MATERIALS AND WORKMANSHIP AS PER THE NATIONAL BUILDING CODE OF CANADA (NBC), 2015, INCLUDING ALL CORRECTIONS AND REVISIONS TO DATE. ALL WORK AND INSTALLATIONS SHALL ALSO COMPLY TO APPLICABLE MUNICIPAL AND PROVINCIAL REGULATIONS. IN THE ABSENCE OF SPECIFIC REQUIREMENTS IN THE ABOVE, WORK SHALL CONFORM TO SOUND BUILDING PRACTICE AND QUALITY WORKMANSHIP.
- THESE STRUCTURAL DRAWINGS ARE TO BE READ IN CONJUNCTION WITH STRUCTURAL SPECIFICATIONS.
- REFER TO ARCHITECTURAL DRAWINGS FOR WALL OPENING DIMENSIONS AND LOCATIONS.
- SEE MECH. FOR LOCATION OF REQUIRED SLEEVES THROUGH FOUNDATION WALL. OPENING SHALL BE 6"Ø OR LESS (UNLESS APPROVED BY CONSULTANT) AND SHOULD NOT INTERRUPT REINFORCEMENT BARS.
- TYPICAL STEEL REINFORCEMENT COVER TO BE 40mm U.N.O.

# ARCHITECTS:

1435, RUE SAINT-ALEXANDRE, BUREAU 1000 MONTRÉAL (QUÉBEC) H3A 2G4 T. 514-393-9490 F. 514-393-9498 info@evogarchitecture.com

ROY CONSULTANTS

13, rue Costigan Street
Edmundston (NB) E3V 1
T. / 506.737.9730
ES D'INGÉNIERIE F. / 506.548.2207

REF: 493-18-4B


LANDSCAPE ARCHITECTS:



Red Island Contractors Inc. 305, Route 390, Tobique First Nation, NB, E7H 4P7

#### SPECIFIC NOTES

- 1. REFER TO ARCHITECTURAL DRAWINGS FOR LOCATION AND DIMENSION OF DOOR OPENINGS.
- 2. REFER TO **DETAIL 1** ON **DWG F2** FOR CURB REQUIRED ALONG LINES 1, B & C. (INTERRUPT CURB AT DOOR OPENINGS)

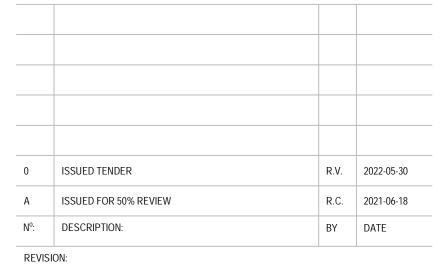

#### GENERAL NOTES :

- THE GENERAL CONTRACTOR IS RESPONSIBLE FOR VERIFYING ALL DIMENSIONS ON SITE TO ENSURE CONFORMITY WITH THE DIMENSIONS GIVEN ON THE DRAWINGS.

  THE CENERAL CONTRACTOR OF PERPONSIBLE FOR MATERIAL CONTRACTOR OF PERPONSIBLE FOR PE
- THE GENERAL CONTRACTORIS RESPONSIBLE TO IMMEDIATELY SUBMIT A REPORT TO THE ARCHITECT OR ENGINEER WITH ANY INACCURACIES.
   THE GENERAL CONTRACTORSHOULD NOT TAKE SCALED MEASUREMENTS OFF THE
- DRAWINGS.

  4. ANY INDIVIDUAL OR FIRM THAT HAVE RECEIVED ELECTRONIC DOCUMENT USE THEM AT THEIR OWN RISK. ONLY ORIGINAL DRAWINGS, STAMPED BY THE ARCHITECT, CAN BE USED FOR CONSTRUCTION.

KCIW KNICANEWEK SPORTS
AND RECREATION PARK PHASE 2 BUILDINGS
TOBIQUE FIRST NATION, NB

DRAWING TITLE:

VERIFIED: M. BOUDREAU


PARK CENTER BUILDING
-STRUCTURALFOUNDATION PLAN


SCALE: AS SHOWN


DESIGN: M. BOUDREAU APPROVED: -
DRAWN: R. COUTURE DATE: JUNE 2021

PROJECT N°: DRAWING N°:

9223-18-00 F1B

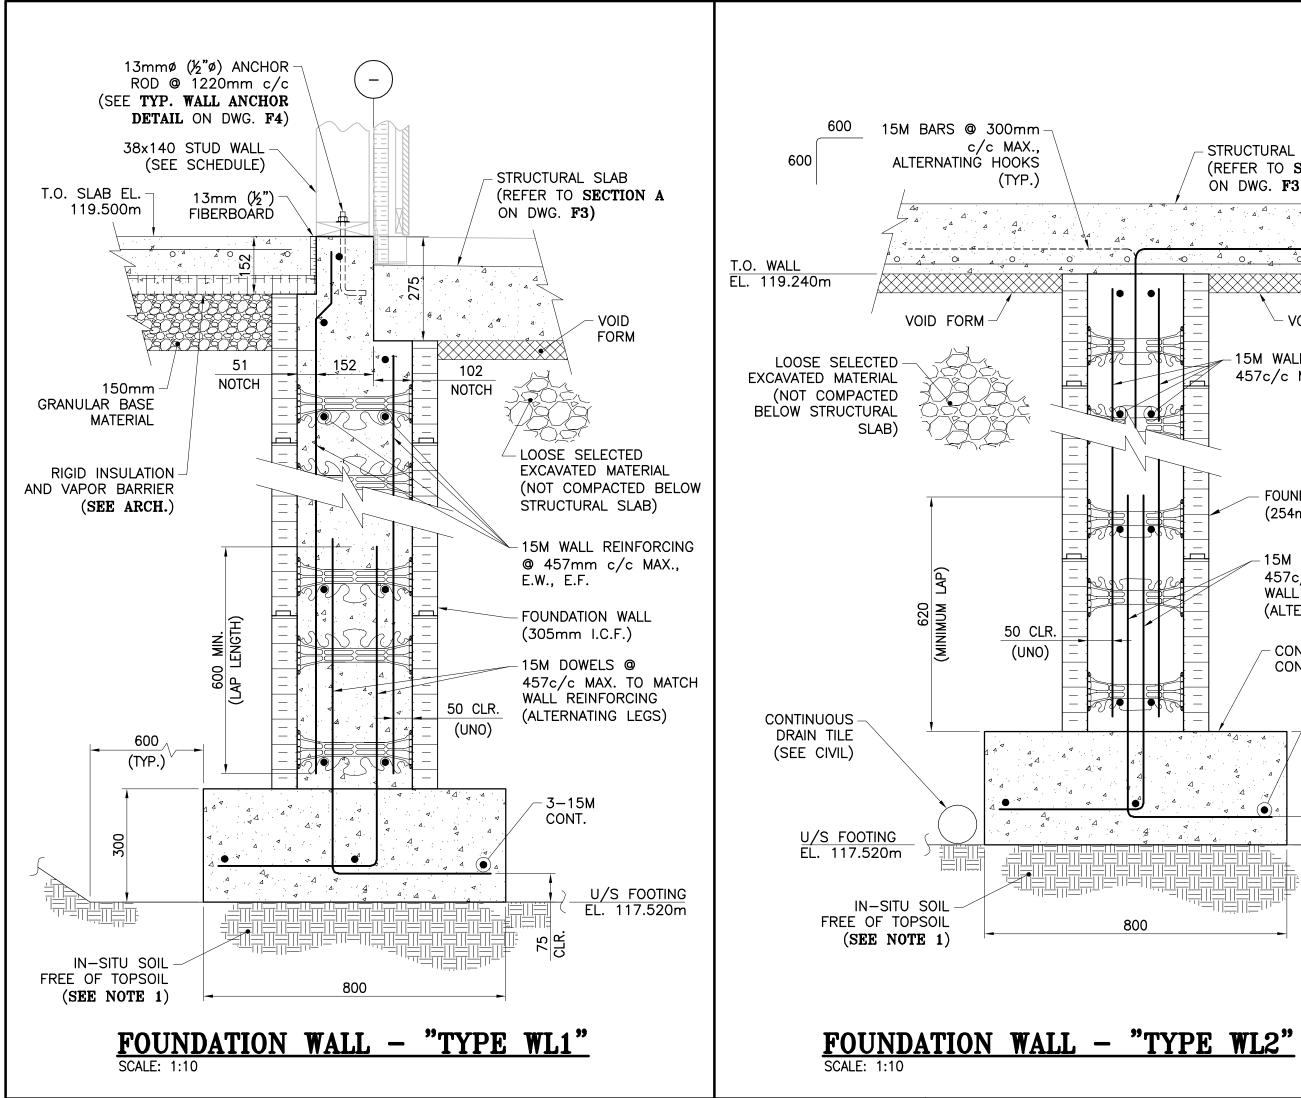

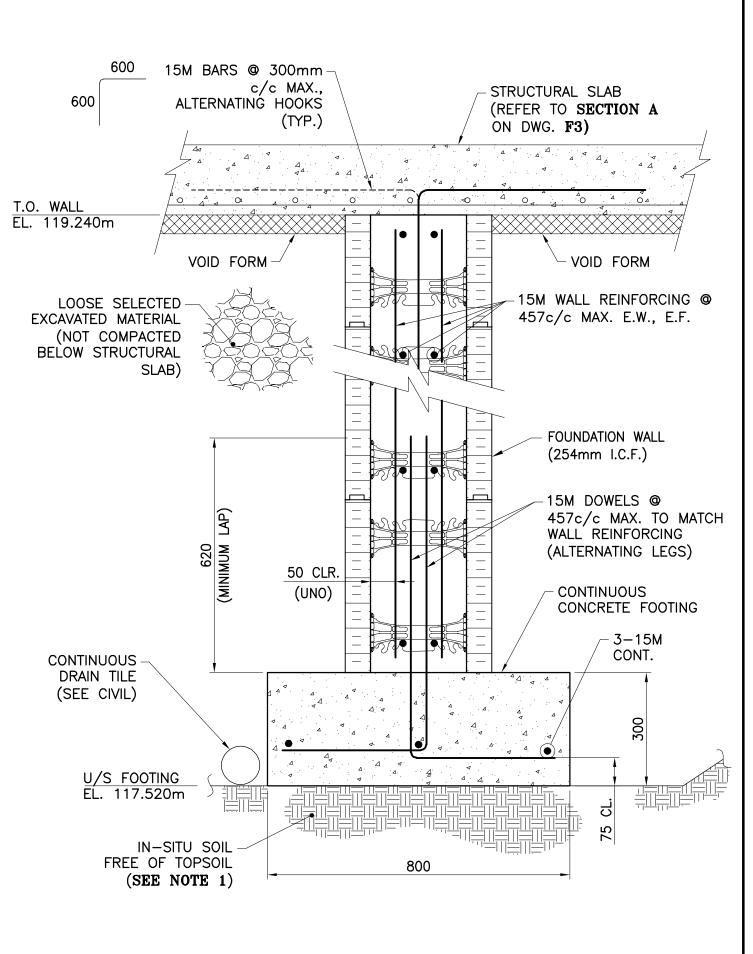

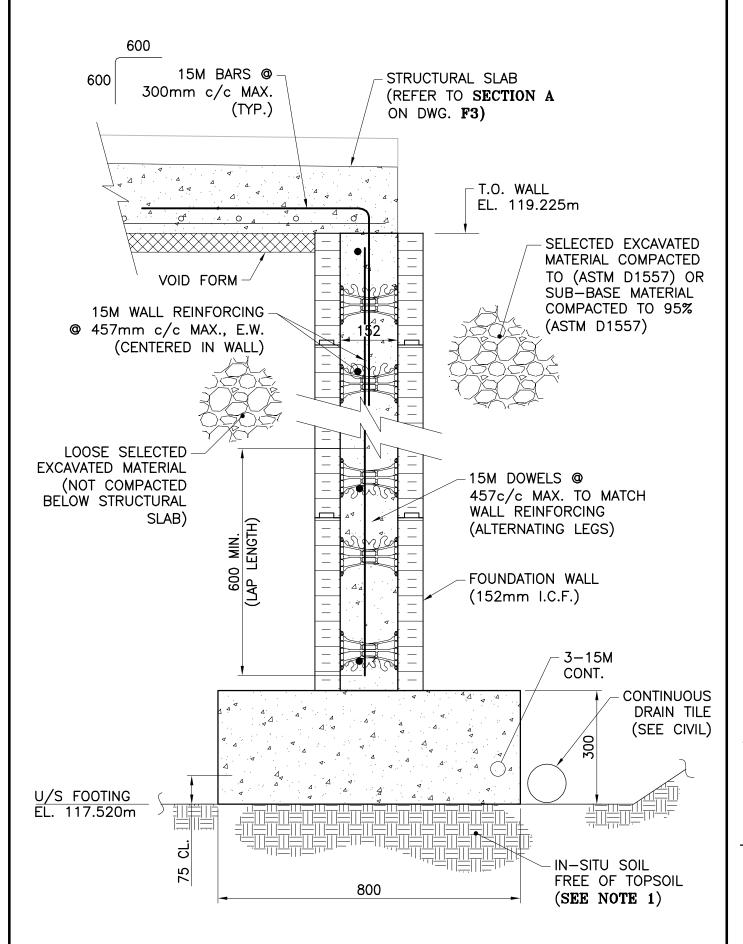


FOUNDATION WALL - "TYPE WL3"

DESIGN LOAD FOR 1000 GAL. PROPANE TANK


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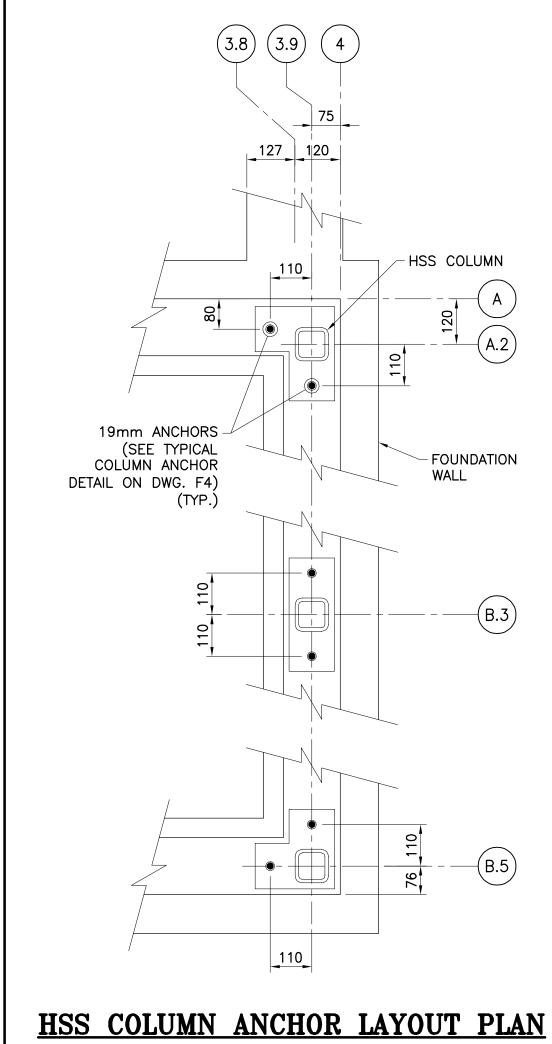
8 kN EMPTY WEIGHT


23 kN FULL WEIGHT




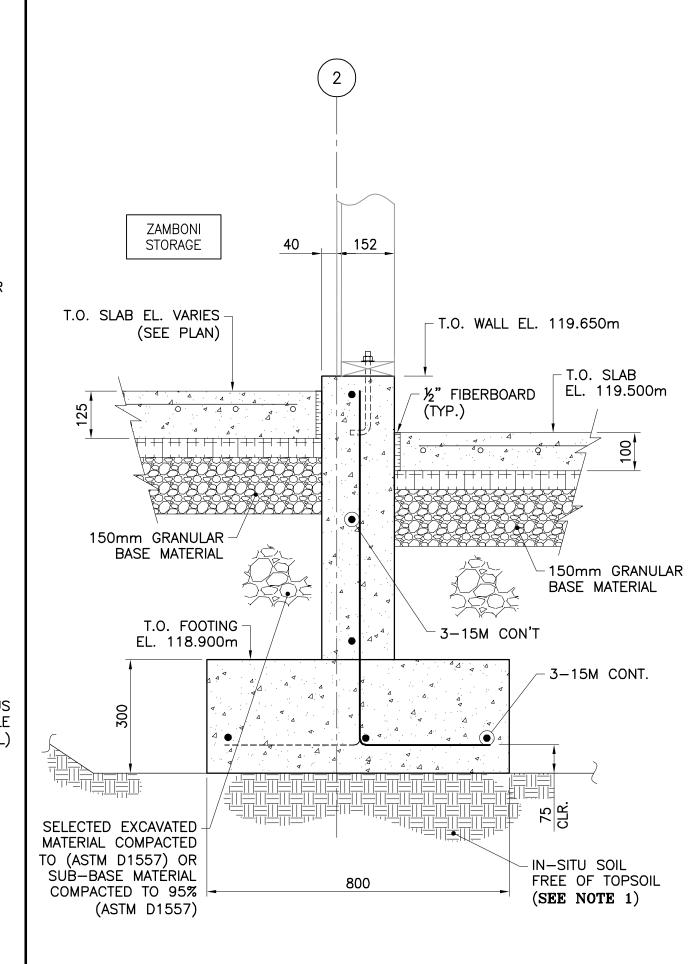



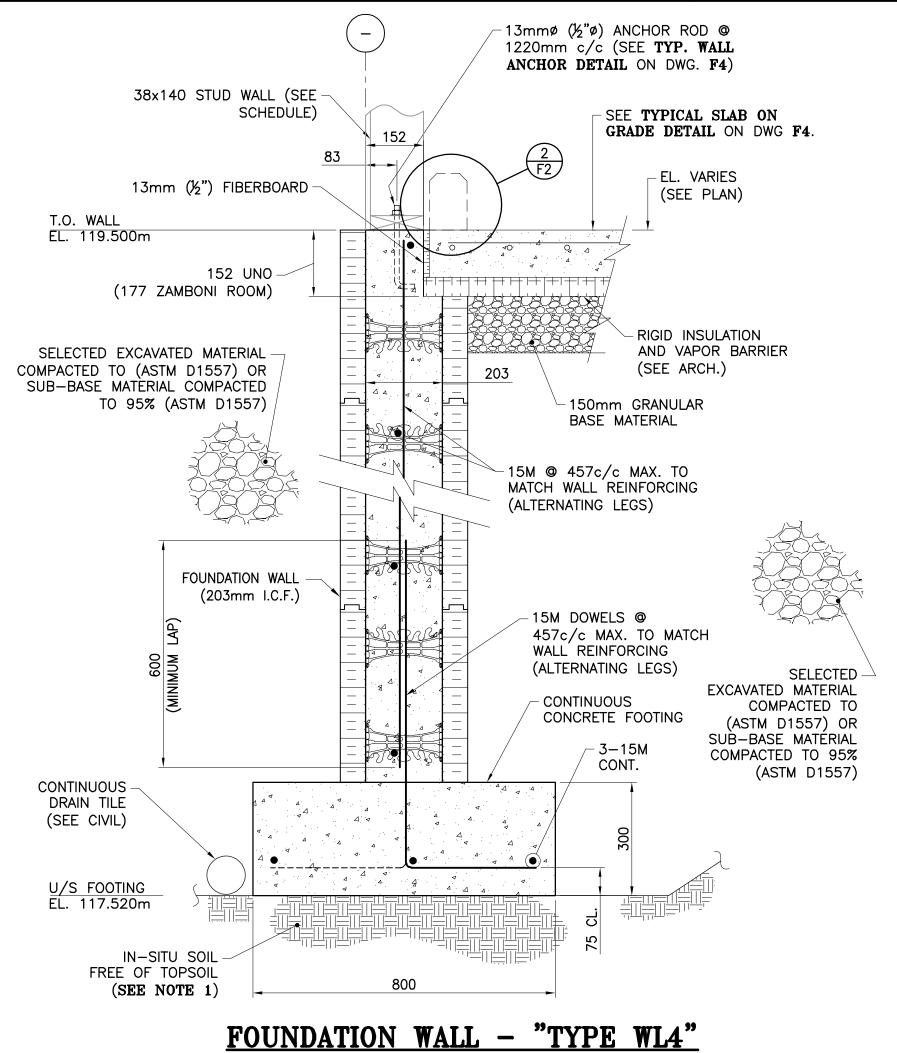

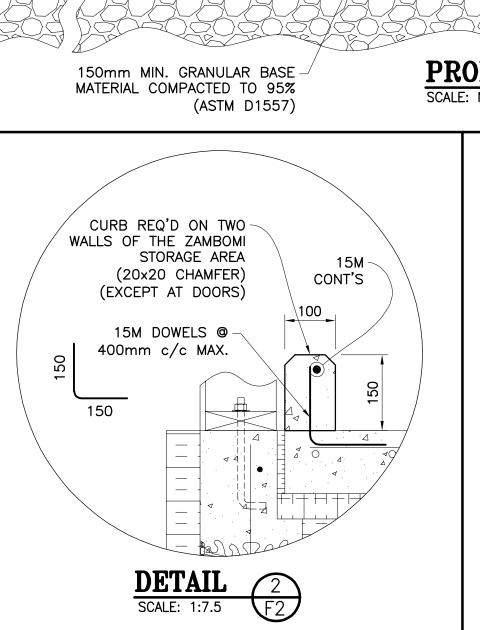

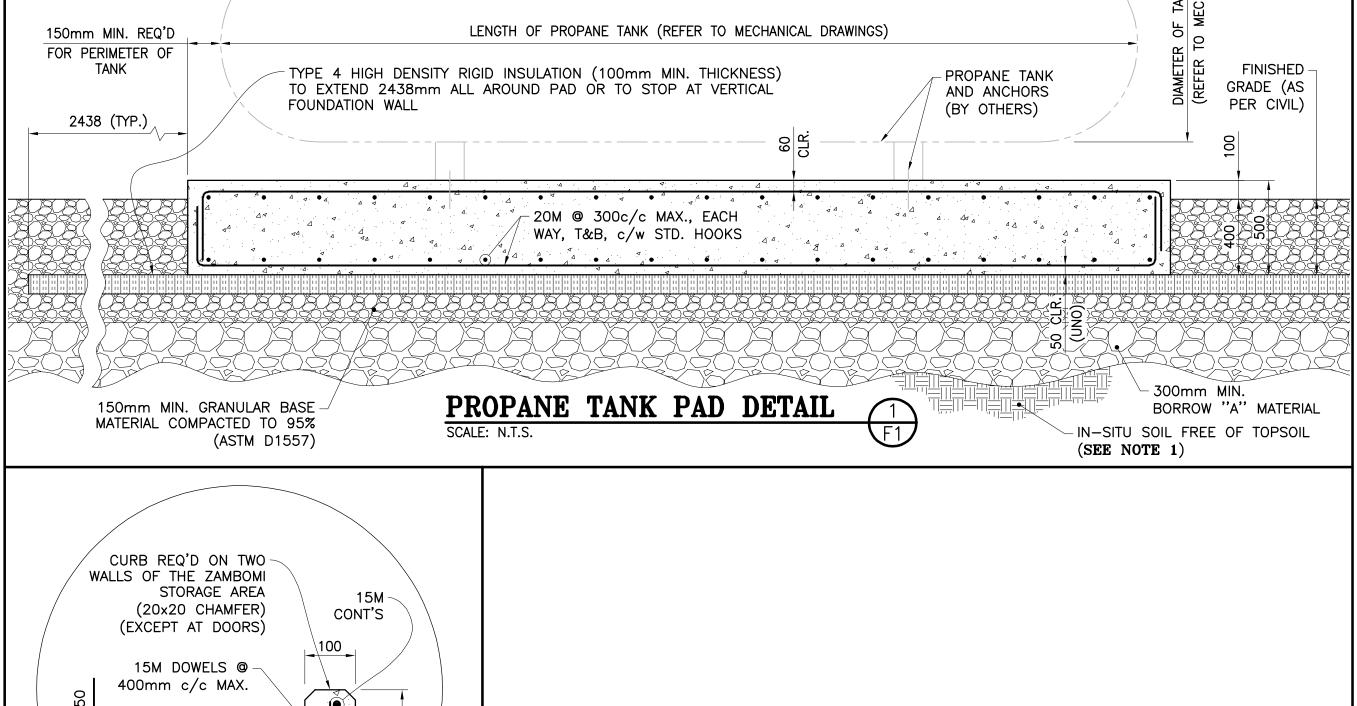

# EVOQ

info@evoqarchitecture.com

1435, RUE SAINT-ALEXANDRE, BUREAU 1000 MONTRÉAL (QUÉBEC) H3A 2G4 T. 514-393-9490 F. 514-393-9498



REF: 493-18-4B

LANDSCAPE ARCHITECTS:



Red Island Contractors Inc. 305, Route 390, Tobique First Nation, NB, E7H 4P7

#### GENERAL NOTE

- REFER TO DRAWING F1 FOR GENERAL NOTES AND LEGEND.

#### SPECIFIC NOTES

1. REFER TO GEOTECHNICAL REPORT FOR EXCAVATION AND BACKFILL RECOMMENDATIONS.

0	ISSUED TENDER	R.V.	2022-05-30
A	ISSUED FOR 50% REVIEW	R.C.	2021-06-18
Nº:	DESCRIPTION:	BY	DATE

#### **GENERAL NOTES:**

REVISION:

1. THE GENERAL CONTRACTOR IS RESPONSIBLE FOR VERIFYING ALL DIMENSIONS ON SITE TO ENSURE CONFORMITY WITH THE DIMENSIONS GIVEN ON THE DRAWINGS. THE GENERAL CONTRACTORIS RESPONSIBLE TO IMMEDIATELY SUBMIT A REPORT

TO THE ARCHITECT OR ENGINEER WITH ANY INACCURACIES.

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KCIW KNICANEWEK SPORTS AND RECREATION PARK -PHASE 2 BUILDINGS TOBIQUE FIRST NATION, NB


DRAWING TITLE:


PARK CENTER BUILDING -STRUCTURAL-**SECTIONS & DETAILS** 

DESIGN: M. BOUDREAU APPROVED: DRAWN: R. COUTURE DATE: JUNE 2021 VERIFIED: M. BOUDREAU SCALE: AS SHOWN

PROJECT Nº: DRAWING N°: 9223-18-00

F2B

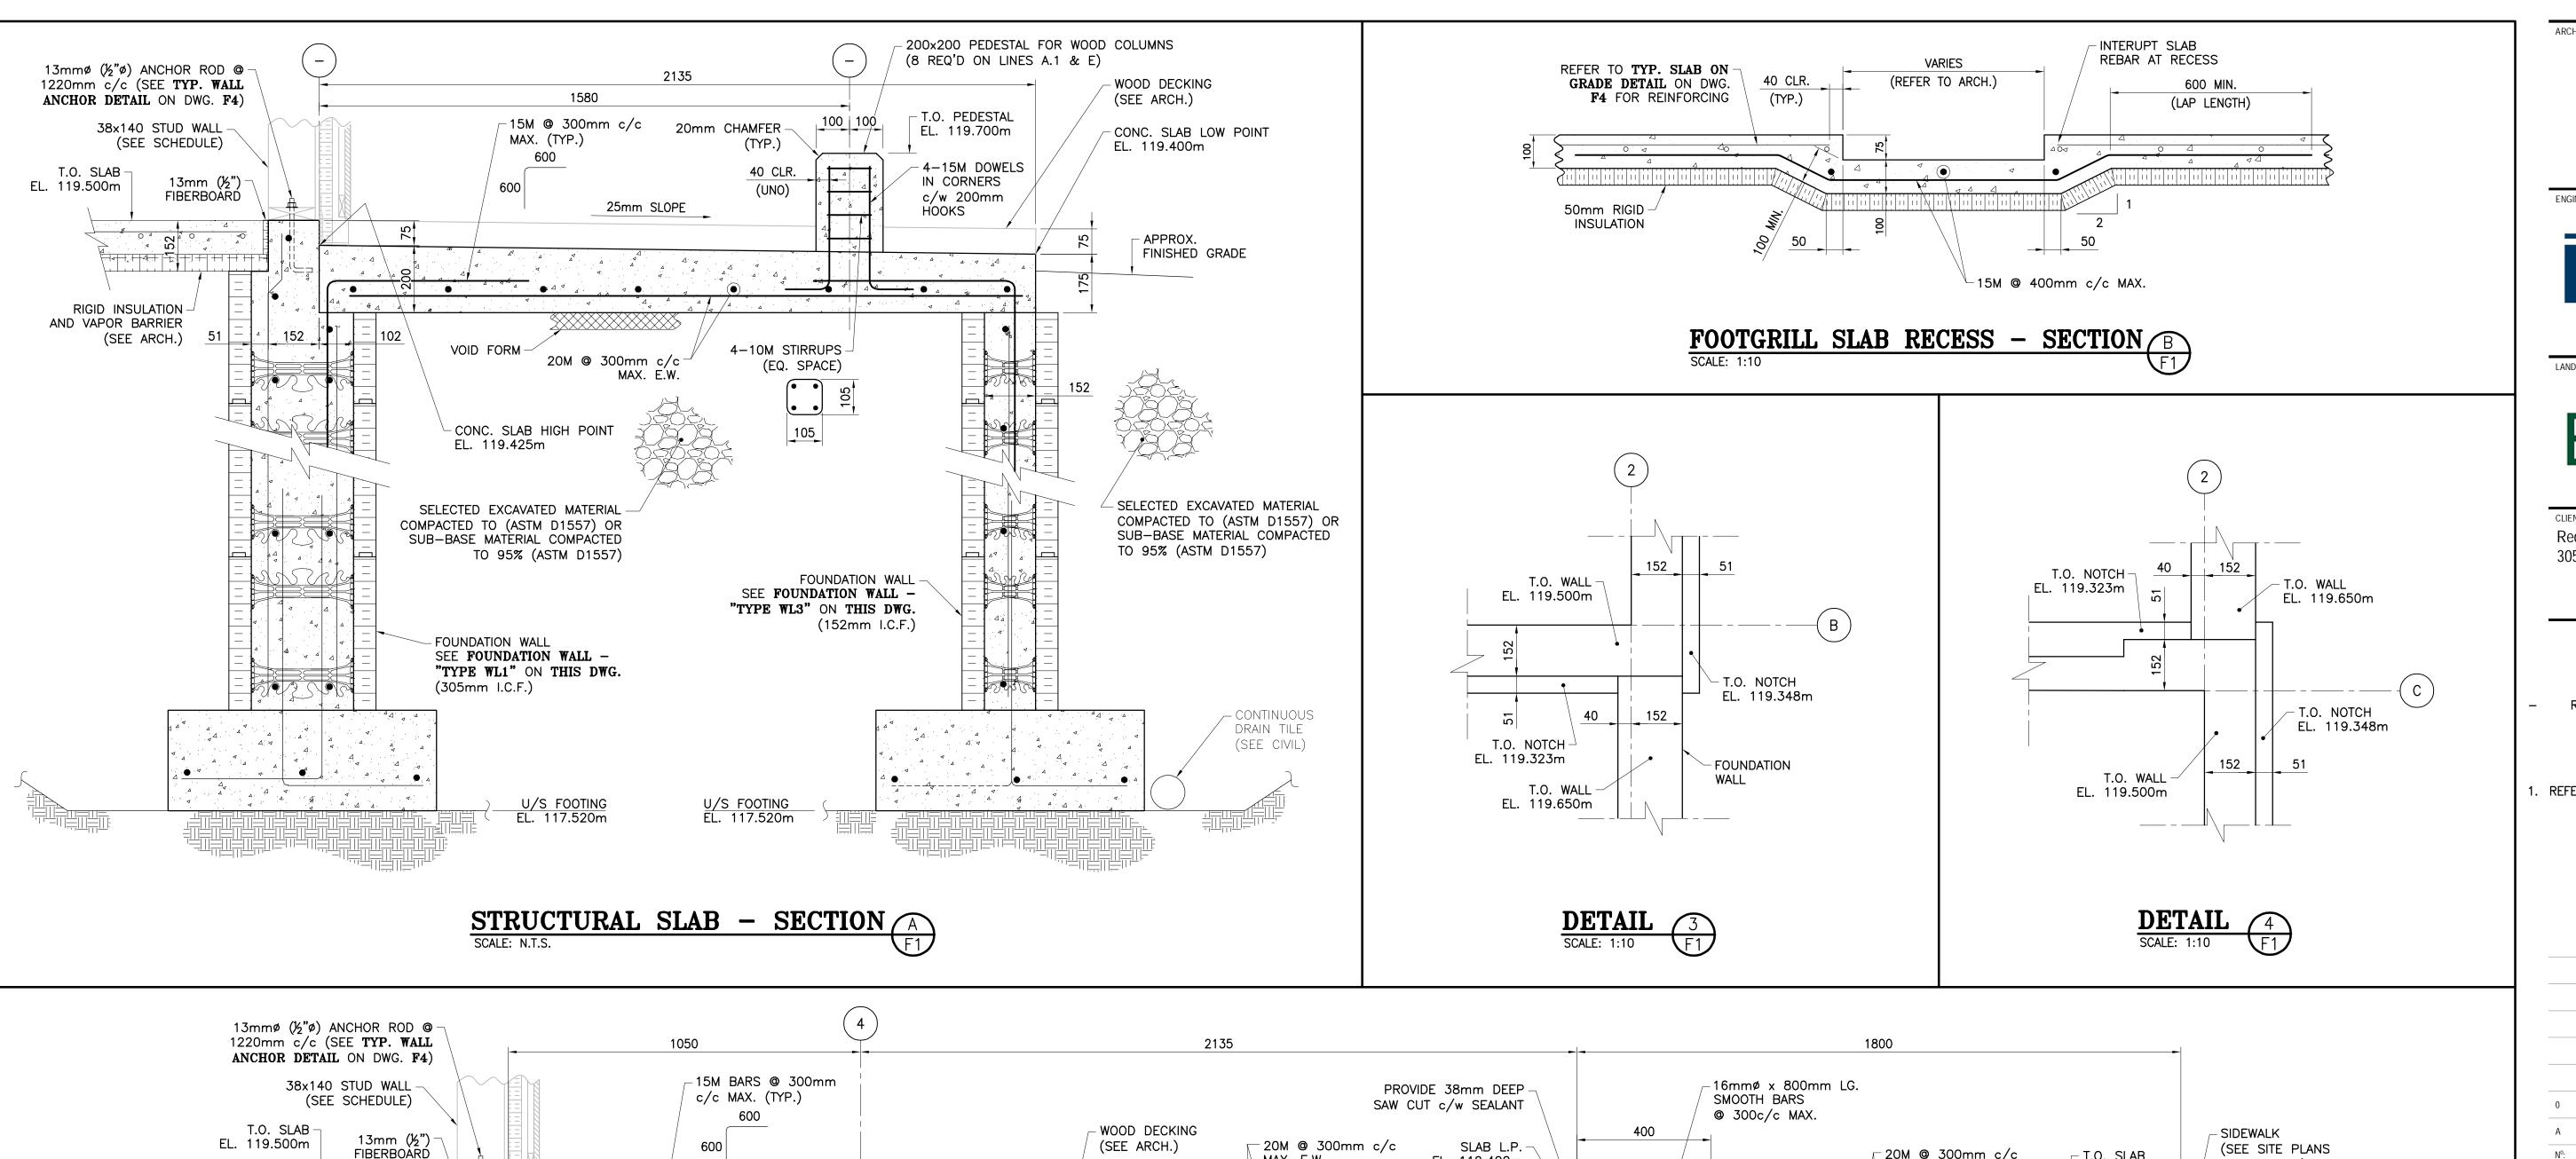

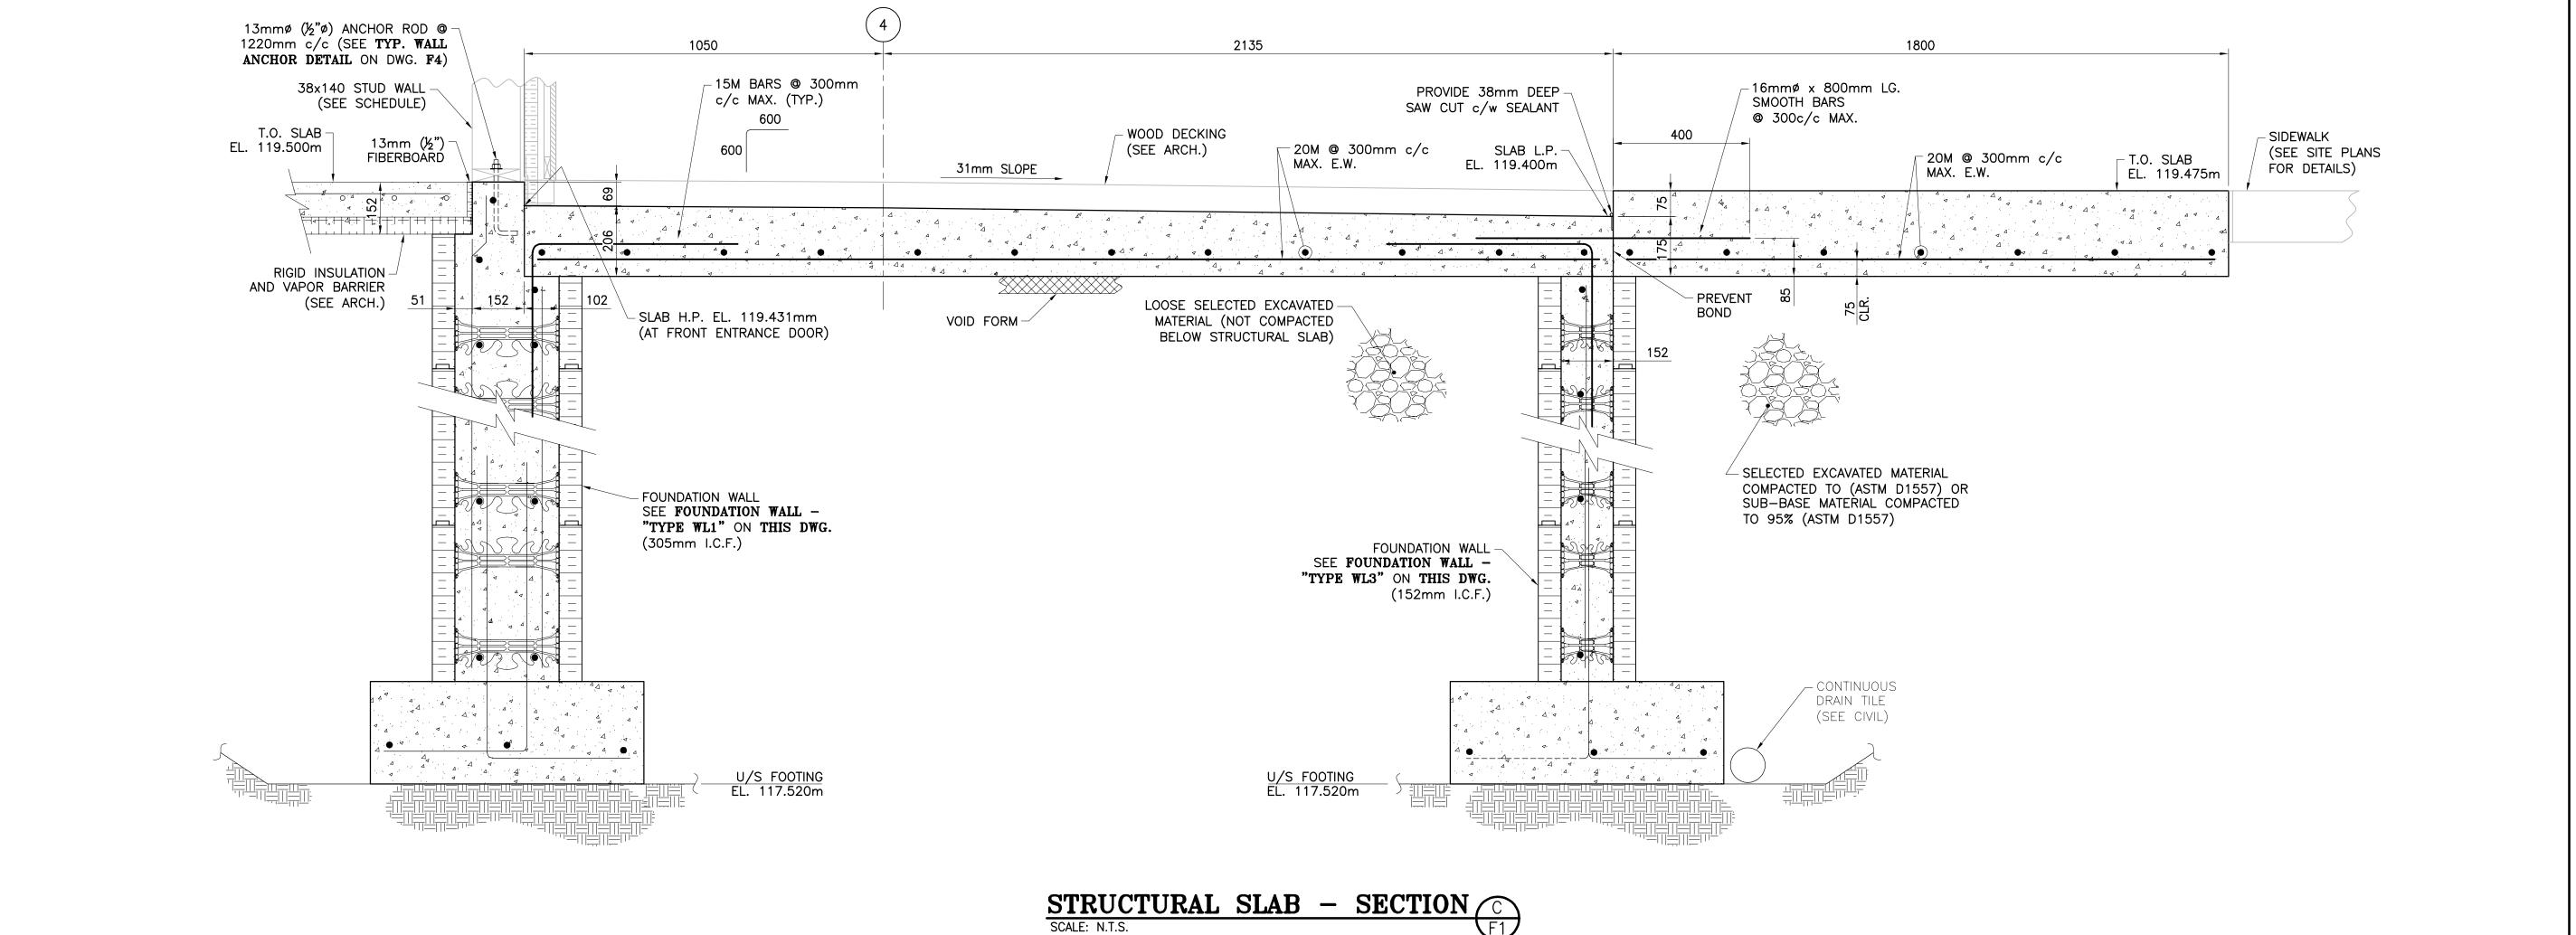

EVOQ

1435, RUE SAINT-ALEXANDRE, BUREAU 1000 MONTRÉAL (QUÉBEC) H3A 2G4 T. 514-393-9490 F. 514-393-9498 info@evoqarchitecture.com

ENGINEERS:



13, rue Costigan Street Edmundston (NB) E3V 1W7

REF: 493-18-4B

LANDSCAPE ARCHITECTS:



Red Island Contractors Inc. 305, Route 390, Tobique First Nation, NB, E7H 4P7

#### **GENERAL NOTE**

REFER TO DRAWING F1 FOR GENERAL NOTES AND LEGEND.

### SPECIFIC NOTE

. REFER TO PLAN VIEW ON DRAWING F1 FOR SLAB THICKNESS.

0	ISSUED TENDER	R.V.	2022-05-30
Α	ISSUED FOR 50% REVIEW	R.C.	2021-06-18
Nº:	DESCRIPTION:	BY	DATE
RE	/ISION:		1

#### **GENERAL NOTES:**

- 1. THE GENERAL CONTRACTOR IS RESPONSIBLE FOR VERIFYING ALL DIMENSIONS ON SITE TO ENSURE CONFORMITY WITH THE DIMENSIONS GIVEN ON THE DRAWINGS. 2. THE GENERAL CONTRACTORIS RESPONSIBLE TO IMMEDIATELY SUBMIT A REPORT TO THE ARCHITECT OR ENGINEER WITH ANY INACCURACIES.
- 3. THE GENERAL CONTRACTORSHOULD NOT TAKE SCALED MEASUREMENTS OFF THE
- ANY INDIVIDUAL OR FIRM THAT HAVE RECEIVED ELECTRONIC DOCUMENT USE THEM AT THEIR OWN RISK. ONLY ORIGINAL DRAWINGS, STAMPED BY THE ARCHITECT, CAN BE USED FOR CONSTRUCTION.

KCIW KNICANEWEK SPORTS AND RECREATION PARK -PHASE 2 BUILDINGS TOBIQUE FIRST NATION, NB


DRAWING TITLE:

PARK CENTER BUILDING -STRUCTURAL-**SECTIONS & DETAILS** 


DESIGN: M. BOUDREAU APPROVED: DRAWN: R. COUTURE DATE: JUNE 2021 VERIFIED: M. BOUDREAU SCALE: AS SHOWN

PROJECT Nº: DRAWING N°:


9223-18-00 F3B

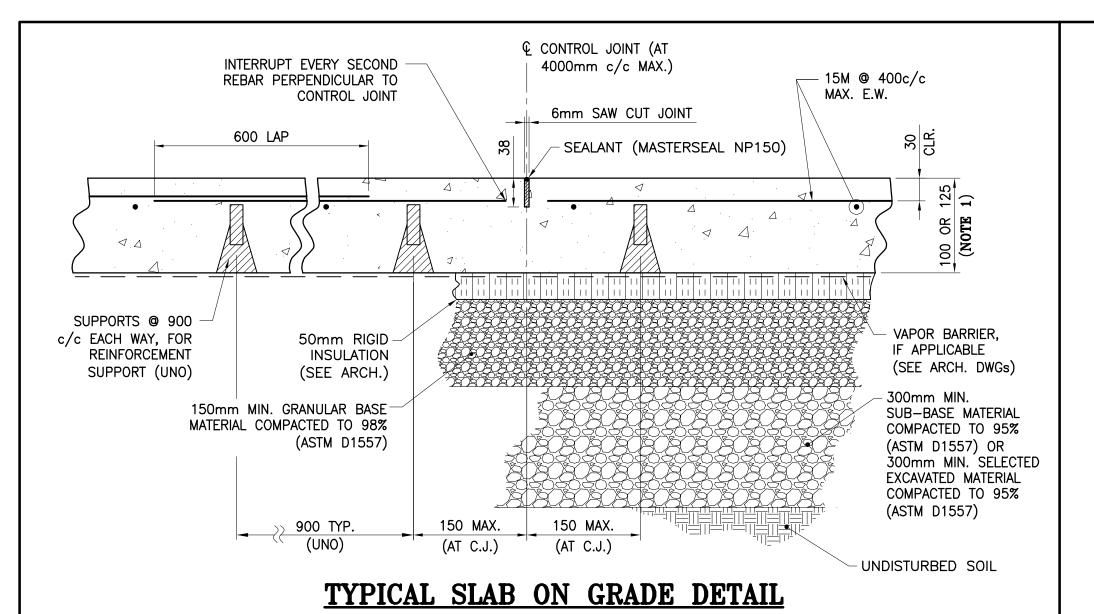


#### 38×140 STUD WALL (SEE SCHEDULE) - SEE **TYPICAL SLAB** ON GRADE DETAIL MIN. 610 OVERLAP (TYP.) ON THIS DWG. -15M @ 400mm c/c -3-15M CONT'S 150mm MIN. GRANULAR BASE -300mm MIN. SUB-BASE MATERIAL MATERIAL COMPACTED TO 98% COMPACTED TO 95% (ASTM D1557) OR (ASTM D1557) 300mm MIN. SELECTED EXCAVATED MATERIAL COMPACTED TO 95% (ASTM D1557) - UNDISTURBED SOIL TYPICAL SLAB THICKENING ON LINE 3

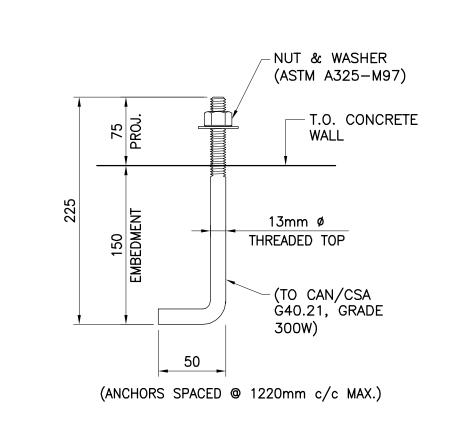


## TYPICAL WALL ANCHOR DETAIL

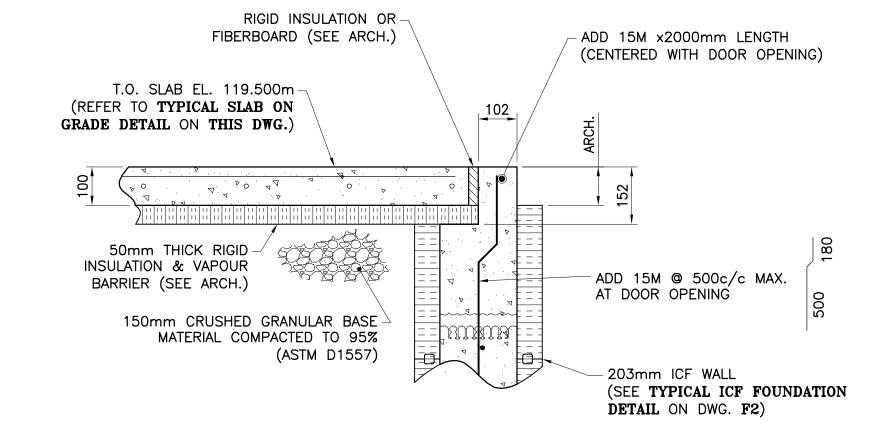


## TYP. DETAIL AT MAN DOORS (D.O.)

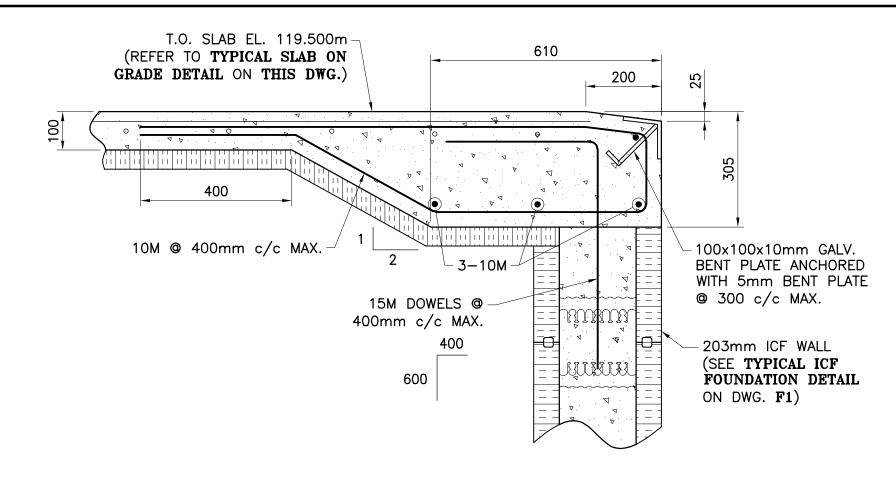


TYP. SECTION AT OVER HEAD DOOR

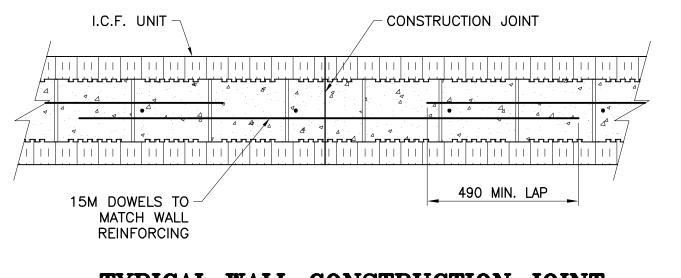

## TYPICAL WALL CONSTRUCTION JOINT

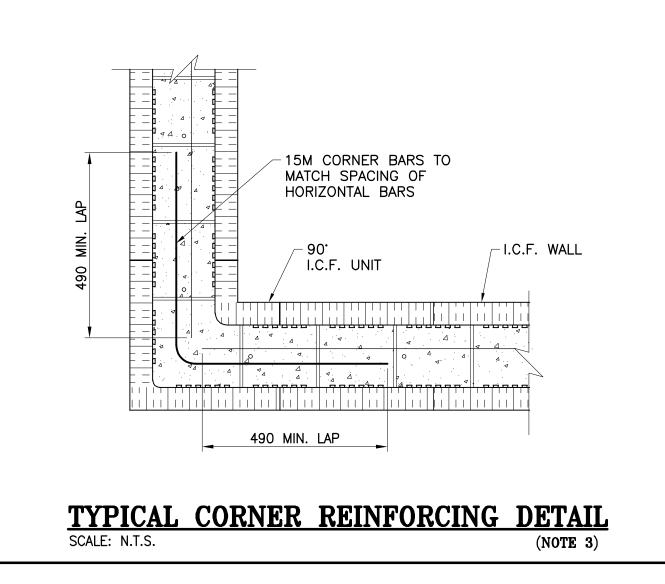

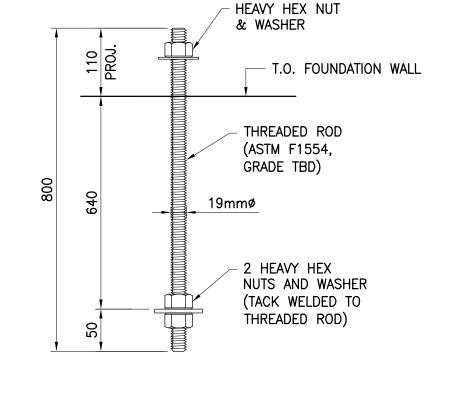

TYPICAL COLUMN ANCHOR DETAIL

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info@evoqarchitecture.com ENGINEERS:



13, rue Costigan Street Edmundston (NB) E3V 1W7

REF: 493-18-4B

LANDSCAPE ARCHITECTS:



Red Island Contractors Inc.

305, Route 390, Tobique First Nation, NB, E7H 4P7

#### SPECIFIC NOTES

- . REFER TO PLAN VIEW ON DRAWING F1 FOR SLAB THICKNESS.
- 2. THIS DETAIL IS APPLICABLE FOR 152mm AND 203mm THICK ICF WALLS. FOR 305mm THICK ICF WALL, TWO DOWELS ARE REQUIRED (NEAR FACE AND FAR FACE). LOCATIONS OF CONSTRUCTION JOINTS TO BE APPROVED BY THE ENGINEERING CONSULTANT.
- 3. THIS DETAIL IS APPLICABLE FOR 152mm AND 203mm THICK ICF WALLS. FOR 305mm THICK ICF WALL, TWO CORNER BARS ARE REQUIRED (NEAR FACE AND FAR

0	ISSUED TENDER	R.V.	2022-05-3
A	ISSUED FOR 50% REVIEW	R.C.	2021-06-1
Nº:	DESCRIPTION:	BY	DATE

**GENERAL NOTES:** 

- 1. THE GENERAL CONTRACTOR IS RESPONSIBLE FOR VERIFYING ALL DIMENSIONS ON
- SITE TO ENSURE CONFORMITY WITH THE DIMENSIONS GIVEN ON THE DRAWINGS 2. THE GENERAL CONTRACTORIS RESPONSIBLE TO IMMEDIATELY SUBMIT A REPORT TO THE ARCHITECT OR ENGINEER WITH ANY INACCURACIES.

3. THE GENERAL CONTRACTORSHOULD NOT TAKE SCALED MEASUREMENTS OFF THI

4. ANY INDIVIDUAL OR FIRM THAT HAVE RECEIVED ELECTRONIC DOCUMENT USE THEM AT THEIR OWN RISK. ONLY ORIGINAL DRAWINGS, STAMPED BY THE ARCHITECT, CAN BE USED FOR CONSTRUCTION.


KCIW KNICANEWEK SPORTS AND RECREATION PARK -PHASE 2 BUILDINGS TOBIQUE FIRST NATION, NB

PARK CENTER BUILDING -STRUCTURAL-**SECTIONS & TYPICAL DETAILS** 

DESIGN: M. BOUDREAU APPROVED: DATE: JUNE 2021 DRAWN: R. COUTURE VERIFIED: M. BOUDREAU SCALE: AS SHOWN

PROJECT Nº: DRAWING N°:

9223-18-00 F4B

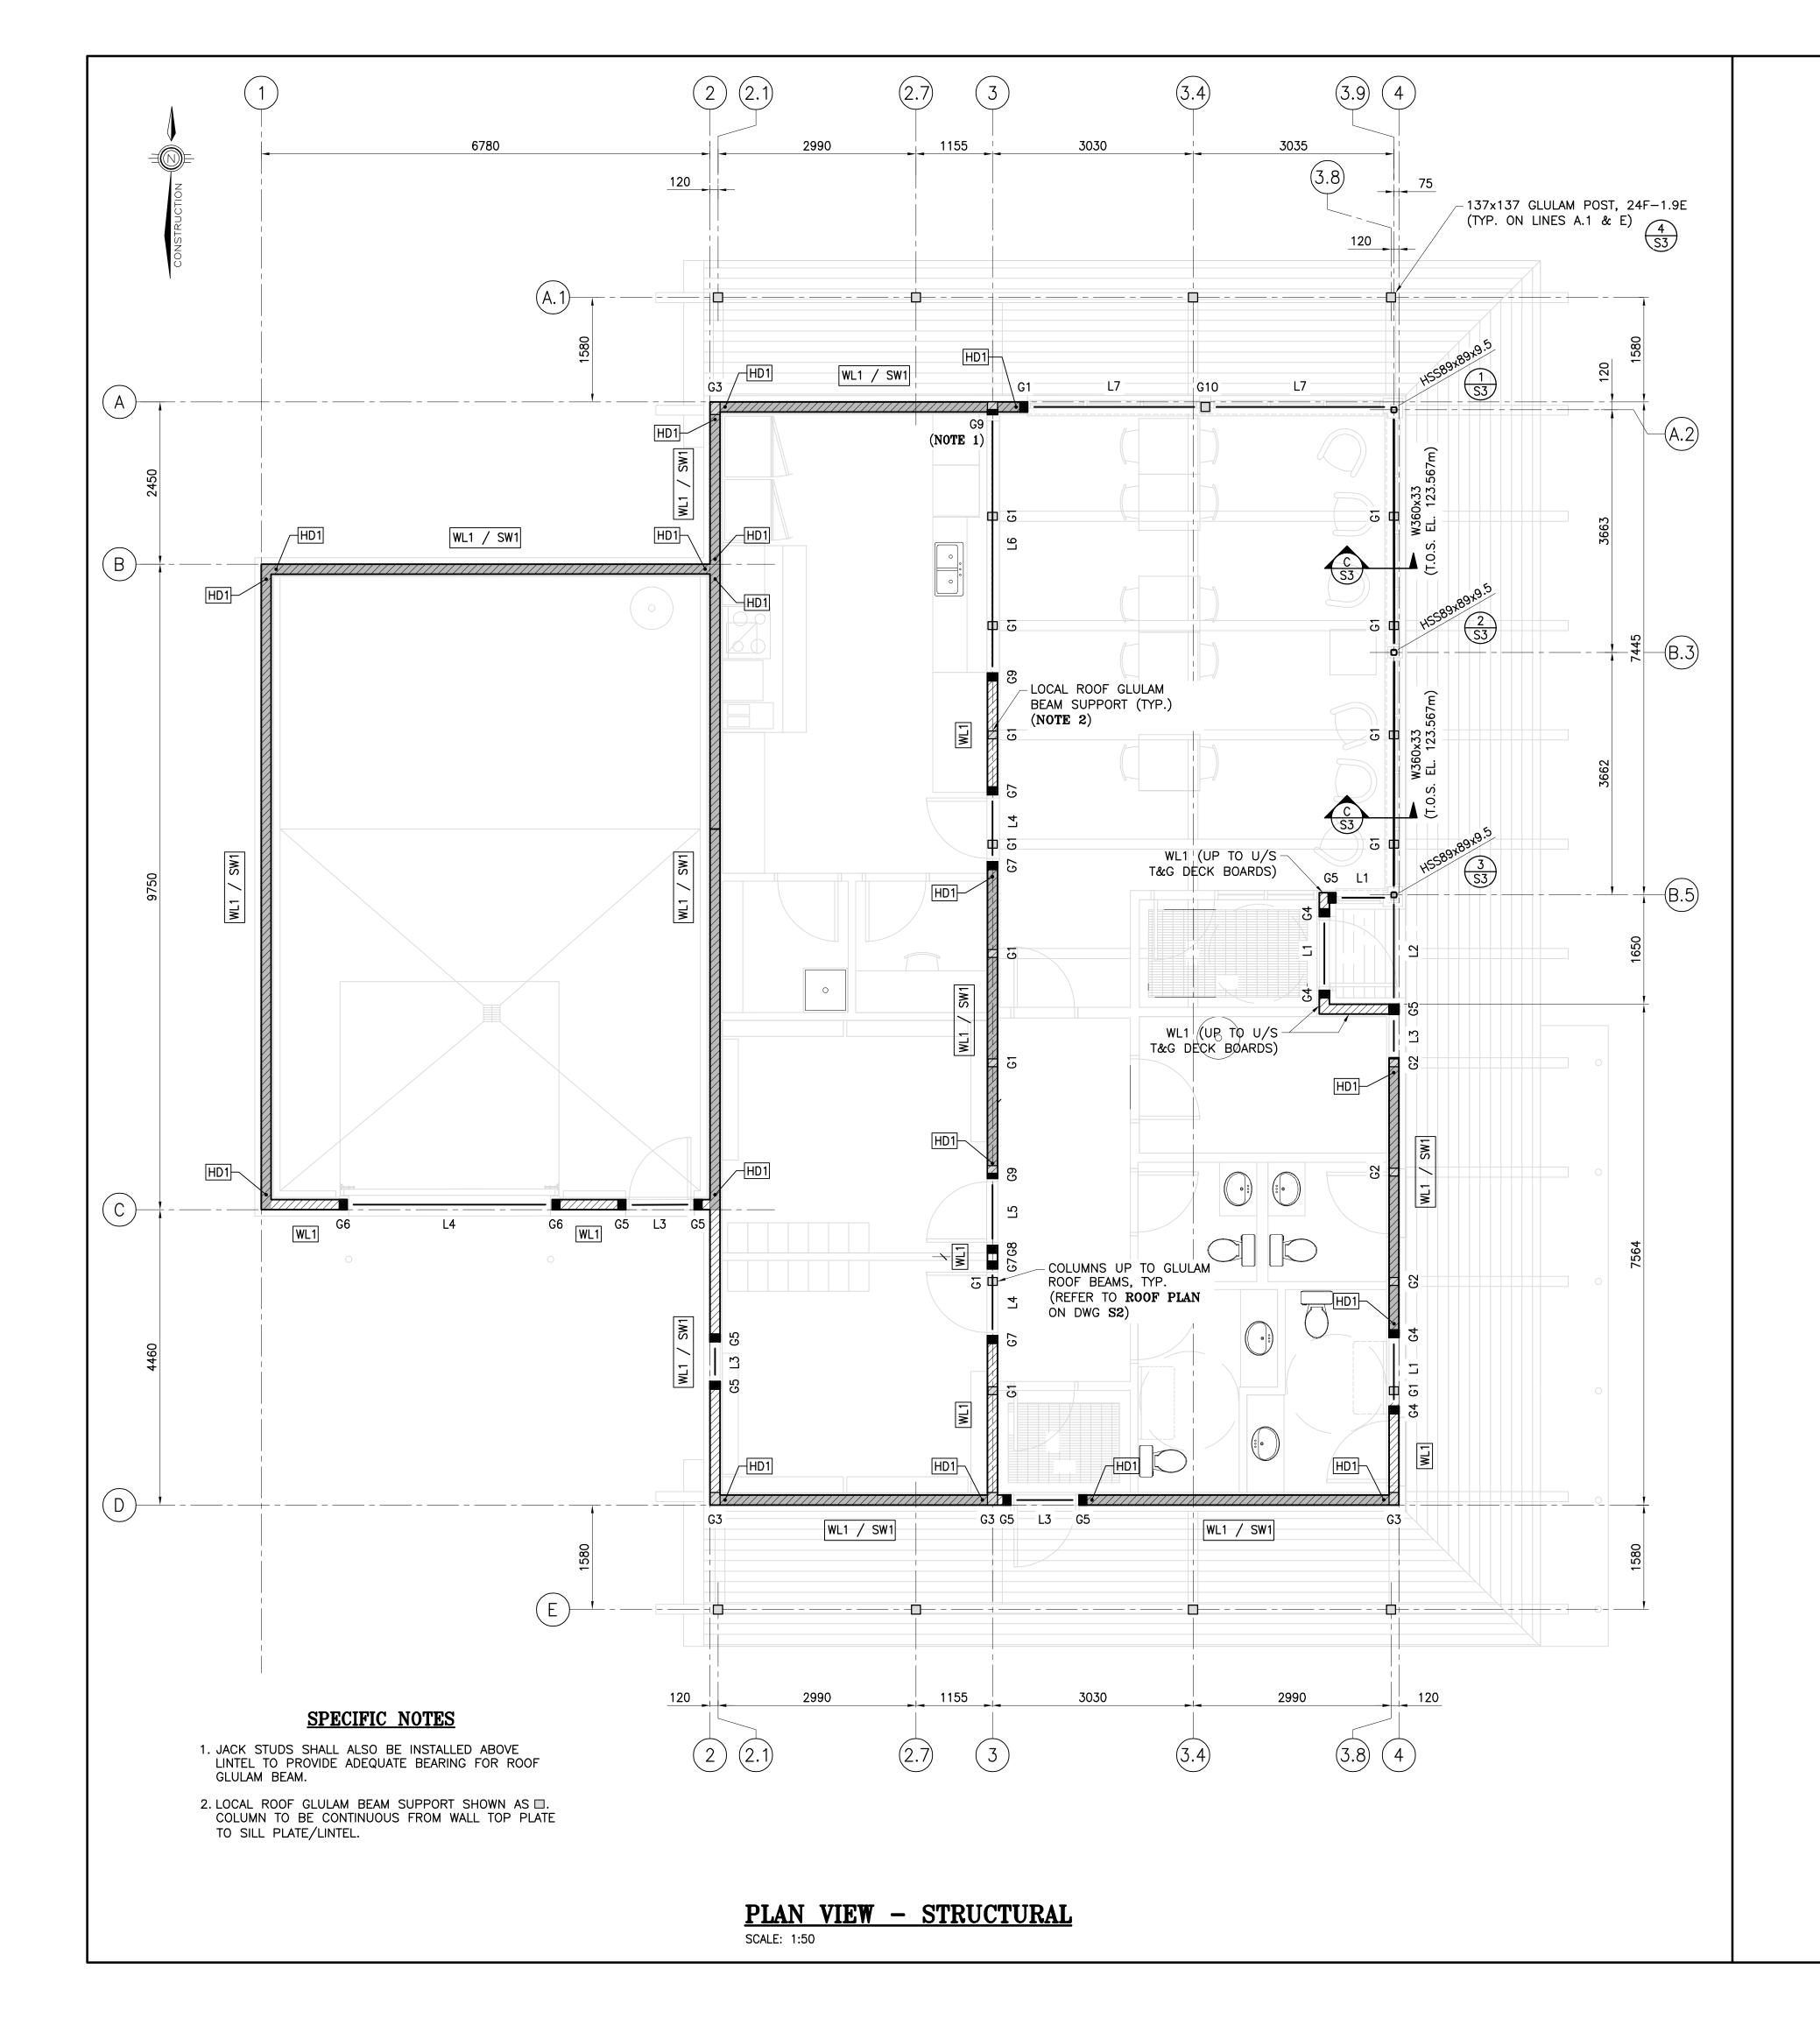

#### **LEGEND**

Gx - GANG STUD, SEE SCHEDULE ON THIS DRAWING.

LX - LINTEL, SEE SCHEDULE ON THIS DRAWING.

HDx - HOLD-DOWN, SEE SCHEDULE ON THIS DRAWING.

- SHEAR WALL, SEE SCHEDULE ON THIS DRAWING.

SWX

 $\frac{2}{|x|}$  - LOAD BEARING WALL, SEE SCHEDULE ON THIS DRAWING.

GANG STUD SCHEDULE					
MARK	MEMBER SIZE	NO. OF PLIES	KING STUDS REQ'D	JACK STUDS REQ'D	LUMBER GRADE
G1	38x140	3	3	0	No. 2 SPF
G2	38x140	4	4	0	No. 2 SPF
G3	38x140	5	5	0	No. 2 SPF
G4	38x140	4	2	2	No. 2 SPF
G5	38x140	3	2	1	No. 2 SPF
G6	38x140	4	3	1	No. 2 SPF
G7	38x140	4	2	2	No. 2 SPF
G8	38x140	3	2	1	No. 2 SPF
G9	38x140	5	3	2	No. 2 SPF
G10	133x133	_	_	_	PSL 1.8E

NOTE:

ALL GANG STUDS TO BE SPF #2 OR BETTER.REFER TO LINTEL ARRANGEMENTS ON DRAWING S4.

	LINTEL SCHEDULE					
MARK	MEMBER SIZE	NO. OF PLIES	LINTEL ARRANGEMENT	LUMBER GRADE		
L1	44X302	3	LINTEL ARRANGEMENT 'B'	LVL 2.0E		
L2	44X302	3	LINTEL ARRANGEMENT 'A'	LVL 2.0E		
L3	38X140	2	LINTEL ARRANGEMENT 'B'	No. 2 SPF		
L4	38X235	3	LINTEL ARRANGEMENT 'B'	No. 2 SPF		
L5	38X140	3	LINTEL ARRANGEMENT 'B'	No. 2 SPF		
L6	44X406	3	LINTEL ARRANGEMENT 'B'	LVL 2.0E		
L7	38X140	3	LINTEL ARRANGEMENT 'B' (LAID HORIZONTALLY)	No. 2 SPF		

NOTE:

– REFER TO LINTEL ARRANGEMENTS ON DRAWING S4.

#### LOAD BEARING WALL SCHEDULE

38x140mm SPF No.2 OR BETTER STUDS SPACED AT 406mm c/c MAX. SILL PLATE TO BE 38x140mm SPF No.2 OR BETTER. TOP PLATE TO BE 2-38X140mm SPF No.2 OR BETTER (UNO). STUD SPACINGS ARE MINIMUM STRUCTURAL REQUIREMENTS. CONTRACTOR TO MODIFY (CLOSER) AS REQUIRED TO SUIT ARCHITECTURAL FINISH.

#### HOLD-DOWN SCHEDULE

HD1: SIMPSON HDU5-SDS2.5 (76mm (3") MIN. END GANG STUD THICKNESS), ANCHORED TO FOUNDATION USING HILTI 15.9mmø HAS THREADED ROD c/w HILTI HIT-RE500 V3 EPOXY ADHESIVE INSTALLED AS PER MANUFACTURER'S RECOMMENDATIONS. MINIMUM EMBEDMENT DEPTH OF 200mm.

#### SHEAR WALL SCHEDULE

12.7mm PLYWOOD EXTERIOR SHEATHING WITH LONG DIMENSION LAID HORIZONTALLY AND ENDS STAGGERED 1220mm (4'-0") c/c. FASTEN SHEATHING WITH 63.5mm (2.5") LONG x 3.05mmø (0.120"ø) MIN. NAILS AT 75mm (3") c/c AT ALL PANEL EDGES AND AT 305mm (12") c/c ALONG INTERMEDIATE WALL STUDS. BLOCK PANEL EDGES. PROVIDE HOLD-DOWN ANCHORS AT EACH END OF OF ALL SHEAR WALL SEGMENTS SCREWED INTO 76mm (3") MIN. OR 114mm (4.5") THICKNESS GANG STUDS. REFER TO 'HOLD-DOWN SCHEDULE' FOR ANCHOR SIZE AND TYPES. ANCHOR WALL SILL PLATES TO FOUNDATION AS PER 'TYPICAL EXTERIOR WALL ANCHORING' DETAIL. INTERIOR GYPSUM WALL BOARD SHEATHING AS PER ARCHITECTURAL DRAWINGS.

NOTE: SHEAR WALLS ARE SHOWN SHADED ON PLANS

#### MINIMUM SHEATHING REQUIREMENTS

MATERIAL: CONSTRUCTION SHEATHING PLYWOOD IN ACCORDANCE WITH

CAN/CSA 0151.

ROOFS:

16mm THICK 5-PLY T&G PLYWOOD FOR ALL ROOFS (U.N.O.) ORIENTED AT 0' (EXTERIOR TYPE) WITH STAGGERED PATTERN.

NAIL SHEATHING AT 152mm c/c ON PANEL EDGES AND AT 305mm c/c AT INTERMEDIATE FRAMING MEMBERS USING 64mm

(2½") COMMON WIRE NAILS (8d).

BR'G WALLS:

12.7mm (U.N.O.) PLYWOOD SHEATHING FOR ALL BEARING WALLS (EXTERIOR TYPE FOR EXTERIOR WALLS), WITH LONG DIMENSION LAID HORIZONTALLY AND ENDS STAGGERED 1220mm (4'-0") c/c. FASTEN SHEATHING WITH 63.5mm (2.5") LONG x 3.05mmø (0.120"ø) MIN. NAILS AT 152mm (6") c/c MIN. AT ALL PANEL EDGES AND AT 305mm (12") c/c ALONG INTERMEDIATE WALL STUDS. BLOCK PANEL EDGES.

ARCHITECTS:



1435, RUE SAINT-ALEXANDRE, BUREAU 1000 MONTRÉAL (QUÉBEC) H3A 2G4 T. 514-393-9490 F. 514-393-9498 info@evogarchitecture.com

ENGINEERS



13, rue Costigan Street Edmundston (NB) E3V 1

REF: 493-18-4B

LANDSCAPE ARCHITECTS:




LIENI: Dod Islani

Red Island Contractors Inc. 305, Route 390, Tobique First Nation, NB, E7H 4P7

#### **GENERAL NOTES**

- CONTRACTOR SHALL VERIFY ALL DIMENSIONS, LOCATIONS, ELEVATIONS, SLOPES AND/OR CONSTRUCTION DETAILS. REPORT ANY DISCREPANCIES TO OWNER AND/OR CONSULTANT.
- THESE STRUCTURAL DRAWINGS ARE TO BE READ IN CONJUNCTION WITH STRUCTURAL SPECIFICATIONS.
- NO HOLES ARE PERMITTED IN THE SHEAR WALLS (OTHER THAN THOSE SHOWN ON THESE PROJECT DRAWINGS), WITHOUT THE CONSENT OF THE CONSULTING ENGINEER.

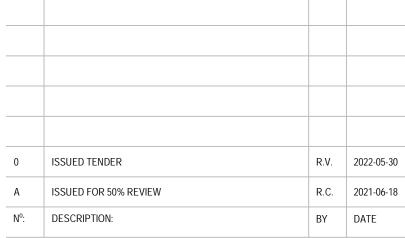

#### REVISION:

GENERAL NOTES :

ARCHITECT, CAN BE USED FOR CONSTRUCTION.

- THE GENERAL CONTRACTOR IS RESPONSIBLE FOR VERIFYING ALL DIMENSIONS ON SITE TO ENSURE CONFORMITY WITH THE DIMENSIONS GIVEN ON THE DRAWINGS.
   THE GENERAL CONTRACTORIS RESPONSIBLE TO IMMEDIATELY SUBMIT A REPORT TO THE ARCHITECT OR ENGINEER WITH ANY INACCURACIES.
- THE GENERAL CONTRACTORSHOULD NOT TAKE SCALED MEASUREMENTS OFF THE DRAWINGS.
   ANY INDIVIDUAL OR FIRM THAT HAVE RECEIVED ELECTRONIC DOCUMENT USE THEM AT THEIR OWN RISK. ONLY ORIGINAL DRAWINGS, STAMPED BY THE

PROJECT:

KCIW KNICANEWEK SPORTS AND RECREATION PARK -PHASE 2 BUILDINGS TOBIQUE FIRST NATION, NB

DRAWING T

VERIFIED: M. BOUDREAU

PARK CENTER BUILDING
-STRUCTURALPLAN VIEW & SCHEDULES

PLAN VIEW & SCHEDULES


DESIGN: M. BOUDREAU APPROVED: --

DRAWN: R. COUTURE DATE: JUNE 2021

PROJECT N°: DRAWING N°:

9223-18-00 S1B

SCALE: AS SHOWN

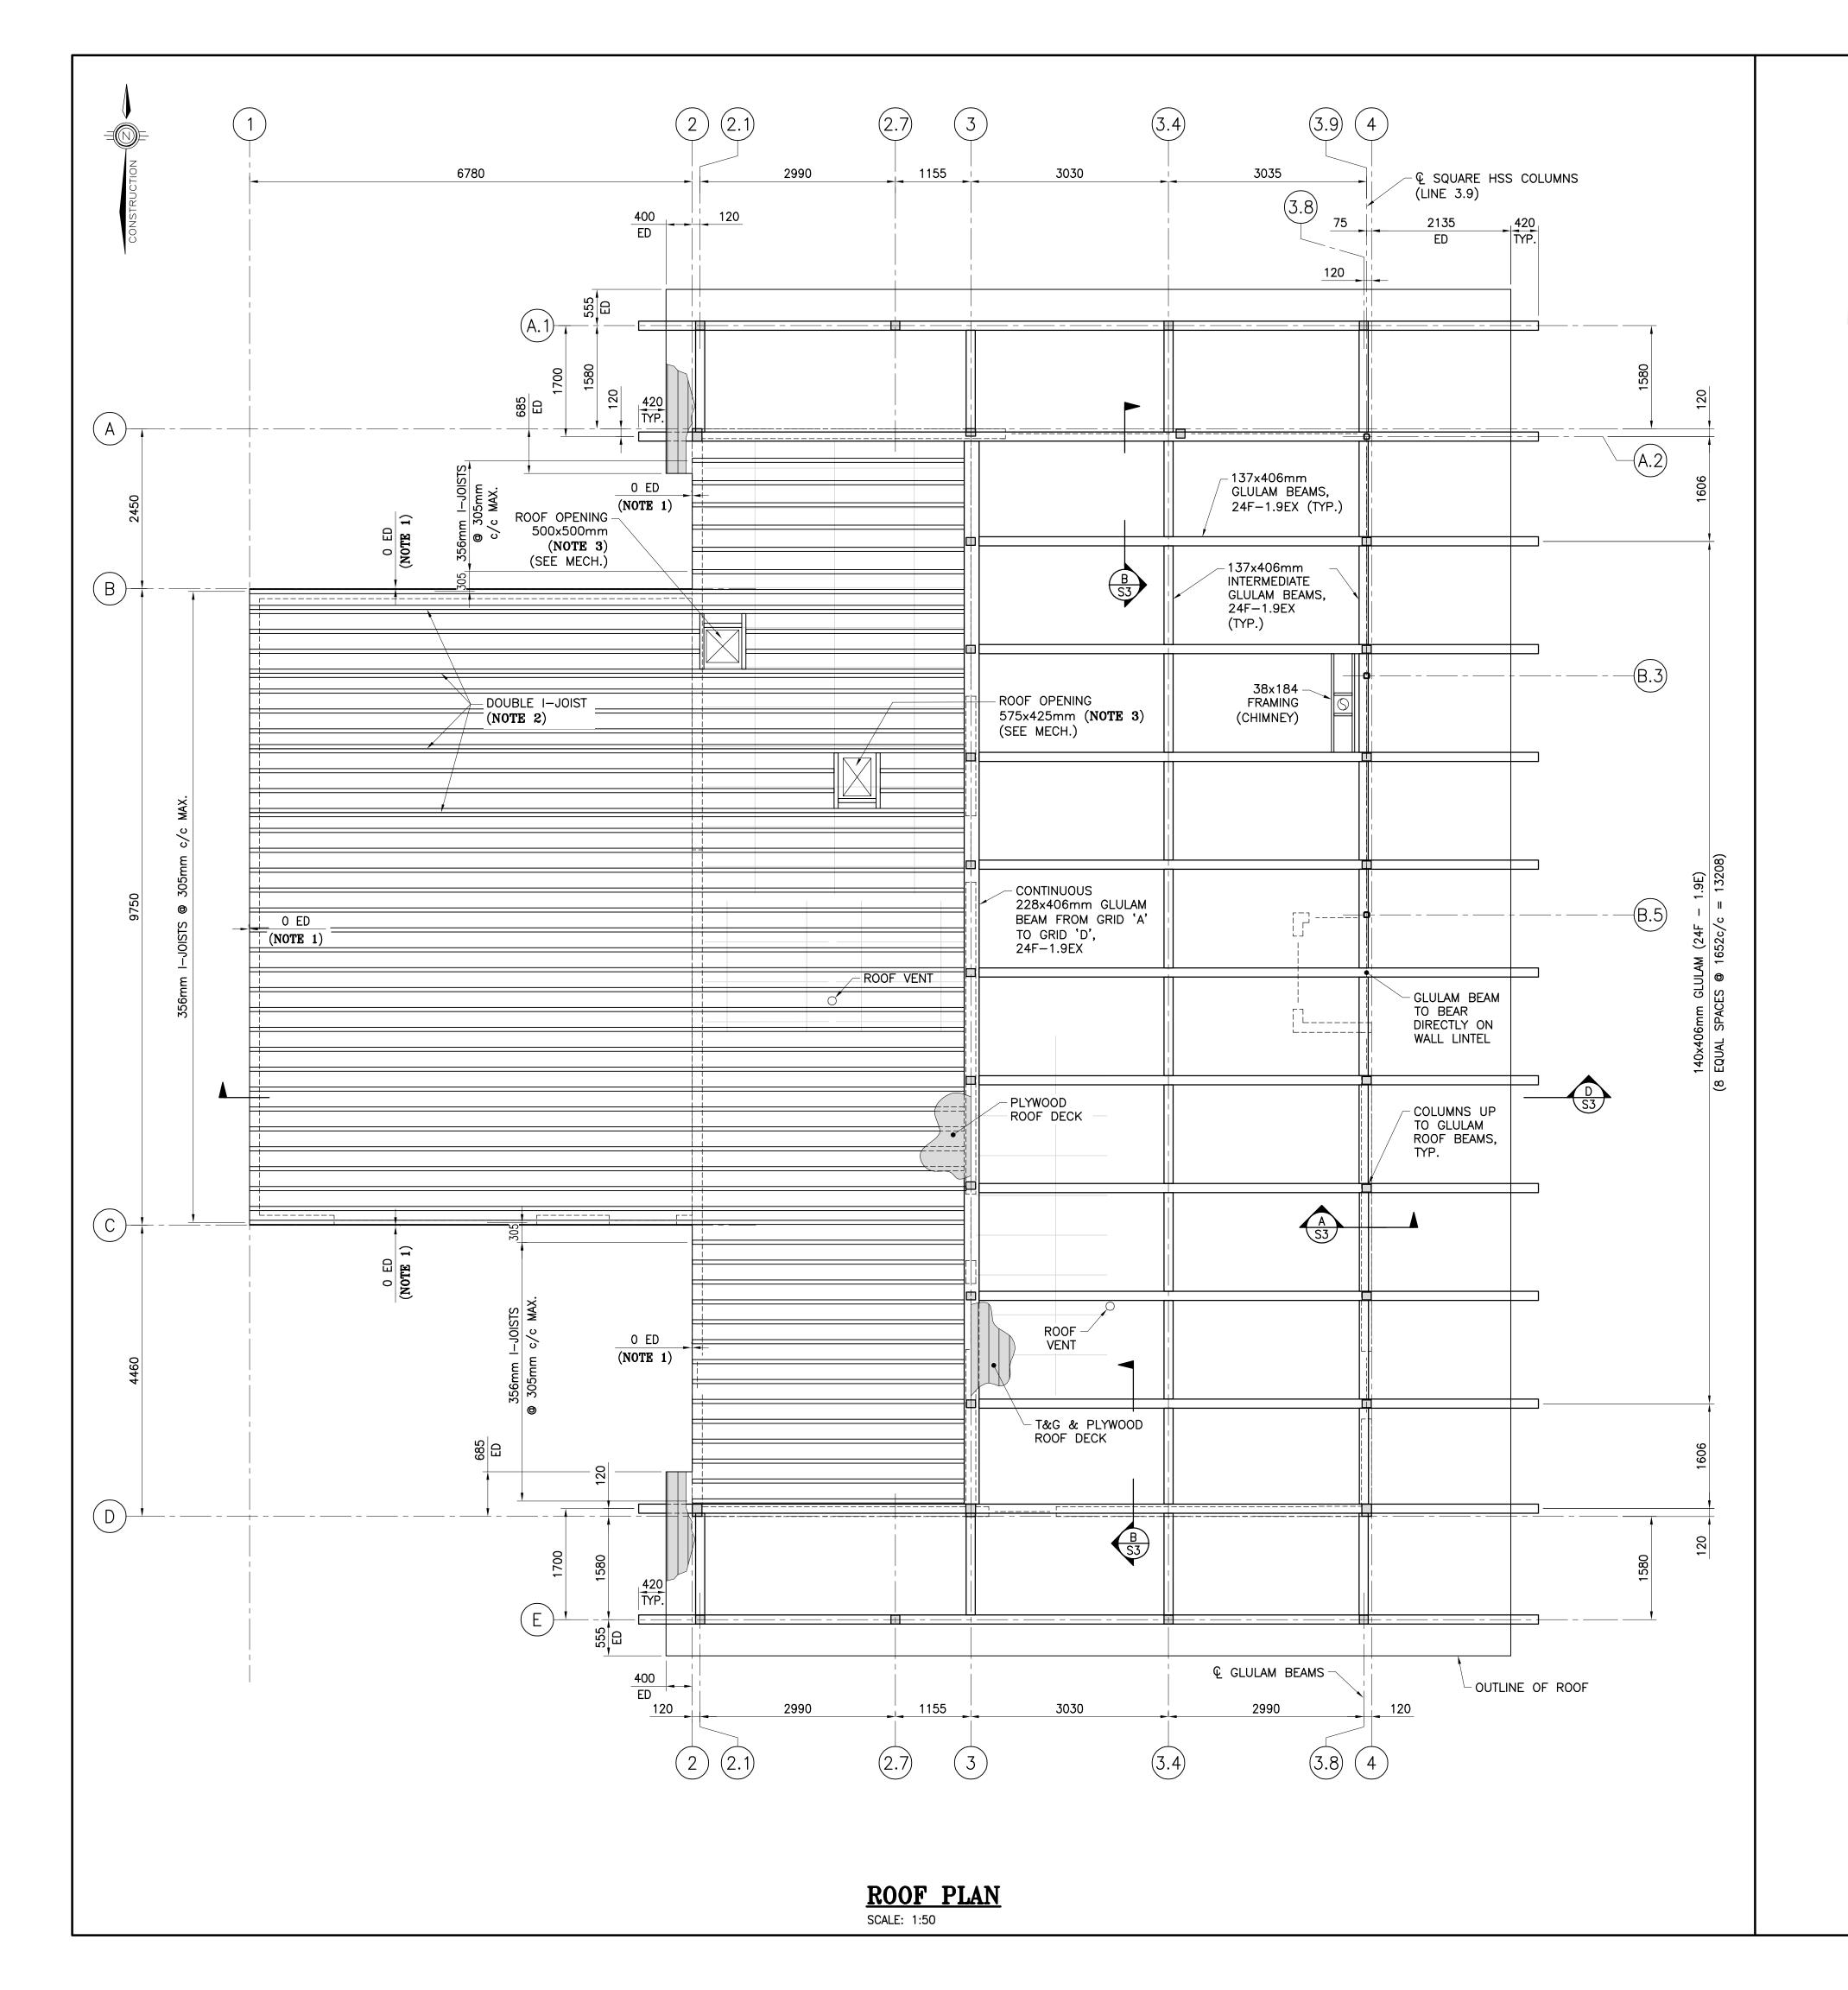

#### ROOF JOISTS DESIGN LOADS

(AS PER PART 4 OF THE NBC OF CANADA 2015, BUT WITH FOLLOWING UNFACTORED LOADS)

1.6kPa (NOT INCLUDING JOISTS) DL ROOF:

TOP CHORD = 1.1kPa, BOTTOM CHORD = 0.5kPa ALL JOISTS SHALL BE DESIGNED FOR AN ADDITIONAL POINT LOAD OF 0.71kN

ANYWHERE ON THEIR BOTTOM AND TOP CHORD (NON SIMULTANEOUSLY).

3.48kPa, UNO. (Ss = 3.6kPa, Sr = 0.6kPa, Cb = 0.8, Is=1.0)

L/360 <u>ΔSL:</u>

EVOQ

1435, RUE SAINT-ALEXANDRE, BUREAU 1000

MONTRÉAL (QUÉBEC) H3A 2G4 T. 514-393-9490 F. 514-393-9498 info@evoqarchitecture.com

13, rue Costigan Street Edmundston (NB) E3V 1W7

REF: 493-18-4B

LANDSCAPE ARCHITECTS:



Red Island Contractors Inc.

305, Route 390, Tobique First Nation, NB, E7H 4P7

#### SPECIFIC NOTES

- 1. ZERO EDGE OF DECK IS FOR THE PLYWOOD ATTACHED TO THE TOPS OF I-JOISTS. REFER TO ARCHITECTURAL FOR EDGE OF DECK ABOVE THE ROOF INSULATION.
- 2. DOUBLE I-JOIST AS PER TYP. CONSTRUCTION OF DOUBLE I-JOIST DETAIL ON DRAWING S4 AND AS PER JOIST MANUFACTURER. THESE DOUBLE I-JOISTS MAY BE REPLACED BY A GLULAM TRIMMER.
- 3. HEADERS AND CONNECTORS AS PER JOIST MANUFACTURER.

0	ISSUED TENDER	R.V.	2022-05-30
Α	ISSUED FOR 50% REVIEW	R.C.	2021-06-18
Nº:	DESCRIPTION:	BY	DATE

#### REVISION:

#### GENERAL NOTES:

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KCIW KNICANEWEK SPORTS AND RECREATION PARK -PHASE 2 BUILDINGS TOBIQUE FIRST NATION, NB

PROJECT Nº:


PARK CENTER BUILDING -STRUCTURAL-**ROOF PLAN & SECTIONS** 

DESIGN: M. BOUDREAU APPROVED: DRAWN: R. COUTURE DATE: JUNE 2021

SCALE: AS SHOWN VERIFIED: M. BOUDREAU

9223-18-00

S2B

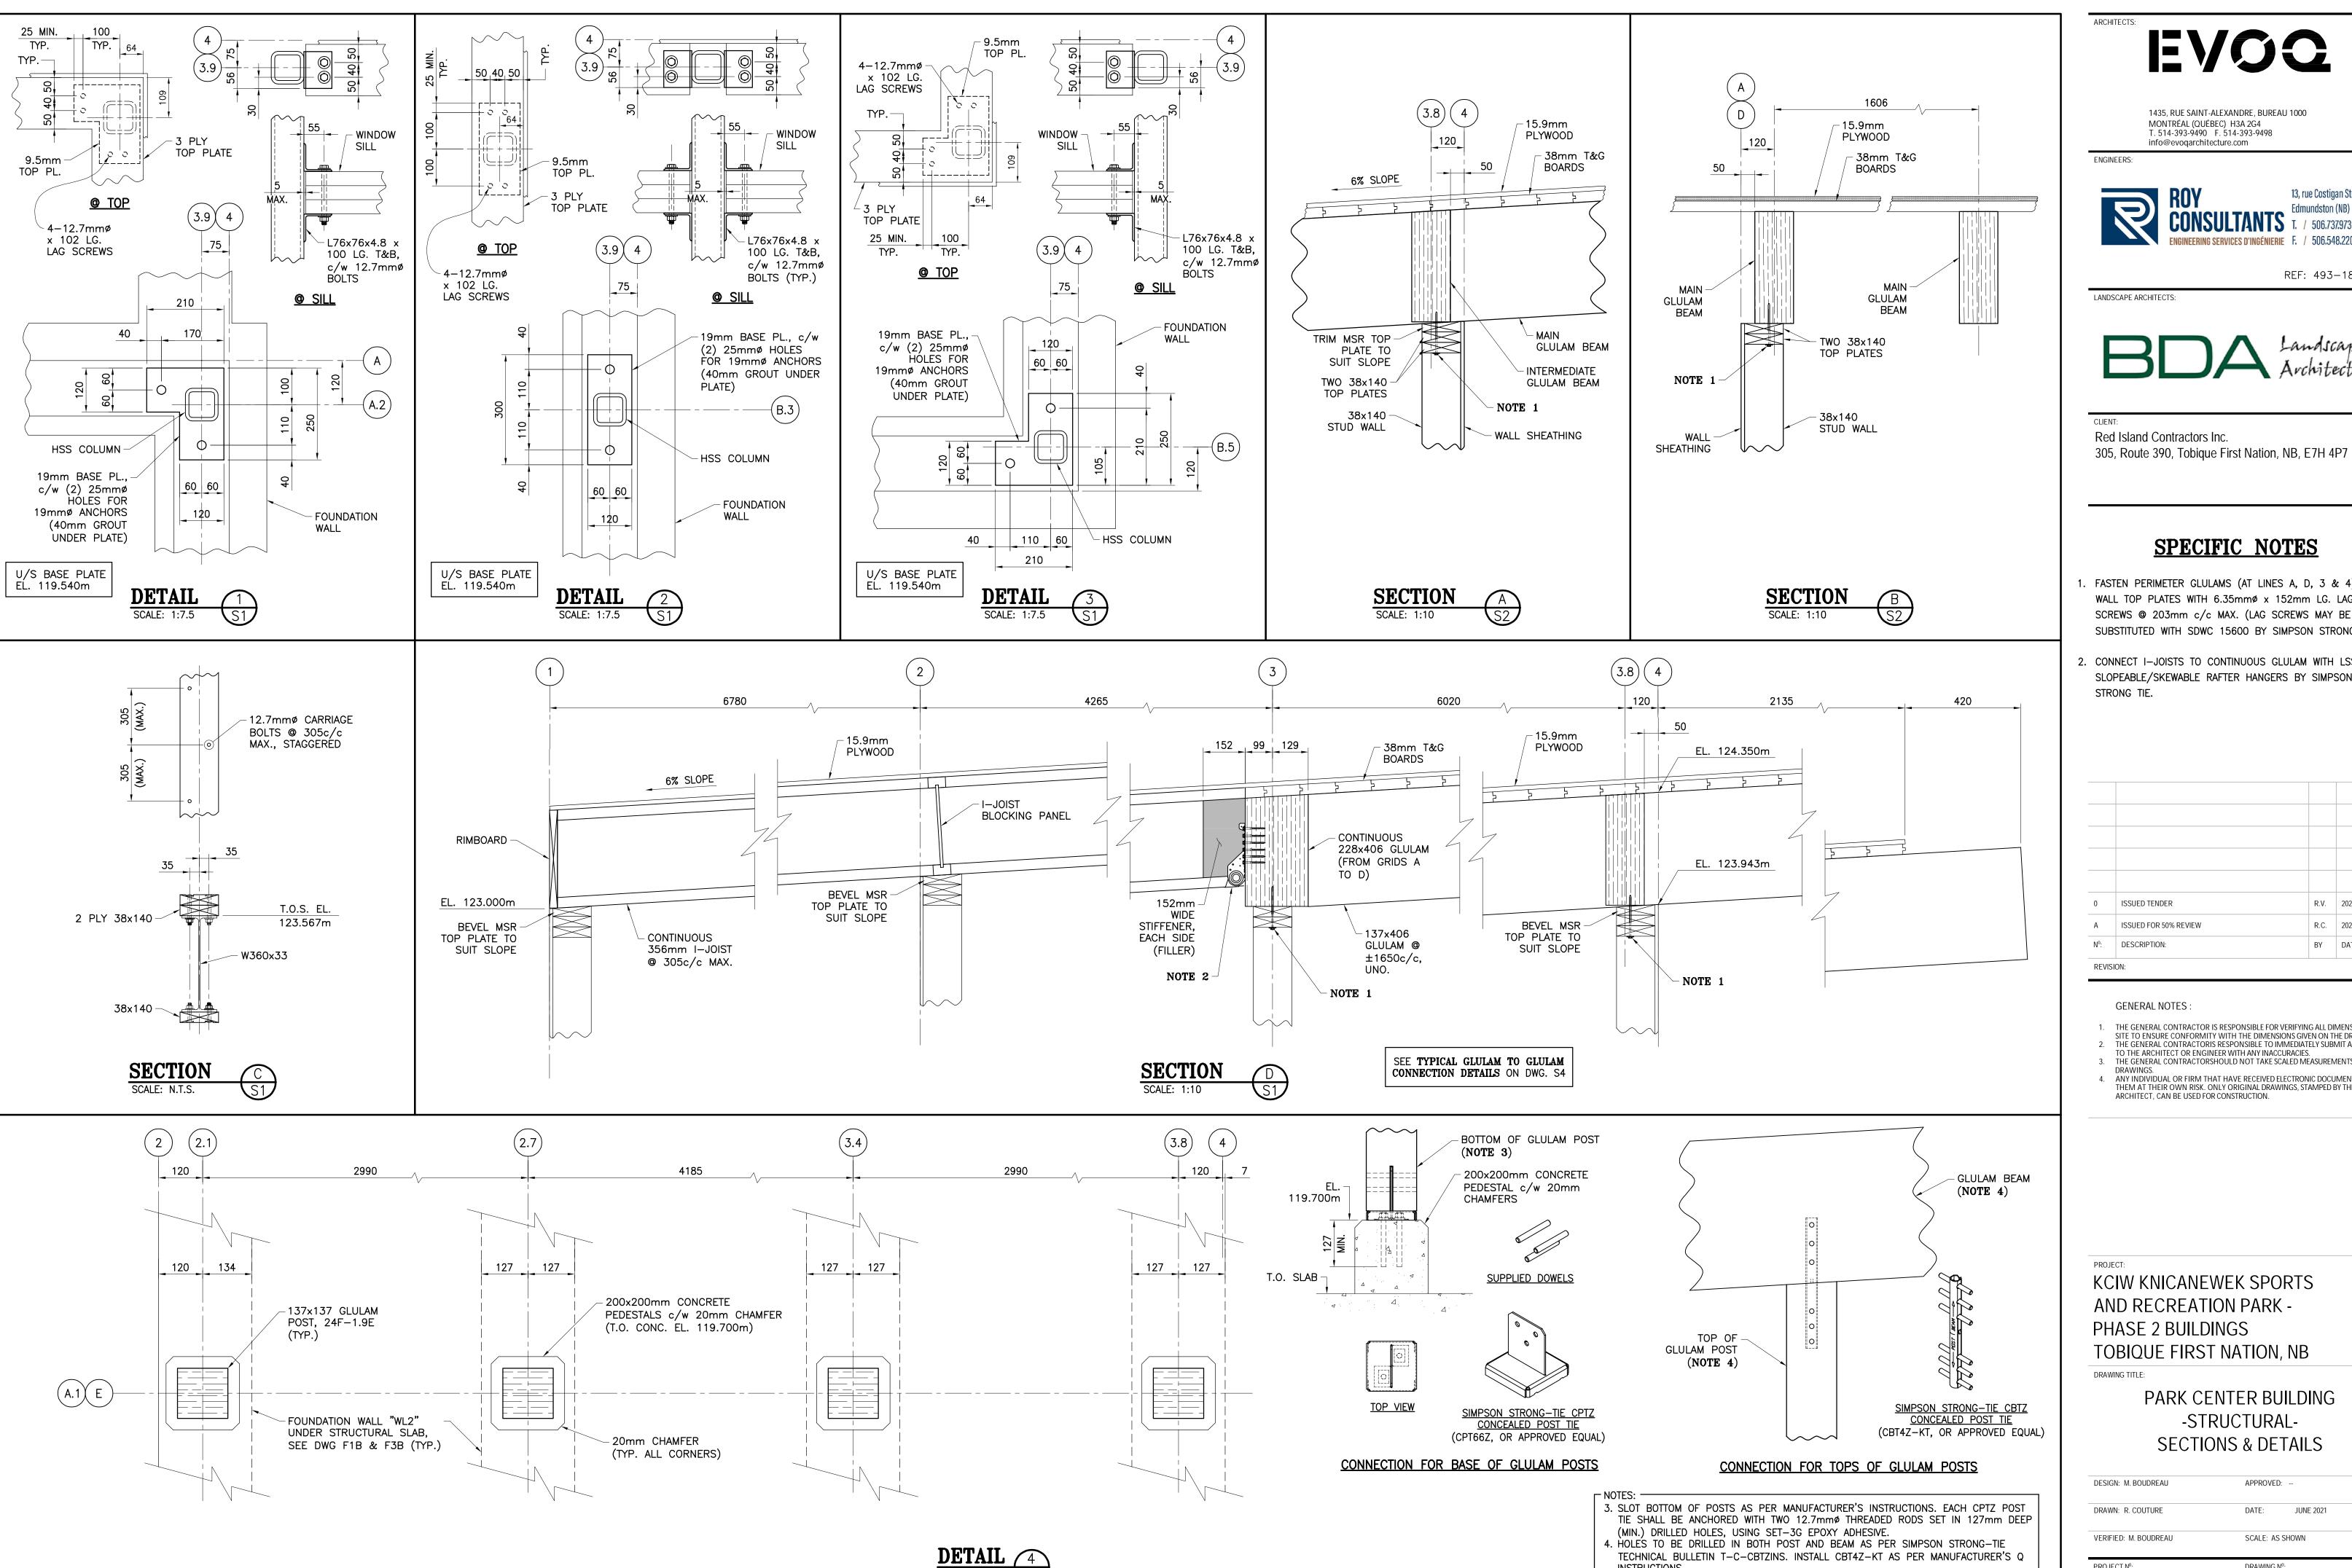

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13, rue Costigan Street 506.737.9730

REF: 493-18-4B


LANDSCAPE ARCHITECTS:



Red Island Contractors Inc.

#### SPECIFIC NOTES

- 1. FASTEN PERIMETER GLULAMS (AT LINES A, D, 3 & 4) TO WALL TOP PLATES WITH 6.35mmø x 152mm LG. LAG SCREWS @ 203mm c/c MAX. (LAG SCREWS MAY BE SUBSTITUTED WITH SDWC 15600 BY SIMPSON STRONG TIE).
- 2. CONNECT I-JOISTS TO CONTINUOUS GLULAM WITH LSSR2.56Z SLOPEABLE/SKEWABLE RAFTER HANGERS BY SIMPSON STRONG TIE.

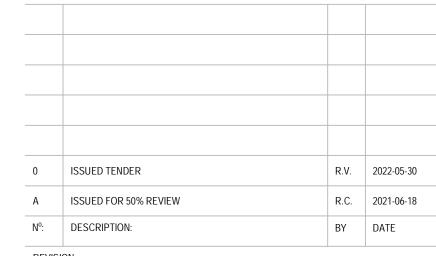

#### **GENERAL NOTES:**

- 1. THE GENERAL CONTRACTOR IS RESPONSIBLE FOR VERIFYING ALL DIMENSIONS ON SITE TO ENSURE CONFORMITY WITH THE DIMENSIONS GIVEN ON THE DRAWINGS
- 2. THE GENERAL CONTRACTORIS RESPONSIBLE TO IMMEDIATELY SUBMIT A REPORT TO THE ARCHITECT OR ENGINEER WITH ANY INACCURACIES.
- 3. THE GENERAL CONTRACTORSHOULD NOT TAKE SCALED MEASUREMENTS OFF TH
- 4. ANY INDIVIDUAL OR FIRM THAT HAVE RECEIVED ELECTRONIC DOCUMENT USE THEM AT THEIR OWN RISK. ONLY ORIGINAL DRAWINGS, STAMPED BY THE ARCHITECT, CAN BE USED FOR CONSTRUCTION.

KCIW KNICANEWEK SPORTS AND RECREATION PARK -PHASE 2 BUILDINGS TOBIQUE FIRST NATION, NB

DRAWING TITLE:

TECHNICAL BULLETIN T-C-CBTZINS. INSTALL CBT4Z-KT AS PER MANUFACTURER'S Q


INSTRUCTIONS.


PARK CENTER BUILDING -STRUCTURAL-**SECTIONS & DETAILS** 

DESI	GN: M. BOUDREAU	APPROVED: -	-
DRAV	VN: R. COUTURE	DATE:	JUNE 2021
VERI	FIED: M. BOUDREAU	SCALE: AS SH	OWN

PROJECT Nº: DRAWING N°: 9223-18-00

S3B

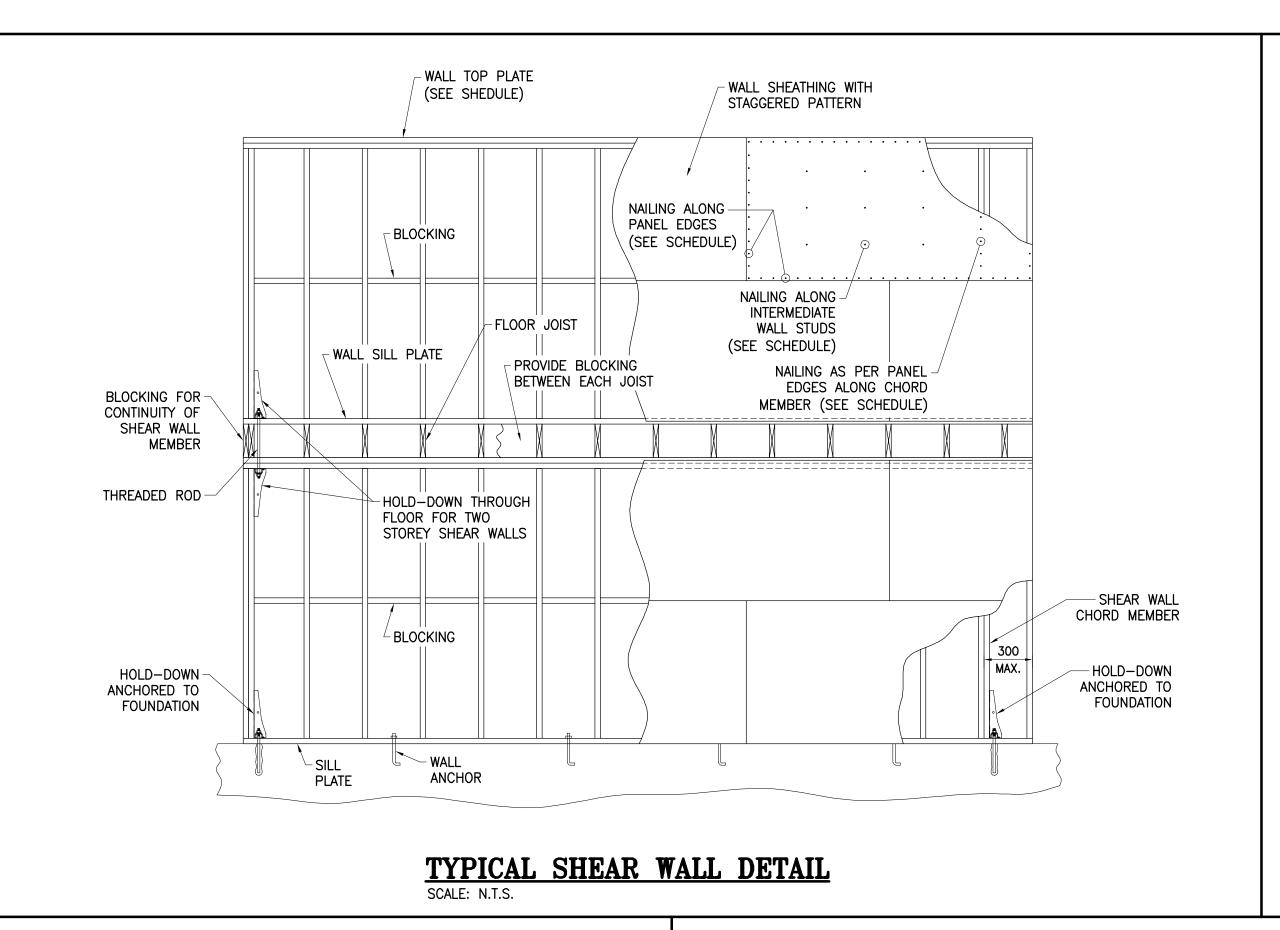


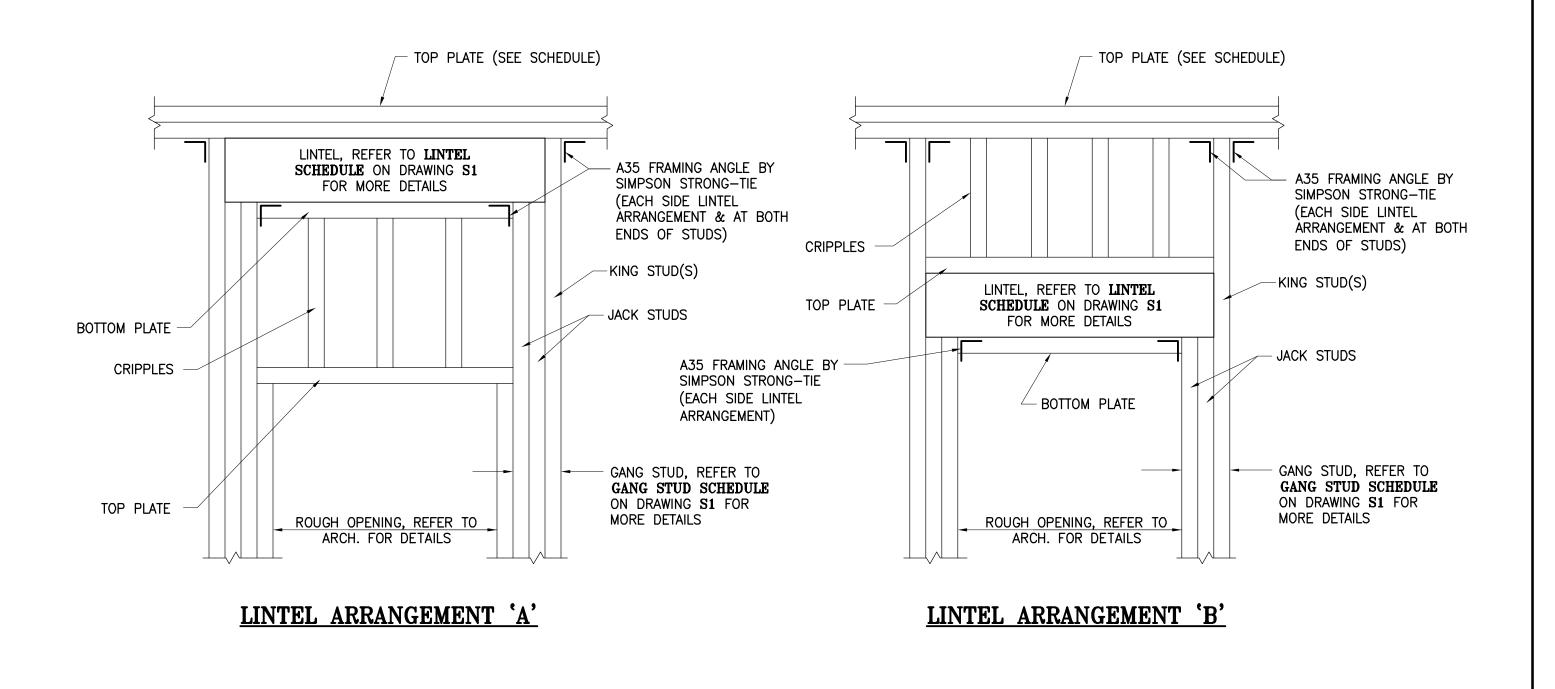

WITH THE EXCEPTION OF DOORS, OPENING SILL SHALL BE FRAMED WITH (2) 38x140 SPF#2 UNO, c/w A35 FRAMING ANGLES AT ENDS.
 WINDOWS ON LINES A & 4 REQUIRE (3) 38x140

SPF#2, c/w A35 FRAMING ANGLES AT ENDS.

## LINTEL ARRANGEMENTS

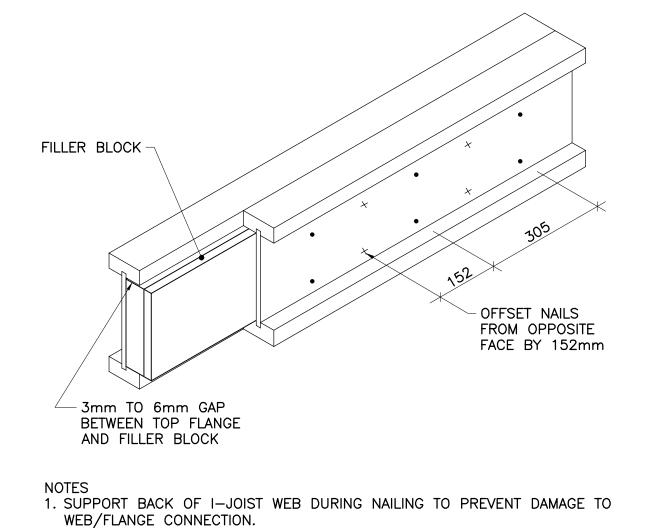



- 2. LEAVE A 3mm TO 6mm GAP BETWEEN TOP OF FILLER BLOCK AND BOTTOM OF TOP I—JOIST FLANGE.
- FILLER BLOCK IS REQUIRED BETWEEN JOISTS FOR FULL LENGTH OF SPAN.
   NAIL JOISTS TOGETHER WITH TWO ROWS OF 76mm NAILS AT 305mm O.C. (CLINCHED WHEN POSSIBLE) ON EACH SIDE OF THE DOUBLE I—JOIST
- (TOTAL OF FOUR NAILS PER 305mm).

  5. THE MAXIMUM FACTORED LOAD THAT MAY BE APPLIED TO ONE SIDE OF THE DOUBLE I—JOIST USING THIS DETAIL IS 12.6Kn/m (860 LBF/FT.).

#### TYP. CONSTRUCTION OF DOUBLE I-JOIST

SCALE: N.T.S.

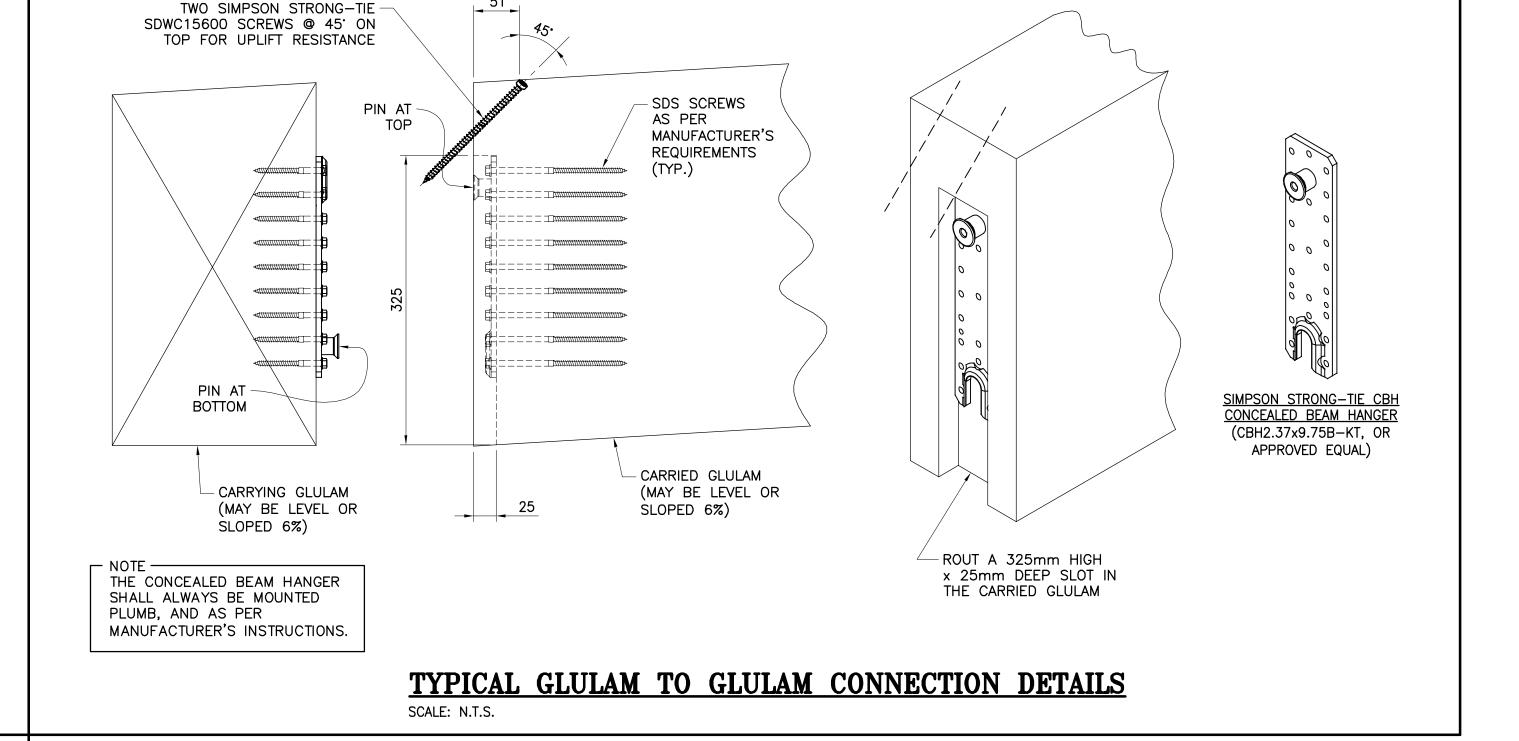

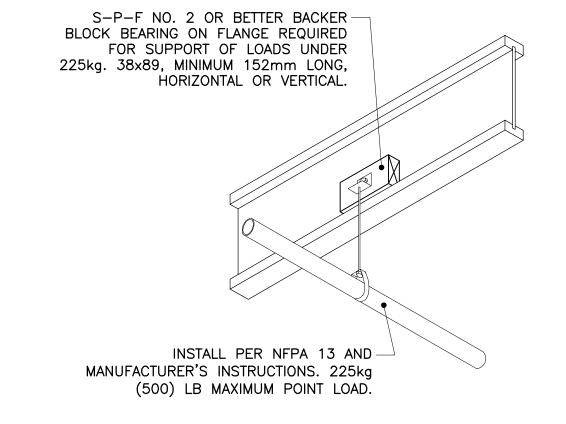

HANGING ELEC./MECH. LOADS TO I-JOISTS

SCALE: N.T.S.

1/35 PLIE SAINT-ALEYANDRE BUREAU 1000

1435, RUE SAINT-ALEXANDRE, BUREAU 1000 MONTRÉAL (QUÉBEC) H3A 2G4 T. 514-393-9490 F. 514-393-9498 info@evogarchitecture.com



13, rue Costigan Street
Edmundston (NB) E3V 1W7
T. / 506.737.9730
VGÉNIERIE F. / 506.548.2207

REF: 493-18-4B

LANDSCAPE ARCHITECTS:



Red Island Contractors Inc.

305, Route 390, Tobique First Nation, NB, E7H 4P7

0	ISSUED TENDER	R.V.	2022-05-30
Nº:	DESCRIPTION:	ВУ	DATE

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- DRAWINGS.

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KCIW KNICANEWEK SPORTS AND RECREATION PARK -PHASE 2 BUILDINGS TOBIQUE FIRST NATION, NB

DRAWING TITLE:

PARK CENTER BUILDING
-STRUCTURALDETAILS

DETAILS

DESIGN: M. BOUDREAU APPROVED: --

DRAWN: R. VALDRON


DATE: JULY 2021


VERIFIED: M. BOUDREAU

SCALE: AS SHOWN

PROJECT N°: DRAWING N°:

9223-18-00 S4B

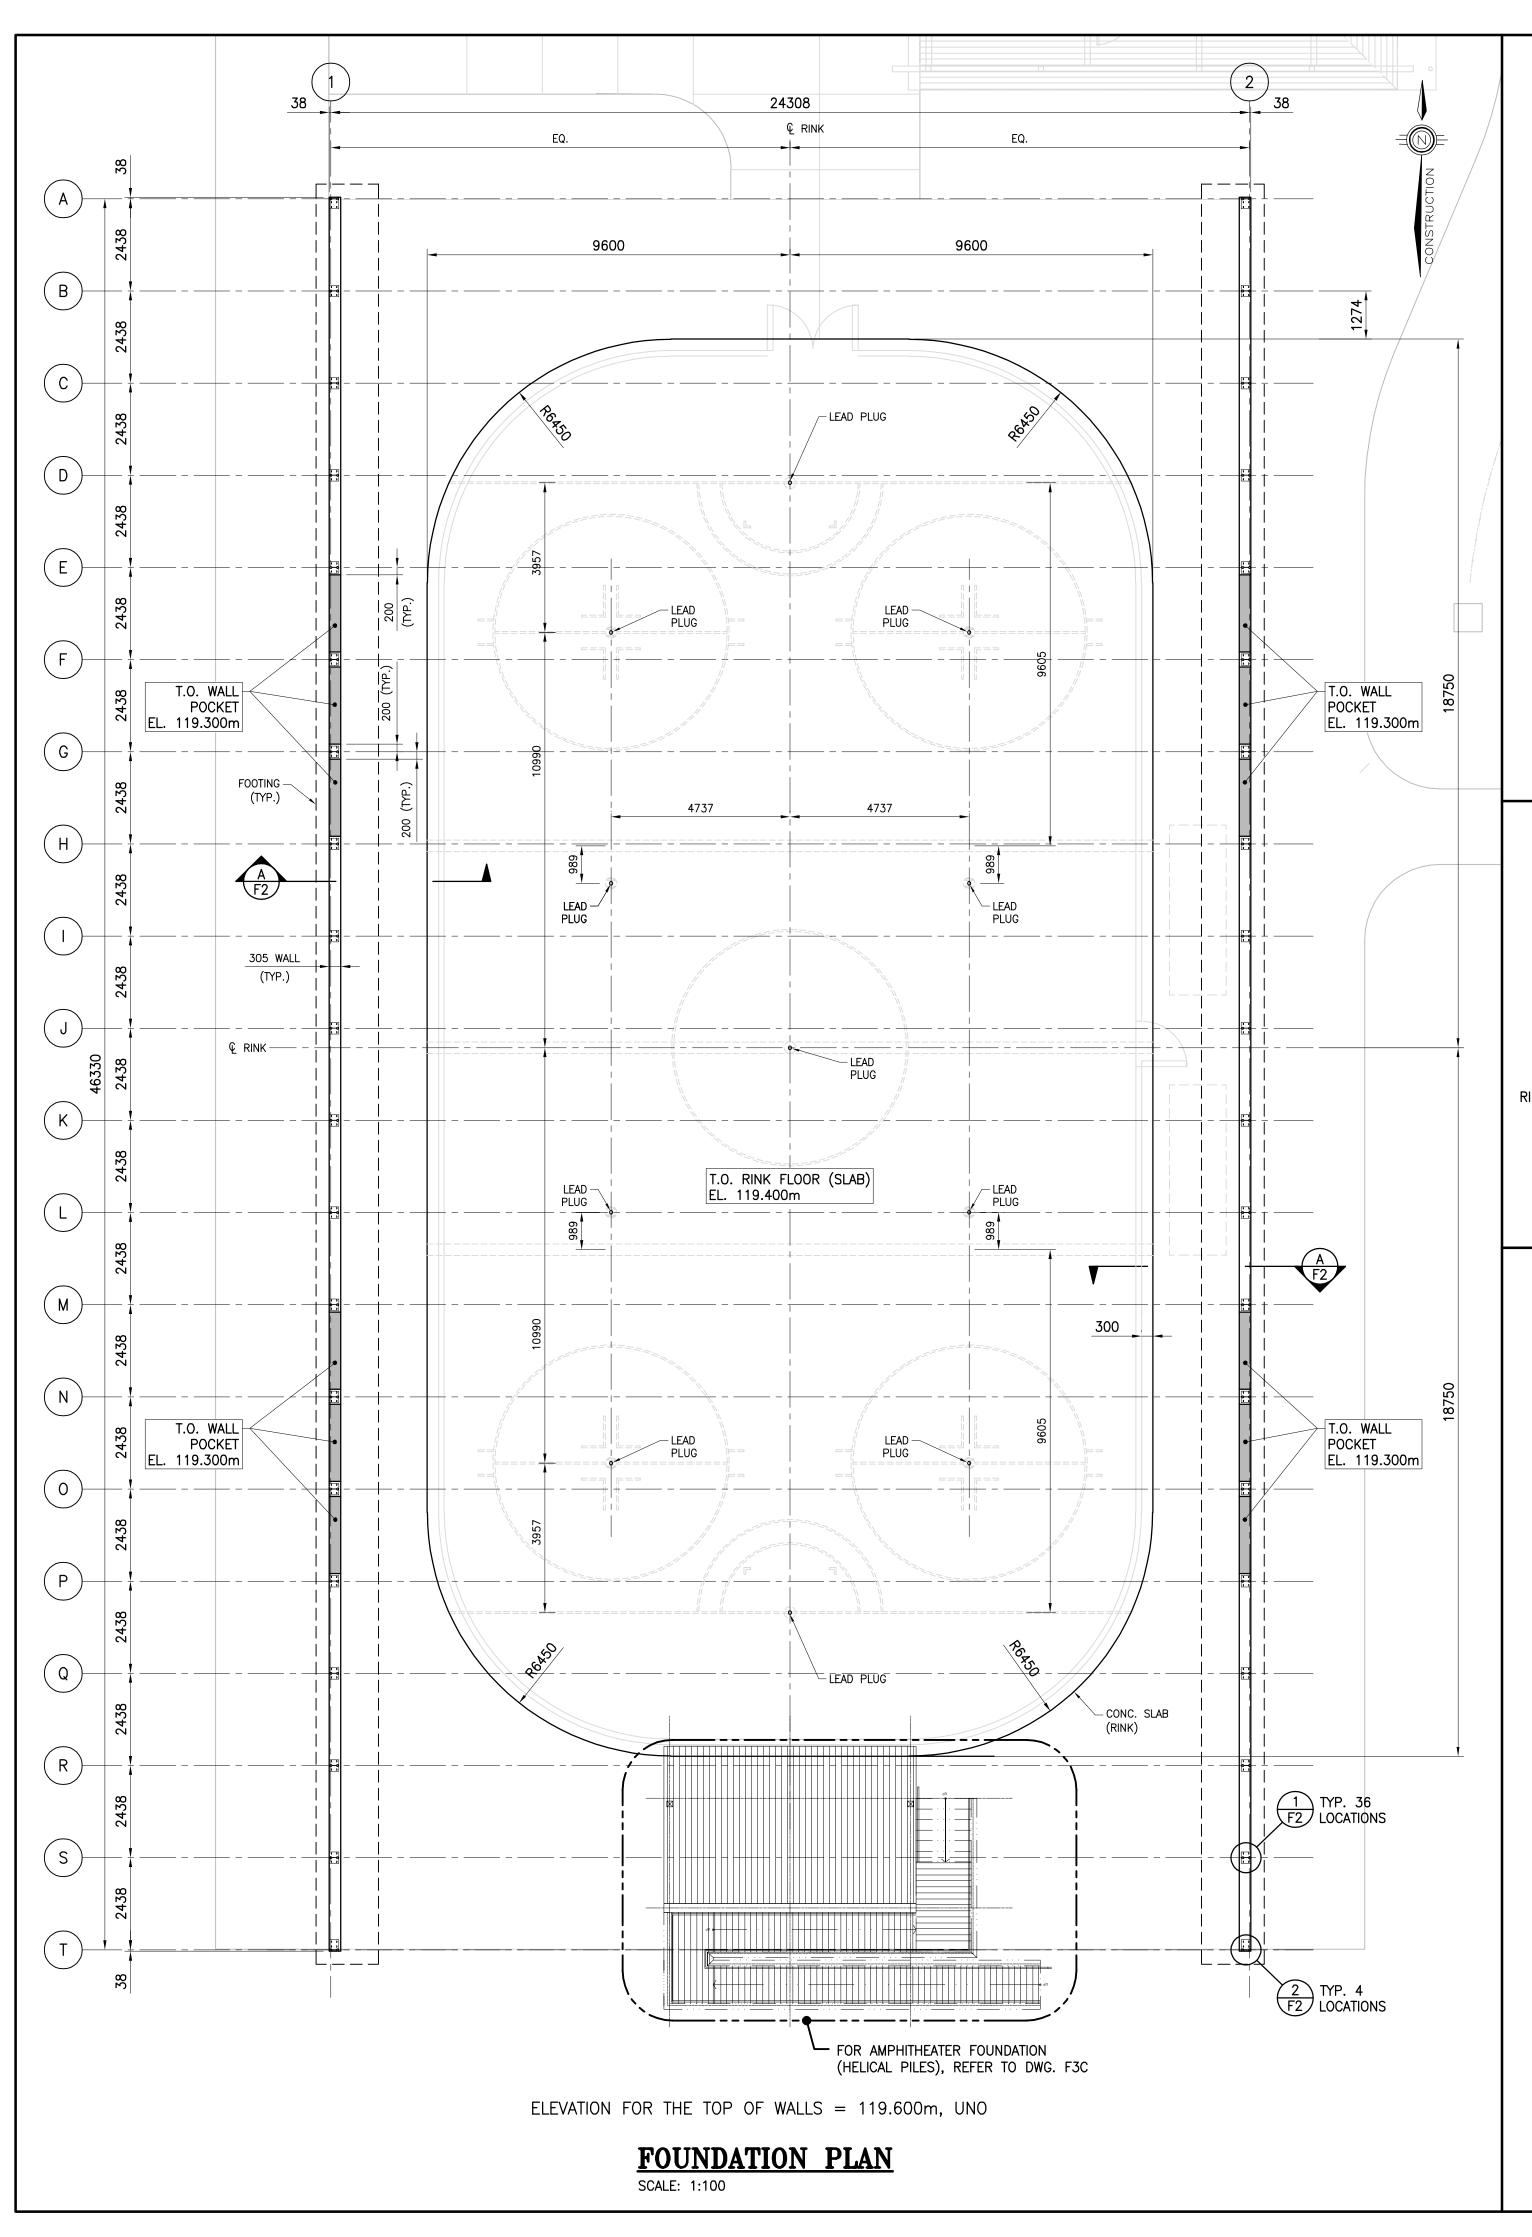

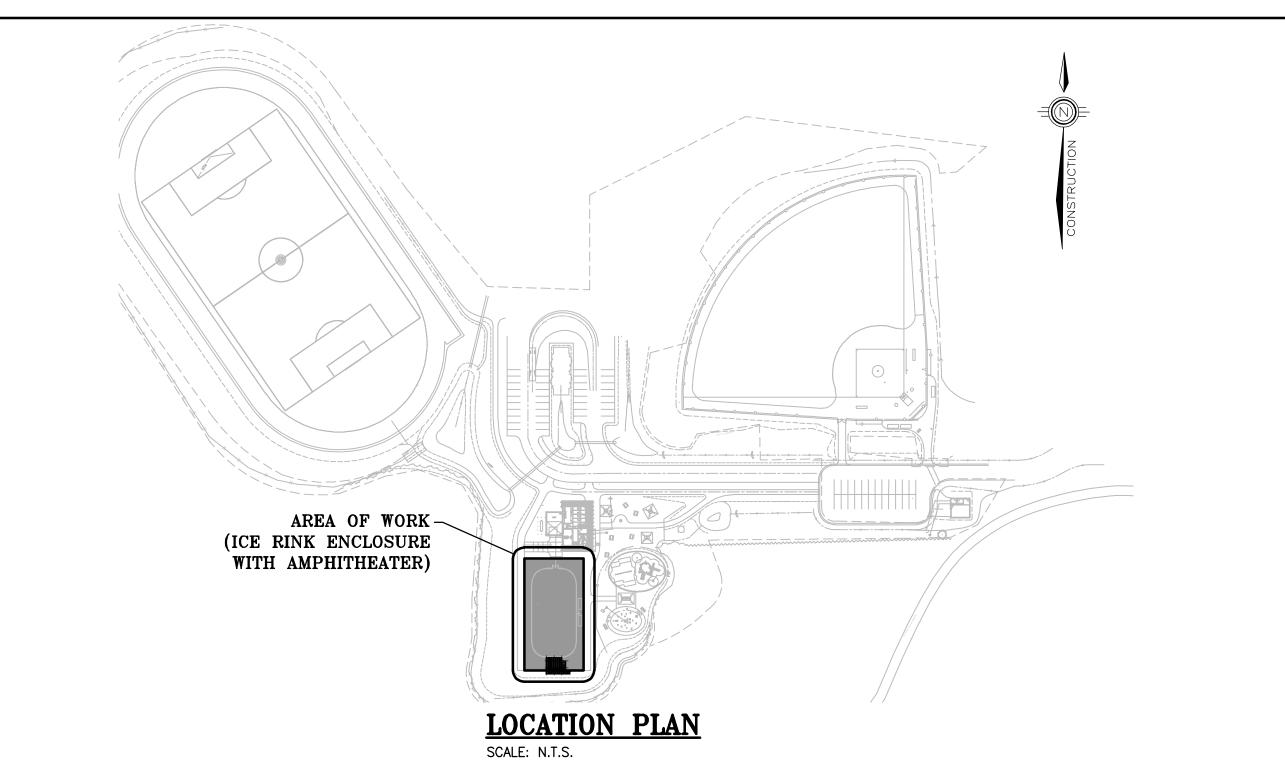

## SAWCUTS TO -MARK CENTRE TOP VIEW RINK SLAB — SECTION VIEW - POURED LEAD TYP. LED PLUG

#### **GENERAL NOTES**

- CONTRACTOR IS RESPONSIBLE FOR ALL CUTTING AND PATCHING, AND THE REMOVAL OF ALL EXISTING MATERIALS AND INSTALLATIONS NECESSARY FOR THE EXECUTION OF THE WORK DESCRIBED BELOW OR SHOWN ON THESE STRUCTURAL DRAWINGS. ALL REMOVED MATERIALS ARE TO BE DISPOSED OF IN ACCORDANCE WITH AUTHORITY HAVING JURISDICTION, UNLESS INDICATED OTHERWISE BY OWNER AND/OR TENANT.
- CONTRACTOR SHALL VERIFY ALL DIMENSIONS, LOCATIONS, ELEVATIONS AND/OR CONSTRUCTION DETAILS. REPORT ANY DISCREPANCIES TO THE CONSULTANT. DO NOT SCALE ON THESE STRUCTURAL DRAWINGS.
- ALL WORK SHALL BE PERFORMED AND COMPLETED TO THE STANDARDS OF MATERIALS AND WORKMANSHIP AS PER THE NATIONAL BUILDING CODE OF CANADA (NBC), 2015, INCLUDING ALL CORRECTIONS AND REVISIONS TO DATE. ALL WORK AND INSTALLATIONS SHALL ALSO COMPLY TO APPLICABLE MUNICIPAL AND PROVINCIAL REGULATIONS. IN THE ABSENCE OF SPECIFIC REQUIREMENTS IN THE ABOVE, WORK SHALL CONFORM TO SOUND BUILDING PRACTICE AND QUALITY WORKMANSHIP.
- THESE STRUCTURAL DRAWINGS ARE TO BE READ IN CONJUNCTION WITH STRUCTURAL SPECIFICATIONS.
- REFER TO ARCHITECTURAL DRAWINGS FOR WALL OPENING DIMENSIONS AND LOCATIONS.
- SEE MECH. FOR LOCATION OF REQUIRED SLEEVES THROUGH FOUNDATION WALL. OPENING SHALL BE 150mmø OR LESS (UNLESS APPROVED BY CONSULTANT) AND SHOULD NOT INTERRUPT REINFORCEMENT BARS.
- TYPICAL STEEL REINFORCEMENT COVER TO BE 40mm
- FOR ICE RINK & AMPHITHEATER, REFERENCE ELEVATIONS ARE AS PER CIVIL AND LANDSCAPE ARCH. (BDA). THEY DIFFER FROM BUILDING ARCH. (EVOQ) ELEVATIONS.

EVOQ

1435, RUE SAINT-ALEXANDRE, BUREAU 1000 MONTRÉAL (QUÉBEC) H3A 2G4 T. 514-393-9490 F. 514-393-9498 info@evoqarchitecture.com



REF: 493-18-4C

LANDSCAPE ARCHITECTS:



Red Island Contractors Inc.

305, Route 390, Tobique First Nation, NB, E7H 4P7

0 ISSUED TENDER R.V. 2022-05-30 N°: DESCRIPTION: BY DATE REVISION:

#### GENERAL NOTES:

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KCIW KNICANEWEK SPORTS AND RECREATION PARK -PHASE 2 BUILDINGS TOBIQUE FIRST NATION, NB


ICE RINK ENCLOSURE BLDG. WITH **AMPHITHEATER** -FOUNDATION-

PLAN VIEW & DETAIL DESIGN: M. BOUDREAU APPROVED:

DRAWN: R. COUTURE DATE: JUNE 2021 VERIFIED: M. BOUDREAU SCALE: AS SHOWN

F1C


PROJECT Nº: DRAWING N°: 9223-18-00

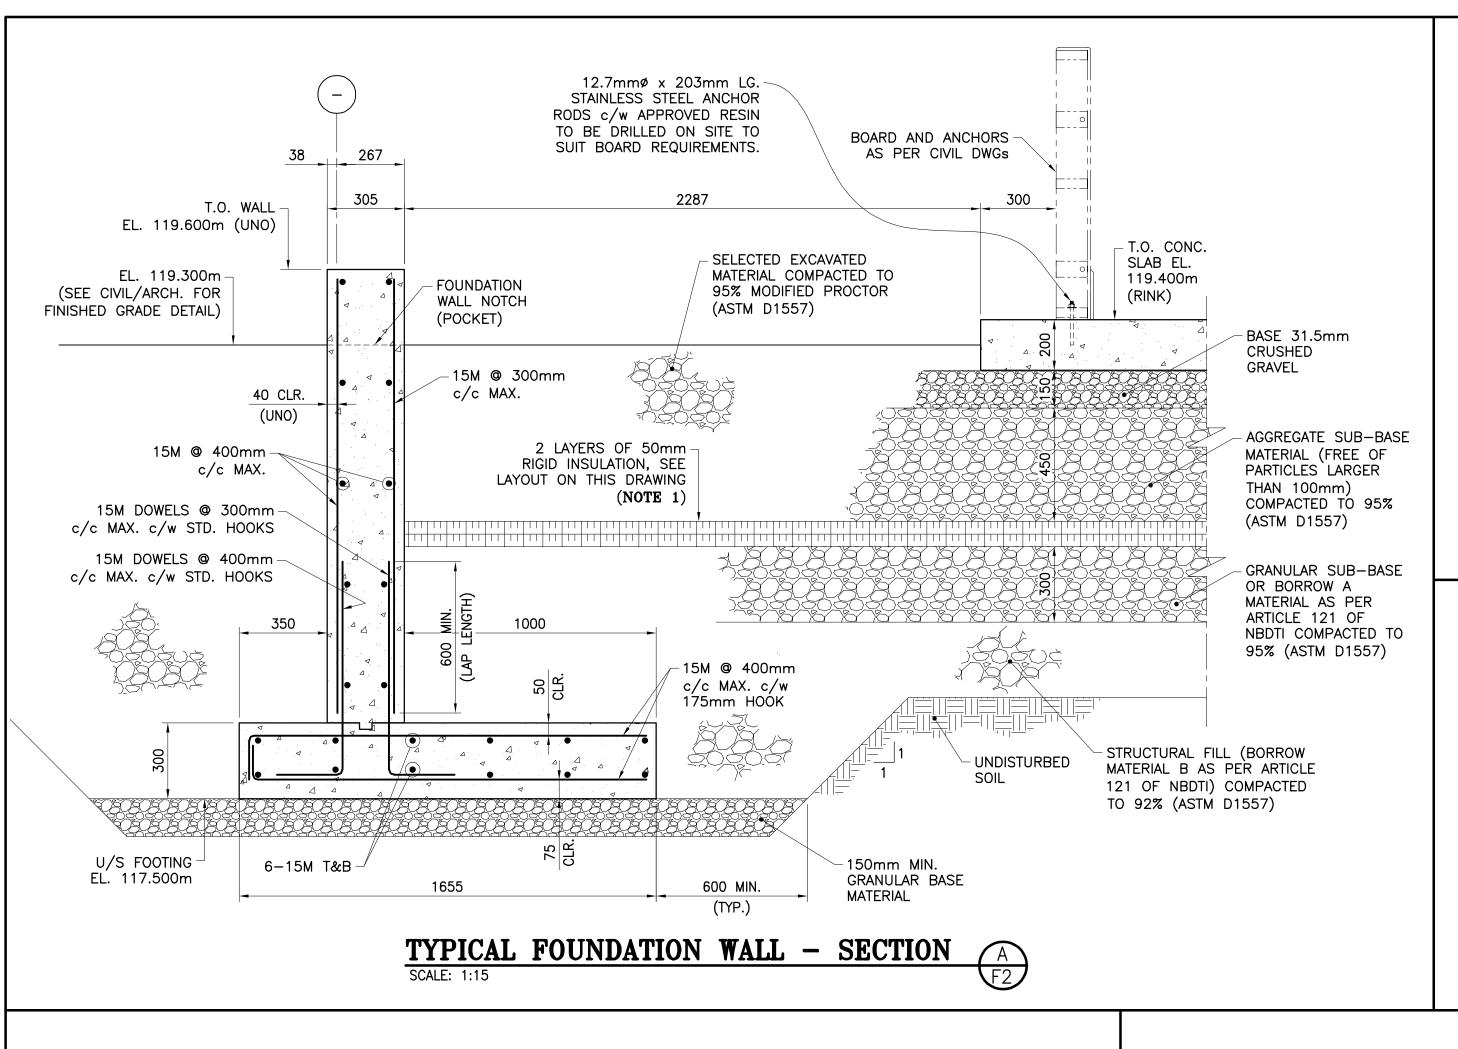


EXTRUDED HIGH-DENSITY POLYSTYRENE INSULATION


R5 PER INCH


THERMAL RESISTANCE

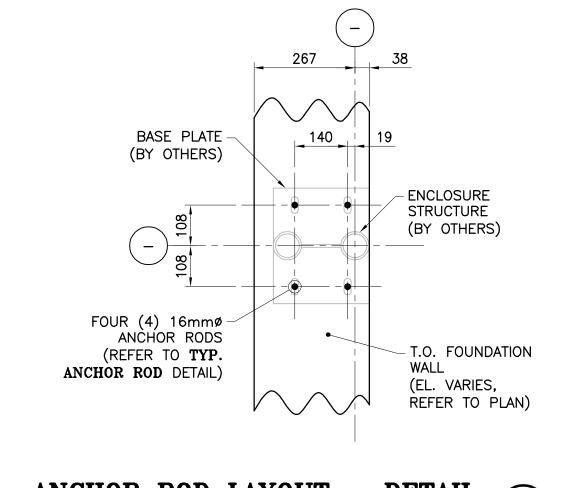

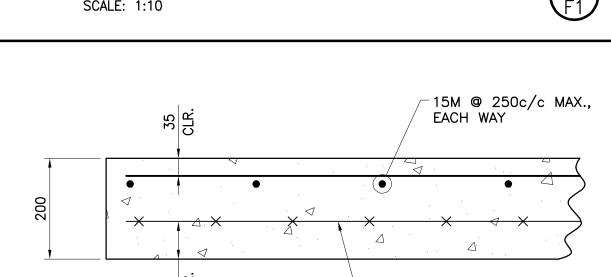



RINK FLOOR REINFORCING DETAIL

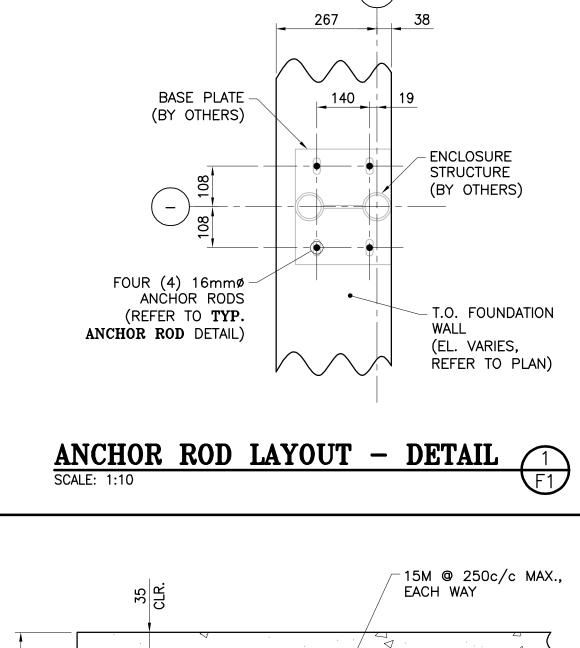

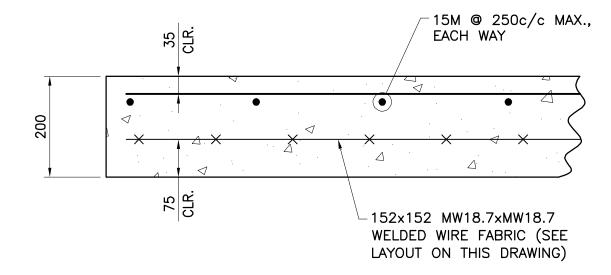

SCALE: N.T.S.

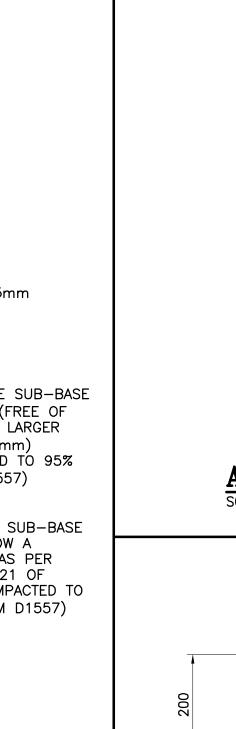

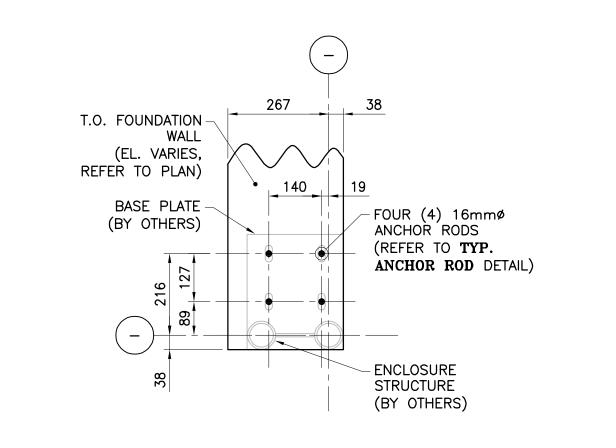

ANCHOR ROD LAYOUT - DETAIL 2

# EVOQ

1435, RUE SAINT-ALEXANDRE, BUREAU 1000 MONTRÉAL (QUÉBEC) H3A 2G4 T. 514-393-9490 F. 514-393-9498 info@evoqarchitecture.com



REF: 493-18-4C


LANDSCAPE ARCHITECTS:



Red Island Contractors Inc. 305, Route 390, Tobique First Nation, NB, E7H 4P7

#### SPECIFIC NOTE

1. AT NORTH AND SOUTH END OF THE ENCLOSURE, EXTEND THE INSULATION 2400mm FURTHER THAN THE CONCRETE ICE SLAB AND ELSEWHERE. STOP THE INSULATION AT THE FOUNDATION WALL.

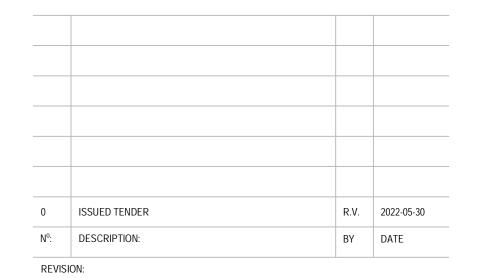

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KCIW KNICANEWEK SPORTS AND RECREATION PARK -PHASE 2 BUILDINGS

TOBIQUE FIRST NATION, NB

ICE RINK ENCLOSURE BLDG. WITH AMPHITHEATER -FOUNDATION-


**SECTIONS & DETAILS** 


DESIGN: M. BOUDREAU DRAWN: R. COUTURE

DATE: JUNE 2021 VERIFIED: M. BOUDREAU SCALE: AS SHOWN

PROJECT Nº: DRAWING N°:


9223-18-00 F2C

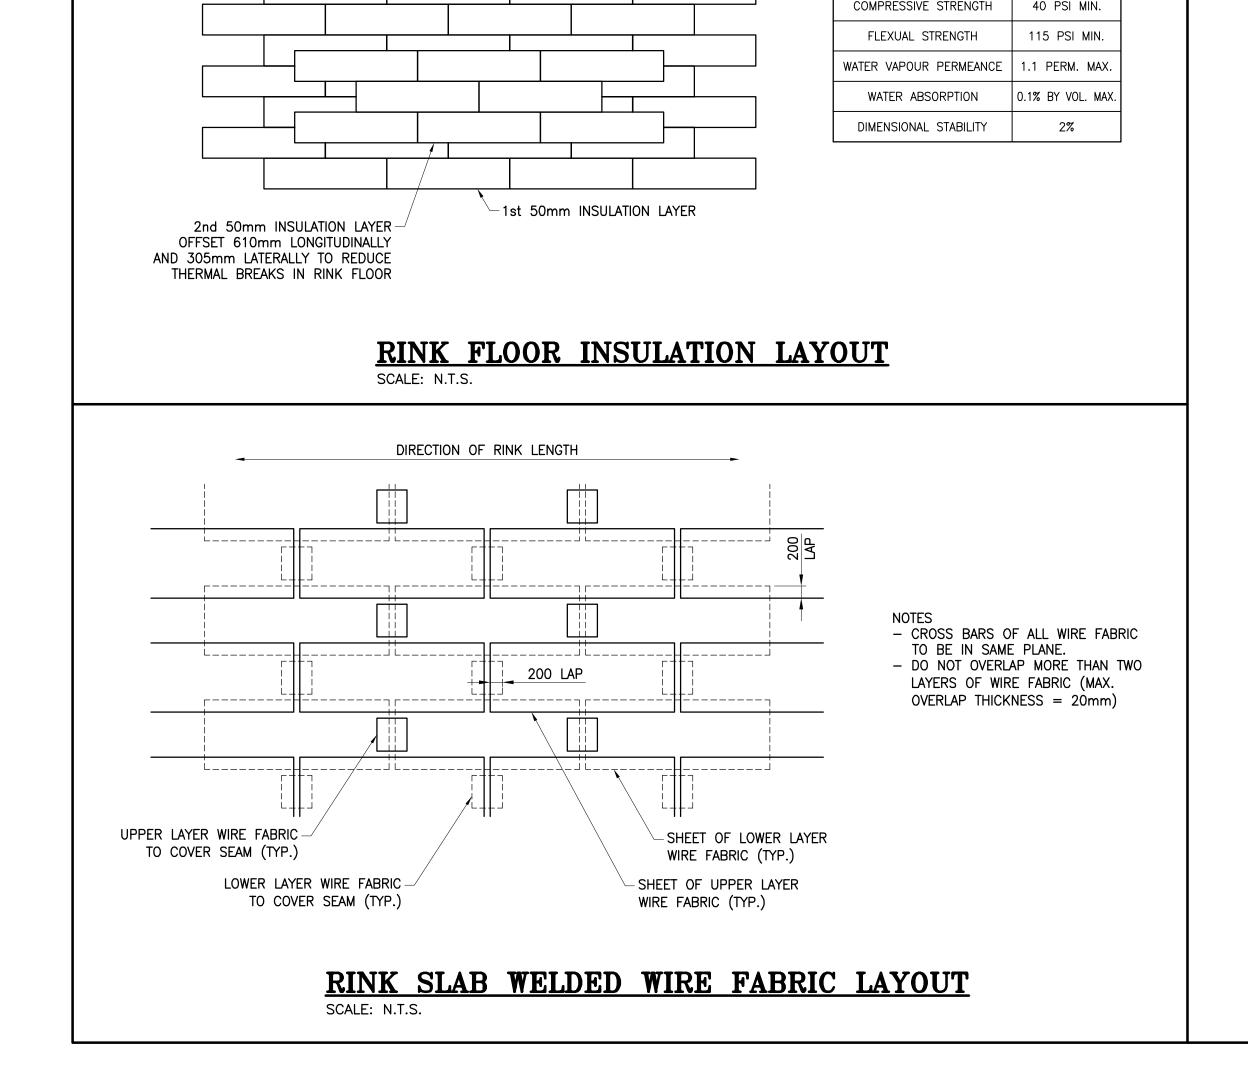

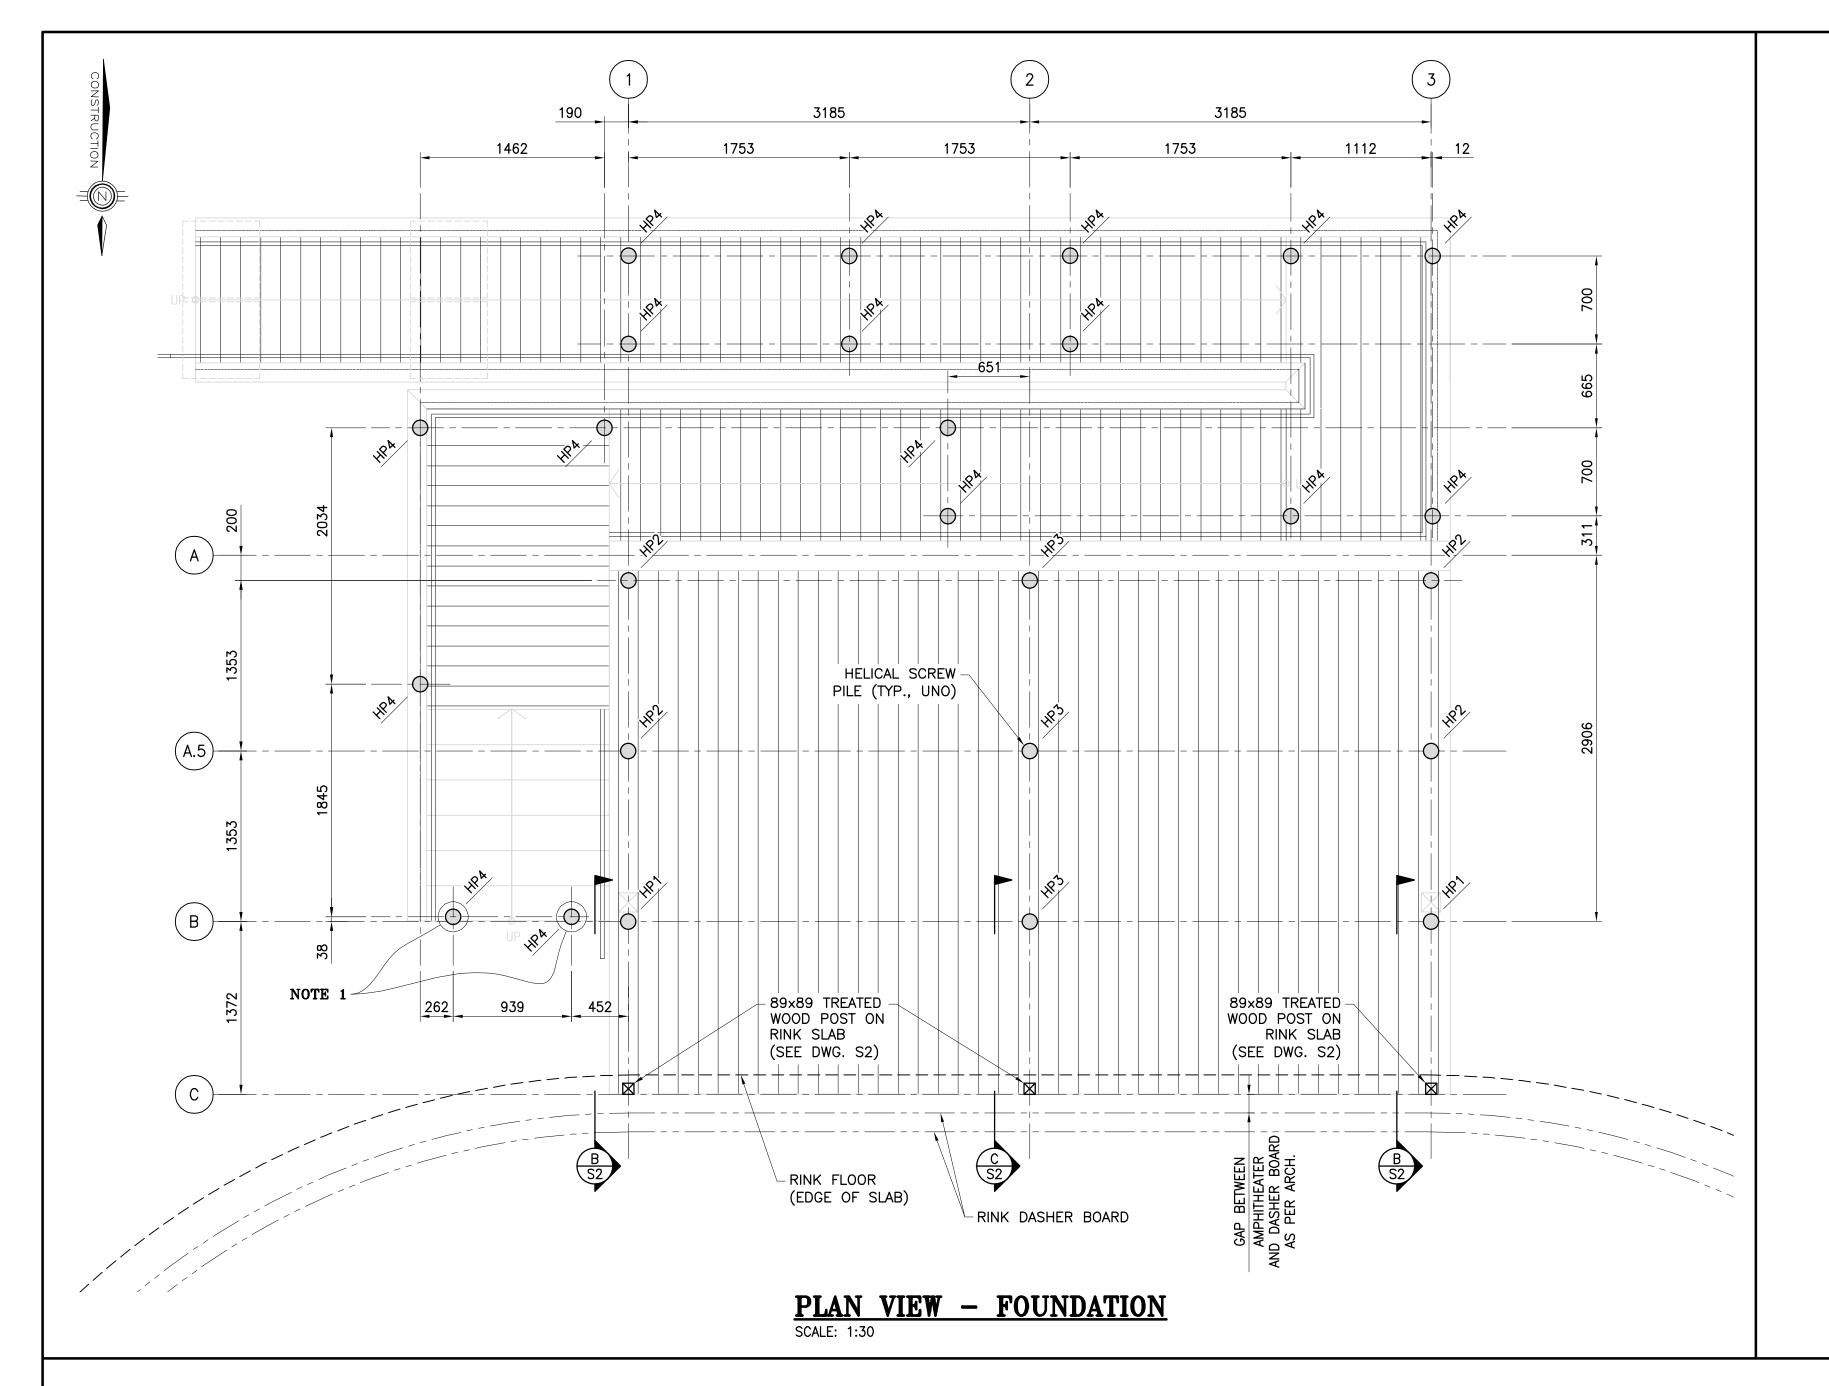

		HE	LICAL F	PILE SC	CHEDULE	
DESIGNATION	AXIAL LOAD (kN) (+ COMPRESSION, – TENSION)		LATERAL LOAD (kN)		TOP OF PILE CONNECTOR ELEVATION (m) (TO BE COORDINATED	PILE HEAD WOOD CONNECTOR
	(SLS)	(ULS)	(SLS)	(ULS)	WITH WOOD CONNECTOR SUPPLIER)	33.111201011
HP1 (89mmø MIN.)	47	71	1.5	5.0	119.500	U-BRACKET FOR WOO POST (140x140)
HP2 (89mmø MIN.)	19	29	1.0	8.0	119.969	U-BRACKET FOR WOO 2 PLY BEAM
HP3 (89mmø MIN.)	37	55	1.0	2.0	119.969	U-BRACKET FOR BUII 3 PLY BEAM
HP4 (76mmø MIN.)	15	25	1.0	4.0	VARIES AS PER RAMP REQUIREMENTS	U-BRACKET FOR BUI 2 PLY BEAM

- REFER TO SPECIFICATIONS FOR OTHER HELICAL PILE REQUIREMENTS.
- MINIMUM DEPTH OF PILES TO BE 2.44m. - ALL STEEL SHALL BE HOT-DIP GALVANIZED.
- COORDINATION WITH ELECTRICAL CONTRACTOR IS REQUIRED TO ENSURE
- TRENCHING IS DONE AFTER INSTALLATION OF PILES.

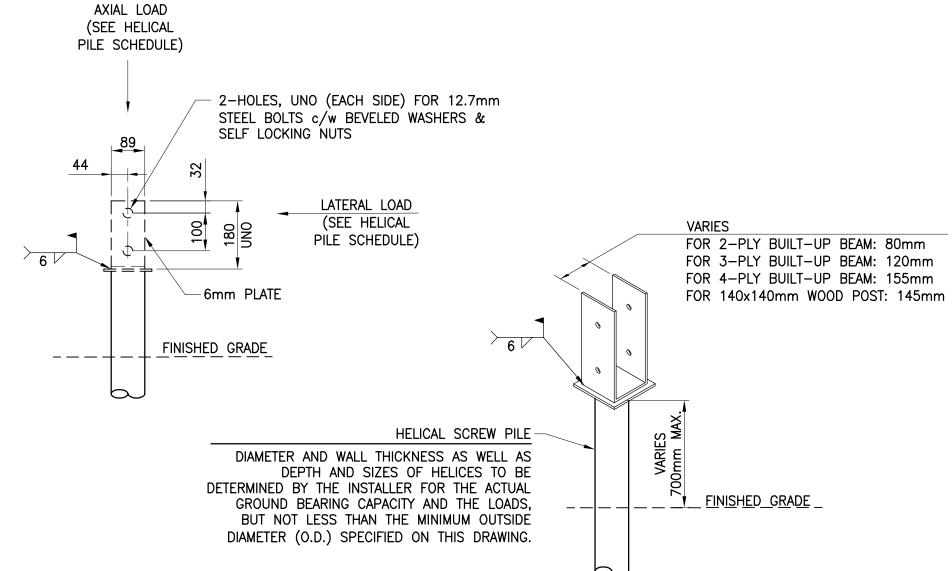

## TYPICAL HELICAL PILE CONNECTION SCALE: N.T.S.



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13, rue Costigan Street Edmundston (NB) E3V 1W7

REF: 493-18-4C

LANDSCAPE ARCHITECTS:




Red Island Contractors Inc.

305, Route 390, Tobique First Nation, NB, E7H 4P7

#### SPECIFIC NOTE

1. THE HEIGHT OF THE ATTACHED 'U' PLATE FOR THESE PILES SHALL BE 140mm AND HAVE ONLY ONE HOLE AT THE CENTER.

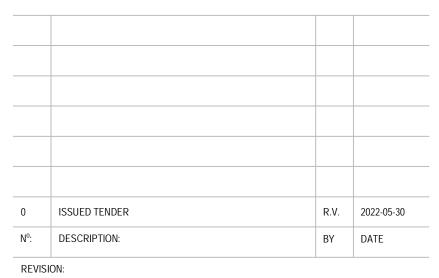

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KCIW KNICANEWEK SPORTS AND RECREATION PARK -PHASE 2 BUILDINGS TOBIQUE FIRST NATION, NB

DRAWING TITLE:


AMPHITHEATER -FOUNDATION-PLAN VIEW & SECTIONS


DESIGN: M. BOUDREAU APPROVED: --DRAWN: R. VALDRON DATE: MAY 2022

VERIFIED: M. BOUDREAU SCALE: AS SHOWN


PROJECT Nº: DRAWING N°:

9223-18-00 F3C

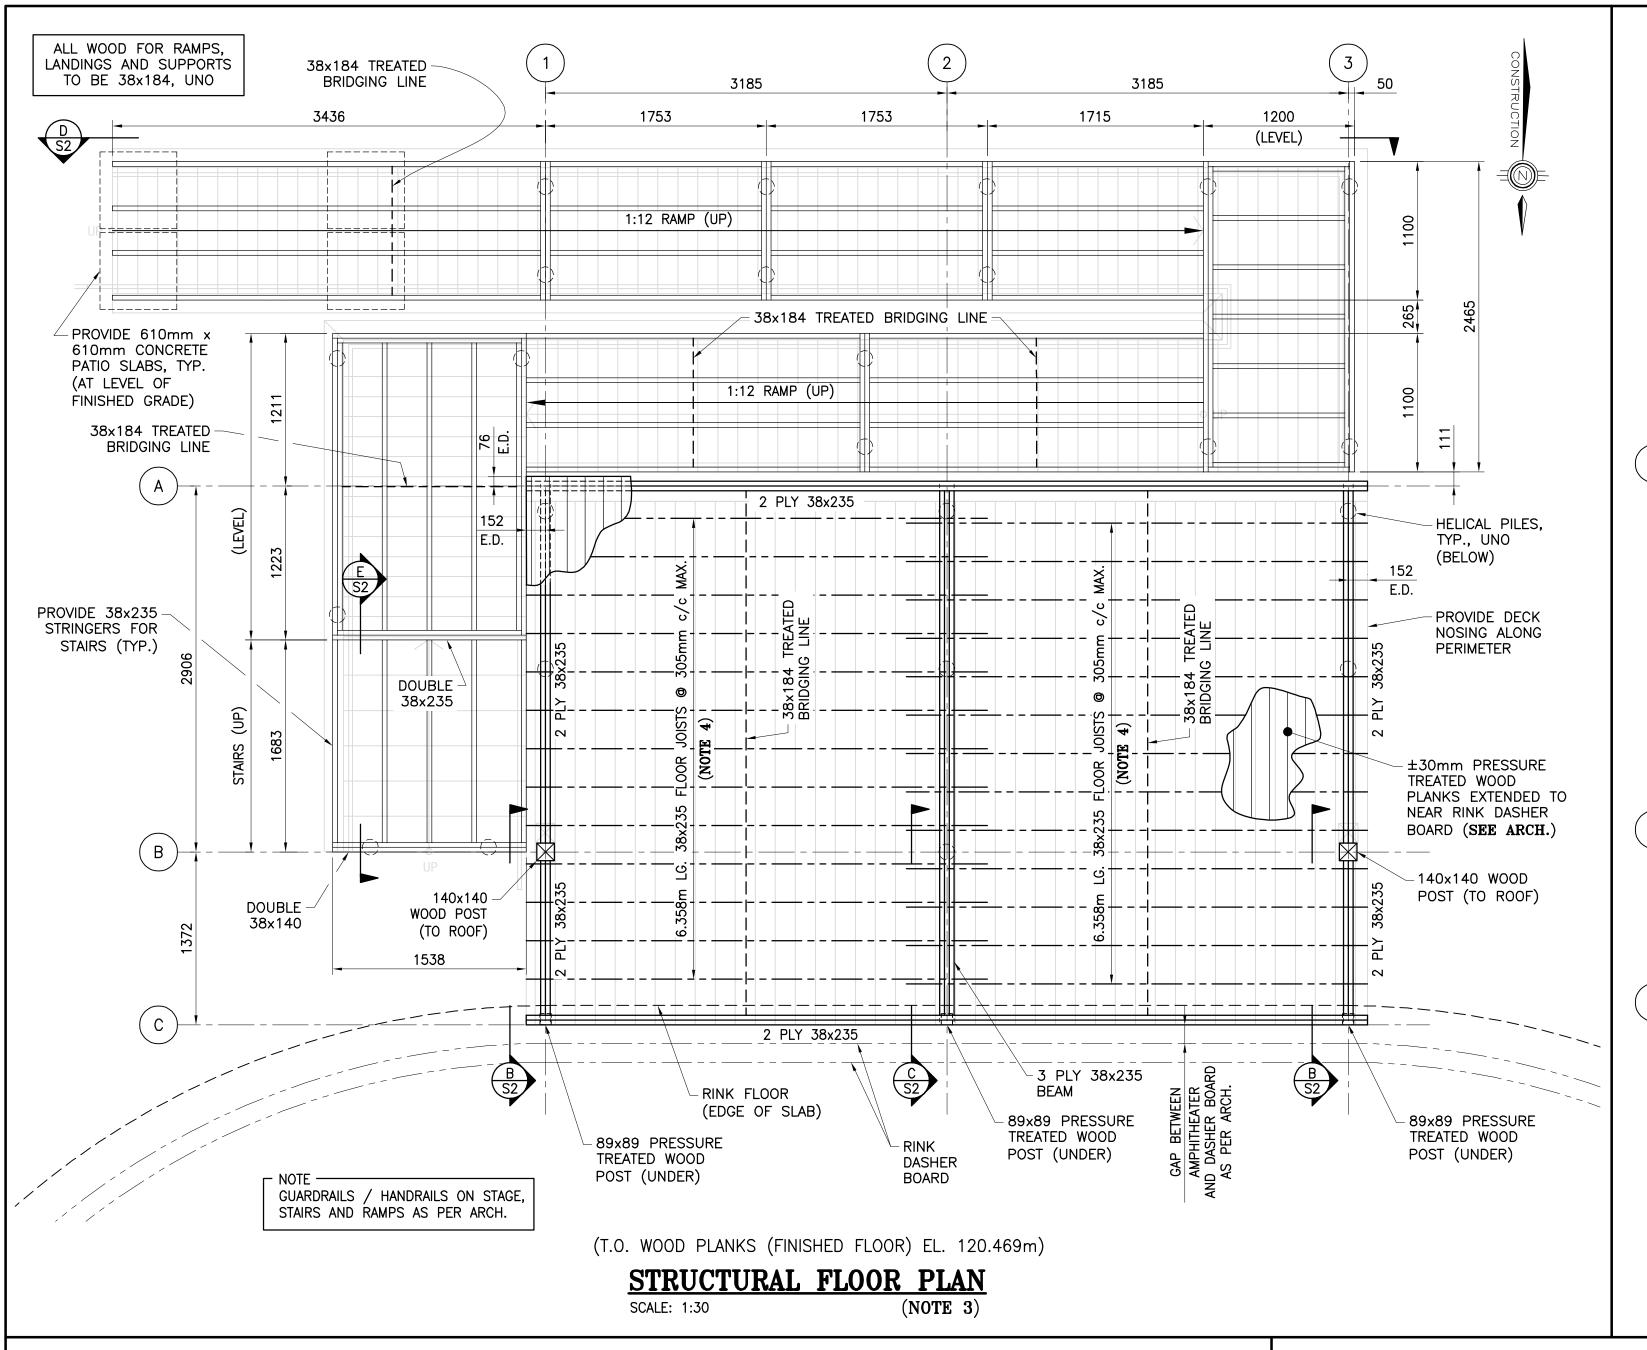

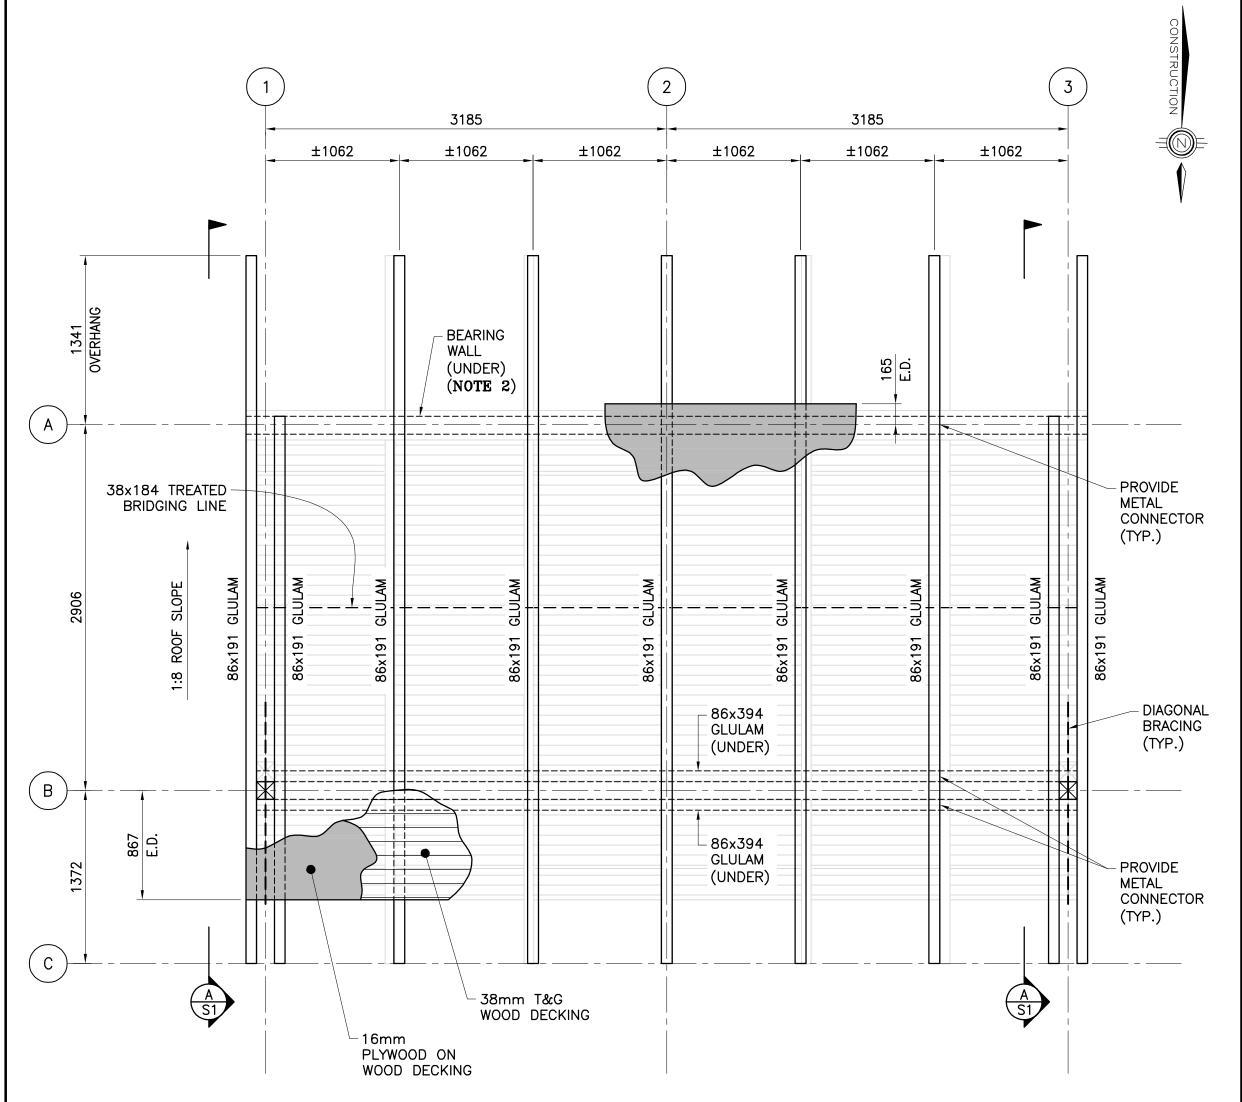

## STRUCTURAL ROOF PLAN SCALE: 1:30 (NOTE 3)

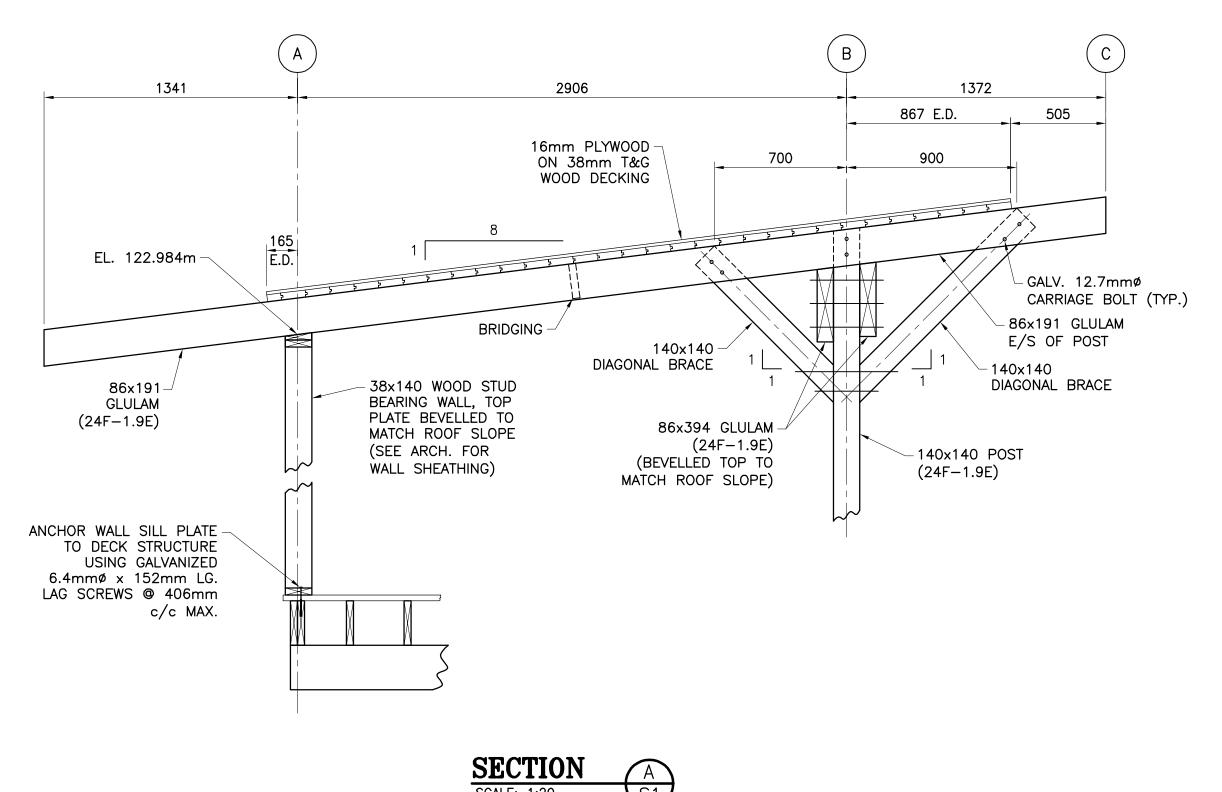

# (AS PER PART 4 OF THE NBC OF CANADA 2015, BUT WITH FOLLOWING UNFACTORED LOADS) DL ROOF: 1.0kPa (NOT INCLUDING JOISTS AND BEAMS) SL ROOF: 3.48kPa, UNO. (Ss = 3.6kPa, Sr = 0.6kPa, Cb = 0.8, Is=1.0) \[ \Delta SL: L/360 \] DL FLOOR: 1.0kPa (NOT INCLUDING JOISTS AND BEAMS) LL FLOOR: 4.8kPa \[ \Delta LL: L/360 \]

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- REFER TO ARCHITECTURAL DRAWINGS FOR FINISHES, AS WELL AS WALL OPENING DIMENSIONS AND LOCATIONS.
- THE TYPICAL DETAILS ON THIS THESE STRUCTURAL DRAWINGS ARE DIAGRAMMATIC AND INDICATE GENERAL ARRANGEMENT. REFER TO WRITTEN ANNOTATIONS AND SCHEDULES FOR EXACT ARRANGEMENT.
- REFERENCE ELEVATIONS ARE AS PER CIVIL AND LANDSCAPE ARCH. (BDA). THEY DIFFER FROM BUILDING ARCH. (EVOQ) ELEVATIONS.

ARCHITECTS:

info@evoqarchitecture.com

1435, RUE SAINT-ALEXANDRE, BUREAU 1000 MONTRÉAL (QUÉBEC) H3A 2G4 T. 514-393-9490 F. 514-393-9498

ENGINEERS



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Edmundston (NB) E3V 1V
T. / 506.737.9730

REF: 493-18-4C


LANDSCAPE ARCHITECTS:



Red Island Contractors Inc. 305, Route 390, Tobique First Nation, NB, E7H 4P7

#### SPECIFIC NOTES

- EACH ROOF JOIST TO BE CONNECTED TO EXTERIOR WALL TOP PLATES WITH ONE H4 CONNECTOR BY SIMPSON STRONG TIE (OR APPROVED EQUAL), ALONG LINES 'A' AND 'C'.
- WALL VERTICALS TO BE @ 406mm c/c MAX. PROVIDE A DOUBLED VERTICAL STUD IN THE WALL DIRECTLY IN LINE WITH EACH GLULAM.
- 3. ALL LUMBER TO BE PRESSURE TREATED WOOD, UNLESS NOTED OTHERWISE AND CONNECTORS TO BE GALVANIZED.
- 4. SPLICE TO BE NAILED WITH 2 ROWS OF COMMON WIRE NAILS @ 150mm c/c MAX.

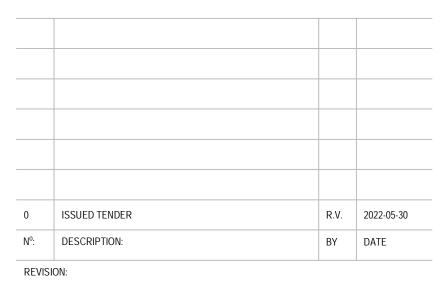

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KCIW KNICANEWEK SPORTS AND RECREATION PARK -PHASE 2 BUILDINGS TOBIQUE FIRST NATION, NB

DRAWING TITLE:

AMPHITEATHER
-STRUCTURALPLAN VIEWS & DETAILS


DRAWING No:

DESIGN: M. BOUDREAU APPROVED: -
DRAWN: R. VALDRON DATE: MAY 2022

VERIFIED: M. BOUDREAU SCALE: AS SHOWN

9223-18-00

S1C

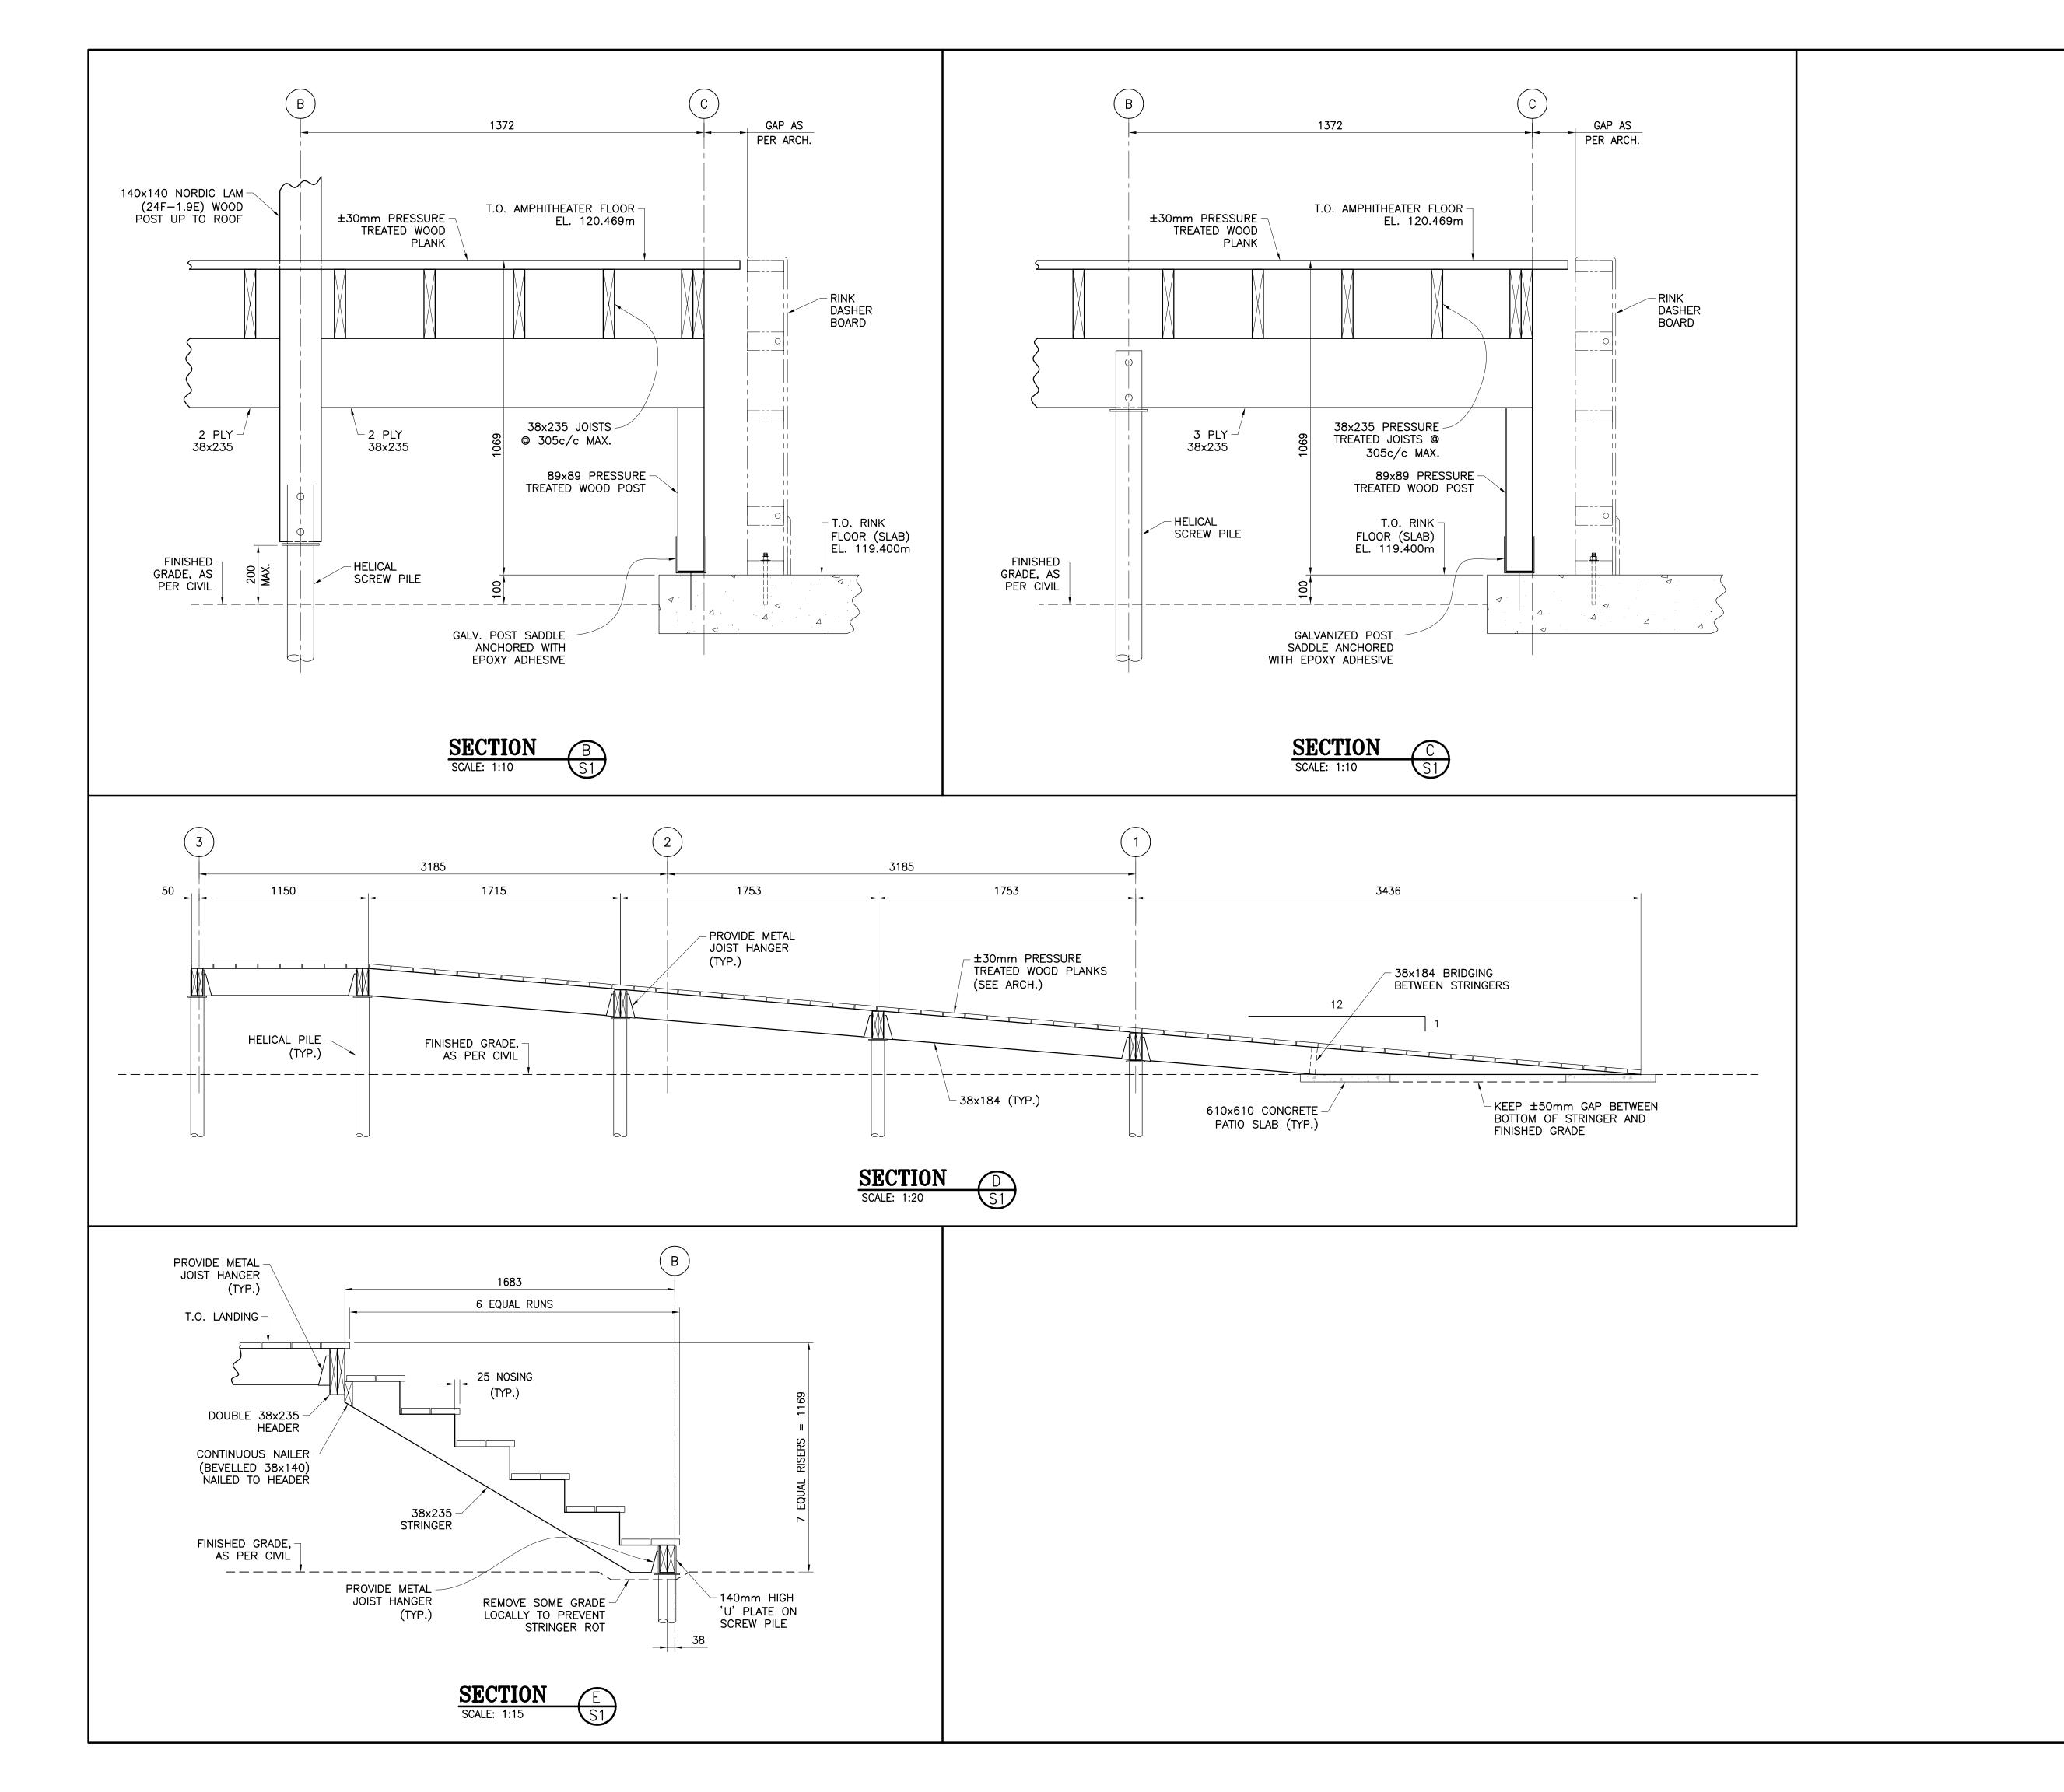

ARCHITECTS:

1435, RUE SAINT-ALEXANDRE, BUREAU 1000 MONTRÉAL (QUÉBEC) H3A 2G4 T. 514-393-9490 F. 514-393-9498 info@evoqarchitecture.com

ENGINEERS



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T. / 506.737.9730

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LANDSCAPE ARCHITECTS:



Red Island Contractors Inc.

305, Route 390, Tobique First Nation, NB, E7H 4P7

0	ISSUED TENDER	R.V.	2022-05-30
Nº:	DESCRIPTION:	BY	DATE

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REVISION:

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KCIW KNICANEWEK SPORTS AND RECREATION PARK -

AND RECREATION PARK -PHASE 2 BUILDINGS TOBIQUE FIRST NATION, NB

DRAWING TITLE:

AMPHITEATHER
-STRUCTURALSECTIONS

DESIGN: M. BOUDREAU APPROVED: -
DRAWN: R. VALDRON DATE: MAY 2022

VERIFIED: M. BOUDREAU SCALE: AS SHOWN

PROJECT N°: DRAWING N°:

9223-18-00 S2C