



WEST ELEVATION

1/8" = 1'-0"

SCALE

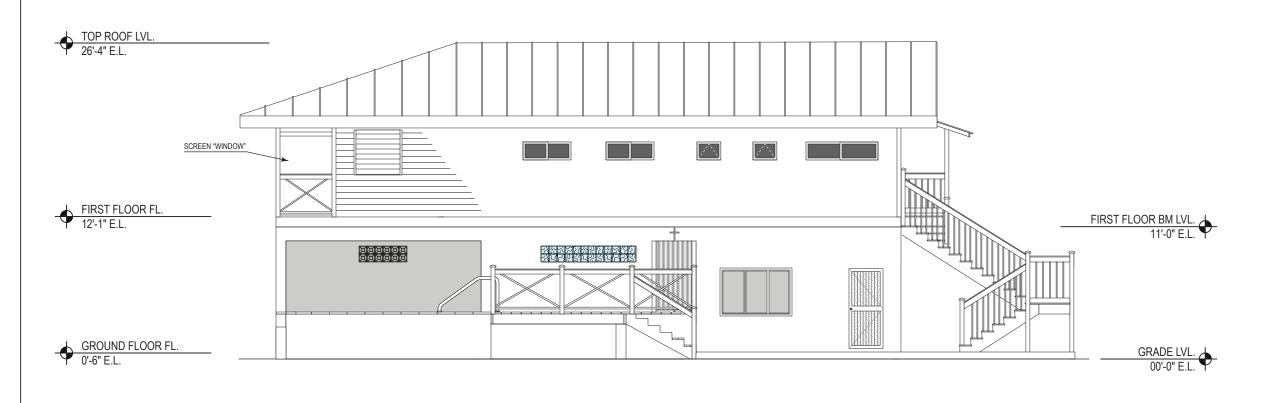



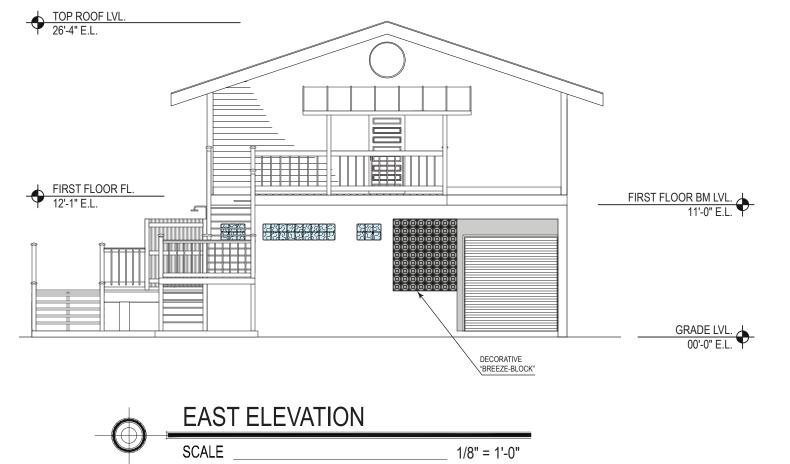

1/8" = 1'-0"






OWN & DEBRA STUART "THE BOATHOUSE" PLACENCIA NORTH, BELIZE TIM BR

> PLANS & **ELEVATIONS**

SCALE:1/96 DRAWN BY: Tim Brown

DATE: August 2020

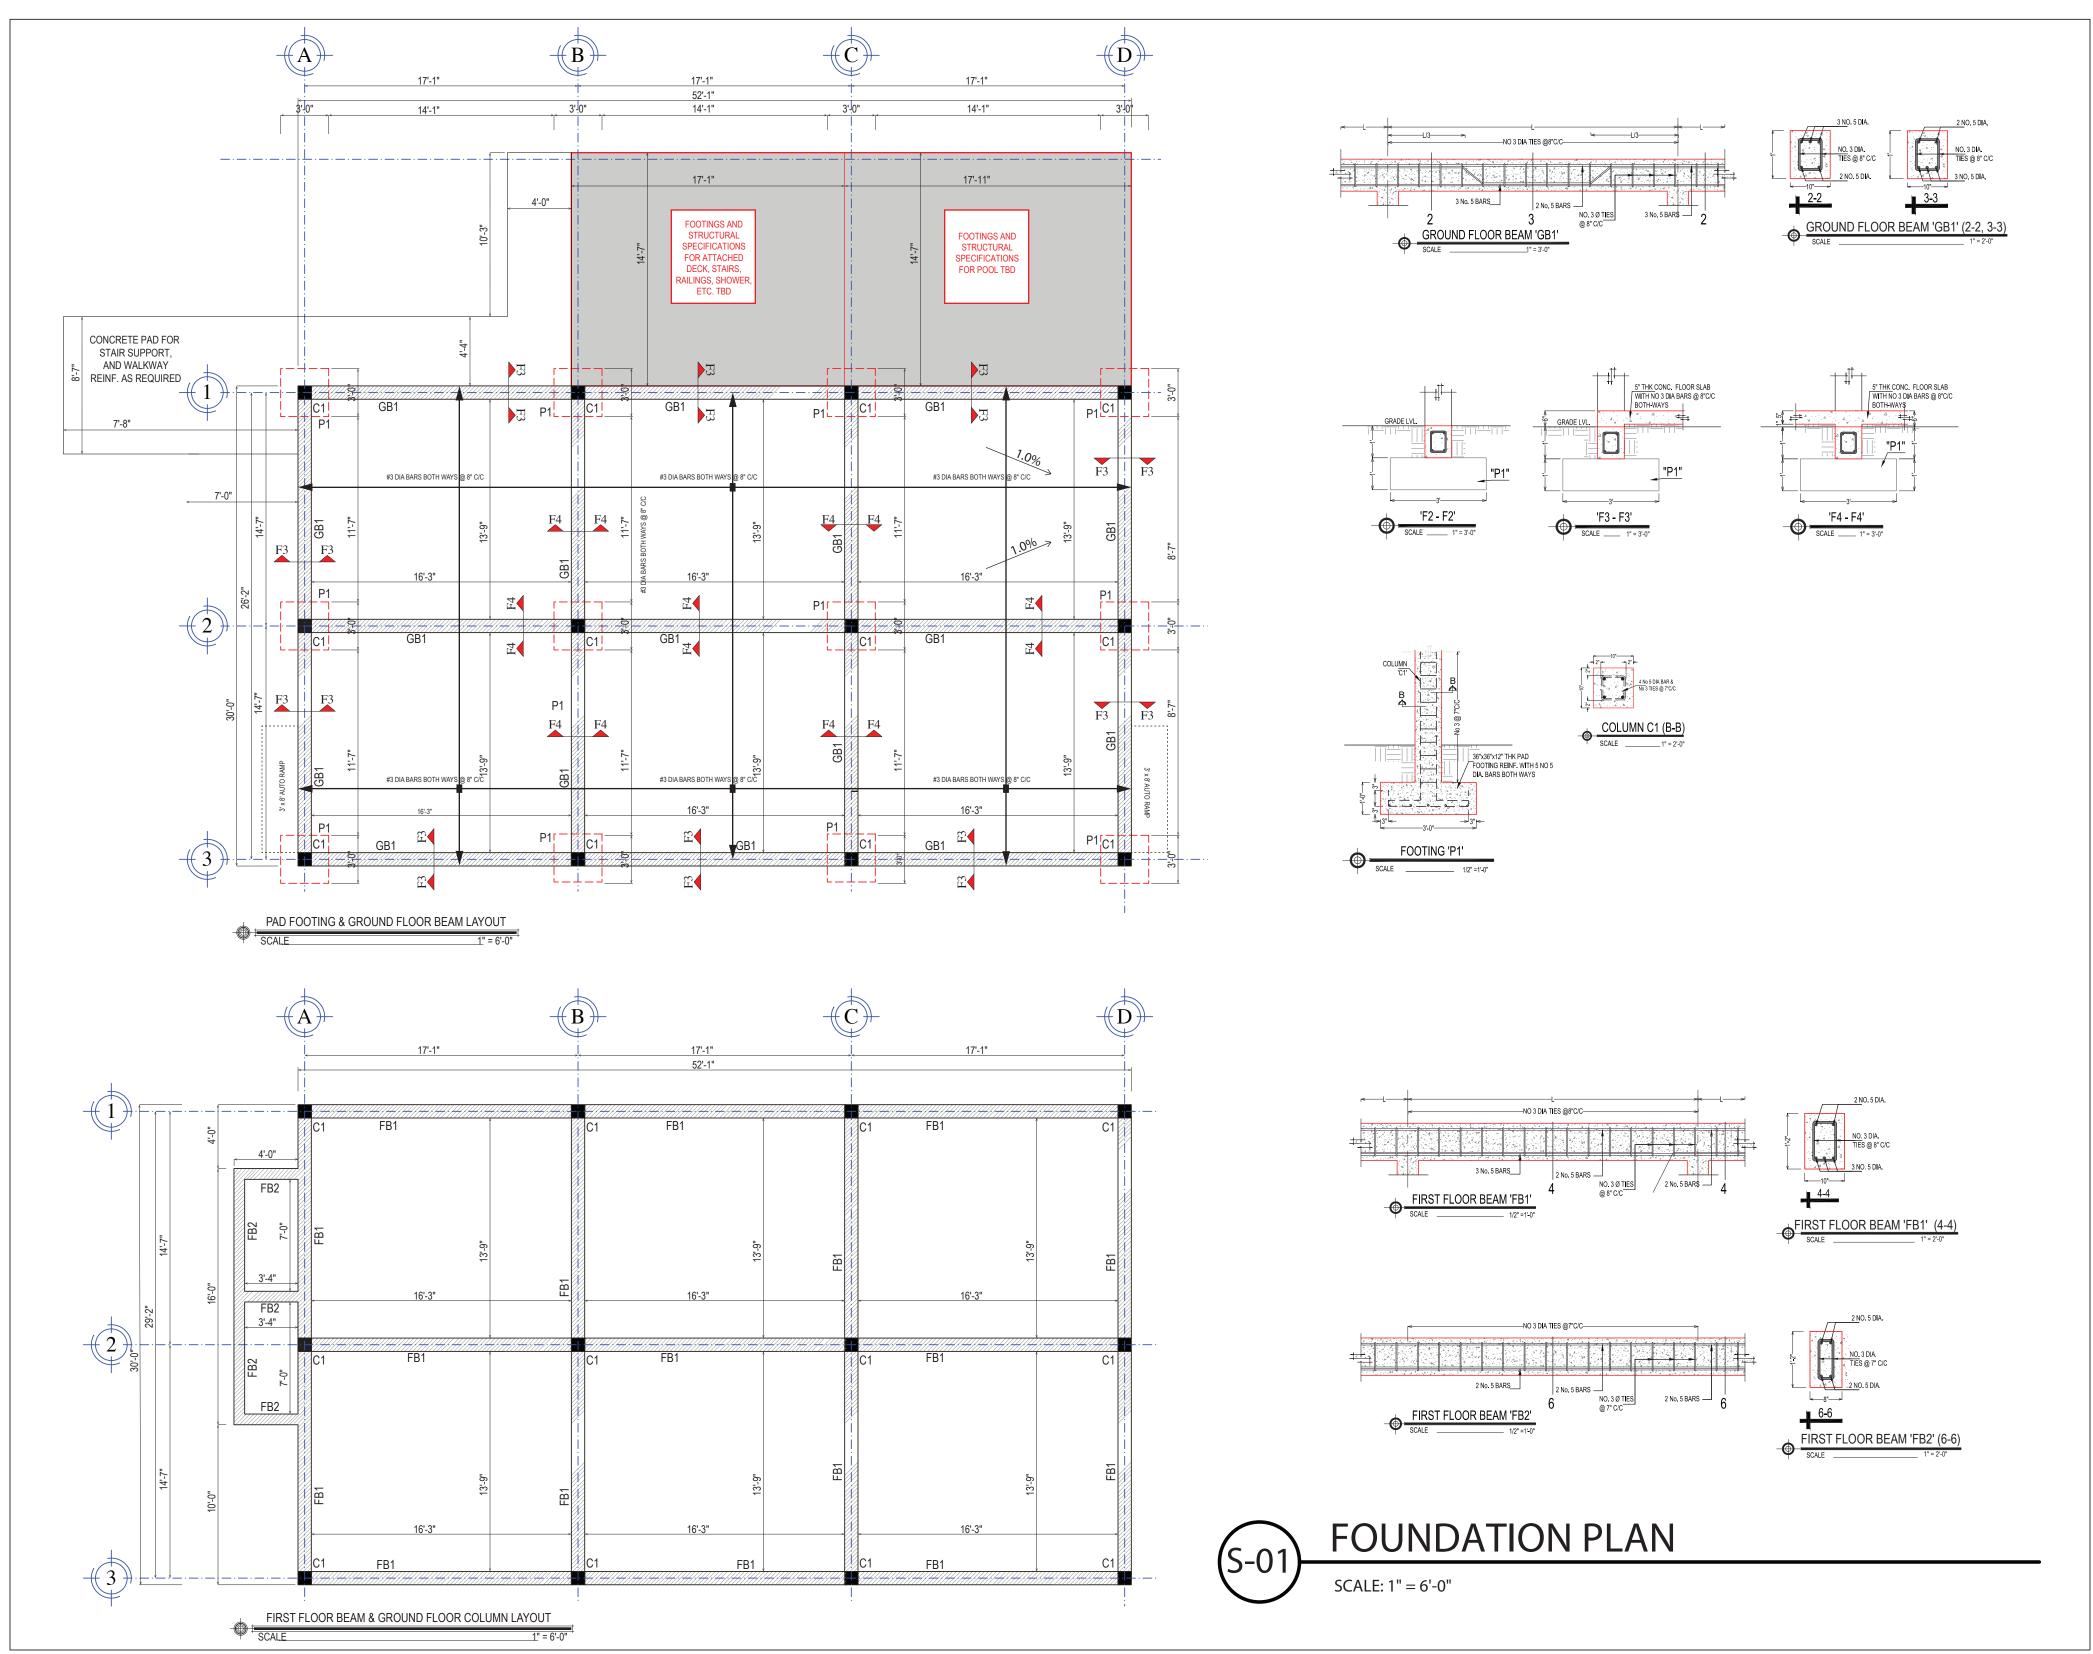

CHITECT:




TIM BROWN & DEBRA STUART

PLANS & ELEVATIONS

DATE: August 2020

SCALE:1/96

DRAWN BY: Tim Brown

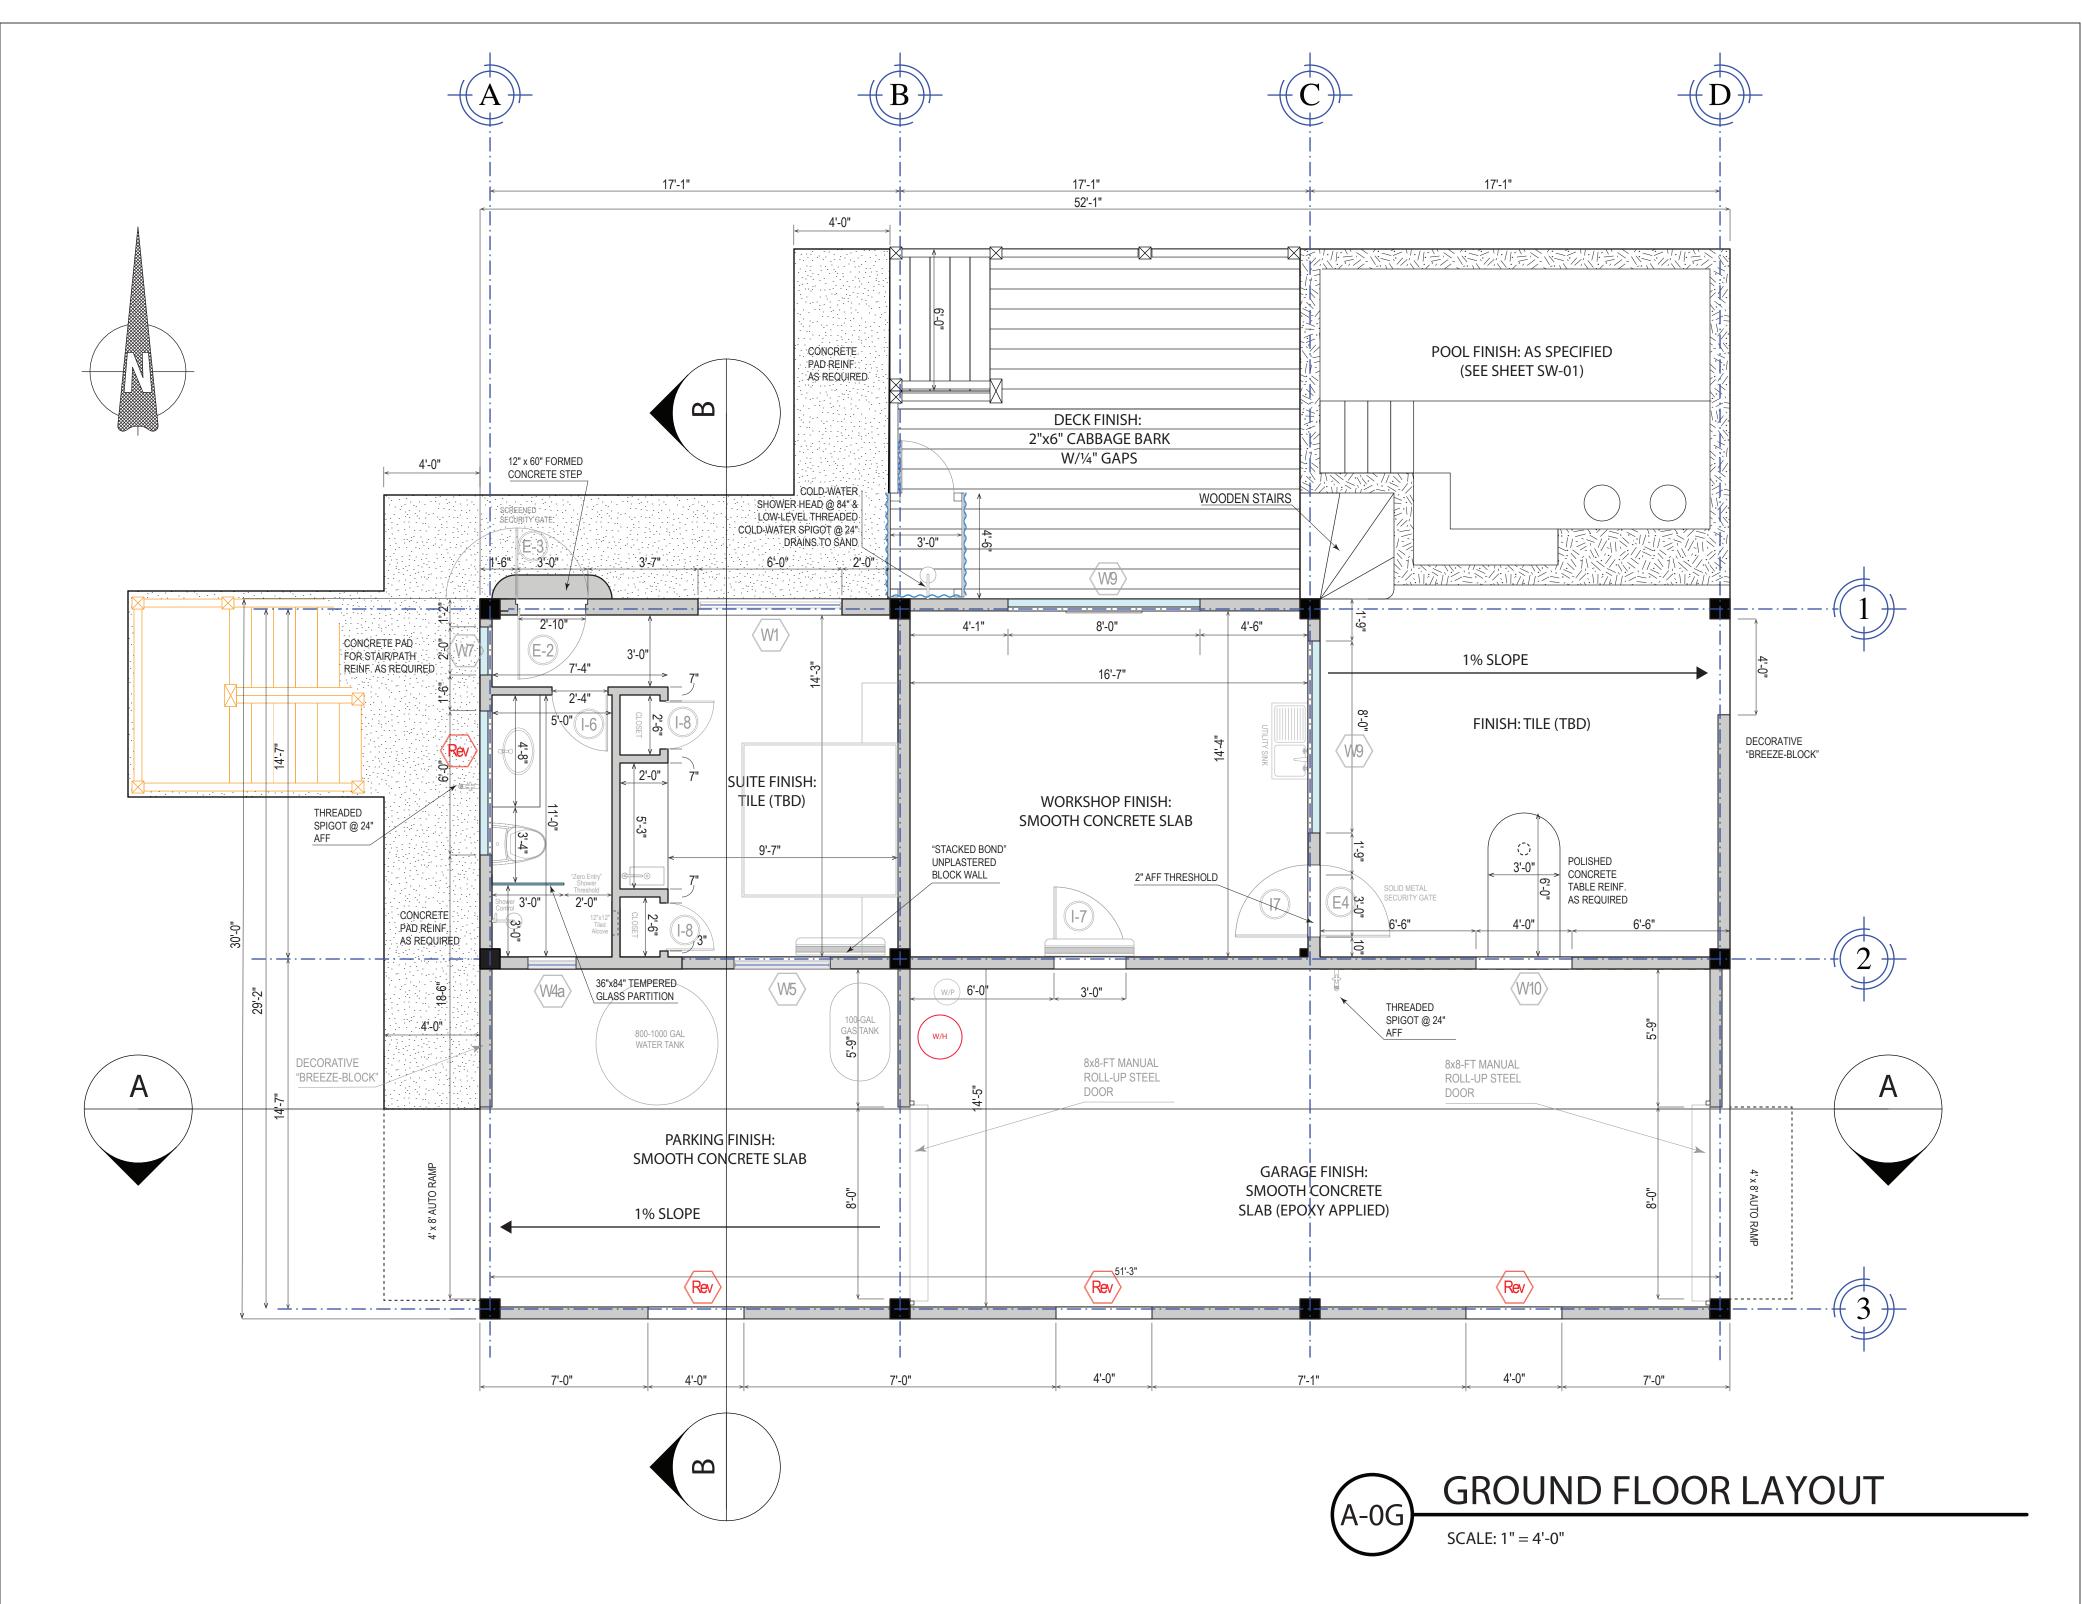


OWN & DEBRA STUART TIM BR

> PLANS & **ELEVATIONS**

DATE: 26 October 2021 SCALE:1:48

DRAWN BY: Tim Brown

JOB:

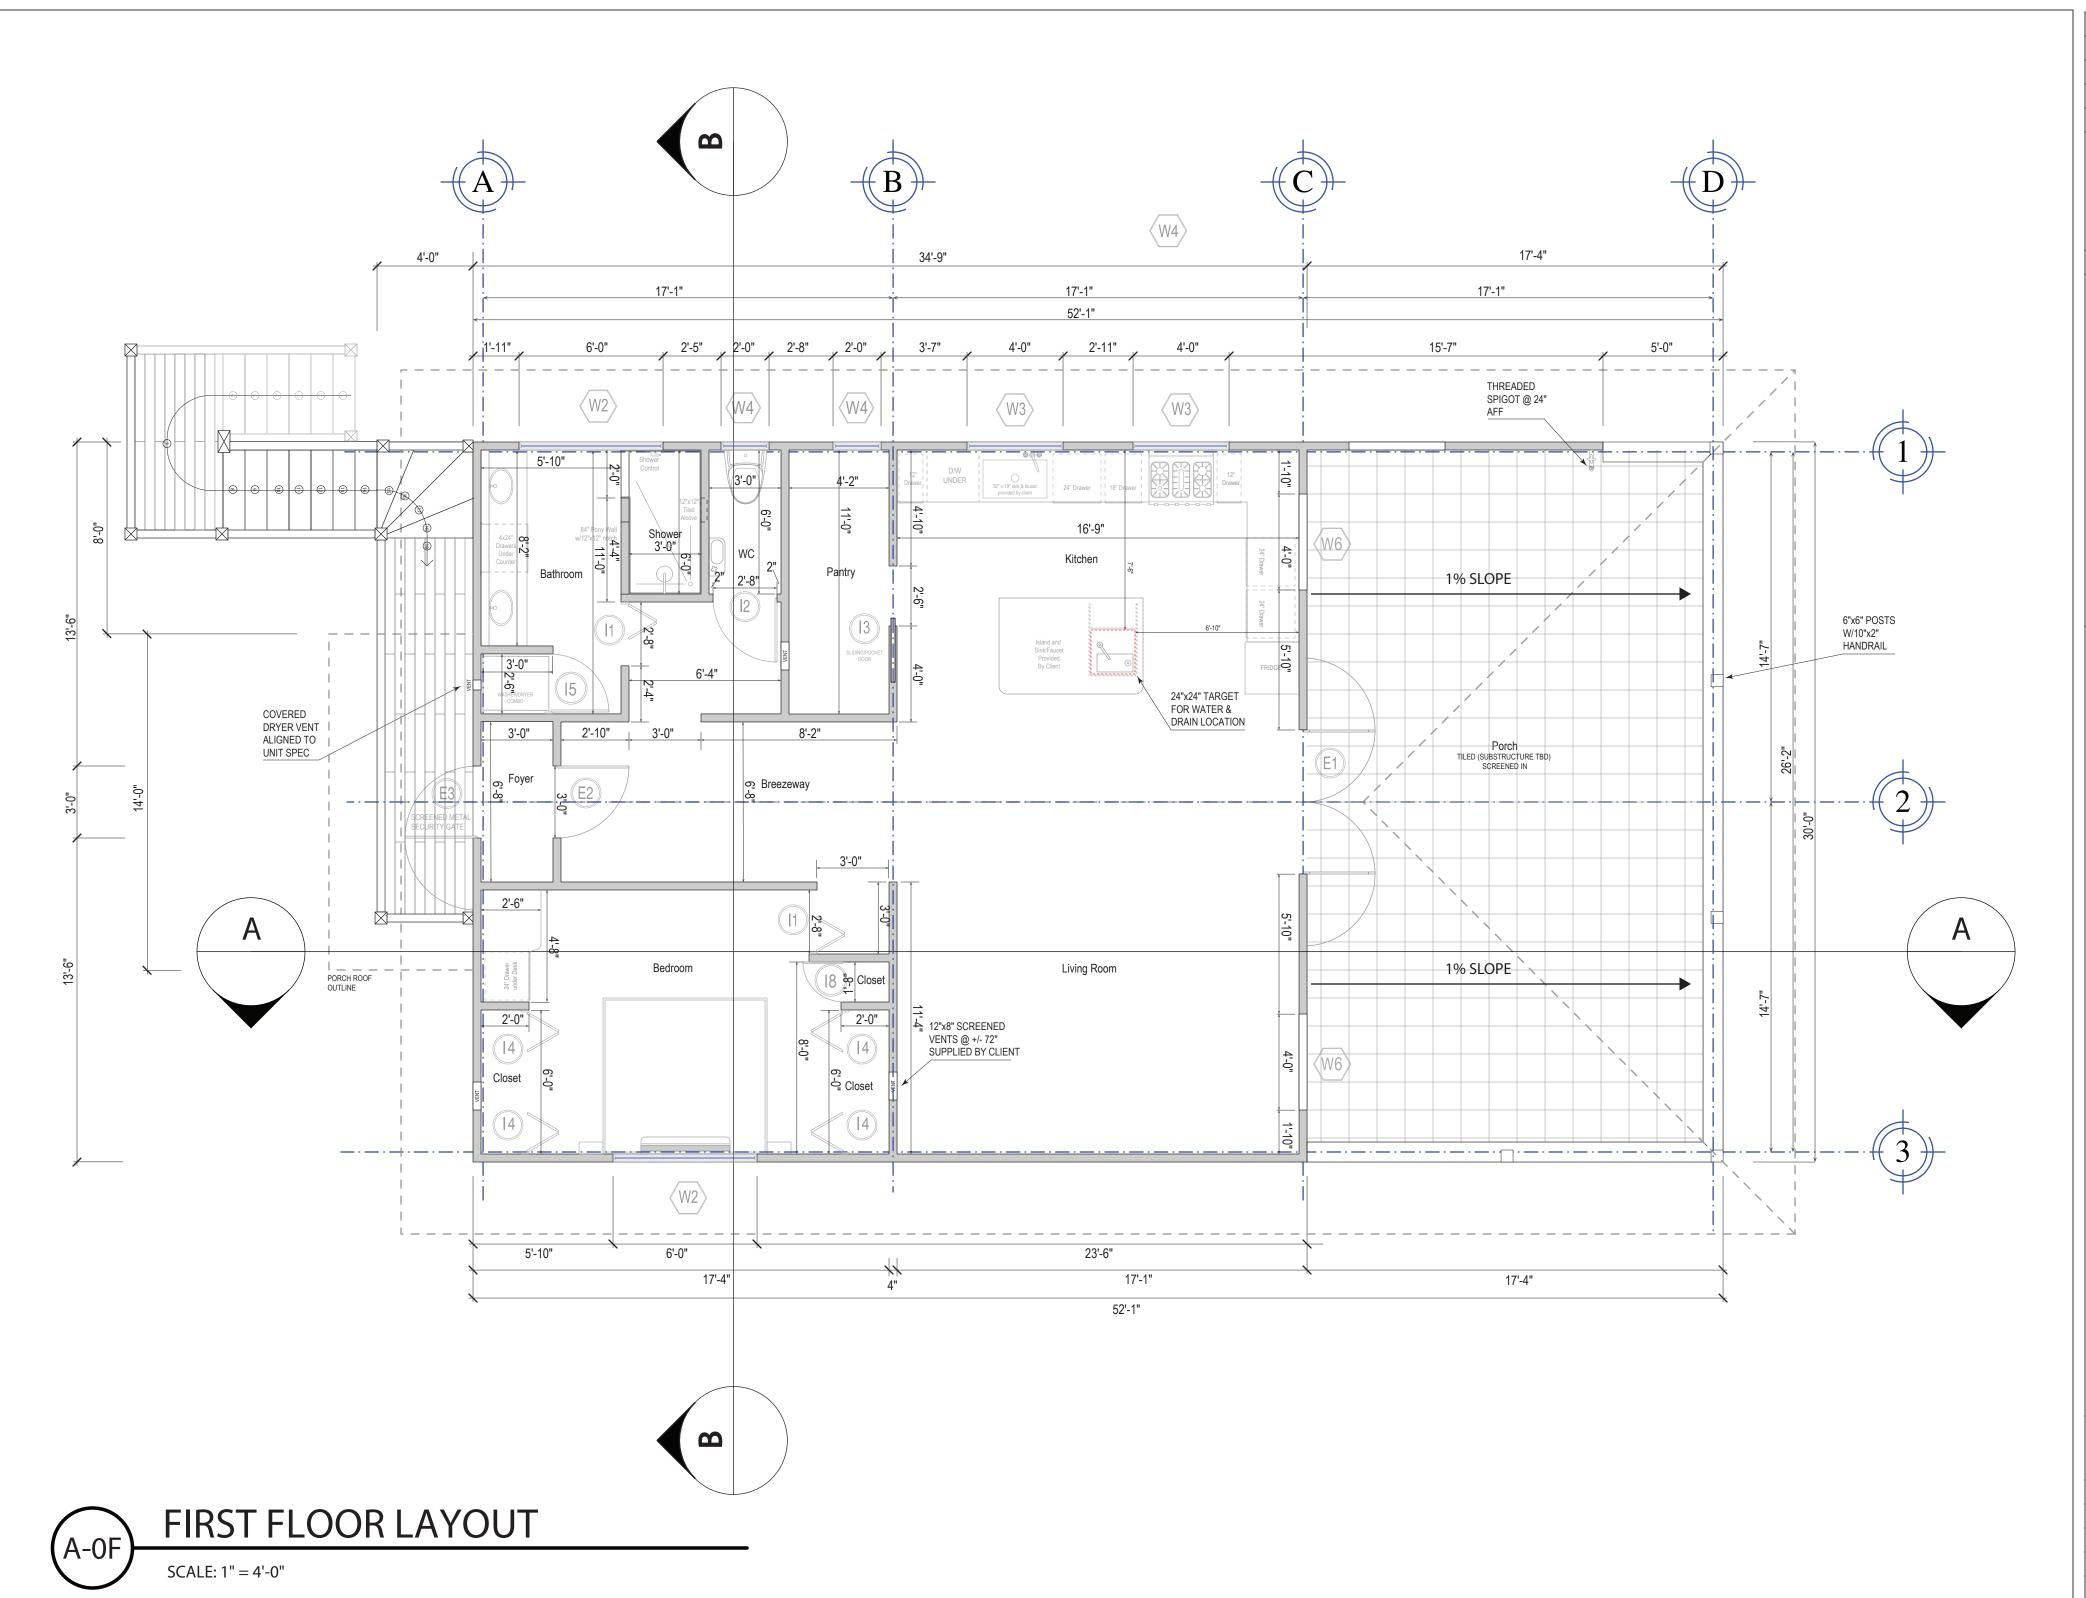


OWN & DEBRA STUART TIM BR

> PLANS & **ELEVATIONS**

DATE: August 2020

SCALE:1/96 DRAWN BY: Tim Brown

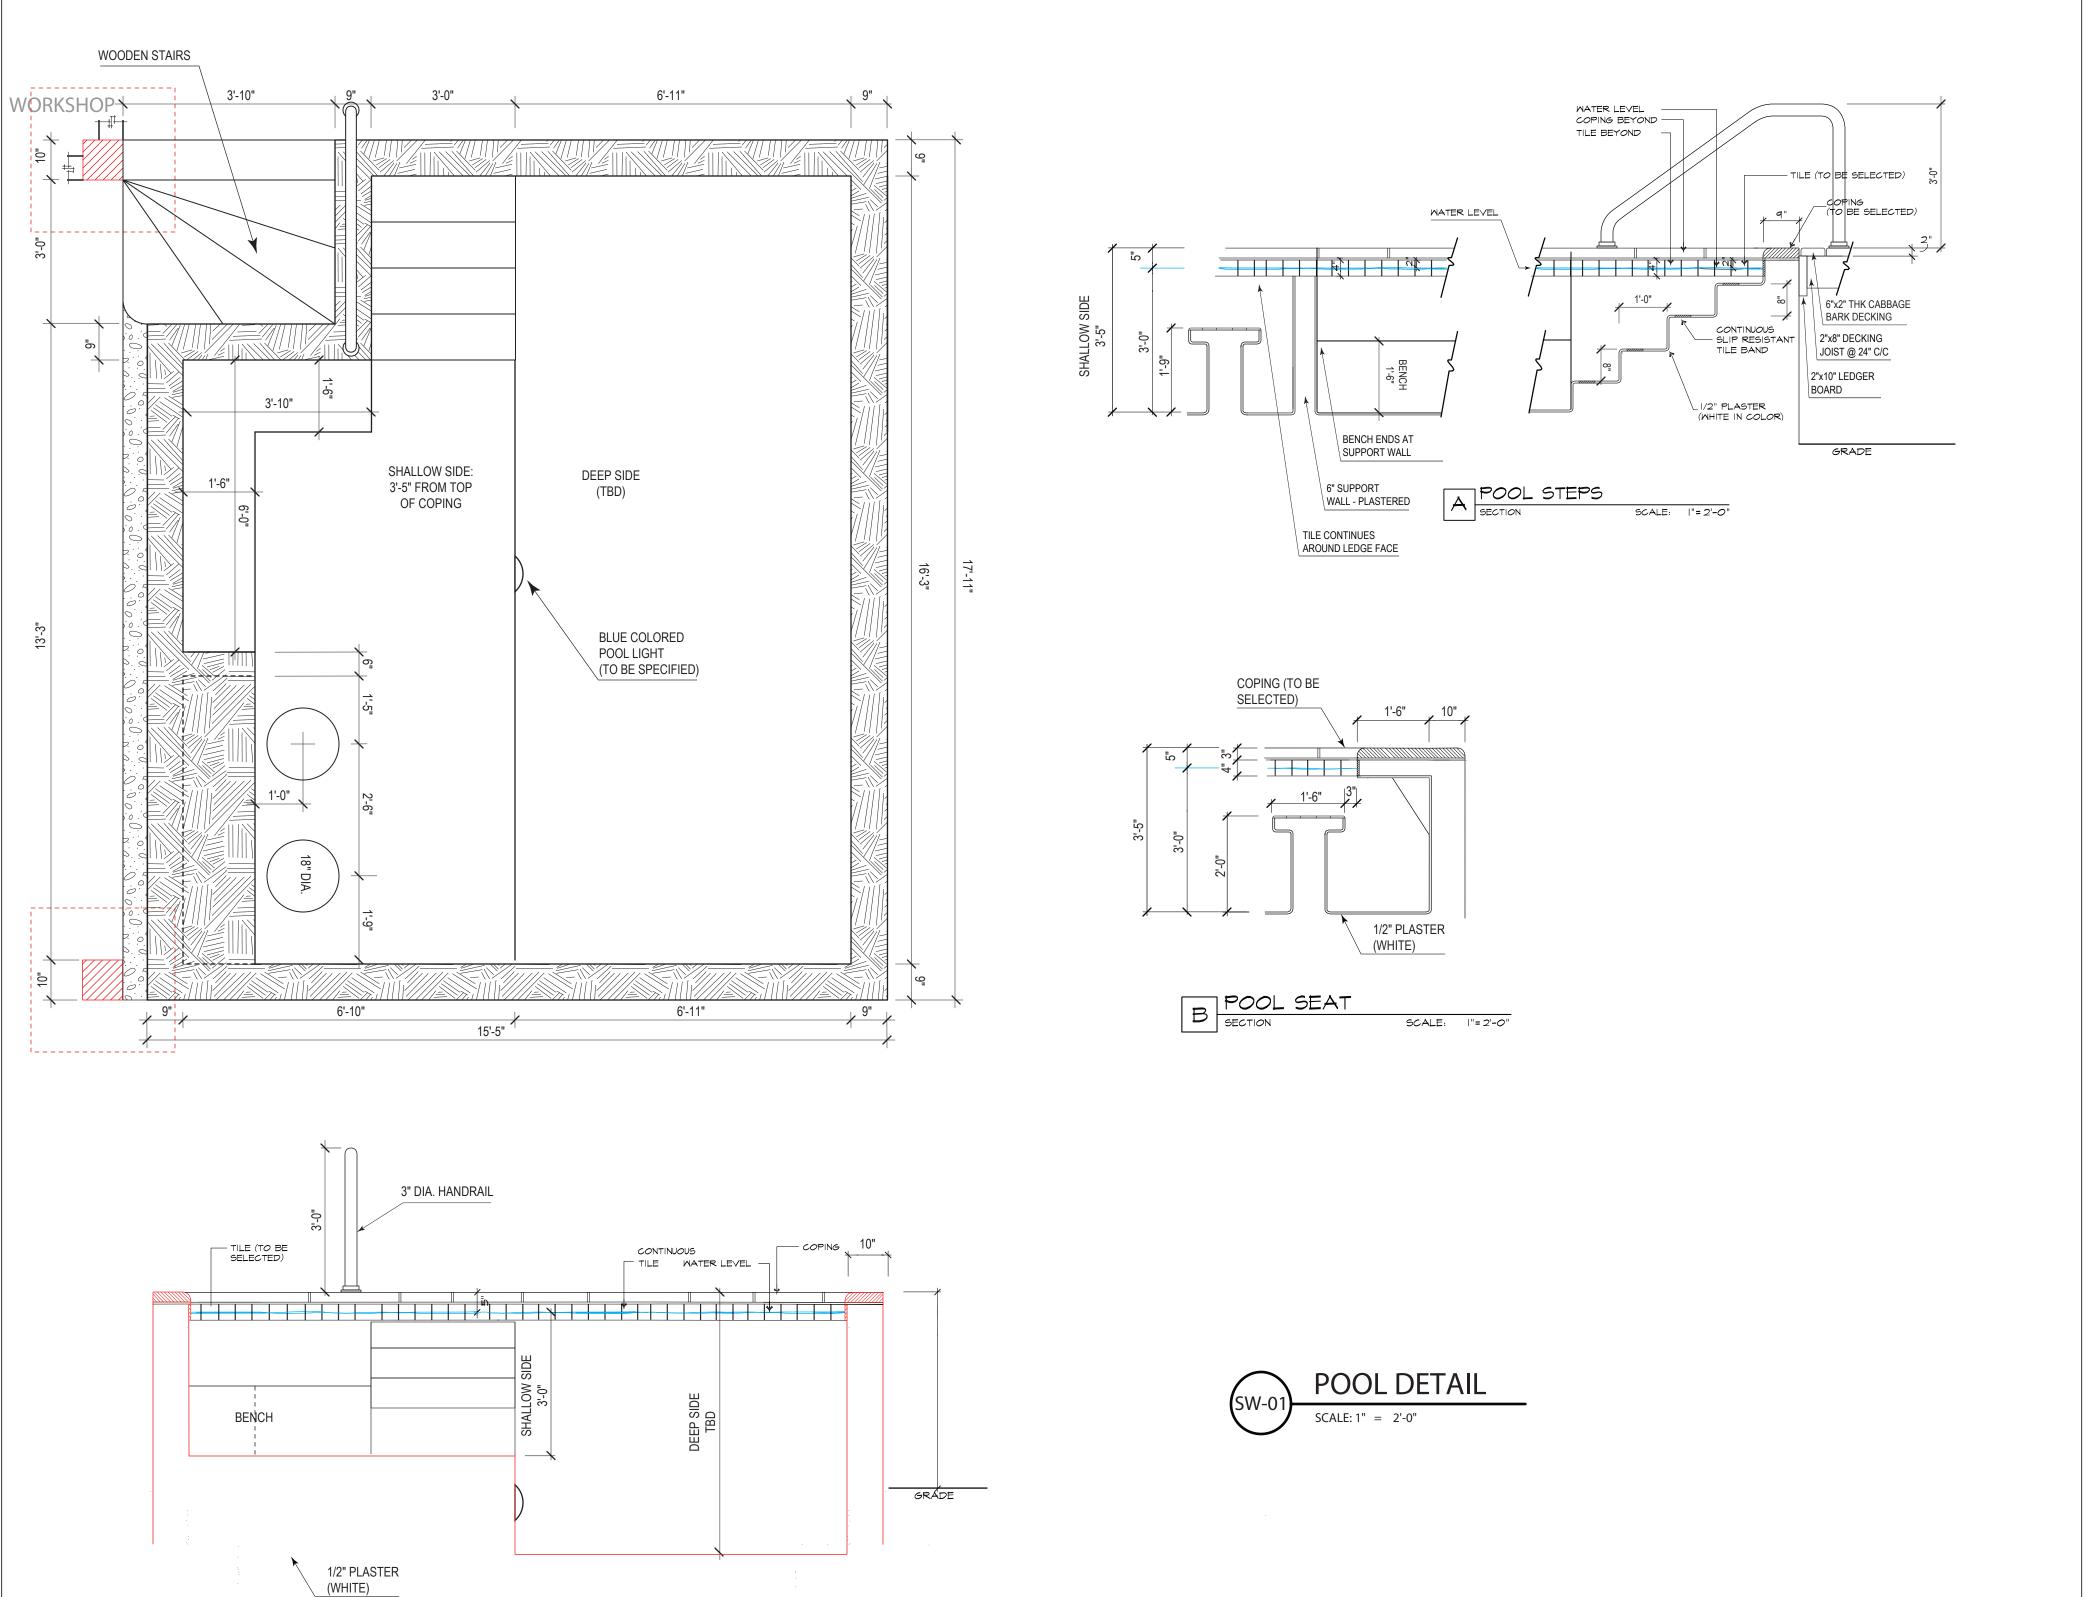





STUART **OWN & DEBRA** BR 

> PLANS & **ELEVATIONS**


DATE: August 2020 SCALE:1/96


DRAWN BY: Tim Brown

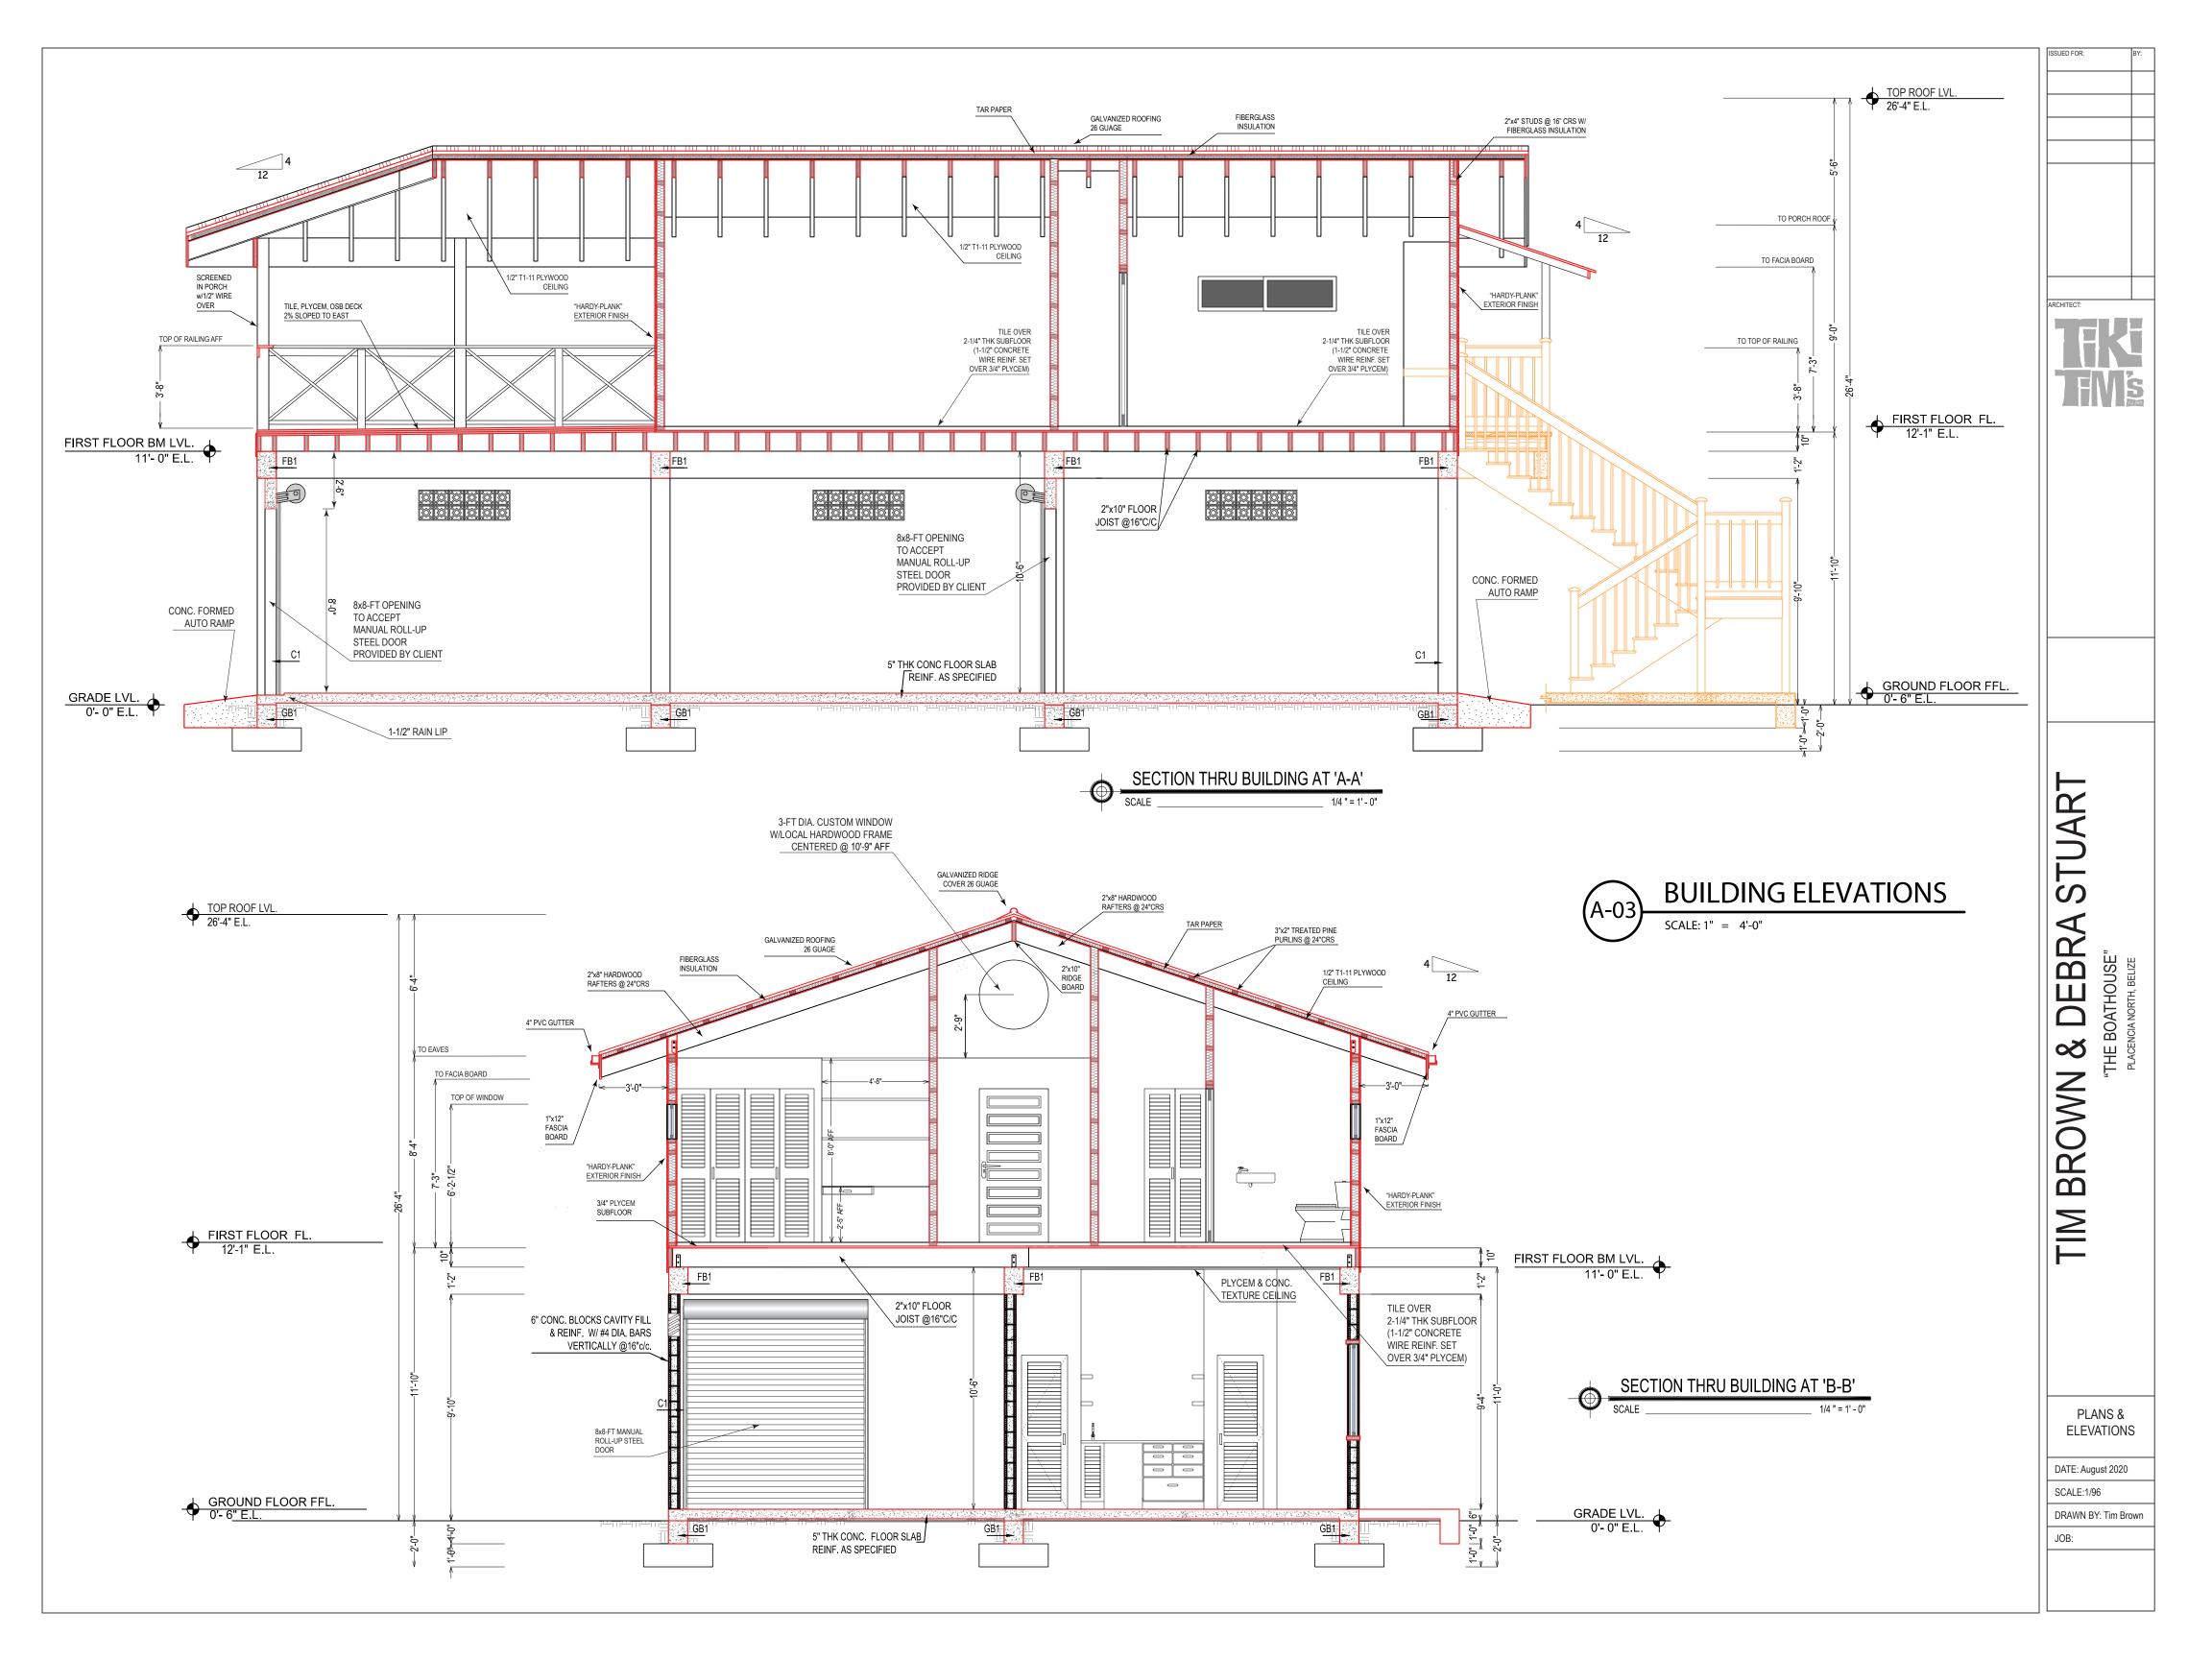

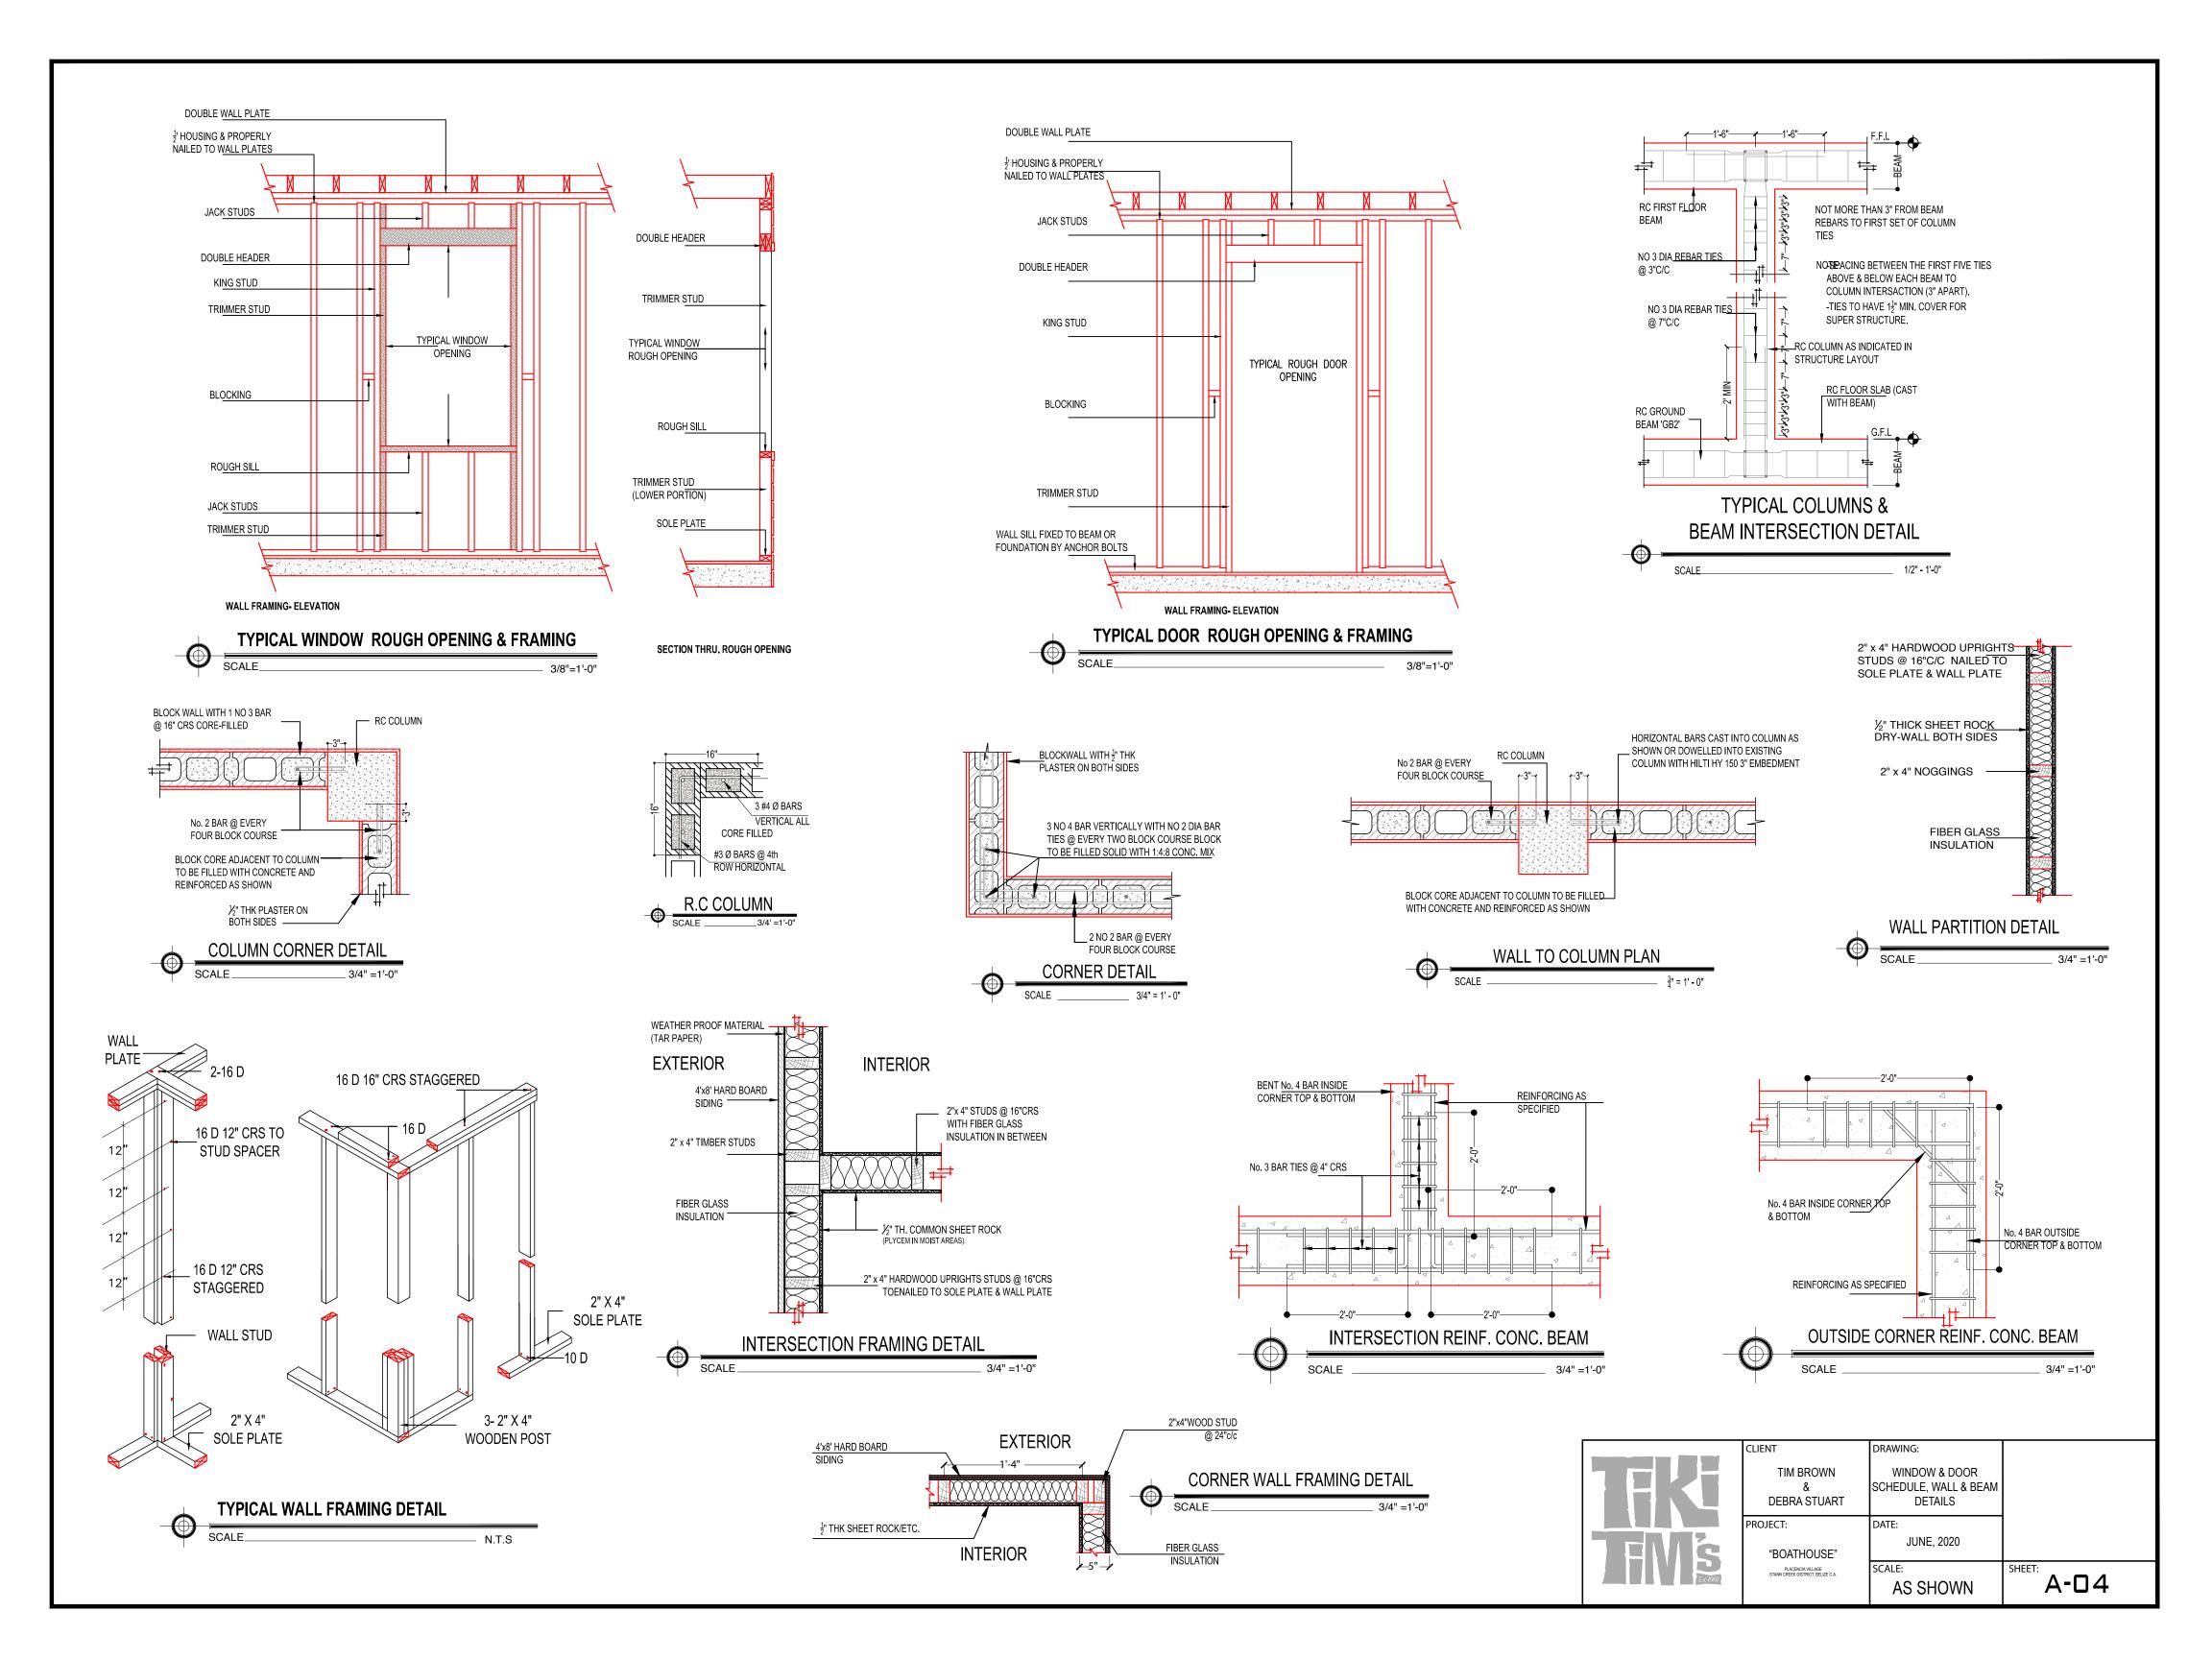



WINDOW SCHEDULE				
CODE QUANT. SIZE (WxH)		ROUGH OPNG.	TYPE	
W1	1	6'-0" X 4'-0"	6'-4" x 4'-4"	3-PANEL SLIDING, GLASS
W2	2	6'-0" X 1'-6"	6'-4" x 1'-10"	2-PANEL SLIDING, GLASS
W3	2	4'-0" X 1'-6"	4'-4" x 1'-10"	2-PANEL SLIDING, GLASS
W4/4a	3	2'-0" X 1'-6"	2'-4" x 1'-10"	HOPPER, GLASS
W5	1	4'-0" X 1'-6"	4'-4" x 1'-10"	2-PANEL SLIDING, GLASS
W6	2	4'-0" X 4'-0"	4'-4" x 4'-4"	3-PANEL FOLDING, GLASS
W7	2	2'-0" X 1'-4"	SET IN BLOCK WALL	8"x8" (x6) GLASS BLOCK
W8	1	6'-0" X 1'-4"	SET IN BLOCK WALL	8"x8" (x12) GLASS BLOCK
W9	2	8'-0" X 1'-4"	SET IN BLOCK WALL	8"x8" (x24) GLASS BLOCK
W10	4	4'-0" X 1'-4"	SET IN BLOCK WALL 8"x8" (x12) CONCRETE BLO	

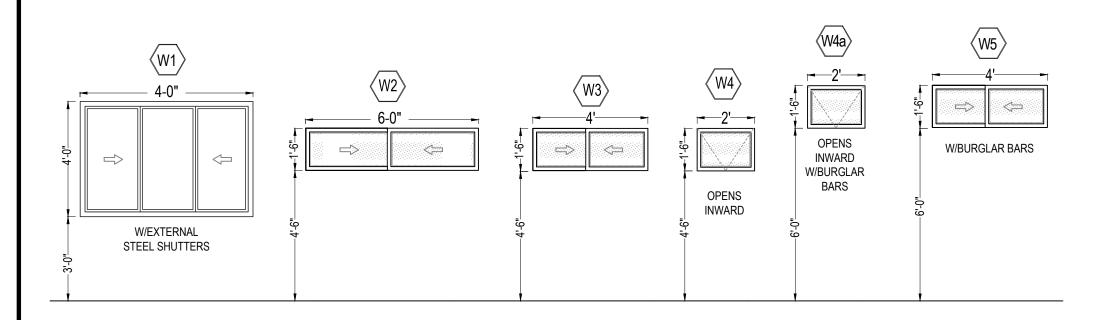


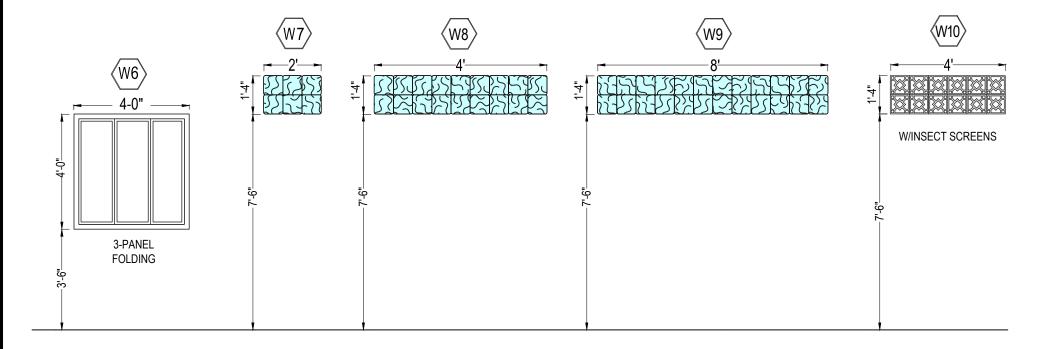


	DOOR SCHEDULE						
CODE	QNT.	SIZE	ROUGH OPNG.	JAMB SIZE	TYPE	FRAME	REMARKS
E1	1	6'-0" x 7'-2"	6'-4" x 7'-6".	2" x 5"	HINGED DOOR	ALUMN./PVC	DECK DOOR
E2	1	3'-0" x 6'-8"	3'-4" x 7'-0".	2" x 5"	SINGLE PANEL HINGED DOOR	TIMBER/GLASS	MAIN DOOR
E3	2	3'-0" x 6'-8"	3'-4" x 7'-0".	2" x 5"	SINGLE PANEL HINGED DOOR	SCREENED METAL/IRON	SECURITY DOOR
E4	1	3'-0" x 6'-8"	3'-4" x 7'-0".	2" x 5"		SOLID METAL/IRON	SECURITY DOOR
E5	1	2'-10" x 6'-8"	3'-2" x 7'-0".	2" x 5"	SINGLE PANEL HINGED DOOR	TIMBER	FRONT DOOR
l1	2	2'-8" x 6'-8"	CLOSET	2" x 5"	FOLDING LOUVERED DOOR	TIMBER	INTERIOR DOORS
12	1	2'-8" x 6'-8"	3'-0" x 7'-0".	2" x 5"	SINGLE PANEL HINGED DOOR	TIMBER	INT/EXT DOORS
13	1	2'-8" x 6'-8"	3'-0" x 7'-0".	N/A	SINGLE PANEL LOUVERED DOOR	TIMBER/GLASS	POCKET DOOR
14	4	3'-0" x 6'-8"	CLOSET	2" x 5"	FOLDING LOUVERED DOOR	TIMBER	INTERIOR DOORS
15	1	2'-6" x 6'-8"	2'-10" x 7'-0".	2" x 5"	SINGLE PANEL LOUVERED DOOR	TIMBER	INTERIOR DOORS
16	1	2'-4" x 6'-8"	2'-8" x 7'-0".	2" x 5"	SINGLE PANEL HINGED DOOR	TIMBER	INTERIOR DOORS
17	2	3'-0" x 6'-8"	3'-4" x 7'-0".	2" x 5"	SINGLE PANEL HINGED DOOR	TIMBER/GLASS	INTERIOR DOORS
18	2	2'-0" x 6'-8"	CLOSET	2" x 5"	SINGLE PANEL LOUVERED DOOR	TIMBER	INTERIOR DOORS

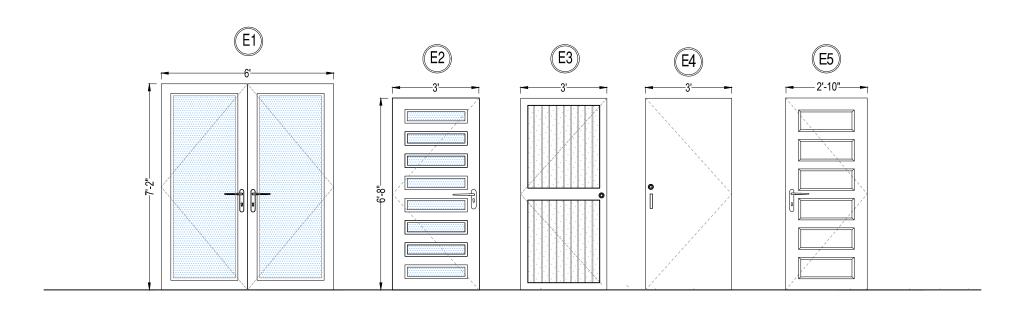

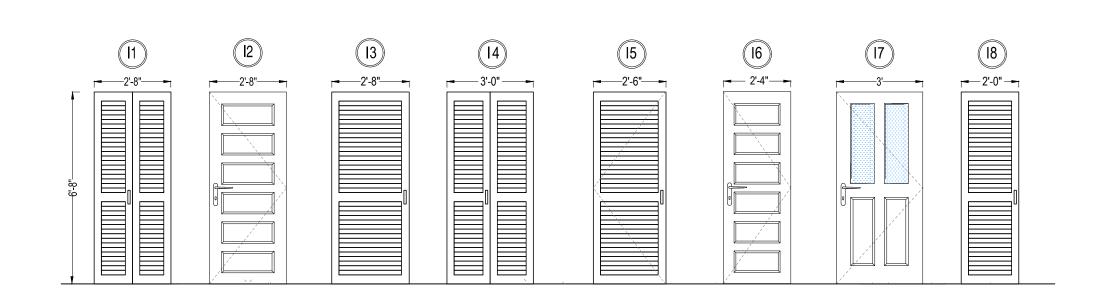

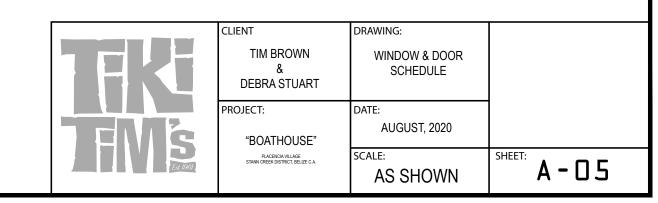

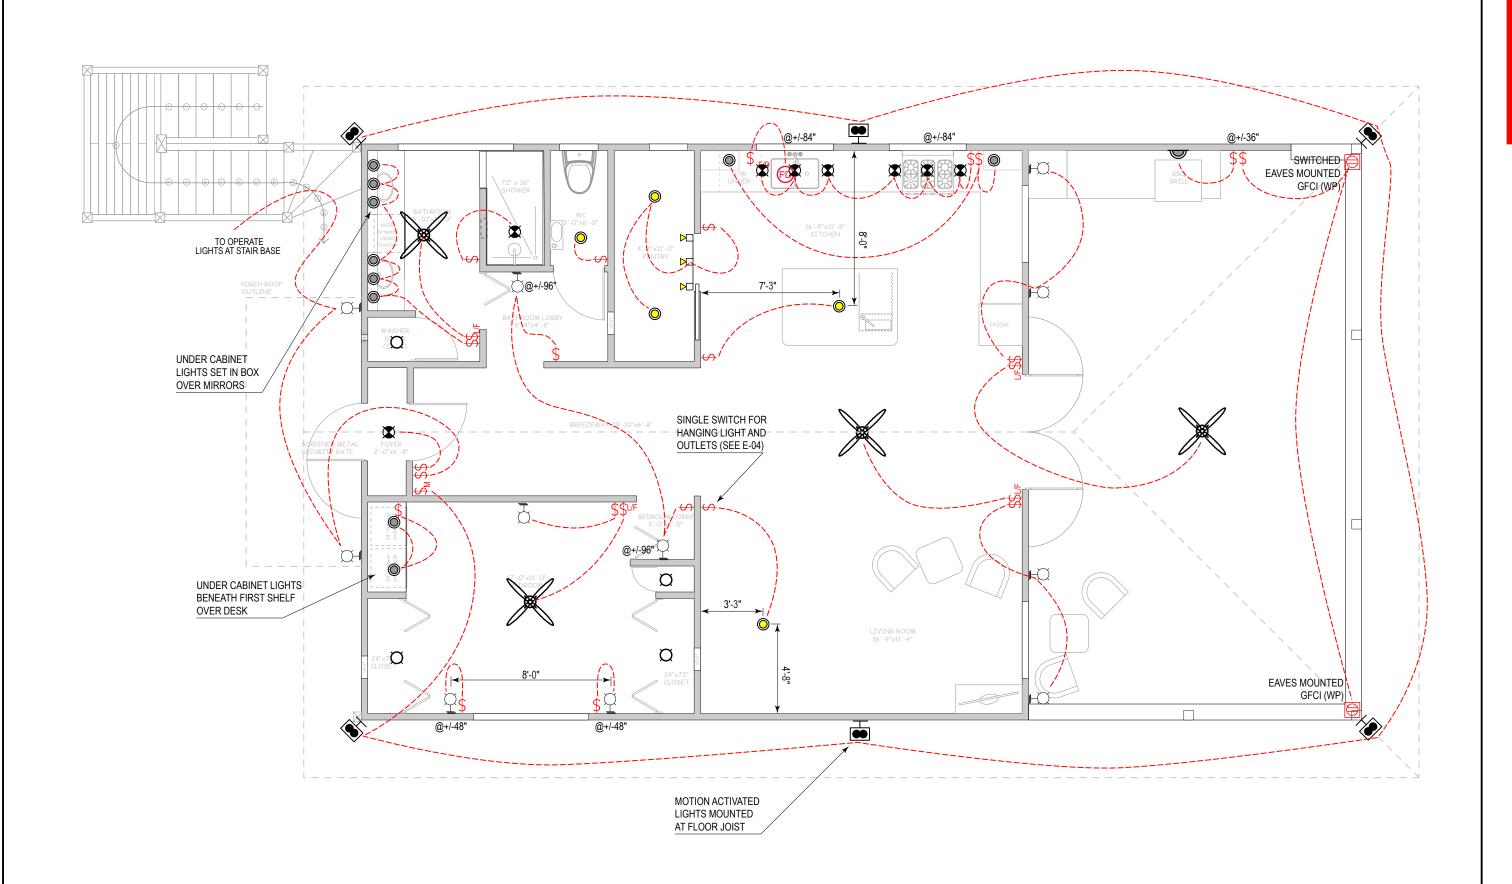

FIRST FLOOR ELECTRICAL FIXTURE LAYOUT

### **ELECTRICAL NOTES**

- 1. All outlets are to be installed 16" height from floor.
- 2. All top counter outlets are to be installed 42" from floor
- 3. All switches are to be installed 48" height from floor
- 4. All wall lights are to be installed 84" height from floor

#### **UNLESS OTHERWISE NOTED**

- 5. All AC units to be just below roof beam. The outside units will be mounted on brackets on the exterior walls as indicated on plans. Use 12,000BTUh in Bedroom 1.
- 6. All design complies with NEC and BEL standards and requirements.
- 7. All installation shall adhere to BEL and NEC standards and requirements.
- 8. All outlets and switches are to ne
- applicable.
- minimum.
- 11. All metal parts are to be bonded and grounded.
- 12. All conduits are to be installed before casting of beams, columns, and slabs.
- 13. All cables are to be installed in one length, no joints are to be allowed. All connections are to be made at outlets, switches, and lights.
- 14. All materials for installation shall be new, UL rated and of the same manufacturer.
- fixtures and switches. NOT for wire directions

# ELECTRICAL LEGEND

Single Pole Switch

Double Pole Switch

Food Disposal Unit Switch

Light/Fan Dual Switch

**Under Cabinet Spot Light** 

Motion Sensor Light Switch

Recessed Spot Light

Door Activated Ceiling Mounted Light

Hanging Lights

Lights Attached to Beams

Sconce Wall Mounted Lights

flush mounted.

- 9. All cables are to be installed via conduits both PVC or EMT where
- 10. Wire gauge should be No. 12

- NOTE: Electrical lines are to indicate

Track Lights

Flourescent Strip Light

Light & Exhaust Fan Combo

Motion Sensor Wall Light

Vanity Wall Light

AC Unit (12,000BTU) Air Conditioning Unit

Main Panel

110V Double Wall Outlet

Double Wall Outlet/Ground

Double Wall Outlet (Waterproof)/ Ground Fault Circuit Inst.

GFCI (WP)

Double Floor Outlet (Waterproof)/ Ground Fault Curcuit Inst.

Cable TV

TV

Electrical Wire

Ceiling Fan with Light

Telephone Outlet

Data Outlet

Telephone & Data Outlet

Smoke Detector

Food Disposer (UNDERCOUNTER)



DRAWING: TIM BROWN DEBRA STUART

PROJECT:

"BOATHOUSE" PLACENCIA VILLAGE STANN CREEK DISTRICT, BELIZE C.A.


FIRST FLOOR **FIXTURE LAYOUT** 

**DRAWING:** 

DATE:

AUGUST 2020

AS SHOWN

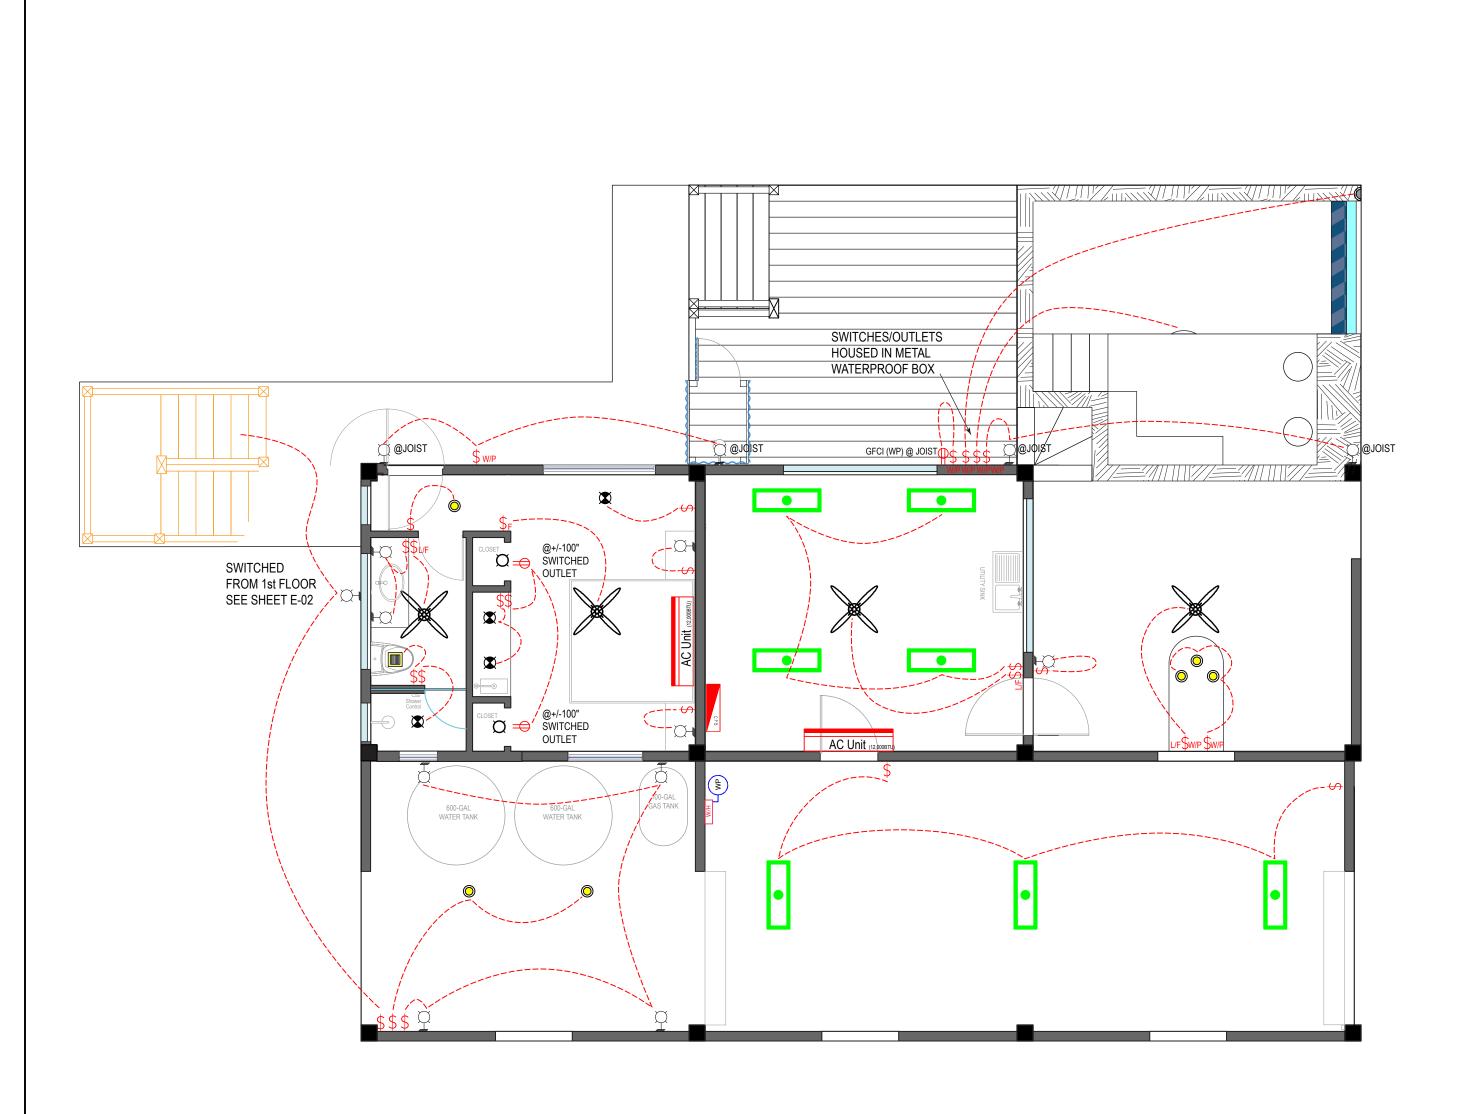

GROUND FLOOR ELECTRICAL FIXTURE LAYOUT

### **ELECTRICAL NOTES**

- 1. All outlets are to be installed 16" height from floor.
- 2. All top counter outlets are to be installed 42" from floor
- 3. All switches are to be installed 48" height from floor
- 4. All wall lights are to be installed 84" height from floor

#### **UNLESS OTHERWISE NOTED**

- 5. All AC units to be just below roof beam. The outside units will be mounted on brackets on the exterior walls as indicated on plans. Use 12,000BTUh in Bedroom 1.
- 6. All design complies with NEC and BEL standards and requirements.
- 7. All installation shall adhere to both BEL and NEC.
- 8. All outlets and switches are to ne flush mounted.
- 9. All cables are to be installed via conduits both PVC or EMT where applicable.
- 10. Wire gauge should be No. 12 minimum.
- 11. All metal parts are to be bonded and grounded.
- 12. All conduits are to be installed before casting of beams, columns, and slabs.
- 13. All cables are to be installed in one length, no joints are to be allowed. All connections are to be made at outlets, switches, and lights.
- 14. All materials for installation shall be new, UL rated and of the same manufacturer.
- NOTE: Electrical lines are to indicate fixtures and switches. NOT for wire directions

# ELECTRICAL LEGEND

Single Pole Switch

Double Pole Switch

3-Way Pole

Light/Fan Dual Switch

Motion Sensor Light Switch

Under Cabinet Spot Light

Recessed Spot Light

Door Activated Ceiling Mounted Light

Hanging Lights

Lights Attached to Beams

Sconce Wall Mounted Lights

Track Lights

Flourescent Strip Light

Light & Exhaust Fan Combo

Vanity Wall Light

Motion Sensor Wall Light

AC Unit (12,000BTU) Air Conditioning Unit

Main Panel

110V Double Wall Outlet

Double Wall Outlet/Ground Fault Circuit Inst.

Double Wall Outlet (Waterproof)/ Ground Fault Circuit Inst.

GFCI (WP)

Double Floor Outlet (Waterproof)/ Ground Fault Curcuit Inst.

Cable TV TV

**Electrical Wire** 

Ceiling Fan with Light

Data Outlet

Telephone Outlet

Telephone & Data Outlet

Smoke Detector

Food Disposer (UNDERCOUNTER)



DRAWING: TIM BROWN & DEBRA STUART


PROJECT:

"BOATHOUSE" PLACENCIA VILLAGE STANN CREEK DISTRICT, BELIZE C.A. **DRAWING: GROUND FLOOR** FIXTURE LAYOUT

DATE:

AUGUST 2020

AS SHOWN

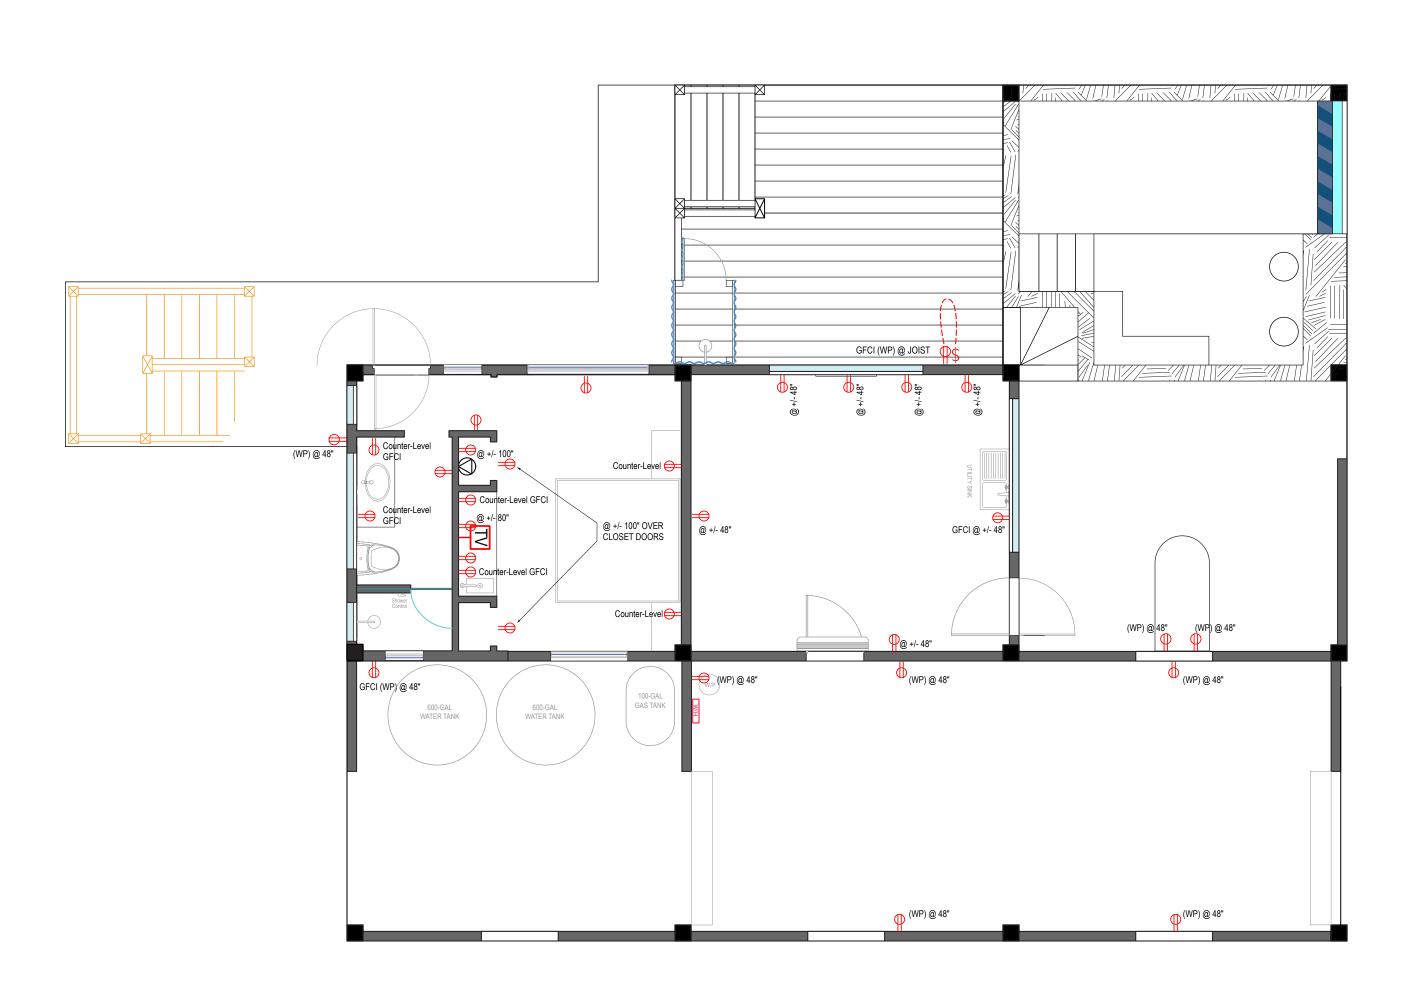

# GROUND FLOOR ELECTRICAL OUTLET LAYOUT 1" = 5'-0"

### **ELECTRICAL NOTES**

- 1. All outlets are to be installed 16" height from floor.
- 2. All top counter outlets are to be installed 42" from floor
- 3. All switches are to be installed 48" height from floor
- 4. All wall lights are to be installed 84" height from floor

#### **UNLESS OTHERWISE NOTED**

- 5. All AC units to be just below roof beam. The outside units will be mounted on brackets on the exterior walls as indicated on plans. Use 12,000BTUh in Bedroom 1.
- 6. All design complies with NEC and BEL standards and requirements.
- 7. All installation shall adhere to both BEL and NEC.
- 8. All outlets and switches are to ne flush mounted.
- 9. All cables are to be installed via conduits both PVC or EMT where applicable.
- 10. Wire gauge should be No. 12 minimum.
- 11. All metal parts are to be bonded and grounded.
- 12. All conduits are to be installed before casting of beams, columns, and slabs.
- 13. All cables are to be installed in one length, no joints are to be allowed. All connections are to be made at outlets, switches, and lights.
- 14. All materials for installation shall be new, UL rated and of the same manufacturer.
- NOTE: Electrical lines are to indicate fixtures and switches. NOT for wire directions

# ELECTRICAL LEGEND

Single Pole Switch

Double Pole Switch

3-Way Pole

Light/Fan Dual Switch

Motion Sensor Light Switch

Under Cabinet Spot Light

Recessed Spot Light

Door Activated Ceiling Mounted Light

Hanging Lights

Lights Attached to Beams

Sconce Wall Mounted Lights

Track Lights Flourescent Strip Light •

Light & Exhaust Fan Combo

Motion Sensor Wall Light

Vanity Wall Light

AC Unit (12,000BTU) Air Conditioning Unit

Main Panel

110V Double Wall Outlet

Double Wall Outlet/Ground Fault Circuit Inst.

Double Wall Outlet (Waterproof)/ Ground Fault Circuit Inst.

GFCI (WP)

Double Floor Outlet (Waterproof)/ Ground Fault Curcuit Inst.

TV Cable TV

**Electrical Wire** 

Ceiling Fan with Light

Data Outlet

Telephone Outlet

Telephone & Data Outlet

Smoke Detector

Food Disposer (UNDERCOUNTER)



DRAWING: TIM BROWN DEBRA STUART


PROJECT:

"BOATHOUSE" PLACENCIA VILLAGE STANN CREEK DISTRICT, BELIZE C.A. **DRAWING: GROUND FLOOR OUTLET LAYOUT** 

DATE:

AUGUST 2020

AS SHOWN

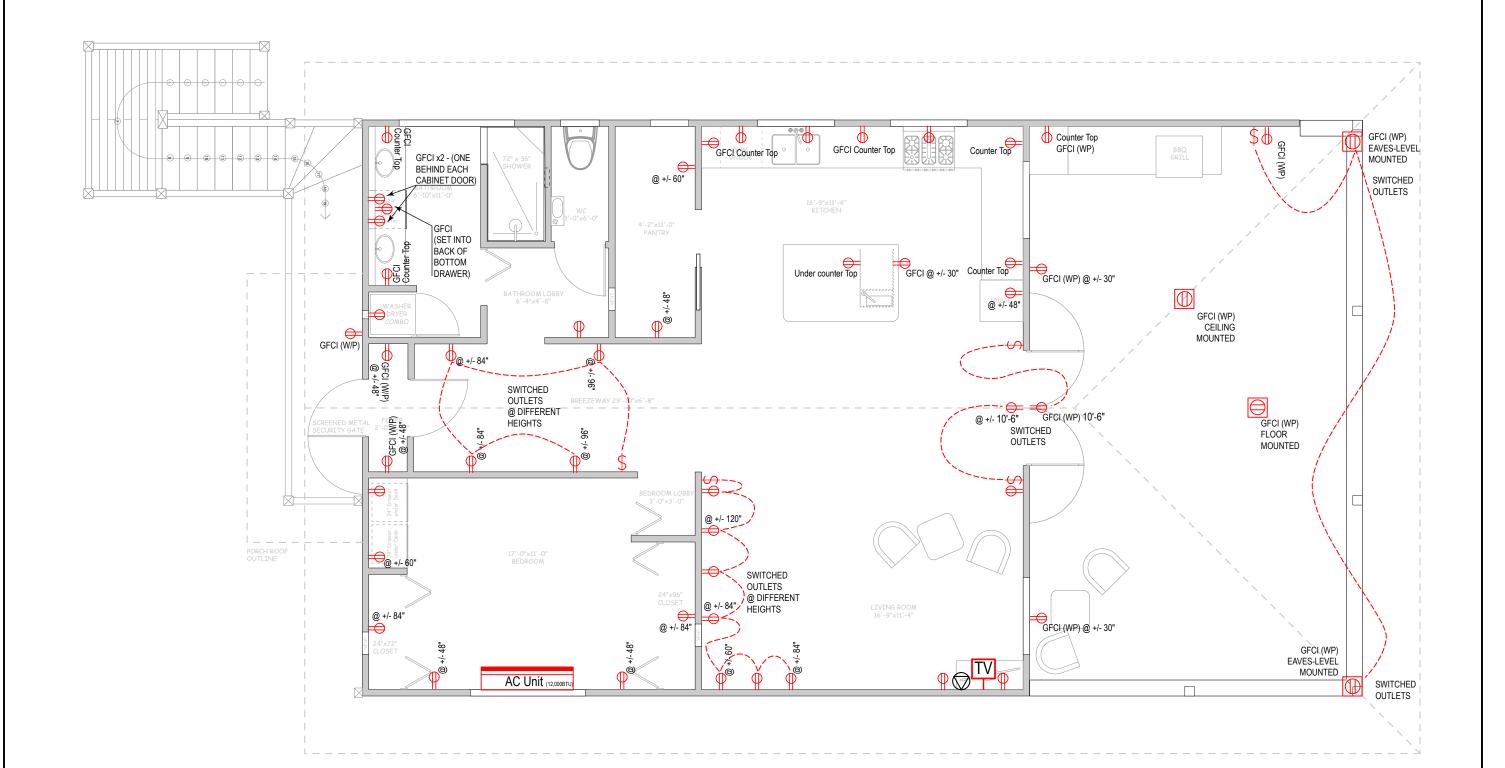

### **ELECTRICAL NOTES**

- 1. All outlets are to be installed 16" height from floor.
- 2. All top counter outlets are to be installed 42" from floor
- 3. All switches are to be installed 48" height from floor
- 4. All wall lights are to be installed 84" height from floor

#### **UNLESS OTHERWISE NOTED**

- 5. All AC units to be just below roof beam. The outside units will be mounted on brackets on the exterior walls as indicated on plans. Use 12,000BTUh in Bedroom 1.
- 6. All design complies with NEC and BEL standards and requirements.
- 7. All installation shall adhere to both BEL and NEC.
- 8. All outlets and switches are to be flush mounted.
- 9. All cables are to be installed via conduits both PVC or EMT where applicable.
- 10. Wire gauge should be No. 12 minimum.
- 11. All metal parts are to be bonded and grounded.
- 12. All conduits are to be installed before casting of beams, columns, and slabs.
- 13. All cables are to be installed in one length, no joints are to be allowed. All connections are to be made at outlets, switches, and lights.
- 14. All materials for installation shall be new, UL rated and of the same manufacturer.
- NOTE: Electrical lines are to indicate fixtures and switches. NOT for wire directions

### **ELECTRICAL LEGEND**

Single Pole Switch

Double Pole Switch

3-Way Pole

Light/Fan Dual Switch

Motion Sensor Light Switch

Under Cabinet Spot Light

Recessed Spot Light

Door Activated Ceiling Mounted Light

Hanging Lights

Lights Attached to Beams

Sconce Wall Mounted Lights

Track Lights

• Flourescent Strip Light Light & Exhaust Fan Combo

Motion Sensor Wall Light

Vanity Wall Light

AC Unit (12,000BTU) Air Conditioning Unit

Main Panel

110V Double Wall Outlet

Double Wall Outlet/Ground Double Wall Outlet (Waterproof)/ Ground Fault Circuit Inst.

GFCI (WP) Double Floor Outlet (Waterproof)/ Ground Fault Curcuit Inst.

TV Cable TV

Electrical Wire

Ceiling Fan with Light


Telephone Outlet

Telephone & Data Outlet

Smoke Detector

Data Outlet

Food Disposer (UNDERCOUNTER)

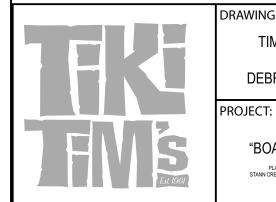

TIM BROWN DEBRA STUART

PLACENCIA VILLAGE STANN CREEK DISTRICT, BELIZE C.A.

"BOATHOUSE"


DATE:

DRAWING:

AUGUST, 2020

**AS SHOWN** 

FIRST FLOOR **OUTLET LAYOUT** 

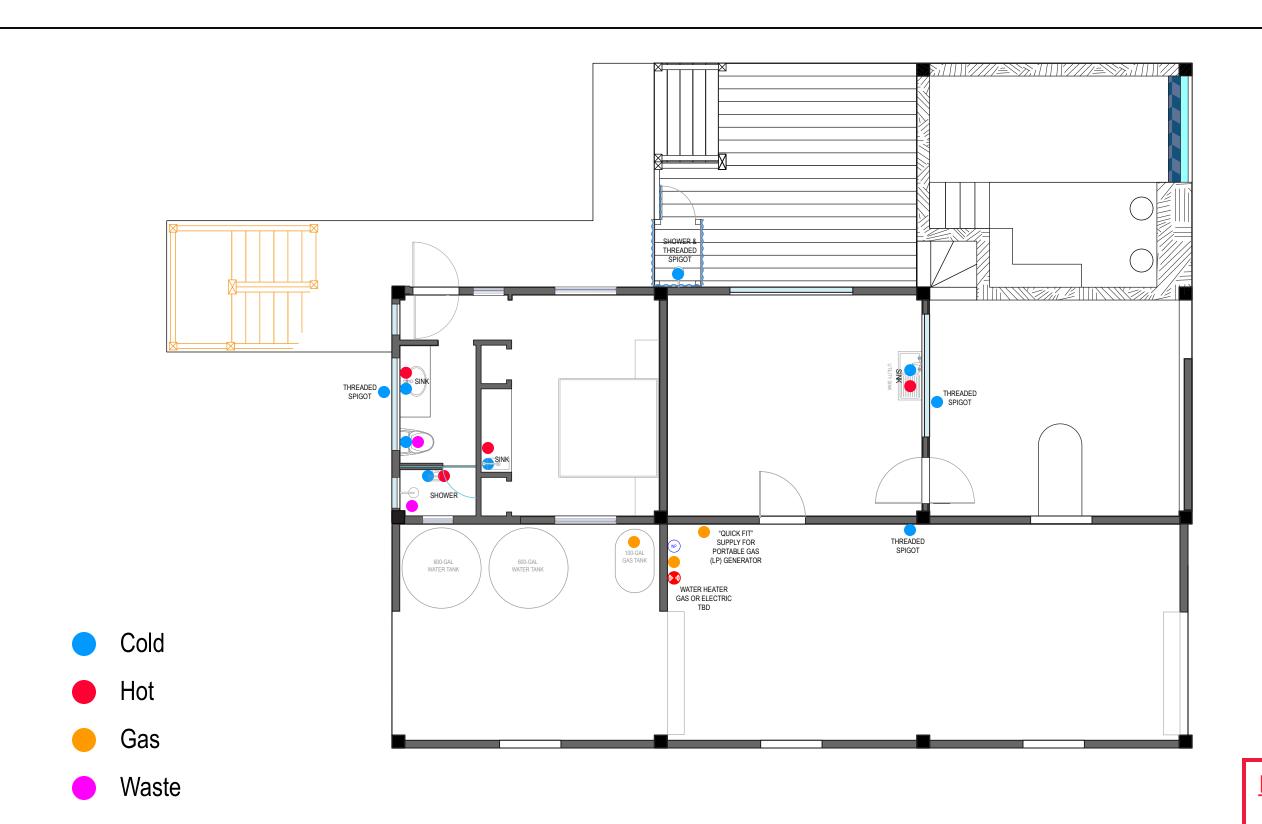



1ST & GROUND FLOOR PLUMBING

--


**IMPORTANT NOTE: GUIDE ONLY** 

GAS, HOT/COLD WATER, WASTE, ETC. EXACT LOCATION AND SPECIFICATION TBD BY LICENSED PRACTITIONER

plumbing legend			
	gas line		
	cold water supply		
	hot water supply		
black waters			
grey waters 2" dia. pvc pipe			
vent pipe 'turned up'			
<b>→</b> ▼	→ <b>又</b> — gate valve		
— check valve			
— (M)— water meter			
•	2" Ø pvc downspout (DST)		
•	pipes running up		
++	pvc sch 40 tee		
t <sub>t</sub>	pvc sch 40 90° elbow		
нв	hose bibb / faucet		
•	elbow 'turned up'		
tee 'turned up'			
		water heater	
we water pump			

#### PLUMBING NOTES:

- 1. MAIN POTABLE WATER PIPE TO BE ¾" DIA. PVC SCH 40 PIPE. 2. ALL HOT WATER PIPES TO BE ¾" DIA. CPVC SCH 40 PIPE.
- 3. POTABLE WATER PIPE THAT LEADS TO ACCESSORIES TO BE  $\frac{1}{2}$ "DIA PVC SCH 40 PIPE.
- 4. DISCHARGE PIPES FROM TOILETS KNOWN AS SOIL PIPES TO BE 4" DIA. SCH 40 PIPE NOT LESS THAN 3" DIA.
- 5. DISCHARGE PIPES FROM LAVATORIES KNOWN AS WASTE PIPES TO BE 2" DIA. SCH 40 PIPE.
- 6. NO WASTE WATER PIPE SHALL DISCHARGE INTO A BEND ATTACHED TO A WATER CLOSET BOWL.
- 7. NO SOIL OR WASTE PIPE SHALL BE FITTED WITH DOUBLE HUBS, DOUBLE TEES OR DOUBLE Y'S.
- 8. ALL JOINTS AND CONNECTIONS SHALL BE OF THE SAME MATERIAL AND SHALL BE AIR AND WATERTIGHT.
- 9. ALL MATERIALS FOR INSTALLATION SHALL BE NEW AND OF THE SAME MANUFACTURER.
- 10. ALL PIPES ARE TO BE INSTALLED BEFORE CASTING OF BEAMS, COLUMNS AND SLABS.
- 11. ALL INSPECTION CHAMBERS TO BE 30"x30" MIN. OF REINFORCED CONCRETE AND TO INCLUDE BENCHING AND BRANCH CHANNEL AND "Y" PIPE OF APPROPRIATE DIAMETER AS RODDING EYE.
- 12. SLOPE OF SOIL PIPE 2.0% MINIMUM.
- 13. SLOPE OF WASTE PIPE TO BE 2.5% MINIMUM.
- 14. ALL FITTING FOR LINE TO BE INCLUDED.
- 15. VENT PIPES TO BE 2" DIA.
- 16. VENT PIPES SHALL BE EXTENDED TO MINIMUM DISTANCE OF 18" ABOVE ROOF.
- 17. PIPES SHALL NOT PASS THROUGH MAIN STRUCTURAL BEAMS.
- 18. ALL PVC PIPES ARE TO BE SCH 40
- 19. HEIGHT OF WASH HAND BASINS ARE TO BE 31" FROM FINISH FLOOR.
  20. HEIGHT OF TOILET PAPER RACKS ARE TO BE 2'-0" FROM FINISH FLOOR.
- 21. ALL FURNITURE SHALL HAVE A ½" DIA. ANGLE VALVE.
- 22. HEIGHT OF TOWEL RACKS TO BE 3'-0" FROM FINISH FLOOR.
- 23. SHOWER TRAYS, BATH TUBS, SINKS AND WASH HAND BASIN SHALL BE PROVIDED WITH A P-TRAP.
- 24. ALL LINES SHALL BE TESTED BEFORE CONCEALING.
- 25. WASTE WATER FROM SWIMMING POOL AND HOT TUB SHALL NOT BE CONNECTED TO THE WASTE WATER LINE AND SHALL BE TREATED OR DISPOSED OF ACCORDING TO LOCAL ENVIRONMENT AUTHORITY.
  26. SWIMMING POOL AND HOT TUB SHALL BE PROVIDED WITH AN
- OVERFLOW SYSTEM NOT CONNECTED TO THE WASTE WATER LINE, CONSULT MANUFACTURER'S MANUAL FOR ALL NECESSARY PIPES AND FITTINGS.

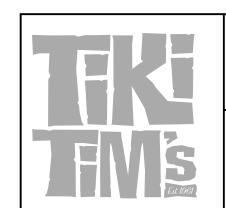


DRAWING:	DRAWING:	
TIM BROWN & DEBRA STUART	1ST & GRND FLOOR PLUMBING	
PROJECT:	DATE:	
"BOATHOUSE"	AUGUST, 2020	
PLACENCIA VILLAGE	SCALE:	SHEET:


PLACENCIA VILLAGE
STANN CREEK DISTRICT, BELIZE C.A.


SCALE:

AS SHOWN

PO-1

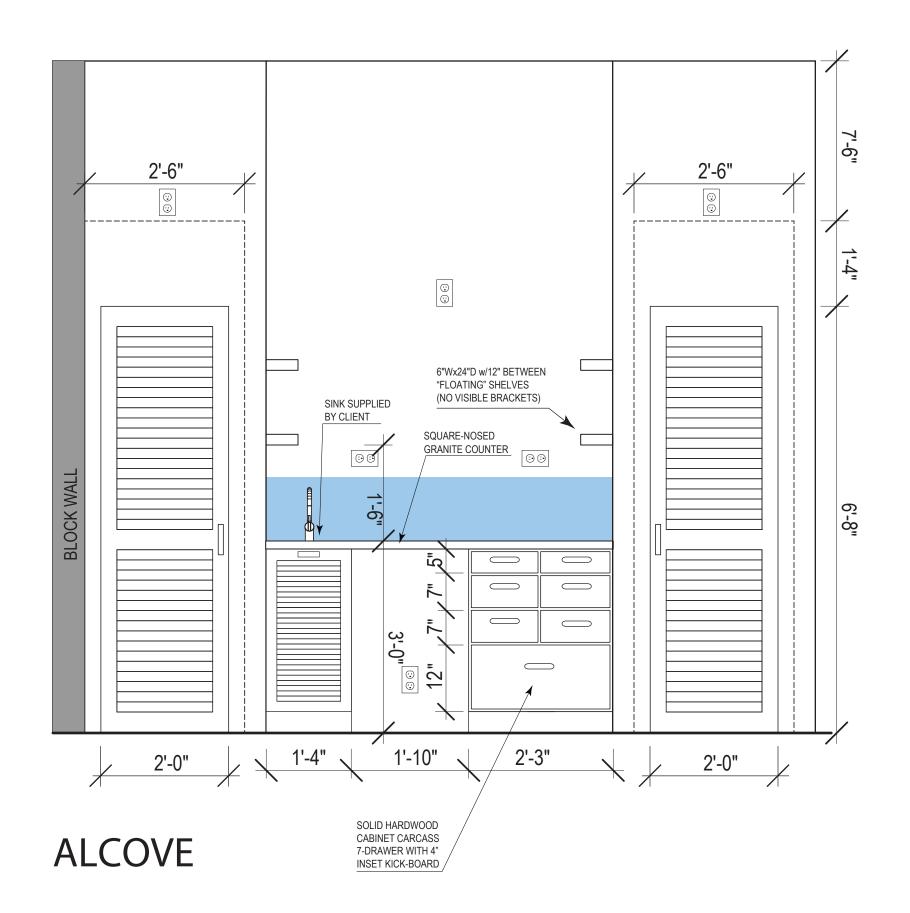

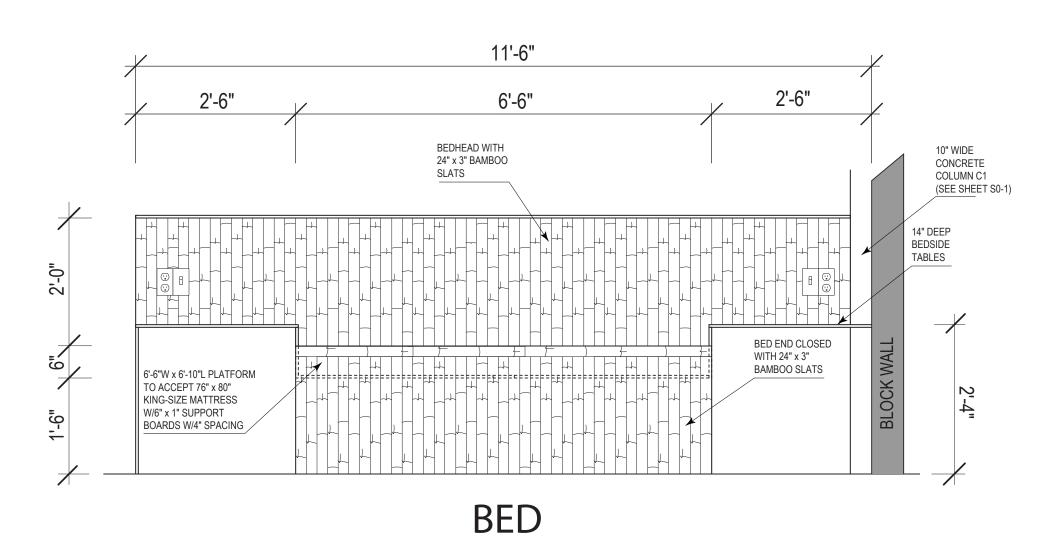

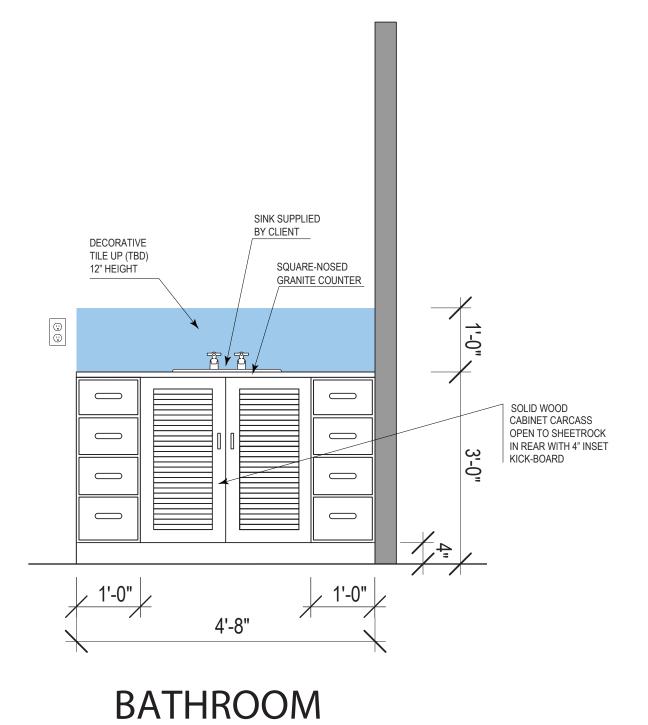







ROWN & DEBRA STUART "THE BOATHOUSE"
PLACENCIA NORTH, BELIZE TIM BI


> PLANS & **ELEVATIONS**


DATE: August 2020


SCALE:1/96 DRAWN BY: Tim Brown

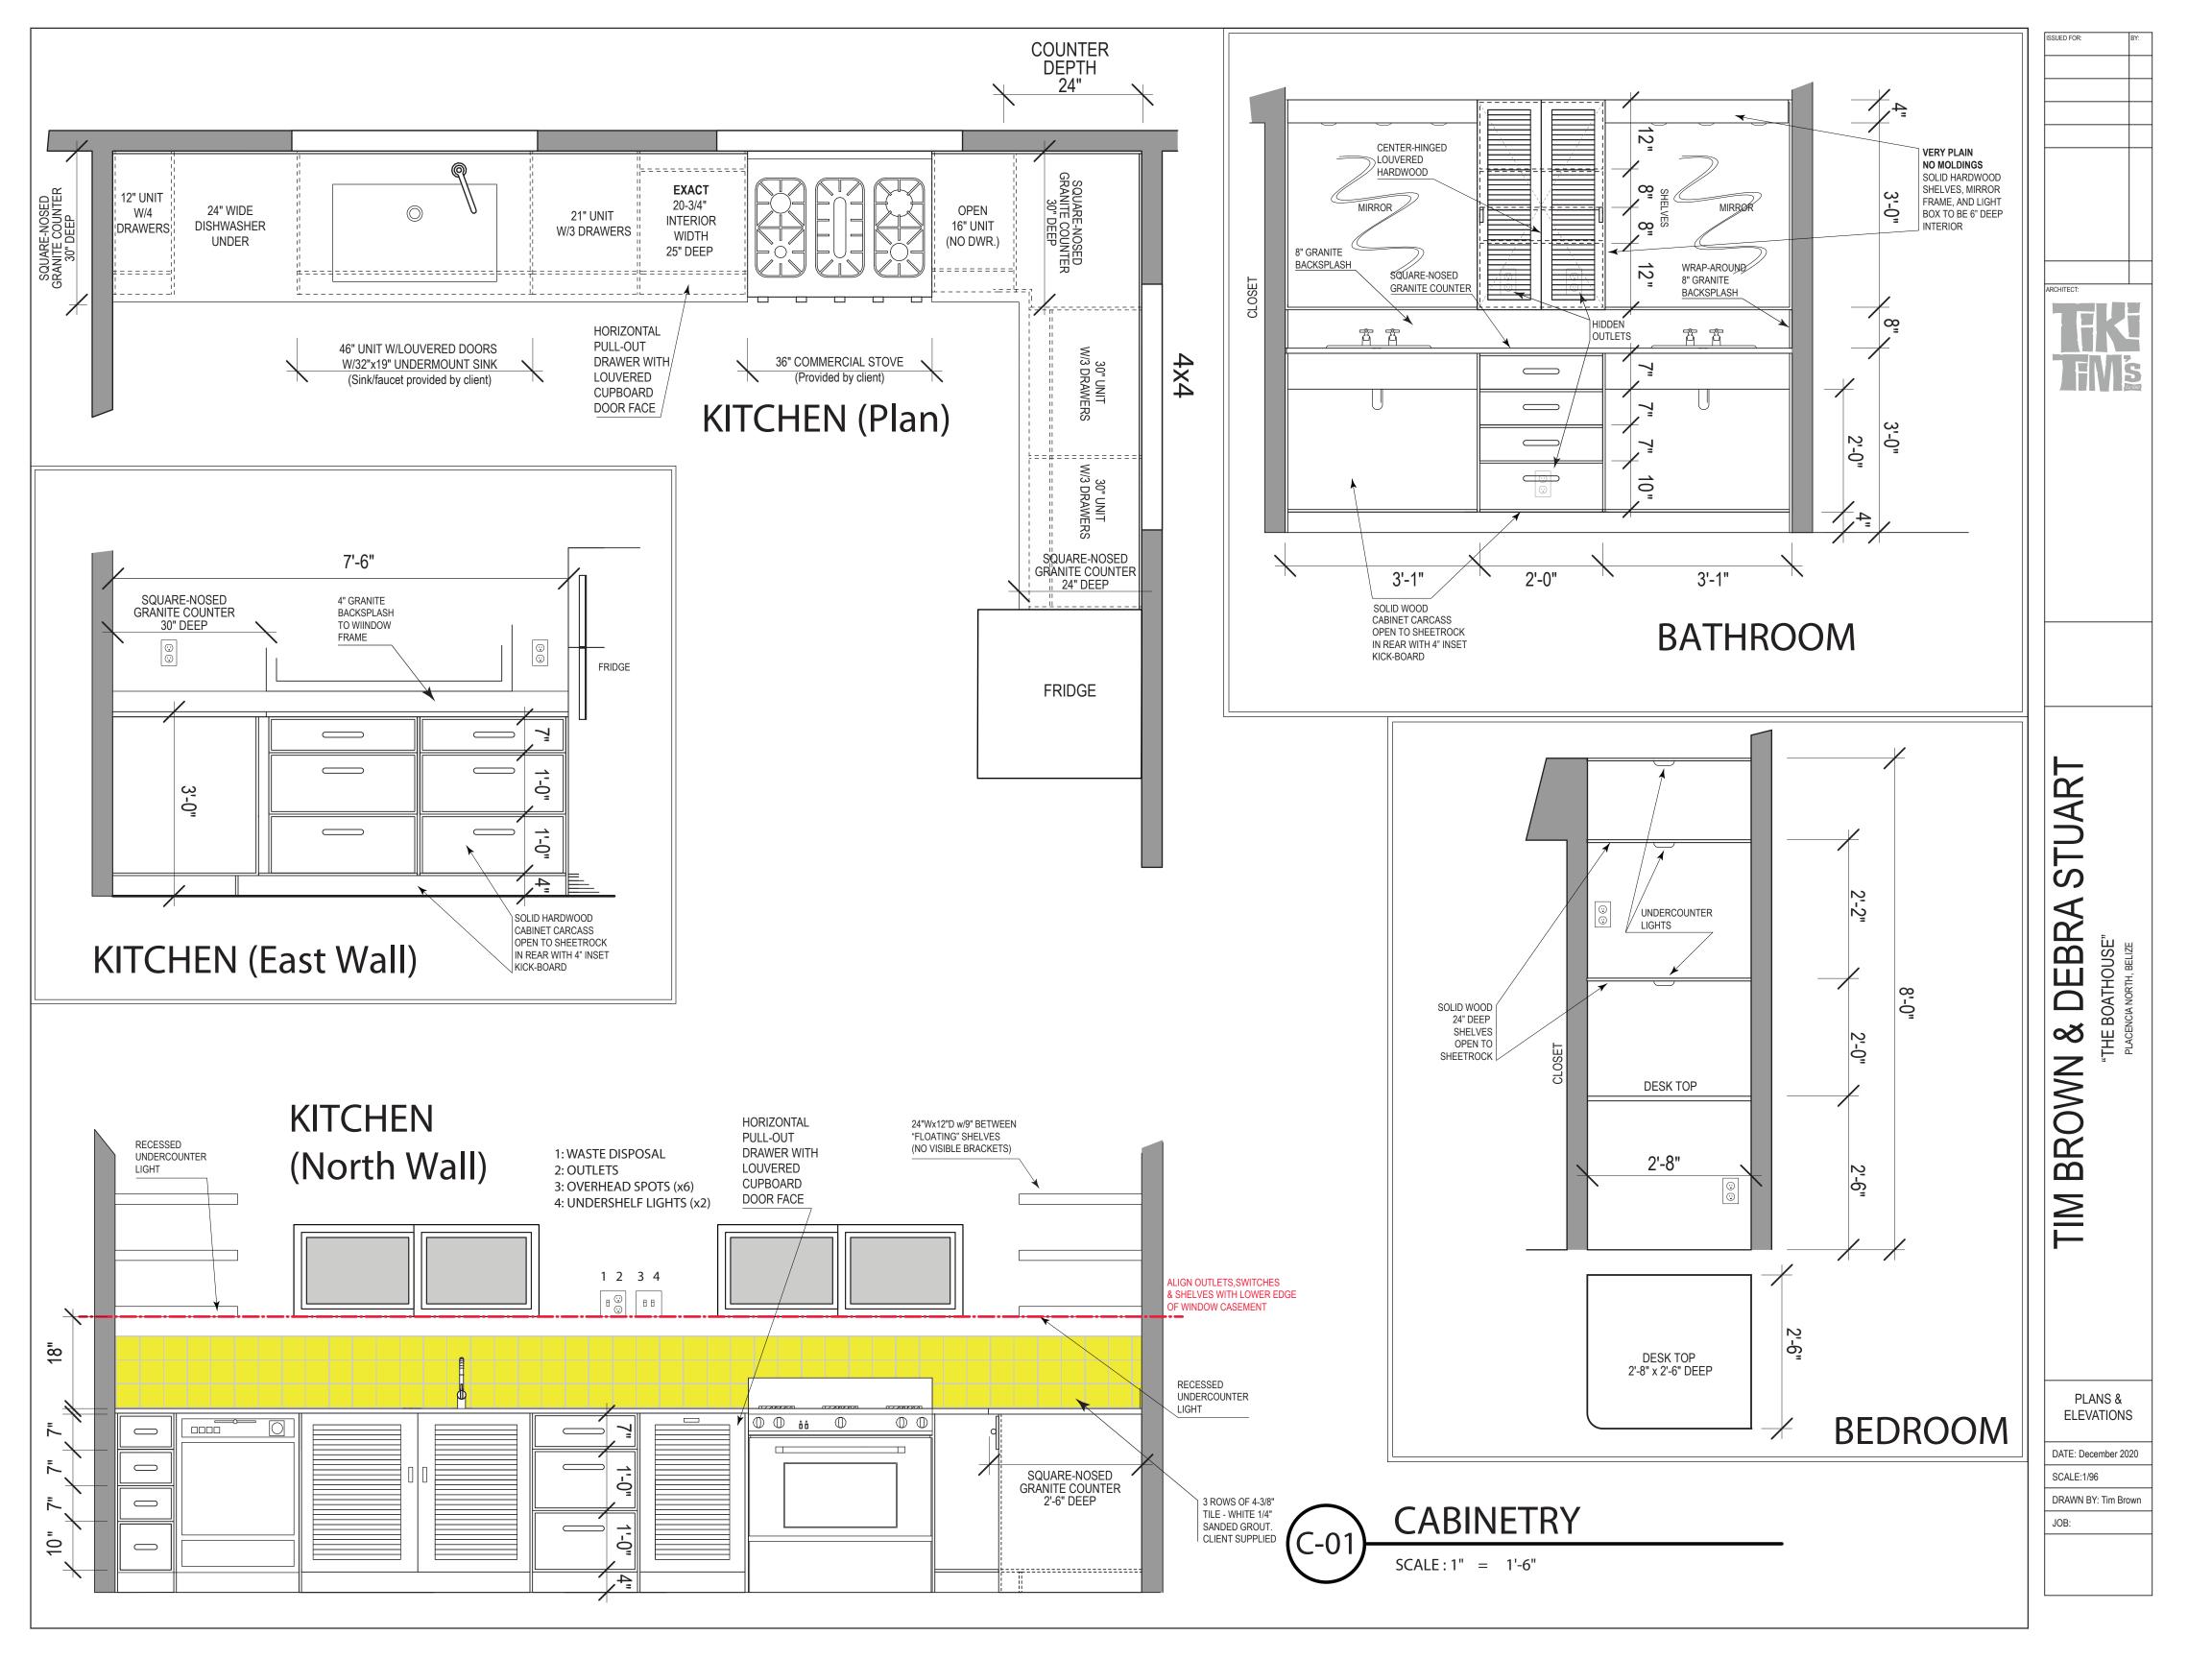


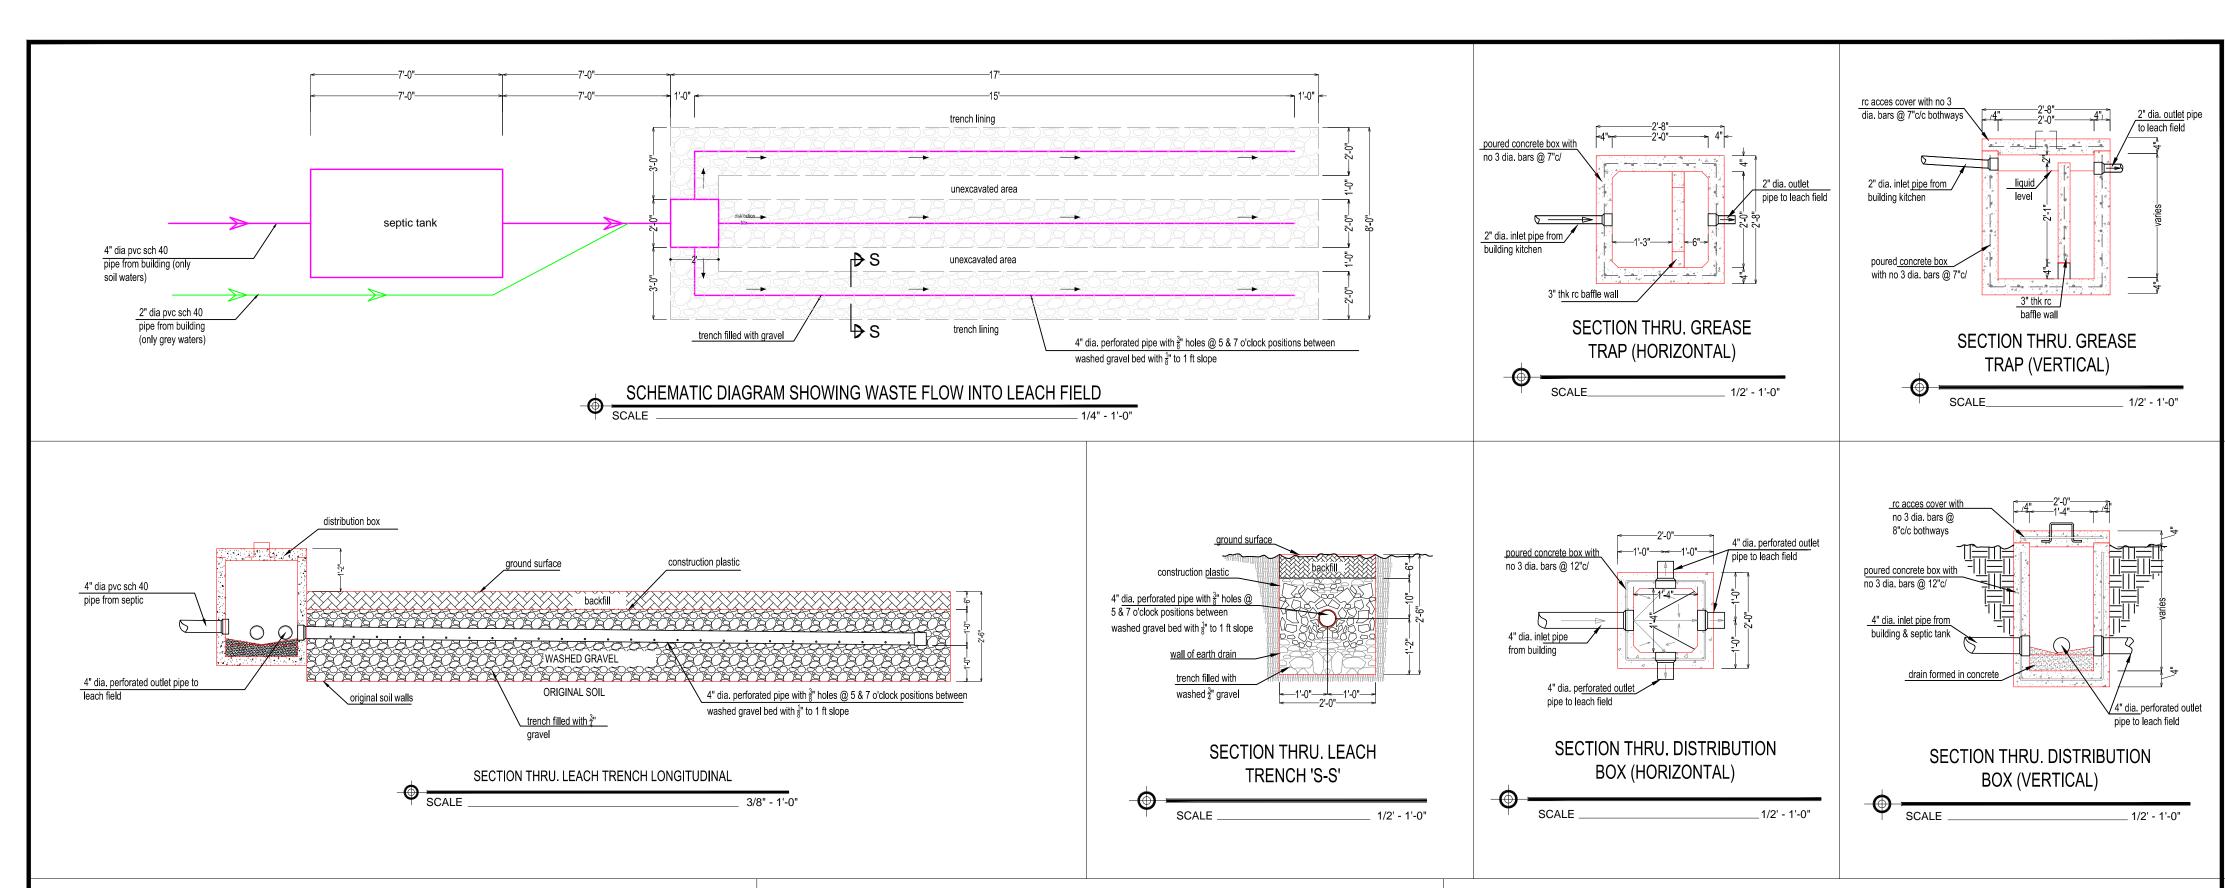

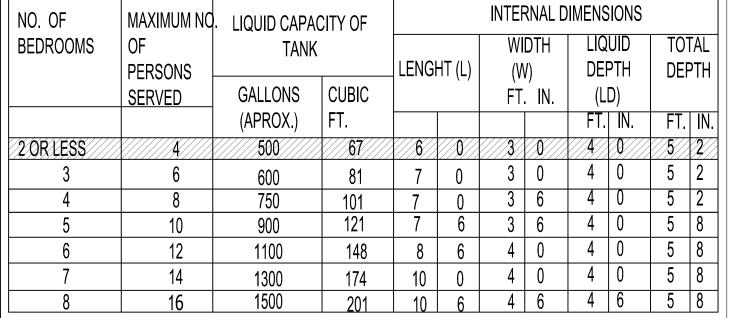

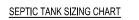

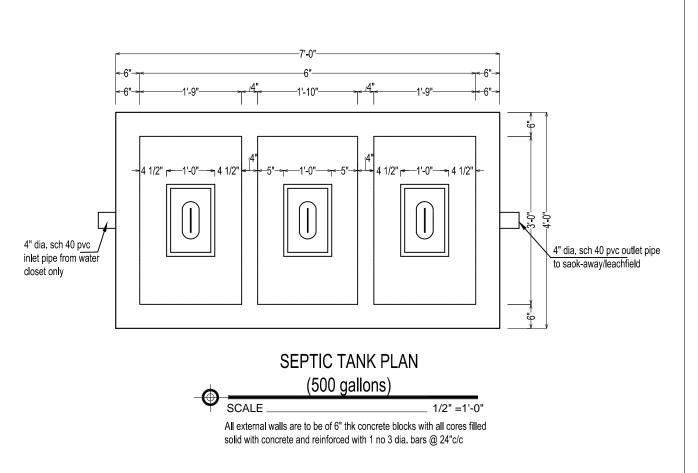

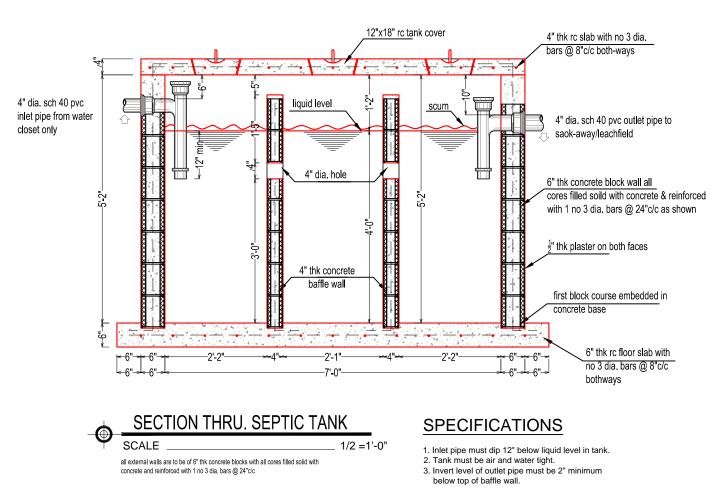

·	below top of baffle wall.		

ENGINEER STAMP:		TIKI TIM VENTURES LLC.	DRAWING: LEACH FIELD & SEPTIC TANK DETAILS/ LAYOUT	Maya Beach, Belize C.A Tel: (501) 533-8113 Mail: info@ab2architects.com  -THIS DRAWING IS PROPERTY OF THE
		RESIDENTIAL HOUSE	DATE:  JUNE, 2016  ARCHITECT AND REPRODUCTION IS PROHIBITED WITHOUT HIS WRITTEN APPROVAL.  THE ARCHITECT DRAWINGS SHALL NOT I USED BY THE CLIENT OR OTHERS ON OTHER PROJECT UNLESS BY AGREEMENT IN WRITING	
	VALID ONLY WHEN SEALED & SIGNED		AS SHOWN	P-02